HOUSTON AIRPORTS

IAH-TERMINAL - SECURITY EXIT LANE

SECURE EXIT LANE BREACH CONTROL GEORGE BUSH IAH 3500 NORTH TERMINAL RD. HOUSTON, TX 77032

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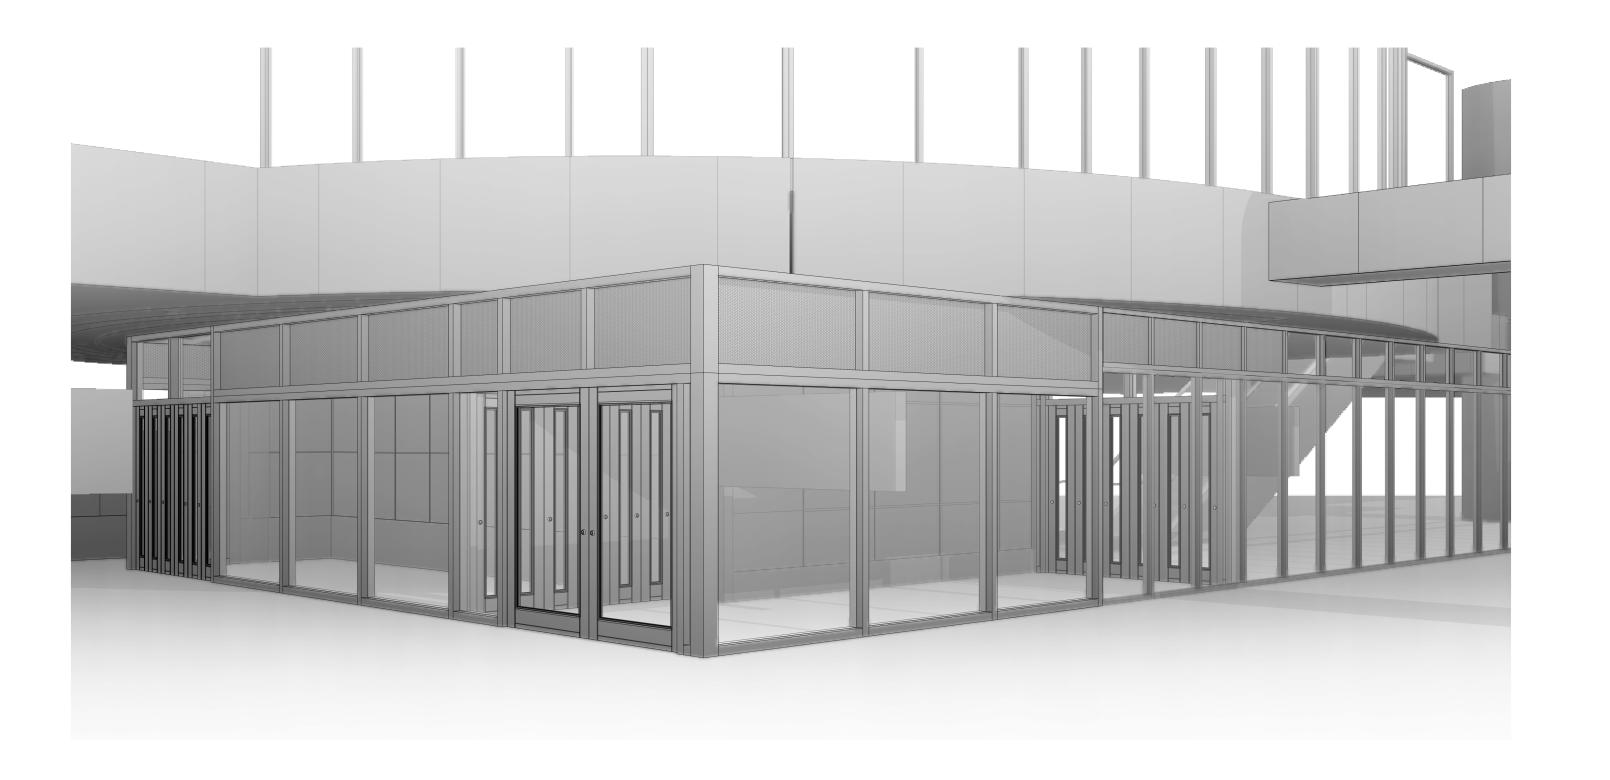
SECURITY / TELECOMMUNICATIONS

PGA ENGINEERS



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FOR INFORMATION AND REFERENCE ONLY



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IAH TERMINAL C SIGNAGE DEMO PLAN

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PROJECT No. 1004345

09-09-21



ARCHITECTURE
ENGINEERING
INTERIORS
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AUSTIN
BOCA RATON
CHICAGO
DALLAS
HOBOKEN
HOUSTON

ALEXANDRIA

LAS VEGAS
LOS ANGELES

HAS - PROJECT MANAGER

DESIGN AS SUBMITTED IS APPROVED

FOR CONSTRUCTION DOCUMENTATION

ON AIRPORT SYSTEM
OR OR DESIGN REPRESENTATIVE

PROJECT NUMBER

DEPARTMENT RECOMMENDED:

COVER SHEET SHEET SHEET INDEX

SHEET NUMBER

G000



SHOP DRAWINGS & SUBMITTALS

- 1. THE GENERAL CONTRACTOR SHALL PROVIDE THE ARCHITECT WITH SHOP DRAWINGS FOR REVIEW AND APPROVAL, FOR ALL, BUT NOT LIMITED TO, THE FOLLOWING: MISC. STEEL, WAYFINDING AND SIGNAGE. SHOP DRAWINGS SHALL BE SUBMITTED IN THE FORM OF DIGITAL PDF PRINTS. SHOP DRAWINGS SHALL NOT BE REPRODUCTIONS OF CONTRACT DOCUMENTS.
- 2. CONTRACTOR NEEDS TO PROVIDE A COMPLETE MESSAGE SCHEDULE AND COMPLETE FABRICATION / ASSEMBLY DETAILS FOR ALL SIGNS FOR VERIFICATION PURPOSES AND SIGNED AND
- 3. THE GENERAL CONTRACTOR SHALL SUBMIT SHOP DRAWINGS AND SUBMITTALS, AND SHALL ORDER AND SCHEDULE DELIVERY OF MATERIALS TO AVOID DELAYS IN CONSTRUCTION. IF AN ITEM IS FOUND TO BE UNAVAILABLE OR TO HAVE A LONG LEAD TIME, THE GENERAL CONTRACTOR SHALL NOTIFY ARCHITECT IMMEDIATELY WITH A PROPOSED ALTERNATIVE.
- 4. THE CONTRACTOR SHALL SUBMIT FINAL CLOSEOUT DOCUMENTS FOR REVIEW.

SEALED ENGINEERED DRAWINGS FOR SIGNAGE MOUNTING AND SUPPORTS.

PATCHING, REPAIR & FINISH WORK

- 1. THE GENERAL CONTRACTOR SHALL INCLUDE ALL X-RAY AND CORE DRILL COSTS. THE GENERAL CONTRACTOR SHALL REVIEW AND COORDINATE THE SIZE AND LOCATION OF ALL SLAB OPENINGS WITH ALL RELATED DISCIPLINES. THE GENERAL CONTRACTOR SHALL SUBMIT PROPOSED LOCATIONS OF CORE DRILLING AND SLAB OPENINGS TO ARCHITECT AND STRUCTURAL ENGINEER OF RECORD FOR REVIEW AND APPROVAL PRIOR TO PROCEEDING WITH THE WORK.
- 2. PATCH, REPAIR, AND INSTALL ALL FIREPROOFING AS REQUIRED BY CODE. FIREPROOF ALL NEW PENETRATIONS AS REQUIRED FOR APPROVAL BY THE AUTHORITY HAVING JURISDICTION. 3. SLAB PENETRATIONS SHALL BE SEALED AS REQUIRED TO MAINTAIN FIRE RATING, USING
- MATERIALS AND METHODS APPROVED BY THE AUTHORITY HAVING JURISDICTION. EXPANSION MATERIAL SHALL BE APPROVED BY THE ARCHITECT. 4. ALL DEBRIS SHALL BE REMOVED FROM THE SITE ON A DAILY BASIS, OR AS DIRECTED BY THE
- AUTHORITY HAVING JURISDICTION. UPON COMPLETION OF THE WORK, REMOVE ALL DEBRIS FROM THE BUILDING CREATED BY THE WORK PROVIDED UNDER THIS CONTRACT AND LEAVE ALL AREAS CLEAN. TRASH IS NOT PERMITTED TO BE BURNED ON SITE. 5. ALL ABANDONED AND MISCELLANEOUS NAILS, HANGERS, STAPLES, WIRES, CONDUITS AND DEBRIS
- SHALL BE REMOVED FROM EXPOSED AREAS OF THE FLOORS, WALLS, AND CEILINGS. REMOVE ALL ABANDONED PIPE SLEEVES IN FLOOR SLABS. PATCH EXISTING SLAB AS REQUIRED TO MAINTAIN UL FIRE RATING OF FLOOR SLAB WHERE PIPES AND CONDUITS HAVE BEEN REMOVED.
- 6. THE GENERAL CONTRACTOR SHALL CONTINUOUSLY CHECK ARCHITECTURAL AND STRUCTURAL CLEARANCES FOR ACCESSIBILITY OF EQUIPMENT AND MECHANICAL AND ELECTRICAL SYSTEMS. NO ALLOWANCES OF ANY KIND WILL BE MADE FOR THE GENERAL CONTRACTOR'S NEGLIGENCE TO FORESEE MEANS OF INSTALLING EQUIPMENT INTO POSITION.
- . THE FINISHED WORK SHALL BE FIRM, WELL-ANCHORED, IN TRUE ALIGNMENT, PLUMB, LEVEL, WITH SMOOTH, CLEAN, UNIFORM, APPEARANCE WITHOUT WAVES, DISTORTIONS, HOLES, MARKS, CRACKS, STAINS, OR DISCOLORATION. JOINTING SHALL BE CLOSE FITTING, NEAT AND WELL SCRIBED. THE FINISHED WORK SHALL HAVE NO EXPOSED UNSIGHTLY ANCHORS OR FASTENERS AND SHALL NOT PRESENT HAZARDOUS, UNSAFE CORNERS. ALL WORK SHALL HAVE THE PROVISION FOR EXPANSION, CONTRACTION AND SHRINKAGE AS NECESSARY TO PREVENT CRACKS, BUCKLING, AND WARPING DUE TO TEMPERATURE AND HUMIDITY CONDITIONS.
- 8. GENERAL CONTRACTOR SHALL WAIVE "COMMON PRACTICE" AND "COMMON USAGE" AS CONSTRUCTION CRITERIA WHEREVER DETAILS AND CONTRACT DOCUMENTS OF GOVERNING CODES, ORDINANCES, ETC. REQUIRE QUANTITY OR BETTER QUALITY THAN COMMON PRACTICE OR COMMON USAGE WOULD REQUIRE.
- 9. ATTACHMENTS, CONNECTIONS OR FASTENERS OF ANY NATURE ARE TO PROPERLY AND PERMANENTLY BE SECURED IN CONFORMANCE WITH INDUSTRY BEST PRACTICES. THE DRAWINGS HIGHLIGHT SPECIAL CONDITIONS ONLY AND BY NO MEANS ILLUSTRATE EVERY CONNECTION. THE CONTRACTOR IS RESPONSIBLE FOR IMPROVING CONNECTION ACCORDINGLY.
- 10. THE GENERAL CONTRACTOR SHALL NOTIFY THE ARCHITECT OF ANY ACCESS PANELS WHICH MAY BE REQUIRED PRIOR TO PROCEEDING WITH THE WORK. CONTRACTOR SHALL BE RESPONSIBLE FOR COORDINATING ALL TRADES. REQUIRED ACCESS PANELS SHALL BE INCLUDED IN THE CONTRACTOR'S SCOPE OF WORK.

PROJECT CONDITIONS

- 1. THE TERM "BASE BUILDING" MEANS THE EXISTING STRUCTURES WITHIN THE PROPERTY SITE WHERE THE PROJECT AND THE WORK IS CONSTRUCTED.
- 2. DRAWING FOR THE WORK IS BASED ON OWNER-FURNISHED BASE BUILDING DOCUMENTS AND UPON THE ARCHITECT'S LIMITED VISUAL OBSERVATIONS OF LATENT EXPOSED CONDITIONS AT THE TIME OF COMMENCING THE ARCHITECT'S DESIGN CONSULTING SERVICES.
- 3. THE GENERAL CONTRACTOR SHALL REVIEW AND VERIFY EXISTING CONDITIONS AS PROVIDED IN THE CONSTRUCTION DOCUMENTS. THE CONTRACTOR SHALL NOTIFY THE ARCHITECT OF ALL DISCREPANCIES, ERRORS, INCONSISTENCIES OR AMBIGUITIES PRIOR TO PROCEEDING WITH THE WORK. ANY UNREPORTED DEFICIENCIES WILL BECOME THE RESPONSIBILITY OF THE GENERAL CONTRACTOR TO CORRECT
- 4. THE GENERAL CONTRACTOR SHALL BE RESPONSIBLE FOR, AND PROVIDE PROTECTION OF, ANY EXISTING FINISHES, MATERIALS, AND EQUIPMENT TO REMAIN. THE GENERAL CONTRACTOR SHALL REPAIR OR REPLACE ANY DAMAGED FINISHES, MATERIALS, AND EQUIPMENT AS A RESULT OF THE WORK. ALL EXISTING FINISHES TO REMAIN SHALL BE CLEANED AT THE COMPLETION OF CONSTRUCTION. THE GENERAL CONTRACTOR SHALL PHOTOGRAPH AND DOCUMENT ALL EXISTING DAMAGES, AND PROVIDE TO THE ARCHITECT, PRIOR TO PROCEEDING WITH THE WORK.
- 5. THE GENERAL CONTRACTOR SHALL VERIFY THAT NO CONFLICTS EXIST BETWEEN THE LOCATIONS OF EXISTING AND PROPOSED NEW WAYFINDING AND SIGNAGE (INCLUDING BUT NOT LIMITED TO STRUCTURAL MEMBERS, PIPING, DUCT WORK, CONDUIT AND SPRINKLERS) AND THAT CLEARANCES FOR INSTALLATION ARE PROVIDED. ELEMENTS IN CONFLICT SHALL BE DOCUMENTED AND PROVIDED TO THE ARCHITECT PRIOR TO PROCEEDING WITH THE WORK.
- 6. IN THE EVENT OF CONFLICT BETWEEN DATA SHOWN ON DRAWINGS AND DATA PROVIDED IN THE SPECIFICATION. THE GENERAL CONTRACTOR SHALL PROVIDE WRITTEN NOTIFICATION TO THE ARCHITECT OF ANY DISCREPANCIES, PRIOR TO PROCEEDING WITH THE WORK.
- 7. THE GENERAL CONTRACTOR SHALL NOT PROCEED WITH WORK FOR WHICH HE EXPECTS ADDITIONAL COMPENSATION BEYOND THE CONTRACT AMOUNT WITHOUT WRITTEN AUTHORIZATION FROM THE ARCHITECT AND OWNER. FAILURE TO OBTAIN SUCH AUTHORIZATION SHALL INVALIDATE A CLAIM FOR EXTRA COMPENSATION. THE CONTRACTOR SHALL NOT PROCEED WITH WORK WHICH. IF COMPLETED IN STRICT CONFORMANCE WITH THE CONSTRUCTION DOCUMENTS, WILL RESULT IN ADDITIONAL WORK BEYOND THE SCOPE OF THE CONTRACT WITHOUT WRITTEN AUTHORIZATION FROM THE ARCHITECT AND OWNER. ANY FIELD CONDITIONS THAT SIGNIFICANTLY VARY FROM THE CONTRACT DOCUMENTS OR WILL RESULT IN ADDITIONAL WORK, SHALL BE BROUGHT TO THE ATTENTION OF THE ARCHITECT PRIOR TO PROCEEDING WITH WORK.
- 8. DO NOT SCALE DRAWINGS. STATED & WRITTEN DIMENSIONS GOVERN. THE GENERAL CONTRACTOR SHALL VERIFY ALL DIMENSIONS IN THE FIELD AND SHALL BE RESPONSIBLE FOR THEIR ACCURACY. NO EXTRA CHARGE OR COMPENSATION SHALL BE ALLOWED BECAUSE OF DIFFERENCE BETWEEN ACTUAL DIMENSIONS AND THOSE INDICATED ON THE DRAWINGS, UNLESS THEY CONTRIBUTE TO A CHANGE IN THE SCOPE OF THE WORK. ANY DIFFERENCE FOUND SHALL BE SUBMITTED TO THE ARCHITECT FOR COORDINATION PRIOR TO ORDERING, MANUFACTURING, OR PROCEEDING WITH THE WORK. HORIZONTAL DIMENSIONS INDICATED ARE TO/FROM FACE OF FINISH, UNLESS NOTED OTHERWISE. VERTICAL DIMENSIONS ARE FROM TOP OF FLOOR SLAB EXCEPT WHERE NOTED TO BE ABOVE FINISHED FLOOR (AFF). DIMENSIONS ARE NOT ADJUSTABLE WITHOUT APPROVAL OF ARCHITECT UNLESS NOTED +/-
- 9. MATERIALS INDICATED TO BE REUSED MUST BE FREE OF DEFECTS AND BE IN GOOD CONDITION OR SHALL BE REPLACED WITH NEW. UNDER THIS CONTRACT, ANY MATERIAL INDICATED TO BE REUSED WHICH IS NOT FREE OF DEFECTS SHALL BE BROUGHT TO THE ATTENTION OF THE ARCHITECT VIA A WRITTEN REQUEST FOR INFORMATION PRIOR TO BEGINNING CONSTRUCTION.

CONTRACTORS USE OF BUILDING

- 1. CONTRACTOR IS RESPONSIBLE FOR COMPLYING WITH ALL BUILDING MANAGEMENT SECURITY
- REQUIREMENTS, INCLUDING PROJECT SITE ACCESS RULES. 2. LIMIT USE OF BASE BUILDING FOR THE WORK AND FOR CONSTRUCTION OPERATIONS, TO ALLOW CONTINUED OCCUPANCY AND USE.
- 3. CONFINE OPERATIONS WITHIN DESIGNATED STAGING AREAS AND COORDINATE USE OF BASE BUILDING FACILITIES AS APPROVED BY THE OWNER.
- 4. THIS PROJECT WILL REQUIRE WORK WITHIN THE SIDA (SECURITY IDENTIFICATION DISPLAY AREA) AREAS. THE GENERAL CONTRACTOR AND HIS SUBCONTRACTORS ARE TO HAVE PROPER SECURITY TRAINING AND CREDENTIALS AS REQUIRED AND GRANTED BY HAS. THE CONTRACTOR AND THEIR SUBS ARE TO BE AWARE OF THEIR LOCATIONS WHILE WORKING IN THESE AREAS AND PROPER BADGING MUST BE DISPLAYED AT ALL TIMES. ALL COSTS ASSOCIATED WITH OBTAINING TRAINING AND CREDENTIALS TO ACCESS THE SIDA. ARE THE RESPONSIBILITY OF THE GENERAL CONTRACTOR AND SHALL BE COMPLETED PRIOR TO COMMENCEMENT OF WORK.
- 5. COORDINATE ANY SECURITY DEVICE REMOVAL / RELOCATION WITH HAS PRIOR TO COMMENCEMENT OF WORK.
- 6. MAINTAIN PROPER PATHS AND IDENTIFICATION OF EMERGENCY EGRESS.

PROJECT GENERAL DESCRIPTION

OVERALL PROGRAM NAME:

IAH TERMINAL - SECURITY EXIT LANE

THE BASIS OF DESIGN IS TO PROVIDE AN EXIT LANE BREACH CONTROL (FLBC) SYSTEM THAT AUTOMATICALLY WATCHES PEOPLE AND OBJECTS FLOW THROUGH AIRPORT EXIT LANES (DEFINED AS A PASSENGER TRANSITION AREA CONTAINING A LINE OF DEMARCATION BETWEEN THE STERILE AND NON-STERILE AREA WHERE PASSENGERS ARE UNABLE TO RETURN WITHOUT SCREENING) AND PROVIDE AUTOMATED PHYSICAL BARRIER(S) PREVENTING ACCESS BACK INTO THE STERILE AREA

THE ELBC SYSTEM SHALL CONTINUOUSLY, SILENTLY, RELIABLY AND AUTOMATICALLY MONITORS THE EXIT LANE TO ACCURATELY DETECT PEOPLE TRAVELLING THE WRONG WAY AND OBJECTS THROWN FROM THE PUBLIC TO THE STERILE SIDE IN THE EXIT LANE WITHIN THE PROTECTED ZONES

THIS DETECTION IS ACHIEVED UTILIZING THE EXITSENTRY VIDEO ANALYTICS SYSTEM. SOPHISTICATED AND HIGHLY SPECIALIZED VIDEO ANALYTICS SOFTWARE INTEGRATED WITH COMMERCIAL OFF THE SHELF (COTS) HARDWARE, THE SYSTEM SHALL PROVIDE LOCAL & REMOTE AUDIBLE AND VISUAL NOTIFICATIONS, LIVE AND RECORDED VIDEO OF THE EVENT, AND SYSTEM CONTROL FUNCTIONS UPON THEIR DETECTION. EXITSENTRY IS THE INDUSTRY-LEADING SECURITY MONITORING AND ALARM SYSTEM. USING

AN INTERFACE VIA THE ACCESS CONTROL SYSTEM (ACS) FROM EXITSENTRY TO LAYERED CONTAINMENT MEASURES (AUTOMATIC DOORS) SHALL BE IMPLEMENTED AT THE ENTRANCE, CENTER, AND SECURE END OF THE EXIT LANE, THUS THE EXITSENTRY SYSTEM SHALL CONTROL THE CONTAINMENT AUTOMATED DOOR MEASURES THROUGH THE ACS AND PREVENT (CONTAIN) THE

LOCALLY, THE SYSTEM DEPLOYS A HIGH-DEFINITION MESSAGING LOUDSPEAKER, AUDIBLE ALARM SIGNAL AND A VISUAL STROBE FOR PASSENGER NOTIFICATIONS. SYSTEM MONITORING AND CONTROL AT THE REMOTE COMMAND TERMINAL LOCATED ADJACENT TO THE EXIT LANE.

ADVANCING BREACH, WHETHER IT INVOLVES PEOPLE OR OBJECTS (OR BOTH).

IT ALSO PROVIDES LOCAL COMMUNICATIONS FOR THE SYSTEM SHALL UTILIZE THE EXISTING AIRPORT ETHERNET NETWORK. EVENTS THROUGH OBVIOUS CHANGES CONFIGURED ON THE AIRPORT ACCESS CONTROL SYSTEM (ACS) OPERATOR CONTROL WORKSTATION(S), AND CONTROL FUNCTIONS CAN ALSO BE

CONFIGURED USING ACS OUTPUTS FOR REMOTE BYPASS, RESET AND MANUAL CONTROL OF AUTOMATIC CONTAINMENT MEASURES. VIDEO MONITORING IS PROVIDED FROM EXITSENTRY VIDEO OUTPUTS THROUGH A VIDEO PROCESSOR TO THE AIRPORT VIDEO MANAGEMENT SYSTEM (VMS). THE EXITSENTRY SYSTEM SHALL NOTIFY THE AIRPORT COMMUNICATIONS CENTER OF SYSTEM

PROJECT GENERAL NOTES

- 1. HOUSTON AIRPORT SYSTEMS (HAS) SHALL BE DESIGNATED AS "THE OWNER", PGAL ARCHITECTS SHALL BE DESIGNATED AS "THE ARCHITECT". GEORGE BUSH INTERCONTINENTAL AIRPORT (IAH) SHALL BE DESIGNATED AS "THE LANDLORD". THE GENERAL CONTRACTOR SHALL BE BOTH LICENSED AND BONDED IN TEXAS AND SHALL PROVIDE DOCUMENTS UPON REQUEST. 2. THE WORK SHALL BE DONE IN ACCORDANCE WITH THE RULES AND REGULATIONS OF ALL
- APPLICABLE SAFETY AND BUILDING CODES, AND AS APPROVED BY THE AUTHORITY HAVING JURISDICTION, INCLUDING OBSERVING ALL RULES AND REGULATIONS IN AN AIRPORT SECURE **FNVIRONMENT**
- 3. THE GENERAL CONTRACTOR IS RESPONSIBLE FOR SECURING AND PAYING FOR ALL PERMITS REQUIRED FOR THE WORK AND FOR THE SCHEDULING OF ALL REQUIRED INSPECTIONS DURING THE COURSE OF THE WORK.
- 4. THE CONTRACTOR SHALL VERIFY THAT THE DRAWINGS ARE THE LATEST ISSUE BEFORE COMMENCING CONSTRUCTION.

HAS STANDARDS

- 1. THIS PROJECT IS TO FOLLOW HOUSTON AIRPORT SYSTEM (HAS) STANDARDS FOR ALL DISCIPLINES. HAS STANDARDS CAN BE FOUND AT THEIR WEBSITE, HTTP://WWW.HOUSTONAIRPORTS/BIZ/TIP. 2. ANY CONFLICTS BETWEEN HAS STANDARDS AND BID/CONSTRUCTION DOCUMENTS ARE TO BE
- BROUGHT TO THE ARCHITECTS ATTENTION VIA RFI. 3. ANY FLOOR PENETRATION WILL NEED TO BE X-RAY SCANNED. THIS INCLUDES BUT NOT LIMITED TO FLOOR ANCHORS, CORE, ETC. ALL SCANS ARE TO BE SUBMITTED TO HAS / EOR FOR REVIEW BEFORE WORK CAN BE PERFORMED.
- 4. THE CONTRACTOR SHALL THOROUGHLY EXAMINE THE PREMISES AND SHALL BASE THE BID ON THE EXISTING CONDITIONS IN CONJUNCTION WITH THESE DOCUMENTS. THE CONTRACTOR SHALL NOTIFY THE ARCHITECT PRIOR TO THE BID OF ANY DISCREPANCIES FOUND WITH THESE DOCUMENTS OR CONFLICTS WITH EXISTING CONDITIONS VIA WRITTEN REQUEST FOR
- 5. PRIOR TO BEGINNING ANY CONSTRUCTION OR DEMOLITION, THE CONTRACTOR SHALL VERIFY THE GENERAL LAYOUT AND EXACT LAYOUT OF ALL WAYFINDING AND SIGNAGE AND REPORT ANY QUESTIONS OR DISCREPANCIES TO THE ARCHITECT FOR RESOLUTION VIA A WRITTEN REQUEST FOR INFORMATION.

FACILITIES

- 1. CORE DRILLING. THE CONTRACTOR SHALL SCAN THE AREA PRIOR TO CORE DRILLING OF CONCRETE STRUCTURES. THE CONTRACTOR SHALL USE THE GROUND PENETRATING RADAR (GPR) METHOD. THE CONTRACTOR SHALL SUBMIT A COPY OF THE GPR RESULTS TO AIRPORT STAFF, PRIOR TO CORE DRILLING, VERIFYING THAT THE AREA IS CLEAR OF CONDUITS/REBAR/PORT TENSION TENDONS/ETC.
- 2. HOT WORK PERMIT. THE CONTRACTOR SHALL OBTAIN A HOT WORK PERMIT FROM THE AIRPORT FOR WELDING, CUTTING, GRINDING, OR ANY OTHER ACTIVITY INVOLVING OPEN FLAMES. SPARKS. OR OTHER IGNITION SOURCES THAT MAY CAUSE SMOKE. FIRE, OR CAN TRIGGER THE FIRE

AIRSIDE / LANDSIDE

- 1. THE CONTRACTOR SHALL NOT BLOCK THE TERMINAL PASSENGER PATHS AND SHALL NOT BLOCK THE TSA CHECKPOINT AREAS.
- 2. THE CONTRACTOR SHALL MAINTAIN THE PATH OF TRAVEL TO AND FROM THE WORK AREA IN A CLEAN MANNER. THE CONTRACTOR SHALL CLEAN THE PATH OF TRAVEL, AS NEEDED AND REMOVE ANY DUST/DEBRIS FROM THE PATH OF TRAVEL.

SECURITY

- 1. HAS APPROVAL OF THE REQUIRED "SECURITY PLAN" IS REQUIRED PRIOR TO THE START OF ANY WORK, THE SECURITY PLAN MUST BE SUBMITTED TO HAS FOR REVIEW AND APPROVAL. THE "SECURITY PLAN" SHALL INCLUDE BUT IS NOT LIMITED TO THE FOLLOWING:
- DATES AND TIME OF WORK
- CONTRACTOR NAME & CONTACT INFORMATION BADGING OF CONSTRUCTION PERSONNEL
- SUMMARY OF WORK, INCLUDING ATTACHED PLAN
- PERSONNEL & VEHICLE SECURITY CLEARANCE INFORMATION
- PERSONNEL & VEHICLE ACCESS INFORMATION. SHOW ALL PENETRATIONS OF THE SECURITY BOUNDARY. DESIGNATED ROUTE FOR WORKERS TO ACCESS VARIOUS WORK AREAS MUST BE
- PROVIDED & APPROVED. IDENTIFY THE PATH OF TRAVEL TO THE WORK SITE AND IDENTIFY ANY ELEVATORS AND OR DOORS TO BE USED TO ACCESS THE SITE.
- CONSTRUCTION DEBRIS SHOW HOW CONSTRUCTION DEBRIS WILL BE DISPOSED OF OR TRANSPORTED OFF SITE SHOW PROPOSED LAYDOWN AREAS
- CONTACT AIRPORT SECURITY COMPLIANCE FOR TIMELINES FOR SUBMISSION AND COORDINATION OF WORK UNDER TSA GUIDELINES THE CONTRACTOR SHALL ATTEND A PRE-CONSTRUCTION MEETING PRIOR TO THE START OF WORK

CLIENT



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ARCHITECT



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AVIATION DEPARTMENT

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DRAWING HISTORY DESCRIPTION 09-09-21 FOR INFORMATION AND REFERENCE ONLY

PROJECT NAME IAH-TERMINAL -**SECURITY EXIT** LANE

PROJECT LOCATION


GEORGE BUSH IAH 3500 NORTH TERMINAL RD. HOUSTON, TX 77032

PROJECT NUMBER

1004345 SHEET TITLE

GENERAL PROJECT INFORMATION

SHEET NUMBER

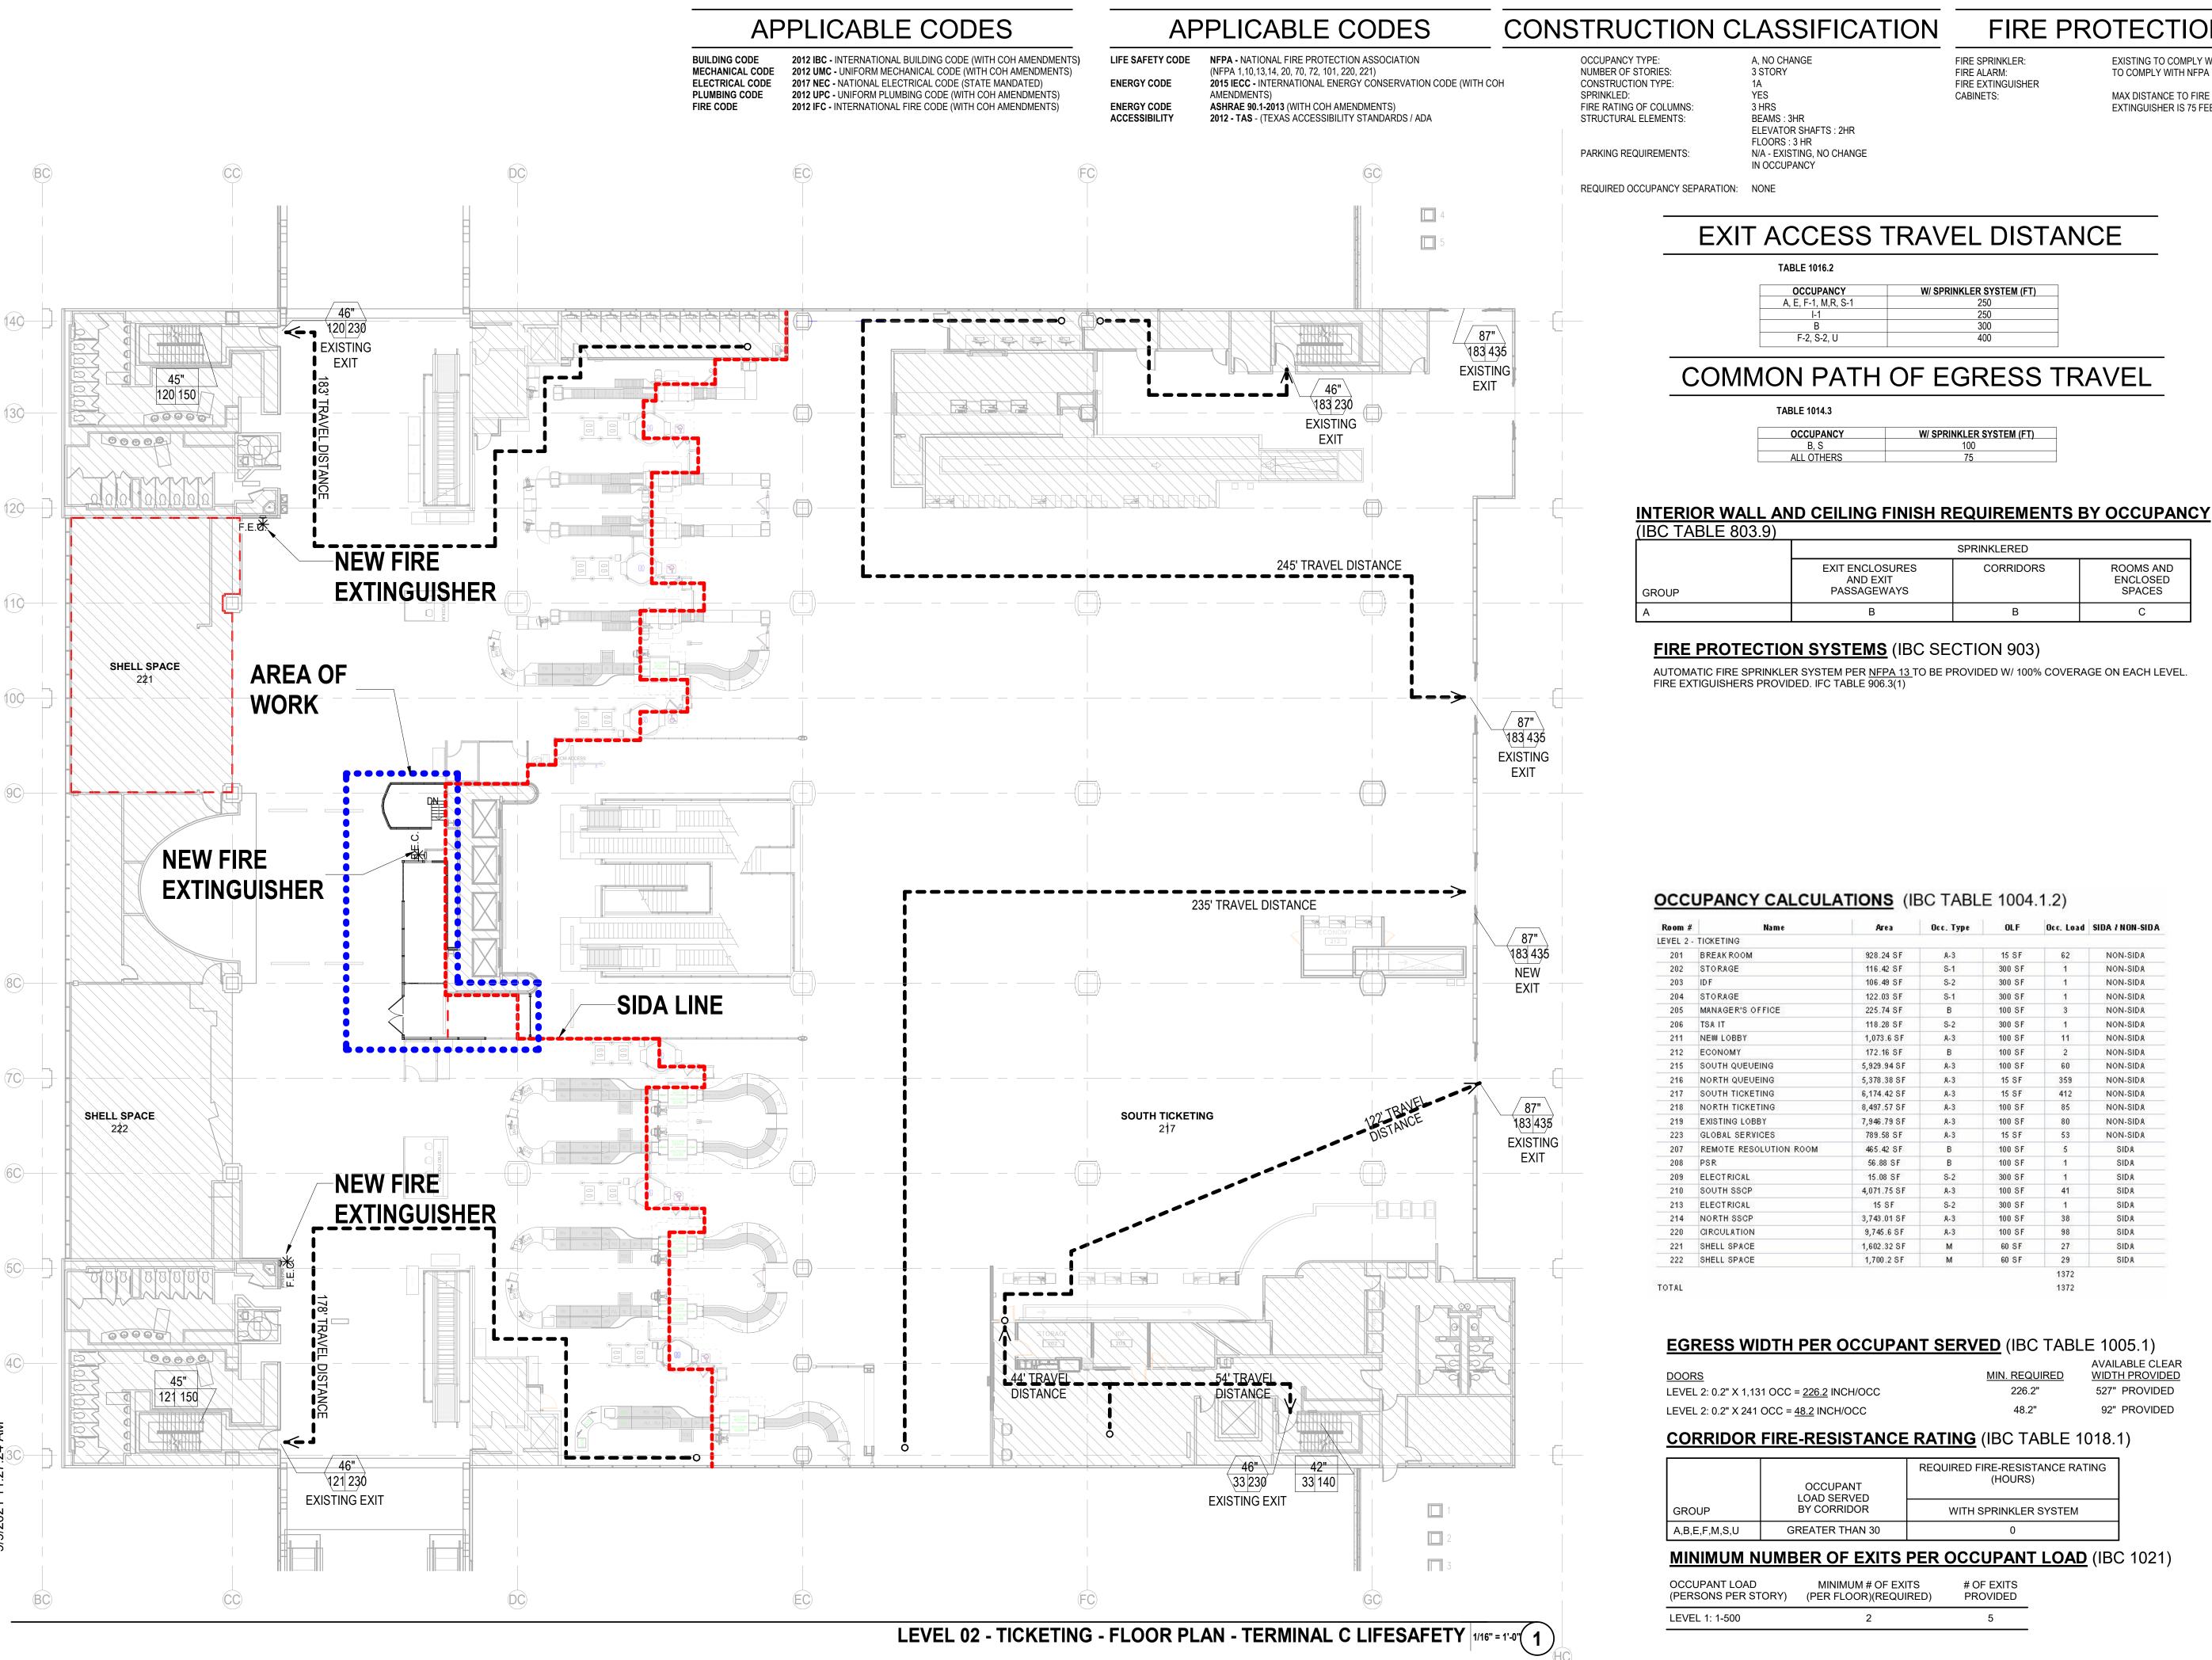

110-

CONSTRUCTION CLASSIFICATION

TABLE 1016.2

OCCUPANCY

A, E, F-1, M,R, S-1

F-2, S-2, U

TABLE 1014.3

OCCUPANCY

ALL OTHERS

EXIT ENCLOSURES

AND EXIT

PASSAGEWAYS

EXIT ACCESS TRAVEL DISTANCE

W/ SPRINKLER SYSTEM (FT)

W/ SPRINKLER SYSTEM (FT)

SPRINKLERED

CORRIDORS

A, NO CHANGE 3 STORY YES FIRE RATING OF COLUMNS: STRUCTURAL ELEMENTS:

3 HRS BEAMS: 3HR **ELEVATOR SHAFTS: 2HR** FLOORS: 3 HR N/A - EXISTING, NO CHANGE IN OCCUPANCY

FIRE PROTECTION

FIRE SPRINKLER: **EXISTING TO COMPLY WITH NFPA 13** TO COMPLY WITH NFPA 72 FIRE ALARM: FIRE EXTINGUISHER CABINETS:

ROOMS AND

ENCLOSED

SPACES

MAX DISTANCE TO FIRE EXTINGUISHER IS 75 FEET

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CLIENT

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DRAWING HISTORY

PROJECT NAME IAH-TERMINAL -**SECURITY EXIT** LANE

PROJECT LOCATION GEORGE BUSH IAH **3500 NORTH** TERMINAL RD. HOUSTON, TX 77032

PROJECT NUMBER 1004345

SHEET TITLE LIFE SAFETY ANALYSIS

SHEET NUMBER

G003

Room #	Name	Area	Occ. Type	OLF	Occ. Load	SIDA / NON-SIDA
EVEL 2 -	TICKETING					
201	BREAKROOM	928.24 SF	A-3	15 SF	62	NON-SIDA
202	STORAGE	116.42 SF	8-1	300 SF	1	NON-SIDA
203	IDF	106.49 SF	8-2	300 SF	1	NON-SIDA
204	STORAGE	122.03 SF	S-1	300 SF	1	NON-SIDA
205	MANAGER'S OFFICE	225.74 SF	В	100 SF	3	NON-SIDA
206	TSA IT	118.28 SF	8-2	300 SF	1	NON-SIDA
211	NEW LOBBY	1,073.6 SF	A-3	100 SF	11	NON-SIDA
212	ECONOMY	172.16 SF	В	100 SF	2	NON-SIDA
215	SOUTH QUEUEING	5,929.94 SF	A-3	100 SF	60	NON-SIDA
216	NORTH QUEUEING	5,378.38 SF	A-3	15 SF	359	NON-SIDA
217	SOUTH TICKETING	6,174.42 SF	A-3	15 SF	412	NON-SIDA
218	NORTH TICKETING	8,497.57 SF	A-3	100 SF	85	NON-SIDA
219	EXISTING LOBBY	7,946.79 SF	A-3	100 SF	80	NON-SIDA
223	GLOBAL SERVICES	789.58 SF	A-3	15 S F	53	NON-SIDA
207	REMOTE RESOLUTION ROOM	465.42 SF	В	100 SF	5	SIDA
208	PSR	56.88 SF	В	100 SF	1	SIDA
209	ELECTRICAL	15.08 SF	8-2	300 SF	1	SIDA
210	SOUTH SSCP	4,071.75 SF	A-3	100 SF	41	SIDA
213	ELECTRICAL	15 SF	8-2	300 SF	1	SIDA
214	NORTH SSCP	3,743.01 SF	A-3	100 SF	38	SIDA
220	CIRCULATION	9,745.6 SF	A-3	100 SF	98	SIDA
221	SHELL SPACE	1,602.32 SF	М	60 SF	27	SIDA
222	SHELL SPACE	1,700.2 SF	М	60 SF	29	SIDA

EGRESS WIDTH PER OCCUPANT SERVED (IBC TABLE 1005.1)

<u>DOORS</u>	MIN. REQUIRED	AVAILABLE CLEAR WIDTH PROVIDED
LEVEL 2: 0.2" X 1,131 OCC = <u>226.2</u> INCH/OCC	226.2"	527" PROVIDED
LEVEL 2: 0.2" X 241 OCC = 48.2 INCH/OCC	48.2"	92" PROVIDED

CORRIDOR FIRE-RESISTANCE RATING (IBC TABLE 1018.1)

	OCCUPANT LOAD SERVED	REQUIRED FIRE-RESISTANCE RATING (HOURS)
GROUP	BY CORRIDOR	WITH SPRINKLER SYSTEM
AREEMSII	GREATER THAN 30	0


MINIMUM NUMBER OF EXITS PER OCCUPANT LOAD (IBC 1021)


CUPANT LOAD ERSONS PER STORY)	MINIMUM # OF EXITS (PER FLOOR)(REQUIRED)	# OF EXITS PROVIDED
VEL 1: 1-500	2	5

ALL METAL STUDS TO BE 20 ga. AND PLACED AT 16 INCHES 0.C. UNLESS NOTED OTHERWISE OR WHERE THE LIMITING HEIGHT REQUIRES 16ga AT 16" 1. ALL FURRING CHANNELS TO BE 25 ga. AND PLACED AT 16 INCHES 0.C. UNLESS NOTED OTHERWISE.


COLD FORMED FRAMING NOTES

- 2. PARTITIONS SUPPORTING WALL HUNG PLUMBING FIXTURES SHALL BE
- 16 ga. AND PLACED 16 INCHES O.C.
- 3. REFER TO STRUCTURAL DRAWINGS FOR STUD ga. SIZE AND SPACING FOR ALL STRUCTURALLY DESIGNED PARTITIONS.
- 4. REFER TO ASTM C754 FOR LIMITING HEIGHTS CRITERIA. LIMITING HEIGHTS ARE TO BE DETERMINED BY DEFLECTION CRITERIA RATIO OF <u>L/240</u>, AND LATERAL PRESSURE OF <u>5 PSF</u> UNLESS NOTED OTHERWISE OR DICTATED OTHERWISE BY PRESIDING BUILDING CODE. WHERE FLOOR TO STRUCTURE HEIGHT OF PARTITION EXCEEDS THE INDICATED LIMITING HEIGHT. PROVIDE SUPPLEMENTAL BRACING TO THE STRUCTURE OVERHEAD AS REQUIRED TO MAINTAIN REQUIRED DEFLECTION RATIO.
- FOR PARTITIONS WITH "BRITTLE" FINISHES SUCH AS PLASTER AND CERAMIC TILE, DESIGN PARTITION SYSTEM TO MAINTAIN DEFLECTION RATIO WITHIN L/360. SUSPENDED CEILINGS SHALL NOT BE CONSIDERED AS BRACING.

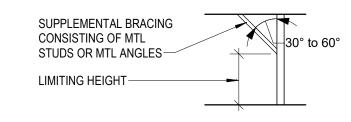

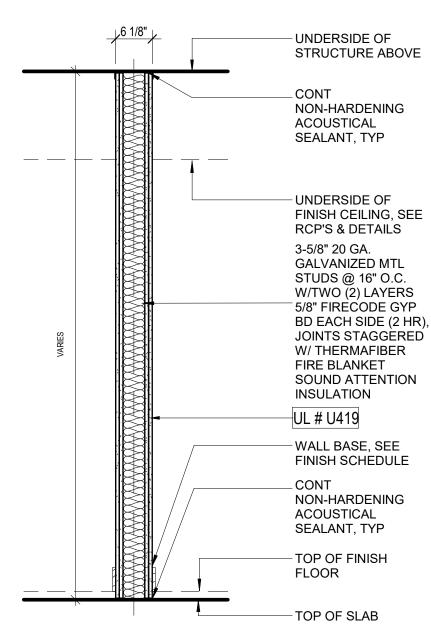



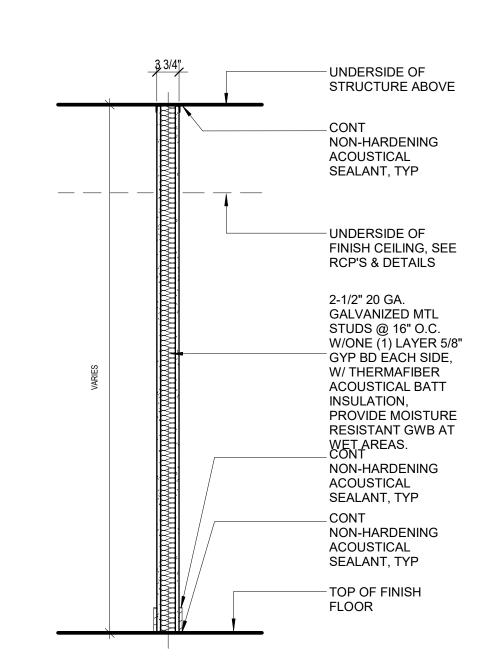

B1.1 NON-RATED PARTITION 2-1/2" STUD1 3/4" = 1'-0" 1

B7.1 FURRING WALL PARTITION 3-5/8" STUD | 3/4" = 1'-0" (4)

UNDERSIDE OF

STRUCTURE ABOVE

CONT NON-HARDENING

ACOUSTICAL SEALANT,

UNDERSIDE OF FINISH CEILING, SEE RCP'S &

3-5/8" 20 GA. GALVANIZED

MTL STUDS @ 16" O.C.

W/ONE (1) LAYER 5/8"

GYPSUM BOARD, W/

ACOUSTICAL BATT

INSULATION, PROVIDE

MOISTURE RESISTANT

GWB AT WET AREAS.

EXISTING COLUMN /

WALL BASE, SEE FINISH

CONT NON-HARDENING

ACOUSTICAL SEALANT,


TOP OF FINISH FLOOR

PARTITION

SCHEDULE

THERMAFIBER

DETAILS

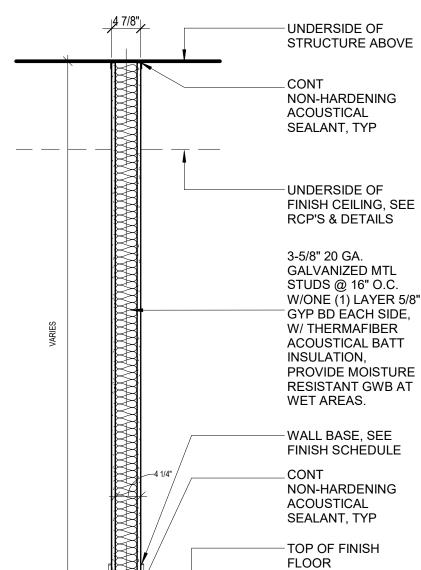


B1.3 NON-RATED PARTITION 3-5/8" STUD1 3/4" = 1'-0" (3)

ACOUSTICAL NOTES

- 1. ALL ACOUSTICALLY CLASSED PARTITIONS SHALL BE CONSTRUCTED IN STRICT ACCORDANCE TO THE REFERENCED TEST.
- 2. STAGGER AND SEAL ALL JOINTS ON MULTIPLE GYPSUM BOARD LAYER PARTITIONS.
- 3. SEAL ALL PERIMETER GAPS, AIR TIGHT, AT THE FLOORS, HEAD, ADJACENT CONSTRUCTION AND AROUND ANY PENETRATING ELEMENTS WITH INTERIOR GRADE ACOUSTICAL SEALANT.
- 4. ALL BATTS AND BLANKETS IN RATED WALLS MUST BEAR THE REQUIRED U.L. CLASSIFICATION MARKING AS TO FIRE-RESISTANCE. ALSO REFER TO CODE COMPLIANCE DETAILS IN G010 SERIES.
- 5. AT ACOUSTICALLY RATED PARTITIONS, DO NOT FILL THE STUD CAVITY (DEPTH) FULLY WITH SOUND BATTS. THE WIDTH OF THE SOUND BATTS SHOULD BE SLIGHTLY SMALLER THAN CAVITY TO AVOID BATTS COMPRESSION. HOWEVER, THE ENTIRE LENGTH AND HEIGHT OF THE WALL SHOULD HAVE CONTINUOUS AND UNINTERRUPTED SOUND ATTENUATION BATTS.
- 6. SEAL ALL WALL INTERSECTIONS AND CONTROL JOINTS AT ACOUSTICALLY **CLASSED PARTITIONS**
- 7. SEAL ALL CONDUIT, STRUCTURAL, DUCT AND LARGE PIPE PENETRATIONS UNLESS THE PARTITION IS ALSO FIRE RATED WHERE THE CODE COMPLIANCE DETAILS
- 8. OUTLETS ON OPPOSITE SIDES OF ACOUSTICALLY CLASSED PARTITIONS

FIREWALL CONTROL JOINTS

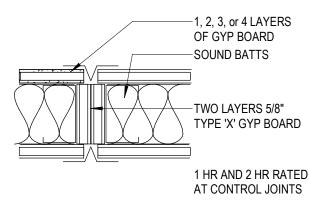

FIRE RATING NOTES


- 1. UNDERWRITERS LABORATORY AND OTHER TESTING AGENCY DESIGNATIONS INDICATED FOR FIRE RESISTIVE CONSTRUCTION ARE GIVEN FOR PURPOSES OF DESCRIBING CONSTRUCTION REQUIREMENTS ONLY AND ARE NOT INTENDED TO LIMIT MANUFACTURERS OF MATERIALS. COMPLY WITH THE CONSTRUCTION REQUIREMENTS OF THE INDICATED DESIGN.
- 2. ALL PARTITION TYPES SHOWN HERE ARE DRAWN AS "NON FIRE-RATED". WHERE FIRE RESISTIVE WALL CONSTRUCTION IS INDICATED, ON THE FLOOR PLANS, PROVIDE "TYPE X" GYPSUM WALLBOARD. AND FIRE RATED SEALANT AT PERIMETER JOINTS AND ALL PENETRATIONS, TYPICAL BOTH SIDES OF PARTITION AS INDICATED ON THE U.L. DETAILS AND ASSEMBLIES.
- 3. REFER TO SHEET G010 FOR U.L. LISTED ASSEMBLIES.

GYPSUM BOARD PARTITION PRIORITY LEGEND

PARTITION	DOOR RATING	PRIORITY
FOUR HOUR FIRE PARTITION	3 HOUR - A LABEL	PRIORITY 1 - HIGHEST
TWO HOUR FIRE/SMOKE PARTITION	1 1/2 HOUR - B LABEL	PRIORITY 2
TWO HOUR FIRE PARTITION	1 1/2 HOUR - B LABEL	PRIORITY 3
ONE HOUR FIRE/SMOKE PARTITION	3/4 HOUR - C LABEL	PRIORITY 4
ONE HOUR FIRE PARTITION	3/4 HOUR - C LABEL	PRIORITY 5
ONE HOUR FIRE PARTITION	20 MIN RATING	PRIORITY 6
NON-RATED PARTITION	NONE	PRIORITY 7 - LOWEST

GENERAL NOTES

- 1. ALL POSSIBLE VARIATIONS OF PARTITIONS TYPES AND <u>U.L. FIRE RATINGS ARE NOT</u> NECESSARILY UTILIZED IN THIS PROJECT AND ARE SHOWN FOR REFERENCE ONLY UNLESS RATED PARTITIONS ARE INDICATED ON THE FLOOR PLANS. WHERE U.L. RATED PARTITIONS ARE INDICATED, REFER TO FLOOR PLANS AND PROVIDE FIRE SEALANT AT THOSE LOCATIONS AS REQUIRED.
- 2. WHERE FULL HEIGHT PARTITIONS ARE PERPENDICULAR TO SPAN OF STRUCTURAL JOISTS OR GIRDERS, THE PARTITION SHALL EXTEND TO THE UNDERSIDE OF STRUCTURE AND FOLLOW THE LINE OF STRUCTURE.
- 3. PROVIDE CEMENTITIOUS BACKER BOARD ON ALL WALLS TO RECEIVE CERAMIC TILE FINISH. PROVIDE WATER RESISTANT GYPSUM PANELS ON CEILINGS IN ROOMS THAT INCLUDE SHOWERS. FRAMING NOT TO EXCEED SPACING RECOMMENDED BY MANUFACTURER.
- 4. PROVIDE ONE LAYER OF 5/8" MOISTURE RESISTANT GYPSUM BOARD AT WALLS BEHIND SINKS AND LAVATORIES WITHOUT TILE. MOISTURE RESISTANT GYPSUM BOARD SHALL BE INSTALLED WITHIN 2' OF ALL URINALS AND WATER CLOSETS, TO A HEIGHT OF 4' AFF.
- 5. WHERE FIRE RESISTIVE CONSTRUCTION IS INDICATED, PROVIDE TYPE X-W/R BOARD. IN CONDITIONS WHERE NOTE 3 AND 4 APPLY, INSTALL 1 LAYER OF APPLICABLE MOISTURE RESISTANT BOARD OR CEMENTITIOUS BACKER BOARD OVER THE TYPE X-W/R BOARD. INSTALL PER MANUFACTURER LIMITATIONS.
- 6. STC RATINGS SHOWN FOR SOUND WALLS ARE BASED ON LABORATORY TESTED ASSEMBLIES AND DO NOT NECESSARILY INDICATE THE ACTUAL STC RATING OF THE COMPLETED WORK. PROVIDE MTL. DECK FILLERS WHERE FULL HEIGHT PARTITIONS ARE PERPENDICULAR TO SPAN OF DECK. DECK FILLERS ARE TO BE COMPATIBLE WITH ALL FIRE RATED ASSEMBLIES AND ARE TO BE APPROVED BY ALL GOVERNING
- 7. PROVIDE FIRE TREATED WOOD BLOCKING, SHEET METAL OR STEEL BACKING IN PARTITIONS TO SUPPORT WALL MOUNTED ITEMS AND EQUIPMENT, ETC.
- 8. REFER TO SPECIFICATIONS FOR ADDITIONAL INFORMATION.

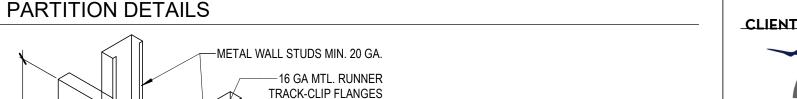

-MIN. 20 GA. MTL.

STUDS FACING

DIRECTIONS TO

-ALLOW MOUNTING

PLATE ATTACHMENT

FLANGES AND FOLD

ATTACHMENT FLANGE

-MIN. 20 GA. MTL.

-3 5/8" MIN. DEEPER

16 GA MTL. RUNNER

FLANGES TO FIT

TRACK-CLIP

OVER STUDS

IF REQUIRED

STUDS

8" MIN. DEEPER IF

REQUIRED

TO FIT OVER STUDS

METAL WALL -

TYPE B

STUDS MIN. 20 GA.

CONT. 16 GA. X 4"

WIDE MTL. BACK-UP

STUDS

PLAN SECTION 🚣

DETAIL A

SCALE: NONE

PARTITION AT MULLION DETAILS

MOUNTING HEIGHTS

MOUNTING SUPPORT DETAILS

GRAB BAR BRACKET SHOWN, OTHER DEVICES SIMILAR.

REFER

PROVIDE IN-WALL BRACING IN ALL PARTITIONS OR EXTERIOR WALLS WHERE

GRAB BARS, HANDRAILS, SHOWER SEATS OR OTHER EQUIPMENT ANCHORS TO

METAL STUD WALLS AND IN OTHER LOCATIONS AS NOTED ON THE DRAWINGS.

GRAB BAR

EQUAL

-EXISTING WINDOWS TO REMAIN.

-1/4" GAP TYP. BETWEEN END AND

- IF SPANDREL GLASS, INSTALL BLACK

IF VISION GLASS, LEAVE GAP UNSEALED.

-DRYWALL MOLDING END CLOSURE BY FRY

NEOPRENE GASKET.

REGLET OR EQUAL.

NOTE: EDGE ELEVATION OF PARTITION SHALL MATCH

OR MASONRY. 1/4" GAP MAX FOR ENTIRE HEIGHT.

-EXISTING WINDOWS TO REMAIN

BETWEEN FRAME AND END

-PARTITION AS SCHEDULED

REGLET OR EQUAL

COMPRESS BLACK NEOPRENE GASKET

-CENTER PARTITION ON MULLION, TYP.

-DRYWALL MOLDING END CLOSURE BY FRY

THE EDGE OF THE EXISTING WINDOW FRAME, GLAZING,

-PARTITION AS SCHEDULED.

CENTER STUDS ABOUT THE LOCATION OF THE DEVICE ANCHOR POINT.

IN-WALL BRACING SHALL BE NO LESS THAN A 6" x 1 1/4" x 14 GUAGE CHANNEL, STEEL Fy = 50ksi, AND SHALL SUPPORT A 250 POUND GRAVITY LOAD CONCENTRATED AT ANY POINT ON THE DEVICE BEING ANCHORED.

16 GA.x4" WIDE MTL BACKUP PLATE MAY BE USED

IN-WALL BRACING



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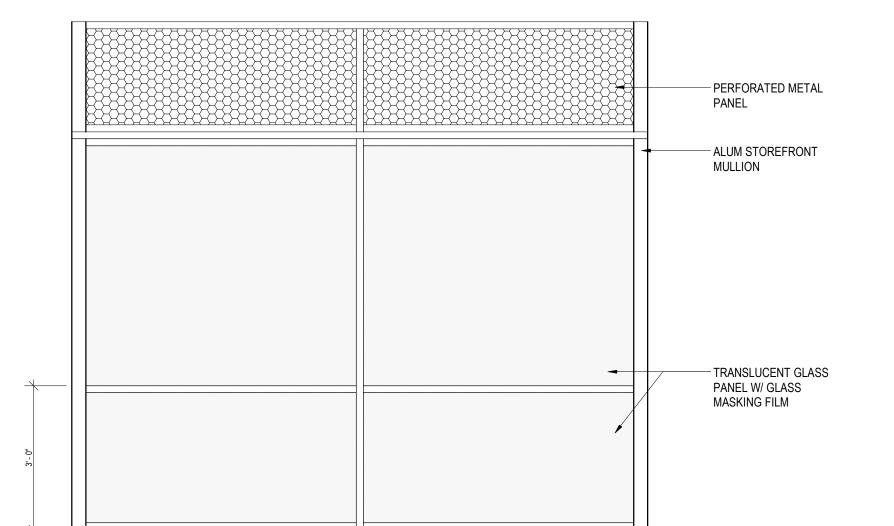
PROJECT NAME IAH-TERMINAL -**SECURITY EXIT** LANE

PROJECT LOCATION GEORGE BUSH IAH 3500 NORTH TERMINAL RD. HOUSTON, TX 77032

PROJECT NUMBER 1004345

SHEET TITLE **PARTITION TYPES**

SHEET NUMBER



UNDERSIDE OF STRUCTURE ABOVE CONT NON-HARDENING
ACOUSTICAL SEALANT,
TYP GYP BD SHALL NOT CONTINUE TO UNDERSIDE OF SLAB AT DROP CEILING CONDITIONS, SEE RCPS — ALUM TOP RAIL, BLOCKING AS REQ, TYP AL/GL PARTITION SYSTEM
W/ 1/4" CLEAR TEMPERED
GLASS, BLOCKING AS — SPECIALTY GRAPHICS FDC 3500 SERIES FROSTED ETCHED GLASS FILM, ONE SIDE — ALUM BOTTOM RAIL, BLOCKING AS REQ. — AL/GL PARTITION SYSTEM W/ 1/4" CLEAR TEMPERED GLASS, BLOCKING AS REQ. CONT NON-HARDENING ACOUSTICAL SEALANT, TOP OF FINISH FLOOR

FULL HEIGHT STOREFRONT W/ GLASS & METAL INFILL 3/4" = 1'-0" 2

CLIENT

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DRAWING HISTORY

PROJECT NAME IAH-TERMINAL -SECURITY EXIT LANE


PROJECT LOCATION GEORGE BUSH IAH 3500 NORTH TERMINAL RD. HOUSTON, TX 77032

PROJECT NUMBER 1004345

SHEET TITLE STOREFRONT **TYPES**

SHEET NUMBER

A012

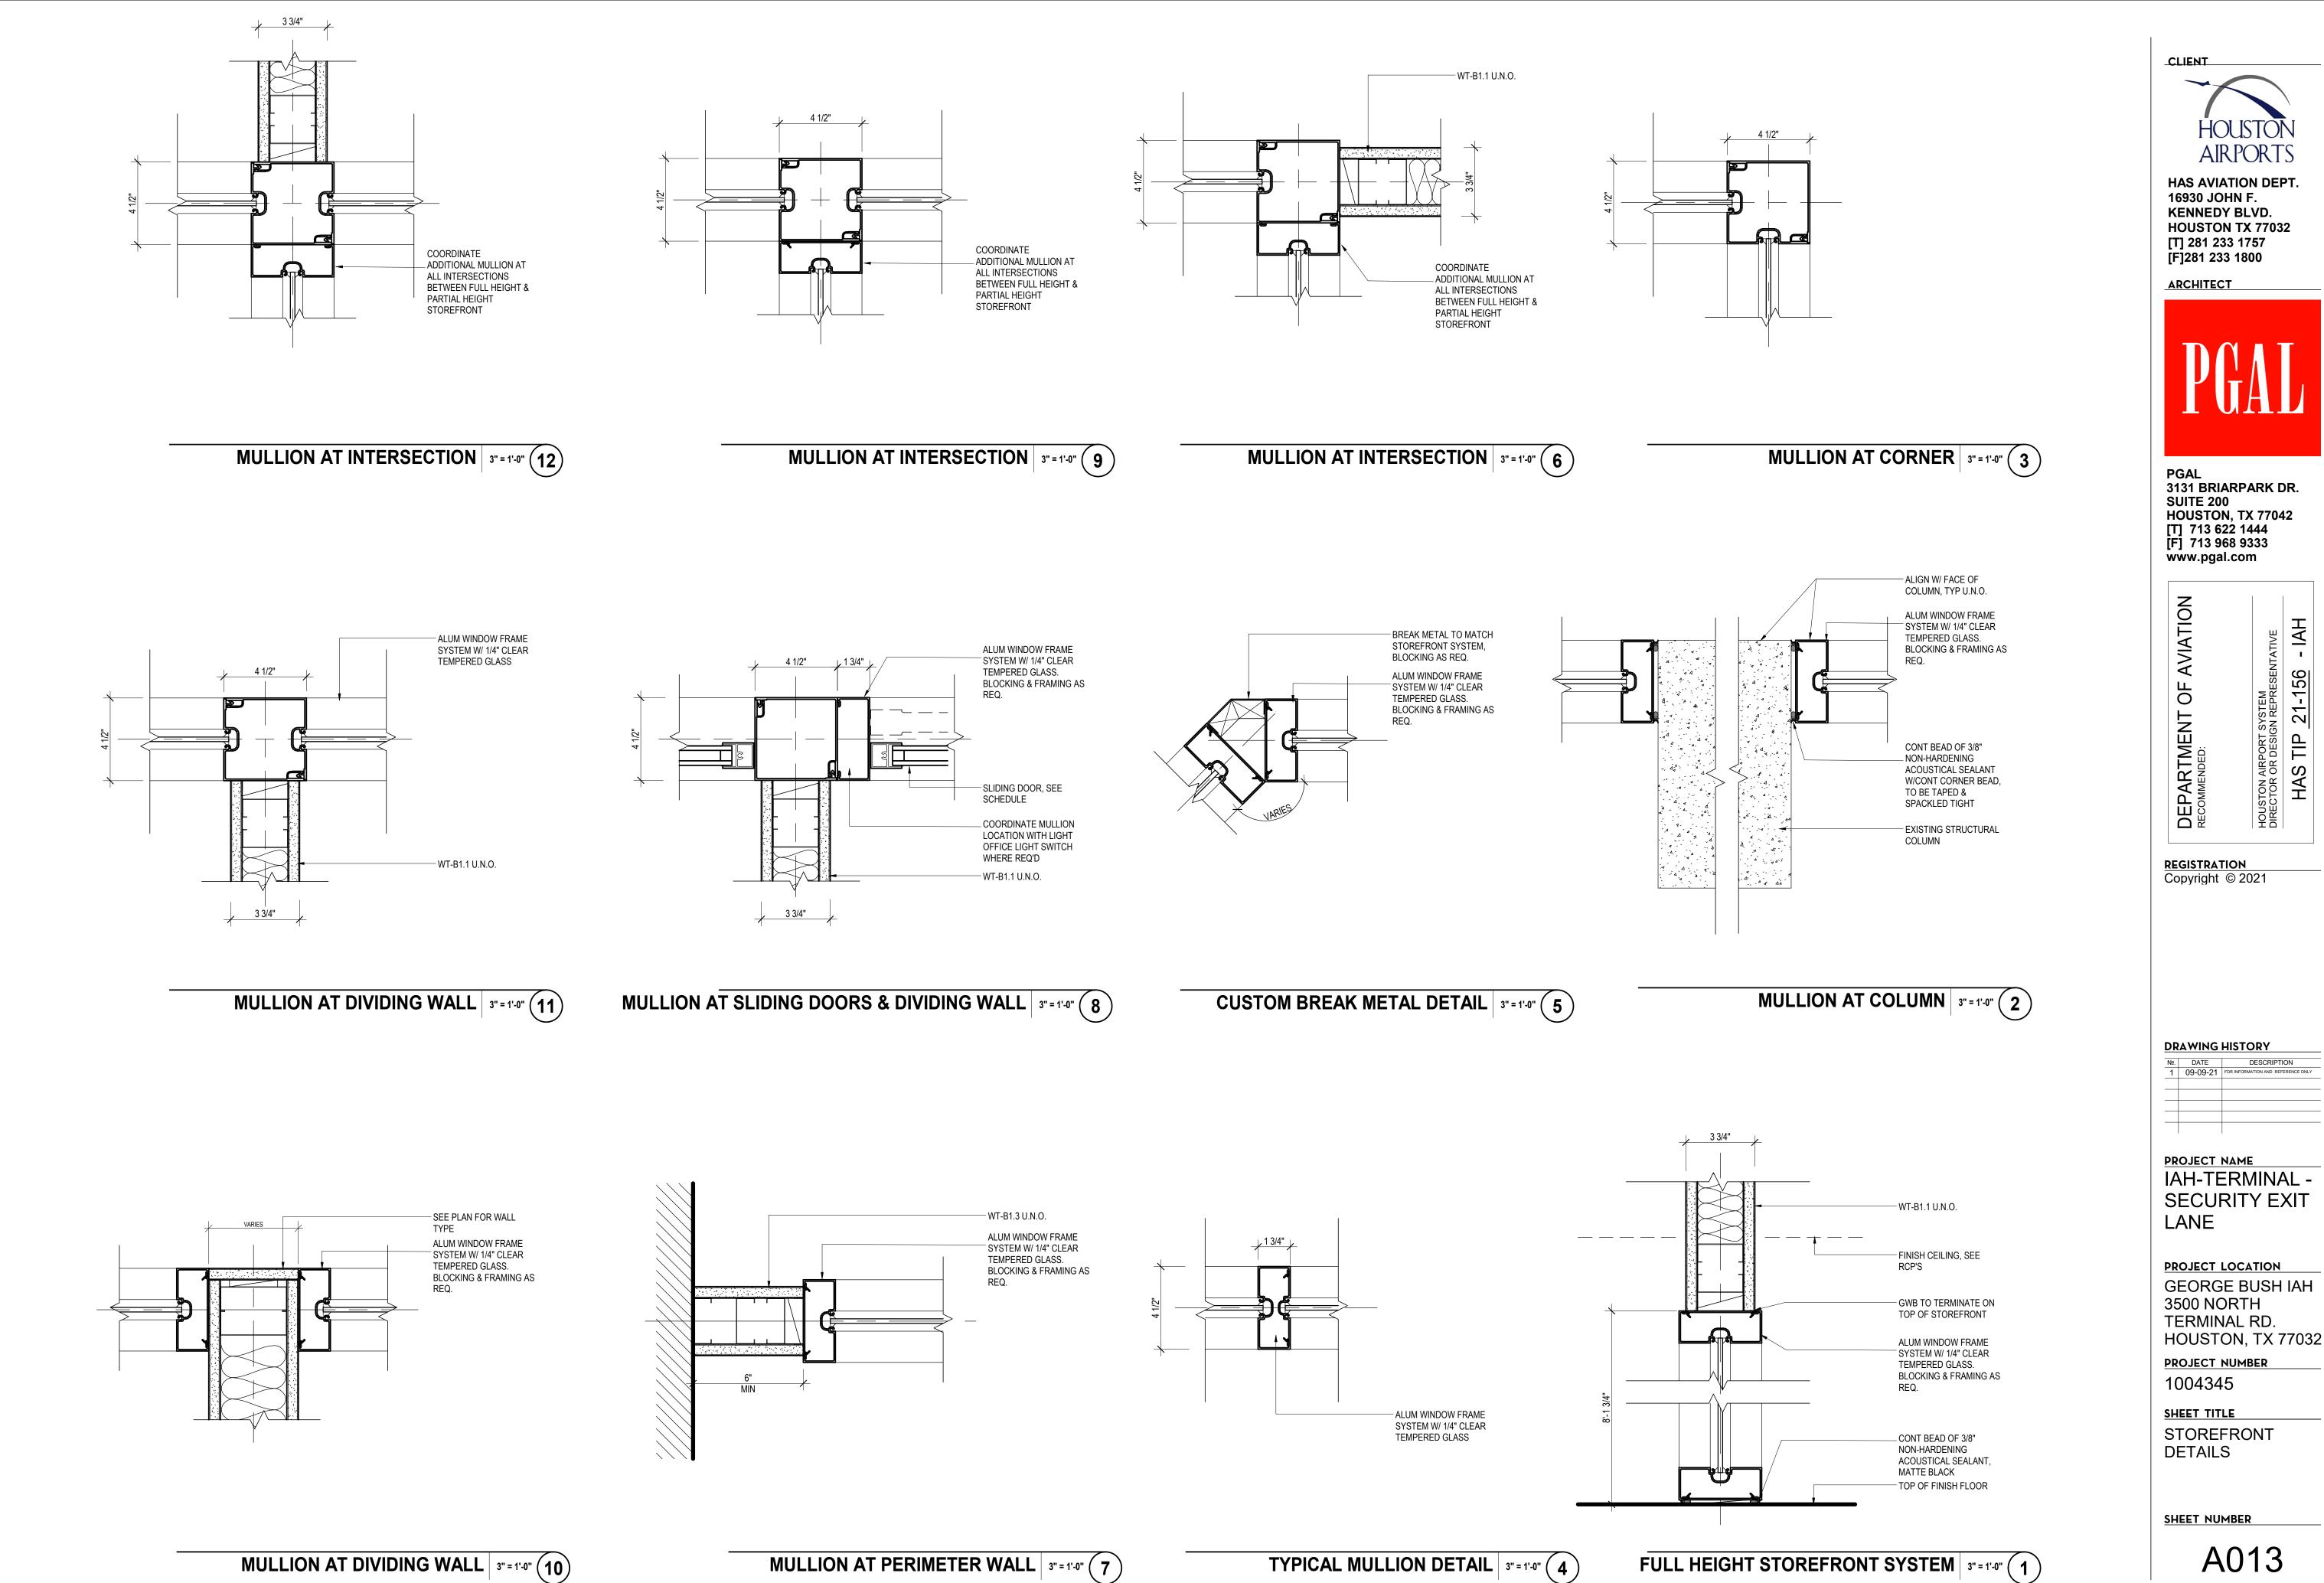


A013


DESCRIPTION

DOOR SCHEDULE

	Room Name	Panel					Frame					General			
			Size								Details on A0.35	UNO	Fire		
Mark	Room Name	Width	Height	THK	Matl	Panel	Finish	Matl	Туре	Finish	Jamb Head	Sill	Rating	HDWR	Remarks
LEVEL 02	- TICKETING DEPARTURES														
112	ELECTRIC PRE ALARM ZONE	8'-0"	7'-0"	1/2"	GL	MS	GL1	AL	002	PT1					
113	EXIT ALARM ZONE 01	8'-0"	7'-0"	1/2"	GL	DS	GL1	AL	002	PT1					
114	EXIT ALARM ZONE 02	8'-0"	7'-0"	1/2"	GL	MS	GL1	AL	002	PT1					
115	ELECTRICAL CHASEWAY	2'-8"	7'-0"	1/2"	GL	SS	GL1	AL	002	PT1					
116	EXIT ALARM ZONE 02	8'-0"	7'-0"	1/2"	GL	MS	GL1	AL	002	PT1					

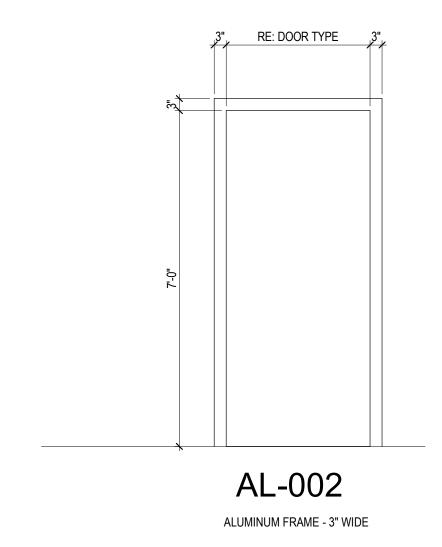



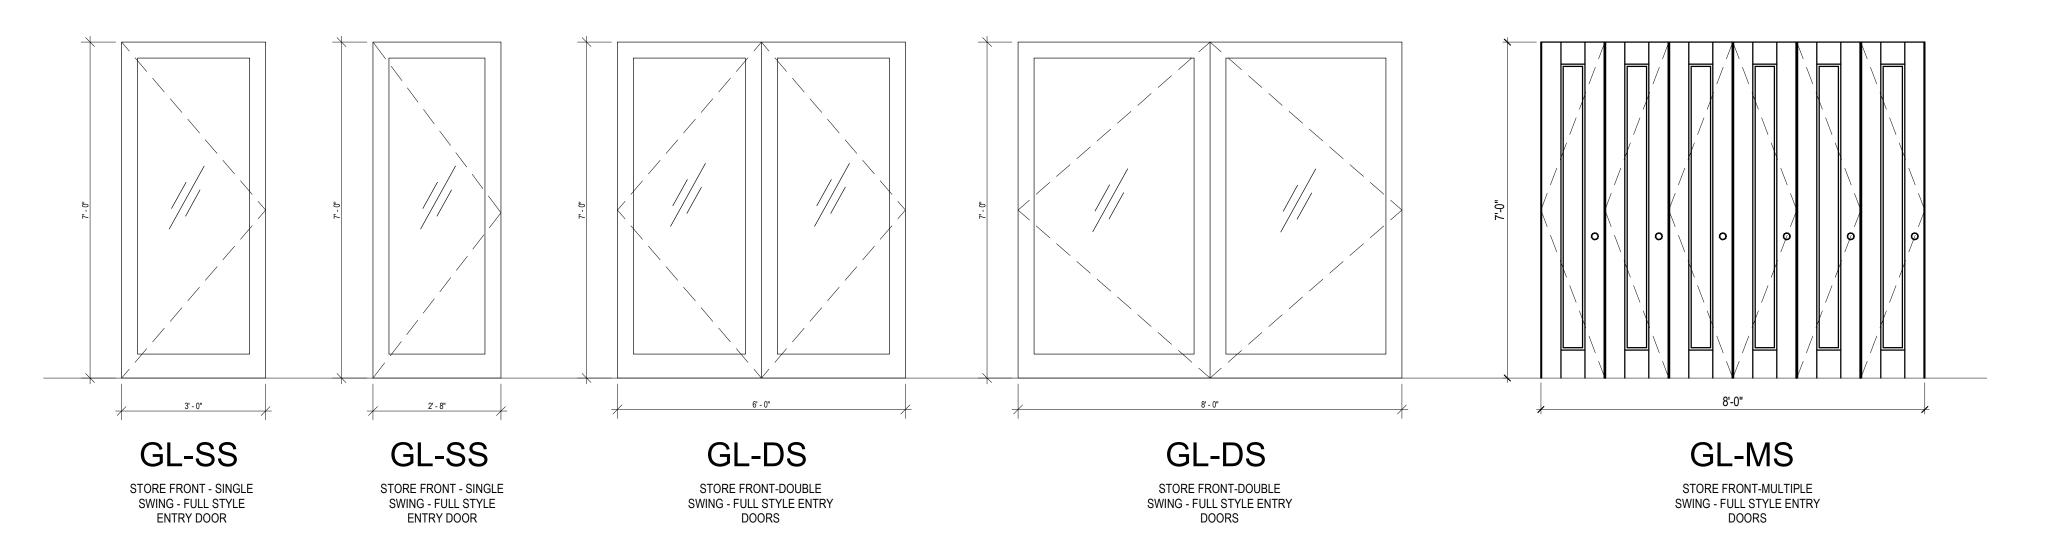


DOOR TYPES 1/2" = 1'-0" (1)

GENERAL NOTES

- A. PROVIDE UNDERCUT AS REQUIRED FOR THRESHOLD MECHANICAL REQUIREMENTS. B. PROVIDE TEMPERED GLASS WHERE REQUIRED BY CODE.
- C. PROVIDE SILICONE SEALANT OVER BACKER ROD AT ALL EXTERIOR FRAMES. D. REFER TO SPECIFICATIONS FOR ADDITIONAL INFORMATION. E. ALL HOLLOW METAL FRAMES TO BE WELDED FRAMES.
- F. SEE SHEETS A0.020 FOR FINISHES AND MATERIAL LEGENDS. G. USE GRAY GASKETS AT ALL GLASS DOORS UNLESS NOTED OTHERWISE. H. ALL ALUMINUM DOOR FRAMES TO BE CLEAR ANODIZED AS SPECIFIED U.N.O. I. ALL EXIT HARDWARE TO BE TIED TO FIRE ALARM SYSTEM

DOOR PANEL LEGEND

SINGLE DOOR

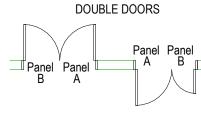

PANEL "A" WILL ALWAYS BE FROM LEFT HINGE SWINGING OUTWARD.



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DOOR PANEL MATERIALS

AL - Aluminum

WD - Wood

GL - Glass

PL - Plastic Laminate

DOOR PANEL TYPES

F - Flush Panel, Single DF - Flush Panel, Double

SS - Storefront Panel, Single DS - Storefront Panel, Double

MS - Storefront Panel, Multiple (More than 2)

FRAME MATERIALS

AL - Aluminum **HM** - Hollow Metal

WD - Wood **DT** - Detention Grade Steel

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FRAME CONFIGURATION

Transom: **0** - No Transom 1 - Transom

0 - No Sidelite

1 - 1 Sidelite

Frame Config: 1 - 2" Jamb/Head Wraps Wall

2 - 2 Sidelites, 1 each side or both

2 - 2" Jamb/Head, Mfr Standard 3 - 2" Jamb, 4" Head, Masonry 5 - Transom & Sidelites Both Sides 6 - Sidelite On Either Side

7 - ---8 - ---

H - Overhead Frame M - 4" Jamb/Head, Masonry W - Welded Wire

Frame Legend: X ### -Frame Configuration -Side Lite -Transom

A030

DOOR LEGEND | 1/8" = 1'-0" 2

DRAWING HISTORY

PROJECT NAME IAH-TERMINAL -SECURITY EXIT LANE


PROJECT LOCATION GEORGE BUSH IAH

3500 NORTH TERMINAL RD. HOUSTON, TX 77032


PROJECT NUMBER 1004345


SHEET TITLE DOOR SCHEDULE

SHEET NUMBER

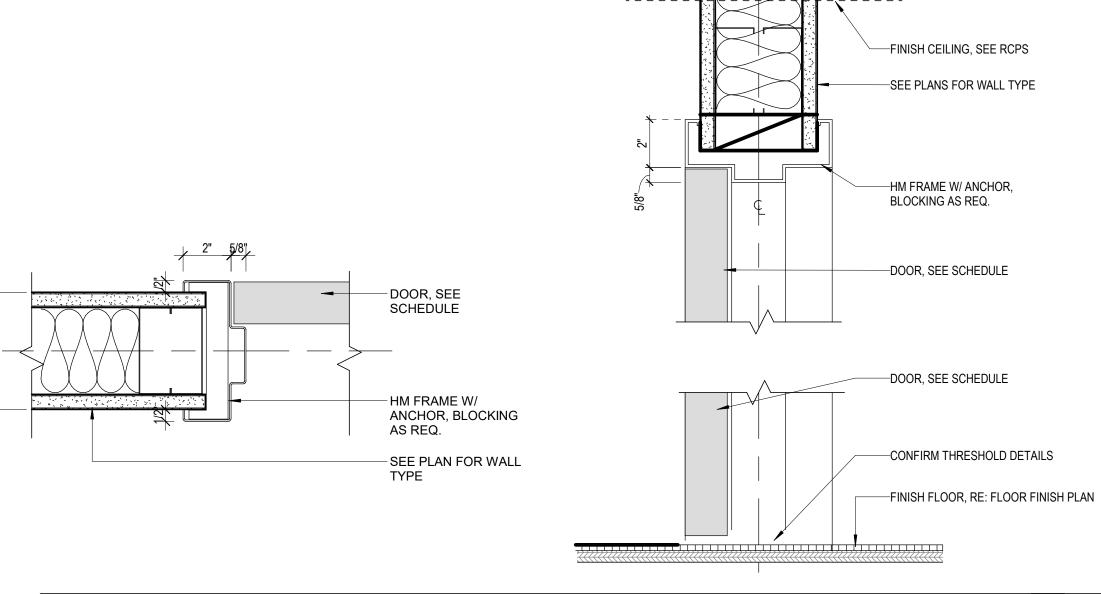

FR3 - HOLLOW METAL FRAME TYPE 3" = 1'-0" (3)

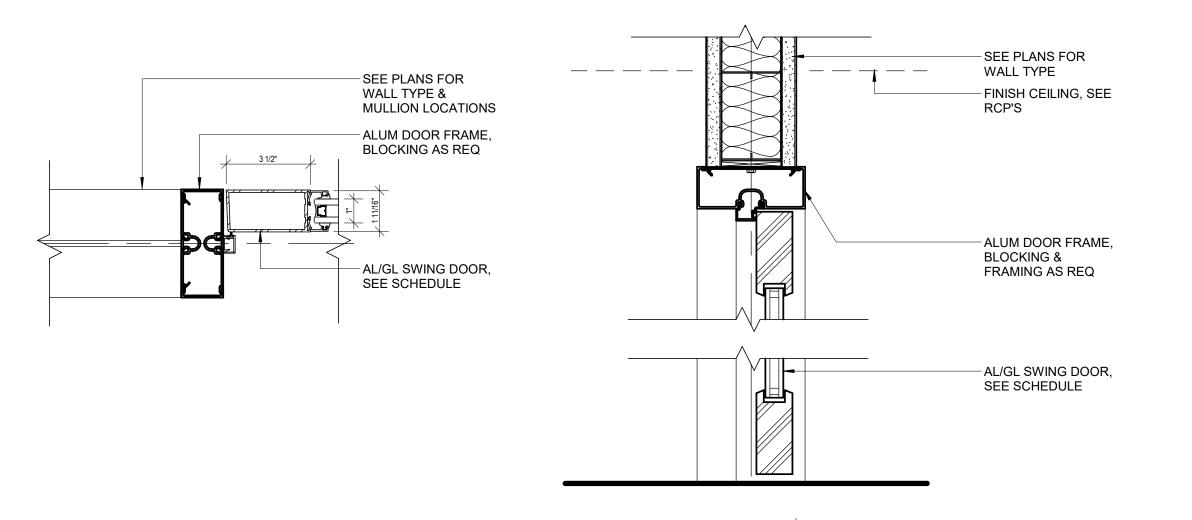

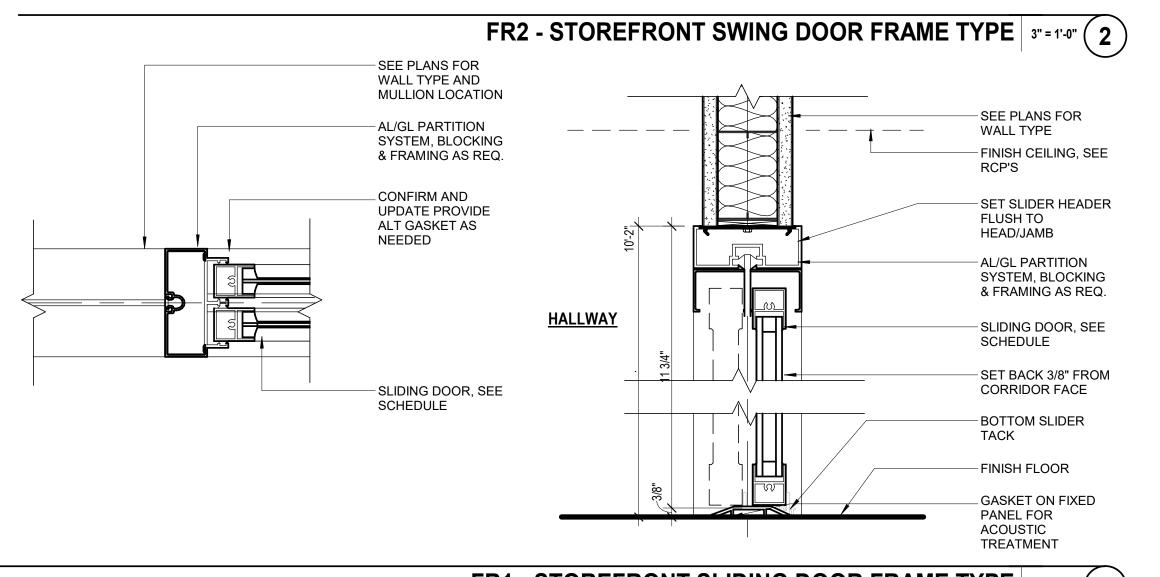

FR1 - STOREFRONT SLIDING DOOR FRAME TYPE 3" = 1'-0" 1

CLIENT

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DEPARTMENT OF AVIATION
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HAS TIP 21-156 - IAH

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DRAWING HISTORY

No. DATE DESCRIPTION
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PROJECT NAME
IAH-TERMINAL SECURITY EXIT
LANE


PROJECT LOCATION
GEORGE BUSH IAH
3500 NORTH
TERMINAL RD.
HOUSTON, TX 77032

PROJECT NUMBER 1004345

SHEET TITLE
DOOR DETAILS

SHEET NUMBER

A035

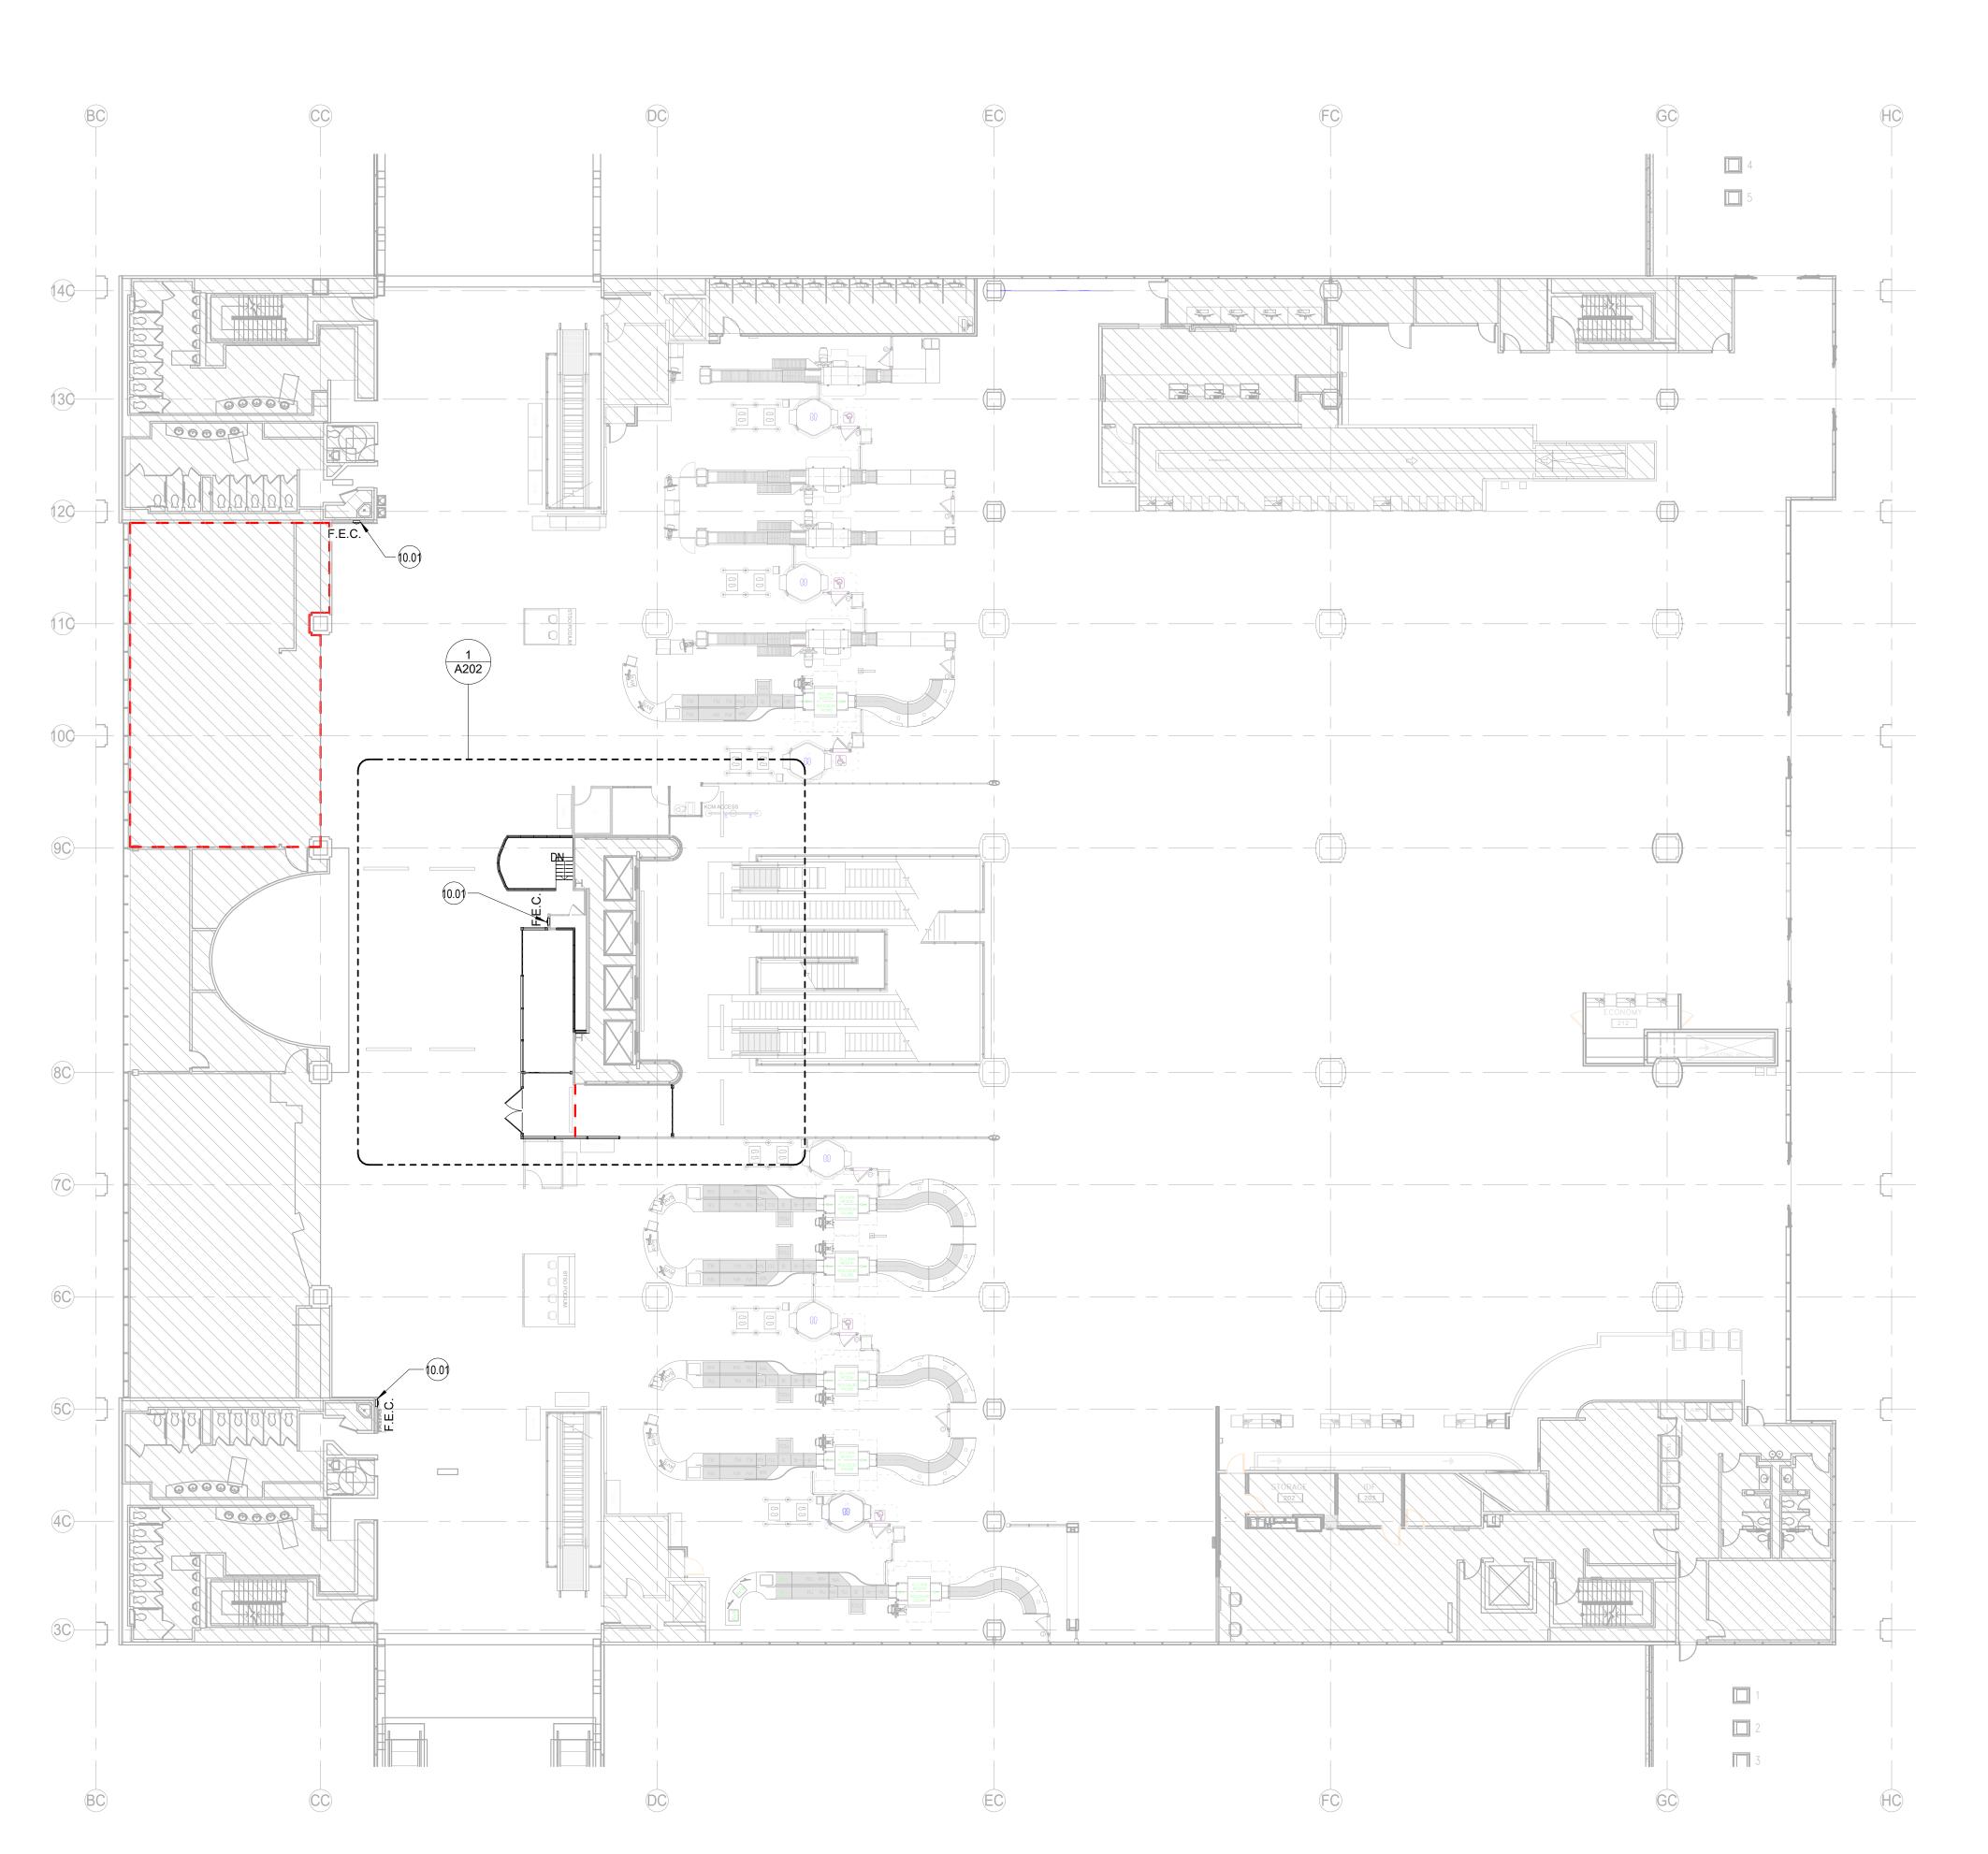

GENERAL NOTES

- DO NOT SCALE DIMENSIONS FROM DRAWINGS, ANY UNKNOWN DIMENSION SHALL BE OBTAINED FROM DESIGN PROFFESIONALS VIA REQUEST FOR INFORMATION (RFI).
- 2. CONTRACTOR SHALL FIELD VERIFY ALL EXISTING CONDITIONS PRIOR TO COMMENCING WORK.
- COMMENCING WORK.

 3. CONTRACTOR SHALL NOTIFY ARCHITECT OF ANY DISCREPANCY, INCACURACY OR CONFLICTING INFORMATION BEFORE EXECURTION OF WORK.
- OR CONFLICTING INFORMATION BEFORE EXECUTION OF WORK.

 4. REFER TO WALL PARTITION/STOREFRONT TYPES SHEET A011 FOR ADDTIONAL INFORMATION.
- 5. REFER TO ENLARGED ELEVATIONS AND AXO ON SERIES SHEETS A400.

LEGEND



VIEW REFERENCE CALLOUT



NOT INCLUDED IN SCOPE OF WORK

KEYNOTE LEGEND

NUMBE

DESCRIPTION

D.01 PRO

PROVIDE NEW RECESSED MOUNTED FIRE EXTINGUISHER CABINET, REPAIR EXISTING FINISHES AS NEEDED

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LANE

PROJECT LOCATION

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PROJECT NUMBER

1004345
SHEET TITLE

OVERALL FLOOR
PLAN - TERMINAL C
CENTRAL

SHEET NUMBER

A102

GENERAL NOTES - PLAN

- DO NOT SCALE DIMENSIONS FROM DRAWINGS, ANY UNKNOWN DIMENSION SHALL BE OBTAINED FROM DESIGN PROFESSIONALS VIA REQUEST FOR INFORMATION (DE)
- INFORMATION (RFI).
 2. CONTRACTOR SHALL FIELD VERIFY ALL EXISTING CONDITIONS PRIOR TO
- COMMENCING WORK.

 3. CONTRACTOR SHALL NOTIFY ARCHITECT OF ANY DISCREPANCY, INACCURACY
- OR CONFLICTING INFORMATION BEFORE EXECUTION OF WORK.


 4. REFER TO WALL PARTITION/STOREFRONT TYPES SHEET A011 FOR ADDTIONAL
- 5. REFER TO ENLARGED ELEVATIONS AND AXO ON SERIES SHEETS A400.
- 6. REFER TO DOOR SCHEDULES AND DOOR TYPES SHEET A030.
- 7. ALL SHAFT PENETRATING SLAB SHALL BE RATED 2H.
- 8. CONTRACTOR SHALL FIELD COORDINATE LOCATION, SIZE AND TYPE OF BLOCKING FOR INSTALLATION OF SIGNAGE, MILLWORK, ETC. ALL CONCEALED WOOD SHALL BE FIRE RETARDANT TREATED (FRT).

GENERAL NOTES

- CONTRACTOR TO INSURE PROPER EXITING AT AL TIMES DURING PHASING.
 PHASED WORK AND NIGHT HOURS, AS ALLOWED BY HAS, WILL BE REQUIRED AS
- A SCOPE OF THE WORK.

 3. THE WORK AREA SHALL BE LOCKED AND SECURED PER HAS AND TSA SECURITY REQUIREMENTS
- 4. PHASING PLANS SHOWN ARE GENERAL IN NATURE. THE CONTRACTOR IS TO PROVIDE AND MAINTAIN A DETAILED WORK PHASING PLAN FOR HAS/PGAL APPROVAL.

LEGEND

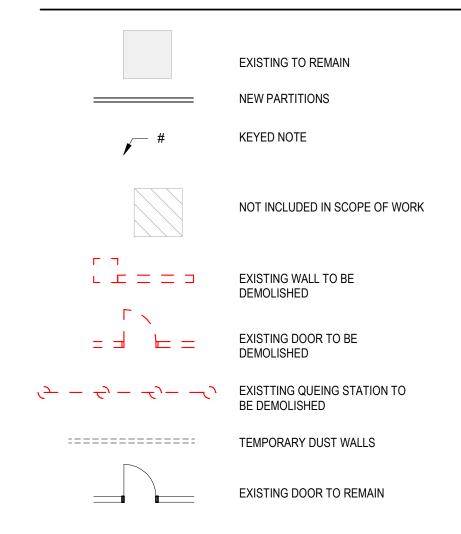

PHASING PLAN KEYNOTES

02.22 PHASE TWO: INSTALL NEW DUST WALL. FIRE TREATED WOOD FRAME AND PLYWOOD, PAINTED WHITE TO PUBLIC SIDE. WALLS TO BE LOCKABLE.

PHASE THREE: DEMO WALLS SCOPE INSIDE THE WORK AREA.

PHASE FOUR: INSTALL NEW WORK PER SCOPE – TEST & CLOSEOUT.

SCOPE OF NEW WORK

CLIENT



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DRAWING HISTORY

DRAWING HISTORY

DATE DESCRIPTION

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PROJECT NAME
IAH-TERMINAL SECURITY EXIT
LANE

PROJECT LOCATION

GEORGE BUSH IAH 3500 NORTH TERMINAL RD. HOUSTON, TX 77032

PROJECT NUMBER 1004345

001010

SHEET TITLE

ENLARGED FLOOR


PLAN - TERMINAL C

CENTRAL -

PHASING PLAN
SHEET NUMBER

AP202


LEVEL 02 - TICKETING - FLOOR PLAN - TERMINAL C - PHASING PLAN 3/16" = 1'-0" 1

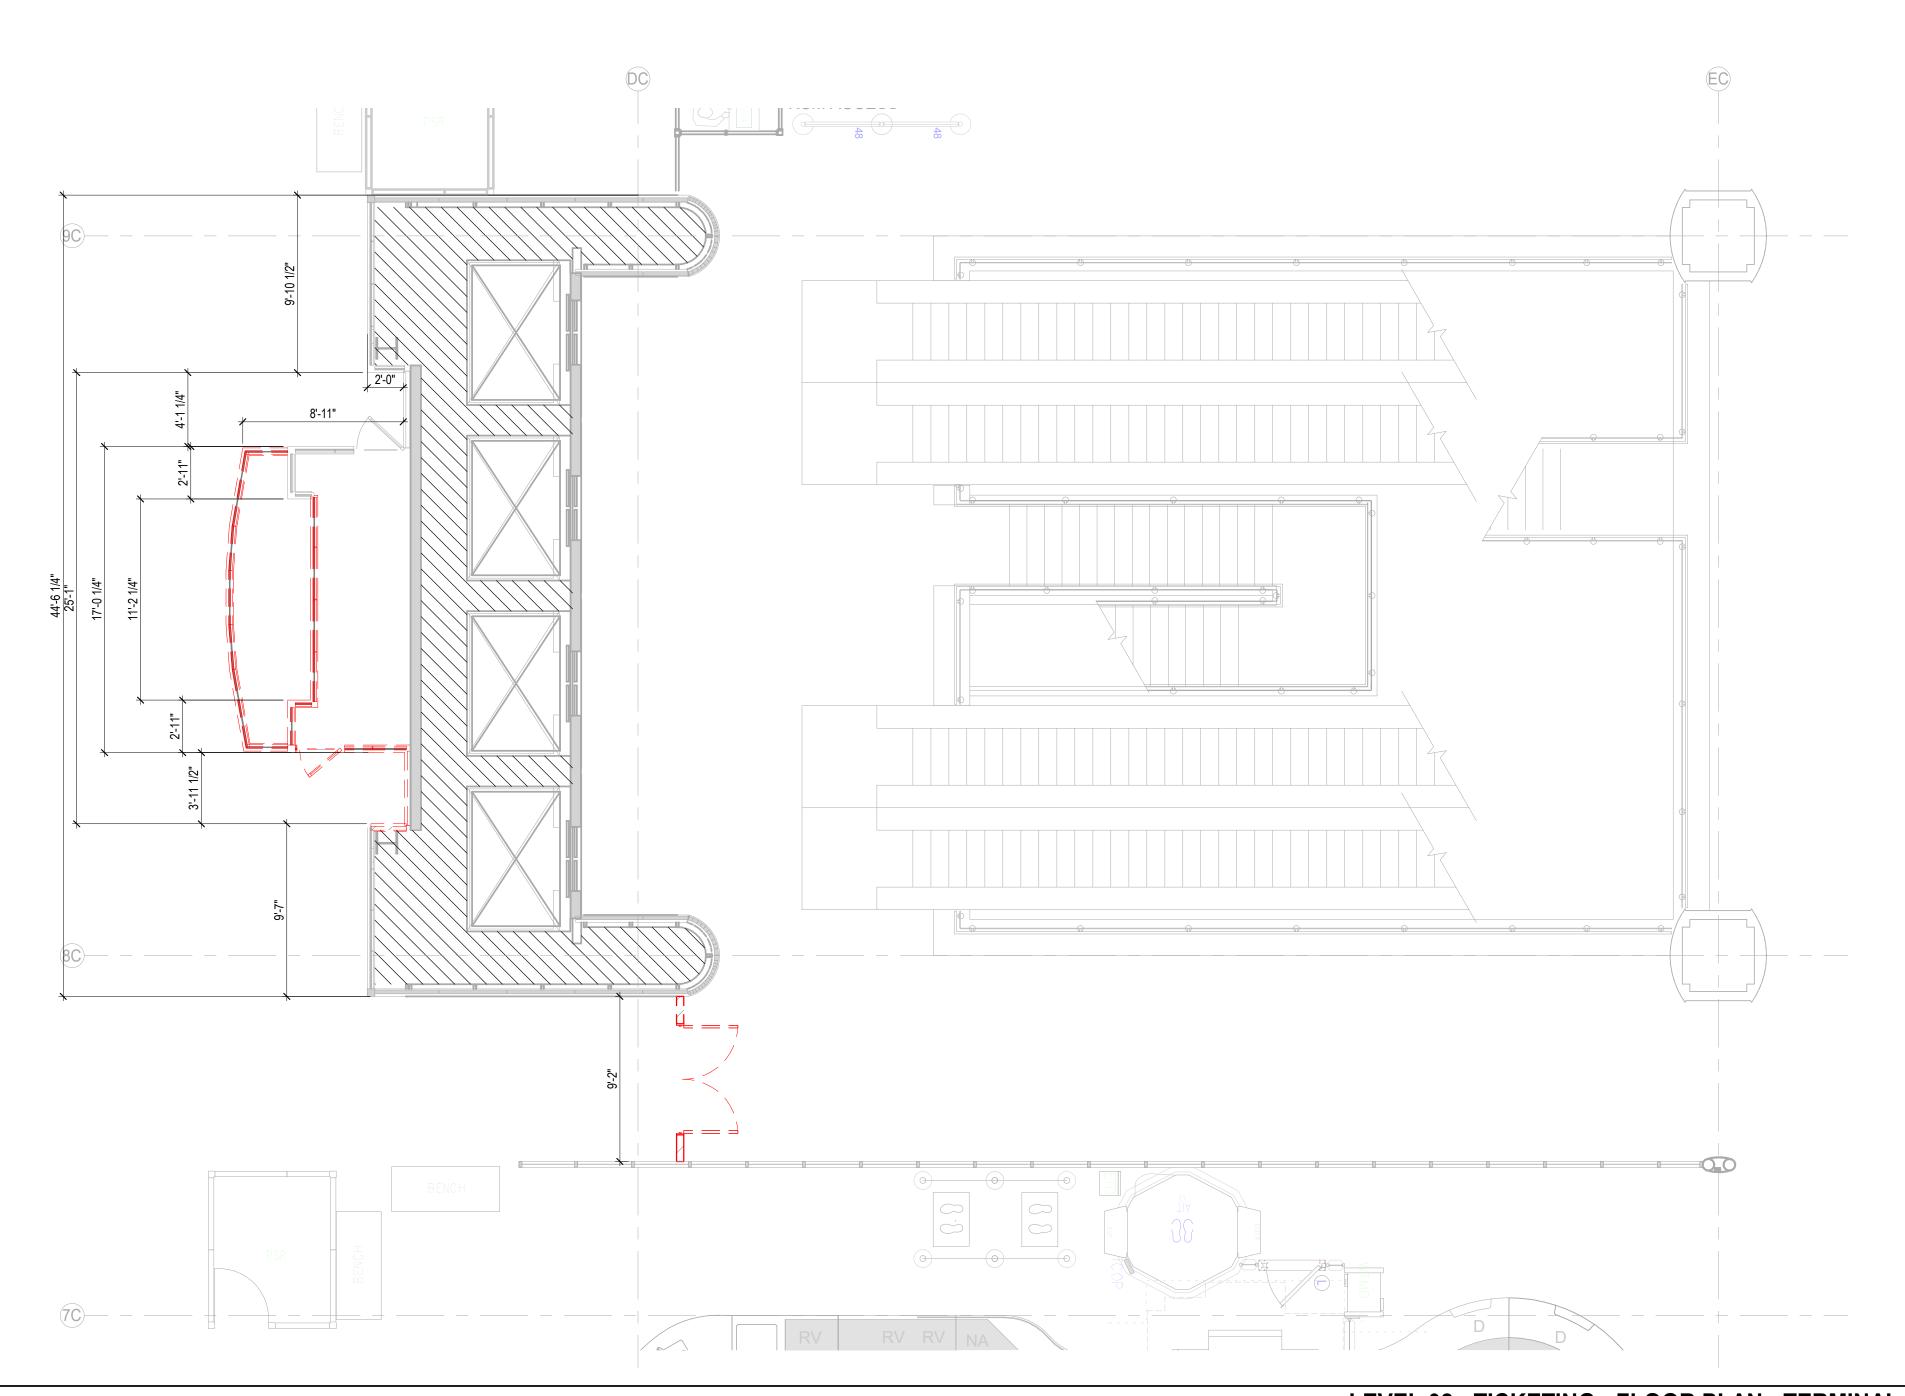

GENERAL NOTES - DEMO

- 1. DO NOT SCALE DIMENSIONS FROM DRAWINGS, ANY UNKNOWN DIMENSION SHALL BE OBTAINED FROM DESIGN PROFFESIONALS VIA REQUEST FOR INFORMATION (RFI).
- 2. CONTRACTOR SHALL FIELD VERIFY ALL EXISTING CONDITIONS PRIOR TO
- COMMENCING WORK. 3. CONTRACTOR SHALL NOTIFY ARCHITECT OF ANY DISCREPANCY, INCACURACY
- OR CONFLICTING INFORMATION BEFORE EXECURTION OF WORK. REFER TO WALL PARTITION/STOREFRONT TYPES SHEET A011 FOR ADDTIONAL INFORMATION.
- 5. REFER TO ENLARGED ELEVATIONS AND AXO ON SERIES SHEETS A400. 6. REFER TO DOOR SCHEDULES AND DOOR TYPES SHEET A030.
- 7. ALL SHAFT PENETRATING SLAB SHALL BE RATED 2H. 8. ARCHITECTURAL LIGHTING ARE FOR LOCATE AND TYPE REFERENCE ONLY, REFER TO ELECTRICAL DRAWINGS FOR FIXTURE DESIGNATIONS AND SPECIFICATIONS.
- 9. USE UNISTRUT BELOW MECHANICAL DUCT OR STRUCTURAL BEAMS TO
- ACCOMMODATE LIGHT FIXTURES AS NEEDED. 10. PATCH AND REPAIR EXISTING EXPOSED CEILINGS AS NEEDED.


LEGEND - DEMO

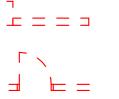


EXISTING WALL TO BE DEMOLISHED




EXISTING DOOR TO BE

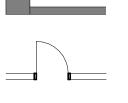

EXISTING WALL TO REMAIN

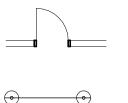

EXISTING DOOR TO REMAIN

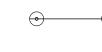

QUEUING STANCHION



KEYED NOTE



NOT INCLUDED IN SCOPE OF WORK



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DRAWING HISTORY

PROJECT NAME IAH-TERMINAL -SECURITY EXIT LANE

PROJECT LOCATION

GEORGE BUSH IAH 3500 NORTH TERMINAL RD. HOUSTON, TX 77032


PROJECT NUMBER

1004345


SHEET TITLE **DEMOLITION** FLOOR PLAN -TERMINAL C CENTRAL


SHEET NUMBER


AD202

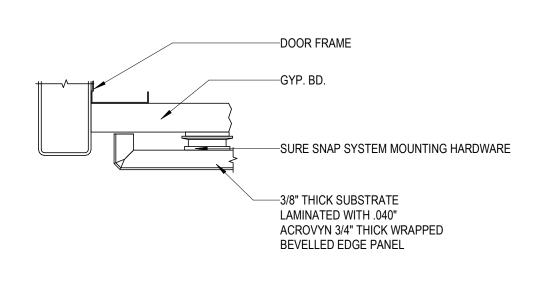


END WALL/DOOR FRAME DETAIL 6" = 1'-0" (5)

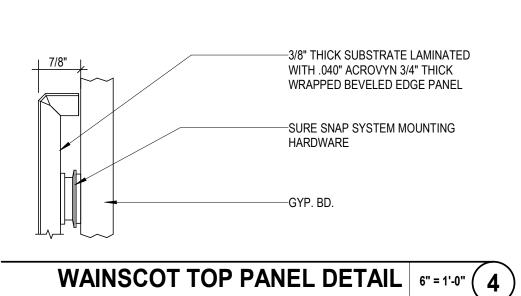

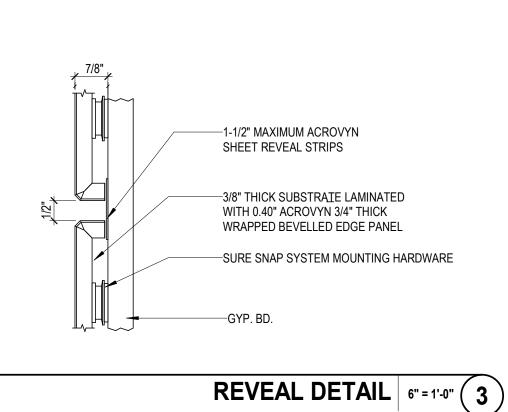

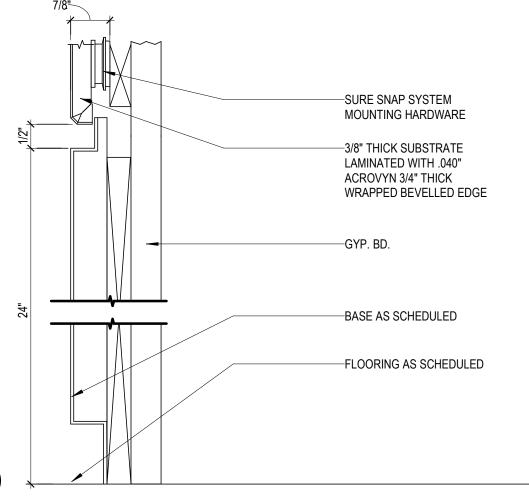

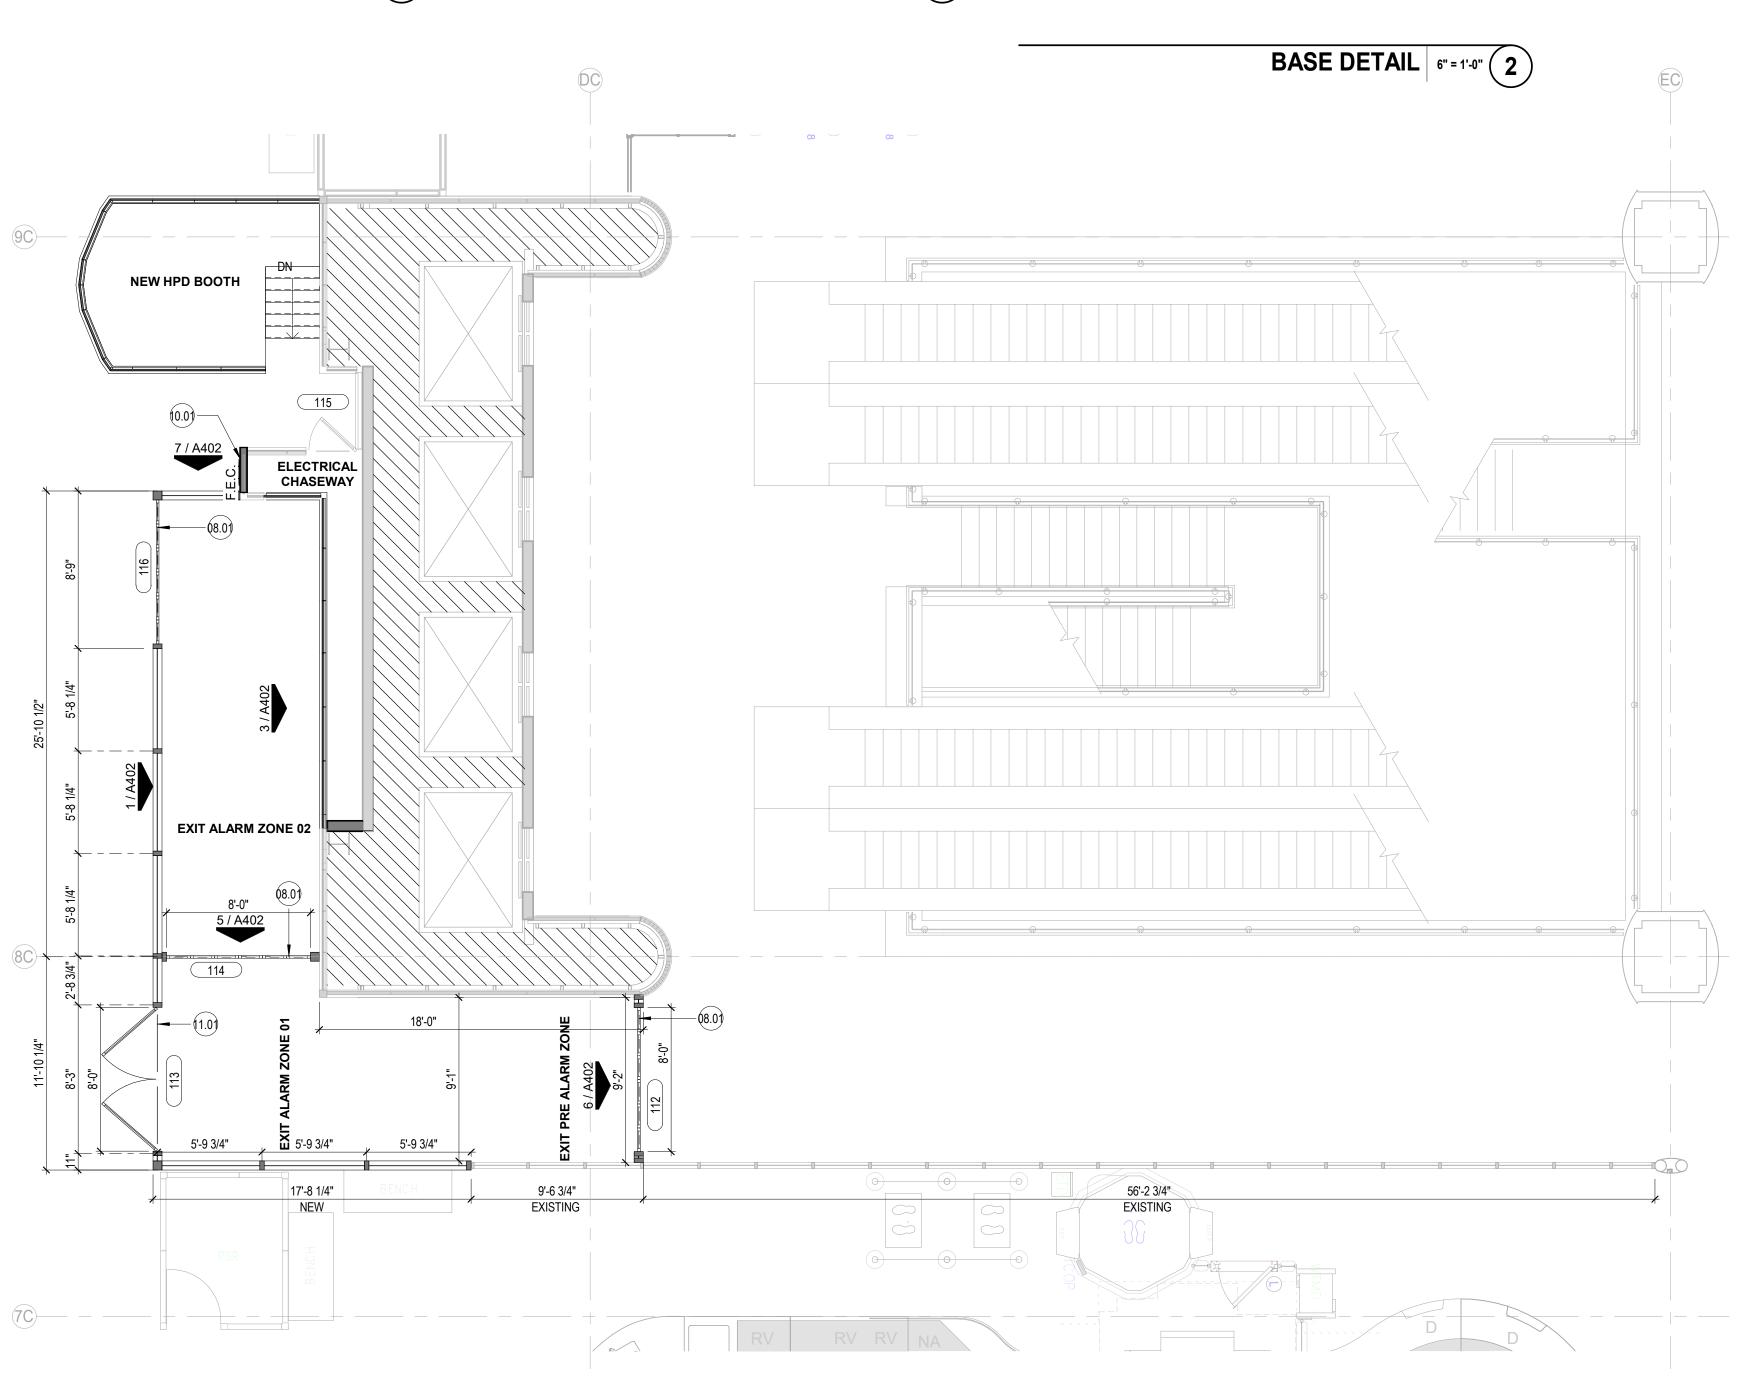

GENERAL NOTES - PLAN

- 1. DO NOT SCALE DIMENSIONS FROM DRAWINGS, ANY UNKNOWN DIMENSION SHALL BE OBTAINED FROM DESIGN PROFFESIONALS VIA REQUEST FOR
- 2. CONTRACTOR SHALL FIELD VERIFY ALL EXISTING CONDITIONS PRIOR TO
- COMMENCING WORK.
- 3. CONTRACTOR SHALL NOTIFY ARCHITECT OF ANY DISCREPANCY, INACCURACY OR CONFLICTING INFORMATION BEFORE EXECUTION OF WORK. 4. REFER TO WALL PARTITION/STOREFRONT TYPES SHEET A011 FOR ADDITIONAL
- INFORMATION. 5. REFER TO ENLARGED ELEVATIONS AND AXO ON SERIES SHEETS A400.
- 6. REFER TO DOOR SCHEDULES AND DOOR TYPES SHEET A030.
- 7. ALL SHAFT PENETRATING SLAB SHALL BE RATED 2H. 8. CONTRACTOR SHALL FIELD COORDINATE LOCATION, SIZE AND TYPE OF BLOCKING FOR INSTALLATION OF SIGNAGE, MILLWORK, ETC. ALL CONCEALED WOOD SHALL BE FIRE RETARDANT TREATED (FRT).

GENERAL NOTES

- 1. FIELD COOORDINATE CONDUIT ROUTING
- 2. EXPOSED CONDUIT SHALL BE PAINTED TO MATCH ADJACENT SURFACES
- 3. LABEL SECURITY CONDUITS. REFER TO NOTES ON SHEET G002. 4. ALL SECURITY SYSTEM EQUIPMENT FURNISHINGS, CONDUIT, CABLING AND OTHER RELATED MATERIALS AND INTERFACES SHALL BE INSTALLED IN
- 5. CONTRACTOR SHALL FURNISH AND INSTALL ALL CABLING AND CONDUIT FROM SECURITY DEVICE LOCATIONS TO DESIGNATED NODES/ROOMS. CABLING SHALL BE OF APPROPRIATE TYPE AND GAUGE AS REQUIRED BY THE MANUFACTURER. FOR PROPER SYTEM OPERATION. CONTRACTOR SHALL ENSURE CABLES TO EACH DEVICE PROVIDE SUFFICIENT VOLTAGE, OR SIGNAL STRENGTH TO OPERATE WITHIN MANUFACTURERS SPECIFIED LIMITS.


ACCORDANCE WITH PROJECT CONTRUCTION DOCUMENTS AND SCHEDULES.

- 6. CONTRACTOR SHALL COORDINATE EXACT DEVICE MOUNTING LOCATIONS WITH OWNERS DESIGNATED REPRESENTATIVE AND OTHER TRADES PRIOR TO INSTALLATION OF DEVICES AND RELATED INFRASTRUCTURE.
- 7. CONTRACTOR SHALL FIELD VERIFY AND COORDINATE WITH OWNERS DESIGNATED REPRESENTATVIE FINAL FIELD OF VIEW OF SECURITY CAMERAS

8. ALL SECURITY CAMERAS SHALL BE PROVIDED WITH APPROPRIATE HOUSING

- AND MOUNTS IN IDENTIFIED LOCATIONS. 9. CONTRACTOR SHALL PATCH AND REPAIR ANY SURFACE AFFECTED FROM INSTALLLATION IN THE COURSE OF THE SCOPE OF WORK TO ORIGINAL OR
- 10. EXISTING SECURITY INFRASTRUCTRE AND COMPONENTS AFFECTED BY CONSTRUCTION SHALL BE REROUTED AND/OR DECOMMISIONED.

LEGEND

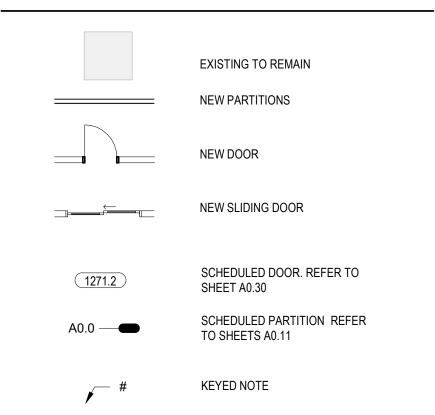

MATERIAL TAG

NOT INCLUDED IN SCOPE OF WORK

KEYNOTE LEGEND

NUMBER	DESCRIPTION
08.01	EXIT LANE 6 PANEL SLIDING DOORS
10.01	PROVIDE NEW RECESSED MOUNTED FIRE EXTINGUISHER CABINET, REPAIR EXISTING FINISHES AS NEEDED
11.01	VEHICULAR BYPASS DOORS

CLIENT



HAS AVIATION DEPT. 16930 JOHN F. **KENNEDY BLVD. HOUSTON TX 77032** [T] 281 233 1757 [F]281 233 1800

ARCHITECT



3131 BRIARPARK DR. **SUITE 200 HOUSTON, TX 77042** [T] 713 622 1444 [F] 713 968 9333 www.pgal.com

AVIATION

DEPARTMENT

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DRAWING HISTORY

PROJECT NAME IAH-TERMINAL -SECURITY EXIT

PROJECT LOCATION

LANE

GEORGE BUSH IAH **3500 NORTH** TERMINAL RD. HOUSTON, TX 77032


PROJECT NUMBER 1004345

SHEET TITLE

ENLARGED FLOOR PLAN - TERMINAL C CENTRAL

SHEET NUMBER

A202

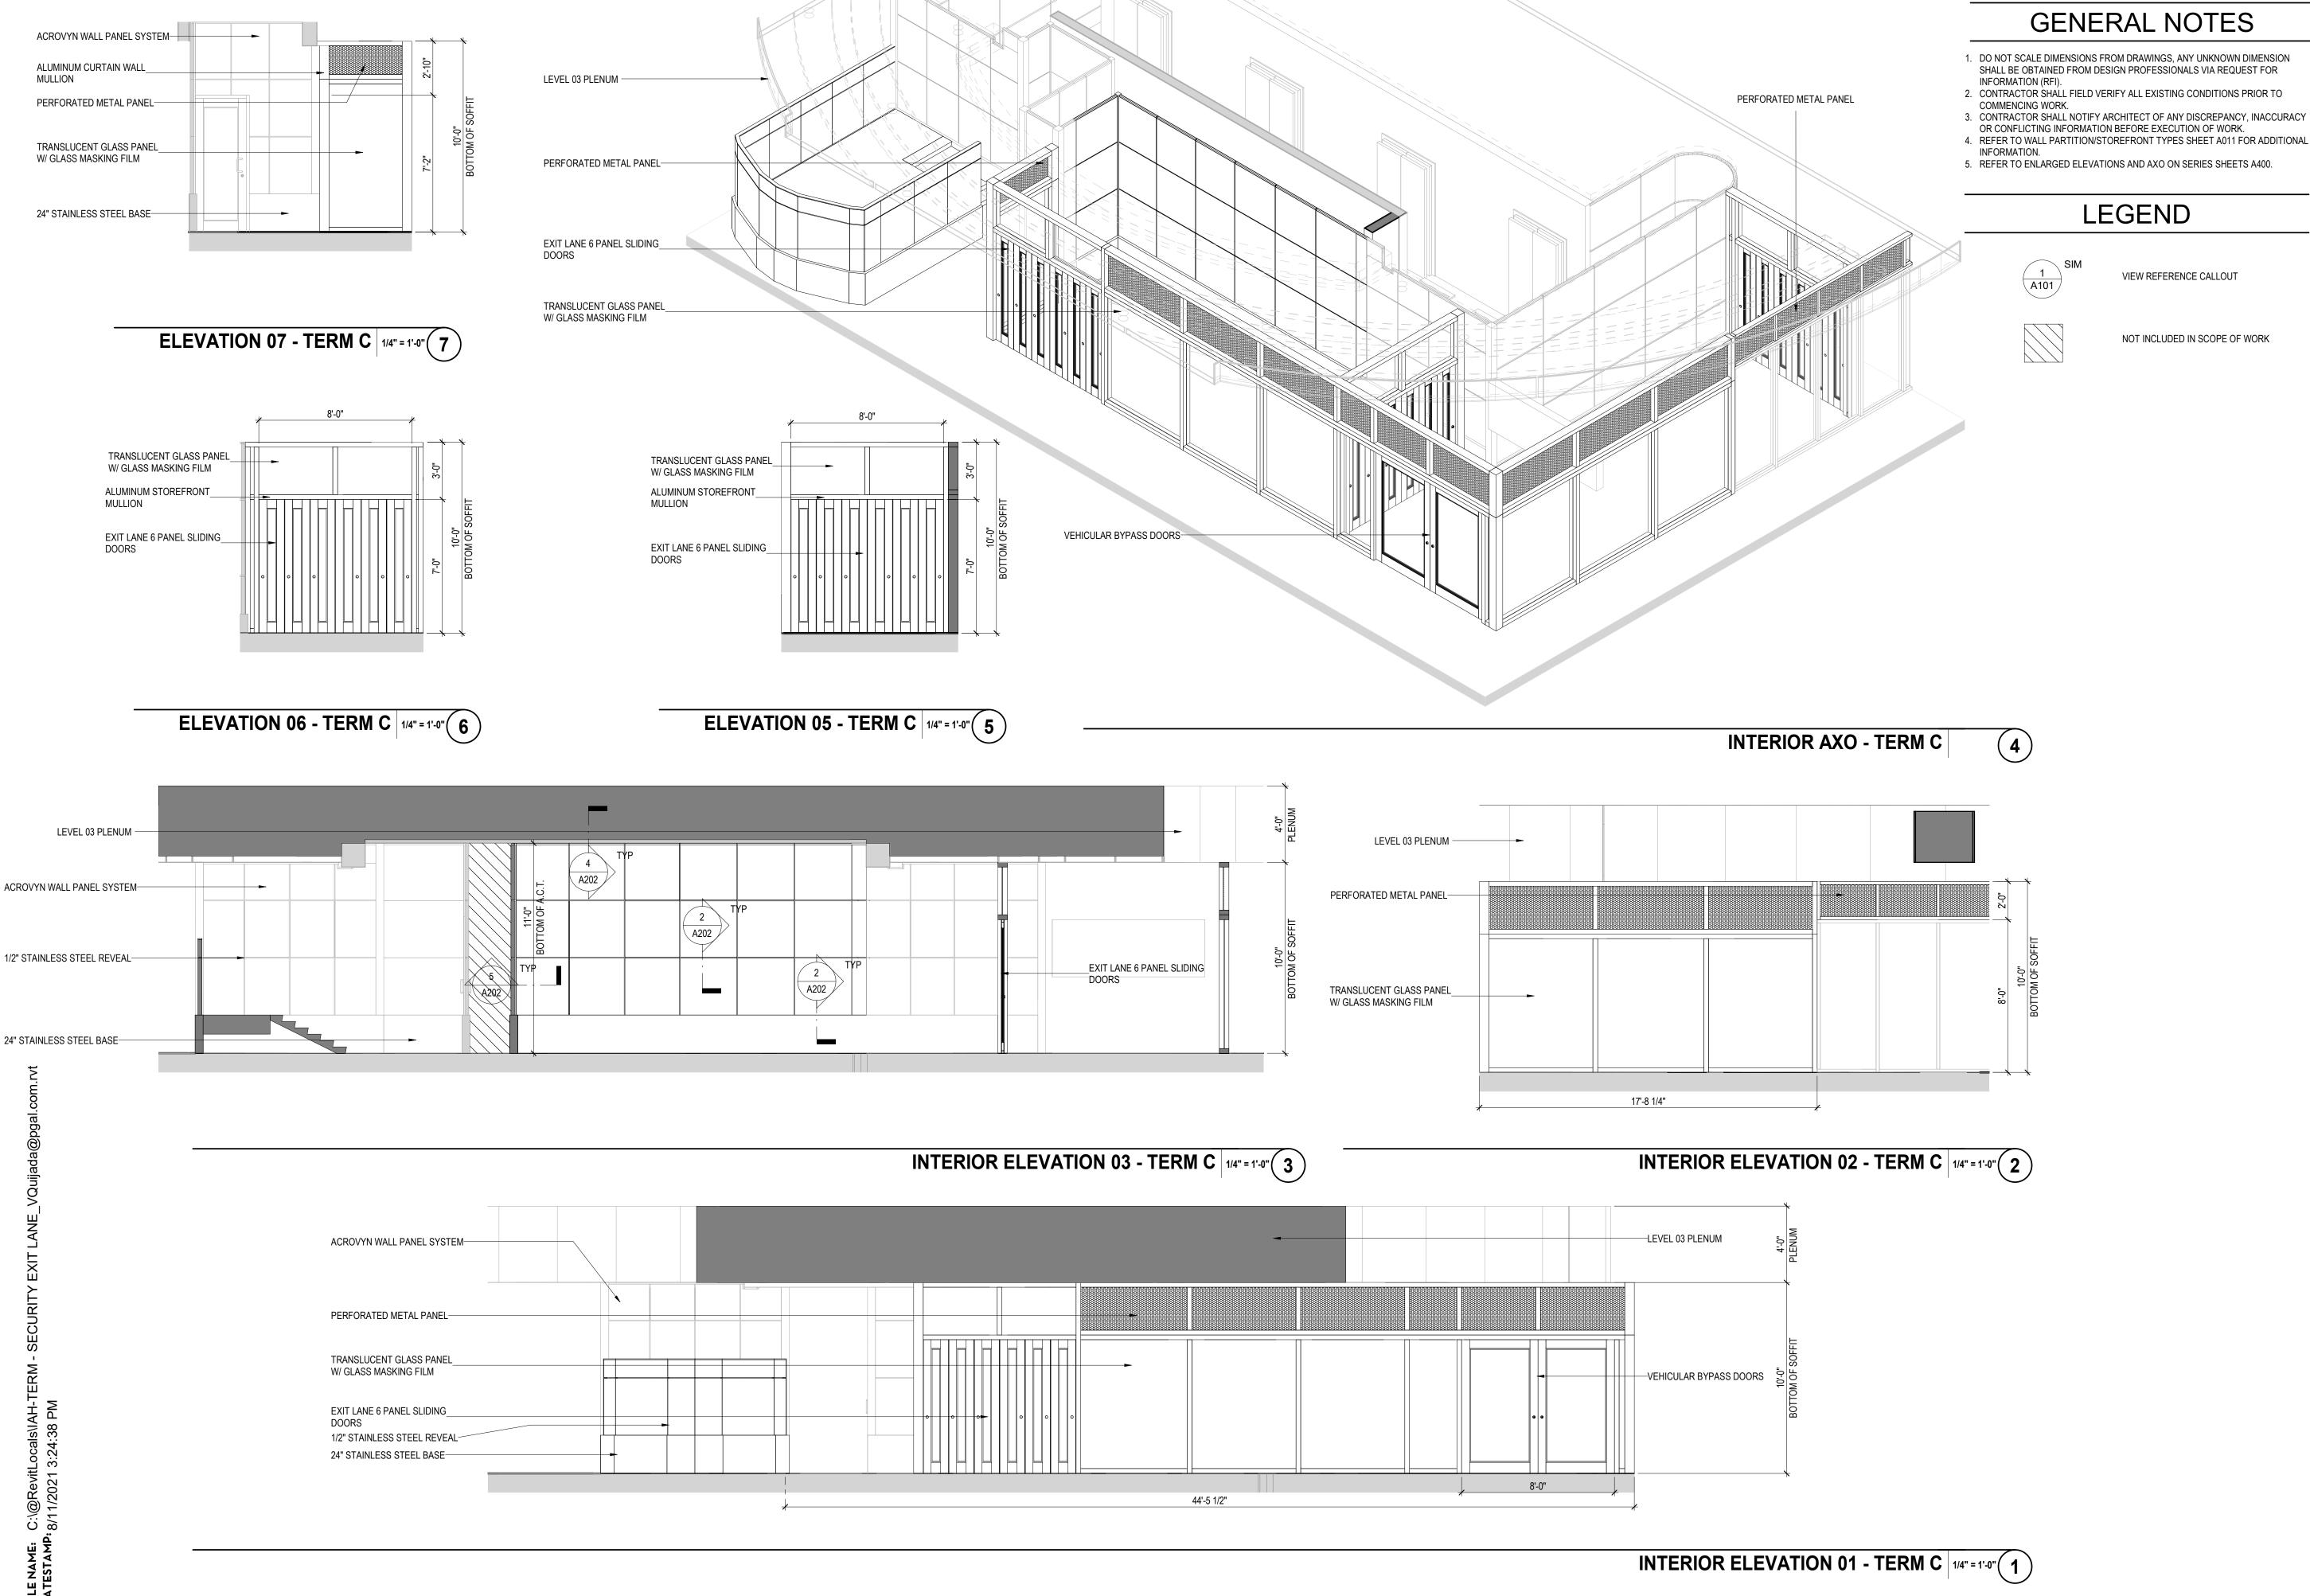

CLIENT

HAS AVIATION DEPT. 16930 JOHN F. KENNEDY BLVD.

HOUSTON TX 77032

[T] 281 233 1757

[F]281 233 1800 ARCHITECT



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AVIATION

DEPARTMENT

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DRAWING HISTORY

PROJECT NAME IAH-TERMINAL -SECURITY EXIT LANE

PROJECT LOCATION GEORGE BUSH IAH 3500 NORTH TERMINAL RD. HOUSTON, TX 77032

PROJECT NUMBER 1004345

SHEET TITLE

ENLARGED ELEVATIONS & AXO - TERMINAL C CENTRAL

SHEET NUMBER

GENERAL NOTES

- DO NOT SCALE DIMENSIONS FROM DRAWINGS, ANY UNKNOWN DIMENSION SHALL BE OBTAINED FROM DESIGN PROFESSIONALS VIA REQUEST FOR INFORMATION (RFI).
 CONTRACTOR SHALL FIELD VERIFY ALL EXISTING CONDITIONS PRIOR TO COMMENCING WORK.
 CONTRACTOR SHALL NOTIFY ARCHITECT OF ANY DISCREPANCY, INACCURACY OR CONFLICTING INFORMATION BEFORE EXECUTION OF WORK.
 REFER TO WALL PARTITION/STOREFRONT TYPES SHEET A011 FOR ADDITIONAL INFORMATION.
 REFER TO ENLARGED ELEVATIONS AND AXO ON SERIES SHEETS A400.

LEGEND



VIEW REFERENCE CALLOUT



NOT INCLUDED IN SCOPE OF WORK

CLIENT



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ARCHITECT



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DRAWING HISTORY

PROJECT NAME IAH-TERMINAL -SECURITY EXIT LANE

PROJECT LOCATION

GEORGE BUSH IAH 3500 NORTH TERMINAL RD. HOUSTON, TX 77032

PROJECT NUMBER

1004345

SHEET TITLE ENLARGED AXO -TERMINAL C CENTRAL

SHEET NUMBER

A502

12 B 20 B

KEYNOTES

- A EXISTING CEILING MOUNTED SIGN TO BE CAREFULLY REMOVED AND REMOUNTED. IF DAMAGED, SIGN SHALL BE REPLACED, PATCH/REPAIR AS REQUIRED.
- B EXISTING SIGN TO REMAIN, UNLESS NOTED OTHERWISE

GENERAL NOTES

- DO NOT SCALE DIMENSIONS FROM DRAWINGS, ANY UNKNOWN DIMENSION SHALL BE OBTAINED FROM DESIGN PROFESSIONALS VIA REQUEST FOR INFORMATION (RFI).
- 2. CONTRACTOR SHALL FIELD VERIFY ALL EXISTING CONDITIONS PRIOR TO COMMENCING WORK.
- 3. CONTRACTOR SHALL NOTIFY ARCHITECT OF ANY DISCREPANCY, INACCURACY OR CONFLICTING INFORMATION BEFORE EXECUTION OF WORK.
- ALL SHAFT PENETRATING SLAB SHALL BE RATED 2H.
 CONTRACTOR SHALL FIELD COORDINATE LOCATION, SIZE AND TYPE OF BLOCKING FOR INSTALLATION OF SIGNAGE, MILLWORK, ETC. ALL CONCEALED WOOD SHALL BE FIRE RETARDANT TREATED (FRT).

LEGEND

EXISTING SIGNAGE TO REMAIN

EXISTING TO REPLACED

MARK — 01 A KEYNOTE

AGE TAG



CLIENT



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ARCHITECT



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DEPARTMENT OF AVIATION RECOMMENDED:

HOUSTON AIRPORT SYSTEM DIRECTOR OR DESIGN REPRESENTATIVE

HAS TIP 21-156 - IAH

REGISTRATION
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DRAWING HISTORY

2. DATE DESCRIPTION

1 09-09-21 FOR INFORMATION AND REFERENCE ONLY

PROJECT NAME
IAH-TERMINAL SECURITY EXIT
LANE

PROJECT LOCATION

GEORGE BUSH IAH 3500 NORTH TERMINAL RD. HOUSTON, TX 77032

PROJECT NUMBER

1004345


SHEET TITLE
IAH TERMINAL C

SIGNAGE DEMO PLAN

SHEET NUMBER

ADG202

LEVEL 02 - DEMO SIGNAGE - FLOOR PLAN - TERMINAL C - ENLARGED 3/16" = 1'-0" 2

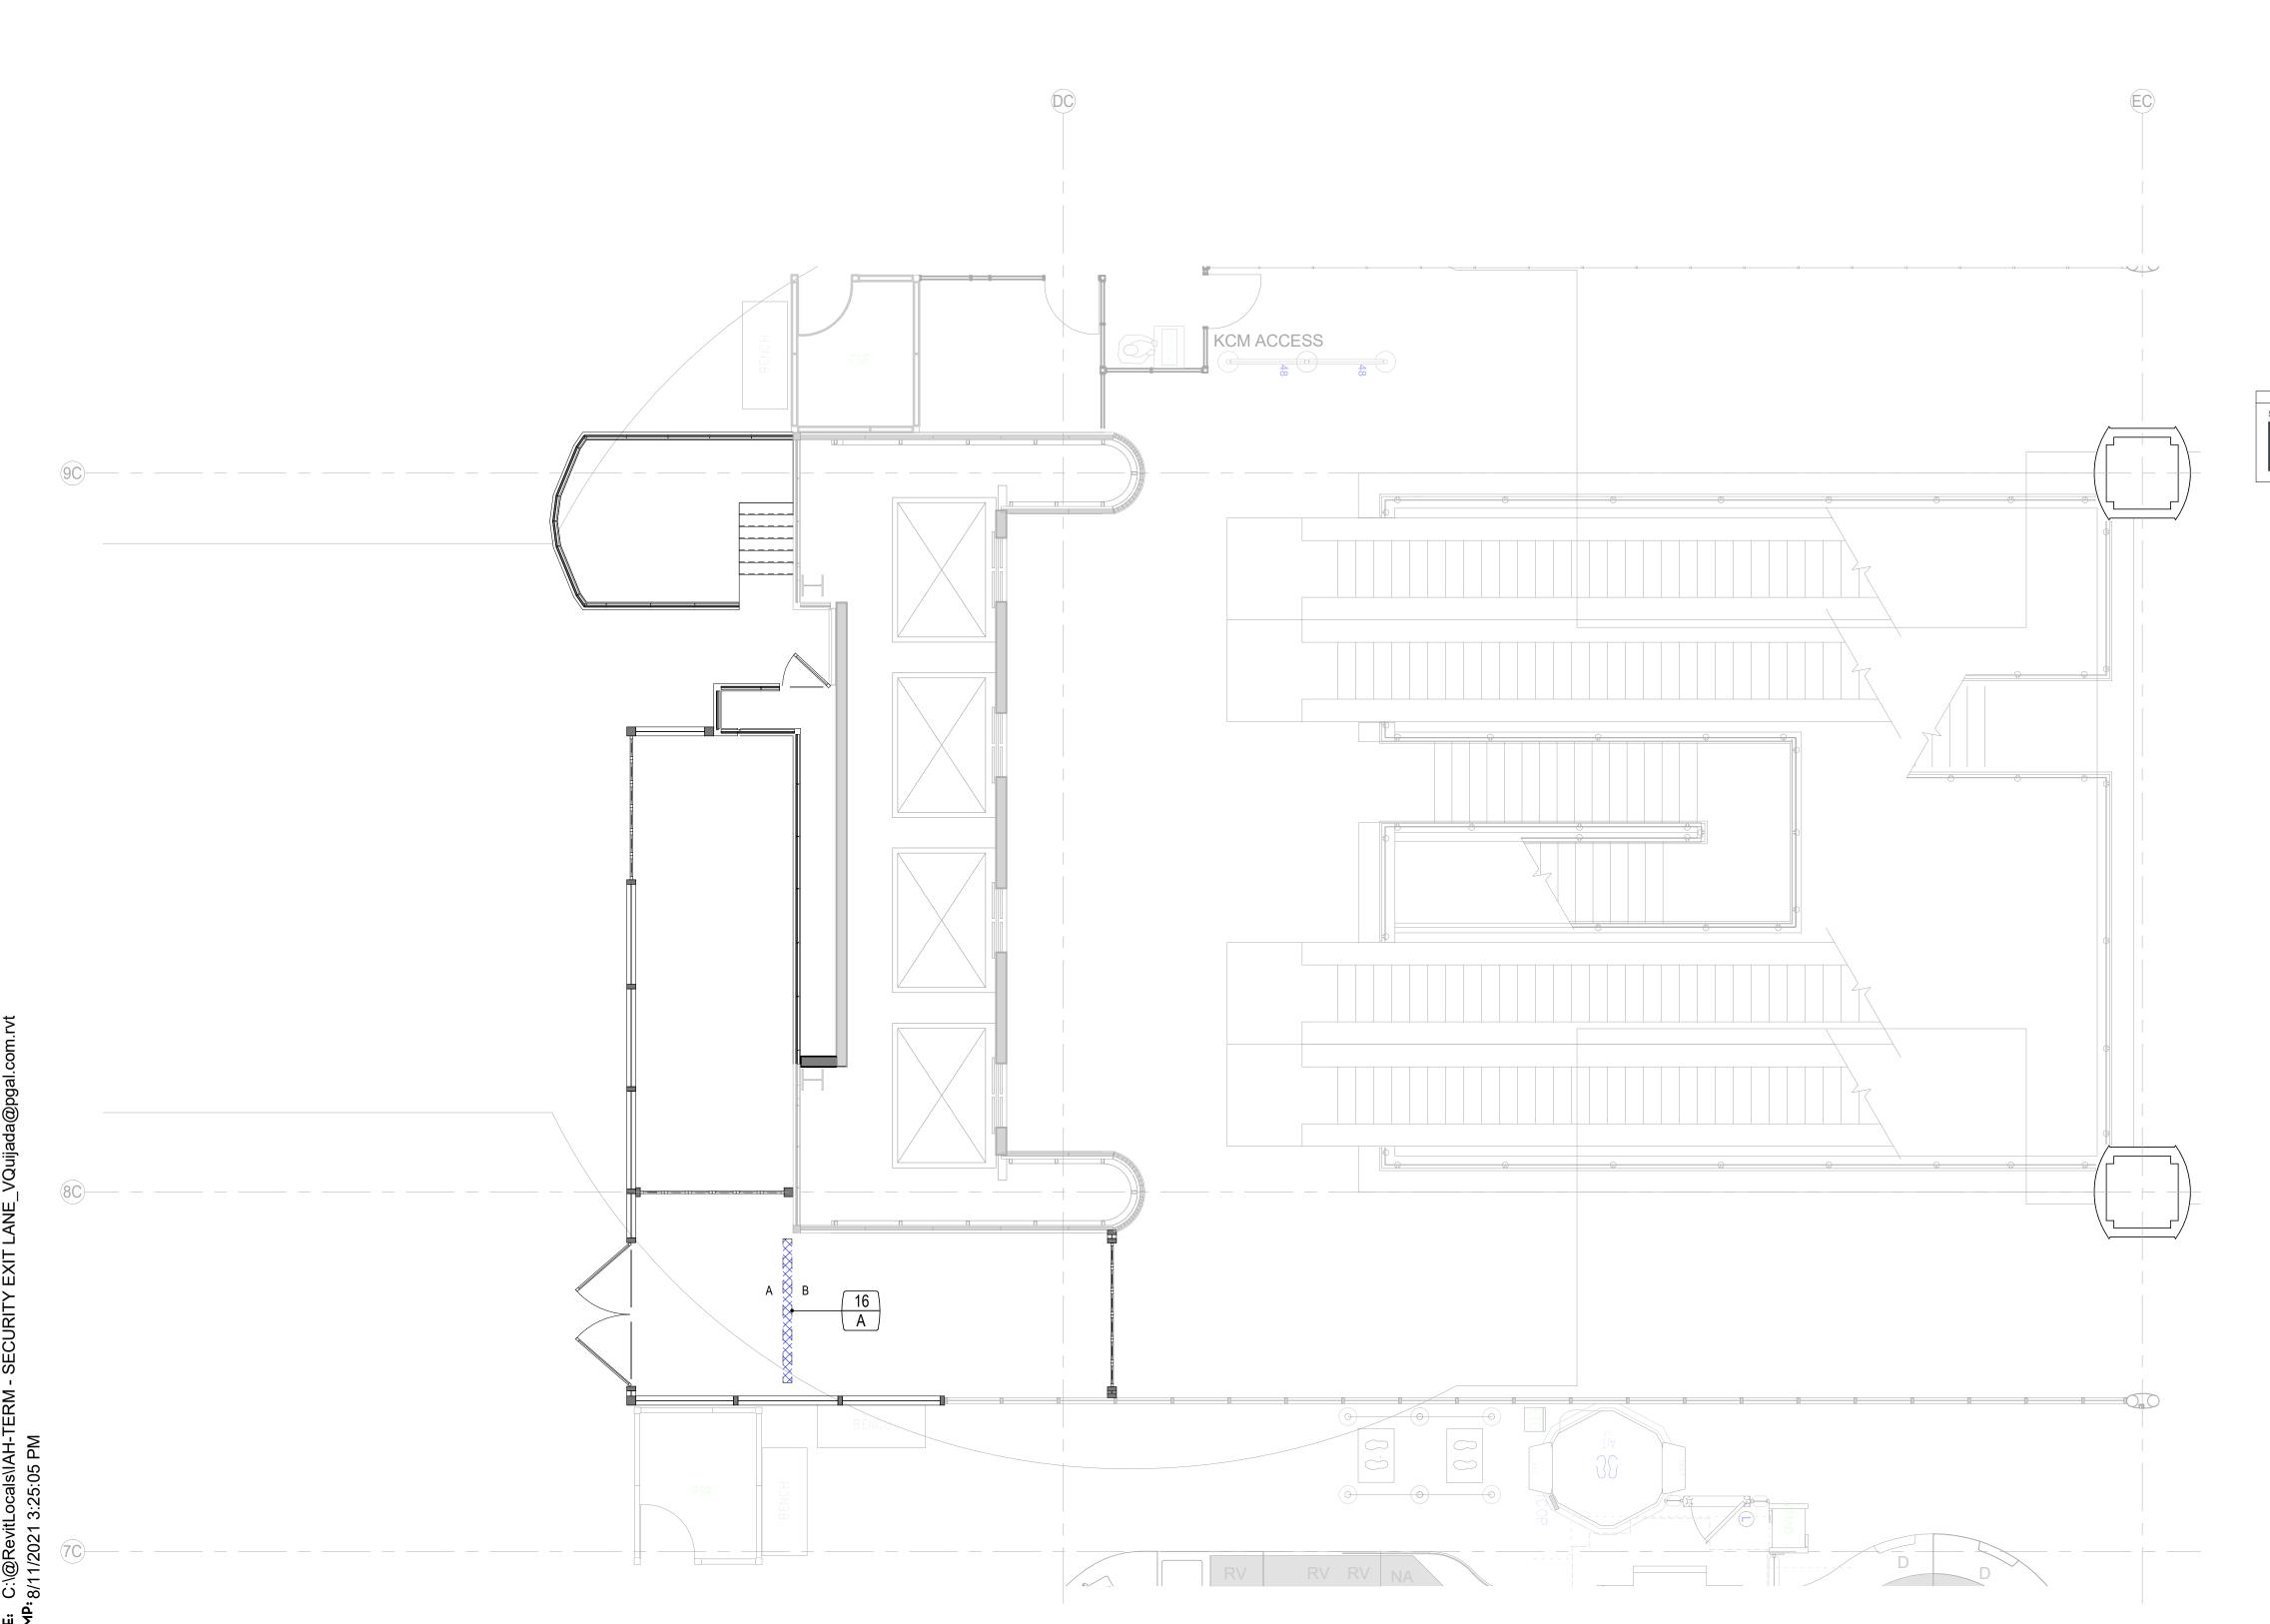

LEVEL 02 - SIGNAGE - FLOOR PLAN - TERMINAL C - ENLARGED 3/16" = 1'-0" 1

KEYNOTES

A NEW MOUNTED SIGN IF EXISTING SIGN IS DAMAGED

GENERAL NOTES

- 1. DO NOT SCALE DIMENSIONS FROM DRAWINGS, ANY UNKNOWN DIMENSION SHALL BE OBTAINED FROM DESIGN PROFESSIONALS VIA REQUEST FOR INFORMATION (RFI).
- 2. CONTRACTOR SHALL FIELD VERIFY ALL EXISTING CONDITIONS PRIOR TO
- COMMENCING WORK.
 3. CONTRACTOR SHALL NOTIFY ARCHITECT OF ANY DISCREPANCY, INACCURACY
- OR CONFLICTING INFORMATION BEFORE EXECUTION OF WORK.
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LEGEND

NEW SIGNAGE

CLIENT



HAS AVIATION DEPT. 16930 JOHN F. KENNEDY BLVD. HOUSTON TX 77032 [T] 281 233 1757 [F]281 233 1800

ARCHITECT



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AVIATION

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PROJECT NAME IAH-TERMINAL -SECURITY EXIT LANE

PROJECT LOCATION

GEORGE BUSH IAH 3500 NORTH TERMINAL RD. HOUSTON, TX 77032

PROJECT NUMBER 1004345

SHEET TITLE

IAH TERMINAL C SIGNAGE PLAN

SHEET NUMBER

AG202

LOW VOL	LOW VOLTAGE (RACEWAY ONLY)						
SYMBOL	DESCRIPTION						
▼X,N	INFORMATION OUTLET						
▼	INFORMATION OUTLET, FLOOR MOUNTED						
TV ±	CATV OUTLET						

NAME: ESTAMP

RECEPTACLE(S)					
SYMBOL	DESCRIPTION				
\oplus	DUPLEX RECEPTACLE, 20 AMP, 120V U.O.N.				
	DUPLEX RECEPTACLE, 20 AMP, 120V U.O.N. MOUNTED AT 48" UNLESS NOTED OTHERWISE				
\bigoplus	QUADRAPLEX RECEPTACLE, 20 AMP, 120V U.O.N.				
#	QUADRAPLEX RECEPTACLE, 20 AMP, 120V U.O.N. MOUNTED AT 48" UNLESS NOTED OTHERWISE				
Ф	SINGLE RECEPTACLE, 20 AMP, 120V U.O.N.				
Ф	GFI - TYPE DUPLEX RECEPTACLE (WP: DENOTES WEATHERPROOF COVER)				
	GFI - TYPE DOUBLE DUPLEX RECEPTACLE				
I	GFI - DUPLEX RECEPTACLE MOUNTED AT 48" UNLESS OTHERWISE NOTED				
	GFI - DOUBLE DUPLEX RECEPTACLE MOUNTED AT 48" UNLESS OTHERWISE NOTED				
	SPECIAL PURPOSE RECEPTACLE (NEMA RATING AS INDICATED)				
Ф	DUPLEX RECEPTACLE - HALF SWITCHED				
\bigoplus	DUPLEX RECEPTACLE - CEILING MOUNTED				
\oplus^{IG}	DUPLEX RECEPTACLE WITH ISOLATED GROUND				
	DUPLEX RECEPTACLE - FLOOR MOUNTED				
J	JUNCTION BOX - CEILING MOUNTED				
Ā	JUNCTION BOX - WALL MOUNTED				
[J]	JUNCTION BOX - FLOOR / GROUND MOUNTED				

FIELD VERIFY ALL LOCATION

DESIGN DRAWINGS ARE SCHEMATIC. THIS CONTRACTOR SHALL VISIT THE SITE PRIOR TO BIDDING OR AWARD OF CONTRACT TO INSPECT EXISTING FIELD CONDITIONS. THIS CONTRACT SHALL INCLUDE ALL LABOR AND MATERIALS NECESSARY FOR FIELD MODIFICATIONS DUE TO EXISTING

THE CONTRACTOR SHALL CONTACT THE ARCHITECT, ENGINEER OR OWNER PRIOR TO BIDDING FOR INTERPRETATIONS AND CLARIFICATIONS OF THE DESIGN AND INCLUDE IN HIS BID ALL COSTS TO MEET THE DESIGN INTENT. CLARIFICATIONS MADE BY THE ARCHITECT. ENGINEER OR OWNER AFTER BIDDING WILL BE FINAL AND SHALL BE IMPLEMENTED AT CONTRACTORS

- BIDDING CONTRACTORS SHALL HAVE A WORKING KNOWLEDGE OF LOCAL CODES AND ORDINANCES AND SHALL INCLUDE IN THEIR BIDS THE COST FOR ALL WORK INSTALLED IN STRICT ACCORDANCE WITH GOVERNING CODES, THE PLANS AND SPECIFICATIONS NOT WITHSTANDING. THE CONTRACTOR SHALL ALERT ARCHITECT, ENGINEER OR OWNER OF ANY APPARENT DISCREPANCIES BETWEEN GOVERNING CODES AND DESIGN INTENT.
- EXISTING CONDITIONS REFLECTED IN DESGN DRAWINGS WERE TAKEN FROM VARIOUS FIELD VISITS CONDUCTED FROM 5/1/19 -8/28/19. THE ENGINEER AND ARCHITECTURAL FIRM ARE NOT RESPONSIBLE FOR ANY INSTALLATIONS THAT MAY HAVE OCCURED OUT IN THE FIELD THAT DIFFER FROM WHAT IS SHOWN ON THE PLANS. CONTRACTOR IS RESPONSIBLE TO CONDUCT A SITE VISIT TO VERIFY THE EXISTING CONDITIONS AND PROVIDE A REPORT TO THE A/E FIRMS DOCUMENTING ANY CHANGES THAT HAVE OCCURED THAT DIRECTLY AFFECT ANY OF THE PROPOSED INSTALLATIONS INDICATED ON ANY PART OF THE DRAWINGS COMPILED IN THIS SET.

SYMBOL	DESCRIPTION
	CEILING MOUNTED 2'x2' / 2'x4' LUMINAIRE - RECESSED NORMAL POWER
	CEILING MOUNTED 2'x2' / 2'x4' LUMINAIRE - RECESSED EMERGENCY POWER
	CEILING MOUNTED 1'x4' LUMINAIRE RECESSED OR SURFACE MOUNTED - NORMAL POWER
	CEILING MOUNTED 1'x4' LUMINAIRE RECESSED OR SURFACE MOUNTED - EMERGENCY POWER
• •	CEILING MOUNTED 1'x4' LUMINAIRE PENDANT MOUNTED - NORMAL POWER
	CEILING MOUNTED 1'x4' LUMINAIRE PENDANT MOUNTED - EMERGENCY POWER
	STRIP LUMINAIRE - NORMAL POWER
	STRIP LUMINAIRE - EMERGENCY POWER
	DOWNLIGHT LUMINAIRE - NORMAL POWER
	DOWNLIGHT LUMINAIRE - EMERGENCY POWER
\bigcirc	WALL MOUNTED LUMINAIRE - NORMAL POWER
•	WALL MOUNTED LUMINAIRE - EMERGENCY POWER
	EMERGENCY BATTERY LIGHT UNIT
\bigotimes	EXIT LIGHT - SINGLE FACE WITH DIRECTIONAL ARROW
•	EXIT LIGHT - DOUBLE FACE
▼	EXIT LIGHT - WALL MOUNTED

SYMBOL	DESCRIPTION			
R	FIRE ALARM RELAY			
Р	FIRE ALARM MANUAL PULL STATION			
	FIRE ALARM STROBE ONLY DEVICE MINIMUM 75cd RATING			
	FIRE ALARM HORN / STROBE ONLY DEVICE MINIMUM 75cd RATING			
\(\sigma\cdot\)	FIRE ALARM SPEAKER / STROBE ONLY DEVICE MINIMUM 75cd RATING			
<§	FIRE ALARM SPEAKER DEVICE			
	FIRE ALARM HORN DEVICE MINIMUM 75cd RATING			
©	FIRE ALARM STROBE ONLY DEVICE MINIMUM 75cd RATING - CEILING MOUNTED			
	FIRE ALARM HORN / STROBE ONLY DEVICE MINIMUM 75cd RATING - CEILING MOUNTED			
(Ø)<§	FIRE ALARM SPEAKER / STROBE ONLY DEVICE MINIMUM 75cd RATING - CEILING MOUNTED			
(\$	FIRE ALARM SPEAKER DEVICE - CEILING MOUNTED			
$\bigcirc \triangleleft$	FIRE ALARM HORN DEVICE MINIMUM 75cd RATING - CEILING MOUNTED			

SWITCHES

ALARM CONTROL PANEL THAT SERVES THE PROPOSED AREA OF WORK.

GENERAL NOTES

- THE ELECTRICAL CONTRACT DOCUMENTS ARE SCHEMATIC IN NATURE AND INDICATE THE GENERAL CONFIGURATION OF SYSTEMS AND WORK. EXAMINE ARCHITECTURAL, INTERIOR DESIGN, CIVIL, LANDSCAPE, STRUCTURAL MECHANICAL, PLUMBING, FIRE PROTECTION, TECHNOLOGY, AND FOOD SERVICE DRAWINGS AND SPECIFICATIONS FOR LOCATIONS AND REQUIREMENTS OF DEVICES, EQUIPMENT, LUMINARIES, AND SYSTEMS. CONTENT INDICATED ON THE SPECIFICATIONS BUT NOT THE DRAWINGS, OR CONTENT INDICATED ON THE DRAWINGS BUT NOT THE SPECIFICATIONS, SHALL BE INTERPRETED AS BEING PRESENT ON BOTH.
- PROVIDE ALL DEVICES, EQUIPMENT, ACCESSORIES, MATERIALS, AND LABOR REQUIRED FOR A COMPLETE, FUNCTIONAL, AND CODE-COMPLIANT ELECTRICAL SYSTEM. ALL WORK SHALL BE PERFORMED IN ACCORDANCE WITH THE CODES AND STANDARDS INDICATED ON THIS SHEET.
- ALL DEVICES, EQUIPMENT, ACCESSORIES, AND MATERIALS SHALL BE NEW, AND, WHERE APPLICABLE, SHALL BE LISTED BY U.L. OR ANOTHER APPROVED ELECTRICAL TESTING AGENCY.
- COORDINATE LOCATIONS AND REQUIREMENTS OF EQUIPMENT REQUIRING ELECTRICAL SERVICE (I.E. PRINTERS, APPLIANCES, MOTORIZED PROJECTION SCREENS, MOTORIZED SHADES, ELEVATORS, TOOLS, ETC.) WITH APPROVED SHOP DRAWINGS, SPECIFICATION SHEETS, MANUFACTURER'S INSTALLATION LITERATURE, AND EQUIPMENT NAMEPLATE DATA, PRIOR TO ROUGH-IN AND INSTALLATION. PROVIDE ELECTRICAL CONNECTIONS (AS REQUIRED).
- BID SHALL INCLUDE COSTS ASSOCIATED WITH BACKFILLING, CORE DRILLING, DIRECTIONAL BORING, EXCAVATING, AND REPAIRING OF SURFACES.
- PAY ALL FEES, TAXES, AND OTHER COSTS ASSOCIATED WITH THE WORK ENCOMPASSED BY THE ELECTRICAL CONTRACT DOCUMENTS. PROVIDE ALL REQUIRED NOTICES AND OBTAIN ALL REQUIRED PERMITS.
- PROVIDE COOPERATION WITH OTHER TRADES AND PROVIDE ANY INFORMATION REQUIRED TO FACILITATE THE COMPLETION OF THEIR WORK. COORDINATE DEVICE AND EQUIPMENT LOCATIONS AND MOUNTING HEIGHTS WITH OTHER TRADES PRIOR TO ROUGH-IN AND INSTALLATION. COORDINATE CONDUIT ROUTING WITH OTHER TRADES PRIOR TO ROUGH-IN AND INSTALLATION.
- AN ALLOWANCE OF \$60,000 SHALL BE ADDED FOR ANY MISCELLANEOUS MODIFICATIONS THAT WILL BE REQUIRED IN THE FIELD. ALLOWANCE SHALL BE INCLUDED IN BID WITH NO EXCEPTIONS.
- PROVIDE TEMPORARY ELECTRICAL SERVICE(S) FOR USE BY OTHER TRADES DURING PROJECT CONSTRUCTION. UPON COMPLETION OF THE PROJECT, THE TEMPORARY ELECTRICAL SERVICE(S) SHALL BE REMOVED.
- WITHIN THIRTY (30) DAYS OF SYSTEM ACCEPTANCE, PROVIDE RECORD DRAWINGS TO THE OWNER. DRAWINGS SHALL BE COMPRISED OF SINGLE-LINE DIAGRAMS AND FLOOR PLANS INDICATING THE LOCATIONS AND AREAS SERVED FOR ALL DISTRIBUTION.
- WITHIN THIRTY (30) DAYS OF SYSTEM ACCEPTANCE, PROVIDE AN OPERATING MANUAL AND MAINTENANCE MANUAL TO THE OWNER. THE MANUALS SHALL INCLUDE THE FOLLOWING INFORMATION: SUBMITTAL DATA WITH EQUIPMENT RATINGS AND SELECTED OPTIONS, OPERATION AND MAINTENANCE MANUALS FOR EQUIPMENT REQUIRING MAINTENANCE, NAMES AND ADDRESSES OF A MINIMUM OF ONE (1) QUALIFIED SERVICE AGENCY.
- COORDINATE LOCATIONS AND MOUNTING HEIGHTS OF ALL WALL-MOUNTED ELECTRICAL DEVICES AND EQUIPMENT WITH THE ARCHITECTURAL DRAWINGS, GENERAL CONTRACTOR, CASEWORK/MILLWORK, AND OTHER TRADES PRIOR TO ROUGH-IN AND INSTALLATION.
- EQUIPMENT LOCATIONS SHALL SATISFY THE WORKING CLEARANCE REQUIREMENTS AND DEDICATED SPACE REQUIREMENTS OF NEC ARTICLE 110. PROVIDE SHOP DRAWINGS, DEMONSTRATING COMPLIANCE AND INTER-DISCIPLINARY COORDINATION, FOR ENGINEERING REVIEW.
- REFER TO ARCHITECTURAL REFLECTED CEILING PLANS, SECTIONS, AND ELEVATIONS FOR LOCATIONS AND/OR MOUNTING HEIGHTS OF LUMINARIES LOCATED AT CEILINGS AND/OR WALLS. VERIFY THAT CEILING-MOUNTED LUMINARIES ARE SUITABLE FOR THE FINISHED CEILING SYSTEM INDICATED AND PROVIDE ACCORDINGLY. COORDINATE LOCATIONS AND MOUNTING HEIGHTS OF WALL-MOUNTED LUMINARIES WITH CASEWORK, FURNITURE, AND ARCHITECTURAL ELEMENTS. WHERE ARCHITECTURAL REFLECTED CEILING PLANS INDICATE FIRE-RATED CEILING SYSTEMS, PROVIDE UL-LISTED LUMINAIRE ENCLOSURES (AS REQUIRED).
- TYPE BX(AC) OR MC CABLE IS PROHIBITED FOR USE ON THIS PROJECT. FLEX CONDUIT IS ONLY ALLOW IN 3' MAXIMUM LENGTH FROM JUNCTION BOX TO LIGHT FIXURES.

NATIONAL ELECTRICAL CODE (2020)

NATIONAL FIRE ALARM CODE (2016)

STANDARD FOR THE PROTECTION OF ELECTRONIC

CODES AND STANDARDS

- 16. PROVIDE A COMPLETE GROUNDING SYSTEM IN ACCORDANCE WITH APPLICABLE SECTIONS OF THE NEC AND SPECIFICATIONS. BOND SERVICE ENTRANCE ELECTRICAL EQUIPMENT TO BUILDING STEEL, GROUND RODS, METAL WATER MAINS, LIGHTNING PROTECTION SYSTEM GROUNDING ELECTRODES (WHERE PRESENT), AND TELECOMMUNICATIONS SYSTEM GROUNDING ELECTRODES (AS REQUIRED). EQUIPMENT GROUNDING SHALL BE OF THE WIRE TYPE.
- 17. MINIMUM CONDUIT SIZE SHALL BE 3/4".
- 18. MINIMUM CONDUCTOR SIZE SHALL BE #12 AWG. ALL FEEDER AND BRANCH CIRCUIT CONDUCTORS SHALL BE INSTALLED WITHIN CONDUIT, UNLESS OTHERWISE INDICATED. ALL CONDUCTORS SHALL BE COPPER, UNLESS OTHERWISE INDICATED.
- 19. PROVIDE A DEDICATED NEUTRAL CONDUCTOR FOR EACH CIRCUIT. MULTI-WIRE BRANCH CIRCUITS SHALL BE PROHIBITED.
- 20. CONNECTIONS TO TRANSFORMERS AND MECHANICAL EQUIPMENT SHALL BE MADE WITH FMC OR LFMC, UNLESS OTHERWISE INDICATED.
- 21. WHERE PRACTICABLE, CONDUITS SHALL BE CONCEALED BELOW SLABS, WITHIN WALLS, AND ABOVE FINISHED CEILING SYSTEMS. WHERE CONDUITS ARE EMBEDDED WITHIN CONCRETE SLABS, COORDINATE CONDUIT SIZE LIMITATIONS AND SPACING REQUIREMENTS WITH THE STRUCTURAL DRAWINGS/ENGINEER PRIOR TO INSTALLATION.
- 22. SEAL ALL CONDUIT PENETRATIONS AT FIRE-RATED PARTITIONS. REFER TO DETAILS FOR FURTHER INFORMATION.
- 23. COORDINATE ALL CONDUIT PENETRATIONS WITH ARCHITECTURAL DRAWINGS, STRUCTURAL DRAWINGS, FIELD CONDITIONS, AND OTHER TRADES, PROVIDE SEALING FITTINGS TO PROHIBIT CONDENSATION AND/OR THE PASSAGE OF GASES OR VAPORS (AS REQUIRED).
- 24. INCREASE FEEDER AND BRANCH CIRCUIT CONDUCTOR SIZES AS REQUIRED IN ORDER TO MAINTAIN A MAXIMUM, CUMULATIVE VOLTAGE DROP OF 5% AT THE END LOAD, MAXIMUM VOLTAGE DROP SHALL BE DISTRIBUTED AS FOLLOWS: 3% FOR FEEDERS, 2% FOR BRANCH CIRCUITS. WHERE THE VOLTAGE DROP REQUIREMENTS OF THE LOCAL ENERGY CODE ARE MORE STRINGENT, THE REQUIREMENTS OF THE LOCAL ENERGY CODE SHALL TAKE PRECEDENCE. WHERE PHASE AND NEUTRAL CONDUCTOR SIZES ARE INCREASED FOR VOLTAGE DROP, THE EQUIPMENT GROUNDING CONDUCTOR SHALL BE INCREASED PROPORTIONATELY.
- 25. PROVIDE ALL REQUIRED DISCONNECT SWITCHES, STARTERS, AND COMBINATION STARTER/DISCONNECT SWITCHES. MAKE CONNECTIONS TO ALL ELECTRICALLY-DRIVEN DEVICES AND EQUIPMENT PROVIDED BY THE MECHANICAL, PLUMBING, AND FIRE PROTECTION CONTRACTORS. EXAMINE EQUIPMENT NAMEPLATE RATINGS PRIOR TO ROUGH-IN AND INSTALLATION. PROVIDE OVERCURRENT PROTECTION IN ACCORDANCE WITH EQUIPMENT NAMEPLATE RATINGS. PROVIDE ALL POWER SUPPLIES, CONTROL TRANSFORMERS, RELAYS, AND OTHER ACCESSORIES REQUIRED TO FACILITATE THE PROPER OPERATION OF MECHANICAL EQUIPMENT AS DESCRIBED WITHIN THE MECHANICAL ENGINEER'S SEQUENCE OF OPERATIONS.
- 26. ALL INTERIOR ELECTRICAL EQUIPMENT SHALL BE OF NEMA 1 CONSTRUCTION. UNLESS OTHERWISE INDICATED. ALL EXTERIOR ELECTRICAL EQUIPMENT SHALL BE OF NEMA 4X CONSTRUCTION, UNLESS OTHERWISE INDICATED. EQUIPMENT RATINGS SHALL CORRESPOND TO THEIR INSTALLED ENVIRONMENTS.
- 27. ALL NEW AND/OR EXISTING PANELBOARDS AND SWITCHBOARDS WITHIN THE SCOPE OF THIS PROJECT SHALL BE PROVIDED WITH NEW, TYPEWRITTEN DIRECTORIES, CIRCUIT DESCRIPTIONS SHALL CONTAIN ROOM NAMES AND ROOM NUMBERS BASED UPON INSTALLED ROOM SIGNAGE.
- 28. PROVIDE PHENOLIC, ENGRAVED IDENTIFICATION PLACARDS AT ALL SWITCHBOARDS, SWITCHGEAR, PANELBOARDS, TRANSFORMERS, DISCONNECT SWITCHES, ENCLOSED CIRCUIT BREAKERS, CABINETS, AND AUTOMATIC TRANSFER SWITCHES. REFER TO DETAILS FOR FURTHER INFORMATION.
- 29. PROVIDE PHENOLIC, ENGRAVED IDENTIFICATION PLACARDS AT EACH CIRCUIT BREAKER WITHIN A DISTRIBUTION PANEL, SWITCHBOARD, OR SWITCHGEAR.
- 30. PROVIDE TYPEWRITTEN OR ENGRAVED PANEL AND CIRCUIT IDENTIFICATION AT DEVICE COVER PLATES.
- 31. PROVIDE HANDWRITTEN PANEL AND CIRCUIT IDENTIFICATION ON THE EXTERIORS OF ALL JUNCTION BOXES, PULL BOXES, AND WIREWAYS.
- 32. CURRENT DRAWINGS ARE BASED ON SPECIFICATIONS AND REQUIREMENTS BASED ON TYCO SECURITY DOCUMENTS (ISSUED IN MAY 2019). IF ANY OTHER MANUFACTURER OR UPDATED SYSTEM IS TO BE PROVIDED THE INFORMATION ON THE CURRENT DOCUMENTS WILL NOT BE ACCCURATE. THE ENGINEER RESERVES THE RIGHT TO REVIEW ANY REVISED SPECIFCIATIONS AND ELECTRICAL REQUIREMENTS PRIOR TO BID TO ENSURE THE PROVISION NOTED ON THE DOCUMENTS ARE CORRECT OR IF THEY WILL NEED TO BE REVISED.

COMMISSIONING

PRIOR TO FINAL INSPECTION, THE CONTRACTOR SHALL SUBMIT EVIDENCE TO THE REGISTERED DESIGN PROFESSIONAL (ELECTRICAL ENGINEER-OF-RECORD) OR REGISTERED DESIGN PROFESSIONAL'S REPRESENTATIVE THAT THE LIGHTING SYSTEMS HAVE BEEN TESTED TO ENSURE THAT THEY ARE SATISFY THE INTENT OF THESE CONTRACT EN INSTRUCTIONS.

	COMPUTER / DATA PROCESSING EQUIPMENT (2013)	DOCUMI	ENTS AND THE MANUFACTURERS' WRITTEN
NFPA 90A	STANDARD FOR THE INSTALLATION OF AIR CONDITIONING AND VENTILATING SYSTEMS (2015)		
NFPA 90B	STANDARD FOR THE INSTALLATION OF WARM AIR HEATING AND AIR CONDITIONING SYSTEMS (2015)		
NFPA 92	RECOMMENDED PRACTICE FOR SMOKE CONTROL SYSTEMS (2012)	SHEET	INDEX
NFPA 101	LIFE SAFETY CODE (2015)	NUMBER	NAME
NFPA 110	STANDARD FOR EMERGENCY AND STAND-BY POWER	E000	ELECTRICAL LEGEND
	SYSTEMS (2015)	E203	DEMOLITION PLAN - TERMINAL C - E
		E303	FLOOR PLAN - TERMINAL C - LIGHTI
NFPA 780	STANDARD FOR THE INSTALLATION OF LIGHTNING	E403	FLOOR PLAN - TERMINAL C - POWE
	PROTECTION SYSTEMS (2014)	E601	ELECTRICAL RISER DIAGRAMS
2015 (IECC)	INTERNATIONAL ENERGY CONSERVATION CODE	E901	ELECTRICAL DETAILS
2010 (1200)	INTERIORAL ENERGY CONCERNATION CODE	E902	ELECTRICAL DETAILS
	LOCAL JURISDICATION CODES AND / OR OWNER DESIGN GUIDELINES		
2018 (HAS)	HAS DESIGN STANDARDS MANUAL		

SHEET INDEX						
NUMBER	NAME					
E000	ELECTRICAL LEGEND					
E203	DEMOLITION PLAN - TERMINAL C - ELECTRICAL POWER					
E303	FLOOR PLAN - TERMINAL C - LIGHTING					
E403	FLOOR PLAN - TERMINAL C - POWER					
E601	ELECTRICAL RISER DIAGRAMS					
E901	ELECTRICAL DETAILS					
E902	ELECTRICAL DETAILS					

CLIENT



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DRAWING HISTORY Nº. DATE DESCRIPTION 1 09-09-21 FOR INFORMATION AND REFERENCE ONLY

PROJECT NAME IAH-TERMINAL -**SECURITY EXIT** LANE

PROJECT LOCATION **GEORGE BUSH IAH 3500 NORTH** TERMINAL RD. HOUSTON, TX 77032 PROJECT NUMBER

SHEET TITLE **ELECTRICAL**


1004345

LEGEND


VOLT AIR SHEET NUMBER 5353 West Alabama Suite 205

Houston, TX. 77056 Phone:832.371.6181

Texas Firm: F-14583 ProjectNo.:02.18027

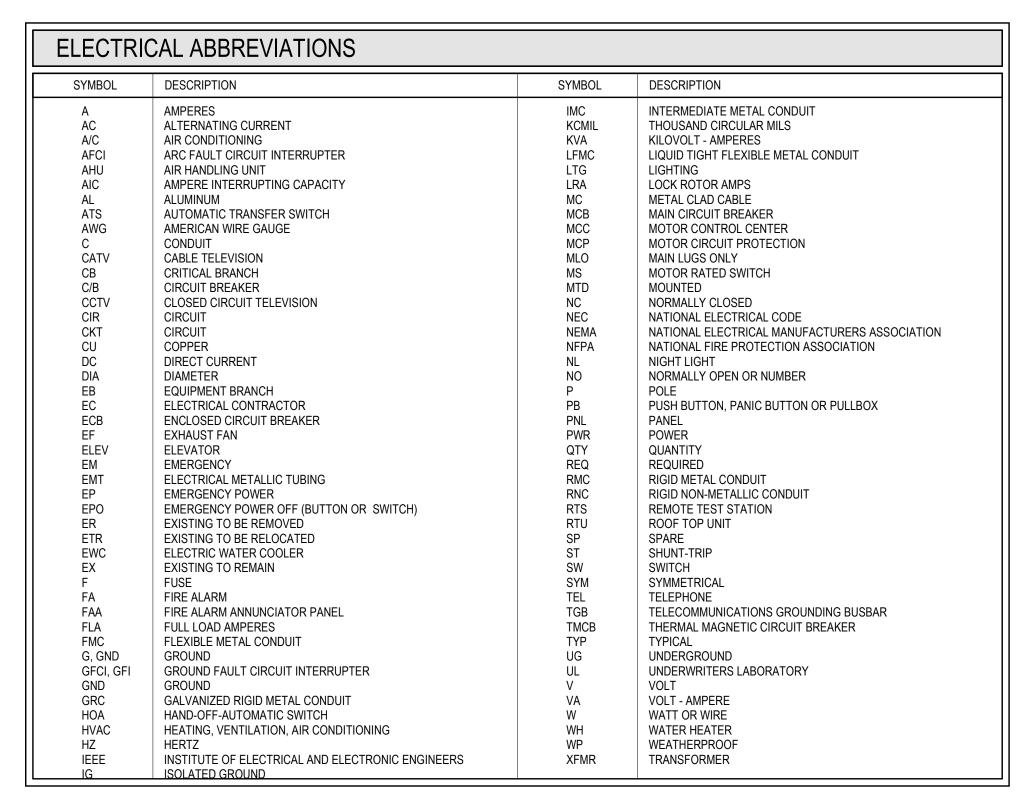

SYMBOL	DESCRIPTION				
\$	SINGLE POWER TOGGLE SWITCH (LETTER DENOTES FIXTURE CONTROLLED)				
\$3	THREE-WAY TOGGLE SWITCH				
\$4	FOUR-WAY TOGGLE SWITCH				
\$м	MOTOR SWITCH				
\$ _F	FAN SWITCH				
\$ _D	DIMMER SWITCH, COMPATIBLE WITH 0-10V DIMMING.				
\$т	TIMER SWITCH (60 MINUTES)				
\$LV	LOW VOLTAGE SWITCH				
\$к	KEY SWITCH				
\$wp	SWITCH - WEATHERPROOF				
\$os	WALL SWITCH OCCUPANCY SENSOR				
\$pos	DIMMER OCCUPANCY SENSOR SWITCH				
(OS)	OCCUPANCY SENSOR - CEILING MOUNTED				
(OS)	OCCUPANCY SENSOR - WALL MOUNTED				
PC	PHOTOCELL				

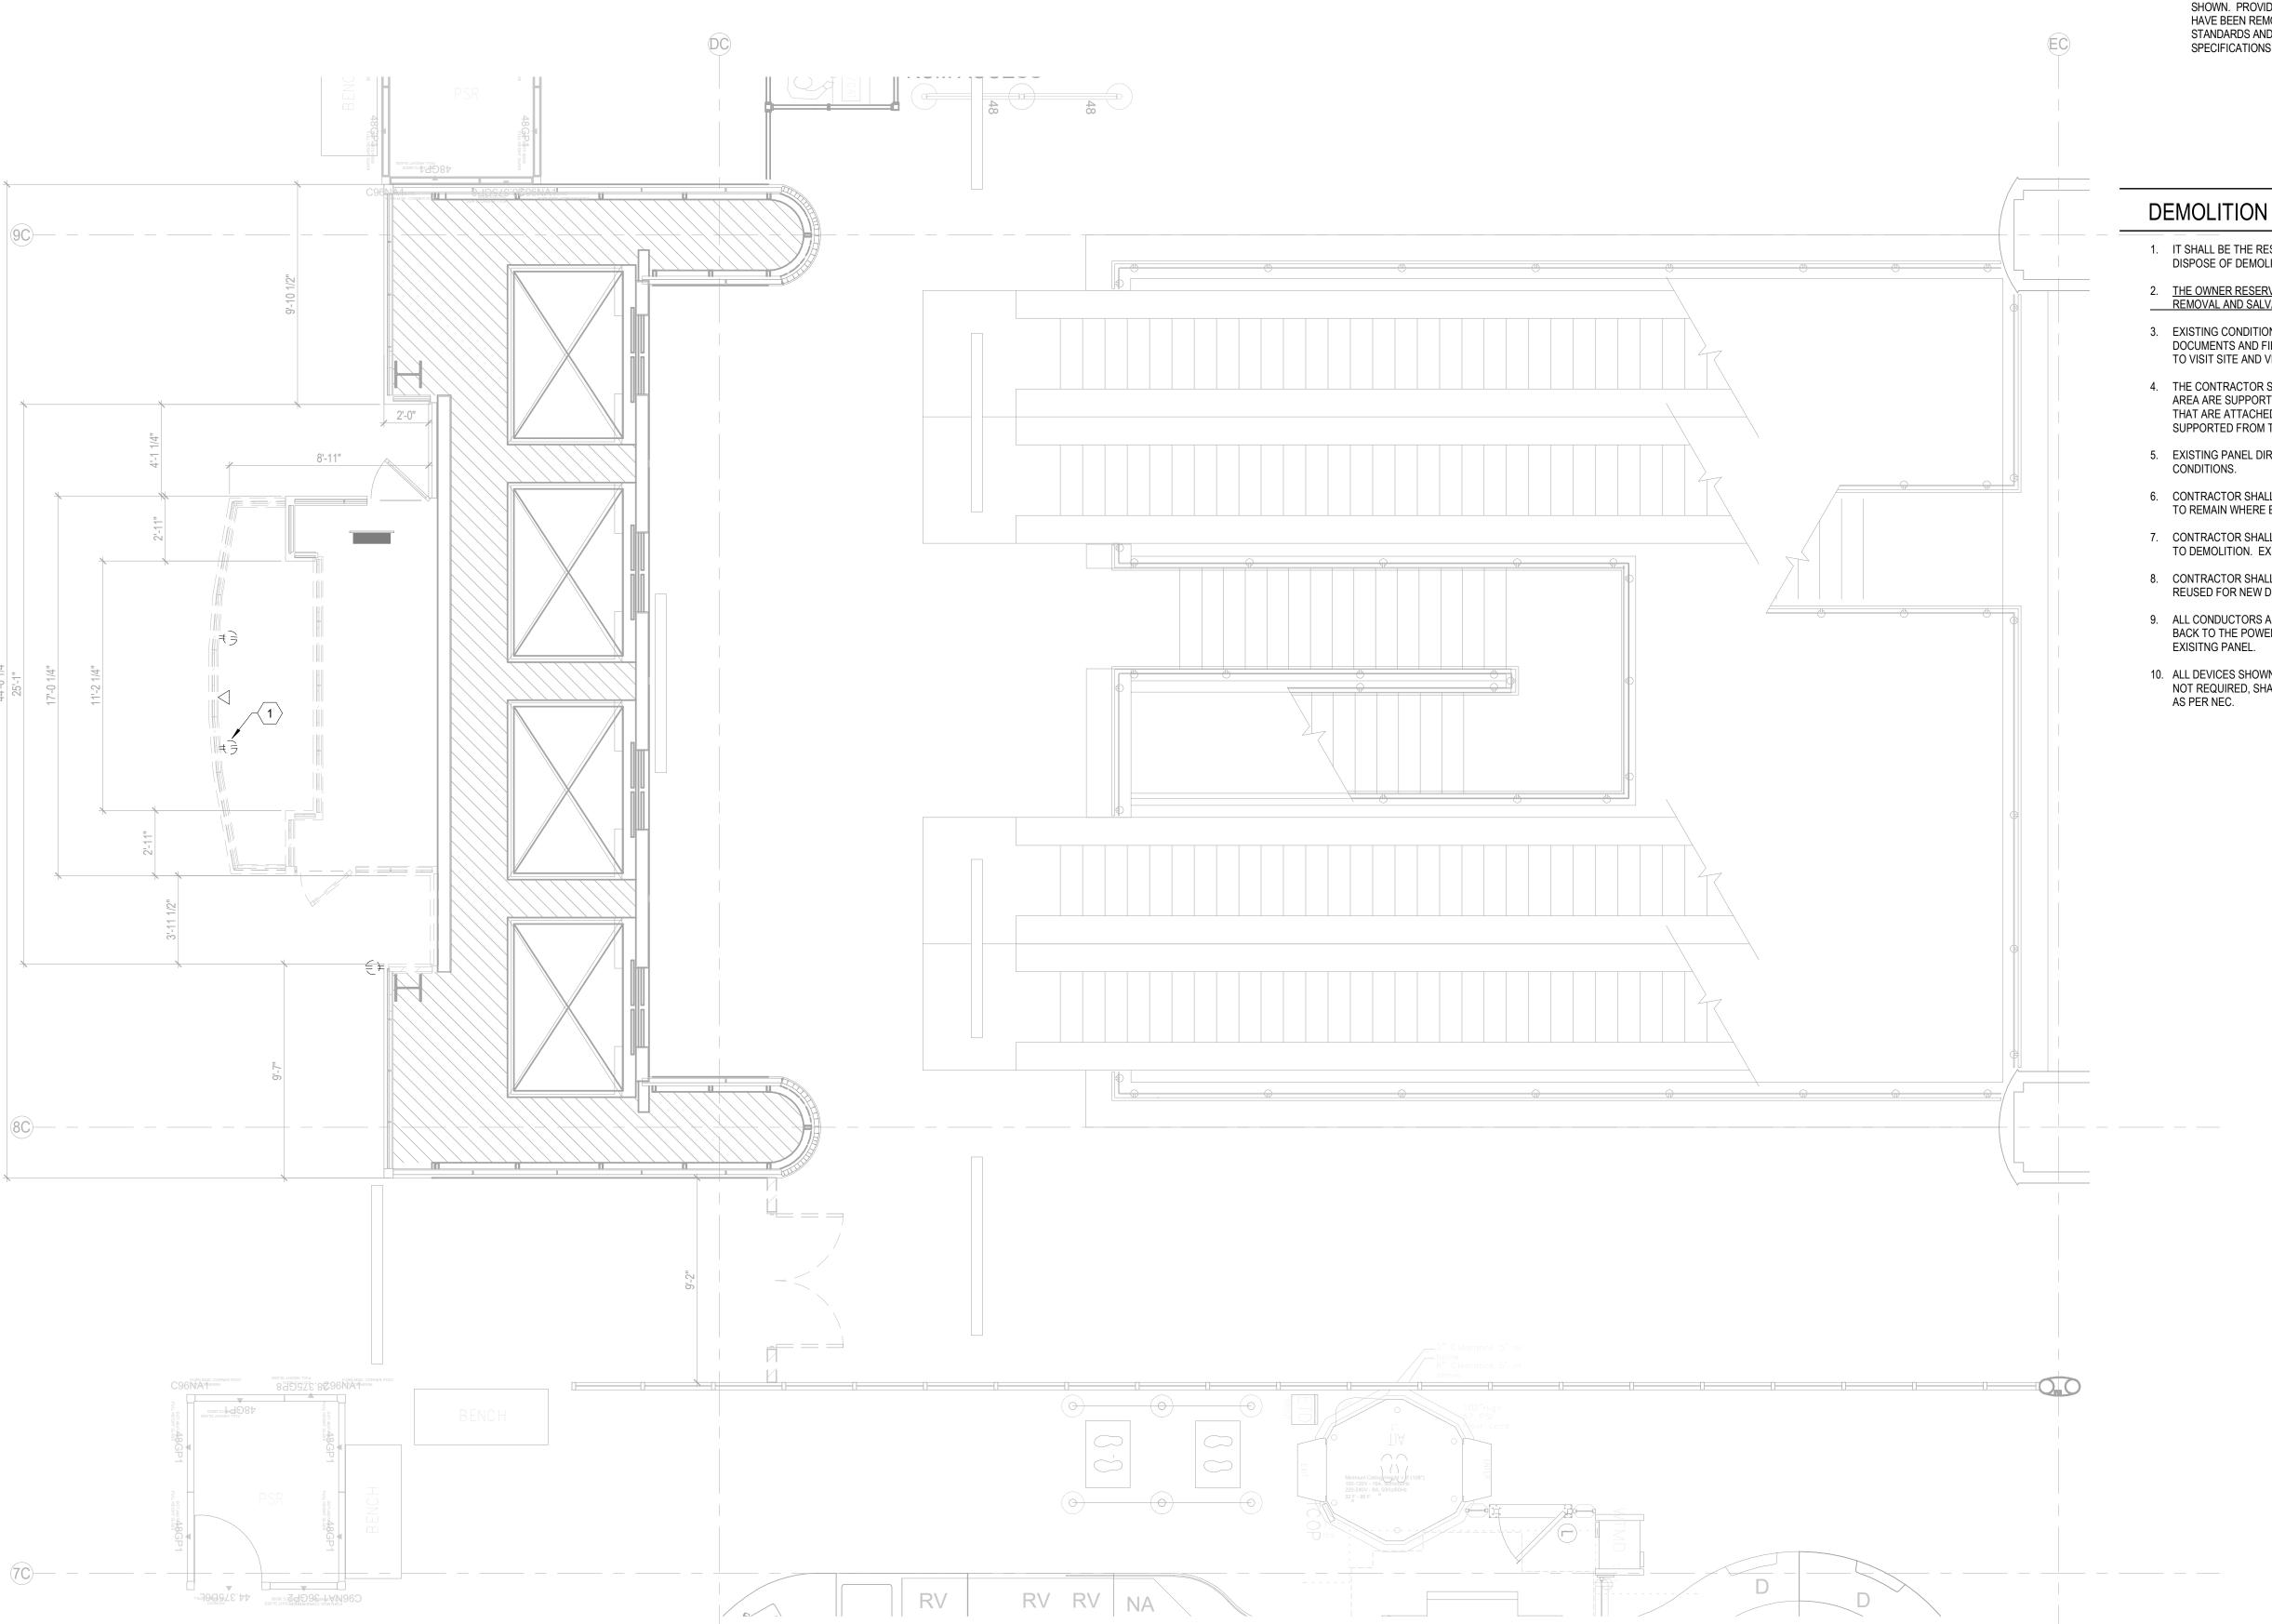

FILE NAME: C:\Users\j; DATESTAMP 8/9/2021 {

KEYNOTES ?

REMOVE AND RELOCATE EXISTING CIRCUITS SERVING HPD BOOTH TO NEW LOCATION SHOWN. PROVIDE BLANK COVER PLATE FOR EXISTING OUTLETS ONCE CONDUCTORS HAVE BEEN REMOVED. ALL RELOCATED DEVICES SHALL BE INSTALLED PER H.A.S. STANDARDS AND SPECIFICATIONS TO INCLUDE BUT NOT LIMITED TO H.A.S. I.T.

DEMOLITION NOTES

- 1. IT SHALL BE THE RESPONSIBILITY OF THE CONTRACTOR TO REMOVE AND LEGALLY DISPOSE OF DEMOLISHED MATERIALS.
- 2. THE OWNER RESERVES THE RIGHT TO INSPECT THE MATERIAL SCHEDULED FOR REMOVAL AND SALVAGE ANY ITEMS DEEMED USEABLE AS SPARE PARTS.
- 3. EXISTING CONDITIONS INDICATED ON THIS DRAWING ARE TAKEN FROM EXISTING DOCUMENTS AND FIELD INVESTIGATION. IT IS RECOMMENDED FOR CONTRACTOR TO VISIT SITE AND VERIFY EXISTING CONDITIONS PRIOR TO BID.
- 4. THE CONTRACTOR SHALL INSURE THAT CONDUITS REMAINING WITHIN THE PROJECT AREA ARE SUPPORTED IN ACCORDANCE WITH THE SPECIFICATIONS. CONDUITS THAT ARE ATTACHED TO ITEMS BEING REMOVED DURING DEMOLITION SHALL BE SUPPORTED FROM THE STRUCTURE PRIOR TO REMOVING ITEM.
- 5. EXISTING PANEL DIRECTORIES SHALL BE UPDATED TO REFLECT CURRENT
- 6. CONTRACTOR SHALL PATCH, PAINT AND MATCH FINISH WITH EXISTING SURFACES TO REMAIN WHERE ELECTRICAL DEVICES ARE BEING REMOVED.
- 7. CONTRACTOR SHALL REVIEW NEW FLOOR PLANS FOR DEVICES TO REMAIN PRIOR TO DEMOLITION. EXISTING DEVICES TO REMAIN ARE SHOWN LIGHT IN COLOR.
- 8. CONTRACTOR SHALL REVIEW NEW FLOOR PLANS FOR CIRCUITS TO REMAIN AND BE REUSED FOR NEW DEVICES PRIOR TO DEMOLITION.
- 9. ALL CONDUCTORS AND THAT ARE NOT BEING USED, SHALL BE DISCONNECTED BACK TO THE POWER SOURCE. REMOVE ALL CONDUIT AND CONDUCTORS TO THE
- 10. ALL DEVICES SHOWN TO BE REMOVED OR REMOVED DUE TO INACTITIVY OR DEEMED NOT REQUIRED, SHALL BE DEMOLISHED(CONDUIT, CABLING, ETC.) BACK TO SOURCE

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DRAWING HISTORY

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PROJECT NAME IAH-TERMINAL -SECURITY EXIT LANE

PROJECT LOCATION GEORGE BUSH IAH 3500 NORTH TERMINAL RD. HOUSTON, TX 77032

PROJECT NUMBER 1004345


SHEET TITLE

VOLT AIR

5353 West Alabama Suite 205 Houston, TX. 77056 Phone:832.371.6181 Texas Firm: F-14583 ProjectNo.:02.18027

DEMOLITION PLAN -TERMINAL C -ELECTRICAL **POWER**

SHEET NUMBER

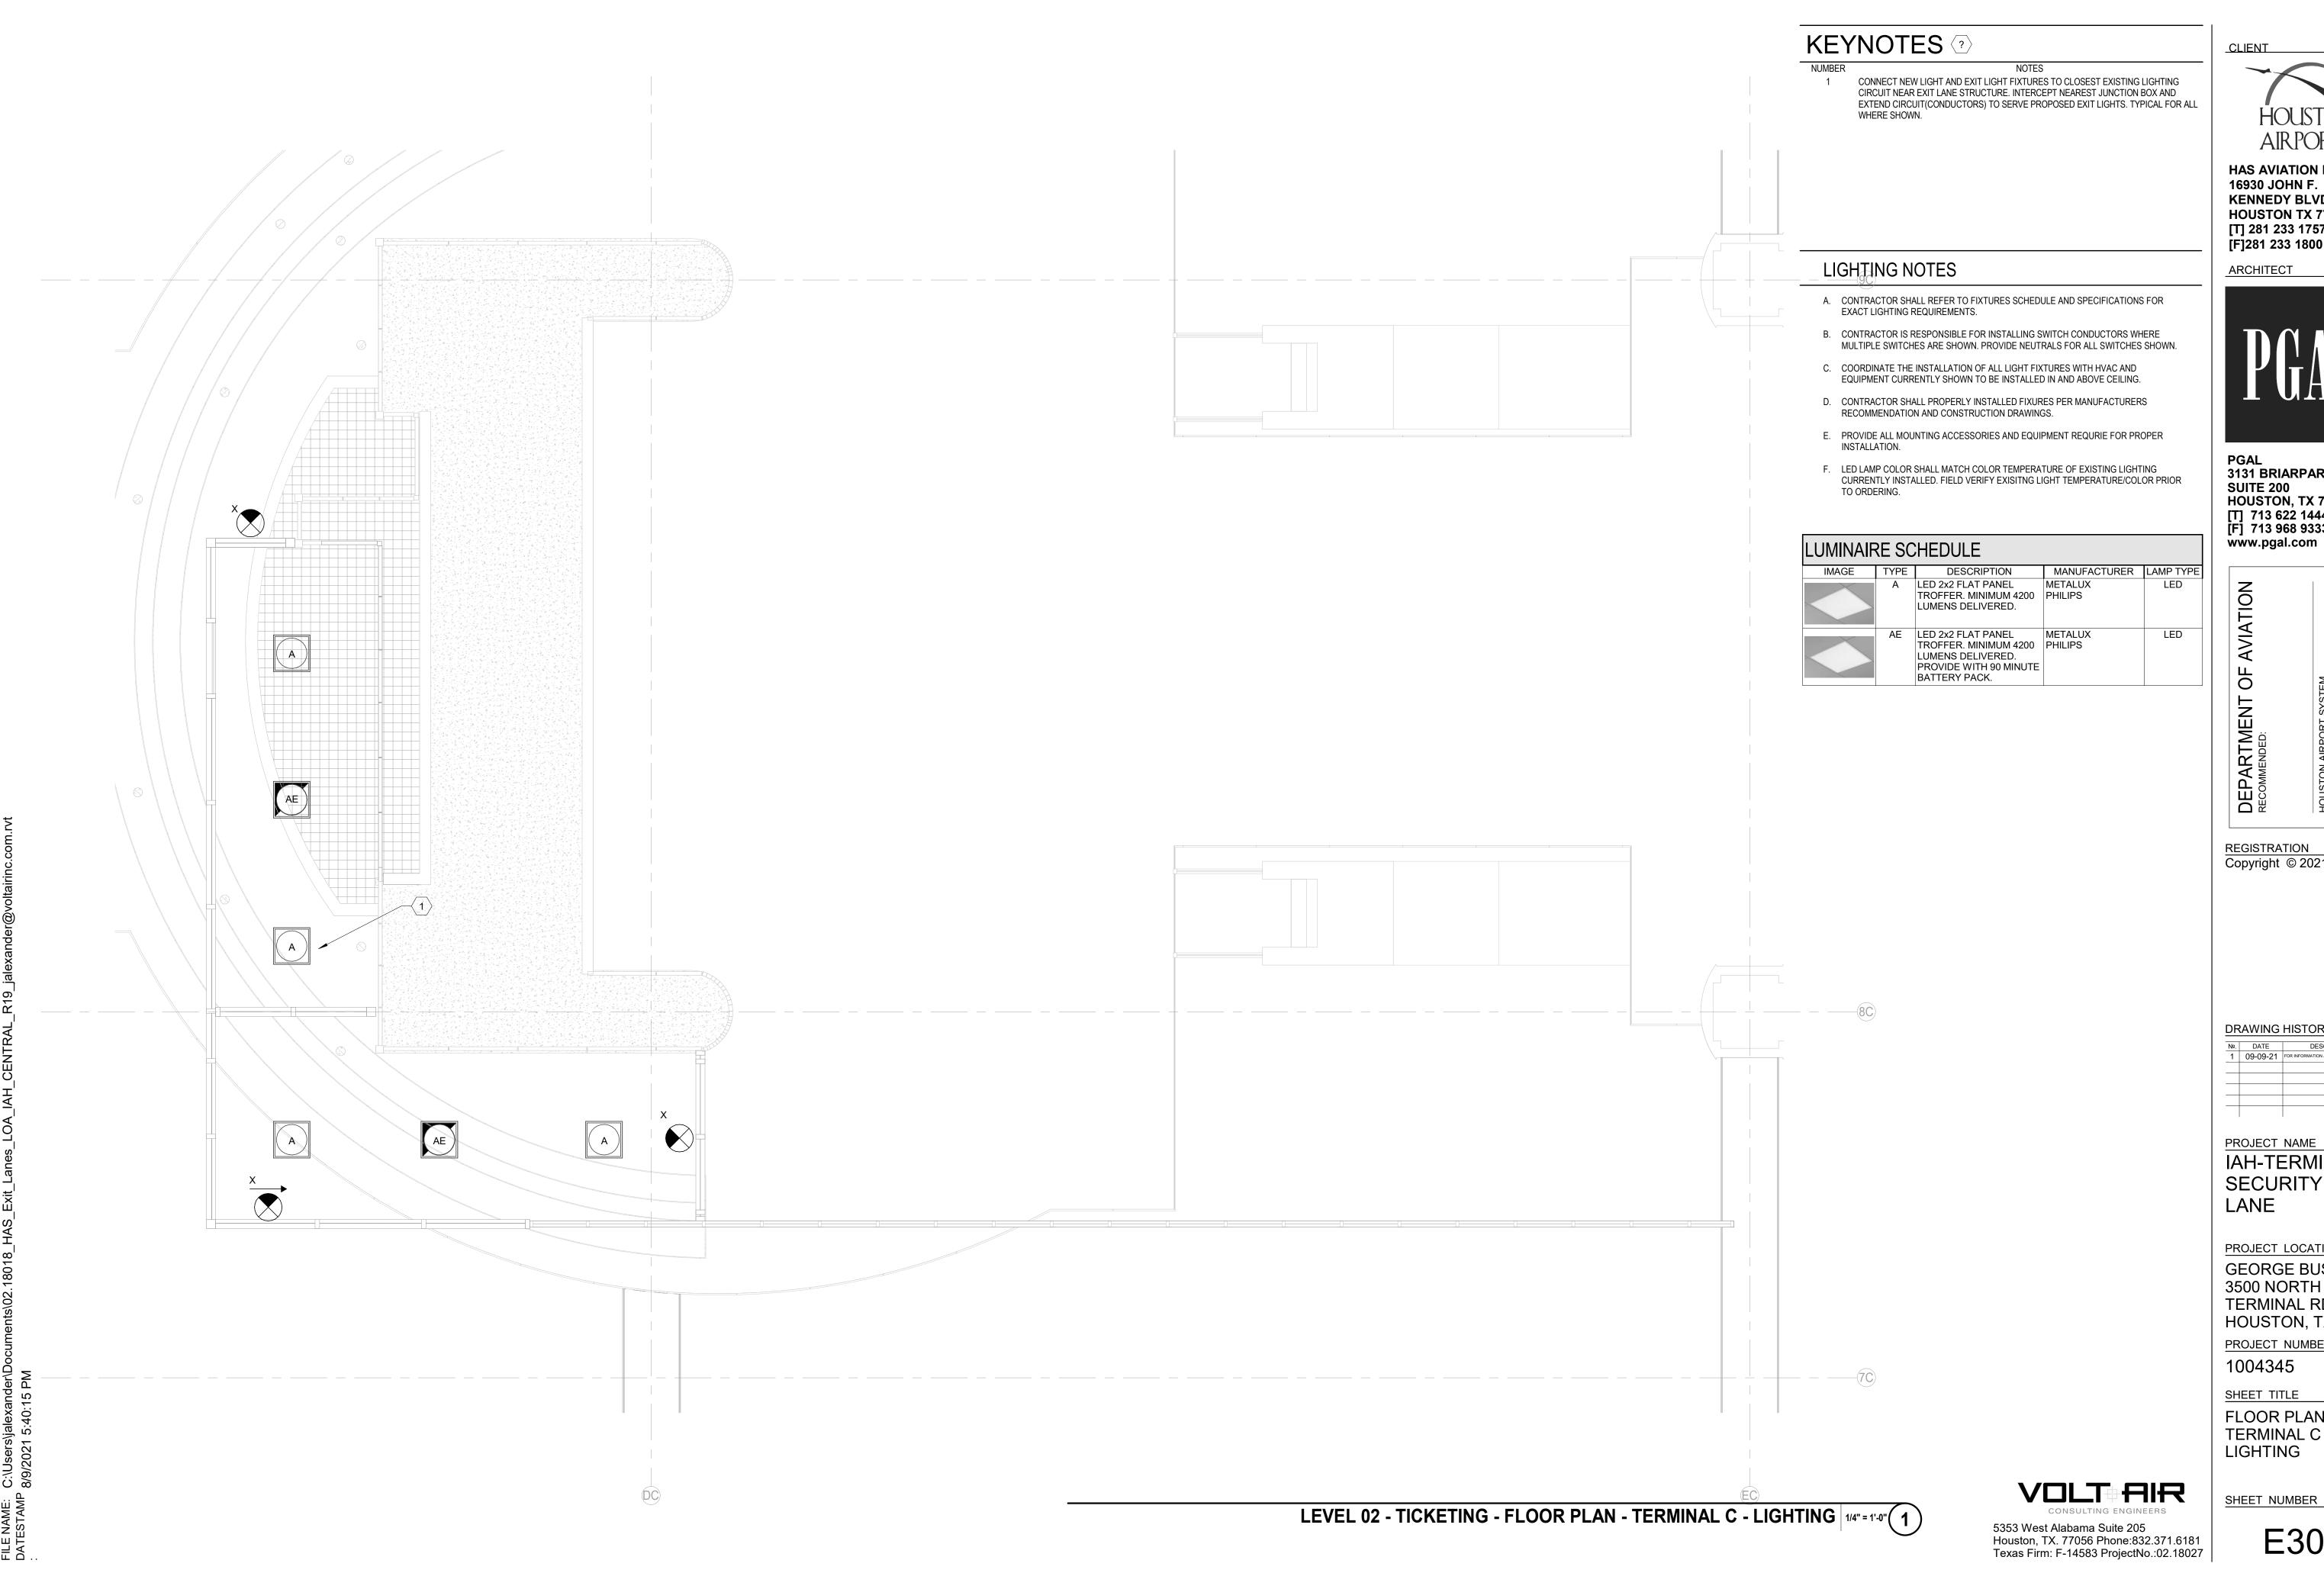

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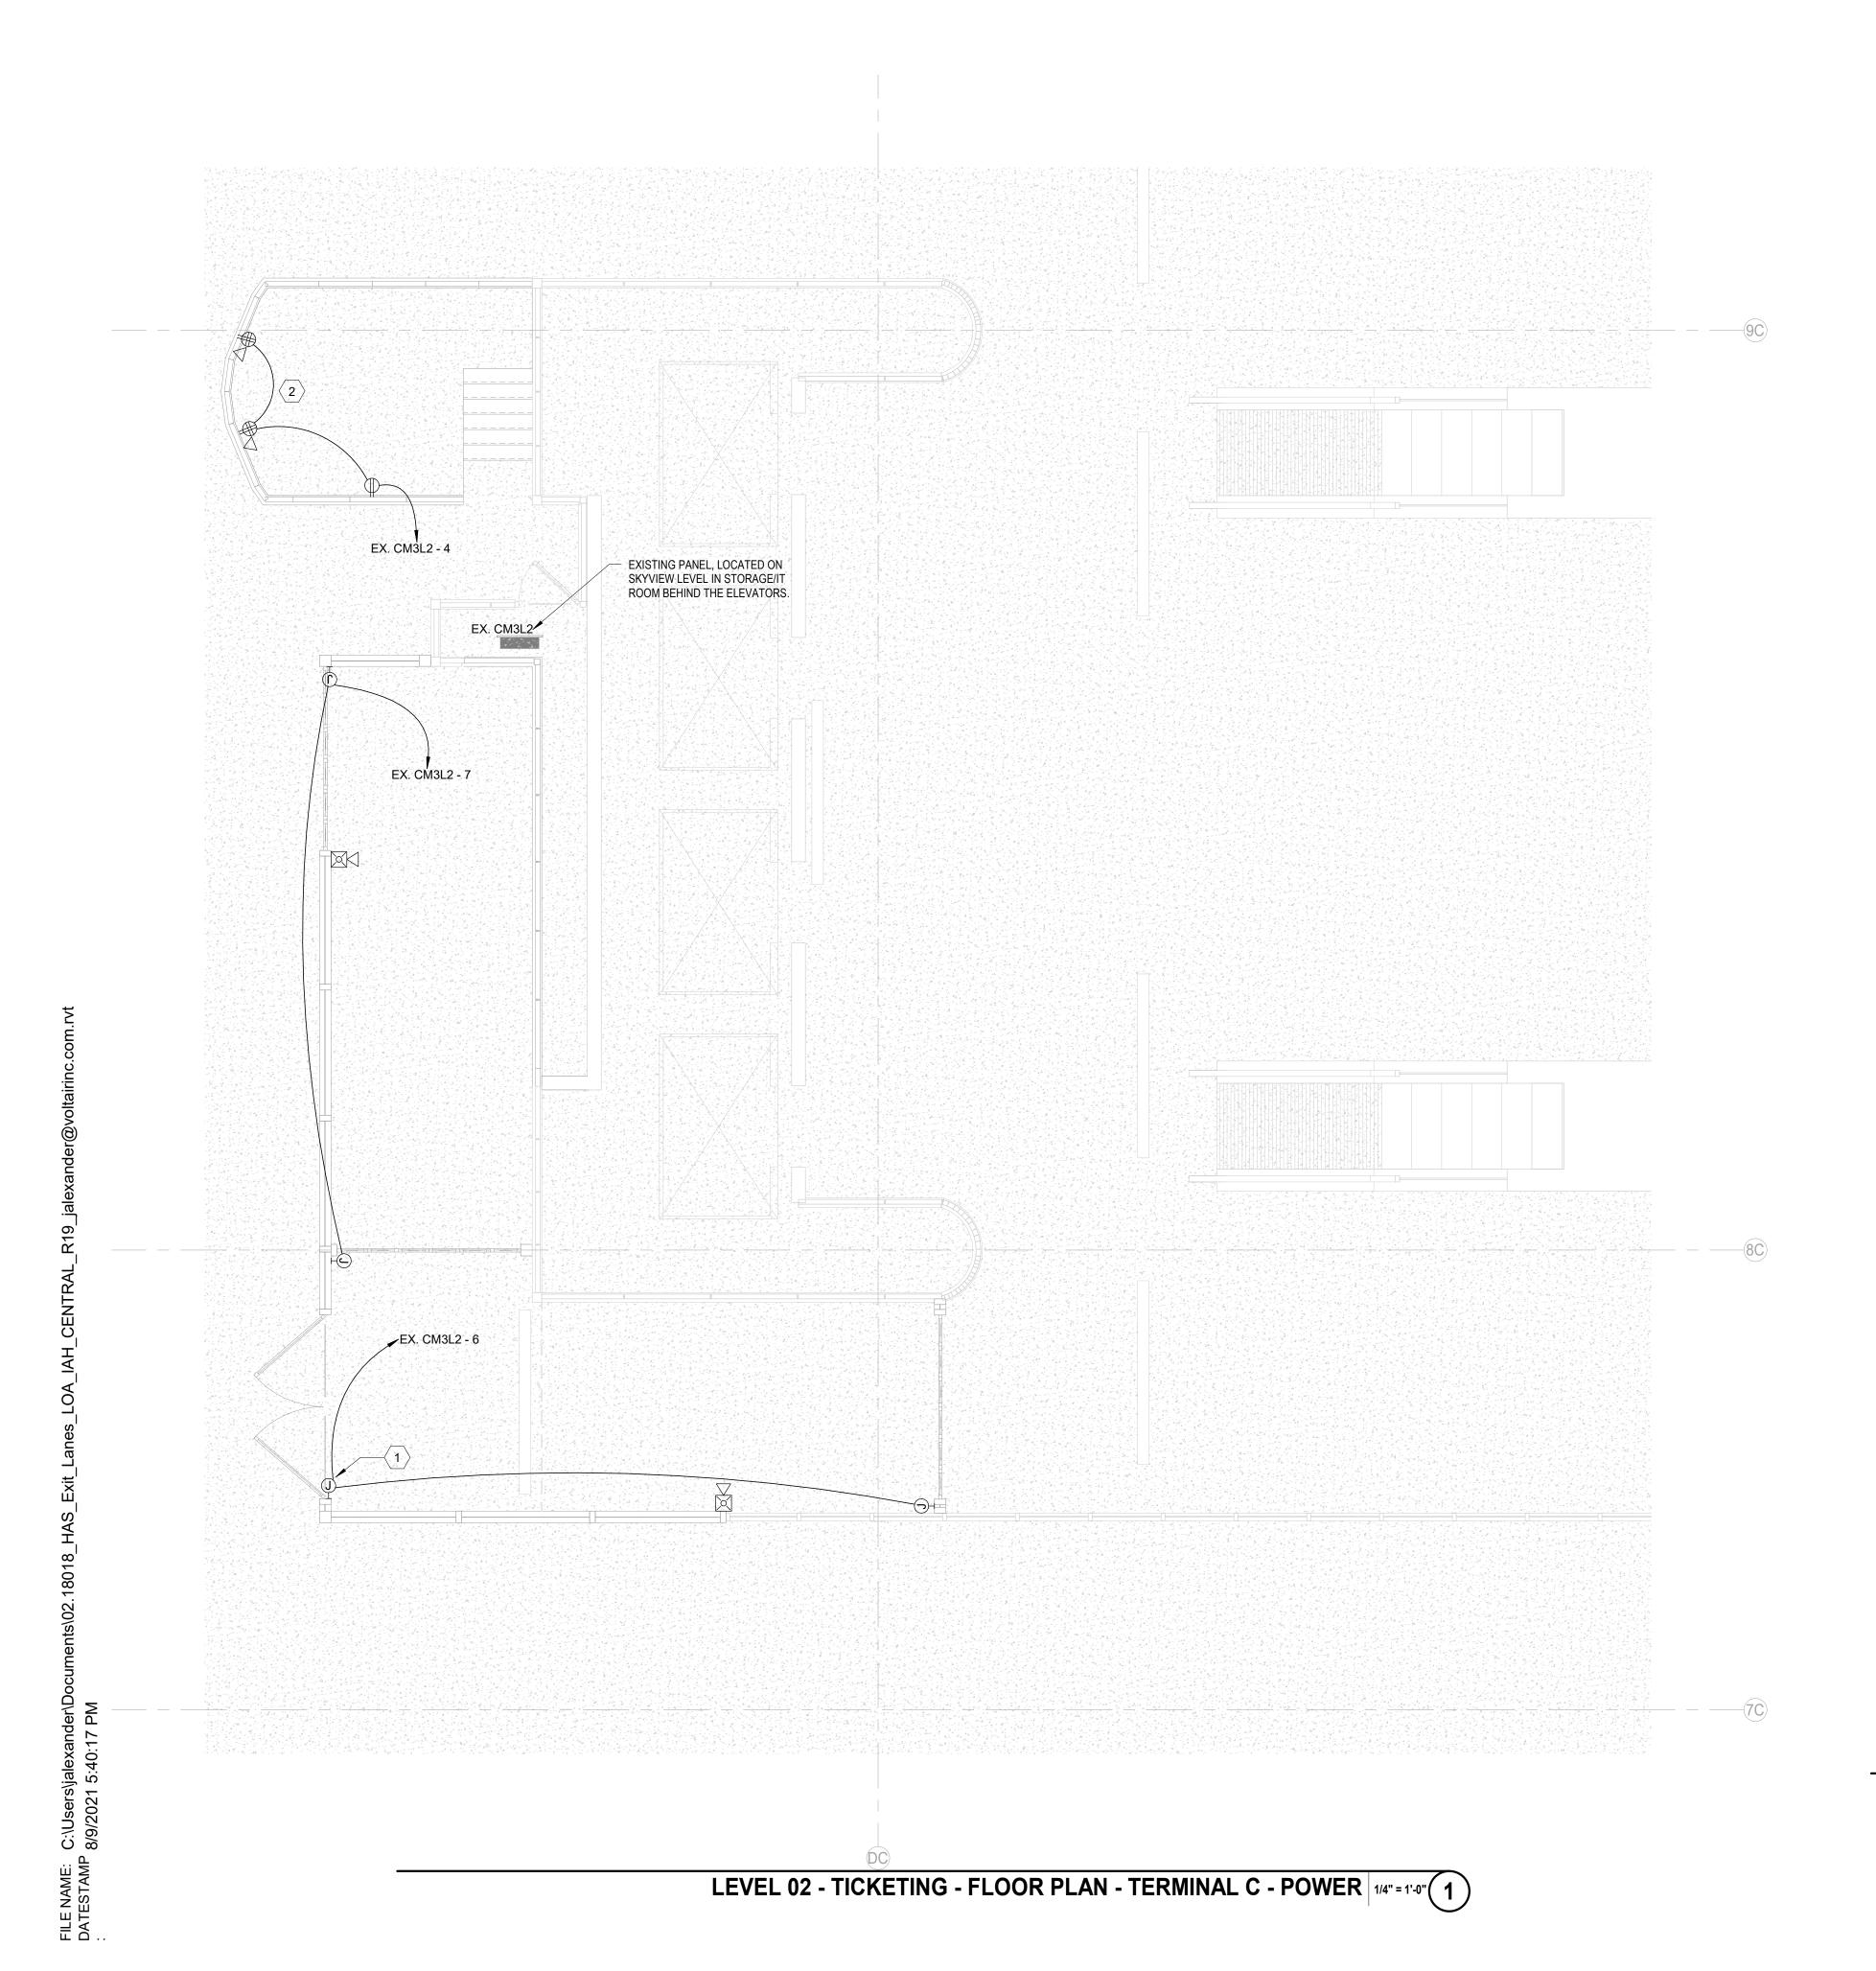
IAH-TERMINAL -SECURITY EXIT LANE

PROJECT LOCATION GEORGE BUSH IAH 3500 NORTH TERMINAL RD. HOUSTON, TX 77032 PROJECT NUMBER

1004345

SHEET TITLE FLOOR PLAN -TERMINAL C -

SHEET NUMBER



KEYNOTES ?

MANUFACTURES DOCUMENTATION FOR PROPER INSTALLATION AND ROUTING OF CONCEALED CONDUIT. ADDITIONAL CIRCUIT MAY BE REQUIRED PER DOOR MANUFACTURER. FINAL VERIFICATION WILL OCCUR DURING SUBMITTAL PROCESS. ROUTE #10'S IN 1" CONDUIT FROM PANEL TO CLOSEST JUNCTION BOX LOCATION AT THE EXIT LANE HOUSING.

WORKSTATIONS TO NEW PROPOSED LOCATION.

- A. COORDINATE WITH ARCHITECTURAL ELEVATIONS AND TELECOMM DRAWINGS
- B. PROVIDE ADHESIVE LABELS FOR ALL RECEPTACLE OUTLETS SHOWN ON PLANS.
- C. REFER TO TELECOMM (T-SERIES) DRAWINGS FOR EXACT LOCATIONS OF ALL
- D. UPS AND BATTERY CABINET SHALL BE OWNER FURNISHED AND INSTALLED BY CONTRACTOR. COORDINATE WITH PROJECT MANAGER FOR EXACT REQUIREMENTS
- E. COORDINATE EXACT RECEPTACLE TYPE WITH OWNER PRIOR TO COMMENCEMENT OF WORK. IF L6-20P ARE REQUESTED FROM OWNER, CONTRACTOR SHALL PROVIDE PLUG ADAPTER TO CONVERT TWIST-LOCK DEVICE TO A STRAIGHT PLUG. BASIS OF DESIGN REFLECTS THE PROVISION OF L5-30P DUPLEX RECEPTACLES.
- F. PROVIDE JUNCTION BOX AND OR HOUSINGS FOR ALL SURFACE MOUNTED RECEPTACLES.
- G. ALL WALL PENETRATIONS SHALL BE SEALED WITH UL LISTED FIRE RATED CAULKING MATERIAL.
- H. CONTRACTOR SHALL OBTAIN AND REVIEW TELECOMM (T-DRAWINGS) AND PROVIDE ALL POWER REQUIREMENTS PER NOTED LOCATION ON PLANS. PROVIDE ALL REQUIRED OUTLETS, BREAKERS, RACEWAYS, CONDUCTORS, ETC. FROM NEAREST UPS SUPPORTED ELECTRICAL PANELS.
- - BIDDING PURPOSES ONLY AND NOT FOR CONSTRUCTION OR INSTALLATION. THE LOCAL JURISDICTION. THE FIRE ALARM CONTRACTOR SHALL EXTEND THE EXISTING FIRE ALARM SYSTEM DESIGN. TEXAS STATE FIRE MARSHALL FIRE ALARM PLANNING



1 PROVIDE 120V POWER FOR DOOR MOTOR AND CONTROLS. VERIFY WITH

EXTEND EXISTING CIRCUITS, AND CONDUCTOR THAT SERVE THE PREVIOUS HPD



- PRIOR TO ROUGH-IN OF ANY OUTLET DEVICES.
- BACKBONE/COMMUNICATION CONDUITS AND GROUNDBARS.
- AND INSTALLATION DETAILS.

- I. ROUTE ALL FIRE ALARM DEVICES SHOWN TO THE EXISTING FIRE ALARM CONTROL
- J. ANY FIRE ALARM DEVICES SHOWN ON ELECTRICAL DRAWINGS ARE SHOWN FOR FIRE ALARM CONTRACTOR SHALL MODIFY THE FIRE ALARM SYSTEM TO PROVIDE FULL COVERAGE OF THE PROJECT AREA IN ACCORDANCE WITH NFPA-72 AND ALL CITY, STATE, NATIONAL CODES AND STANDARDS, AND THE AUTHORITY HAVING FIRE ALARM SYSTEM TO THE NEW SPACE. NEW DEVICES SHALL MATCH EXISTING SUPERINTENDENT AND/OR NICET III CONTRACTOR MUST SUBMIT SHOP DRAWINGS FOR THE INSTALLATION OF THE FIRE ALARM SYSTEM TO THE AHJ FOR APPROVAL, INSTALLATION AND PROVIDE AN APPROVED COPY TO THE OWNER FOR RECORDS.

CLIENT



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PROJECT NAME IAH-TERMINAL -

SECURITY EXIT LANE

PROJECT LOCATION GEORGE BUSH IAH 3500 NORTH TERMINAL RD. HOUSTON, TX 77032


PROJECT NUMBER 1004345

SHEET TITLE FLOOR PLAN -TERMINAL C -

SHEET NUMBER

POWER

E403

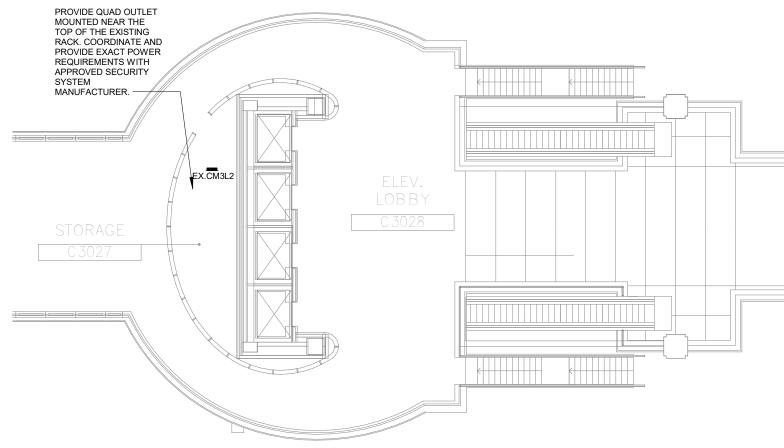

LEVEL 03 - SKYWAY - FLOOR PLAN - TERMINAL C -POWER 1/16" = 1'-0" 2

VOLT AIR 5353 West Alabama Suite 205 Houston, TX. 77056 Phone:832.371.6181 Texas Firm: F-14583 ProjectNo.:02.18027

GENERAL NOTES

- CONTRACTOR IS REQUIRED TO COORDINATE ALL INSTALLATIONS IN EACH SPACE WITH OTHER TRADES. PROVIDE SHOP DRAWINGS AND LAYOUTS FOR EACH ELECTRICAL ROOM WITH PROPOSED CONDUIT ROUTES TO ALLEVIATE POTENTIAL CONFLICTS WITH MECHANICAL, PLUMBING AND TELECOMMUNICATIONS.
- CONTRACTOR SHALL CONDUCT AMPERAGE READINGS FOR THE EXISTING SWITCHGEAR TO VERIFY AMPERAGES FOR EACH PHASE. READINGS SHALL BE RECORDED AND PROVIDED TO THE ENGINEER FOR REVIEW PRIOR TO COMMENCEMENT OF ANY ELECTRICAL INSTALLATIONS.
- PROVIDE PROPER LABELING FOR ALL ELECTRICAL DEVICES. REFER TO SPECIFICATIONS AND DETAILS FOR LABEL TYPES AND REQUIREMENTS.
- CONTRACTOR SHALL PROVIDE ALL NECESSARY MOUNTING EQUIPMENT AND ACCESSORIES REQUIRED FOR PROPER INSTALLATION OF ALL DEVICES TO BE INSTALLED.
- CONTRACTOR SHALL PLACE A LAMINATED COPY OF THE LOAD CALCULATIONS ON THE BOTTOM INTERIOR BEZEL IN EACH PANEL. LOAD CALCULATIONS ARE LOCATED ON THE PANELBOARD SHEETS AT THE BOTTOM OF EACH PANEL SCHEDULE.
- ALL CONDUITS SHALL BE LABELED WITH THE VOLTAGE AND CIRCUITS THAT ARE HOUSED WITHIN. REFER TO SPECIFICATIONS FOR EXACT

KEYED NOTES (#)

- REMOVE AND REPLACE EXISTING PANEL WITH NEW PANEL IN LOCATION SHOWN ON POWER PLANS.
- FIELD VERIFY AND COORDINATE EXACT ROUTING OF CONDUIT PRIOR TO COMMENCEMENT OF WORK. CONDUIT SHALL BE LABELED AND MOUNTED PER H.A.S
- CONTRACTOR SHALL RELOCATE ALL EXISTING POWER SERVING EXISTING DEVICE PREVIOUSLY IN EX. UPS 1 N TO NEW 24 SPACE PANEL. PREPARE ALL NEW CONDUITS, CONDUCTORS, JUNCTION BOX, ETC. TO REDUCE DOWN TIME DURING
- PROVIDE THREE(3)NEW 20A/1P BREAKERS IN EXISTING PANEL TO SERVE DEVICES AT EXIT LANE STRUCTURE. NEW BREAKERS SHALL HAVE THE SAME A.I.C. RATING AS THE BREAKERS THAT ARE CURRENTLY INSTALLED.
- CONTRACTOR SHALL UTILIZE ANY OF THE EXISTING SPARES IN EX. PANEL 2LCW, TO SERVE DOOR MOTORS IN EXIT LANE STRUCTURE.
- CONTRACTOR SHALL CONTACT CURRENT UPS MANUFACTURER REP TO SCHEDULE MAINTENANCE ON EXISTING UPS TO VERIFY IF ONLY THE BATTERIES NEED TO BE REPLACE OR IF THE UPS DEVICE IS DEFECTIVE. BASIS OF WORK SHALL BE TO ORDER NEW BATTERIES FOR THE UPS DEVICE. CONTRACTOR SHALL BE PROVIDED WITH \$40,000 ALLOWANCE FOR NEW UPS DEVICE AND BATTERIES IF DEVICE IS FOUND DEFECTIVE.

LEGEND

NEW EQUIPMENT — — — EXISTING EQUIPMENT TO REMAIN SURGE PROTECTION DEVICE

LOAD ANALYSIS

EXISTING MAX DEMAND LOAD = 8.5 KVA NEW LOAD = 2.720 KVA

TOTAL LOAD ON PANEL = 11.220KVA (31A)

NEW PROPOSED LOAD DOES NOT EXCEED 100A CAPACITY

IDF ROOM MEZZANINE LEVEL ABOVE TICKETING 100A MCB, 208/120V, 3ф, 4W NEMA 1 FED FROM CB4LDP— TO BRANCH CIRCUITS TICKETING LEVEL SERVING EXIT LANES EXIST LANE, BREACH CONTROL STRUCTURE

> **ELECTRICAL POWER RISER DIAGRAM** NOT TO SCALE

Branch Panel: EX. CM3L2 Location: ELECTRICAL CHASEWAY A.I.C. Rating: Volts: 120/208 Wye Supply From: Mains Type: MCB Phases: 3 Mains Rating: 100 A Mounting: Surface MCB Rating: 100 A Enclosure: Type 1 PROVIDE NEW BREAKERS WITH THE SAME A.I.C. RATINGS FOR ALL NEW BREKERS SHOWN TO BE INSTALLED.
 20
 1
 360
 520
 1
 20

 20
 1
 600
 900
 1
 20
 1 Ex. Load 3 Ex. Load
 20
 1
 000
 900
 1
 20

 20
 1
 360
 0
 1
 20

 20
 1
 360
 0
 1
 20

 20
 1
 100
 0
 1
 20
 5 Ex. Load 7 Receptacle 9 Receptacle 12 14 30 3 2200 19 Existing Load 22 2200 2200 4800 VA 2980 VA Total Load 3440 VA Total Amps 29 A 41 A 25 A Legend: Load Classification Panel Totals **Estimated Demand** Connected Load 100.00% Receptacle 2720 VA 2720 VA 5525 VA Total Conn. Load: 11220 VA 8500 VA 65.00% Total Est. Demand: 8245 VA Total Conn.: 31 A Total Est. Demand: 23 A 1. UTILIZE EXISTING 20A/1P BREAKERS FOR PROPOSED LOADS. PROVIDE AND INSTALL NEW 20A/1P BREAKERS FOR PROPOSED LOADS.

<u>CLIENT</u>

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DEPARTMENT OF AVIATION RECOMMENDED:	HOUSTON AIRPORT SYSTEM DIRECTOR OR DESIGN REPRESENTATIVE HAS TIP 21-156 - IAH
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PROJECT NAME IAH-TERMINAL -SECURITY EXIT LANE

PROJECT LOCATION GEORGE BUSH IAH **3500 NORTH** TERMINAL RD. HOUSTON, TX 77032 PROJECT NUMBER

1004345


SHEET TITLE **ELECTRICAL RISER** DIAGRAMS

VOLT AIR 5353 West Alabama Suite 205

Houston, TX. 77056 Phone:832.371.6181 Texas Firm: F-14583 ProjectNo.:02.18027

SHEET NUMBER



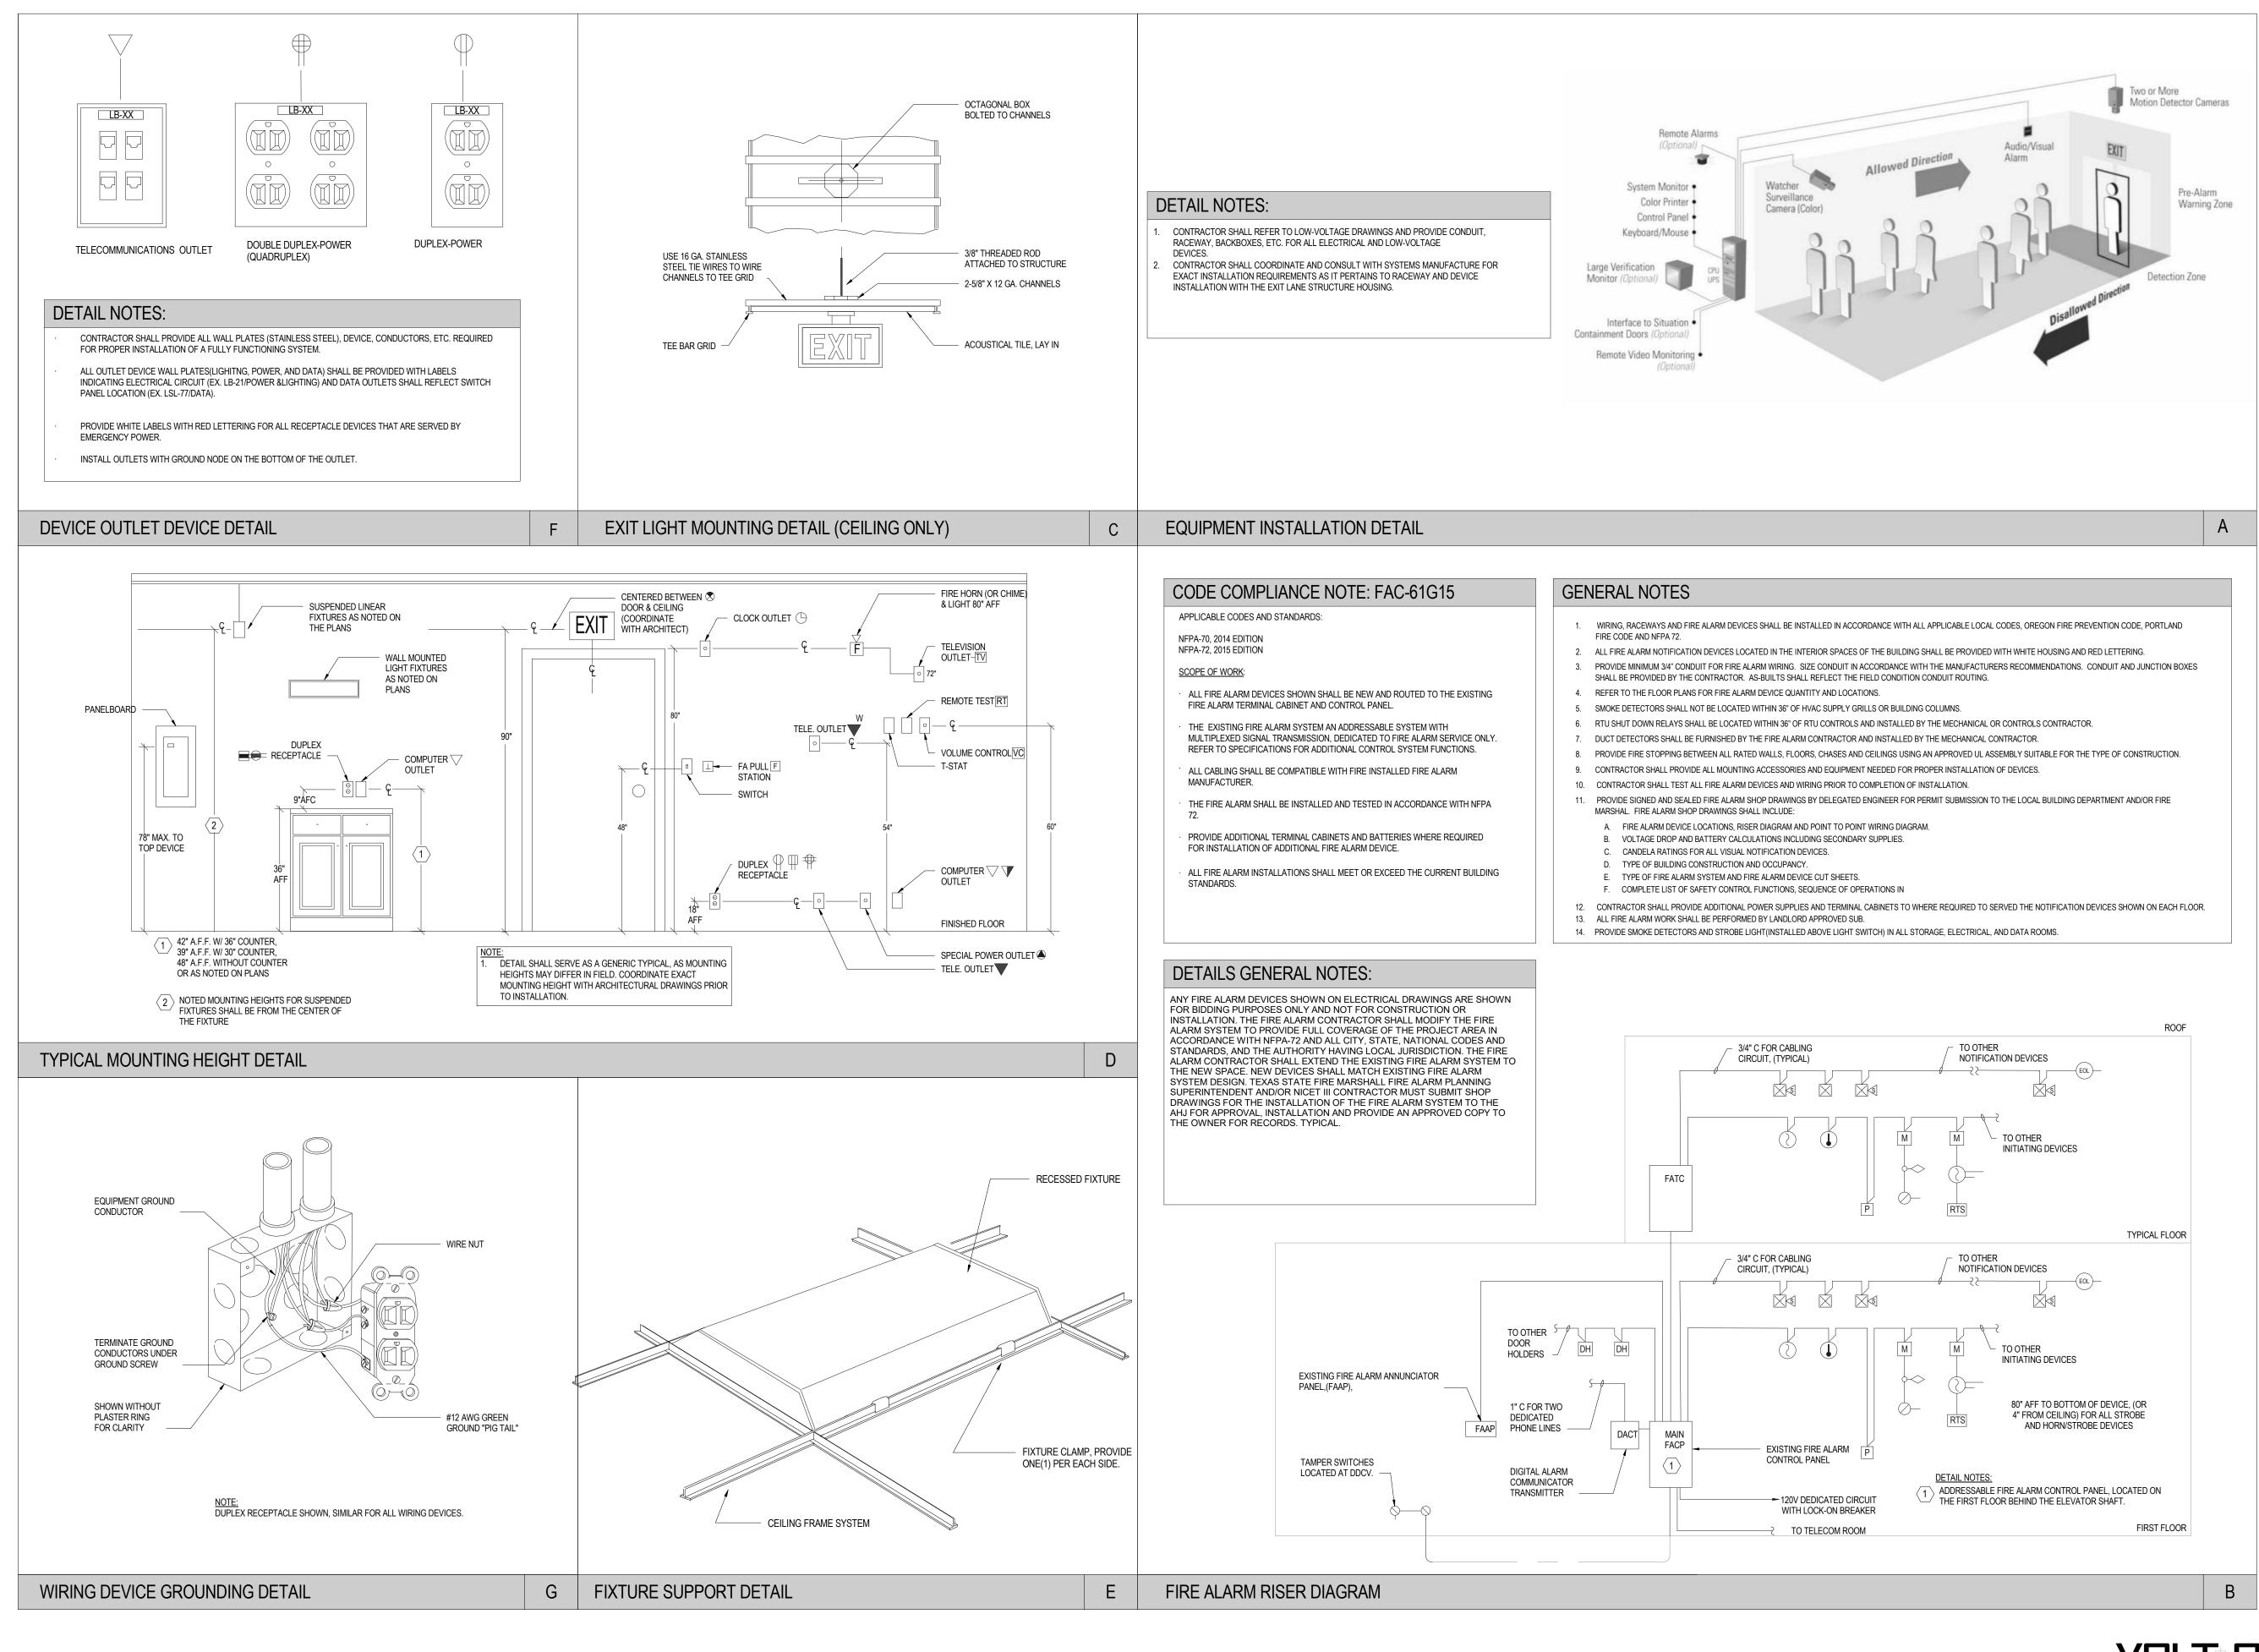

Texas Firm: F-14583 ProjectNo.:02.18027

SHEET NUMBER 5353 West Alabama Suite 205 E901 Houston, TX. 77056 Phone:832.371.6181

<u>CLIENT</u>

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SHEET TITLE

DETAILS

ELECTRICAL

GEORGE BUSH IAH

HOUSTON, TX 77032

№. DATE DESCRIPTION 1 09-09-21 FOR INFORMATION AND REFERENCE ONLY


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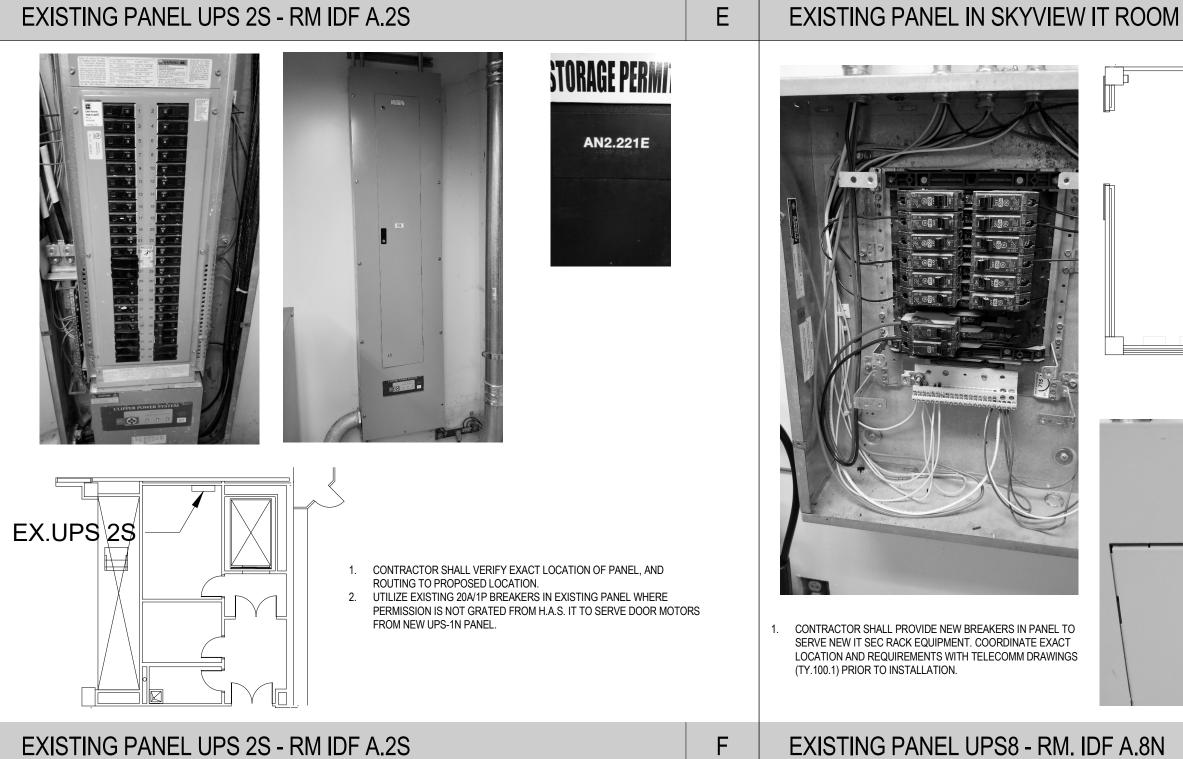










FIRE ALARM CONTROL PANEL IDF ROOM TERMINAL A NORTH

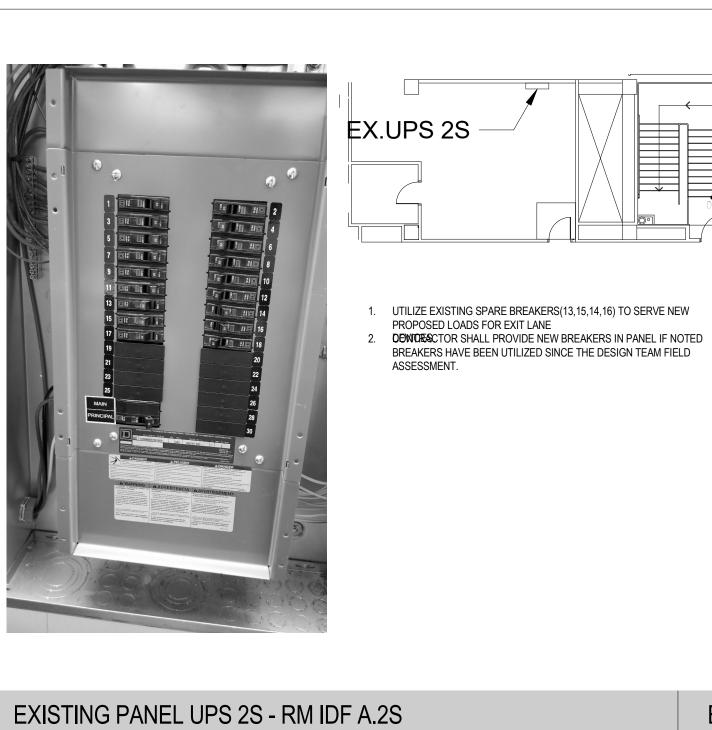

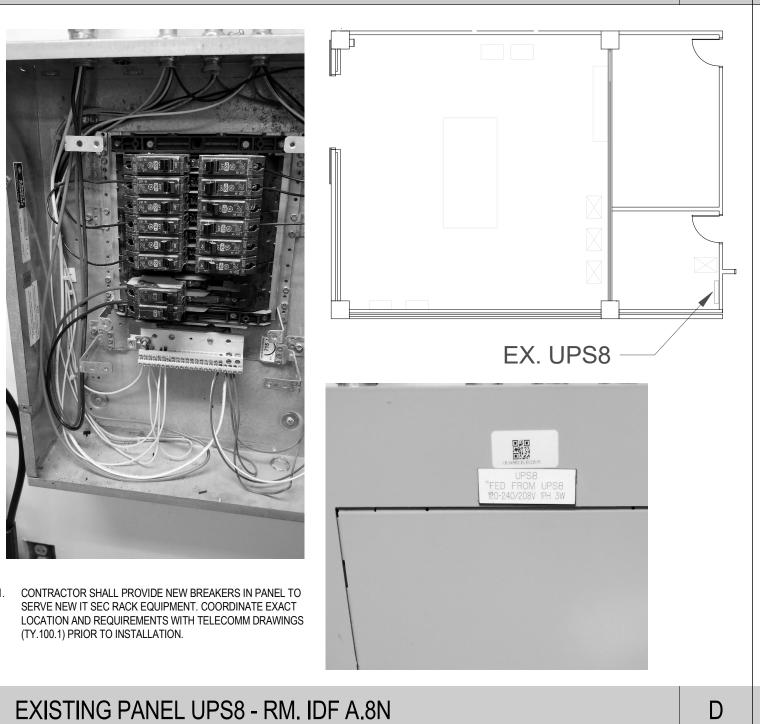



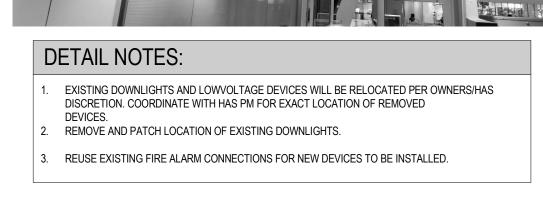

EXISTING SOFFIT - TERMINAL C

В

5353 West Alabama Suite 205 Houston, TX. 77056 Phone:832.371.6181 Texas Firm: F-14583 ProjectNo.:02.18027

VOLT AIR

CLIENT **AIRPORTS**

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PROJECT NAME IAH-TERMINAL -SECURITY EXIT LANE

PROJECT LOCATION GEORGE BUSH IAH 3500 NORTH TERMINAL RD. HOUSTON, TX 77032 PROJECT NUMBER

1004345

SHEET TITLE ELECTRICAL **DETAILS**

SHEET NUMBER

CCVS SYSTEM NOTES

- 1. ALL OUTDOOR CAMERAS, TERMINATION BOXES, AND PULLBOXES SHALL BE INSTALLED WITH WEATHER RESISTANT HARDWARE.
- 2. PROVIDE ALL INTEGRATION WITH ALARM ACCESS CONTROL SYSTEM COMPONENTS.
- 3. PROVIDE ALL COORDINATION WITH OTHER DISCIPLINES FOR INSTALLATION OF EQUIPMENT.
- 4. COORDINATE ALL SITE WORK WITH OWNER'S REP.
- 5. DRAWINGS INDICATE CAMERA 'HOME POSITIONS'. VERIFY FIELD OF VIEW WITH HOUSTON AIRPORT SYSTEM (HAS) REPRESENTATIVE AND DESIGN CONSULTANT DURING INSTALLATION. SUBSTITUTION OF LENS TYPE & SIZE TO ACCOMPLISH INTENDED FIELD OF VIEW SHALL BE AT NO ADDITIONAL COST.
- 6. CAMERAS MAY INCLUDE MULTIPLE TRANSMISSION METHODS. VERIFY EACH CAMERA PRIOR TO INSTALLATION.
- 7. FIELD VERIFY ALL CAMERA LOCATIONS PRIOR TO INSTALLATION. CAMERA MAY BE RELOCATED WITHIN 25' OF LOCATION SHOWN ON FLOOR PLANS WITHOUT ADDITIONAL COST.

CAMERA SERVER AND DIGITAL STORAGE NOTES

- 1. PROVIDE DIGITAL STORAGE FOR THIS PROJECT IN THE HAS ADMIN BUILDING AS REQUIRED.
- 2. THE EXISTING CAMERA SERVERS AND DIGITAL STORAGE ARE LOCATED AT THE HAS ADMINISTRATION BUILDING AND TERMINAL C. THEY ARE REDUNDANT.
- 3. PROVIDE HONEYWELL MAXPRO CAMERA LICENSING AS REQUIRED AT THE HAS ADMINISTRATION BUILDING AND TERMINAL C TO SUPPORT ALL HAS CAMERAS INSTALLED AS PART OF THIS PROJECT.

ACS SYSTEM NOTES

- 1. ALL OUTDOOR MOUNTED CARD READERS SHALL BE INSTALLED WITH WEATHER RESISTANT AND TAMPER PROOF HARDWARE.
- 2. CARD READER PEDESTALS SHALL BE SIZED FOR VOICE COMMUNICATIONS.
- 3. PROVIDE ALL INTEGRATION WITH CLOSED CIRCUIT VIDEO SURVEILLANCE COMPONENTS.
- 4. PROVIDE ALL COORDINATION WITH OTHER DISCIPLINES FOR INSTALLATION OF EQUIPMENT.
- 5. COORDINATE ALL SITE WORK WITH OWNERS REP.
- 6. PROVIDE ACCESS CONTROL LICENSES AS REQUIRED PART OF THIS PROJECT.
- 7. CARD READER ICLASS ELITE KEY SHALL BE REQUIRED, AND ONLY AUTHORIZED PURCHASER ARE AUTHORIZED TO PURCHASE. THE ICLASS ELITE PROGRAM INCLUDES A CREDENTIAL FORMAT AND CUSTOM AUTHENTICATION KEY.

EQU	IPMENT SYMBOLS LIST
SYMBOL	DESCRIPTION
CR	CARD READER
СВ	CALL BOX (VOIP) W/ CAMERA
360	360 IP CAMERA
FIX	FIXED CAMERA
PTZ	PTZ HD IP CAMERA
DB	DURESS BUTTON (UNDER DESK/TABLE/COUNTER)
D	DOOR POSITION SWITCH (FLUSH MOUNT)
⟨M⟩	REX MOTION SENSOR
RCT	REMOTE COMMAND TERMINAL (BY OTHER)
CCR	CENTRAL CONTROL RACK (BY OTHER)
AO	AUTO DOOR OPERATOR (BY OTHER)
∇	PHONE
_	DATA
V _x	CATEGORY 6 DATA OUTLET WHERE X= QUANTITY OF CABLES

SHEET NO.	SHEET NAME
TY000	INDEX, SYMBOLS & NOTES
TY001	NOTES
TY002	EQUIPMENT SCHEDULES
TY102.2	OVERALL SECURITY FLOOR PLAN - TERMINAL C, LEVEL 02
TY102.3	OVERALL SECURITY FLOOR PLAN - TERMINAL C, LEVEL MEZZANINE
TY202	SECURITY FLOOR PLAN - TERMINAL C CENTRAL, LEVEL 02
TY404	ENLARGED PLAN AT BDF C3320
TY500	DOOR AND IFP DETAILS
TY501	CAMERA DETAILS
TY502	TELECOM DETAILS

CLIENT



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RPORT SYSTEM

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ISSUE FOR REVIEW

DRAWING HISTORY

Nº. DATE DESCRIPTION
1 09-09-21 FOR INFORMATION AND REFERENCE

PROJECT NAME

IAH-TERMINAL SECURITY EXIT
LANE

PROJECT LOCATION

GEORGE BUSH IAH
3500 NORTH
TERMINAL RD.
HOUSTON, TX 77032

PROJECT NUMBER

1004345

SHEET TITLE
INDEX, SYMBOLS &
NOTES

SHEET NUMBER

TY000

NAME: ESTAMP

TELECOM GENERAL NOTES

- 1. FOLLOW TELECOM STANDARDS AND PRACTICES. SEE DIVISION 27 SPECIFICATIONS AND T DRAWINGS
- 2. REGISTERED COMMUNICATIONS DISTRIBUTION DESIGNER (RCDD) SUPERVISOR SHALL REVIEW, APPROVE AND STAMP ALL SHOP DRAWINGS. COORDINATE DRAWINGS AND RECORD DRAWINGS.
- 3. ALL WALL PENETRATIONS SHALL BE SEALED WITH APPROVED FIRE STOPPING.
- 4. REFER TO THE ELECTRICAL FLOOR PLAN DRAWINGS FOR ADDITIONAL ROUGH-IN REQUIREMENTS. WHERE THERE ARE DRAWING DISCREPANCIES, THE CONTRACTOR SHALL INSTALL THE GREATER QUANTITY OF DEVICES.
- 5. REFER TO THE SITE PLAN ON AND RISER DIAGRAM FOR TELECOMMUNICATION BACKBONE CONDUITS/CABLES. FIELD COORDINATE EXACT ROUTING WITH OTHER TRADES.
- 6. ALL COMMUNICATIONS EQUIPMENT SHOWN SHALL BE PROVIDED AND INSTALLED BY CONTRACTOR UNLESS NOTED OTHERWISE.
- 7. BOND ALL COMMUNICATIONS CABINETS, RELAY RACKS, CABLE TRAYS, AND OTHER METALLIC SUPPORTING DEVICES TO TELECOMMUNICATIONS GROUND BUSBAR INSIDE COMMUNICATIONS ROOM. BOND WITH A #6 GROUND CONDUCTOR.
- 8. ALL HORIZONTAL VOICE AND DATA CABLES SHALL BE DISTRIBUTED VIA MINIMUM 1" CONDUIT AND/OR CABLE TRAY. NO
- 9. SINGLE LINE DIAGRAMS, SCHEMATICS, DETAILS AND CONDUIT PATHS SHOWN HEREIN ARE CONCEPTUAL AND ILLUSTRATE ONLY THE FUNCTIONAL RELATIONSHIPS BETWEEN COMPONENTS OF THE SYSTEM. ACCORDINGLY, FULL SHOP DRAWING DEVELOPMENT IS REQUIRED TO REALIZE THE SPECIFIED FUNCTIONS.
- 10. DEVICE LOCATIONS ON PLANS ARE CONCEPTUAL. LOCATE AS SITE CONDITIONS REQUIRE AND AS APPROVED BY GC.
- 11. REFER TO THE BID SPECIFICATION FOR ADDITIONAL REQUIREMENTS REGARDING THIS WORK.
- 12. PAINTING, PATCHING AND FINISHES FOR DEVICES LOCATED IN EXISTING AREAS SHALL MATCH EXISTING FINISHES AS APPROVED BY GC.
- 13. FINISHES OF DEVICES IN NEW/REMODEL AREAS SHALL BE APPROVED BY GC.

DESIGNATION TABLE FOR SHOP DRAWING AND RECORD DRAWING SUBMITTALS.


- 14. WORK AND MATERIALS SHALL CONFORM TO THE MOST CURRENT UNIFORM STANDARD SPECIFICATIONS AND DETAILS FOR CONSTRUCTION AS FURNISHED BY GC. WORK AND MATERIALS NOT IN CONFORMANCE WITH THESE SPECIFICATIONS AND DETAILS ARE SUBJECT TO REMOVAL AND REPLACEMENT AT THE CONTRACTOR'S EXPENSE.
- 15. IN SOME INSTANCES THE IDF MAY BE OVER 90 METERS FROM THE IP DEVICE DUE TO LEGACY DESIGN STANDARDS WHEN THE BUILDING WAS CONSTRUCTED. IF TESTED CABLE DOES NOT PASS CERTIFICATION. CONTRACTOR MUST USE MIDSPAN EXTENDER INSTALLED INSIDE OF ENCLOSURE. REFERENCE DETAIL SHEETS FOR INSTALLATION DIAGRAM.

SECURITY CABLE DESIGNATION/TYPE	GNATION/TYPE *	DESI	CABLE	RITY	SECU
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DESIGNATION	DESCRIPTION	USAGE	PART#
Α	1 PAIR 22AWG SHIELDED	ALARM MONITORING	BELDEN 5500FE
В	2 PAIR 20AWG SHIELDED	MOTION DETECTOR, BEAM DETECTORS	BELDEN 5441 FE
С	3 PAIR 22AWG SHIELDED	CARD READER	BELDEN 5542 FE
D	2/C 18AWG	CAMERA PWR, PUSH BUTTON, LOCK PWR	BELDEN 5300 UE
E	2 PAIR 22AWG SHIELDED	DATA, CCVS PTZ CONTROL	BELDEN 5541 FE
F	2/C 18AWG SHIELDED	HORN	BELDEN 5300 UE
G	COAXIAL W/2C POWER	VIDEO	
Н	1 PAIR 20AWG TWISTED	INTERCOM	BELDEN 5400 FE
I	1 PAIR TWISTED SH 18AWG PLUS 2/C 18AWG	EMERGENCY PHONE	BELDEN 5302GE
J	ENHANCED CAT-5E BONDED-PAIR UTP	NETWORK AND CAMERA	BELDEN 7815A
K	ACCESS CONTROL COMPOSITE CABLE, 4C 18AWG,3PR 22 AWG, 4C 22 AWG	LOCK PWR, CR, DOOR CONTACT, REX, 1 SPARE YELLOW JACKET	WSECCOMP2835
L	CCTV COMPOSITE CABLE 2C 18AWG, UNSHIELDED, CABLE ETHERNET (PLENUM), R659 (PLENUM)	CAM PWR, UTP/IP VIDEO ANALOG VIDEO CONNECT K112	WSECOMP-2817

 * THIS TABLE IS REFERENCED AND IS SHOWN AS AN EXAMPLE OF ACCEPTABLE CABLE DESIGNATIONS. CONTRACTOR SHALL UTILIZE

CONDUIT DESIGNATION KEY

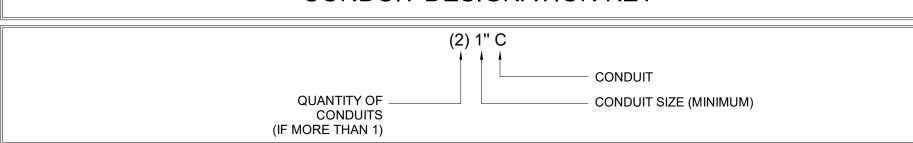

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SECURITY GENERAL NOTES

- THE DRAWINGS OR IN THE BID SPECIFICATION.
- 2. SINGLE LINE DIAGRAMS, SCHEMATICS, DETAILS AND CONDUIT PATHS SHOWN HEREIN ARE CONCEPTUAL AND ILLUSTRATE ONLY THE FUNCTIONAL RELATIONSHIPS BETWEEN COMPONENTS OF THE SYSTEM. ACCORDINGLY, FULL SHOP DRAWING DEVELOPMENT
- 3. DEVICE LOCATIONS ON PLANS ARE CONCEPTUAL. LOCATE AS SITE CONDITIONS REQUIRE AND AS APPROVED BY THE OWNER.
- 4. REFER TO THE BID SPECIFICATION FOR ADDITIONAL REQUIREMENTS REGARDING THIS WORK.
- 5. INSTALL WALL MOUNTED CARD READERS, PUSH BUTTON SWITCHES, KEYPADS, KEY SWITCHES AND OTHER WALL MOUNTED FIELD DEVICES, AT 48 INCHES MAXIMUM ABOVE FINISHED FLOOR, UNLESS OTHERWISE NOTED. MOUNTING HEIGHT SHALL COMPLY WITH TEXAS ACCESSIBILITY STANDARD (TAS).
- AND HAND OF DOOR) MAY VARY.
- 8. WORK AND MATERIALS TO CONFORM TO THE MOST CURRENT UNIFORM STANDARD SPECIFICATIONS, ASSOCIATED CODES REFERENCED BY THE (AHJ) AUTHORITY HAVING JURISDICTION, AND DETAILS FOR CONSTRUCTION, AS FURNISHED BY THE OWNER. WORK AND MATERIALS, NOT IN CONFORMANCE WITH PROJECT SPECIFICATIONS AND DETAILS, ARE SUBJECT TO REMOVAL AND REPLACEMENT AT THE CONTRACTOR'S EXPENSE.
- 9. FOR INFORMATION REGARDING FIRE RATINGS AND OCCUPANCY SEPARATIONS, REFER TO ARCHITECTURAL PLANS AND
- 10. NEW CONDUIT CONNECTIONS TO INCLUDE INTEGRAL PROTECTIVE BUSHINGS OR CHASE NIPPLES.
- 11. NEW CONDUIT FOR FUTURE USE TO BE FILLED WITH 200 POUND STRENGTH PULL LINE. PROVIDE LABELING ON EACH END OF THE PULL LINE TO INDICATE LOCATION OF OTHER END.
- 12. NEW CONDUITS SHALL BE CONCEALED WHENEVER POSSIBLE. SURFACE MOUNTED CONDUITS ARE PERMISSIBLE ONLY WHERE APPROVED. USE ONLY CONCEALED CONDUITS WITHIN FINISHED SPACES. THE ABOVE STANDARDS ALSO APPLY TO EXTERIOR SPACES. SEEK APPROVAL FROM THE OWNER FOR EACH AREA WHERE SURFACE CONDUIT IS NECESSARY.
- 13. JUNCTION BOXES SHALL BE MINIMUM 4 INCH SQUARE DEEP STYLE, SIZED AS REQUIRED TO ACCOMMODATE CONDUITS UNLESS OTHERWISE NOTED. PROVIDE MOUNTING RING AS REQUIRED. PROVIDE A BLANK COVER PLATE FOR JUNCTION BOXES AND PULL BOXES WITH NO DEVICE.

- LOADS. COORDINATE WITH OWNER IF ADDITIONAL CIRCUITS ARE REQUIRED.
- 17. CONTRACTOR TO VERIFY CONDUIT AND PLENUM CABLE PATHS INDICATED ON THE DRAWINGS. CONTRACTOR MAY PROPOSE
- 18. CONTRACTOR IS RESPONSIBLE FOR CEILING INTEGRITY, THIS INCLUDES ROUTING ABOVE CONCEALED SPLINE INTERLOCKING
- 19. CONTRACTOR TO OBTAIN RECERTIFICATION FOR FIRE RATED DOOR FRAME AND DOOR MODIFIED BY THIS PROJECT.
- 20. ACCESS CONTROL LOW VOLTAGE WIRING TO BE PLENUM RATED.
- 21. DO NOT EXCEED 180° IN AGGREGATE CONDUIT BENDS AND/OR 100' CONDUIT WITHOUT PULLBOX.
- 22. PROVIDE GROUND BUSHING ON ALL CONDUIT END IN EQUIPMENT ROOM. BOND TO APPROVED BUILDING GROUND.
- 23. LABEL CONDUIT EVERY 50' WITH DEVICE ID & EQUIPMENT ROOM ID WITH PERMANENT INK CABLE MADE WITH LASER CABLE MAKER. SECURE TO CONDUIT WITH CLEAR TAPE.
- 24. ALL WALL AND FLOOR PENETRATIONS SHALL BE SEALED WITH APPROVED FIRE STOP.
- 25. ALL CABLES NOT IN CONDUIT ABOVE DROP CEILING SHALL BE INSTALLED IN MIN, 1" J-HOOK EVERY 5'-8". DO NOT EXCEED 40% FILL.
- SECURE TO CONDUIT WITH CLEAR TAPE.
- 25. FIELD VERIFY ALL DIMENSIONS.
- 26. REFER TO THE SPECIFICATION FOR ADDITIONAL REQUIREMENTS REGARDING THIS WORK. CONTRACTOR TO PREPARE PROPOSAL FOR EACH DISCIPLINE. PROVIDE COORDINATION BETWEEN DISCIPLINES FOR CONSTRUCTION.
- 27. NOTIFY DESIGN CONSULTANT AND OWNER WHERE EXISTING CONDITIONS REQUIRE REPAIR PRIOR TO INSTALLATION.
- 28. COORDINATE ALL WORK WITH GENERAL CONTRACTOR.
- 29. ALL CABLE PULLS WITHIN EXISTING AND NEW CONDUITS TO BE MADE AT SAME TIME.
- 30. DEFINITION: BY DIVISION 8 EQUIPMENT PROVIDED AND INSTALLED BY DIVISION 8 CONTRACTOR.
- 31. DEFINITION: BY DIVISION 26 EQUIPMENT PROVIDED AND INSTALLED BY DIVISION 26 CONTRACTOR.

- 1. THE FOLLOWING GENERAL NOTES ARE APPLICABLE AS STATED BELOW, EXCEPT WHERE SPECIFICALLY INDICATED OTHERWISE, ON
- IS REQUIRED TO REALIZE THE SPECIFIED FUNCTIONS.

- 6. PROVIDE PAINTING, PATCHING AND FINISHES, OF MATERIALS AND DEVICES, AS APPROVED BY THE OWNER.
- 7. DOOR DETAILS ILLUSTRATE FUNCTIONAL RELATIONSHIPS. ACTUAL ARCHITECTURAL CONDITIONS (SUCH AS DIRECTION OF SWING
- SPECIFICATIONS.

- 14. EXPOSED BOXES AND PANELS, MOUNTED IN OR ON EXTERIOR WALLS, TO BE NEMA 4.
- 15. NEW CONDUIT TO BE 3/4 INCH EMT MINIMUM, UNLESS OTHERWISE NOTED. EXTERIOR CONDUIT TO BE RIGID.
- 16. USE 120VAC CIRCUITS UNLESS OTHERWISE NOTED. VERIFY CURRENT LOAD ON EXISTING CIRCUITS BEFORE CONNECTING NEW
- ALTERNATE ROUTING WHERE CONFLICTS ARE FOUND.

- 23. LABEL CONDUIT EVERY 50' WITH DEVICE ID & EQUIPMENT ROOM ID WITH PERMANENT INK CABLE MADE WITH LASER CABLE MAKER.
- 24. LOCATE DEVICES AS SITE CONDITIONS REQUIRE.

- 34. DEFINITION: BY DIVISION 27 EQUIPMENT PROVIDED AND INSTALLED BY DIVISION 27 CONTRACTOR.
- 35. DEFINITION: BY DIVISION 28 EQUIPMENT PROVIDED AND INSTALLED BY DIVISION 28 CONTRACTOR.

CLIENT



HAS AVIATION DEPT. 16930 JOHN F. **KENNEDY BLVD. HOUSTON TX 77032**

ARCHITECT



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ISSUE FOR REVIEW

DRAWING HISTORY

DESCRIPTION 1 09-09-21

PROJECT NAME IAH-TERMINAL -

LANE PROJECT LOCATION GEORGE BUSH IAH

SECURITY EXIT

TERMINAL RD. HOUSTON, TX 77032

3500 NORTH

PROJECT NUMBER 1004345

SHEET TITLE NOTES

SHEET NUMBER

ITEM	CAMERA NO.	SHEET NO.	LEVEL	CAMERA VIEW	CAMERA TYPE	CAMERA MOUNTING TYPE	TERMINATING IDF	REFERENCE MOUNTING DETAIL	DESCRIPTION
1	C2.C01	TY202	LEVEL 02	CR C2.R01	HD FIX	CEILING MOUNT	BDF C3320	1/TY501	NEW CAMERA
2	C2.C02	TY202	LEVEL 02	CR C2.R02	HD FIX	CEILING MOUNT	BDF C3320	1/TY501	NEW CAMERA
3	C2.C03	TY202	LEVEL 02	CR C2.R01	HD FIX	CEILING MOUNT	BDF C3320	1/TY501	NEW CAMERA
4	C2.C04	TY202	LEVEL 02	CR C2012	HD FIX	CEILING MOUNT	BDF C3320	1/TY501	NEW CAMERA
5	C2033	TY202	LEVEL 02	ACTIVITY AT LEVEL 2 LOBBY	360	CEILING MOUNT	BDF C3320	1/TY501	RELOCATE EXISTING CAMERA

CAMERA SCHEDULE NTS (1)

ITEM	READER NO.	SHEET NO.	LEVEL	LOCATION	ASSOCIATED CAMERA	TERMINATING IDF	DESCRIPTION
1	C2.R01	TY202	LEVEL 02	TER C EXIT LANE (MIDDLE DOOR)	C2.C01, C2.C03	BDF C3320	NEW CARD READER
2	C2.R02	TY202	LEVEL 02	TER C EXIT LANE (ENTRANCE DOOR)	C2.C02	BDF C3320	DOOR CONTACT
3	C2012	TY202	LEVEL 02	TER C EXIT LANE (EXIT DOOR)	C2033, C2.C04	BDF C3320	REUSE EXISTING CARD READER

CARD READER SCHEDULE NTS 2

ITEM	ALARM NO.	SHEET NO.	LEVEL	LOCATION	ASSOCIATED CAMERA	TERMINATING IDF	DESCRIPTION
1	C2.A01	TY202	LEVEL 02	TER C EXIT LANE (DOUBLE DOOR)	C2031	BDF C3320	DOOR CONTACTS

ALARM POINT SCHEDULE NTS (3)



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PROJECT NAME IAH-TERMINAL -SECURITY EXIT LANE

PROJECT LOCATION GEORGE BUSH IAH

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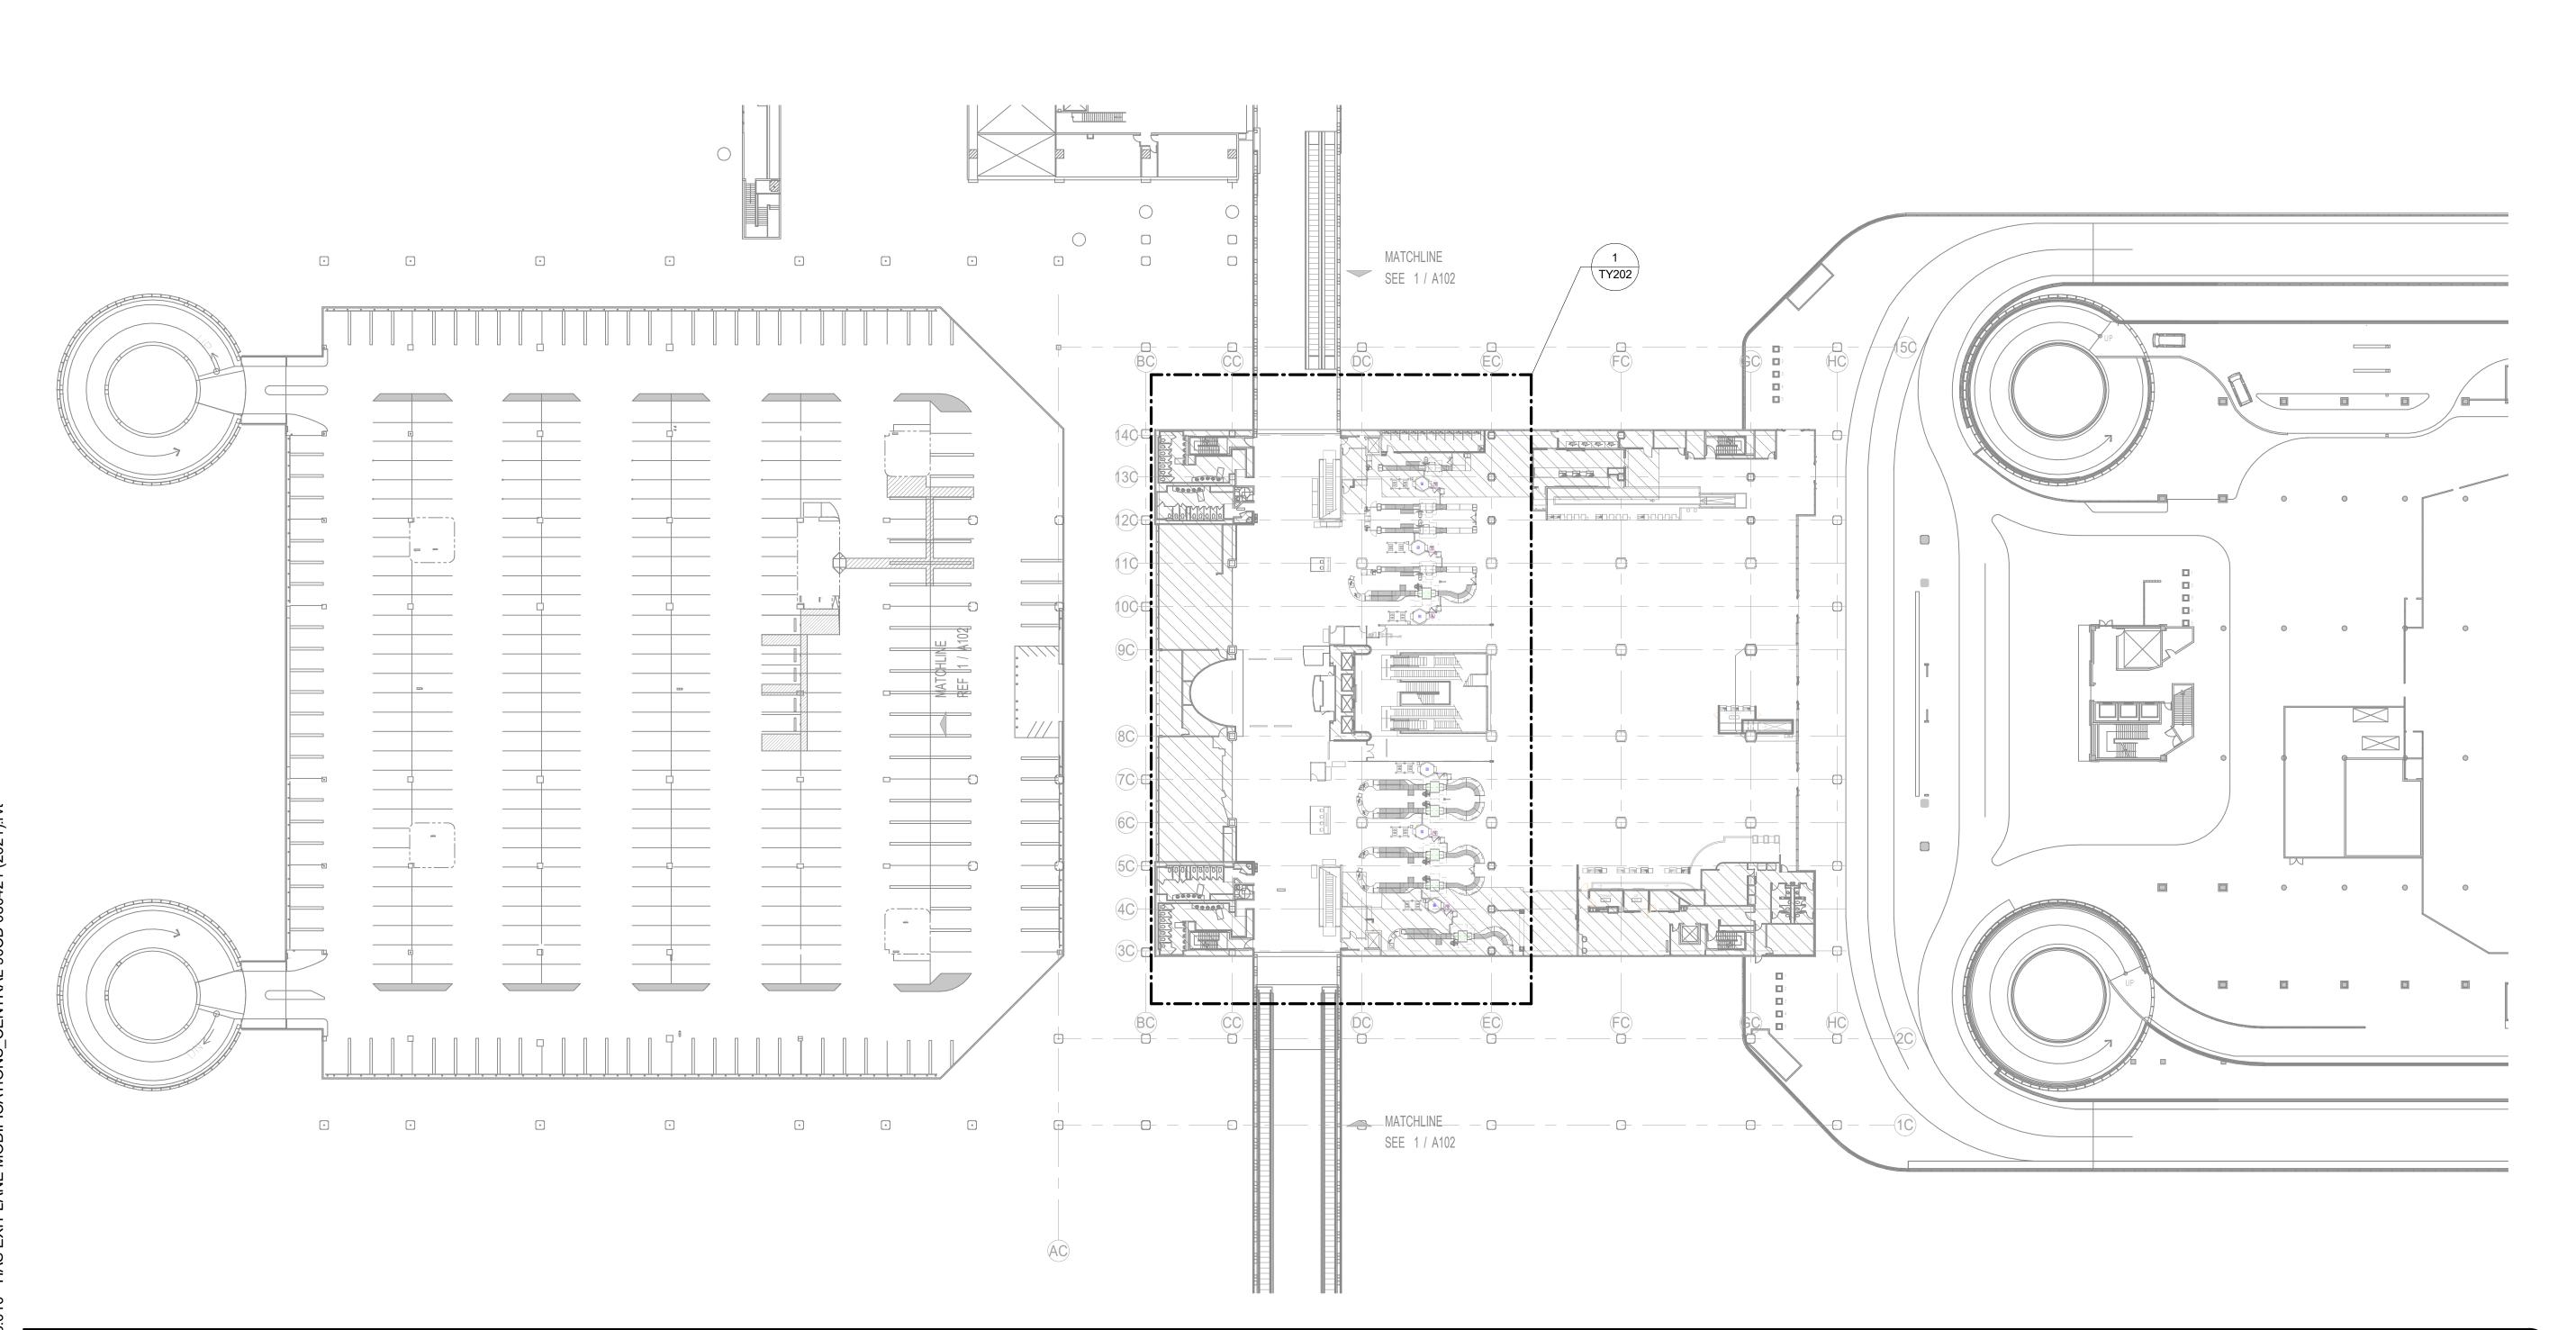
PROJECT NUMBER 1004345

SHEET TITLE

EQUIPMENT SCHEDULES

SHEET NUMBER

TY002



OVERALL SECURITY FLOOR PLAN - TERMINAL C, LEVEL 02 1" = 40'-0" (1)

PLAN NORTH 1 : 256 SCALE

0 2.56 5.12 12.8 25.6 m

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DEPARTMENT OF AVIATIC
RECOMMENDED:
HOUSTON AIRPORT SYSTEM
DIRECTOR OR DESIGN REPRESENTATIVE
HACTID# vvvv IAH

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PROJECT NAME

IAH-TERMINAL -SECURITY EXIT LANE

PROJECT LOCATION

GEORGE BUSH IAH 3500 NORTH TERMINAL RD. HOUSTON, TX 77032

PROJECT NUMBER

1004345

SHEET TITLE

OVERALL SECURITY FLOOR PLAN - TERMINAL C, LEVEL 02

SHEET NUMBER

TY102.2

OVERALL SECURITY FLOOR PLAN - TERMINAL C, LEVEL MEZZANINE 1" = 40'-0" 1

PLAN NORTH 1:256 SCALE 0 2.56 5.12 CLIENT

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 DESCRIPTION

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PROJECT NAME

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PROJECT LOCATION

GEORGE BUSH IAH 3500 NORTH TERMINAL RD. HOUSTON, TX 77032

PROJECT NUMBER


1004345

SHEET TITLE

OVERALL SECURITY FLOOR PLAN - TERMINAL C, LEVEL MEZZANINE

SHEET NUMBER

TY102.3

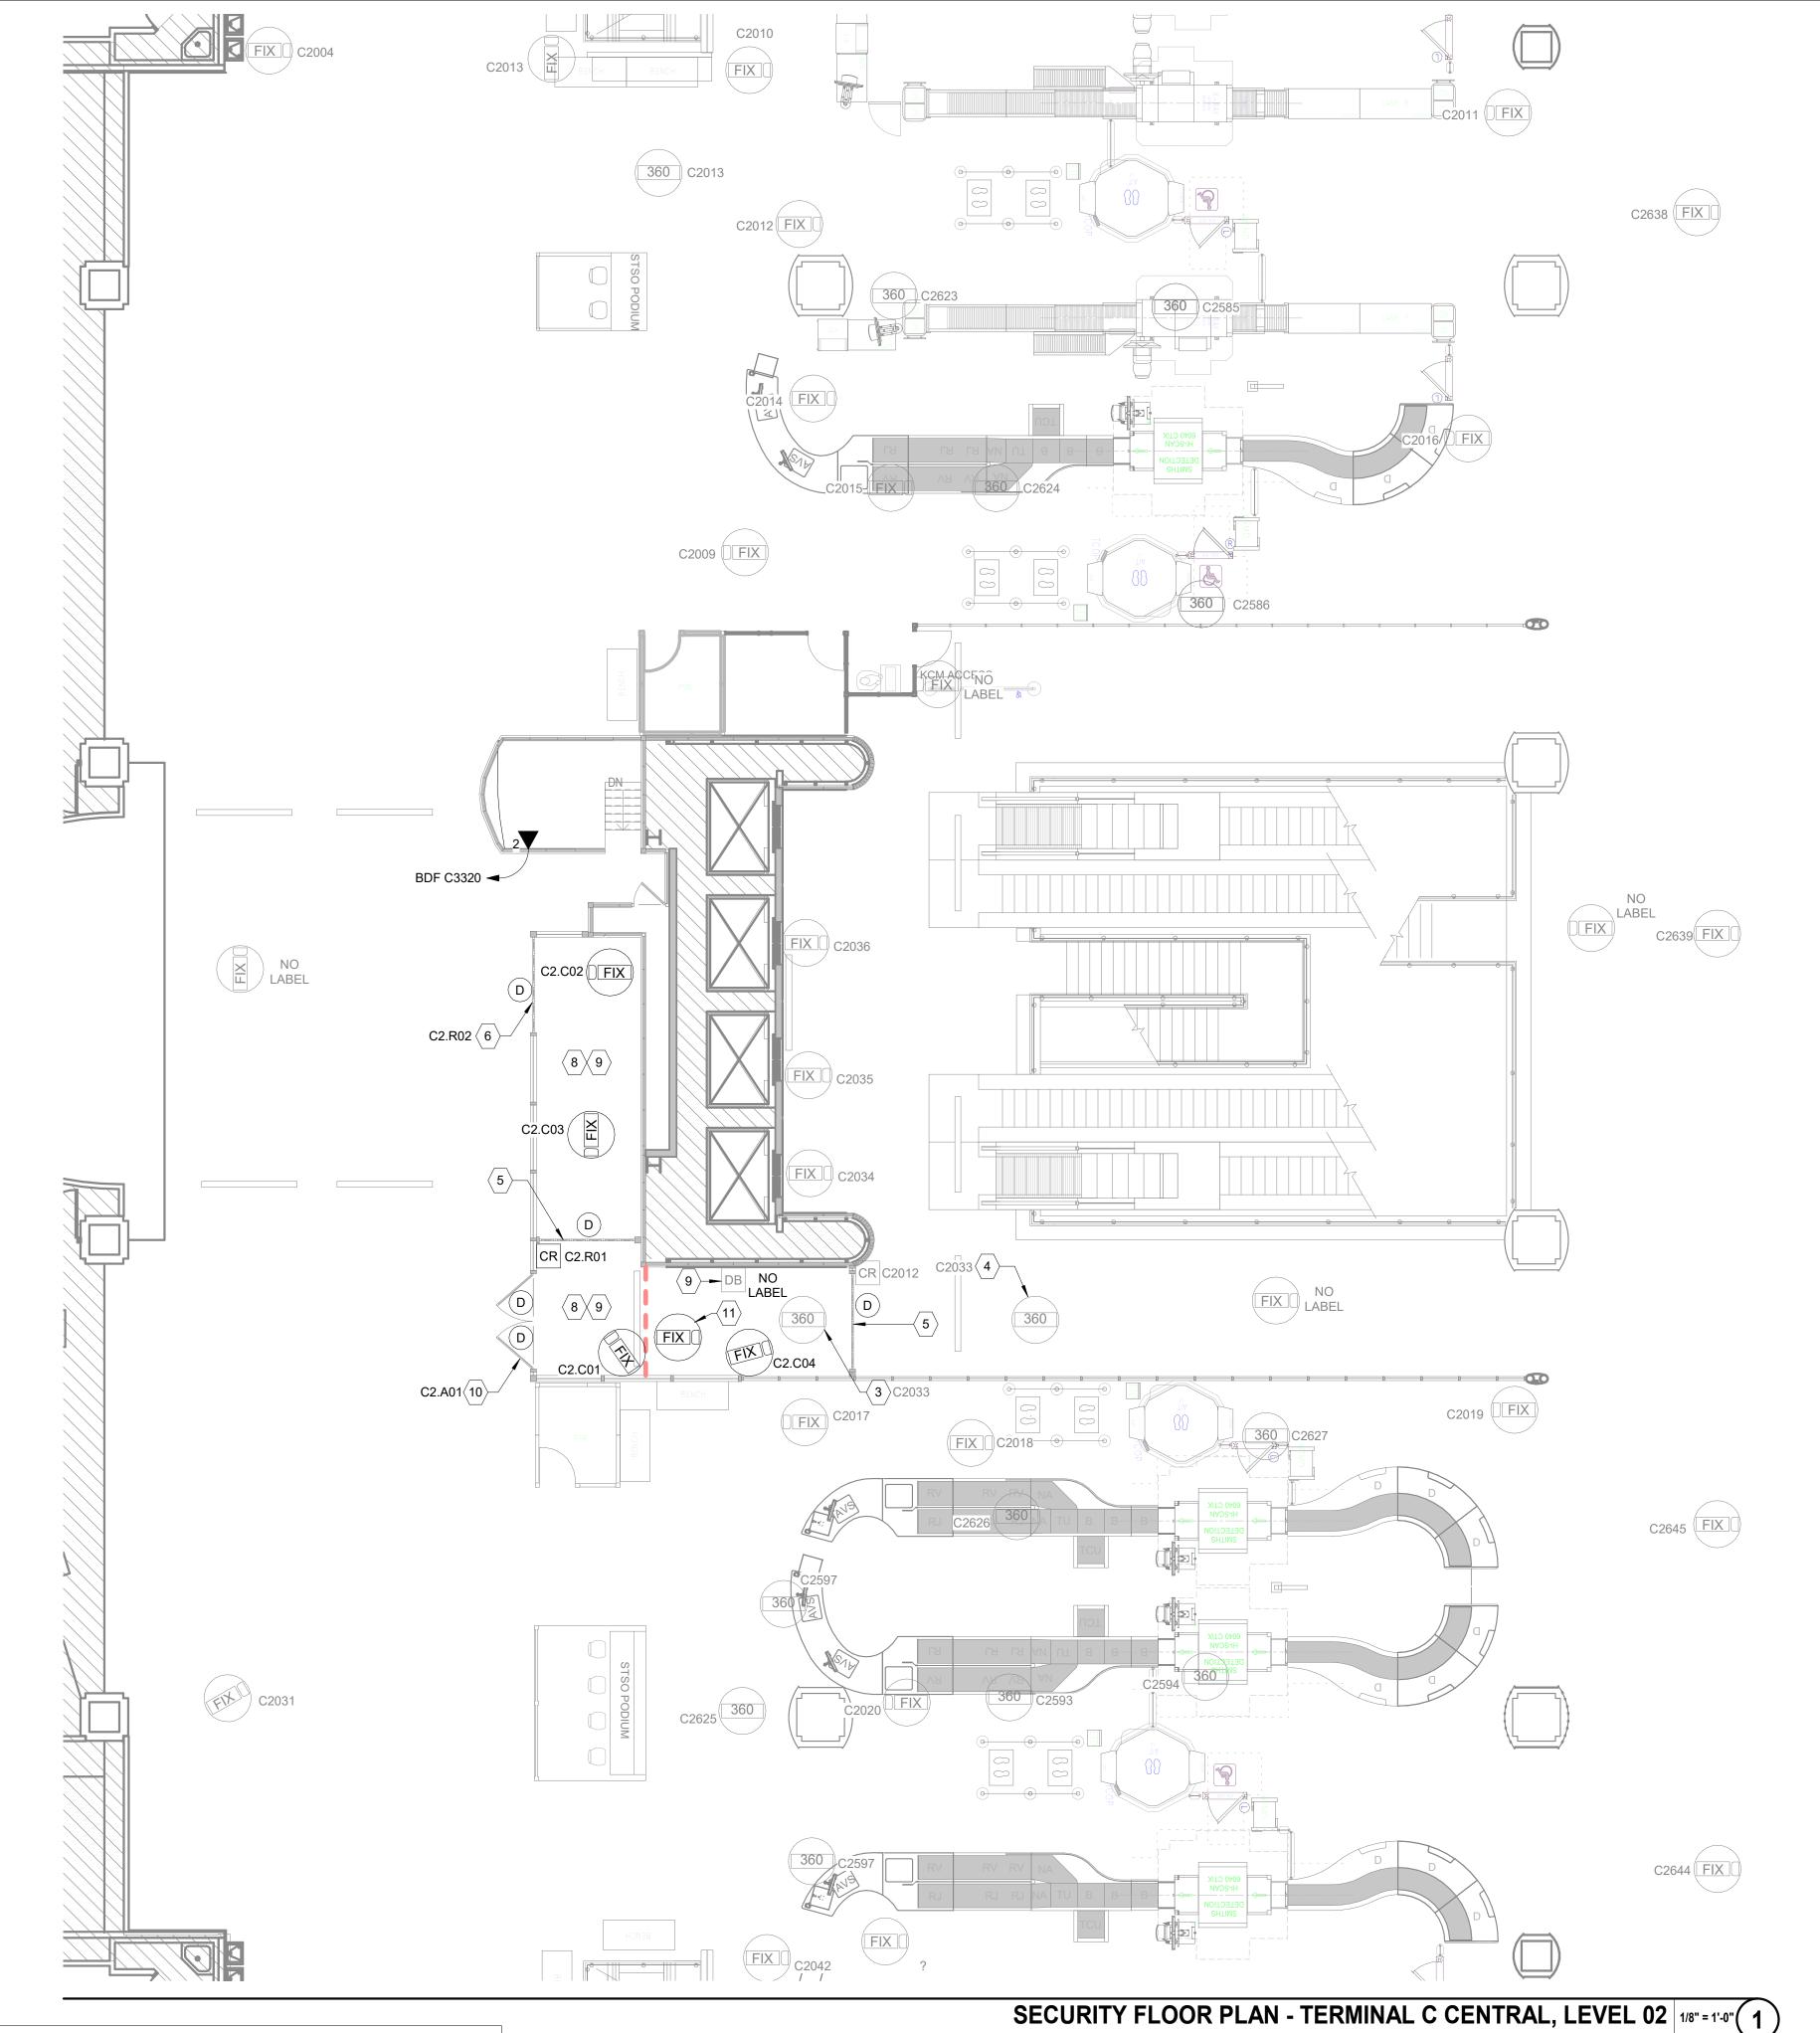

GENERAL NOTES:

- 1. ALL SECURITY DEVICES SHALL TERMINATE IN BDF C3320.
- 2. EXIT LANE CONTAINMENT DEVICES SHALL TERMINATE IN CCR AT BDF C3320.

KEY NOTES:

- \langle 1 \rangle (E) CARD READER TO BE RELOCATED, REMOVE ALL UNUSED CABLES.
- RELOCATE (E) CARD READER TO THIS LOCATION.
- 3 (E) CAMERA TO BE RELOCATED, REMOVE ALL UNUSED CABLES.
- \langle 4 \rangle RELOCATE (E) CAMERA TO THIS LOCATION.
- $\left\langle 5 \right\rangle$ ADD (N) DOOR CONTACT AND CARD READER. RE: <u>1/TY500</u> FOR DOOR DETAIL.
- $^{'}6$ $^{>}$ ADD DOOR CONTACT, RE: 2/TY500 FOR DOOR DETAIL.
- (E) SPEAKERS IN THE IMPACTED PROJECT AREA SHALL BE RELOCATED. COORDINATE SPEAKERS NEW LOCATIONS W/ HAS IT.
- (E) DURESS BUTTON IN THE IMPACTED AREA SHALL BE RELOCATED. COORDINATE NEW LOCATIONS W/ TSA REP.
- $\langle 10 \rangle$ RE: 3/TY500 FOR DOOR DETAIL.
- EXIT LANE BREACH CONTROL CAMERA. PROVIDE QUANTITY AS REQUIRED BY SUPPLIER. TERMINATE IN CCR AT BDF C3320.

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PROJECT NAME

IAH-TERMINAL -SECURITY EXIT LANE

PROJECT LOCATION

GEORGE BUSH IAH 3500 NORTH TERMINAL RD. HOUSTON, TX 77032

PROJECT NUMBER

1004345

SHEET TITLE


SECURITY FLOOR PLAN - TERMINAL C CENTRAL, LEVEL 02

SHEET NUMBER

25.6 m

TY202

PLAN NORTH 1:256 SCALE 0 2.56 5.12

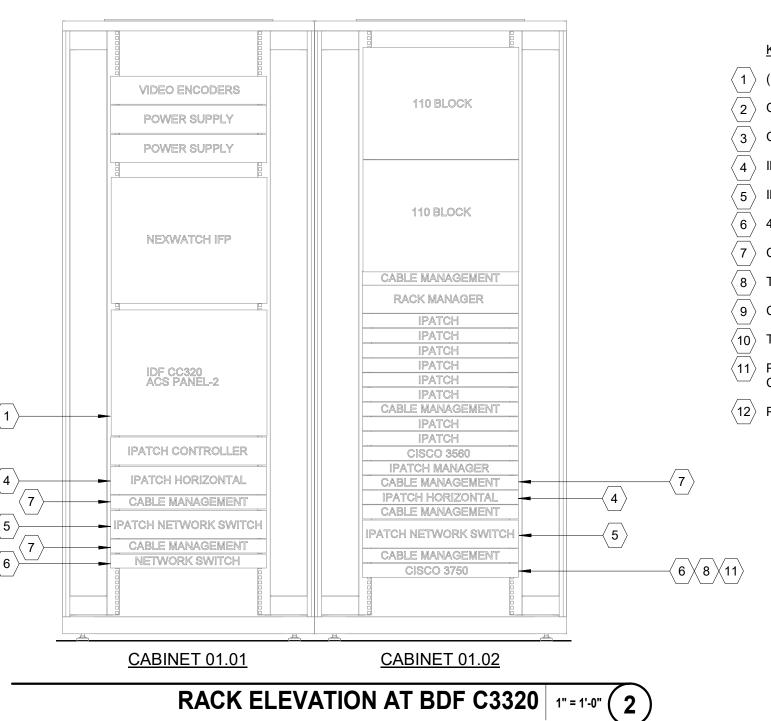

C2.C02 (FIX C2033 CR C2.R01 C2.C03 (FIX)-AO (E) IFP D C2.R02 IDF C3320 ACS PANEL - 2 IPATCH - HORIZONTAL 5 IPATCH - NETWORK SWITCH CISCO 3750 WITH POE D C2.A01 TO EXISTING HAS LAN/WAN

BDF C3320 ONE-LINE DIAGRAM | 12" = 1'-0" (3)

PLAN NORTH 1:256 SCALE 0 2.56 5.12 25.6 m

KEY NOTES:

- \langle 1 \rangle (E) IFP. PROVIDE READER, INPUT, OUTPUT MODULES AS REQUIRED FOR THIS PROJECT.
- CAT6 PATCH CORD. ONE PER SWITCH PORT.
- CAT6 PATCH CORD. ONE (1) PER CAMERA (TYP).
- IPATCH HORIZONTAL, SYSTIMAX 360 48 PORT PATCH PANEL (EXISTING).
- IPATCH NETWORK SWITCH, SYSTIMAX 360 48 PORT PATCH PANEL (EXISTING).
- 48 PORT NETWORK SWITCH (EXISTING).
- CABLE MANAGEMENT.
- TERMINATE CAMERAS IN THIS NETWORK SWITCH. COORDINATE PORTS ASSIGNMENT AND IP ADDRESSES W/ HAS IT.
- COMPOSITE ACCESS CONTROL CABLE, ONE (1) PER DOOR.
- THIS SPACE SHALL BE USED FOR CENTRAL CONTROL RACK (CCR). CCR RACK AND EQUIPMENT WILL BE BY OTHER.
- PROVIDE EIGHT (8) CAT 6 CABLES BETWEEN (E) HAS NETWORK SWITCH AND CCR FOR NETWORK CONNECTIVITY. COORDINATE WITH HAS IT FOR NETWORK PORTS AVAILABILITY.
- PROVIDE 120VAC 20A POWER CIRCUIT FOR CCR (BY DIV 26, ELECTRICAL).

HAS AVIATION DEPT.

HOUSTON TX 77032

16930 JOHN F.

ARCHITECT

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PROJECT LOCATION GEORGE BUSH IAH 3500 NORTH TERMINAL RD. HOUSTON, TX 77032

PROJECT NUMBER 1004345


LANE

SHEET TITLE **ENLARGED PLAN** AT BDF C3320


SHEET NUMBER

TY404

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DOOR WITH ELECTRIFIED PANIC HARDWARE, DOOR SWITCHER, EPT, CARD READER NTS (3)

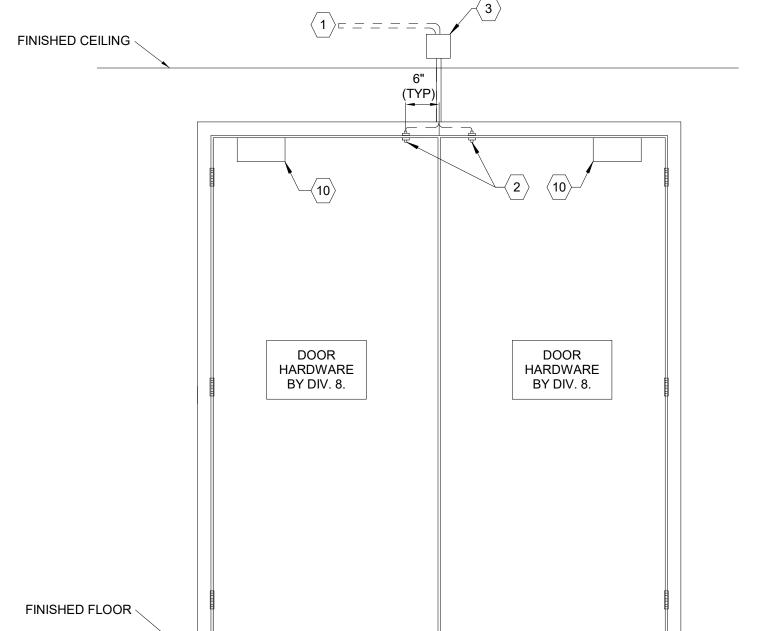

GENERAL NOTES:

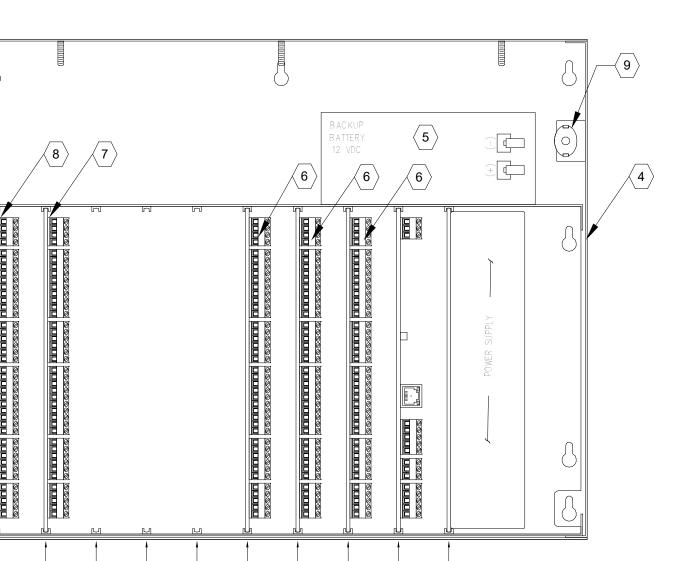OTHERWISE NOTED.

1. VIEW SHOWN IS FROM SECURED SIDE OF PORTAL. CONDUIT BOXED AND EQUIPMENT SHALL BE MOUNTED ON SECURED SIDE OF PORTAL, UNLESS

2. CONDUITS MAY BE COMBINED, IF COMBINED, CONTRACTOR SHALL ENSURE CONDUIT IS SIZED TO ACCEPT REQUIRED CONDUCTORS PER NEC.

3. COORDINATE MOUNTING LOCATIONS, ROUGH-IN AND FINISHES WITH THE

5. DOOR HARDWARE SHOWN FOR REFERENCE ONLY. TYPE OF HARDWARE MAY VARY. ALL DOOR HARDWARE SHALL HAVE KEY CYLINDER UNLESS NOTED

6. PROVIDE CONDUIT ONLY WHERE WIRING CANNOT ROUTE IN DOOR FRAME.

9. PROVIDE PATCH CABLE (CAT 6) FOR CONNECTIVITY TO THE NEAREST

11. PROVIDE BATTERY BACKUP TO SUPPORT FULL LOAD FOR 4 HOURS.

13. PROVIDE ADDITIONAL PANEL ENCLOSURE AND MODULE TO MEET

14. PROVIDE FIRE ALARM RELAY AS REQUIRED FOR AUTO DOOR.

MOUNT 4S J-BOX 6" AFC. OR AS APPROVED BY THE OWNER.

PROVIDE FIELD PANEL ENCLOSURE WITH POWER SUPPLY AND BATTERY BACK UP. THE FIRST FIELD PANEL SHALL HAVE THE INTELLIGENT

 $\langle 6 \rangle$ DUAL READER MODULE. PROVIDE DUAL READER MODULES AS NECESSARY

PROVIDE OUTPUT MODULE IN SLOT 9. QTY AS REQUIRED FOR PROJECT.

(5) BATTERY BACKUP SHALL BE SIZED TO CARRY FULL LOAD FOR FOUR (4)

 \langle 7 \rangle PROVIDE INPUT MODULE IN SLOT 8. QTY AS REQUIRED FOR PROJECT.

 \langle 1 \rangle 1"C. TO NEAREST IDF. TERMINATE CABLES IN IFP.

DOOR POSITION SWITCH, FLUSH MOUNT.

CONTROLLED MOUNTED TO SLOT #1.

10. CONFIGURE THE INTELLIGENT CONTROLLER (IC) TO BE ABLE TO DETECT

12. SUBMIT PROGRAMMING WORK SHEETS AS GENERAL SUBMITTAL REQUEST

4. CONDUIT SHALL BE CONCEALED UNLESS OTHERWISE NOTED.

OTHERWISE. DOOR HARDWARE BY DIV.8.

STATIC IP AUTOMATICALLY.

REQUIREMENTS OF PROJECT.

FROM HAS IT.

KEY NOTES:

FOR THE PROJECT.

9 TAMPER SWITCH

7. ALL SECURITY DOORS SHALL HAVE DOOR CLOSER.

8. COORDINATE WITH HAS FOR ADDRESSING SCHEME.

CLIENT

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ARCHITECT



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ISSUE FOR REVIEW

DRAWING HISTORY Nº. DATE
1 09-09-21 FOR I

> PROJECT NAME IAH-TERMINAL -SECURITY EXIT LANE

PROJECT LOCATION GEORGE BUSH IAH **3500 NORTH** TERMINAL RD. HOUSTON, TX 77032

PROJECT NUMBER

1004345

SHEET TITLE DOOR AND IFP **DETAILS**

SHEET NUMBER


TY500

AND TSA'S REGULATION IMPLEMENTING THIS AUTHORITY, SET FORTH IN 49 CFR PART 1520.


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 $\langle 10 \rangle$ DOOR CLOSER REGISTRATION Copyright © 2021

└─SLOT └─SLOT └─SLOT └─SLOT

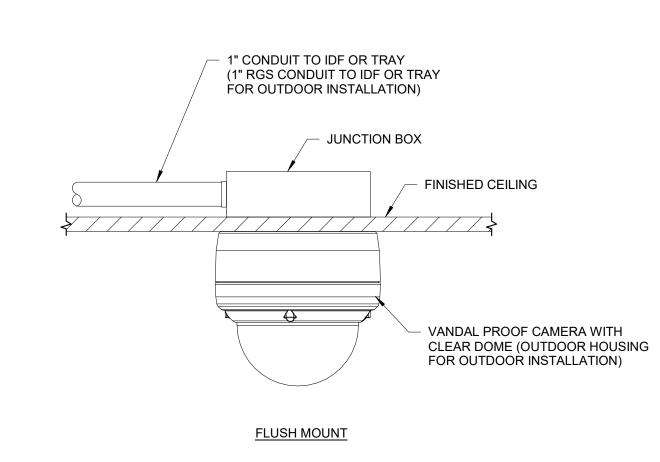

TYPICAL CAMERA MOUNTING OPTION 1 - CEILING MOUNT FOR HD OR PTZ CAMERA NTS (1)

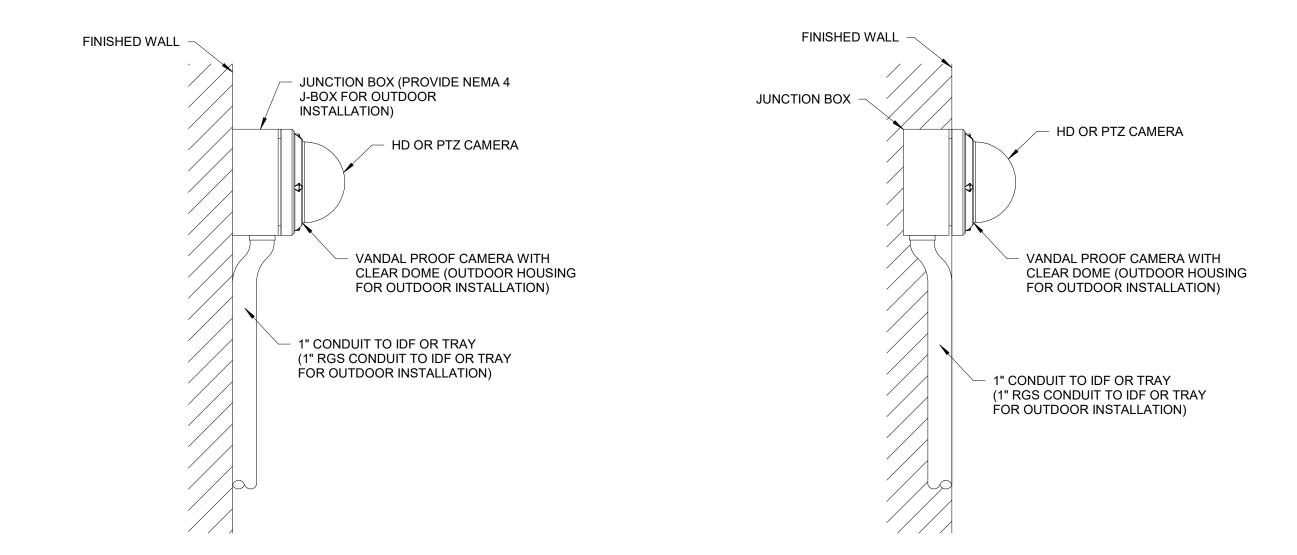

TYPICAL CAMERA MOUNTING OPTION 2 - WALL MOUNT FOR HD OR PTZ CAMERA NTS (2)

<u>CLIENT</u>



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DRAWING HISTORY

PROJECT NAME

IAH-TERMINAL -SECURITY EXIT LANE

PROJECT LOCATION

GEORGE BUSH IAH 3500 NORTH TERMINAL RD. HOUSTON, TX 77032

PROJECT NUMBER 1004345


SHEET TITLE

CAMERA DETAILS

SHEET NUMBER

TY501

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CABLE LABEL WALL PLATE -END OF CABLE CABLE LABEL CABLE SHALL TERMINATE IN THE BACKSIDE OF THE PATCH PANEL AT THE INDICATED PORT (020).

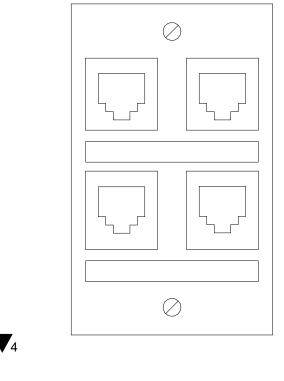WORK AREA OUTLET (4) NTS (2) WORK AREA OUTLET (2) NTS 1

COMMUNICATIONS CABLE LABELING NTS 3

CLIENT



HAS AVIATION DEPT. 16930 JOHN F. KENNEDY BLVD. **HOUSTON TX 77032**

ARCHITECT



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ISSUE FOR REVIEW

DRAWING HISTORY

 №.
 DATE
 DESCRIPTION

 1
 09-09-21
 FOR INFORMATION AND REFERENCE ONLY

PROJECT NAME IAH-TERMINAL -SECURITY EXIT LANE

PROJECT LOCATION GEORGE BUSH IAH 3500 NORTH TERMINAL RD.

HOUSTON, TX 77032

PROJECT NUMBER 1004345

SHEET TITLE TELECOM DETAILS

SHEET NUMBER

TY502