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SECURITY / TELECOMMUNICATIONS

PGA ENGINEERS




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FOR INFORMATION AND REFERENCE ONLY



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PROJECT No. 1004345

09-09-21

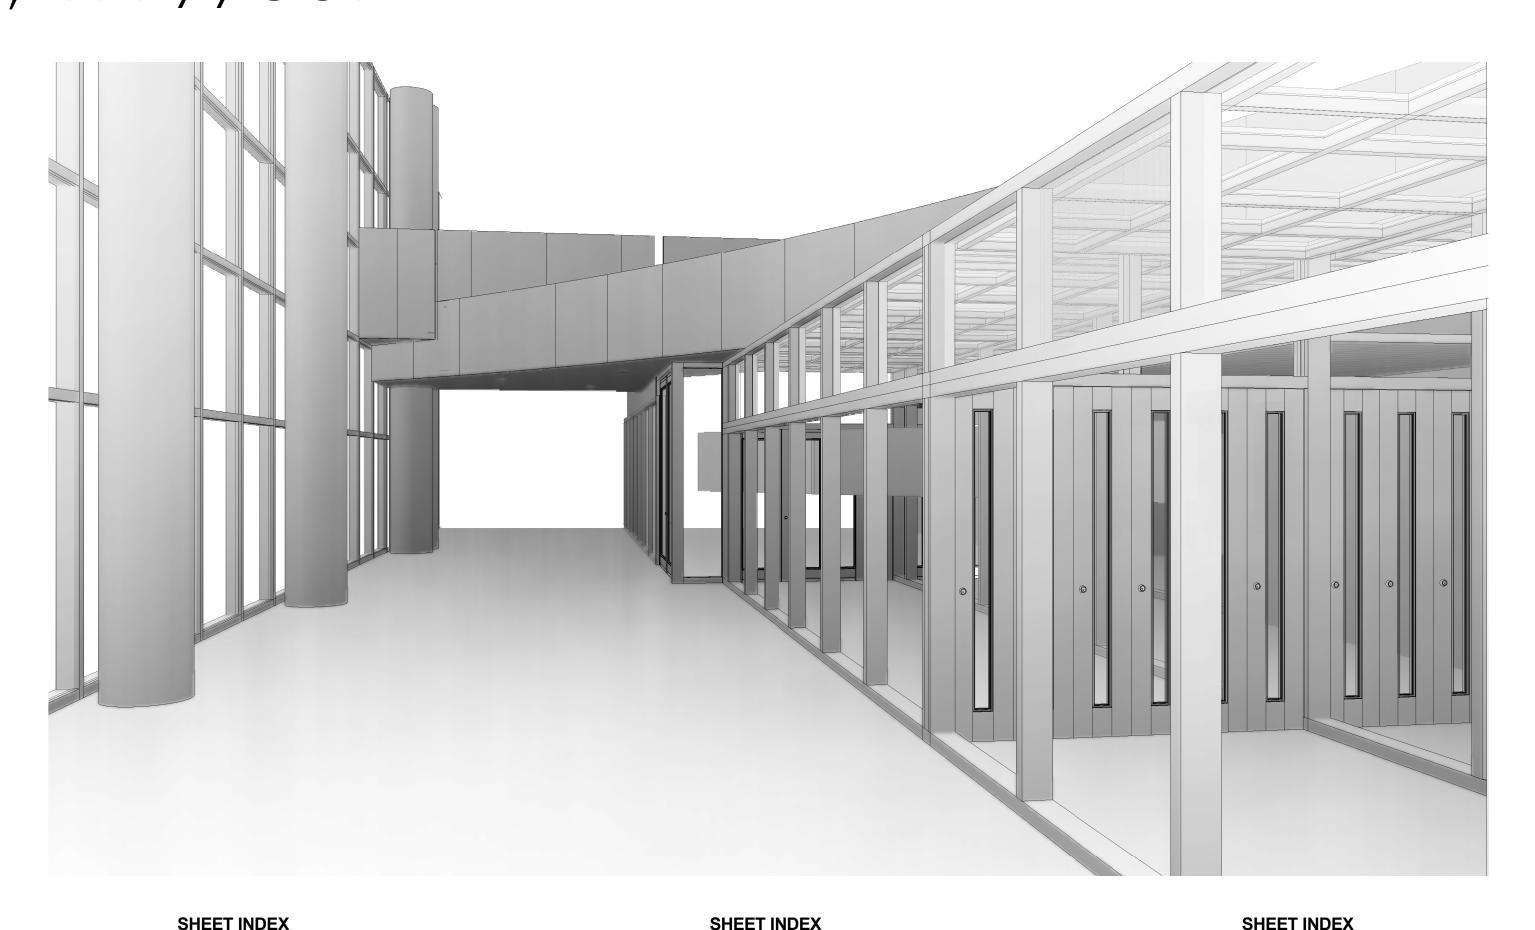ARCHITECTURE ENGINEERING INTERIORS PLANNING

ALEXANDRIA

ATLANTA AUSTIN **BOCA RATON** CHICAGO DALLAS HOBOKEN

HOUSTON

LAS VEGAS LOS ANGELES

1004345

COVER SHEET SHEET INDEX

SHEET NUMBER



SHOP DRAWINGS & SUBMITTALS

- 1. THE GENERAL CONTRACTOR SHALL PROVIDE THE ARCHITECT WITH SHOP DRAWINGS FOR REVIEW AND APPROVAL, FOR ALL, BUT NOT LIMITED TO, THE FOLLOWING: MISC. STEEL, WAYFINDING AND SIGNAGE. SHOP DRAWINGS SHALL BE SUBMITTED IN THE FORM OF DIGITAL PDF PRINTS. SHOP DRAWINGS SHALL NOT BE REPRODUCTIONS OF CONTRACT DOCUMENTS.
- DRAWINGS SHALL NOT BE REPRODUCTIONS OF CONTRACT DOCUMENTS.

 2. CONTRACTOR NEEDS TO PROVIDE A COMPLETE MESSAGE SCHEDULE AND COMPLETE FABRICATION / ASSEMBLY DETAILS FOR ALL SIGNS FOR VERIFICATION PURPOSES AND SIGNED AND SEALED ENGINEERED DRAWINGS FOR SIGNAGE MOUNTING AND SUPPORTS.
- THE GENERAL CONTRACTOR SHALL SUBMIT SHOP DRAWINGS AND SUBMITTALS, AND SHALL ORDER AND SCHEDULE DELIVERY OF MATERIALS TO AVOID DELAYS IN CONSTRUCTION. IF AN ITEM IS FOUND TO BE UNAVAILABLE OR TO HAVE A LONG LEAD TIME, THE GENERAL CONTRACTOR SHALL NOTIFY ARCHITECT IMMEDIATELY WITH A PROPOSED ALTERNATIVE.
 THE CONTRACTOR SHALL SUBMIT FINAL CLOSEOUT DOCUMENTS FOR REVIEW.

PATCHING, REPAIR & FINISH WORK

- THE GENERAL CONTRACTOR SHALL INCLUDE ALL X-RAY AND CORE DRILL COSTS. THE GENERAL CONTRACTOR SHALL REVIEW AND COORDINATE THE SIZE AND LOCATION OF ALL SLAB OPENINGS WITH ALL RELATED DISCIPLINES. THE GENERAL CONTRACTOR SHALL SUBMIT PROPOSED LOCATIONS OF CORE DRILLING AND SLAB OPENINGS TO ARCHITECT AND STRUCTURAL ENGINEER OF RECORD FOR REVIEW AND APPROVAL PRIOR TO PROCEEDING WITH THE WORK.
 PATCH, REPAIR, AND INSTALL ALL FIREPROOFING AS REQUIRED BY CODE. FIREPROOF ALL NEW
- PATCH, REPAIR, AND INSTALL ALL FIREPROOFING AS REQUIRED BY CODE. FIREPROOF ALL NEW PENETRATIONS AS REQUIRED FOR APPROVAL BY THE AUTHORITY HAVING JURISDICTION.
 SLAB PENETRATIONS SHALL BE SEALED AS REQUIRED TO MAINTAIN FIRE RATING, USING
- MATERIALS AND METHODS APPROVED BY THE AUTHORITY HAVING JURISDICTION. EXPANSION MATERIAL SHALL BE APPROVED BY THE ARCHITECT.

 4. ALL DEBRIS SHALL BE REMOVED FROM THE SITE ON A DAILY BASIS, OR AS DIRECTED BY THE AUTHORITY HAVING JURISDICTION. UPON COMPLETION OF THE WORK, REMOVE ALL DEBRIS FROM THE BUILDING CREATED BY THE WORK PROVIDED UNDER THIS CONTRACT AND LEAVE ALL AREAS
- CLEAN. TRASH IS NOT PERMITTED TO BE BURNED ON SITE.

 5. ALL ABANDONED AND MISCELLANEOUS NAILS, HANGERS, STAPLES, WIRES, CONDUITS AND DEBRIS SHALL BE REMOVED FROM EXPOSED AREAS OF THE FLOORS, WALLS, AND CEILINGS. REMOVE ALL ABANDONED PIPE SLEEVES IN FLOOR SLABS. PATCH EXISTING SLAB AS REQUIRED TO MAINTAIN UL FIRE RATING OF FLOOR SLAB WHERE PIPES AND CONDUITS HAVE BEEN REMOVED.
- 6. THE GENERAL CONTRACTOR SHALL CONTINUOUSLY CHECK ARCHITECTURAL AND STRUCTURAL CLEARANCES FOR ACCESSIBILITY OF EQUIPMENT AND MECHANICAL AND ELECTRICAL SYSTEMS.

 NO ALLOWANCES OF ANY KIND WILL BE MADE FOR THE GENERAL CONTRACTOR'S NEGLIGENCE TO FORESEE MEANS OF INSTALLING EQUIPMENT INTO POSITION.
- 7. THE FINISHED WORK SHALL BE FIRM, WELL-ANCHORED, IN TRUE ALIGNMENT, PLUMB, LEVEL, WITH SMOOTH, CLEAN, UNIFORM, APPEARANCE WITHOUT WAVES, DISTORTIONS, HOLES, MARKS, CRACKS, STAINS, OR DISCOLORATION. JOINTING SHALL BE CLOSE FITTING, NEAT AND WELL SCRIBED. THE FINISHED WORK SHALL HAVE NO EXPOSED UNSIGHTLY ANCHORS OR FASTENERS AND SHALL NOT PRESENT HAZARDOUS, UNSAFE CORNERS. ALL WORK SHALL HAVE THE PROVISION FOR EXPANSION, CONTRACTION AND SHRINKAGE AS NECESSARY TO PREVENT CRACKS, BUCKLING, AND WARPING DUE TO TEMPERATURE AND HUMIDITY CONDITIONS.
- S. GENERAL CONTRACTOR SHALL WAIVE "COMMON PRACTICE" AND "COMMON USAGE" AS CONSTRUCTION CRITERIA WHEREVER DETAILS AND CONTRACT DOCUMENTS OF GOVERNING CODES, ORDINANCES, ETC. REQUIRE QUANTITY OR BETTER QUALITY THAN COMMON PRACTICE OR COMMON USAGE WOULD REQUIRE.
- 9. ATTACHMENTS, CONNECTIONS OR FASTENERS OF ANY NATURE ARE TO PROPERLY AND PERMANENTLY BE SECURED IN CONFORMANCE WITH INDUSTRY BEST PRACTICES. THE DRAWINGS HIGHLIGHT SPECIAL CONDITIONS ONLY AND BY NO MEANS ILLUSTRATE EVERY CONNECTION. THE CONTRACTOR IS RESPONSIBLE FOR IMPROVING CONNECTION ACCORDINGLY.
- 10. THE GENERAL CONTRACTOR SHALL NOTIFY THE ARCHITECT OF ANY ACCESS PANELS WHICH MAY BE REQUIRED PRIOR TO PROCEEDING WITH THE WORK. CONTRACTOR SHALL BE RESPONSIBLE FOR COORDINATING ALL TRADES. REQUIRED ACCESS PANELS SHALL BE INCLUDED IN THE CONTRACTOR'S SCOPE OF WORK.

PROJECT CONDITIONS

- 1. THE TERM "BASE BUILDING" MEANS THE EXISTING STRUCTURES WITHIN THE PROPERTY SITE
- WHERE THE PROJECT AND THE WORK IS CONSTRUCTED.

 2. DRAWING FOR THE WORK IS BASED ON OWNER-FURNISHED BASE BUILDING DOCUMENTS AND UPON THE ARCHITECT'S LIMITED VISUAL OBSERVATIONS OF LATENT EXPOSED CONDITIONS AT THE TIME OF COMMENCING THE ARCHITECT'S DESIGN CONSULTING SERVICES.
- THE GENERAL CONTRACTOR SHALL REVIEW AND VERIFY EXISTING CONDITIONS AS PROVIDED IN
 THE CONSTRUCTION DOCUMENTS. THE CONTRACTOR SHALL NOTIFY THE ARCHITECT OF ALL
 DISCREPANCIES, ERRORS, INCONSISTENCIES OR AMBIGUITIES PRIOR TO PROCEEDING WITH THE
 WORK. ANY UNREPORTED DEFICIENCIES WILL BECOME THE RESPONSIBILITY OF THE GENERAL
 CONTRACTOR TO CORRECT.
- 4. THE GENERAL CONTRACTOR SHALL BE RESPONSIBLE FOR, AND PROVIDE PROTECTION OF, ANY EXISTING FINISHES, MATERIALS, AND EQUIPMENT TO REMAIN. THE GENERAL CONTRACTOR SHALL REPAIR OR REPLACE ANY DAMAGED FINISHES, MATERIALS, AND EQUIPMENT AS A RESULT OF THE WORK. ALL EXISTING FINISHES TO REMAIN SHALL BE CLEANED AT THE COMPLETION OF CONSTRUCTION. THE GENERAL CONTRACTOR SHALL PHOTOGRAPH AND DOCUMENT ALL EXISTING DAMAGES, AND PROVIDE TO THE ARCHITECT, PRIOR TO PROCEEDING WITH THE WORK.
- 5. THE GENERAL CONTRACTOR SHALL VERIFY THAT NO CONFLICTS EXIST BETWEEN THE LOCATIONS OF EXISTING AND PROPOSED NEW WAYFINDING AND SIGNAGE (INCLUDING BUT NOT LIMITED TO STRUCTURAL MEMBERS, PIPING, DUCT WORK, CONDUIT AND SPRINKLERS) AND THAT CLEARANCES FOR INSTALLATION ARE PROVIDED. ELEMENTS IN CONFLICT SHALL BE DOCUMENTED AND PROVIDED TO THE ARCHITECT PRIOR TO PROCEEDING WITH THE WORK.
- 6. IN THE EVENT OF CONFLICT BETWEEN DATA SHOWN ON DRAWINGS AND DATA PROVIDED IN THE SPECIFICATION. THE GENERAL CONTRACTOR SHALL PROVIDE WRITTEN NOTIFICATION TO THE ARCHITECT OF ANY DISCREPANCIES, PRIOR TO PROCEEDING WITH THE WORK.
- 7. THE GENERAL CONTRACTOR SHALL NOT PROCEED WITH WORK FOR WHICH HE EXPECTS ADDITIONAL COMPENSATION BEYOND THE CONTRACT AMOUNT WITHOUT WRITTEN AUTHORIZATION FROM THE ARCHITECT AND OWNER. FAILURE TO OBTAIN SUCH AUTHORIZATION SHALL INVALIDATE A CLAIM FOR EXTRA COMPENSATION. THE CONTRACTOR SHALL NOT PROCEED WITH WORK WHICH, IF COMPLETED IN STRICT CONFORMANCE WITH THE CONSTRUCTION DOCUMENTS, WILL RESULT IN ADDITIONAL WORK BEYOND THE SCOPE OF THE CONTRACT WITHOUT WRITTEN AUTHORIZATION FROM THE ARCHITECT AND OWNER. ANY FIELD CONDITIONS THAT SIGNIFICANTLY VARY FROM THE CONTRACT DOCUMENTS OR WILL RESULT IN ADDITIONAL WORK, SHALL BE BROUGHT TO THE ATTENTION OF THE ARCHITECT PRIOR TO PROCEEDING WITH WORK.
- 8. DO NOT SCALE DRAWINGS. STATED & WRITTEN DIMENSIONS GOVERN. THE GENERAL CONTRACTOR SHALL VERIFY ALL DIMENSIONS IN THE FIELD AND SHALL BE RESPONSIBLE FOR THEIR ACCURACY. NO EXTRA CHARGE OR COMPENSATION SHALL BE ALLOWED BECAUSE OF DIFFERENCE BETWEEN ACTUAL DIMENSIONS AND THOSE INDICATED ON THE DRAWINGS, UNLESS THEY CONTRIBUTE TO A CHANGE IN THE SCOPE OF THE WORK. ANY DIFFERENCE FOUND SHALL BE SUBMITTED TO THE ARCHITECT FOR COORDINATION PRIOR TO ORDERING, MANUFACTURING, OR PROCEEDING WITH THE WORK. HORIZONTAL DIMENSIONS INDICATED ARE TO/FROM FACE OF FINISH, UNLESS NOTED OTHERWISE. VERTICAL DIMENSIONS ARE FROM TOP OF FLOOR SLAB EXCEPT WHERE NOTED TO BE ABOVE FINISHED FLOOR (AFF). DIMENSIONS ARE NOT ADJUSTABLE WITHOUT APPROVAL OF ARCHITECT UNLESS NOTED +/-.
- 9. MATERIALS INDICATED TO BE REUSED MUST BE FREE OF DEFECTS AND BE IN GOOD CONDITION OR SHALL BE REPLACED WITH NEW. UNDER THIS CONTRACT, ANY MATERIAL INDICATED TO BE REUSED WHICH IS NOT FREE OF DEFECTS SHALL BE BROUGHT TO THE ATTENTION OF THE ARCHITECT VIA A WRITTEN REQUEST FOR INFORMATION PRIOR TO BEGINNING CONSTRUCTION.

CONTRACTORS USE OF BUILDING

- CONTRACTOR IS RESPONSIBLE FOR COMPLYING WITH ALL BUILDING MANAGEMENT SECURITY
 REQUIREMENTS, INCLUDING PROJECT SITE ACCESS RULES.
- REQUIREMENTS, INCLUDING PROJECT SITE ACCESS RULES.

 2. LIMIT USE OF BASE BUILDING FOR THE WORK AND FOR CONSTRUCTION OPERATIONS, TO ALLOW CONTINUED OCCUPANCY AND USE.
- CONFINE OPERATIONS WITHIN DESIGNATED STAGING AREAS AND COORDINATE USE OF BASE BUILDING FACILITIES AS APPROVED BY THE OWNER.

 OUT OF THE OWNER.

 OUT OF THE OWNER.
- 4. THIS PROJECT WILL REQUIRE WORK WITHIN THE SIDA (SECURITY IDENTIFICATION DISPLAY AREA) AREAS. THE GENERAL CONTRACTOR AND HIS SUBCONTRACTORS ARE TO HAVE PROPER SECURITY TRAINING AND CREDENTIALS AS REQUIRED AND GRANTED BY HAS. THE CONTRACTOR AND THEIR SUBS ARE TO BE AWARE OF THEIR LOCATIONS WHILE WORKING IN THESE AREAS AND PROPER BADGING MUST BE DISPLAYED AT ALL TIMES. ALL COSTS ASSOCIATED WITH OBTAINING TRAINING AND CREDENTIALS TO ACCESS THE SIDA, ARE THE RESPONSIBILITY OF THE GENERAL CONTRACTOR AND SHALL BE COMPLETED PRIOR TO COMMENCEMENT OF WORK.
- COORDINATE ANY SECURITY DEVICE REMOVAL / RELOCATION WITH HAS PRIOR TO COMMENCEMENT OF WORK.
- 6. MAINTAIN PROPER PATHS AND IDENTIFICATION OF EMERGENCY EGRESS.

PROJECT GENERAL DESCRIPTION

OVERALL PROGRAM NAME: HOU TERMINAL - SECURITY EXIT LANE

THE BASIS OF DESIGN IS TO PROVIDE AN EXIT LANE BREACH CONTROL (ELBC) SYSTEM THAT AUTOMATICALLY WATCHES PEOPLE AND OBJECTS FLOW THROUGH AIRPORT EXIT LANES (DEFINED AS A PASSENGER TRANSITION AREA CONTAINING A LINE OF DEMARCATION BETWEEN THE STERILE AND NON-STERILE AREA WHERE PASSENGERS ARE UNABLE TO RETURN WITHOUT SCREENING) AND PROVIDE AUTOMATED PHYSICAL BARRIER(S) PREVENTING ACCESS BACK INTO THE STERILE AREA.THE ELBC SYSTEM SHALL CONTINUOUSLY, SILENTLY, RELIABLY AND AUTOMATICALLY MONITORS THE EXIT LANE TO ACCURATELY DETECT PEOPLE TRAVELLING THE WRONG WAY AND OBJECTS THROWN FROM THE PUBLIC TO THE STERILE SIDE IN THE EXIT LANE WITHIN THE PROTECTED ZONES OF DETECTION.THIS DETECTION IS ACHIEVED UTILIZING THE EXITSENTRY VIDEO ANALYTICS SYSTEM.SOPHISTICATED AND HIGHLY SPECIALIZED VIDEO ANALYTICS SOFTWARE INTEGRATED WITH COMMERCIAL OFF THE SHELF (COTS) HARDWARE, THE SYSTEM SHALL PROVIDE LOCAL & REMOTE AUDIBLE AND VISUAL NOTIFICATIONS, LIVE AND RECORDED VIDEO OF THE EVENT, AND SYSTEM CONTROL FUNCTIONS UPON THEIR DETECTION.EXITSENTRY IS THE INDUSTRY-LEADING SECURITY MONITORING AND ALARM SYSTEM. USING PATENTED, AN INTERFACE VIA THE ACCESS CONTROL SYSTEM (ACS) FROM EXITSENTRY TO LAYERED CONTAINMENT MEASURES (AUTOMATIC DOORS) SHALL BE IMPLEMENTED AT THE ENTRANCE, CENTER, AND SECURE END OF THE EXIT LANE, THUS THE EXITSENTRY SYSTEM SHALL CONTROL THE CONTAINMENT AUTOMATED DOOR MEASURES THROUGH THE ACS AND PREVENT (CONTAIN) THE ADVANCING BREACH, WHETHER IT INVOLVES PEOPLE OR OBJECTS (OR BOTH). LOCALLY, THE SYSTEM DEPLOYS A HIGH-DEFINITION MESSAGING LOUDSPEAKER, AUDIBLE ALARM SIGNAL AND A VISUAL STROBE FOR PASSENGER NOTIFICATIONS. SYSTEM MONITORING AND CONTROL AT THE REMOTE COMMAND TERMINAL LOCATED ADJACENT TO THE EXIT LANE. IT ALSO PROVIDES LOCAL COMMUNICATIONS FOR THE SYSTEM SHALL UTILIZE THE EXISTING AIRPORT ETHERNET NETWORK. EVENTS THROUGH OBVIOUS CHANGES CONFIGURED ON THE AIRPORT ACCESS CONTROL SYSTEM (ACS) OPERATOR CONTROL WORKSTATION(S), AND CONTROL FUNCTIONS CAN ALSO BE CONFIGURED USING ACS OUTPUTS FOR REMOTE BYPASS, RESET AND MANUAL CONTROL OF AUTOMATIC CONTAINMENT MEASURES. VIDEO MONITORING IS PROVIDED FROM EXITSENTRY VIDEO OUTPUTS THROUGH A VIDEO PROCESSOR TO THE AIRPORT VIDEO MANAGEMENT SYSTEM (VMS). THE EXITSENTRY SYSTEM SHALL NOTIFY THE AIRPORT COMMUNICATIONS CENTER OF

PROJECT GENERAL NOTES

- 1. HOUSTON AIRPORT SYSTEMS (HAS) SHALL BE DESIGNATED AS "THE OWNER", PGAL ARCHITECTS SHALL BE DESIGNATED AS "THE ARCHITECT". GEORGE BUSH INTERCONTINENTAL AIRPORT (IAH) SHALL BE DESIGNATED AS "THE LANDLORD". THE GENERAL CONTRACTOR SHALL BE BOTH LICENSED AND BONDED IN TEXAS AND SHALL PROVIDE DOCUMENTS UPON REQUEST.
- 2. THE WORK SHALL BE DONE IN ACCORDANCE WITH THE RULES AND REGULATIONS OF ALL APPLICABLE SAFETY AND BUILDING CODES, AND AS APPROVED BY THE AUTHORITY HAVING JURISDICTION, INCLUDING OBSERVING ALL RULES AND REGULATIONS IN AN AIRPORT SECURE ENVIRONMENT.
- THE GENERAL CONTRACTOR IS RESPONSIBLE FOR SECURING AND PAYING FOR ALL PERMITS
 REQUIRED FOR THE WORK AND FOR THE SCHEDULING OF ALL REQUIRED INSPECTIONS DURING THE
 COURSE OF THE WORK.
- 4. REFER TO THE GENERAL NOTES, DESIGN NOTES AND KEYNOTES ON SHEETS 1-1 THROUGH 1-20, 2-1 THROUGH 2-47, 3-1 THROUGH 3-2, 4-1 THROUGH 4-51, AG3.001 AND AG3.002.
- 5. THE CONTRACTOR SHALL VERIFY THAT THE DRAWINGS ARE THE LATEST ISSUE BEFORE COMMENCING CONSTRUCTION.

HAS STANDARDS

- THIS PROJECT IS TO FOLLOW HOUSTON AIRPORT SYSTEM (HAS) STANDARDS FOR ALL DISCIPLINES.
 HAS STANDARDS CAN BE FOUND AT THEIR WEBSITE, HTTP://WWW.HOUSTONAIRPORTS/BIZ/TIP.
 ANY CONFLICTS BETWEEN HAS STANDARDS AND BID/CONSTRUCTION DOCUMENTS ARE TO BE
 BROUGHT TO THE ARCHITECTS ATTENTION VIA RFI.
- 3. ANY FLOOR PENETRATION WILL NEED TO BE X-RAY SCANNED. THIS INCLUDES BUT NOT LIMITED TO FLOOR ANCHORS, CORE, ETC. ALL SCANS ARE TO BE SUBMITTED TO HAS / EOR FOR REVIEW
- BEFORE WORK CAN BE PERFORMED.

 4. THE CONTRACTOR SHALL THOROUGHLY EXAMINE THE PREMISES AND SHALL BASE THE BID ON THE EXISTING CONDITIONS IN CONJUNCTION WITH THESE DOCUMENTS. THE CONTRACTOR SHALL NOTIFY THE ARCHITECT PRIOR TO THE BID OF ANY DISCREPANCIES FOUND WITH THESE DOCUMENTS OR CONFLICTS WITH EXISTING CONDITIONS VIA WRITTEN REQUEST FOR INFORMATION.
- 5. PRIOR TO BEGINNING ANY CONSTRUCTION OR DEMOLITION, THE CONTRACTOR SHALL VERIFY THE GENERAL LAYOUT AND EXACT LAYOUT OF ALL WAYFINDING AND SIGNAGE AND REPORT ANY QUESTIONS OR DISCREPANCIES TO THE ARCHITECT FOR RESOLUTION VIA A WRITTEN REQUEST FOR INFORMATION.

FACILITIES

- 1. CORE DRILLING. THE CONTRACTOR SHALL SCAN THE AREA PRIOR TO CORE DRILLING OF CONCRETE STRUCTURES. THE CONTRACTOR SHALL USE THE GROUND PENETRATING RADAR (GPR) METHOD. THE CONTRACTOR SHALL SUBMIT A COPY OF THE GPR RESULTS TO AIRPORT STAFF, PRIOR TO CORE DRILLING, VERIFYING THAT THE AREA IS CLEAR OF CONDUITS/REBAR/PORT TENSION TENDONS/ETC.
- HOT WORK PERMIT. THE CONTRACTOR SHALL OBTAIN A HOT WORK PERMIT FROM THE AIRPORT FOR WELDING, CUTTING, GRINDING, OR ANY OTHER ACTIVITY INVOLVING OPEN FLAMES, SPARKS, OR OTHER IGNITION SOURCES THAT MAY CAUSE SMOKE, FIRE, OR CAN TRIGGER THE FIRE DETECTION SYSTEM.

AIRSIDE / LANDSIDE

- 1. THE CONTRACTOR SHALL NOT BLOCK THE TERMINAL PASSENGER PATHS AND SHALL NOT BLOCK THE TSA CHECKPOINT AREAS.
- THE TOA CHECKPOINT AREAS.
 THE CONTRACTOR SHALL MAINTAIN THE PATH OF TRAVEL TO AND FROM THE WORK AREA IN A
 CLEAN MANNER. THE CONTRACTOR SHALL CLEAN THE PATH OF TRAVEL, AS NEEDED AND REMOVE
 ANY DUST/DEBRIS FROM THE PATH OF TRAVEL.

SECURITY

- 1. HAS APPROVAL OF THE REQUIRED "SECURITY PLAN" IS REQUIRED PRIOR TO THE START OF ANY WORK, THE SECURITY PLAN MUST BE SUBMITTED TO HAS FOR REVIEW AND APPROVAL. THE "SECURITY PLAN" SHALL INCLUDE BUT IS NOT LIMITED TO THE FOLLOWING:
- DATES AND TIME OF WORK
- CONTRACTOR NAME & CONTACT INFORMATION
 BADGING OF CONSTRUCTION PERSONNEL
- BADGING OF CONSTRUCTION PERSONNEL
 SUMMARY OF WORK, INCLUDING ATTACHED PLAN
- PERSONNEL & VEHICLE SECURITY CLEARANCE INFORMATION
 PERSONNEL & VEHICLE ACCESS INFORMATION. SHOW ALL PENETRATIONS OF THE SECURITY BOUNDARY. DESIGNATED ROUTE FOR WORKERS TO ACCESS VARIOUS WORK AREAS MUST BE
- ELEVATORS AND OR DOORS TO BE USED TO ACCESS THE SITE.
 CONSTRUCTION DEBRIS SHOW HOW CONSTRUCTION DEBRIS WILL BE DISPOSED OF OR
- TRANSPORTED OFF SITE

 SHOW PROPOSED LAYDOWN AREAS
- SHOW PROPOSED LAYDOWN AREAS
 CONTACT AIRPORT SECURITY COMPLIANCE FOR TIMELINES FOR SUBMISSION AND COORDINATION
- OF WORK UNDER TSA GUIDELINES
 THE CONTRACTOR SHALL ATTEND A PRE-CONSTRUCTION MEETING PRIOR TO THE START OF WORK

PROVIDED & APPROVED. IDENTIFY THE PATH OF TRAVEL TO THE WORK SITE AND IDENTIFY ANY

CLIENT



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AVIATION

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HAS TIP 21-157 - IAH

REGISTRATION
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PROJECT NAME
HOU-TERMINAL
- SECURITY
EXIT LANE

PROJECT LOCATION

WILLIAM P. HOBBY AIRPORT 7800 AIRPORT BLVD. HOUSTON, TX 77061

PROJECT NUMBER

1004345

SHEET TITLE
GENERAL PROJECT

INFORMATION

SHEET NUMBER

G002

APPLICABLE CODES

MECHANICAL CODE **ELECTRICAL CODE**

2012 IBC - INTERNATIONAL BUILDING CODE (WITH COH AMENDMENTS) **2012 UMC - UNIFORM MECHANICAL CODE (WITH COH AMENDMENTS)** 2017 NEC - NATIONAL ELECTRICAL CODE (STATE MANDATED) **2012 UPC - UNIFORM PLUMBING CODE (WITH COH AMENDMENTS)** 2012 IFC - INTERNATIONAL FIRE CODE (WITH COH AMENDMENTS) NFPA - NATIONAL FIRE PROTECTION ASSOCIATION

LIFE SAFETY CODE (NFPA 1,10,13,14, 20, 70, 72, 101, 220, 221) **ENERGY CODE** 2015 IECC - INTERNATIONAL ENERGY CONSERVATION CODE (WITH COH

ASHRAE 90.1-2013 (WITH COH AMENDMENTS) 2012 - TAS - (TEXAS ACCESSIBILITY STANDARDS / ADA ACCESSIBILITY

CONSTRUCTION CLASSIFICATION

OCCUPANCY TYPE: NUMBER OF STORIES: A, NO CHANGE 3 STORY CONSTRUCTION TYPE: SPRINKLED: FIRE RATING OF COLUMNS:

BEAMS : 3HR ELEVATOR SHAFTS : 2HR STRUCTURAL ELEMENTS: FLOORS: 2 HR PARKING REQUIREMENTS: N/A - EXISTING, NO CHANGE

REQUIRED OCCUPANCY SEPARATION: NONE

FIRE PROTECTION

FIRE SPRINKLER: FIRE ALARM: FIRE EXTINGUISHER

EXISTING TO COMPLY WITH NFPA 13 TO COMPLY WITH NFPA 72

MAX DISTANCE TO FIRE **EXTINGUISHER IS 75 FEET**

*FIRE ALARM AND FIRE EXTINGUISHER CABINETS ARE EXISTING

EXIT ACCESS TRAVEL DISTANCE

TABLE 1016.2

OCCUPANCY	W/ SPRINKLER SYSTEM (FT)
A, E, F-1, M,R, S-1	250
I-1	250
В	300
F-2 S-2 II	400

COMMON PATH OF EGRESS TRAVEL

TABLE 1014.3

OCCUPANCY	W/ SPRINKLER SYSTEM (FT)
B, S	100
ALL OTHERS	75

INTERIOR WALL AND CEILING FINISH REQUIREMENTS BY OCCUPANCY

(IBC TABLE 803.9)			
		SPRINKLERED	
GROUP	EXIT ENCLOSURES AND EXIT PASSAGEWAYS	CORRIDORS	ROOMS AND ENCLOSED SPACES
Α	В	В	С

FIRE PROTECTION SYSTEMS (IBC SECTION 903)

AUTOMATIC FIRE SPRINKLER SYSTEM PER NFPA 13 TO BE PROVIDED W/ 100% COVERAGE ON EACH LEVEL. FIRE EXTIGUISHERS PROVIDED. IFC TABLE 906.3(1)

OCCUPANCY CALCULATIONS (IBC TABLE 1004.1.2)

LEVEL 2	- TICKETING				
ROOM#	NAME	AREA	OCC. TYPE	OLF	OCC. LOAD
000	LODDY OIDOUR ATION	04.000.05	4.0	400.05	050

EGRESS WIDTH PER OCCUPANT SERVED (IBC TABLE 1005.1)

LEVEL 02 - TICKETING - FLOOR PLAN - TERMINAL LIFE SAFETY 1/16" = 1'-0" 1

LEVEL 2: 0.2" X 250 OCC = <u>50</u> INCH/OCC

WIDTH PROVIDED

180" PROVIDED

CORRIDOR FIRE-RESISTANCE RATING (IBC TABLE 1018.1)

	OCCUPANT LOAD SERVED	REQUIRED FIRE-RESISTANCE RATING (HOURS)
GROUP	BY CORRIDOR	WITH SPRINKLER SYSTEM
A,B,E,F,M,S,U	GREATER THAN 30	0

MINIMUM NUMBER OF EXITS PER OCCUPANT LOAD (IBC 1021)

OCCUPANT LOAD MINIMUM # OF EXITS (PERSONS PER STORY) (PER FLOOR)(REQUIRED) PROVIDED LEVEL 1: 1-500

CLIENT



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ARCHITECT



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DRAWING HISTORY

PROJECT NAME **HOU-TERMINAL** - SECURITY **EXIT LANE**

PROJECT LOCATION WILLIAM P. HOBBY **AIRPORT** 7800 AIRPORT BLVD.

HOUSTON, TX 77061 PROJECT NUMBER

1004345 SHEET TITLE

LIFE SAFETY ANALYSIS


SHEET NUMBER


G003

COLD FORMED FRAMING NOTES


ALL METAL STUDS TO BE 20 ga. AND PLACED AT 16 INCHES 0.C. UNLESS NOTED OTHERWISE OR WHERE THE LIMITING HEIGHT REQUIRES 16ga AT 16"

- 1. ALL FURRING CHANNELS TO BE 25 ga. AND PLACED AT 16 INCHES 0.C. UNLESS NOTED OTHERWISE.
- 2. PARTITIONS SUPPORTING WALL HUNG PLUMBING FIXTURES SHALL BE 16 ga. AND PLACED 16 INCHES O.C.
- 3. REFER TO STRUCTURAL DRAWINGS FOR STUD ga. SIZE AND SPACING FOR ALL STRUCTURALLY DESIGNED PARTITIONS.
- 4. REFER TO ASTM C754 FOR LIMITING HEIGHTS CRITERIA. LIMITING HEIGHTS ARE TO BE DETERMINED BY DEFLECTION CRITERIA RATIO OF <u>L/240</u>, AND LATERAL PRESSURE OF <u>5 PSF</u> UNLESS NOTED OTHERWISE OR DICTATED OTHERWISE BY PRESIDING BUILDING CODE. WHERE FLOOR TO STRUCTURE HEIGHT OF PARTITION EXCEEDS THE INDICATED LIMITING HEIGHT. PROVIDE SUPPLEMENTAL BRACING TO THE STRUCTURE OVERHEAD AS REQUIRED TO MAINTAIN REQUIRED DEFLECTION RATIO.
- FOR PARTITIONS WITH "BRITTLE" FINISHES SUCH AS PLASTER AND CERAMIC TILE, DESIGN PARTITION SYSTEM TO MAINTAIN DEFLECTION RATIO WITHIN L/360. SUSPENDED CEILINGS SHALL NOT BE CONSIDERED AS BRACING.

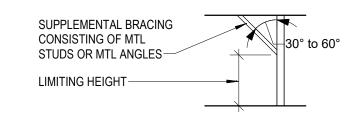

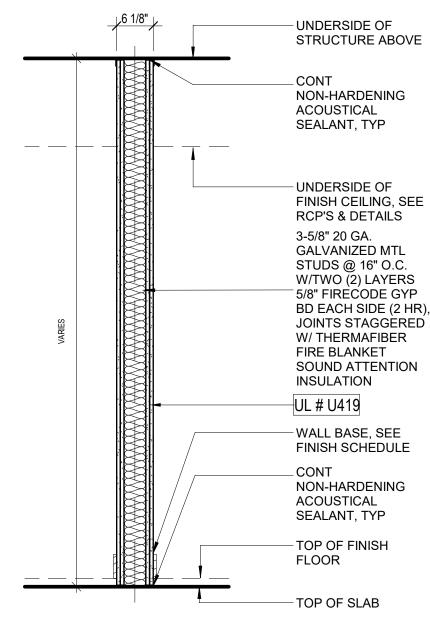



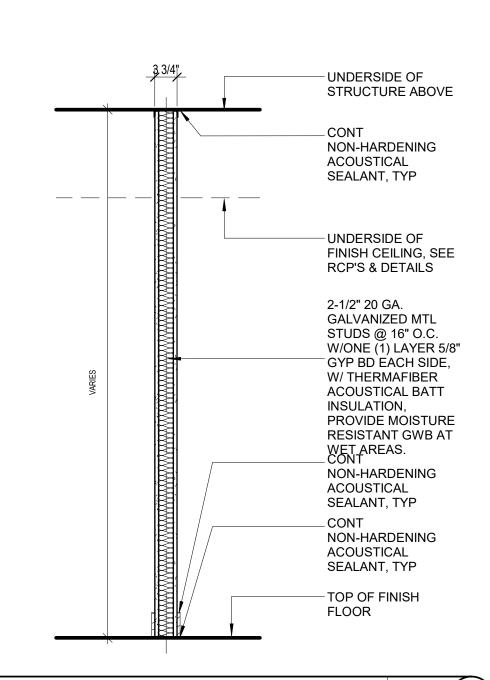

B1.1 NON-RATED PARTITION 2-1/2" STUD1 3/4" = 1'-0" 1

UNDERSIDE OF STRUCTURE ABOVE CONT **NON-HARDENING** ACOUSTICAL SEALANT, TYP UNDERSIDE OF RCP'S & DETAILS 3-5/8" 20 GA. **GALVANIZED MTL**

B7.1 FURRING WALL PARTITION 3-5/8" STUD | 3/4" = 1'-0" (4)

FINISH CEILING, SEE STUDS @ 16" O.C. W/ONE (1) LAYER 5/8" GYP BD EACH SIDE, W/ THERMAFIBER ACOUSTICAL BATT INSULATION, PROVIDE MOISTURE **RESISTANT GWB AT** WET AREAS. WALL BASE, SEE FINISH SCHEDULE CONT **NON-HARDENING** ACOUSTICAL

SEALANT, TYP

TOP OF FINISH

FLOOR

UNDERSIDE OF

STRUCTURE ABOVE

CONT NON-HARDENING

ACOUSTICAL SEALANT,

UNDERSIDE OF FINISH CEILING, SEE RCP'S &

3-5/8" 20 GA. GALVANIZED

MTL STUDS @ 16" O.C.

W/ONE (1) LAYER 5/8"

GYPSUM BOARD, W/

ACOUSTICAL BATT

INSULATION, PROVIDE

MOISTURE RESISTANT

GWB AT WET AREAS.

EXISTING COLUMN /

WALL BASE, SEE FINISH

CONT NON-HARDENING

ACOUSTICAL SEALANT,

TOP OF FINISH FLOOR

PARTITION

SCHEDULE

THERMAFIBER


DETAILS

B1.3 NON-RATED PARTITION 3-5/8" STUD1 3/4" = 1'-0" (3)

ACOUSTICAL NOTES

- 1. ALL ACOUSTICALLY CLASSED PARTITIONS SHALL BE CONSTRUCTED IN STRICT ACCORDANCE TO THE REFERENCED TEST.
- 2. STAGGER AND SEAL ALL JOINTS ON MULTIPLE GYPSUM BOARD LAYER PARTITIONS.
- 3. SEAL ALL PERIMETER GAPS, AIR TIGHT, AT THE FLOORS, HEAD, ADJACENT CONSTRUCTION AND AROUND ANY PENETRATING ELEMENTS WITH INTERIOR GRADE ACOUSTICAL SEALANT.
- 4. ALL BATTS AND BLANKETS IN RATED WALLS MUST BEAR THE REQUIRED U.L. CLASSIFICATION MARKING AS TO FIRE-RESISTANCE. ALSO REFER TO CODE COMPLIANCE DETAILS IN G010 SERIES.
- 5. AT ACOUSTICALLY RATED PARTITIONS, DO NOT FILL THE STUD CAVITY (DEPTH) FULLY WITH SOUND BATTS. THE WIDTH OF THE SOUND BATTS SHOULD BE SLIGHTLY SMALLER THAN CAVITY TO AVOID BATTS COMPRESSION. HOWEVER, THE ENTIRE LENGTH AND HEIGHT OF THE WALL SHOULD HAVE CONTINUOUS AND UNINTERRUPTED SOUND ATTENUATION BATTS.
- 6. SEAL ALL WALL INTERSECTIONS AND CONTROL JOINTS AT ACOUSTICALLY **CLASSED PARTITIONS**
- 7. SEAL ALL CONDUIT, STRUCTURAL, DUCT AND LARGE PIPE PENETRATIONS UNLESS THE PARTITION IS ALSO FIRE RATED WHERE THE CODE COMPLIANCE DETAILS
- 8. OUTLETS ON OPPOSITE SIDES OF ACOUSTICALLY CLASSED PARTITIONS

FIREWALL CONTROL JOINTS

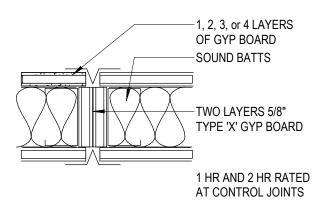

FIRE RATING NOTES

- 1. UNDERWRITERS LABORATORY AND OTHER TESTING AGENCY DESIGNATIONS INDICATED FOR FIRE RESISTIVE CONSTRUCTION ARE GIVEN FOR PURPOSES OF DESCRIBING CONSTRUCTION REQUIREMENTS ONLY AND ARE NOT INTENDED TO LIMIT MANUFACTURERS OF MATERIALS. COMPLY WITH THE CONSTRUCTION REQUIREMENTS OF THE INDICATED DESIGN.
- 2. ALL PARTITION TYPES SHOWN HERE ARE DRAWN AS "NON FIRE-RATED". WHERE FIRE RESISTIVE WALL CONSTRUCTION IS INDICATED, ON THE FLOOR PLANS, PROVIDE "TYPE X" GYPSUM WALLBOARD. AND FIRE RATED SEALANT AT PERIMETER JOINTS AND ALL PENETRATIONS, TYPICAL BOTH SIDES OF PARTITION AS INDICATED ON THE U.L. DETAILS AND ASSEMBLIES.
- 3. REFER TO SHEET G010 FOR U.L. LISTED ASSEMBLIES.


GYPSUM BOARD PARTITION PRIORITY LEGEND


PARTITION	DOOR RATING	PRIORITY
FOUR HOUR FIRE PARTITION	3 HOUR - A LABEL	PRIORITY 1 - HIGHEST
TWO HOUR FIRE/SMOKE PARTITION	1 1/2 HOUR - B LABEL	PRIORITY 2
TWO HOUR FIRE PARTITION	1 1/2 HOUR - B LABEL	PRIORITY 3
ONE HOUR FIRE/SMOKE PARTITION	3/4 HOUR - C LABEL	PRIORITY 4
ONE HOUR FIRE PARTITION	3/4 HOUR - C LABEL	PRIORITY 5
ONE HOUR FIRE PARTITION	20 MIN RATING	PRIORITY 6
NON-RATED PARTITION	NONE	PRIORITY 7 - LOWEST
	FOUR HOUR FIRE PARTITION TWO HOUR FIRE/SMOKE PARTITION TWO HOUR FIRE PARTITION ONE HOUR FIRE/SMOKE PARTITION ONE HOUR FIRE PARTITION ONE HOUR FIRE PARTITION	FOUR HOUR FIRE PARTITION 3 HOUR - A LABEL TWO HOUR FIRE/SMOKE PARTITION 1 1/2 HOUR - B LABEL TWO HOUR FIRE PARTITION 1 1/2 HOUR - B LABEL ONE HOUR FIRE/SMOKE PARTITION 3/4 HOUR - C LABEL ONE HOUR FIRE PARTITION 20 MIN RATING

GENERAL NOTES

SEALANT AT THOSE LOCATIONS AS REQUIRED.


- 1. ALL POSSIBLE VARIATIONS OF PARTITIONS TYPES AND <u>U.L. FIRE RATINGS ARE NOT</u> NECESSARILY UTILIZED IN THIS PROJECT AND ARE SHOWN FOR REFERENCE ONLY UNLESS RATED PARTITIONS ARE INDICATED ON THE FLOOR PLANS. WHERE U.L. RATED PARTITIONS ARE INDICATED, REFER TO FLOOR PLANS AND PROVIDE FIRE
- 2. WHERE FULL HEIGHT PARTITIONS ARE PERPENDICULAR TO SPAN OF STRUCTURAL JOISTS OR GIRDERS, THE PARTITION SHALL EXTEND TO THE UNDERSIDE OF STRUCTURE AND FOLLOW THE LINE OF STRUCTURE.
- 3. PROVIDE CEMENTITIOUS BACKER BOARD ON ALL WALLS TO RECEIVE CERAMIC TILE FINISH. PROVIDE WATER RESISTANT GYPSUM PANELS ON CEILINGS IN ROOMS THAT INCLUDE SHOWERS. FRAMING NOT TO EXCEED SPACING RECOMMENDED BY MANUFACTURER.
- 4. PROVIDE ONE LAYER OF 5/8" MOISTURE RESISTANT GYPSUM BOARD AT WALLS BEHIND SINKS AND LAVATORIES WITHOUT TILE. MOISTURE RESISTANT GYPSUM BOARD SHALL BE INSTALLED WITHIN 2' OF ALL URINALS AND WATER CLOSETS, TO A HEIGHT OF 4' AFF.
- 5. WHERE FIRE RESISTIVE CONSTRUCTION IS INDICATED, PROVIDE TYPE X-W/R BOARD. IN CONDITIONS WHERE NOTE 3 AND 4 APPLY, INSTALL 1 LAYER OF APPLICABLE MOISTURE RESISTANT BOARD OR CEMENTITIOUS BACKER BOARD OVER THE TYPE X-W/R BOARD. INSTALL PER MANUFACTURER LIMITATIONS.
- 6. STC RATINGS SHOWN FOR SOUND WALLS ARE BASED ON LABORATORY TESTED ASSEMBLIES AND DO NOT NECESSARILY INDICATE THE ACTUAL STC RATING OF THE COMPLETED WORK. PROVIDE MTL. DECK FILLERS WHERE FULL HEIGHT PARTITIONS ARE PERPENDICULAR TO SPAN OF DECK. DECK FILLERS ARE TO BE COMPATIBLE WITH ALL FIRE RATED ASSEMBLIES AND ARE TO BE APPROVED BY ALL GOVERNING
- 7. PROVIDE FIRE TREATED WOOD BLOCKING, SHEET METAL OR STEEL BACKING IN PARTITIONS TO SUPPORT WALL MOUNTED ITEMS AND EQUIPMENT, ETC.
- 8. REFER TO SPECIFICATIONS FOR ADDITIONAL INFORMATION.

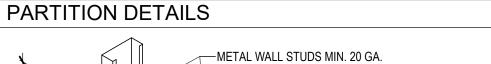

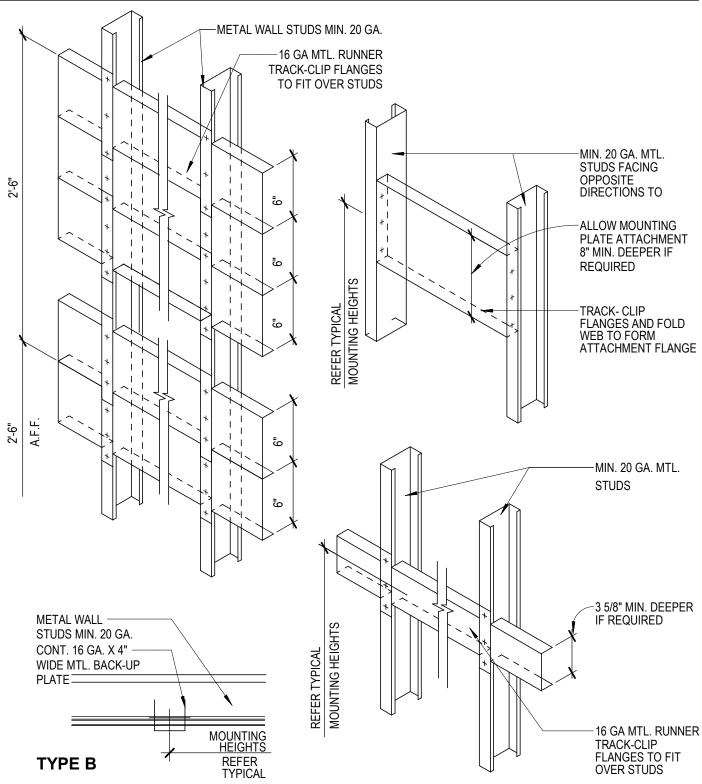

MOUNTING SUPPORT DETAILS


PROVIDE IN-WALL BRACING IN ALL PARTITIONS OR EXTERIOR WALLS WHERE GRAB BARS, HANDRAILS, SHOWER SEATS OR OTHER EQUIPMENT ANCHORS TO METAL STUD WALLS AND IN OTHER LOCATIONS AS NOTED ON THE DRAWINGS. CENTER STUDS ABOUT THE LOCATION OF THE DEVICE ANCHOR POINT. GRAB BAR BRACKET SHOWN, OTHER DEVICES SIMILAR.

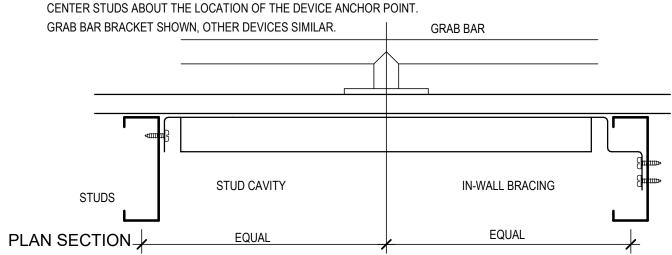

IN-WALL BRACING SHALL BE NO LESS THAN A 6" x 1 1/4" x 14 GUAGE CHANNEL, STEEL Fy = 50ksi, AND SHALL SUPPORT A 250 POUND GRAVITY LOAD CONCENTRATED AT ANY POINT ON THE DEVICE BEING ANCHORED.

16 GA.x4" WIDE MTL BACKUP PLATE MAY BE USED

IN-WALL BRACING

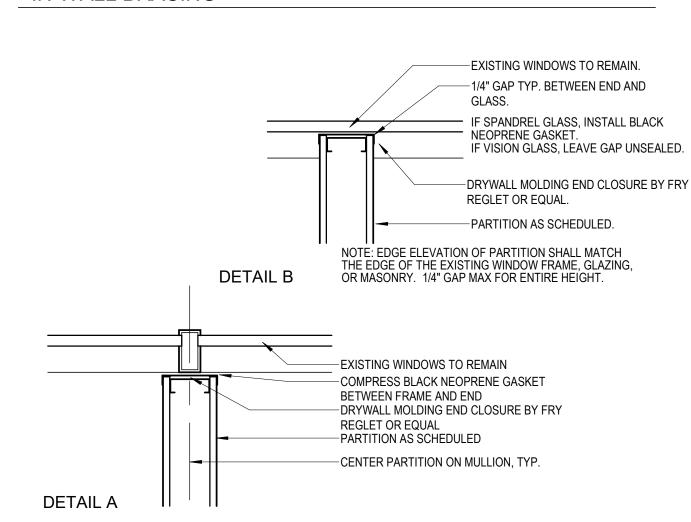

PARTITION AT MULLION DETAILS

SCALE: NONE

CLIENT



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PROJECT NAME **HOU-TERMINAL** - SECURITY **EXIT LANE**


PROJECT LOCATION WILLIAM P. HOBBY **AIRPORT** 7800 AIRPORT BLVD.

HOUSTON, TX 77061 PROJECT NUMBER

1004345 SHEET TITLE

PARTITION TYPES

SHEET NUMBER

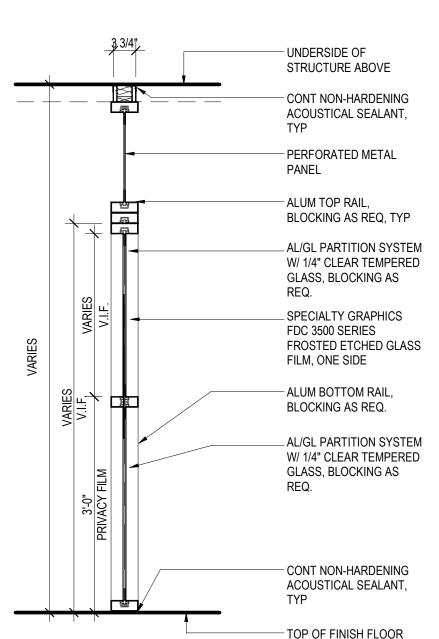

TOP OF FINISH FLOOR

CLIENT

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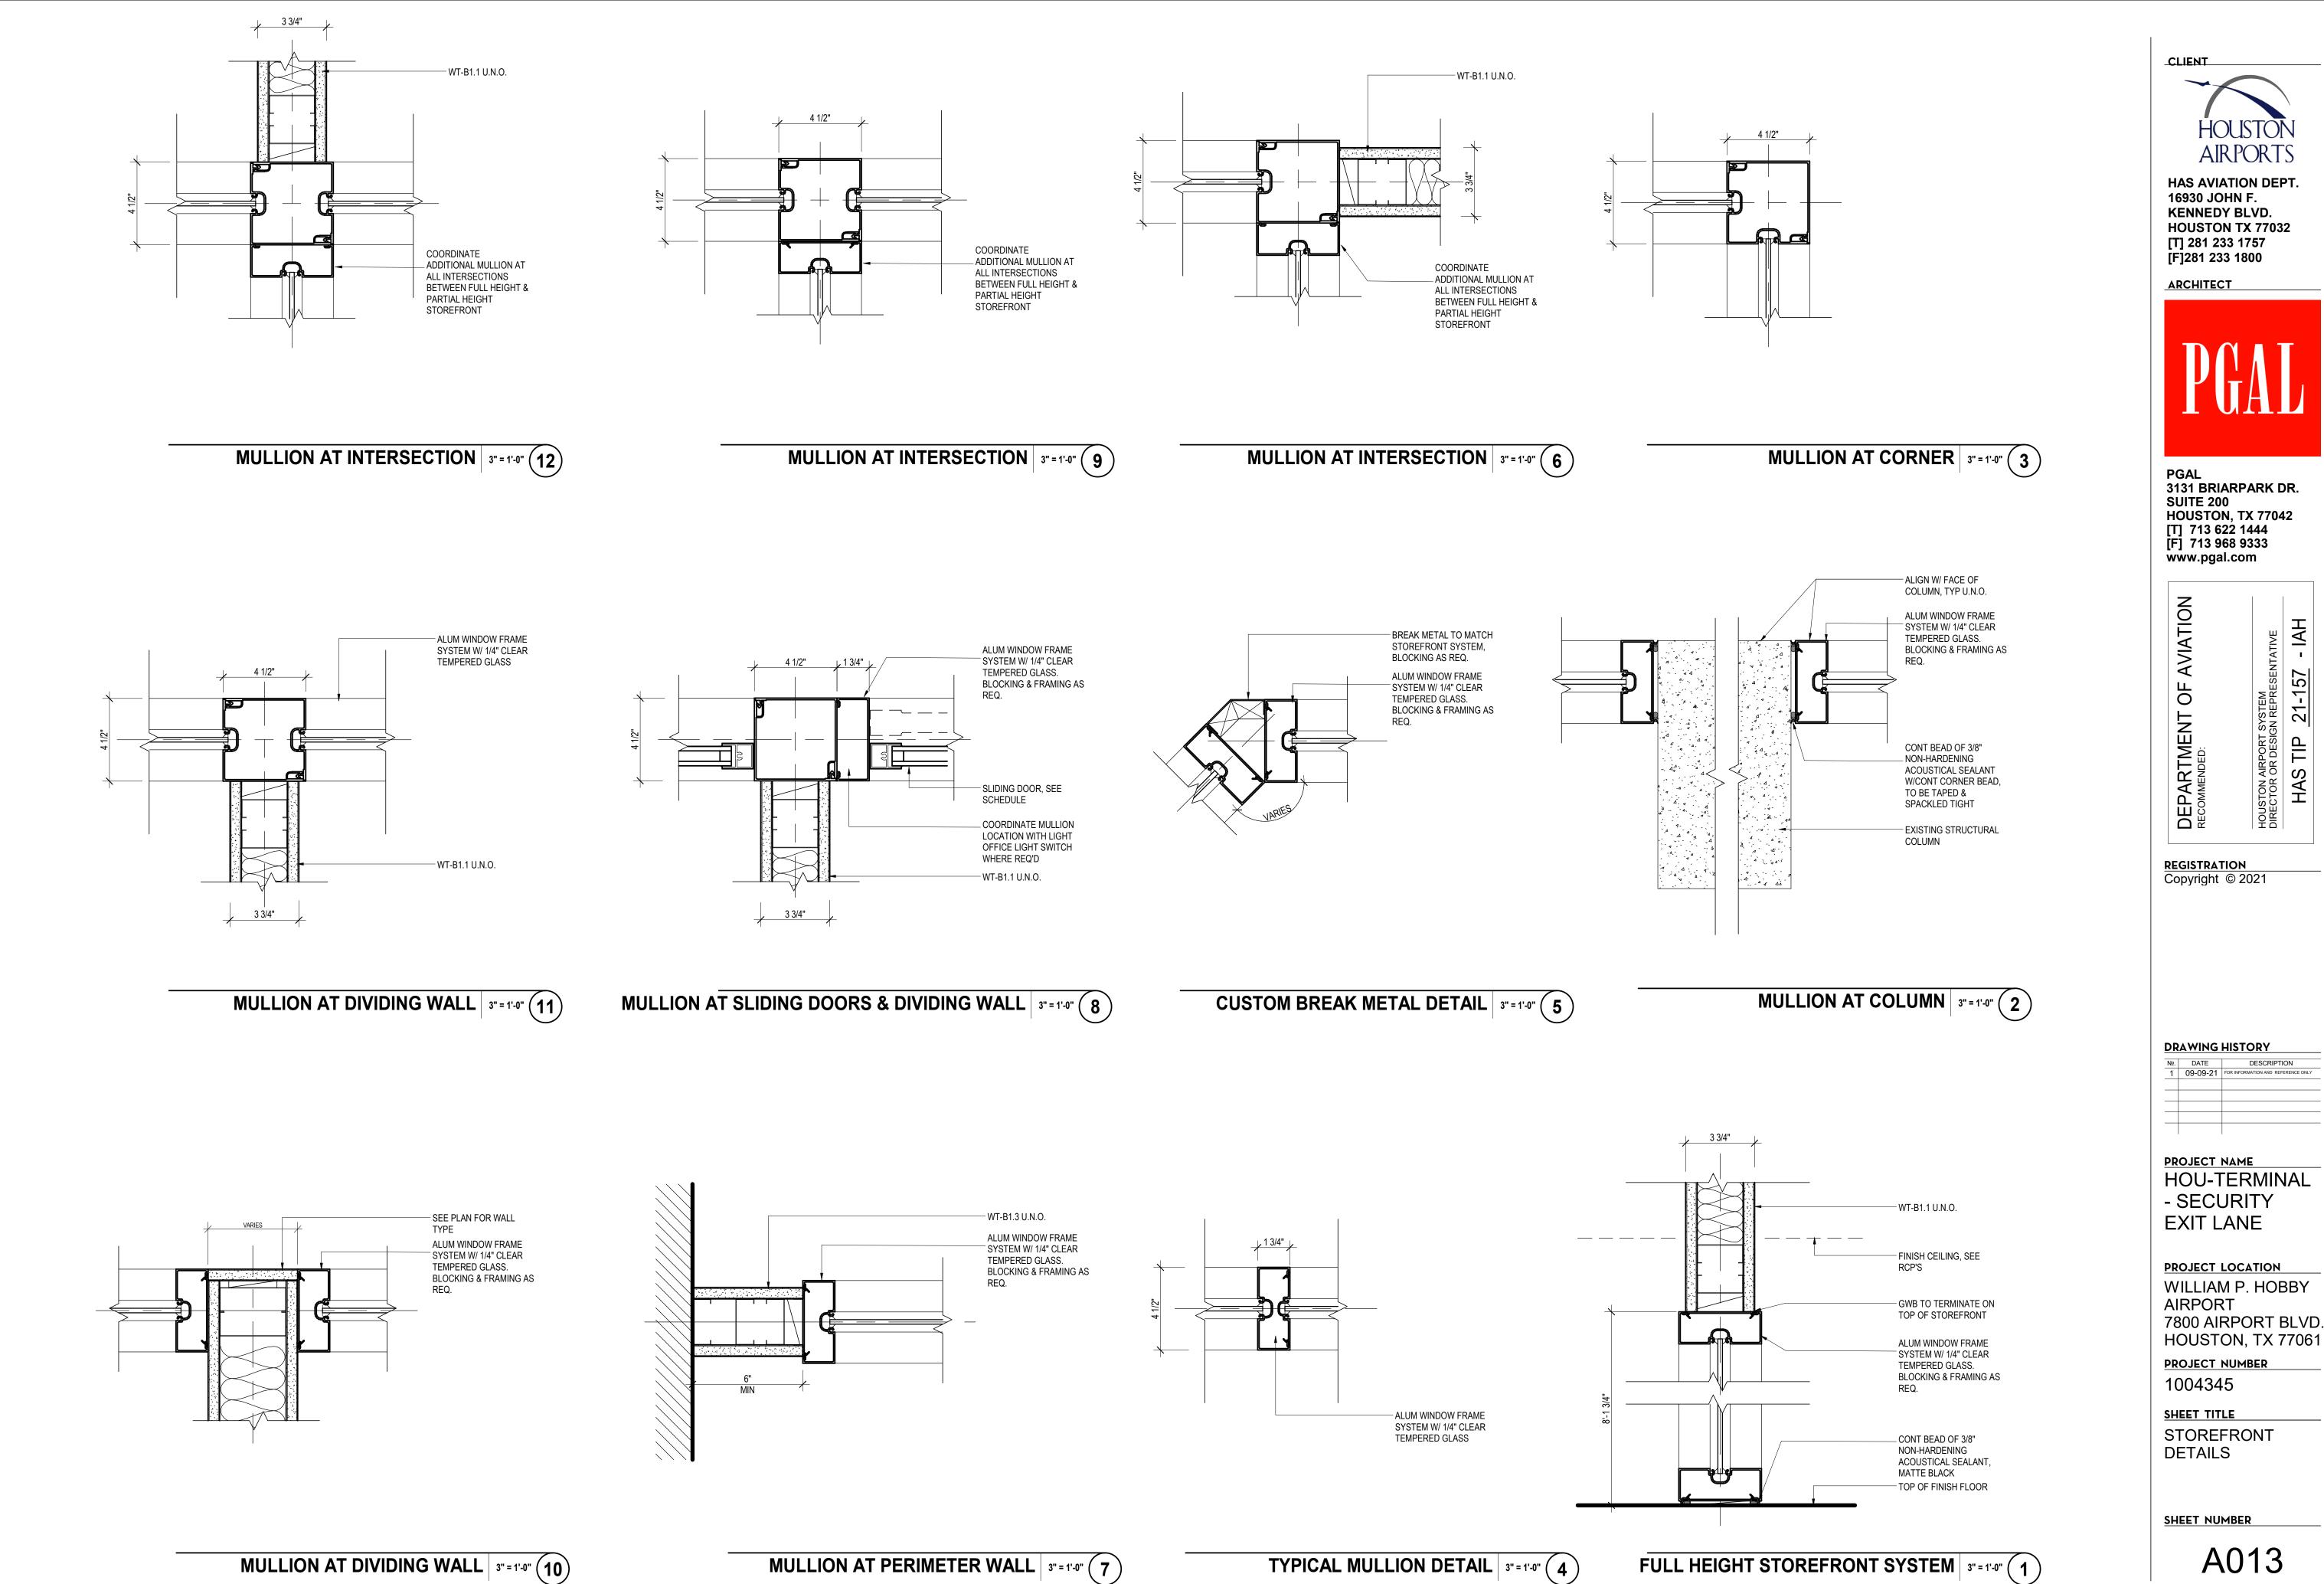
PROJECT NAME HOU-TERMINAL - SECURITY **EXIT LANE**

PROJECT LOCATION WILLIAM P. HOBBY **AIRPORT** 7800 AIRPORT BLVD. HOUSTON, TX 77061

PROJECT NUMBER 1004345


SHEET TITLE STOREFRONT **TYPES**

SHEET NUMBER




A013

DESCRIPTION

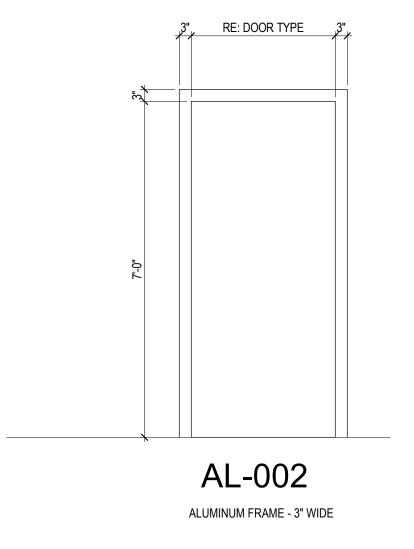

FRAME SCHEDULE 1/2" = 1'-0" 1

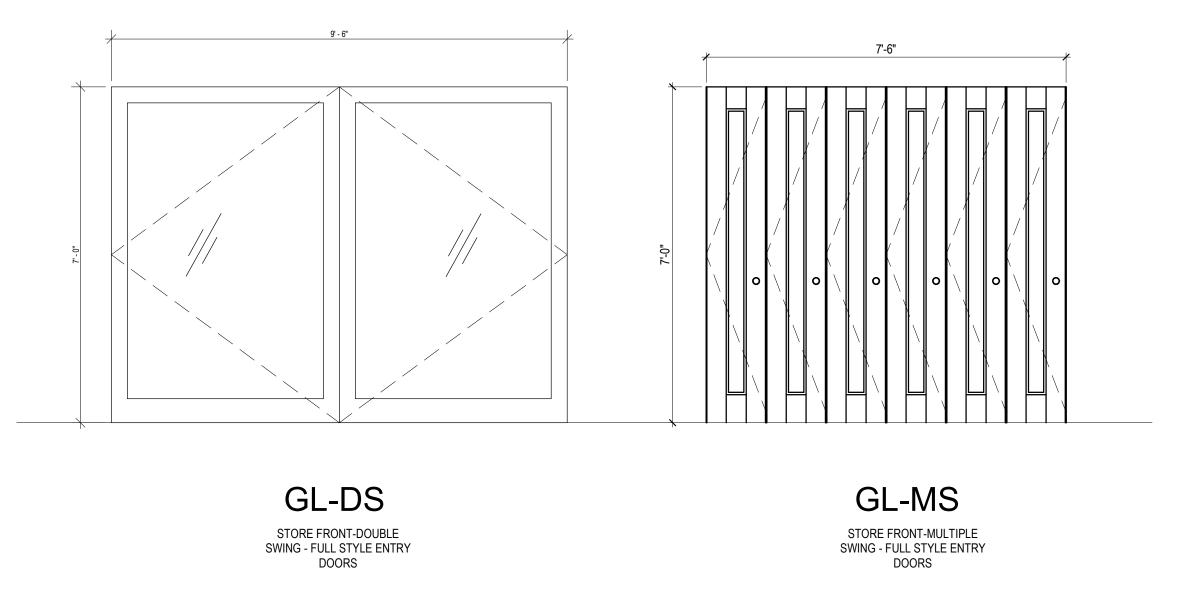


DOOR PANEL TYPES 1/2" = 1'-0" 4

GENERAL NOTES

- A. PROVIDE UNDERCUT AS REQUIRED FOR THRESHOLD MECHANICAL REQUIREMENTS.
 B. PROVIDE TEMPERED GLASS WHERE REQUIRED BY CODE.
 C. PROVIDE SILICONE SEALANT OVER BACKER ROD AT ALL EXTERIOR FRAMES.
 D. REFER TO SPECIFICATIONS FOR ADDITIONAL INFORMATION.
 E. ALL HOLLOW METAL FRAMES TO BE WELDED FRAMES.
- E. ALL HOLLOW METAL FRAMES TO BE WELDED FRAMES.
 F. SEE SHEETS A0.020 FOR FINISHES AND MATERIAL LEGENDS.
 G. USE GRAY GASKETS AT ALL GLASS DOORS UNLESS NOTED OTHERWISE.
 H. ALL ALUMINUM DOOR FRAMES TO BE CLEAR ANODIZED AS SPECIFIED U.N.O.
 I. ALL EXIT HARDWARE TO BE TIED TO FIRE ALARM SYSTEM

DOOR PANEL LEGEND

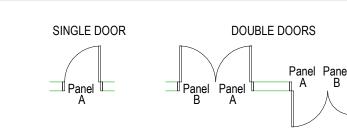

PANEL "A" WILL ALWAYS BE FROM LEFT HINGE SWINGING OUTWARD.

DOOR PANEL MATERIALS

AL - Aluminum

WD - Wood

GL - Glass

PL - Plastic Laminate

DOOR PANEL TYPES

F - Flush Panel, Single

DF - Flush Panel, Double**SS** - Storefront Panel, Single

DS - Storefront Panel, Double

MS - Storefront Panel, Multiple (More than 2)

FRAME MATERIALS

AL - Aluminum

HM - Hollow Metal

WD - Wood

DT - Detention Grade Steel

FRAME CONFIGURATION

Transom: **0** - No Transom 1 - Transom 0 - No Sidelite 1 - 1 Sidelite 2 - 2 Sidelites, 1 each side or both Frame Config: 1 - 2" Jamb/Head Wraps Wall 2 - 2" Jamb/Head, Mfr Standard 3 - 2" Jamb, 4" Head, Masonry 4 - ---5 - Transom & Sidelites Both Sides 6 - Sidelite On Either Side 7 - ---8 - ---H - Overhead Frame M - 4" Jamb/Head, Masonry W - Welded Wire Frame Legend: X ###

—Frame Configuration

-Side Lite

-Transom

-Material

ARCHITECT

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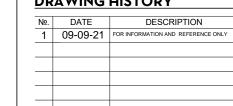


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- SECURITY
EXIT LANE

PROJECT LOCATION
WILLIAM P. HOBBY
AIRPORT

7800 AIRPORT BLVD.


HOUSTON, TX 77061

PROJECT NUMBER


1004345
SHEET TITLE


DOOR SCHEDULE

SHEET NUMBER

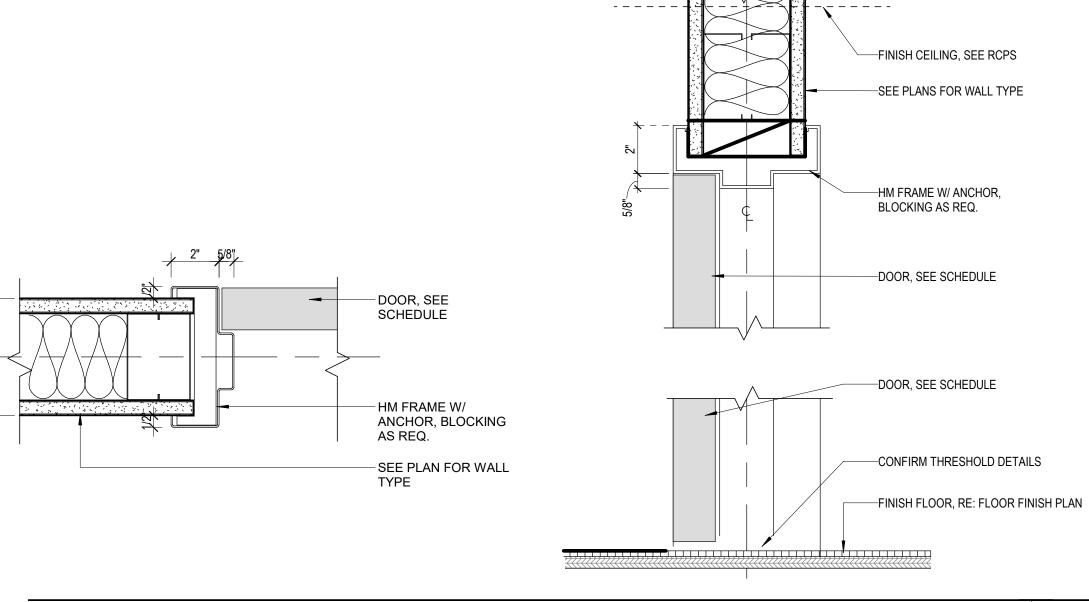

FR3 - HOLLOW METAL FRAME TYPE 3" = 1'-0" (3)

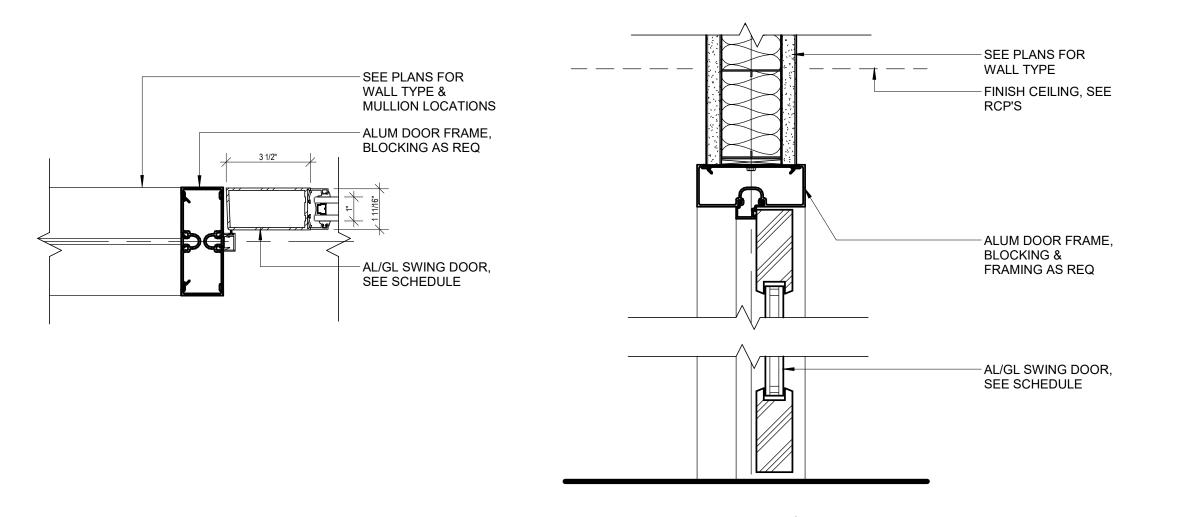

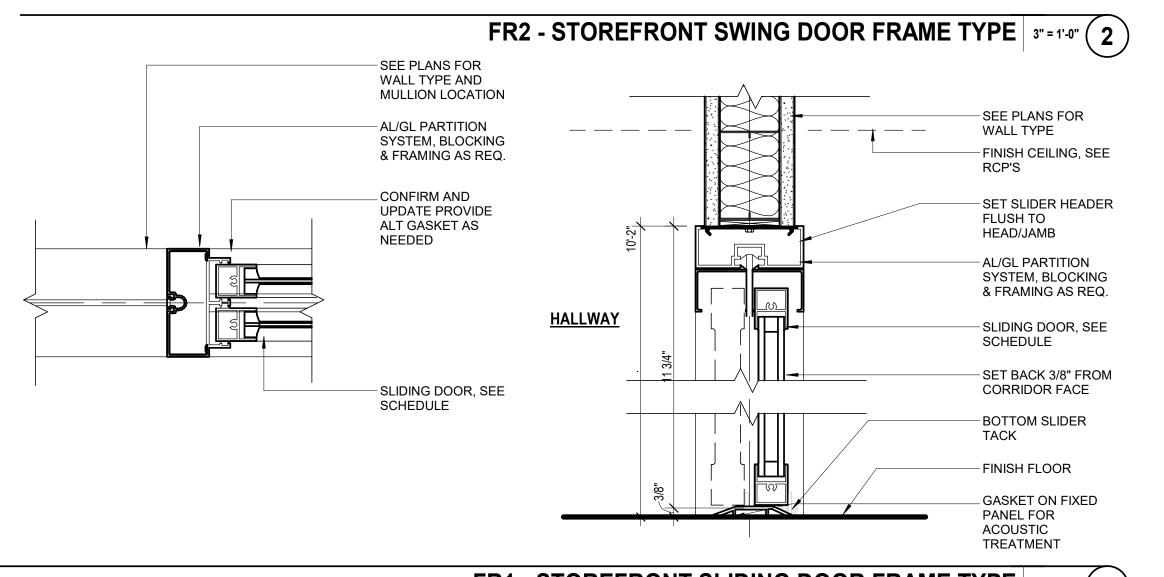

FR1 - STOREFRONT SLIDING DOOR FRAME TYPE 3" = 1'-0" 1

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KENNEDY BLVD.
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PROJECT NAME
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- SECURITY
EXIT LANE

PROJECT LOCATION
WILLIAM P. HOBBY
AIRPORT
7800 AIRPORT BLVD.
HOUSTON, TX 77061

PROJECT NUMBER 1004345

SHEET TITLE
DOOR DETAILS

SHEET NUMBER

GENERAL NOTES

- DO NOT SCALE DIMENSIONS FROM DRAWINGS, ANY UNKNOWN DIMENSION SHALL BE OBTAINED FROM DESIGN PROFFESIONALS VIA REQUEST FOR


- INFORMATION.

 5. REFER TO ENLARGED ELEVATIONS AND AXO ON SERIES SHEETS A400.

LEGEND

LEVEL 02 - TICKETING - FLOOR PLAN - TERMINAL 1/16" = 1'-0" 1

VIEW REFERENCE CALLOUT

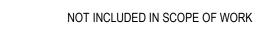

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DRAWING HISTORY

PROJECT NAME HOU-TERMINAL - SECURITY **EXIT LANE**

PROJECT LOCATION

WILLIAM P. HOBBY **AIRPORT** 7800 AIRPORT BLVD. HOUSTON, TX 77061

PROJECT NUMBER 1004345

SHEET TITLE

OVERALL FLOOR PLAN - TERMINAL

SHEET NUMBER

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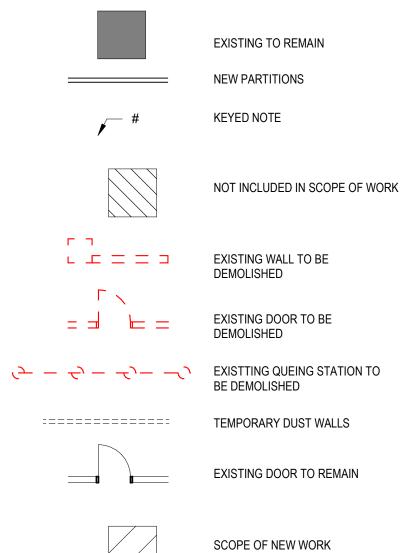
GENERAL NOTES - DEMO

- 1. DO NOT SCALE DIMENSIONS FROM DRAWINGS, ANY UNKNOWN DIMENSION SHALL BE OBTAINED FROM DESIGN PROFFESIONALS VIA REQUEST FOR INFORMATION (RFI).
- 2. CONTRACTOR SHALL FIELD VERIFY ALL EXISTING CONDITIONS PRIOR TO
- COMMENCING WORK.
 3. CONTRACTOR SHALL NOTIFY ARCHITECT OF ANY DISCREPANCY, INACCURACY
- OR CONFLICTING INFORMATION BEFORE EXECUTION OF WORK.

 4. REFER TO WALL PARTITION/STOREFRONT TYPES SHEET A011 FOR ADDTIONAL
- INFORMATION.
 5. REFER TO ENLARGED ELEVATIONS AND AXO ON SERIES SHEETS A400.
- 6. REFER TO DOOR SCHEDULES AND DOOR TYPES SHEET A030.
- ALL SHAFT PENETRATING SLAB SHALL BE RATED 2H.
 ARCHITECTURAL LIGHTING ARE FOR LOCATE AND TYPE REFERENCE ONLY, REFER TO ELECTRICAL DRAWINGS FOR FIXTURE DESIGNATIONS AND
- SPECIFICATIONS.
- 9. USE UNISTRUT BELOW MECHANICAL DUCT OR STRUCTURAL BEAMS TO

ACCOMMODATE LIGHT FIXTURES AS NEEDED. 10. PATCH AND REPAIR EXISTING EXPOSED CEILINGS AS NEEDED.

LEGEND - PHASING PLAN



PHASING PLAN KEYNOTES

02.01 PHASE ONE: DEMO EXISTING DOORS
02.02 PHASE ONE: EXISTING GRAPHICS TO BE REMOVED
02.03 PHASE TWO: INSTALL NEW DUST WALL. FIRE TREATED WOOD FRAME AND PLYWOOD, PAINTED WHITE TO PUBLIC SIDE. WALLS TO BE LOCKABLE.
02.04 PHASE THREE: BYPASS DOORS
02.05 PHASE FOUR: INSTALL NEW WORK PER SCOPE – TEST & CLOSEOUT.

PHASE FIVE: REMOVE DUSTWALLS.

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- SECURITY
EXIT LANE

PROJECT LOCATION

WILLIAM P. HOBBY AIRPORT 7800 AIRPORT BLVD. HOUSTON, TX 77061

PROJECT NUMBER 1004345

SHEET TITLE

ENLARGED FLOOR PLAN - TERMINAL -PHASING PLAN

SHEET NUMBER

AP200




GENERAL NOTES - DEMO


- DO NOT SCALE DIMENSIONS FROM DRAWINGS, ANY UNKNOWN DIMENSION SHALL BE OBTAINED FROM DESIGN PROFFESIONALS VIA REQUEST FOR INFORMATION (RFI).
- 2. CONTRACTOR SHALL FIELD VERIFY ALL EXISTING CONDITIONS PRIOR TO COMMENCING WORK.
 3. CONTRACTOR SHALL NOTIFY ARCHITECT OF ANY DISCREPANCY, INCACURACY
- OR CONFLICTING INFORMATION BEFORE EXECURTION OF WORK.

 4. REFER TO WALL PARTITION/STOREFRONT TYPES SHEET A011 FOR ADDTIONAL INFORMATION.
- 5. REFER TO ENLARGED ELEVATIONS AND AXO ON SERIES SHEETS A400.
- 6. REFER TO DOOR SCHEDULES AND DOOR TYPES SHEET A030.
- 7. ALL SHAFT PENETRATING SLAB SHALL BE RATED 2H. 8. ARCHITECTURAL LIGHTING ARE FOR LOCATE AND TYPE REFERENCE ONLY, REFER TO ELECTRICAL DRAWINGS FOR FIXTURE DESIGNATIONS AND
- SPECIFICATIONS.
- 9. USE UNISTRUT BELOW MECHANICAL DUCT OR STRUCTURAL BEAMS TO ACCOMMODATE LIGHT FIXTURES AS NEEDED. 10. PATCH AND REPAIR EXISTING EXPOSED CEILINGS AS NEEDED.


LEGEND - DEMO

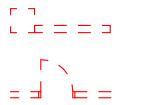


EXISTING WALL TO BE DEMOLISHED

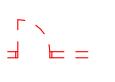

EXISTING DOOR TO BE DEMOLISHED

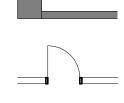

EXISTING WALL TO REMAIN

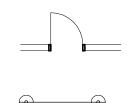

EXISTING DOOR TO REMAIN



QUEUING STANCHION



KEYED NOTE



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AVIATION

OF

PROJECT NAME HOU-TERMINAL - SECURITY **EXIT LANE**

PROJECT LOCATION

WILLIAM P. HOBBY **AIRPORT** 7800 AIRPORT BLVD. HOUSTON, TX 77061

PROJECT NUMBER

1004345 SHEET TITLE DEMOLITION FLOOR PLAN

-TERMINAL

SHEET NUMBER

AD200

GENERAL NOTES - PLAN

- 1. DO NOT SCALE DIMENSIONS FROM DRAWINGS, ANY UNKNOWN DIMENSION SHALL BE OBTAINED FROM DESIGN PROFFESIONALS VIA REQUEST FOR INFORMATION (RFI).
- 2. CONTRACTOR SHALL FIELD VERIFY ALL EXISTING CONDITIONS PRIOR TO COMMENCING WORK.
- 3. CONTRACTOR SHALL NOTIFY ARCHITECT OF ANY DISCREPANCY, INCACURACY OR CONFLICTING INFORMATION BEFORE EXECURTION OF WORK.
- 4. REFER TO WALL PARTITION/STOREFRONT TYPES SHEET A011 FOR ADDTIONAL INFORMATION.
- 5. REFER TO ENLARGED ELEVATIONS AND AXO ON SERIES SHEETS A400.
- 6. REFER TO DOOR SCHEDULES AND DOOR TYPES SHEET A030.
- 7. ALL SHAFT PENETRATING SLAB SHALL BE RATED 2H.
- 8. CONTRACTOR SHALL FIELD COORDINATED LOCATION, SIZE AND TYPE OF BLOCKING FOR INSTALLATION OF SIGNAGE, MILLWORK, ETC. ALL CONCEALED WOOD SHALL BE FIRE RETARDANT TREATED (FRT).


GENERAL NOTES

- 1. FIELD COOORDINATE CONDUIT ROUTING
- 2. EXPOSED CODUIT SHALL BE PAINTED TO MATCH ADJACENT SURFACES 3. LABEL SECURITY CONDUITS. REFER TO NOTES ON SHEET G002.
- 4. ALL SECURITY SYSTEM EQUIPMENT FURNISHINGS, CONDUIT, CABLING AND OTHER RELATED MATERIALS AND INTERFACES SHALL BE INSTALLED IN ACCORDANCE WITH PROJECT CONTRUCTION DOCUMENTS AND SCHEDULES.
- 5. CONTRACTOR SHALL FURNISH AND INSTALL ALL CABLING AND CONDUIT FROM SECURTIY DEVICE LOCATIONS TO DESIGNTATED NODES/ROOMS. CABLING SHALL BE OF APPROPRIATE TYPE AND GAUGE AS REQUIRED BY THE MANUFACTURER, FOR PROPER SYTEM OPERATION. CONTRACTOR SHALL ENSURE CABLES TO EACH DEVICE PROVIDE SUFFICIENT VOLTAGE, OR SIGNAL STRENGTH TO OPERATE WITHIN MANUFACTURERS SPECIFIED LIMITS. 6. CONTRACTOR SHALL COORDINATE EXACT DEVICE MOUNTING LOCATIONS WITH
- OWNERS DESIGNATED REPRESENTATIVE AND OTHER TRADES PRIOOR TO INSTALLATION OF DEVICES AND RELATED INFRASTRUCTURE.
- 7. CONTRACTOR SHALL FIELD VERIFY AND COORDINATE WITH OWNERS DESIGNATED REPRESENTATVIE FINAL FIELD OF VIEW OF SECURITY CAMERAS. 8. ALL SECURITY CAMERAS SHALL BE PROVIDED WITH APPROPRIATE HOUSING
- AND MOUNTS IN IDENTIFIED LOCATIONS. 9. CONTRACTOR SHALL PATCH AND REPAIR ANY SURFACE AFFECTED FROM INSTALLLATION IN THE COURSE OF THE SCOPE OF WORK TO ORIGINAL OR
- 10. EXISTING SECURTIY INFRASTRUCTRE AND COMPONENTS EFFECTED BY CONSTRUCTION SHALL BE REROUTED AND/OR DECOMMISIONED.

LEGEND



EXISTING TO REMAIN

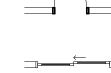

NEW SLIDING DOOR

NEW DOOR

1271.2

SCHEDULED DOOR. REFER TO SHEET A0.30

SCHEDULED PARTITION REFER TO SHEETS A0.11

MATERIAL TAG

NOT INCLUDED IN SCOPE OF WORK

CLIENT



HAS AVIATION DEPT. 16930 JOHN F. **KENNEDY BLVD. HOUSTON TX 77032** [T] 281 233 1757 [F]281 233 1800

ARCHITECT



PGAL 3131 BRIARPARK DR. **SUITE 200** HOUSTON, TX 77042 [T] 713 622 1444 [F] 713 968 9333 www.pgal.com

AVIATION OF DEPARTMENT

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PROJECT NAME HOU-TERMINAL - SECURITY **EXIT LANE**

PROJECT LOCATION

WILLIAM P. HOBBY **AIRPORT** 7800 AIRPORT BLVD. HOUSTON, TX 77061

PROJECT NUMBER 1004345

SHEET TITLE

ENLARGED FLOOR PLAN - TERMINAL

SHEET NUMBER



GENERAL NOTES

PGAL 3131 BRIARPARK DR. SUITE 200 HOUSTON, TX 77042 [T] 713 622 1444 [F] 713 968 9333 www.pgal.com

CLIENT

HOUSTON AIRPORTS

HAS AVIATION DEPT. 16930 JOHN F.

KENNEDY BLVD. HOUSTON TX 77032 [T] 281 233 1757

[F]281 233 1800

ARCHITECT

AVIATION OF DEPARTMENT

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DRAWING HISTORY

PROJECT NAME HOU-TERMINAL - SECURITY

PROJECT LOCATION

EXIT LANE

WILLIAM P. HOBBY **AIRPORT** 7800 AIRPORT BLVD. HOUSTON, TX 77061

PROJECT NUMBER

1004345

SHEET TITLE **ENLARGED ELEVATIONS & AXO** - TERMINAL

SHEET NUMBER

INTERIOR ELEVATION 01 1/4" = 1'-0" 7

CLIENT



HAS AVIATION DEPT. 16930 JOHN F. KENNEDY BLVD. HOUSTON TX 77032 [T] 281 233 1757 [F]281 233 1800

ARCHITECT



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DEPARTMENT OF AVIATION

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DRAWING HISTORY

PROJECT NAME
HOU-TERMINAL
- SECURITY
EXIT LANE

PROJECT LOCATION


WILLIAM P. HOBBY AIRPORT 7800 AIRPORT BLVD. HOUSTON, TX 77061

PROJECT NUMBER 1004345

SHEET TITLE

ENLARGED AXO -TERMINAL

SHEET NUMBER

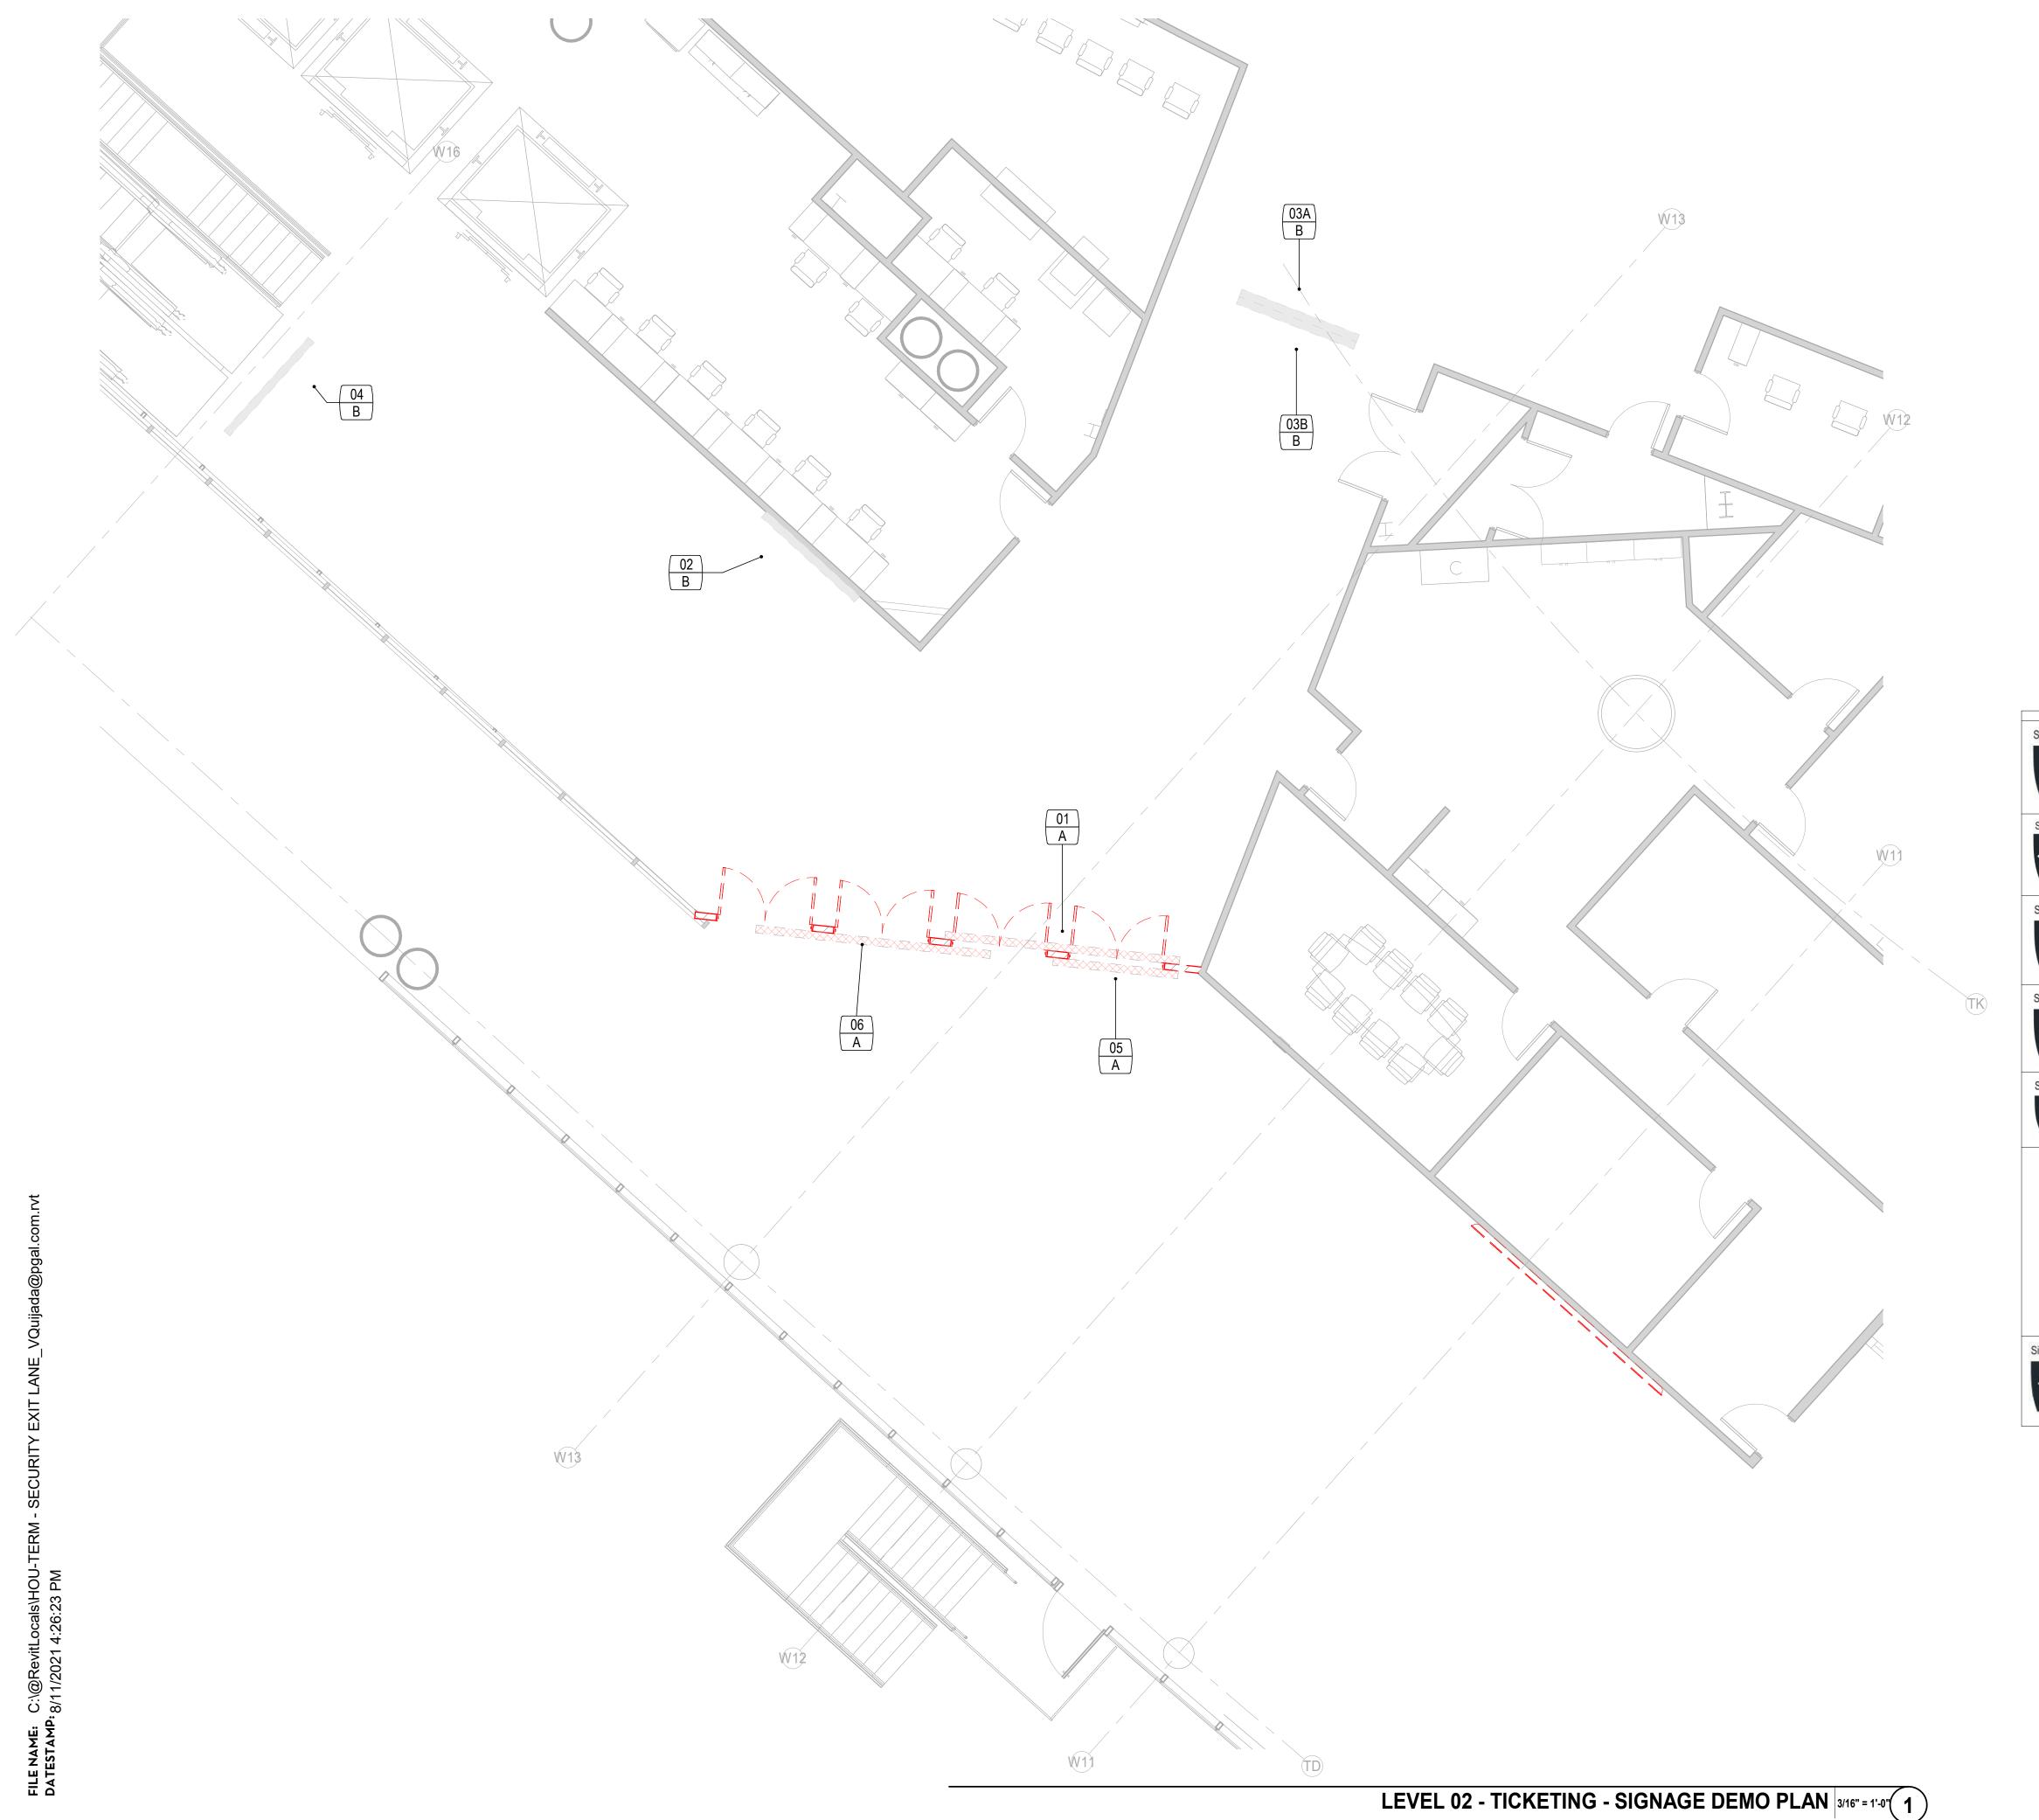

KEYNOTES

A EXISTING CEILING MOUNTED SIGN TO BE REPLACED, PATCH/REPAIR AS B EXISTING SIGN TO REMAIN, UNLESS NOTED OTHERWISE

GENERAL NOTES


- DO NOT SCALE DIMENSIONS FROM DRAWINGS, ANY UNKNOWN DIMENSION SHALL BE OBTAINED FROM DESIGN PROFFESIONALS VIA REQUEST FOR INFORMATION (RFI).
 CONTRACTOR SHALL FIELD VERIFY ALL EXISTING CONDITIONS PRIOR TO COMMENCING WORK.
 CONTRACTOR SHALL NOTIFY ARCHITECT OF ANY DISCREPANCY, INCACURACY OR CONTRACTOR SHALL NOTIFY ARCHITECT OF ANY DISCREPANCY, INCACURACY

- OR CONFLICTING INFORMATION BEFORE EXECURTION OF WORK.
- ALL SHAFT PENETRATING SLAB SHALL BE RATED 2H.
 CONTRACTOR SHALL FIELD COORDINATED LOCATION, SIZE AND TYPE OF BLOCKING FOR INSTALLATION OF SIGNAGE, MILLWORK, ETC. ALL CONCEALED WOOD SHALL BE FIRE RETARDANT TREATED (FRT).

LEGEND

EXISTING SIGNAGE TO REMAIN

EXISTING TO REPLACED

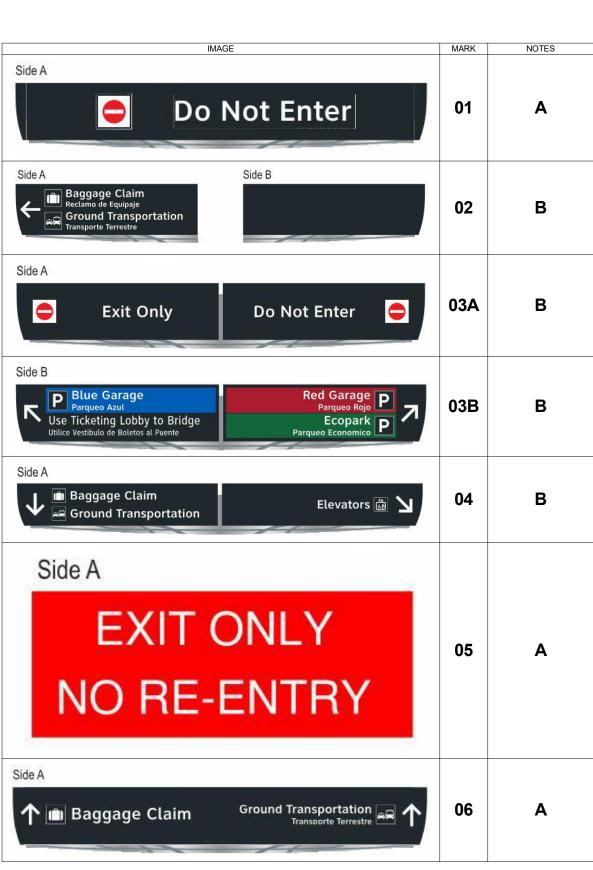

CLIENT



HAS AVIATION DEPT. 16930 JOHN F. KENNEDY BLVD. **HOUSTON TX 77032** [T] 281 233 1757 [F]281 233 1800

ARCHITECT



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DRAWING HISTORY

PROJECT NAME HOU-TERMINAL - SECURITY **EXIT LANE**

PROJECT LOCATION

WILLIAM P. HOBBY **AIRPORT** 7800 AIRPORT BLVD. HOUSTON, TX 77061

PROJECT NUMBER

1004345 SHEET TITLE

HOU TERMINAL SIGNAGE DEMO PLAN

SHEET NUMBER

ADG200



KEYNOTES

A NEW SIGNAGE

GENERAL NOTES

- 1. DO NOT SCALE DIMENSIONS FROM DRAWINGS, ANY UNKNOWN DIMENSION SHALL BE OBTAINED FROM DESIGN PROFFESIONALS VIA REQUEST FOR INFORMATION (RFI).

- INFORMATION (RFI).
 CONTRACTOR SHALL FIELD VERIFY ALL EXISTING CONDITIONS PRIOR TO COMMENCING WORK.
 CONTRACTOR SHALL NOTIFY ARCHITECT OF ANY DISCREPANCY, INCACURACY OR CONFLICTING INFORMATION BEFORE EXECURTION OF WORK.
 ALL SHAFT PENETRATING SLAB SHALL BE RATED 2H.
 CONTRACTOR SHALL FIELD COORDINATED LOCATION, SIZE AND TYPE OF BLOCKING FOR INSTALLATION OF SIGNAGE, MILLWORK, ETC. ALL CONCEALED WOOD SHALL BE FIRE RETARDANT TREATED (FRT).

LEGEND





CLIENT

HAS AVIATION DEPT. 16930 JOHN F. KENNEDY BLVD. HOUSTON TX 77032 [T] 281 233 1757 [F]281 233 1800

ARCHITECT



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DEPARTMENT
RECOMMENDED:

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PROJECT NAME HOU-TERMINAL - SECURITY **EXIT LANE**

PROJECT LOCATION

WILLIAM P. HOBBY **AIRPORT** 7800 AIRPORT BLVD. HOUSTON, TX 77061

PROJECT NUMBER

1004345

SHEET TITLE HOU TERMINAL SIGNAGE PLAN

SHEET NUMBER

AG200

LEVEL 02 - TICKETING -SIGNAGE PLAN 3/16" = 1'-0" 1

C:\Use	8/9/203
FILE NAME:	DATESTAMP;

MISCELLA	ANEOUS
SYMBOL	DESCRIPTION
<u> </u>	DISCONNECT SWITCH, NON-FUSIBLE 3 POLE, 60 AMP, NF: NON-FUSED, 3R: NEMA 3R ENCLOSURE
<u> 3P/60A</u> 3R F:50A	DISCONNECT SWITCH, FUSIBLE 3 POLE, 60 AMP, FUSED AT 50 AMPS, 3R: NEMA 3R ENCLOSURE
<u>□</u> 3P/60A 3R	COMBINATION STARTER / DISCONNECT SWITCH, FUSIBLE 3 POLE, 60 AMP, NEMA x SIZE, 3R: NEMA 3R ENCLOSURE
\bowtie	MAGNETIC MOTOR STARTER
42	ENCLOSED CIRCUIT BREAKER, AS INDICATED
4□ VFD	VFD-RATED, REMOTE DISCONNECT SWITCH WITH EARLY-BREAK, AUXILIARY CONTACTS FOR VFD DECELERATE-TO-STOP SIGNAL. CONNECT CONTROL WIRING TO ASSOCIATED VFD (AS REQUIRED).
	PANELBOARD, 480 / 277V
	PANELBOARD, 208 /120V
SPD	SURGE PROTECTION DEVICE
	ELECTRICAL METER
TX	TRANSFORMER
<u> </u>	GROUND BUS BAR
	3/4" PLYWOOD TELEPHONE BACKBOARD
	CONCRETE ENCASED DUCTBANK
	HOMERUN TO PANEL INDICATED NUMBER OF ARROWS INDICATE NUMBER OF CIRCUITS
	WIRE IN CONDUIT CONCEALED, #12 AWG SIZE WIRE IN 1/2" CONDUIT MINIMUM UNLESS OTHERWISE NOTED
/-\	
	CONDUIT EXPOSED
~~~	<b>₩IRXIBU©QUNDU</b> I©ONCEALED BELOW SLAB OR GRADE
o	CONDUIT TURNING UP
•	CONDUIT TURNING DOWN
<u> </u>	CONDUIT STUB

LOW VOL	TAGE (RACEWAY ONLY)
SYMBOL	DESCRIPTION
▼X,N	INFORMATION OUTLET
$oldsymbol{ar{V}}$	INFORMATION OUTLET, FLOOR MOUNTED
TY	CATV OUTLET

**ELECTRICAL ABBREVIATIONS** 

ALTERNATING CURRENT

ARC FAULT CIRCUIT INTERRUPTER

AMPERE INTERRUPTING CAPACITY

**AUTOMATIC TRANSFER SWITCH** 

CLOSED CIRCUIT TELEVISION

AMERICAN WIRE GAUGE

AIR CONDITIONING

AIR HANDLING UNIT

CABLE TELEVISION

CRITICAL BRANCH

CIRCUIT BREAKER

DIRECT CURRENT

EXHAUST FAN

**EMERGENCY** 

FIRE ALARM

GROUND

GROUND

**ELEVATOR** 

**EQUIPMENT BRANCH** 

EMERGENCY POWER

EXISTING TO REMAIN

FULL LOAD AMPERES

ISOLATED GROUND

FLEXIBLE METAL CONDUIT

ELECTRICAL CONTRACTOR

ENCLOSED CIRCUIT BREAKER

**ELECTRICAL METALLIC TUBING** 

EXISTING TO BE REMOVED

EXISTING TO BE RELOCATED

FIRE ALARM ANNUNCIATOR PANEL

GROUND FAULT CIRCUIT INTERRUPTER

HEATING, VENTILATION, AIR CONDITIONING

INSTITUTE OF ELECTRICAL AND ELECTRONIC ENGINEERS

GALVANIZED RIGID METAL CONDUIT

HAND-OFF-AUTOMATIC SWITCH

ELECTRIC WATER COOLER

EMERGENCY POWER OFF (BUTTON OR SWITCH)

DESCRIPTION

**AMPERES** 

ALUMINUM

CONDUIT

CIRCUIT

CIRCUIT

COPPER

DIAMETER

SYMBOL

AWG

CATV

CB

C/B

CIR

CKT

ECB

ELEV

EPO

ETR

**EWC** 

FMC

GRC

HOA

HVAC

G, GND

CCTV

RECEPTACLE(S)		
SYMBOL	DESCRIPTION	
$\bigoplus$	DUPLEX RECEPTACLE, 20 AMP, 120V U.O.N.	
<b>(</b>	DUPLEX RECEPTACLE, 20 AMP, 120V U.O.N. MOUNTED AT 48" UNLESS NOTED OTHERWISE	
	DUPLEX RECEPTACLE, 20 AMP, 120V U.O.N. AUTOMATIC SWITCHED RECEPTACLE	
	QUADRUPLEX RECEPTACLE, 20 AMP, 120V U.O.N. HALF-AUTOMATIC SWITCHED RECEPTACLE	
<b>#</b>	QUADRAPLEX RECEPTACLE, 20 AMP, 120V U.O.N.	
<b>\</b>	QUADRAPLEX RECEPTACLE, 20 AMP, 120V U.O.N. MOUNTED AT 48" UNLESS NOTED OTHERWISE	
Ф	SINGLE RECEPTACLE, 20 AMP, 120V U.O.N.	
Ф	GFI - TYPE DUPLEX RECEPTACLE (WP: DENOTES WEATHERPROOF COVER)	
	GFI - TYPE DOUBLE DUPLEX RECEPTACLE	
	GFI - DUPLEX RECEPTACLE MOUNTED AT 48" UNLESS OTHERWISE NOTED	
	GFI - DOUBLE DUPLEX RECEPTACLE MOUNTED AT 48" UNLESS OTHERWISE NOTED	
	SPECIAL PURPOSE RECEPTACLE (NEMA RATING AS INDICATED)	
igoplus	DUPLEX RECEPTACLE - HALF SWITCHED	
ф	DUPLEX RECEPTACLE - CEILING MOUNTED	
$\oplus^{IG}$	DUPLEX RECEPTACLE WITH ISOLATED GROUND	
$\square$	DUPLEX RECEPTACLE - FLOOR MOUNTED	
J	JUNCTION BOX - CEILING MOUNTED	
Ţ	JUNCTION BOX - WALL MOUNTED	
[J]	JUNCTION BOX - FLOOR / GROUND MOUNTED	

### FIELD VERIFY ALL LOCATION

DESCRIPTION

LIGHTING

INTERMEDIATE METAL CONDUIT

LIQUID TIGHT FLEXIBLE METAL CONDUIT

THOUSAND CIRCULAR MILS

KILOVOLT - AMPERES

LOCK ROTOR AMPS

METAL CLAD CABLE

MAIN LUGS ONLY

MOUNTED

NIGHT LIGHT

POLE

POWER

QUANTITY

REQUIRED

ROOF TOP UNIT

SHUNT-TRIP

SYMMETRICAL

TELEPHONE

SWITCH

TYPICAL UNDERGROUND

VOLT

**VOLT - AMPERE** 

WATT OR WIRE

WATER HEATER

TRANSFORMER

WEATHERPROOF

RIGID METAL CONDUIT

REMOTE TEST STATION

MAIN CIRCUIT BREAKER

MOTOR RATED SWITCH

NORMALLY CLOSED

MOTOR CONTROL CENTER

MOTOR CIRCUIT PROTECTION

NATIONAL ELECTRICAL CODE

NORMALLY OPEN OR NUMBER

RIGID NON-METALLIC CONDUIT

NATIONAL ELECTRICAL MANUFACTURERS ASSOCIATION

NATIONAL FIRE PROTECTION ASSOCIATION

PUSH BUTTON, PANIC BUTTON OR PULLBOX

TELECOMMUNICATIONS GROUNDING BUSBAR

THERMAL MAGNETIC CIRCUIT BREAKER

UNDERWRITERS LABORATORY

SYMBOL

**KCMIL** 

KVA

LFMC

LTG

LRA

MCB

MCC

MCP

MLO

MS

MTD

NEC

NEMA

NFPA

PNL

PWR

QTY

RTS

RTU

TGB

TMCB

XFMR

- DESIGN DRAWINGS ARE SCHEMATIC. THIS CONTRACTOR SHALL VISIT THE SITE PRIOR TO BIDDING OR AWARD OF CONTRACT TO INSPECT EXISTING FIELD CONDITIONS. THIS CONTRACT SHALL INCLUDE ALL LABOR AND MATERIALS NECESSARY FOR FIELD MODIFICATIONS DUE TO EXISTING
- THE CONTRACTOR SHALL CONTACT THE ARCHITECT, ENGINEER OR OWNER PRIOR TO BIDDING FOR INTERPRETATIONS AND CLARIFICATIONS OF THE DESIGN AND INCLUDE IN HIS BID ALL COSTS TO MEET THE DESIGN INTENT. CLARIFICATIONS MADE BY THE ARCHITECT, ENGINEER OR OWNER AFTEF BIDDING WILL BE FINAL AND SHALL BE IMPLEMENTED AT CONTRACTORS
- BIDDING CONTRACTORS SHALL HAVE A WORKING KNOWLEDGE OF LOCAL CODES AND ORDINANCES AND SHALL INCLUDE IN THEIR BIDS THE COST FOR ALL WORK INSTALLED IN STRICT ACCORDANCE WITH GOVERNING CODES, THE PLANS AND SPECIFICATIONS NOT WITHSTANDING. THE CONTRACTOR SHALL ALERT ARCHITECT, ENGINEER OR OWNER OF ANY APPARENT DISCREPANCIES BETWEEN GOVERNING CODES AND DESIGN

LIGHTING	
SYMBOL	DESCRIPTION
	CEILING MOUNTED 2'x2' / 2'x4' LUMINAIRE - RECESSED NORMAL POWER
	CEILING MOUNTED 2'x2' / 2'x4' LUMINAIRE - RECESSED EMERGENCY POWER
	CEILING MOUNTED 1'x4' LUMINAIRE RECESSED OR SURFACE MOUNTED - NORMAL POWER
	CEILING MOUNTED 1'x4' LUMINAIRE RECESSED OR SURFACE MOUNTED - EMERGENCY POWER
• •	CEILING MOUNTED 1'x4' LUMINAIRE PENDANT MOUNTED - NORMAL POWER
	CEILING MOUNTED 1'x4' LUMINAIRE PENDANT MOUNTED - EMERGENCY POWER
-	STRIP LUMINAIRE - NORMAL POWER
	STRIP LUMINAIRE - EMERGENCY POWER
	DOWNLIGHT LUMINAIRE - NORMAL POWER
	DOWNLIGHT LUMINAIRE - EMERGENCY POWER
$\bigcirc$	WALL MOUNTED LUMINAIRE - NORMAL POWER
•	WALL MOUNTED LUMINAIRE - EMERGENCY POWER
<b>♦</b> — <b>\$</b>	EMERGENCY BATTERY LIGHT UNIT
$\bigotimes$	EXIT LIGHT - SINGLE FACE WITH DIRECTIONAL ARROW
	EXIT LIGHT - DOUBLE FACE
igotimes	EXIT LIGHT - WALL MOUNTED

FIRE ALA	RM
SYMBOL	DESCRIPTION
R	FIRE ALARM RELAY
Р	FIRE ALARM MANUAL PULL STATION
	FIRE ALARM STROBE ONLY DEVICE MINIMUM 75cd RATING
	FIRE ALARM HORN / STROBE ONLY DEVICE MINIMUM 75cd RATING
	FIRE ALARM SPEAKER / STROBE ONLY DEVICE MINIMUM 75cd RATING
\(\sigma\)	FIRE ALARM SPEAKER DEVICE
	FIRE ALARM HORN DEVICE MINIMUM 75cd RATING
<b>(S)</b>	FIRE ALARM STROBE ONLY DEVICE MINIMUM 75cd RATING - CEILING MOUNTED
<b>©</b> <	FIRE ALARM HORN / STROBE ONLY DEVICE MINIMUM 75cd RATING - CEILING MOUNTED
<b>(3)</b>	FIRE ALARM SPEAKER / STROBE ONLY DEVICE MINIMUM 75cd RATING - CEILING MOUNTED
\(\sigma\)	FIRE ALARM SPEAKER DEVICE - CEILING MOUNTED
$\bigcirc \langle$	FIRE ALARM HORN DEVICE MINIMUM 75cd RATING - CEILING MOUNTED

SWITCHES							
SYMBOL	DESCRIPTION						
\$	SINGLE POWER TOGGLE SWITCH (LETTER DENOTES FIXTURE CONTROLLED)						
<b>\$</b> 3	THREE-WAY TOGGLE SWITCH						
\$4	FOUR-WAY TOGGLE SWITCH						
\$м	MOTOR SWITCH						
\$F	FAN SWITCH						
\$ _D	DIMMER SWITCH, COMPATIBLE WITH 0-10V DIMMING.						
\$т	TIMER SWITCH (60 MINUTES)						
\$LV	LOW VOLTAGE SWITCH						
\$к	KEY SWITCH						
\$wp	SWITCH - WEATHERPROOF						
\$os	WALL SWITCH OCCUPANCY SENSOR						
\$pos	DIMMER OCCUPANCY SENSOR SWITCH						
(OS)	OCCUPANCY SENSOR - CEILING MOUNTED						
(OS)	OCCUPANCY SENSOR - WALL MOUNTED						
PC	PHOTOCELL						

### **GENERAL NOTES**

- THE ELECTRICAL CONTRACT DOCUMENTS ARE SCHEMATIC IN NATURE AND INDICATE THE GENERAL CONFIGURATION OF SYSTEMS AND WORK. EXAMINE ARCHITECTURAL, INTERIOR DESIGN, CIVIL, LANDSCAPE, STRUCTURAL, MECHANICAL, PLUMBING, FIRE PROTECTION, TECHNOLOGY, AND FOOD SERVICE DRAWINGS AND SPECIFICATIONS FOR LOCATIONS AND REQUIREMENTS OF DEVICES, EQUIPMENT, LUMINARIES, AND SYSTEMS. CONTENT INDICATED ON THE SPECIFICATIONS BUT NOT THE DRAWINGS, OR CONTENT INDICATED ON THE DRAWINGS BUT NOT THE SPECIFICATIONS, SHALL BE INTERPRETED AS BEING PRESENT ON BOTH.
- PROVIDE ALL DEVICES, EQUIPMENT, ACCESSORIES, MATERIALS, AND LABOR REQUIRED FOR A COMPLETE, FUNCTIONAL, AND CODE-COMPLIANT ELECTRICAL SYSTEM. ALL WORK SHALL BE PERFORMED IN ACCORDANCE WITH THE CODES AND STANDARDS INDICATED ON THIS SHEET.
- 3. ALL DEVICES, EQUIPMENT, ACCESSORIES, AND MATERIALS SHALL BE NEW, AND, WHERE APPLICABLE, SHALL BE LISTED BY U.L. OR ANOTHER APPROVED ELECTRICAL TESTING AGENCY.
- COORDINATE LOCATIONS AND REQUIREMENTS OF EQUIPMENT REQUIRING ELECTRICAL SERVICE (I.E. PRINTERS, APPLIANCES, MOTORIZED PROJECTION SCREENS, MOTORIZED SHADES, ELEVATORS, TOOLS, ETC.) WITH APPROVED SHOP DRAWINGS, SPECIFICATION SHEETS, MANUFACTURER'S INSTALLATION LITERATURE. AND EQUIPMENT NAMEPLATE DATA. PRIOR TO ROUGH-IN AND INSTALLATION. PROVIDE ELECTRICAL CONNECTIONS (AS REQUIRED).
- BID SHALL INCLUDE COSTS ASSOCIATED WITH BACKFILLING, CORE DRILLING, DIRECTIONAL BORING, EXCAVATING, AND REPAIRING OF SURFACES.
- 6. PAY ALL FEES, TAXES, AND OTHER COSTS ASSOCIATED WITH THE WORK ENCOMPASSED BY THE ELECTRICAL CONTRACT DOCUMENTS. PROVIDE ALL REQUIRED NOTICES AND OBTAIN ALL REQUIRED PERMITS.
- PROVIDE COOPERATION WITH OTHER TRADES AND PROVIDE ANY INFORMATION REQUIRED TO FACILITATE THE COMPLETION OF THEIR WORK. COORDINATE DEVICE AND EQUIPMENT LOCATIONS AND MOUNTING HEIGHTS WITH OTHER TRADES PRIOR TO ROUGH-IN AND INSTALLATION. COORDINATE CONDUIT ROUTING WITH OTHER TRADES PRIOR TO ROUGH-IN AND INSTALLATION.
- AN ALLOWANCE OF \$60,000 SHALL BE ADDED FOR ANY MISCELLANEOUS MODIFICATIONS THAT WILL BE REQUIRED IN THE FIELD. ALLOWANCE SHALL BE INCLUDED IN BID WITH NO EXCEPTIONS.
- PROVIDE TEMPORARY ELECTRICAL SERVICE(S) FOR USE BY OTHER TRADES DURING PROJECT CONSTRUCTION. UPON COMPLETION OF THE PROJECT, THE TEMPORARY ELECTRICAL SERVICE(S) SHALL BE REMOVED.
- 10. WITHIN THIRTY (30) DAYS OF SYSTEM ACCEPTANCE, PROVIDE RECORD DRAWINGS TO THE OWNER. DRAWINGS SHALL BE COMPRISED OF SINGLE-LINE DIAGRAMS AND FLOOR PLANS INDICATING THE LOCATIONS AND AREAS SERVED FOR ALL DISTRIBUTION.
- 11. WITHIN THIRTY (30) DAYS OF SYSTEM ACCEPTANCE, PROVIDE AN OPERATING MANUAL AND MAINTENANCE MANUAL TO THE OWNER. THE MANUALS SHALL INCLUDE THE FOLLOWING INFORMATION: SUBMITTAL DATA WITH EQUIPMENT RATINGS AND SELECTED OPTIONS, OPERATION AND MAINTENANCE MANUALS FOR EQUIPMENT REQUIRING MAINTENANCE, NAMES AND ADDRESSES OF A MINIMUM OF ONE (1) QUALIFIED SERVICE AGENCY.
- 12. COORDINATE LOCATIONS AND MOUNTING HEIGHTS OF ALL WALL-MOUNTED ELECTRICAL DEVICES AND EQUIPMENT WITH THE ARCHITECTURAL DRAWINGS. GENERAL CONTRACTOR, CASEWORK/MILLWORK, AND OTHER TRADES PRIOR TO ROUGH-IN AND INSTALLATION.
- 13. EQUIPMENT LOCATIONS SHALL SATISFY THE WORKING CLEARANCE REQUIREMENTS AND DEDICATED SPACE REQUIREMENTS OF NEC ARTICLE 110. PROVIDE SHOP DRAWINGS, DEMONSTRATING COMPLIANCE AND INTER-DISCIPLINARY COORDINATION, FOR ENGINEERING REVIEW.
- REFER TO ARCHITECTURAL REFLECTED CEILING PLANS, SECTIONS, AND ELEVATIONS FOR LOCATIONS AND/OR MOUNTING HEIGHTS OF LUMINARIES LOCATED AT CEILINGS AND/OR WALLS. VERIFY THAT CEILING-MOUNTED LUMINARIES ARE SUITABLE FOR THE FINISHED CEILING SYSTEM INDICATED AND PROVIDE ACCORDINGLY. COORDINATE LOCATIONS AND MOUNTING HEIGHTS OF WALL-MOUNTED LUMINARIES WITH CASEWORK, FURNITURE, AND ARCHITECTURAL ELEMENTS. WHERE ARCHITECTURAL REFLECTED CEILING PLANS INDICATE FIRE-RATED CEILING SYSTEMS, PROVIDE UL-LISTED LUMINAIRE ENCLOSURES (AS REQUIRED).
- 15. TYPE BX(AC) OR MC CABLE IS PROHIBITED FOR USE ON THIS PROJECT. FLEX CONDUIT IS ONLY ALLOW IN 3' MAXIMUM LENGTH FROM JUNCTION BOX TO LIGHT FIXURES.

NATIONAL ELECTRICAL CODE (2021)

NATIONAL FIRE ALARM CODE (2013)

AND VENTILATING SYSTEMS (2015)

SYSTEMS (2012)

SYSTEMS (2015)

GUIDELINES

LIFE SAFETY CODE (2015)

PROTECTION SYSTEMS (2014)

STANDARD FOR THE PROTECTION OF ELECTRONIC

COMPUTER / DATA PROCESSING EQUIPMENT (2013)

STANDARD FOR THE INSTALLATION OF WARM AIR

HEATING AND AIR CONDITIONING SYSTEMS (2015)

RECOMMENDED PRACTICE FOR SMOKE CONTROL

STANDARD FOR EMERGENCY AND STAND-BY POWER

STANDARD FOR THE INSTALLATION OF LIGHTNING

INTERNATIONAL BUILDING CODE (6th EDITION)

INTERNATIONAL ENERGY CONSERVATION CODE

LOCAL JURISDICATION CODES AND / OR OWNER DESIGN

STANDARD FOR THE INSTALLATION OF AIR CONDITIONING

CODES AND STANDARDS

NFPA 72

NFPA 90A

NFPA 90B

NFPA 92

NFPA 101

NFPA 110

NFPA 780

2017 EDT.

- 16. PROVIDE A COMPLETE GROUNDING SYSTEM IN ACCORDANCE WITH APPLICABLE SECTIONS OF THE NEC AND SPECIFICATIONS. BOND SERVICE ENTRANCE ELECTRICAL EQUIPMENT TO BUILDING STEEL, GROUND RODS, METAL WATER MAINS, LIGHTNING PROTECTION SYSTEM GROUNDING ELECTRODES (WHERE PRESENT), AND TELECOMMUNICATIONS SYSTEM GROUNDING ELECTRODES (AS REQUIRED). EQUIPMENT GROUNDING SHALL BE OF THE WIRE TYPE.
- 17. MINIMUM CONDUIT SIZE SHALL BE 3/4".
- 18. MINIMUM CONDUCTOR SIZE SHALL BE #12 AWG. ALL FEEDER AND BRANCH CIRCUIT CONDUCTORS SHALL BE INSTALLED WITHIN CONDUIT, UNLESS OTHERWISE INDICATED. ALL CONDUCTORS SHALL BE COPPER, UNLESS OTHERWISE INDICATED.
- 19. PROVIDE A DEDICATED NEUTRAL CONDUCTOR FOR EACH CIRCUIT. MULTI-WIRE BRANCH CIRCUITS SHALL BE PROHIBITED.
- 20. CONNECTIONS TO TRANSFORMERS AND MECHANICAL EQUIPMENT SHALL BE MADE WITH FMC OR LFMC, UNLESS OTHERWISE INDICATED.
- 21. WHERE PRACTICABLE, CONDUITS SHALL BE CONCEALED BELOW SLABS, WITHIN WALLS, AND ABOVE FINISHED CEILING SYSTEMS. WHERE CONDUITS ARE EMBEDDED WITHIN CONCRETE SLABS, COORDINATE CONDUIT SIZE LIMITATIONS AND SPACING REQUIREMENTS WITH THE STRUCTURAL DRAWINGS/ENGINEER PRIOR TO INSTALLATION.
- 22. SEAL ALL CONDUIT PENETRATIONS AT FIRE-RATED PARTITIONS. REFER TO DETAILS FOR FURTHER INFORMATION.
- 23. COORDINATE ALL CONDUIT PENETRATIONS WITH ARCHITECTURAL DRAWINGS, STRUCTURAL DRAWINGS, FIELD CONDITIONS, AND OTHER TRADES. PROVIDE SEALING FITTINGS TO PROHIBIT CONDENSATION AND/OR THE PASSAGE OF GASES OR VAPORS (AS REQUIRED).
- 24. INCREASE FEEDER AND BRANCH CIRCUIT CONDUCTOR SIZES AS REQUIRED IN ORDER TO MAINTAIN A MAXIMUM, CUMULATIVE VOLTAGE DROP OF 5% AT THE END LOAD. MAXIMUM VOLTAGE DROP SHALL BE DISTRIBUTED AS FOLLOWS: 3% FOR FEEDERS, 2% FOR BRANCH CIRCUITS. WHERE THE VOLTAGE DROP REQUIREMENTS OF THE LOCAL ENERGY CODE ARE MORE STRINGENT. THE REQUIREMENTS OF THE LOCAL ENERGY CODE SHALL TAKE PRECEDENCE. WHERE PHASE AND NEUTRAL CONDUCTOR SIZES ARE INCREASED FOR VOLTAGE DROP, THE EQUIPMENT GROUNDING CONDUCTOR SHALL BE INCREASED PROPORTIONATELY.
- 25. PROVIDE ALL REQUIRED DISCONNECT SWITCHES, STARTERS, AND COMBINATION STARTER/DISCONNECT SWITCHES. MAKE CONNECTIONS TO ALL ELECTRICALLY-DRIVEN DEVICES AND EQUIPMENT PROVIDED BY THE MECHANICAL, PLUMBING, AND FIRE PROTECTION CONTRACTORS. EXAMINE EQUIPMENT NAMEPLATE RATINGS PRIOR TO ROUGH-IN AND INSTALLATION. PROVIDE OVERCURRENT PROTECTION IN ACCORDANCE WITH EQUIPMENT NAMEPLATE RATINGS. PROVIDE ALL POWER SUPPLIES, CONTROL TRANSFORMERS, RELAYS, AND OTHER ACCESSORIES REQUIRED TO FACILITATE THE PROPER OPERATION OF MECHANICAL EQUIPMENT AS DESCRIBED WITHIN THE MECHANICAL ENGINEER'S SEQUENCE OF OPERATIONS.
- 26. ALL INTERIOR ELECTRICAL EQUIPMENT SHALL BE OF NEMA 1 CONSTRUCTION, UNLESS OTHERWISE INDICATED. ALL EXTERIOR ELECTRICAL EQUIPMENT SHALL BE OF NEMA 4X CONSTRUCTION, UNLESS OTHERWISE INDICATED. EQUIPMENT RATINGS SHALL CORRESPOND TO THEIR INSTALLED ENVIRONMENTS.
- 27. ALL NEW AND/OR EXISTING PANELBOARDS AND SWITCHBOARDS WITHIN THE SCOPE OF THIS PROJECT SHALL BE PROVIDED WITH NEW, TYPEWRITTEN DIRECTORIES. CIRCUIT DESCRIPTIONS SHALL CONTAIN ROOM NAMES AND ROOM NUMBERS BASED UPON INSTALLED ROOM SIGNAGE.
- 28. PROVIDE PHENOLIC, ENGRAVED IDENTIFICATION PLACARDS AT ALL SWITCHBOARDS, SWITCHGEAR, PANELBOARDS, TRANSFORMERS, DISCONNECT SWITCHES, ENCLOSED CIRCUIT BREAKERS, CABINETS, AND AUTOMATIC TRANSFER SWITCHES. REFER TO DETAILS FOR FURTHER INFORMATION.
- 29. PROVIDE PHENOLIC, ENGRAVED IDENTIFICATION PLACARDS AT EACH CIRCUIT BREAKER WITHIN A DISTRIBUTION PANEL, SWITCHBOARD, OR SWITCHGEAR.
- 30. PROVIDE TYPEWRITTEN OR ENGRAVED PANEL AND CIRCUIT IDENTIFICATION AT DEVICE COVER PLATES.
- 31. PROVIDE HANDWRITTEN PANEL AND CIRCUIT IDENTIFICATION ON THE EXTERIORS OF ALL JUNCTION BOXES, PULL BOXES, AND WIREWAYS.
- 32. CURRENT DRAWINGS ARE BASED ON SPECIFICATIONS AND REQUIREMENTS BASED ON TYCO SECURITY DOCUMENTS (ISSUED IN MAY 2019). IF ANY OTHER MANUFACTURER OR UPDATED SYSTEM IS TO BE PROVIDED THE INFORMATION ON THE CURRENT DOCUMENTS WILL NOT BE ACCCURATE. THE ENGINEER RESERVES THE RIGHT TO REVIEW ANY REVISED SPECIFCIATIONS AND ELECTRICAL REQUIREMENTS PRIOR TO BID TO ENSURE THE PROVISION NOTED ON THE DOCUMENTS ARE CORRECT OR IF THEY WILL NEED TO BE REVISED.

### COMMISSIONING

PRIOR TO FINAL INSPECTION, THE CONTRACTOR SHALL SUBMIT EVIDENCE TO THE REGISTERED DESIGN PROFESSIONAL (ELECTRICAL ENGINEER-OF-RECORD) OR REGISTERED DESIGN PROFESSIONAL'S REPRESENTATIVE THAT THE LIGHTING SYSTEMS HAVE BEEN TESTED TO ENSURE THAT THEY ARE SATISFY THE INTENT OF THESE CONTRACT DOCUMENTS AND THE MANUFACTURERS' WRITTEN INSTRUCTIONS.

SHEET	INDEX
NUMBER	NAME
E000	ELECTRICAL LEGEND
E201	DEMOLITION PLAN - TERMINAL - ELECTRICAL
E301	LEVEL 02 - TICKETING - FLOOR PLAN - TERMINAL - LIGHTING
E401	LEVEL 01 - BAGGAGE CLAIM - FLOOR PLAN - TERMINAL - POWER
E402	LEVEL 02 - TICKETING - FLOOR PLAN - TERMINAL - POWER
E601	RISER DIAGRAMS - ELECTRICAL
E901	ELECTRICAL DETAILS
E902	ELECTRICAL DETAILS

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PROJECT NAME

**HOU-TERMINAL** - SECURITY **EXIT LANE** 

PROJECT LOCATION **WILLIAM HOBBY** 

7800 AIRPORT BLVD. HOUSTON, TX 77061

PROJECT NUMBER 1004345

SHEET 111LE **ELECTRICAL** 

LEGEND

SHEET NUMBER

KEYNOTES ?

CONTRACTOR SHALL TAG AND TRACE EXISTING CIRCUIT SERVING DOWNLIGHTS PRIOR TO REMOVAL. CIRCUIT SHALL BE UTILIZED FOR THE PROPOSED 2X2 LIGHTS ON THE NEW WORK PLANS.

- REMOVE AND PATCH EXISTING DOWNLIGHTS THAT ARE CURRENTLY INSTALLED IN THE EXISTING SOFFIT. TYPICAL FOR ALL DOWNLIGHTS INSTALLED OVER PROPOSED ARE OF EXIT LANE STRUCTURE HOUSING.
- REFER TO SITE DETAIL(EXISTING EXIT SOFFIT DETAL) FOR ALL ITEMS SHOWN FOR REMOVAL OR RELOCATION.
- CONTRACTOR SHALL REMOVE ALL EXISTING DEVICES SHOWN ON THE PROPOSED LAYOUT UNLESS OTHERWISE NOTED. ALL ASSOCIATED WIRING/CABLING SHALL BE REMOVED BACK TO THE SOURCE.

### **DEMOLITION NOTES**

1. IT SHALL BE THE RESPONSIBILITY OF THE CONTRACTOR TO REMOVE AND LEGALLY V/DI\$POSE OF DEMOLISHED MATERIALS.

2. THE OWNER RESERVES THE RIGHT TO INSPECT THE MATERIAL SCHEDULED FOR REMOVAL AND SALVAGE ANY ITEMS DEEMED USEABLE AS SPARE PARTS.

- 3. EXISTING CONDITIONS INDICATED ON THIS DRAWING ARE TAKEN FROM EXISTING DOCUMENTS AND FIELD INVESTIGATION. IT IS RECOMMENDED FOR CONTRACTOR TO VISIT SITE AND VERIFY EXISTING CONDITIONS PRIOR TO BID.
- 4. THE CONTRACTOR SHALL INSURE THAT CONDUITS REMAINING WITHIN THE PROJECT AREA ARE SUPPORTED IN ACCORDANCE WITH THE SPECIFICATIONS. CONDUITS THAT ARE ATTACHED TO ITEMS BEING REMOVED DURING DEMOLITION SHALL BE SUPPORTED FROM THE STRUCTURE PRIOR TO REMOVING ITEM.
- 5. EXISTING PANEL DIRECTORIES SHALL BE UPDATED TO REFLECT CURRENT CONDITIONS.
- 6. CONTRACTOR SHALL PATCH, PAINT AND MATCH FINISH WITH EXISTING SURFACES TO REMAIN WHERE ELECTRICAL DEVICES ARE BEING REMOVED.
- 7. CONTRACTOR SHALL REVIEW NEW FLOOR PLANS FOR DEVICES TO REMAIN PRIOR TO DEMOLITION. EXISTING DEVICES TO REMAIN ARE SHOWN LIGHT IN COLOR.
- 8. CONTRACTOR SHALL REVIEW NEW FLOOR PLANS FOR CIRCUITS TO REMAIN AND BE REUSED FOR NEW DEVICES PRIOR TO DEMOLITION.
- 9. ALL CONDUCTORS AND THAT ARE NOT BEING USED, SHALL BE DISCONNECTED BACK TO THE POWER SOURCE. REMOVE ALL CONDUIT AND CONDUCTORS TO THE
- 10. CONTRACTOR SHALL REMOVE AND DISCONNECT ALL EXISTING ITEMS SHOWN ON PLANS. PATCH, PAINT AND REMOVE CONDUCTORS BACK TO SOURCE(UNLESS NOTED OTHERWISE) FOR ALL EXISTING DEVICES SHOWN TO BE REMOVED. FIELD VERIFY PROPOSED WORK AREA FOR ANY ADDTIONAL DEVICES (SPEAKER, SENSORS, ETC.) THAT ARE CURRENTLY INSTALLED THAT WILL NEED TO BE REMOVED OR RELOCATED THAT WILL BE IN CONFLICT WITH THE EXIT LANE STRUCTRE.

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ARCHITECT



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PROJECT NAME

HOU-TERMINAL - SECURITY **EXIT LANE** 

PROJECT LOCATION

**WILLIAM HOBBY** 7800 AIRPORT BLVD. HOUSTON, TX 77061

PROJECT NUMBER

1004345

DEMOLITION PLAN -TERMINAL -ELECTRICAL

SHEET NUMBER

**VOLT AIR** 

5353 West Alabama Suite 205 Houston, TX. 77056 Phone:832.371.6181 Texas Firm: F-14583 ProjectNo.:02.18027

1 CONTACTOR SHALL INSTALL AND CONNECT NEW 2X2 LIGHTS TO EXISTING LIGHTING CIRCUIT(2HB1-19) SERVING THE EXISTING DOWNLIGHTS THAT WERE REMOVED DURING CONSTRUCTION.

### LIGHTING NOTES

- A. CONTRACTOR SHALL REFER TO FIXTURES SCHEDULE AND SPECIFICATIONS FOR VEXACT LIGHTING REQUIREMENTS.
- B. CONTRACTOR IS RESPONSIBLE FOR INSTALLING SWITCH CONDUCTORS WHERE MULTIPLE SWITCHES ARE SHOWN. PROVIDE NEUTRALS FOR ALL SWITCHES SHOWN.
- C. COORDINATE THE INSTALLATION OF ALL LIGHT FIXTURES WITH HVAC AND EQUIPMENT CURRENTLY SHOWN TO BE INSTALLED IN AND ABOVE CEILING.
- D. CONTRACTOR SHALL PROPERLY INSTALL FIXURES PER MANUFACTURERS RECOMMENDATION AND CONSTRUCTION DRAWINGS.
- E. PROVIDE ALL MOUNTING ACCESSORIES AND EQUIPMENT REQURIE FOR PROPER
- F. APPROVED LIGHTING MANUFACTURER SHALL PROVIDE PHOTOMETRIC LIGHTING LAYOUT PRIOR TO ORDERING ANY MATERIALS.
- G. PULL UNSWITCHED CONDUCTOR(HOT) TO ALL EXIT AND EMERGENCY LIGHTS.

IMAGE	TYPE	DESCRIPTION	MANUFACTURER	LAMP TYPE
	A	LED 2x2 FLAT PANEL TROFFER	METALUX FP 22 PHILIPS	LED 4000 Lm
	AE	LED 2x2 FLAT PANEL TROFFER. PROVIDE WITH 90 MINUTE BATTERY PACK	METALUX FP 22 PHILIPS	LED 4000 Lm
EXIT	Х	LED EXIT SIGN WITH RED LETTERING AND ALUMINUM HOUSING. PROVIDE WITH 90 MINUTE BATTERY PACK	METALUX SURE LITE	LED



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HOU-TERMINAL - SECURITY **EXIT LANE** 

PROJECT LOCATION

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PROJECT NUMBER


1004345

LEVEL 02 -TICKETING - FLOOR PLAN - TERMINAL -LIGHTING

SHEET NUMBER

VOLTHER CONSULTING ENGINEERS

5353 West Alabama Suite 205 Houston, 1X. 77056 Phone:832.371.6181 Texas Firm: F-14583 ProjectNo.:02.18027

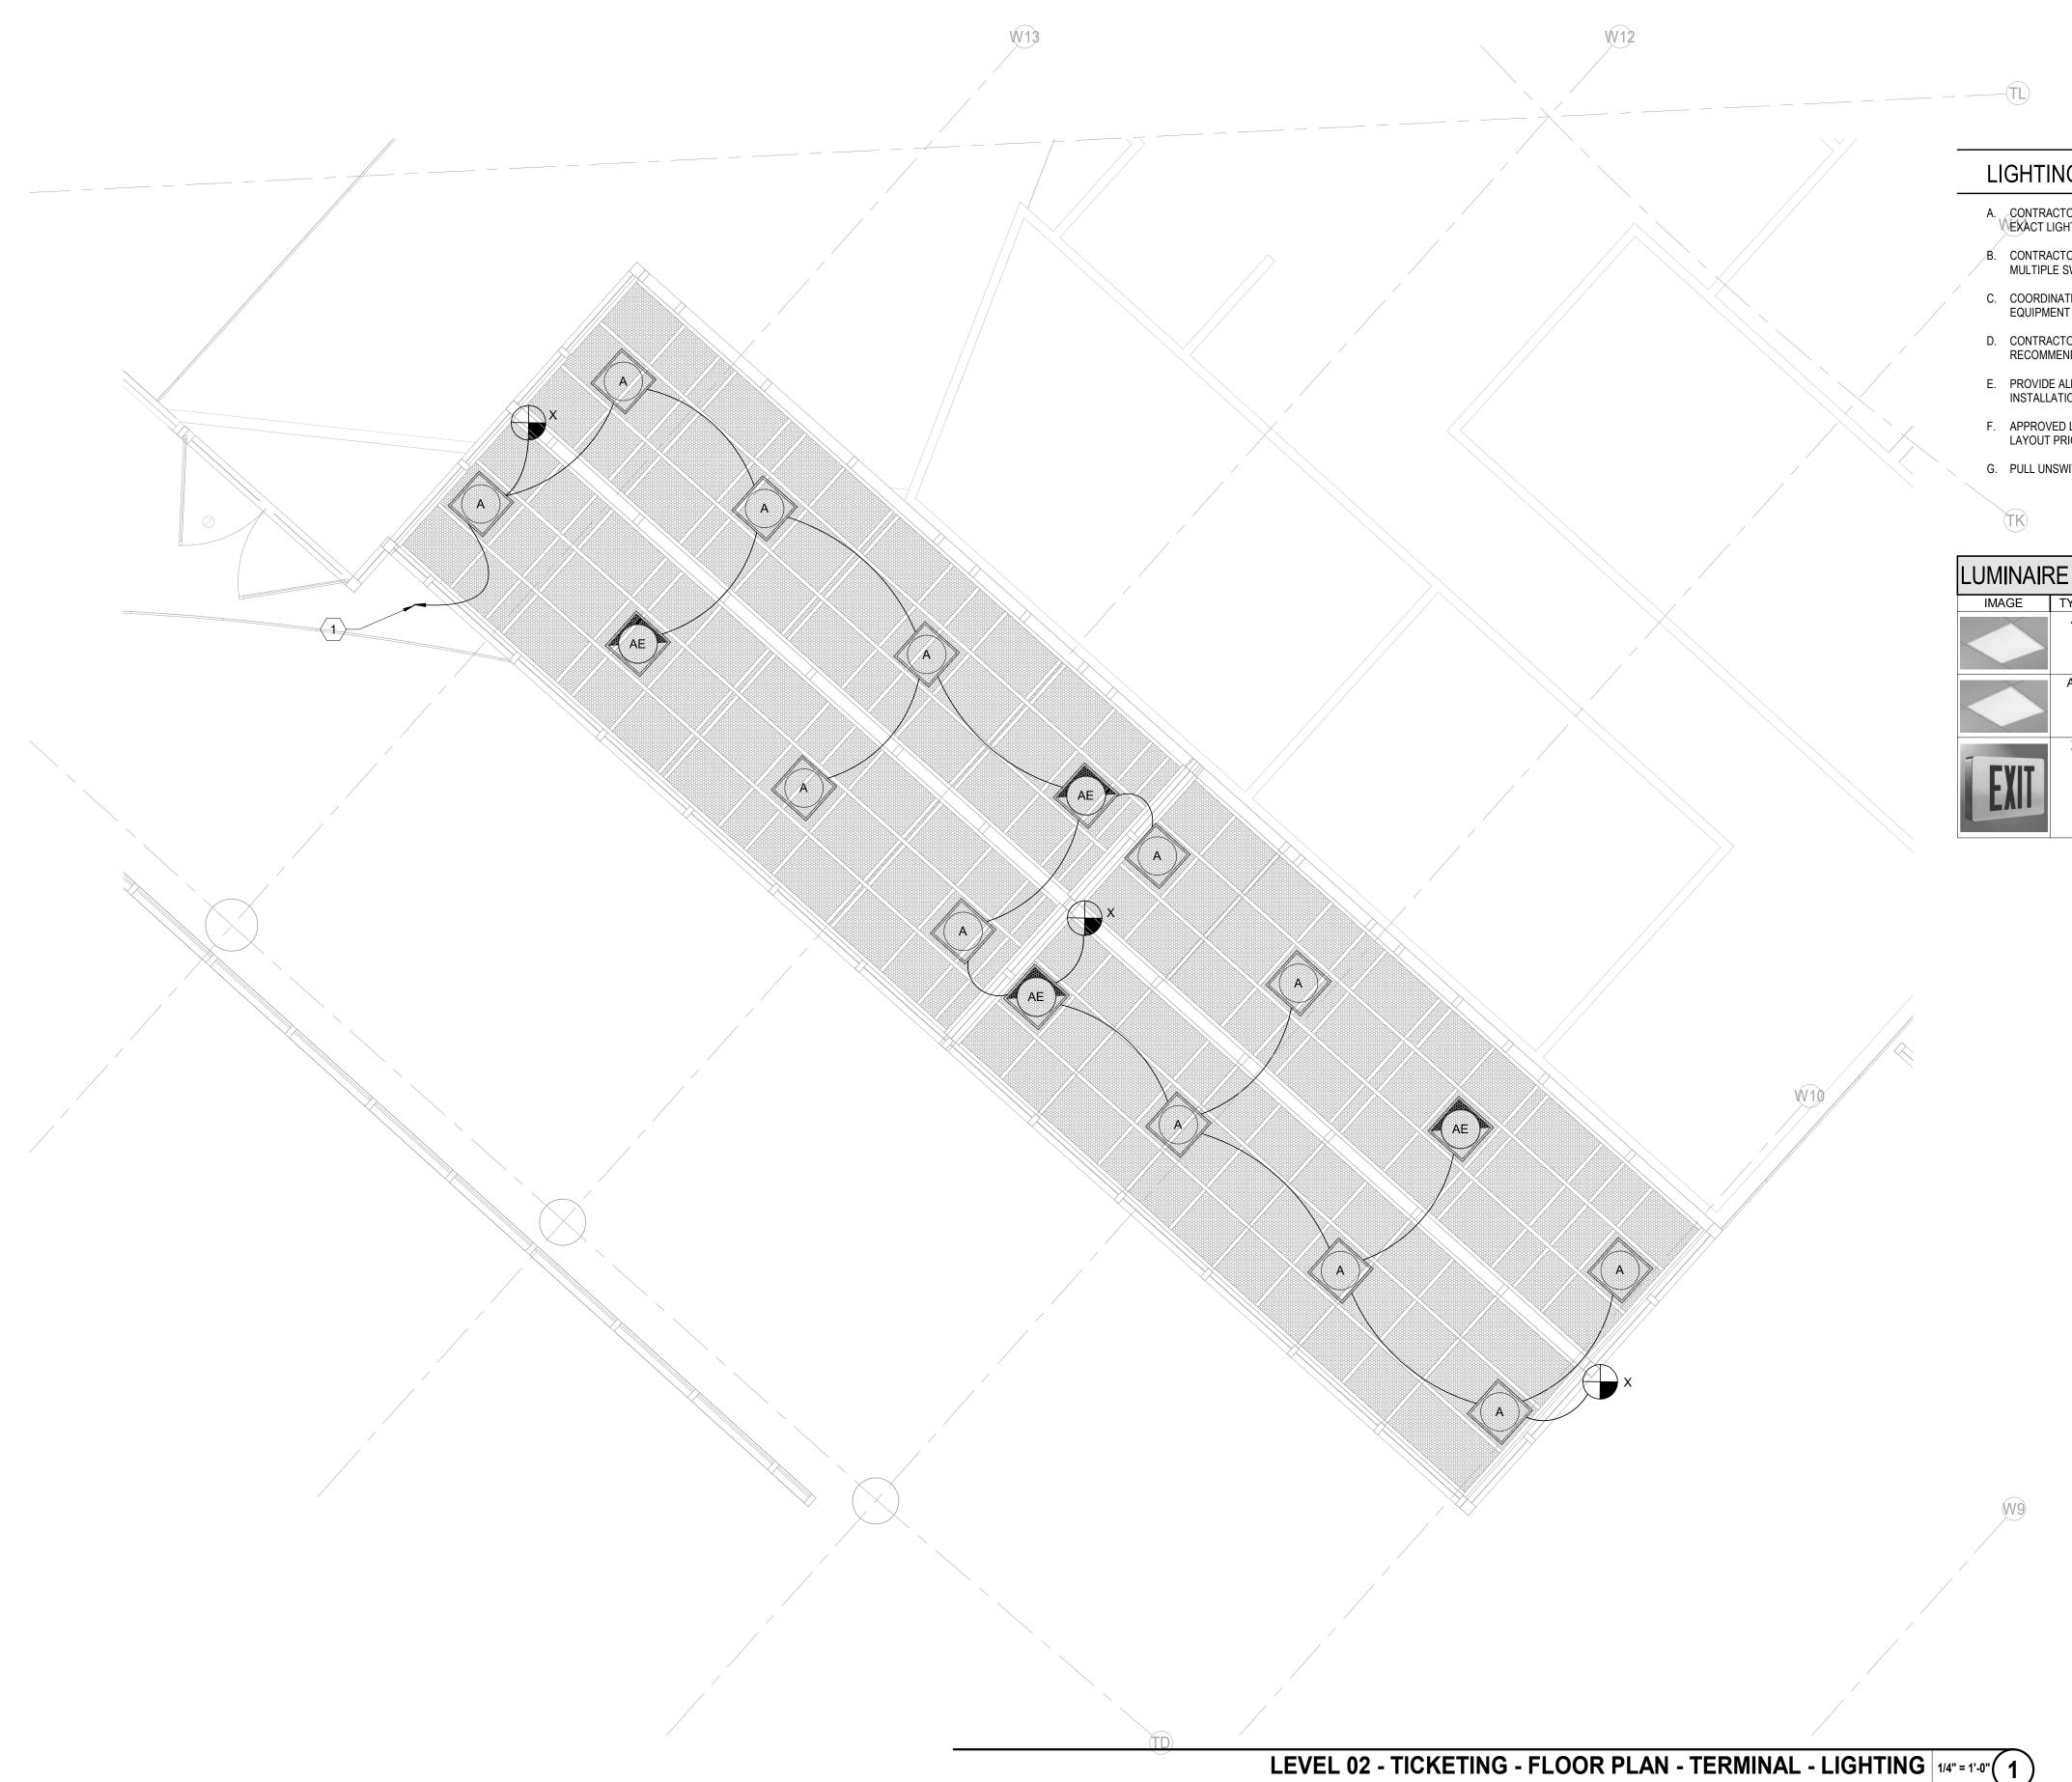



KEYNOTES ?

1 UTILIZE THREE(3) EXISTING SPARE BREAKERS IN EXISTING PANEL. ROUTE CONDUIT AND CONDUCTORS TO PROPOSED LOADS ON SECOND LEVELS. UPDATE PANEL SCHEDULE AND LABEL CONDUITS ACCORDING TO SPECIFICATIONS.

2 COORDINATE EXACT PLUG TYPE WITH EQUIPMENT SUBMITTAL TO CONFIRM PLUG REQUIRED PRIOR TO ROUGH-IN.

### **POWER NOTES**

- A. COORDINATE WITH ARCHITECTURAL ELEVATIONS AND TELECOMM DRAWINGS PRIOR TO ROUGH-IN OF ANY OUTLET DEVICES.
- B. PROVIDE ADHESIVE LABELS FOR ALL RECEPTACLE OUTLETS SHOWN ON PLANS.
- C. REFER TO TELECOMM (T-SERIES) DRAWINGS FOR EXACT LOCATIONS OF ALL BACKBONE/COMMUNICATION CONDUITS AND GROUNDBARS.
- D. UPS AND BATTERY CABINET SHALL BE OWNER FURNISHED AND INSTALLED BY CONTRACTOR. COORDINATE WITH PROJECT MANAGER FOR EXACT REQUIREMENTS AND INSTALLATION DETAILS.
- E. COORDINATE EXACT RECEPTACLE TYPE WITH OWNER PRIOR TO COMMENCEMENT OF WORK. IF L6-20P ARE REQUESTED FROM OWNER, CONTRACTOR SHALL PROVIDE PLUG ADAPTER TO CONVERT TWIST-LOCK DEVICE TO A STRAIGHT PLUG. BASIS OF DESIGN REFLECTS THE PROVISION OF L5-30P DUPLEX RECEPTACLES.
- F. PROVIDE JUNCTION BOX AND OR HOUSINGS FOR ALL SURFACE MOUNTED RECEPTACLES.
- G. ALL WALL PENETRATIONS SHALL BE SEALED WITH UL LISTED FIRE RATED CAULKING MATERIAL.
- H. ANY FIRE ALARM DEVICES SHOWN ON ELECTRICAL DRAWINGS ARE SHOWN FOR BIDDING PURPOSES ONLY AND NOT FOR CONSTRUCTION OR INSTALLATION. THE FIRE ALARM CONTRACTOR SHALL MODIFY THE FIRE ALARM SYSTEM TO PROVIDE FULL COVERAGE OF THE PROJECT AREA IN ACCORDANCE WITH NFPA-72 AND ALL CITY, STATE, NATIONAL CODES AND STANDARDS, AND THE AUTHORITY HAVING LOCAL JURISDICTION. THE FIRE ALARM CONTRACTOR SHALL EXTEND THE EXISTING FIRE ALARM SYSTEM TO THE NEW SPACE. NEW DEVICES SHALL MATCH EXISTING FIRE ALARM SYSTEM DESIGN. TEXAS STATE FIRE MARSHALL FIRE ALARM PLANNING SUPERINTENDENT AND/OR NICET III CONTRACTOR MUST SUBMIT SHOP DRAWINGS FOR THE INSTALLATION OF THE FIRE ALARM SYSTEM TO THE AHJ FOR APPROVAL, INSTALLATION AND PROVIDE AN APPROVED COPY TO THE OWNER FOR RECORDS.

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PROJECT NAME

HOU-TERMINAL - SECURITY **EXIT LANE** 

PROJECT LOCATION

**WILLIAM HOBBY** 7800 AIRPORT BLVD. HOUSTON, TX 77061

PROJECT NUMBER

1004345

LEVEL 01 -BAGGAGE CLAIM -FLOOR PLAN -TERMINAL - POWER

SHEET NUMBER

**VOLT AIR** 

5353 West Alabama Suite 205 Houston, TX. 77056 Phone:832.371.6181 Texas Firm: F-14583 ProjectNo.:02.18027

E401

LEVEL 01 - BAGGAGE CLAIM - FLOOR PLAN - TERMINAL - POWER 1/8" = 1'-0" 1

KEYNOTES ?

1 PROVIDE POWER AND DATA FOR TERMINAL LANE WORKSTATION. CONTRACTOR

TO FIELD VERIFY EXACT LOCATION OF WORKSTATION WITH OWNER PRIOR TO COMMENCEMENT OF WORK.

PROVIDE 120V POWER FOR DOOR MOTOR AND CONTROLS. VERIFY WITH MANUFACTURES DOCUMENTATION FOR PROPER INSTALLATION AND ROUTING OF CONCEALED CONDUIT. ADDITIONAL CIRCUIT MAY BE REQUIRED PER DOOR MANUFACTURER. FINAL VERIFICATION WILL OCCUR DURING SUBMITTAL PROCESS. ROUTE #10'S IN 1" CONDUIT FROM PANEL TO CLOSEST JUNCTION BOX LOCATION AT THE EXIT LANE HOUSING.

CONNECT ALL NEW FIRE ALARM DEVICES TO NEAREST FIRE ALARM JUNCTION BOX TO ENSURE CONNECTION TO F.A.C.P LOCATED ON THE FIRST LEVEL. NEAR THE SOUTHWEST ADMIN OFFICE.

4 PROVIDE ADDITIONAL JUNCTION BOXES WHERE REQUIRED FOR MOTOR CONNECTIONS. UTLIZE ADDITIONAL SPARE BRAKERS FOR POWER CONNECTIONS. PROVIDE CONDUIT AND FEEDERS ROUTED TO EXISTING PANEL

PRIOR TO ROUGH-IN OF ANY OUTLET DEVICES.

B. PROVIDE ADHESIVE LABELS FOR ALL RECEPTACLE OUTLETS SHOWN ON PLANS.

C. REFER TO TELECOMM (T-SERIES) DRAWINGS FOR EXACT LOCATIONS OF ALL

D. UPS AND BATTERY CABINET SHALL BE OWNER FURNISHED AND INSTALLED BY CONTRACTOR. COORDINATE WITH PROJECT MANAGER FOR EXACT REQUIREMENTS

E. COORDINATE EXACT RECEPTACLE TYPE WITH OWNER PRIOR TO COMMENCEMENT OF WORK. IF L6-20P ARE REQUESTED FROM OWNER, CONTRACTOR SHALL PROVIDE PLUG ADAPTER TO CONVERT TWIST-LOCK DEVICE TO A STRAIGHT PLUG. BASIS OF

F. PROVIDE JUNCTION BOX AND OR HOUSINGS FOR ALL SURFACE MOUNTED

G. ALL WALL PENETRATIONS SHALL BE SEALED WITH UL LISTED FIRE RATED CAULKING

H. ANY FIRE ALARM DEVICES SHOWN ON ELECTRICAL DRAWINGS ARE SHOWN FOR BIDDING PURPOSES ONLY AND NOT FOR CONSTRUCTION OR INSTALLATION. THE FIRE ALARM CONTRACTOR SHALL MODIFY THE FIRE ALARM SYSTEM TO PROVIDE FULL COVERAGE OF THE PROJECT AREA IN ACCORDANCE WITH NFPA-72 AND ALL CITY, STATE, NATIONAL CODES AND STANDARDS, AND THE AUTHORITY HAVING LOCAL JURISDICTION. THE FIRE ALARM CONTRACTOR SHALL EXTEND THE EXISTING FIRE ALARM SYSTEM TO THE NEW SPACE. NEW DEVICES SHALL MATCH EXISTING FIRE ALARM SYSTEM DESIGN. TEXAS STATE FIRE MARSHALL FIRE ALARM PLANNING SUPERINTENDENT AND/OR NICET III CONTRACTOR MUST SUBMIT SHOP DRAWINGS FOR THE INSTALLATION OF THE FIRE ALARM SYSTEM TO THE AHJ FOR APPROVAL, INSTALLATION AND PROVIDE AN APPROVED COPY TO THE OWNER FOR RECORDS.

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HOU-TERMINAL - SECURITY **EXIT LANE** 

PROJECT LOCATION

**WILLIAM HOBBY** 7800 AIRPORT BLVD. HOUSTON, TX 77061

PROJECT NUMBER

1004345

LEVEL 02 -TICKETING - FLOOR PLAN - TERMINAL -POWER

SHEET NUMBER

**VOLT AIR** 

5353 West Alabama Suite 205 Houston, TX. 77056 Phone:832.371.6181 Texas Firm: F-14583 ProjectNo.:02.18027

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	DATESTAMP;	

**Branch Panel: EX. 2HLB** Location: A.I.C. Rating: Volts: 480/277 Wye Supply From: Mains Type: MCB Phases: 3 Mounting: Surface Wires: 4 Mains Rating: 100 A MCB Rating: 100 A Enclosure: Type 1 ALL WIRE SIZES SHALL BE 12 AWG, UNLESS OTHERWISE NOTED. Wire Trip Pole Circuit Description Circuit Description (A) Size 1 1 Ex. Lighting 750 560 1 3 Ex. Lighting Ex. Lighting 1 5 Ex. Lighting Ex. Lighting 2 7 Lighting 20 1 1280 **Total Load** 2606.8 VA 1310 VA 1450 VA Total Amps 9 A 5 A 5 A Legend: Load Classification **Demand Factor Estimated Demand Panel Totals** Connected Load 1280 VA 125.00% 1600 VA Total Conn. Load: 5351 VA 4120 VA 100.00% 4120 VA Total Est. Demand: 5662 VA Total Conn.: 6 A Total Est. Demand: 7 A . EXISTING BREAKER TO REMAIN. . INTERCEPT EXISTING CIRCUIT TO SERVE NEW LIGHT FIXTURES.

Note		Location: Supply From: Mounting: Surfa Enclosure: Type	e 1	OTHE	RWIS	E NOTE		Volts: Phases: Wires:	3	08 Wye				Maiı Mains	Rating: ns Type: MCB s Rating: 100 A s Rating: 100 A			
Note	Ckt	Circuit Description	Wire Size	Trip (A)	Pole		A		В	C	;	Pole	Trip (A)	Wire Size	Circuit [	Description	Ckt	No
1	1	Comm. Cab		20	1	780	1200					1	20		Comm. Cab.		2	1
1	3	Comm. Cab.		20	1			300	360			1	20	10	Receptacle (Su	rveilience Desk)	4	2
	5	Spare		20	1					400	540	1	20		ı (		6	2
1	7	Receptacles		20	1	200	1080					1	20	10	· · · · · ·	binet)	8	2
1	9	Spare		20	1			60	200			2	30		Comm. Cab.		10	1
1	11	Comm. Cab.		20	1					0	200						12	
1		Comm. Cab.		20	1	0	0					2	30		Comm. Cab.		14	1
1		Spare		30	2			0	0			ļ					16	
	17									0	0	2	30		Comm. Cab.		18	1
3		Spare		20	1	0	0	_	_								20	
3	21	Spare		20	1			0	0			3	60		RPC Rack		22	1
3	23	Spare (Door Motor)		20	1					0	0						24	₩
3		Spare (Door Motor)		20	1	0	0										26	+.
3	27	Spare (Door Motor)		20	1			0	0	0	0	3	60		RPC Rack		28	1
	29 31	Spare		20	2	0	0			0	0						30	_
	33	-				U	0										34	+
	35																36	+
	37																38	+-
	39																40	+
	41																42	+
			-	- Fotal	Load	326	0 VA	920	VA	1140	VA							+
					Amps		7 A		Α	10		1						
	Leg	end:	I		•													1
		ssification		Cor	necte	d Load	d Dei	mand Fa	actor	Estimate	ed Dem	and			Panel	Totals		
Rece	ptac	le			1980	VA		100.00%	6	198	30 VA							
Spar	е				3340	VA		100.009	6	334	10 VA				al Conn. Load:			
														Tota	I Est. Demand:			
															Total Conn.:			
														Tota	I Est. Demand:	15 A		

### **GENERAL NOTES**

- CONTRACTOR IS REQUIRED TO COORDINATE ALL INSTALLATIONS IN EACH SPACE WITH OTHER TRADES. PROVIDE SHOP DRAWINGS AND LAYOUTS FOR EACH ELECTRICAL ROOM WITH PROPOSED CONDUIT ROUTES TO ALLEVIATE POTENTIAL CONFLICTS WITH MECHANICAL, PLUMBING AND TELECOMMUNICATIONS.
- CONTRACTOR SHALL CONDUCT AMPERAGE READINGS FOR THE EXISTING SWITCHGEAR TO VERIFY AMPERAGES FOR EACH PHASE, READINGS SHALL BE RECORDED AND PROVIDED TO THE ENGINEER FOR REVIEW PRIOR TO COMMENCEMENT OF ANY ELECTRICAL INSTALLATIONS.
- PROVIDE PROPER LABELING FOR ALL ELECTRICAL DEVICES. REFER TO SPECIFICATIONS AND DETAILS FOR LABEL TYPES AND REQUIREMENTS.
- 4. CONTRACTOR SHALL PROVIDE ALL NECESSARY MOUNTING EQUIPMENT AND ACCESSORIES REQUIRED FOR PROPER INSTALLATION OF ALL DEVICES TO BE INSTALLED.
- CONTRACTOR SHALL PLACE A LAMINATED COPY OF THE LOAD CALCULATIONS ON THE BOTTOM INTERIOR BEZEL IN EACH PANEL. LOAD CALCULATIONS ARE LOCATED ON THE PANELBOARD SHEETS AT THE BOTTOM OF EACH PANEL SCHEDULE.
- ALL CONDUITS SHALL BE LABELED WITH THE VOLTAGE AND CIRCUITS THAT ARE HOUSED WITHIN. REFER TO SPECIFICATIONS FOR EXACT REQUIREMENTS.

### KEYED NOTES (#)

- PROVIDE NEW 20A/1P BREAKERS IN EXISTING PANEL TO SERVE THE EXIT LANE POWER LOADS. BREAKERS SHALL HAVE THE SAME A.I.C. RATING AS THE EXISTING BREAKERS CURRENTLY INSTALLED.
- FIELD VERIFY AND COORDINATE EXACT ROUTING OF CONDUIT PRIOR TO COMMENCEMENT OF WORK. CONDUIT SHALL BE LABELED AND MOUNTED PER H.A.S SPECIFICATIONS.
- CONTRACTOR SHALL UPDATE THE EXISTING PANELBOARD DIRECTORY PRIOR TO THE COMPLETION OF WORK TO INDICATE THE NEW DEVICE LOADS BEING SERVED FROM THE EXISTING PANE.

### LEGEND

**NEW EQUIPMENT** 

APPROVED EQUAL

### LOAD ANALYSIS

EXISTING MAX DEMAND LOAD = 3.34 KVA NEW LOAD = 1.980 KVA

TOTAL LOAD ON PANEL = 5.320 KVA (15A)

NEW PROPOSED LOAD DOES NOT EXCEED 100A CAPACITY

EXISTING EQUIPMENT TO REMAIN

SPD SURGE PROTECTION DEVICE

ENERGY MONITORING DEVICE, SIEMENS PAC 3200, EMON-DMON OR

EXISTING BRANCH CIRCUITS SERVING LIGHTS NEAR PROPOSED EXIT LANES

**'EX. 2HB1'**100A MCB,
480/277V, 3φ, 4W NEMA 1

BDF ROOM 102.39 TO BRANCH CIRCUITS
SERVING EXIT LANES EX. UWT1LB' 100A MCB, 208/120V, 3φ, 4W NEMA 1 FED FROM UPS-1B-DP-RM. 113.59

NOT TO SCALE

ELECTRICAL POWER RISER DIAG VOLT HIR

5353 West Alabama Suite 205 Houston, 1X. 77056 Phone:832.371.6181 Texas Firm: F-14583 ProjectNo.:02.18027

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PROJECT NAME

**HOU-TERMINAL** - SECURITY **EXIT LANE** 

PROJECT LOCATION

**WILLIAM HOBBY** 7800 AIRPORT BLVD. HOUSTON, TX 77061


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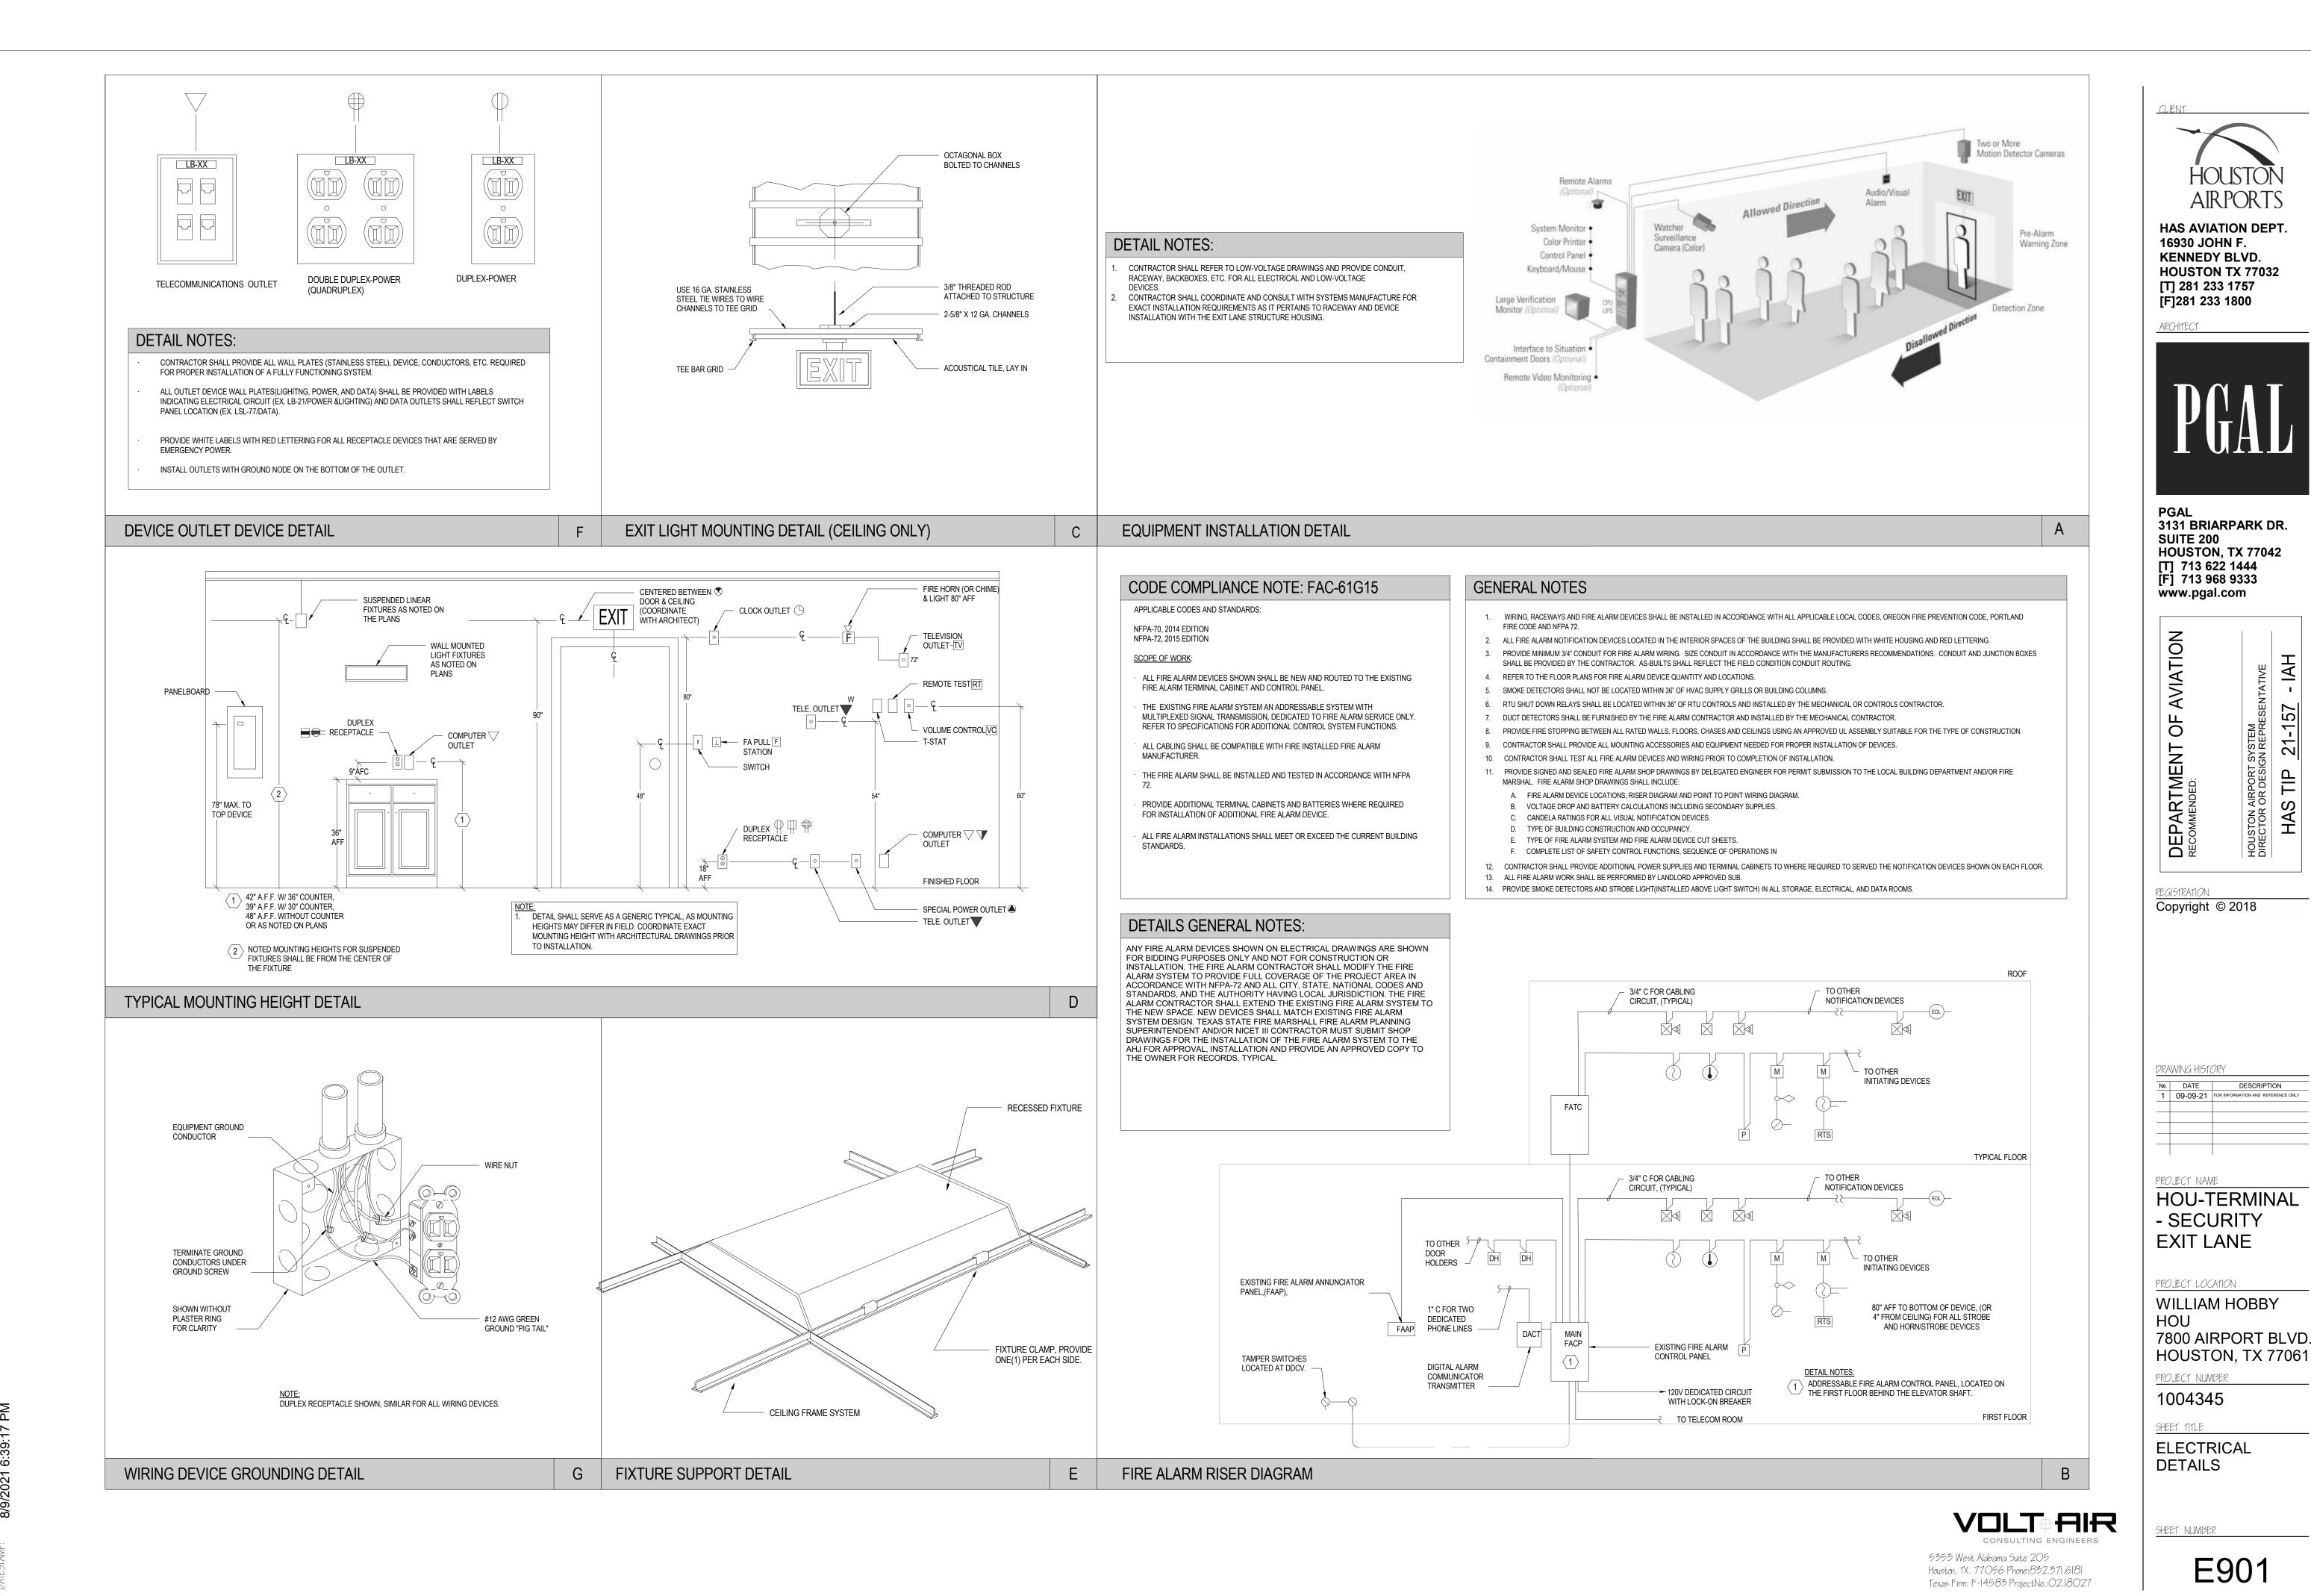
1004345

SHEET 111LE

RISER DIAGRAMS -**ELECTRICAL** 

SHEET NUMBER



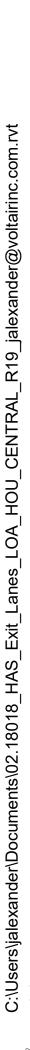



### DETAIL NOTES:

EXISTING DOWNLIGHTS AND LOW-VOLTAGE DEVICES WILL BE RELOCATED PER OWNERS/HAS DISCRETION. COORDINATE WITH HAS PM FOR EXACT LOCATION OF REMOVED

REMOVE AND PATCH LOCATION OF EXISTING DOWNLIGHTS.

REUSE EXISTING FIRE ALARM CONNECTIONS FOR NEW DEVICES TO BE INSTALLED.





**EXISTING EXIT SOFFIT** 

EXISTING FIRE ALARM CONTROL PANEL



**EXISTING EGRESS LANE** 

В



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DIRECTOR OR DESIGN REPRESENTATIVE	
	HOUSTON AIRPORT SYSTEM DIRECTOR OR DESIGN REPRESENTATIVE

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 DATE
 DESCRIPTION

 1
 09-09-21
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PROJECT NAME

HOU-TERMINAL - SECURITY **EXIT LANE** 

PROJECT LOCATION

WILLIAM HOBBY 7800 AIRPORT BLVD. HOUSTON, TX 77061

PROJECT NUMBER

1004345

SHEET TITLE

ELECTRICAL DETAILS



SHEET NUMBER

### **CCVS SYSTEM NOTES**

- 1. ALL OUTDOOR CAMERAS, TERMINATION BOXES, AND PULLBOXES SHALL BE INSTALLED WITH WEATHER RESISTANT HARDWARE.
- 2. PROVIDE ALL INTEGRATION WITH ALARM ACCESS CONTROL SYSTEM COMPONENTS.
- 3. PROVIDE ALL COORDINATION WITH OTHER DISCIPLINES FOR INSTALLATION OF EQUIPMENT.
- 4. COORDINATE ALL SITE WORK WITH OWNER'S REP.
- DRAWINGS INDICATE CAMERA 'HOME POSITIONS'. VERIFY FIELD OF VIEW WITH HOUSTON AIRPORT SYSTEM (HAS) REPRESENTATIVE AND DESIGN CONSULTANT DURING INSTALLATION. SUBSTITUTION OF LENS TYPE & SIZE TO ACCOMPLISH INTENDED FIELD OF VIEW SHALL BE AT NO ADDITIONAL
- 6. CAMERAS MAY INCLUDE MULTIPLE TRANSMISSION METHODS. VERIFY EACH CAMERA PRIOR TO INSTALLATION.
- FIELD VERIFY ALL CAMERA LOCATIONS PRIOR TO INSTALLATION. CAMERA MAY BE RELOCATED WITHIN 25' OF LOCATION SHOWN ON FLOOR PLANS WITHOUT ADDITIONAL COST.

### CAMERA SERVER AND DIGITAL STORAGE NOTES

- PROVIDE DIGITAL STORAGE FOR THIS PROJECT IN THE HAS ADMIN BUILDING AS REQUIRED.
- THE EXISTING CAMERA SERVERS AND DIGITAL STORAGE ARE LOCATED AT THE HAS ADMINISTRATION BUILDING AND TERMINAL C. THEY ARE
- PROVIDE HONEYWELL MAXPRO CAMERA LICENSING AS REQUIRED AT THE HAS ADMINISTRATION BUILDING AND TERMINAL C TO SUPPORT ALL HAS CAMERAS INSTALLED AS PART OF THIS PROJECT.

### ACS SYSTEM NOTES

- ALL OUTDOOR MOUNTED CARD READERS SHALL BE INSTALLED WITH WEATHER RESISTANT AND TAMPER PROOF HARDWARE.
- 2. CARD READER PEDESTALS SHALL BE SIZED FOR VOICE COMMUNICATIONS.
- 3. PROVIDE ALL INTEGRATION WITH CLOSED CIRCUIT VIDEO SURVEILLANCE COMPONENTS.
- 4. PROVIDE ALL COORDINATION WITH OTHER DISCIPLINES FOR INSTALLATION OF EQUIPMENT.
- 5. COORDINATE ALL SITE WORK WITH OWNERS REP.
- 6. PROVIDE ACCESS CONTROL LICENSES AS REQUIRED PART OF THIS PROJECT.
- CARD READER ICLASS ELITE KEY SHALL BE REQUIRED, AND ONLY AUTHORIZED PURCHASER ARE AUTHORIZED TO PURCHASE. THE ICLASS ELITE PROGRAM INCLUDES A CREDENTIAL FORMAT AND CUSTOM AUTHENTICATION KEY.

EQU	EQUIPMENT SYMBOLS LIST					
SYMBOL	DESCRIPTION					
CR	CARD READER					
СВ	CALL BOX (VOIP) W/ CAMERA					
360	360 IP CAMERA					
FIX	FIXED CAMERA					
PTZ	PTZ HD IP CAMERA					
DB	DURESS BUTTON (UNDER DESK/TABLE/COUNTER)					
D	DOOR POSITION SWITCH (FLUSH MOUNT)					
M	REX MOTION SENSOR					
RCT	REMOTE COMMAND TERMINAL (BY OTHER)					
CCR	CENTRAL CONTROL RACK (BY OTHER)					
АО	AUTO DOOR OPERATOR (BY OTHER)					
$\nabla$	PHONE					
•	DATA					
<b>▼</b> _x	CATEGORY 6 DATA OUTLET WHERE X= QUANTITY OF CABLES					
EP	ELECTRIC PANIC BAR WITH REX SWITCH					
EP L	PANIC BAR WITH ELECTRIC LATCH RETRACTION & REX SWITCH					
IFP	INTELLIGENT FIELD PANEL					
Т	TAMPER SWITCH					

SHEET INDEX						
SHEET NO.	SHEET NAME					
TY000 INDEX, SYMBOLS AND NOTES						
TY001	NOTES					
TY002	EQUIPMENT SCHEDULES					
TY100	OVERALL SECURITY FLOOR PLAN - HOBBY TERMINAL, LEVEL 01					
TY101	OVERALL SECURITY FLOOR PLAN - HOBBY TERMINAL, LEVEL 02					
TY200	ENLARGED SECURITY FLOOR PLAN - TERMINAL, LEVEL 02					
TY300	ENLARGED PLAN AT IDF 100.14					
TY500	DOOR AND IFP DETAILS					
TY501	CAMERA DETAILS					
TY502	TELECOM DETAILS					

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**ISSUE FOR REVIEW** 

DRAWING HISTORY

PROJECT NAME **HOU-TERMINAL** - SECURITY **EXIT LANE** 

PROJECT LOCATION **WILLIAM HOBBY** 7800 AIRPORT BLVD. HOUSTON, TX 77061

PROJECT NUMBER 1004345

SHEET TITLE

INDEX, SYMBOLS AND NOTES

SHEET NUMBER

### **TELECOM GENERAL NOTES**


- 1. FOLLOW TELECOM STANDARDS AND PRACTICES. SEE DIVISION 27 SPECIFICATIONS AND T DRAWINGS
- 2. REGISTERED COMMUNICATIONS DISTRIBUTION DESIGNER (RCDD) SUPERVISOR SHALL REVIEW, APPROVE AND STAMP ALL SHOP DRAWINGS. COORDINATE DRAWINGS AND RECORD DRAWINGS.
- 3. ALL WALL PENETRATIONS SHALL BE SEALED WITH APPROVED FIRE STOPPING.
- 4. REFER TO THE ELECTRICAL FLOOR PLAN DRAWINGS FOR ADDITIONAL ROUGH-IN REQUIREMENTS. WHERE THERE ARE DRAWING DISCREPANCIES, THE CONTRACTOR SHALL INSTALL THE GREATER QUANTITY OF DEVICES.
- 5. REFER TO THE SITE PLAN ON AND RISER DIAGRAM FOR TELECOMMUNICATION BACKBONE CONDUITS/CABLES. FIELD COORDINATE EXACT ROUTING WITH OTHER TRADES.
- 6. ALL COMMUNICATIONS EQUIPMENT SHOWN SHALL BE PROVIDED AND INSTALLED BY CONTRACTOR UNLESS NOTED OTHERWISE
- 7. BOND ALL COMMUNICATIONS CABINETS, RELAY RACKS, CABLE TRAYS, AND OTHER METALLIC SUPPORTING DEVICES TO TELECOMMUNICATIONS GROUND BUSBAR INSIDE COMMUNICATIONS ROOM. BOND WITH A #6 GROUND CONDUCTOR.
- 8. ALL HORIZONTAL VOICE AND DATA CABLES SHALL BE DISTRIBUTED VIA MINIMUM 1" CONDUIT AND/OR CABLE TRAY. NO
- 9. SINGLE LINE DIAGRAMS, SCHEMATICS, DETAILS AND CONDUIT PATHS SHOWN HEREIN ARE CONCEPTUAL AND ILLUSTRATE ONLY THE FUNCTIONAL RELATIONSHIPS BETWEEN COMPONENTS OF THE SYSTEM. ACCORDINGLY, FULL SHOP DRAWING DEVELOPMENT IS REQUIRED TO REALIZE THE SPECIFIED FUNCTIONS.
- 10. DEVICE LOCATIONS ON PLANS ARE CONCEPTUAL. LOCATE AS SITE CONDITIONS REQUIRE AND AS APPROVED BY GC.
- 11. REFER TO THE BID SPECIFICATION FOR ADDITIONAL REQUIREMENTS REGARDING THIS WORK.
- 12. PAINTING, PATCHING AND FINISHES FOR DEVICES LOCATED IN EXISTING AREAS SHALL MATCH EXISTING FINISHES AS APPROVED BY GC.
- 13. FINISHES OF DEVICES IN NEW/REMODEL AREAS SHALL BE APPROVED BY GC.
- 14. WORK AND MATERIALS SHALL CONFORM TO THE MOST CURRENT UNIFORM STANDARD SPECIFICATIONS AND DETAILS FOR CONSTRUCTION AS FURNISHED BY GC. WORK AND MATERIALS NOT IN CONFORMANCE WITH THESE SPECIFICATIONS AND DETAILS ARE SUBJECT TO REMOVAL AND REPLACEMENT AT THE CONTRACTOR'S EXPENSE.
- 15. IN SOME INSTANCES THE IDF MAY BE OVER 90 METERS FROM THE IP DEVICE DUE TO LEGACY DESIGN STANDARDS WHEN THE BUILDING WAS CONSTRUCTED. IF TESTED CABLE DOES NOT PASS CERTIFICATION, CONTRACTOR MUST USE MIDSPAN EXTENDER INSTALLED INSIDE OF ENCLOSURE. REFERENCE DETAIL SHEETS FOR INSTALLATION DIAGRAM.

### SECURITY CABLE DESIGNATION/TYPE *

DESIGNATION	DESCRIPTION	USAGE	PART#
A B C D E F G H I J K L	1 PAIR 22AWG SHIELDED 2 PAIR 20AWG SHIELDED 3 PAIR 22AWG SHIELDED 2/C 18AWG 2 PAIR 22AWG SHIELDED 2/C 18AWG SHIELDED 2/C 18AWG SHIELDED COAXIAL W/2C POWER 1 PAIR 20AWG TWISTED 1 PAIR TWISTED SH 18AWG PLUS 2/C 18AWG ENHANCED CAT-5E BONDED-PAIR UTP ACCESS CONTROL COMPOSITE CABLE, 4C 18AWG,3PR 22 AWG, 4C 22 AWG CCTV COMPOSITE CABLE 2C 18AWG, UNSHIELDED, CABLE ETHERNET (PLENUM), R659 (PLENUM)	ALARM MONITORING MOTION DETECTOR, BEAM DETECTORS CARD READER CAMERA PWR, PUSH BUTTON, LOCK PWR DATA, CCVS PTZ CONTROL HORN VIDEO INTERCOM EMERGENCY PHONE NETWORK AND CAMERA LOCK PWR, CR, DOOR CONTACT, REX, 1 SPARE YELLOW JACKET CAM PWR, UTP/IP VIDEO ANALOG VIDEO CONNECT K112	BELDEN 5500FE BELDEN 5441 FE BELDEN 5542 FE BELDEN 5300 UE BELDEN 5541 FE BELDEN 5300 UE  BELDEN 5400 FE BELDEN 5302GE BELDEN 7815A WSECCOMP2835  WSECOMP-2817

* THIS TABLE IS REFERENCED AND IS SHOWN AS AN EXAMPLE OF ACCEPTABLE CABLE DESIGNATIONS. CONTRACTOR SHALL UTILIZE CABLE
DESIGNATION TABLE FOR SHOP DRAWING AND RECORD DRAWING SUBMITTALS.

# CONDUIT DESIGNATION KEY

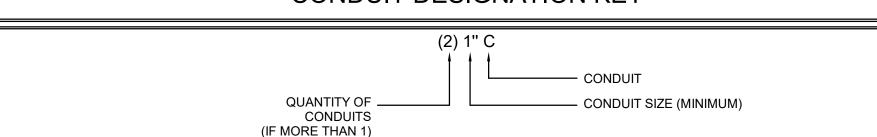

#### SECURITY GENERAL NOTES

- 1. THE FOLLOWING GENERAL NOTES ARE APPLICABLE AS STATED BELOW, EXCEPT WHERE SPECIFICALLY INDICATED OTHERWISE, ON THE DRAWINGS OR IN THE BID SPECIFICATION.
- 2. SINGLE LINE DIAGRAMS, SCHEMATICS, DETAILS AND CONDUIT PATHS SHOWN HEREIN ARE CONCEPTUAL AND ILLUSTRATE ONLY THE FUNCTIONAL RELATIONSHIPS BETWEEN COMPONENTS OF THE SYSTEM. ACCORDINGLY, FULL SHOP DRAWING DEVELOPMENT IS REQUIRED TO REALIZE THE SPECIFIED FUNCTIONS.
- 3. DEVICE LOCATIONS ON PLANS ARE CONCEPTUAL. LOCATE AS SITE CONDITIONS REQUIRE AND AS APPROVED BY THE OWNER.
- 4. REFER TO THE BID SPECIFICATION FOR ADDITIONAL REQUIREMENTS REGARDING THIS WORK.
- INSTALL WALL MOUNTED CARD READERS, PUSH BUTTON SWITCHES, KEYPADS, KEY SWITCHES AND OTHER WALL MOUNTED FIELD DEVICES, AT 48 INCHES MAXIMUM ABOVE FINISHED FLOOR, UNLESS OTHERWISE NOTED. MOUNTING HEIGHT SHALL COMPLY WITH TEXAS ACCESSIBILITY STANDARD (TAS).
- 6. PROVIDE PAINTING, PATCHING AND FINISHES, OF MATERIALS AND DEVICES, AS APPROVED BY THE OWNER.
- 7. DOOR DETAILS ILLUSTRATE FUNCTIONAL RELATIONSHIPS. ACTUAL ARCHITECTURAL CONDITIONS (SUCH AS DIRECTION OF SWING AND HAND OF DOOR) MAY VARY.
- 8. WORK AND MATERIALS TO CONFORM TO THE MOST CURRENT UNIFORM STANDARD SPECIFICATIONS, ASSOCIATED CODES REFERENCED BY THE (AHJ) AUTHORITY HAVING JURISDICTION, AND DETAILS FOR CONSTRUCTION, AS FURNISHED BY THE OWNER. WORK AND MATERIALS, NOT IN CONFORMANCE WITH PROJECT SPECIFICATIONS AND DETAILS, ARE SUBJECT TO REMOVAL AND REPLACEMENT AT THE CONTRACTOR'S EXPENSE.
- 9. FOR INFORMATION REGARDING FIRE RATINGS AND OCCUPANCY SEPARATIONS, REFER TO ARCHITECTURAL PLANS AND SPECIFICATIONS.
- 10. NEW CONDUIT CONNECTIONS TO INCLUDE INTEGRAL PROTECTIVE BUSHINGS OR CHASE NIPPLES.
- 11. NEW CONDUIT FOR FUTURE USE TO BE FILLED WITH 200 POUND STRENGTH PULL LINE. PROVIDE LABELING ON EACH END OF THE PULL LINE TO INDICATE LOCATION OF OTHER END.
- 12. NEW CONDUITS SHALL BE CONCEALED WHENEVER POSSIBLE. SURFACE MOUNTED CONDUITS ARE PERMISSIBLE ONLY WHERE APPROVED. USE ONLY CONCEALED CONDUITS WITHIN FINISHED SPACES. THE ABOVE STANDARDS ALSO APPLY TO EXTERIOR SPACES. SEEK APPROVAL FROM THE OWNER FOR EACH AREA WHERE SURFACE CONDUIT IS NECESSARY.
- 13. JUNCTION BOXES SHALL BE MINIMUM 4 INCH SQUARE DEEP STYLE, SIZED AS REQUIRED TO ACCOMMODATE CONDUITS UNLESS OTHERWISE NOTED. PROVIDE MOUNTING RING AS REQUIRED. PROVIDE A BLANK COVER PLATE FOR JUNCTION BOXES AND PULL BOXES WITH NO DEVICE.
- 14. EXPOSED BOXES AND PANELS, MOUNTED IN OR ON EXTERIOR WALLS, TO BE NEMA 4.
- 15. NEW CONDUIT TO BE 3/4 INCH EMT MINIMUM, UNLESS OTHERWISE NOTED. EXTERIOR CONDUIT TO BE RIGID.
- 16. USE 120VAC CIRCUITS UNLESS OTHERWISE NOTED. VERIFY CURRENT LOAD ON EXISTING CIRCUITS BEFORE CONNECTING NEW LOADS. COORDINATE WITH OWNER IF ADDITIONAL CIRCUITS ARE REQUIRED.
- 17. CONTRACTOR TO VERIFY CONDUIT AND PLENUM CABLE PATHS INDICATED ON THE DRAWINGS. CONTRACTOR MAY PROPOSE ALTERNATE ROUTING WHERE CONFLICTS ARE FOUND.
- 18. CONTRACTOR IS RESPONSIBLE FOR CEILING INTEGRITY, THIS INCLUDES ROUTING ABOVE CONCEALED SPLINE INTERLOCKING
- 19. CONTRACTOR TO OBTAIN RECERTIFICATION FOR FIRE RATED DOOR FRAME AND DOOR MODIFIED BY THIS PROJECT.
- 20. ACCESS CONTROL LOW VOLTAGE WIRING TO BE PLENUM RATED.
- 21. DO NOT EXCEED 180° IN AGGREGATE CONDUIT BENDS AND/OR 100' CONDUIT WITHOUT PULLBOX.
- 22. PROVIDE GROUND BUSHING ON ALL CONDUIT END IN EQUIPMENT ROOM. BOND TO APPROVED BUILDING GROUND.
- 23. LABEL CONDUIT EVERY 50' WITH DEVICE ID & EQUIPMENT ROOM ID WITH PERMANENT INK CABLE MADE WITH LASER CABLE MAKER. SECURE TO CONDUIT WITH CLEAR TAPE.
- 24. ALL WALL AND FLOOR PENETRATIONS SHALL BE SEALED WITH APPROVED FIRE STOP.
- 25. ALL CABLES NOT IN CONDUIT ABOVE DROP CEILING SHALL BE INSTALLED IN MIN, 1" J-HOOK EVERY 5'-8". DO NOT EXCEED 40% FILL.
- 23. LABEL CONDUIT EVERY 50' WITH DEVICE ID & EQUIPMENT ROOM ID WITH PERMANENT INK CABLE MADE WITH LASER CABLE MAKER. SECURE TO CONDUIT WITH CLEAR TAPE.
- 24. LOCATE DEVICES AS SITE CONDITIONS REQUIRE.
- 25. FIELD VERIFY ALL DIMENSIONS.
- 26. REFER TO THE SPECIFICATION FOR ADDITIONAL REQUIREMENTS REGARDING THIS WORK. CONTRACTOR TO PREPARE PROPOSAL FOR EACH DISCIPLINE. PROVIDE COORDINATION BETWEEN DISCIPLINES FOR CONSTRUCTION.
- 27. NOTIFY DESIGN CONSULTANT AND OWNER WHERE EXISTING CONDITIONS REQUIRE REPAIR PRIOR TO INSTALLATION.
- 28. COORDINATE ALL WORK WITH GENERAL CONTRACTOR.
- 29. ALL CABLE PULLS WITHIN EXISTING AND NEW CONDUITS TO BE MADE AT SAME TIME.
- 30. DEFINITION: BY DIVISION 8 EQUIPMENT PROVIDED AND INSTALLED BY DIVISION 8 CONTRACTOR.
- 31. DEFINITION: BY DIVISION 26 EQUIPMENT PROVIDED AND INSTALLED BY DIVISION 26 CONTRACTOR.
- 34. DEFINITION: BY DIVISION 27 EQUIPMENT PROVIDED AND INSTALLED BY DIVISION 27 CONTRACTOR.35. DEFINITION: BY DIVISION 28 EQUIPMENT PROVIDED AND INSTALLED BY DIVISION 28 CONTRACTOR.

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DRAWING HISTORY

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09-09-21 FOR INFORMATION AND REFERENCE

PROJECT NAME
HOU-TERMINAL
- SECURITY

**EXIT LANE** 

PROJECT LOCATION
WILLIAM HOBBY
HOU
7800 AIRPORT BLVD.
HOUSTON, TX 77061

PROJECT NUMBER

1004345
SHEET TITLE

NOTES

SHEET NUMBER

ITEM	CAMERA NO.	SHEET NO.	LEVEL	CAMERA VIEW	CAMERA TYPE	CAMERA MOUNTING TYPE	TERMINATING IDF	REFERENCE MOUNTING DETAIL	DESCRIPTION
			•						
1	2.C01	TY200	LEVEL 02	CR 2.R01	HD FIX	CEILING MOUNT	IDF 100.14	1/TY501	NEW CAMERA
2	2.C02	TY200	LEVEL 02	CR 2.R02	HD FIX	CEILING MOUNT	IDF 100.14	1/TY501	NEW CAMERA
3	2.C03	TY200	LEVEL 02	CR 2.R03 & CR 2.R04	HD FIX	CEILING MOUNT	IDF 100.14	1/TY501	NEW CAMERA
4	2.C04	TY200	LEVEL 02	CR 2.R05	HD FIX	CEILING MOUNT	IDF 100.14	1/TY501	NEW CAMERA
5	2.C05	TY200	LEVEL 02	CR 2.R06	HD FIX	CEILING MOUNT	IDF 100.14	1/TY501	NEW CAMERA
6	2.C06	TY200	LEVEL 02	CR 2.R07	HD FIX	CEILING MOUNT	IDF 100.14	1/TY501	NEW CAMERA
7	2.C07	TY200	LEVEL 02	CR 2.R08	HD FIX	CEILING MOUNT	IDF 100.14	1/TY501	NEW CAMERA
8	2.C08	TY200	LEVEL 02	ACTIVITY AT EXIT LANE ENTRANCE AREA	HD FIX	CEILING MOUNT	IDF 100.14	1/TY501	NEW CAMERA
9	2.C09	TY200	LEVEL 02	STAIR EXIT 215.00A	HD FIX	CEILING MOUNT	IDF 100.14	1/TY501	NEW CAMERA

CAMERA SCHEDULE NTS 1

ITEM	READER NO.	SHEET NO.	LEVEL	LOCATION	ASSOCIATED CAMERA	TERMINATING IDF	DESCRIPTION
1	2.R01	TY200	LEVEL 02	EXIT LANE (DOUBLE DOOR)	2.C01	IDF 100.14	NEW CARD READER
2	2.R02	TY200	LEVEL 02	EXIT LANE (DOUBLE DOOR)	2.C02	IDF 100.14	NEW CARD READER
3	2.R03	TY200	LEVEL 02	EXIT LANE (ENTRANCE DOOR)	2.C03	IDF 100.14	NEW CARD READER
4	2.R04	TY200	LEVEL 02	EXIT LANE (EXIT DOOR)	2.C03	IDF 100.14	NEW CARD READER
5	2.R05	TY200	LEVEL 02	EXIT LANE (MIDDLE DOOR)	2.C04	IDF 100.14	NEW CARD READER
6	2.R06	TY200	LEVEL 02	EXIT LANE (MIDDLE DOOR)	2.C05	IDF 100.14	NEW CARD READER
7	2.R07	TY200	LEVEL 02	EXIT LANE (ENTRANCE DOOR)	2.C06	IDF 100.14	DOOR CONTACT
8	2.R08	TY200	LEVEL 02	EXIT LANE (ENTRANCE DOOR)	2.C07	IDF 100.14	DOOR CONTACT

CARD READER SCHEDULE NTS 2

ITEM	ALARM NO.	SHEET NO.	LEVEL	LOCATION	ASSOCIATED CAMERA	TERMINATING IDF	DESCRIPTION
1	2.A01	TY300	LEVEL 02	IDF 100.14	-	IDF 100.14	NEW IFP TAMPER SWITCH

ALARM POINT SCHEDULE NTS 3

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RECOMMENDED:

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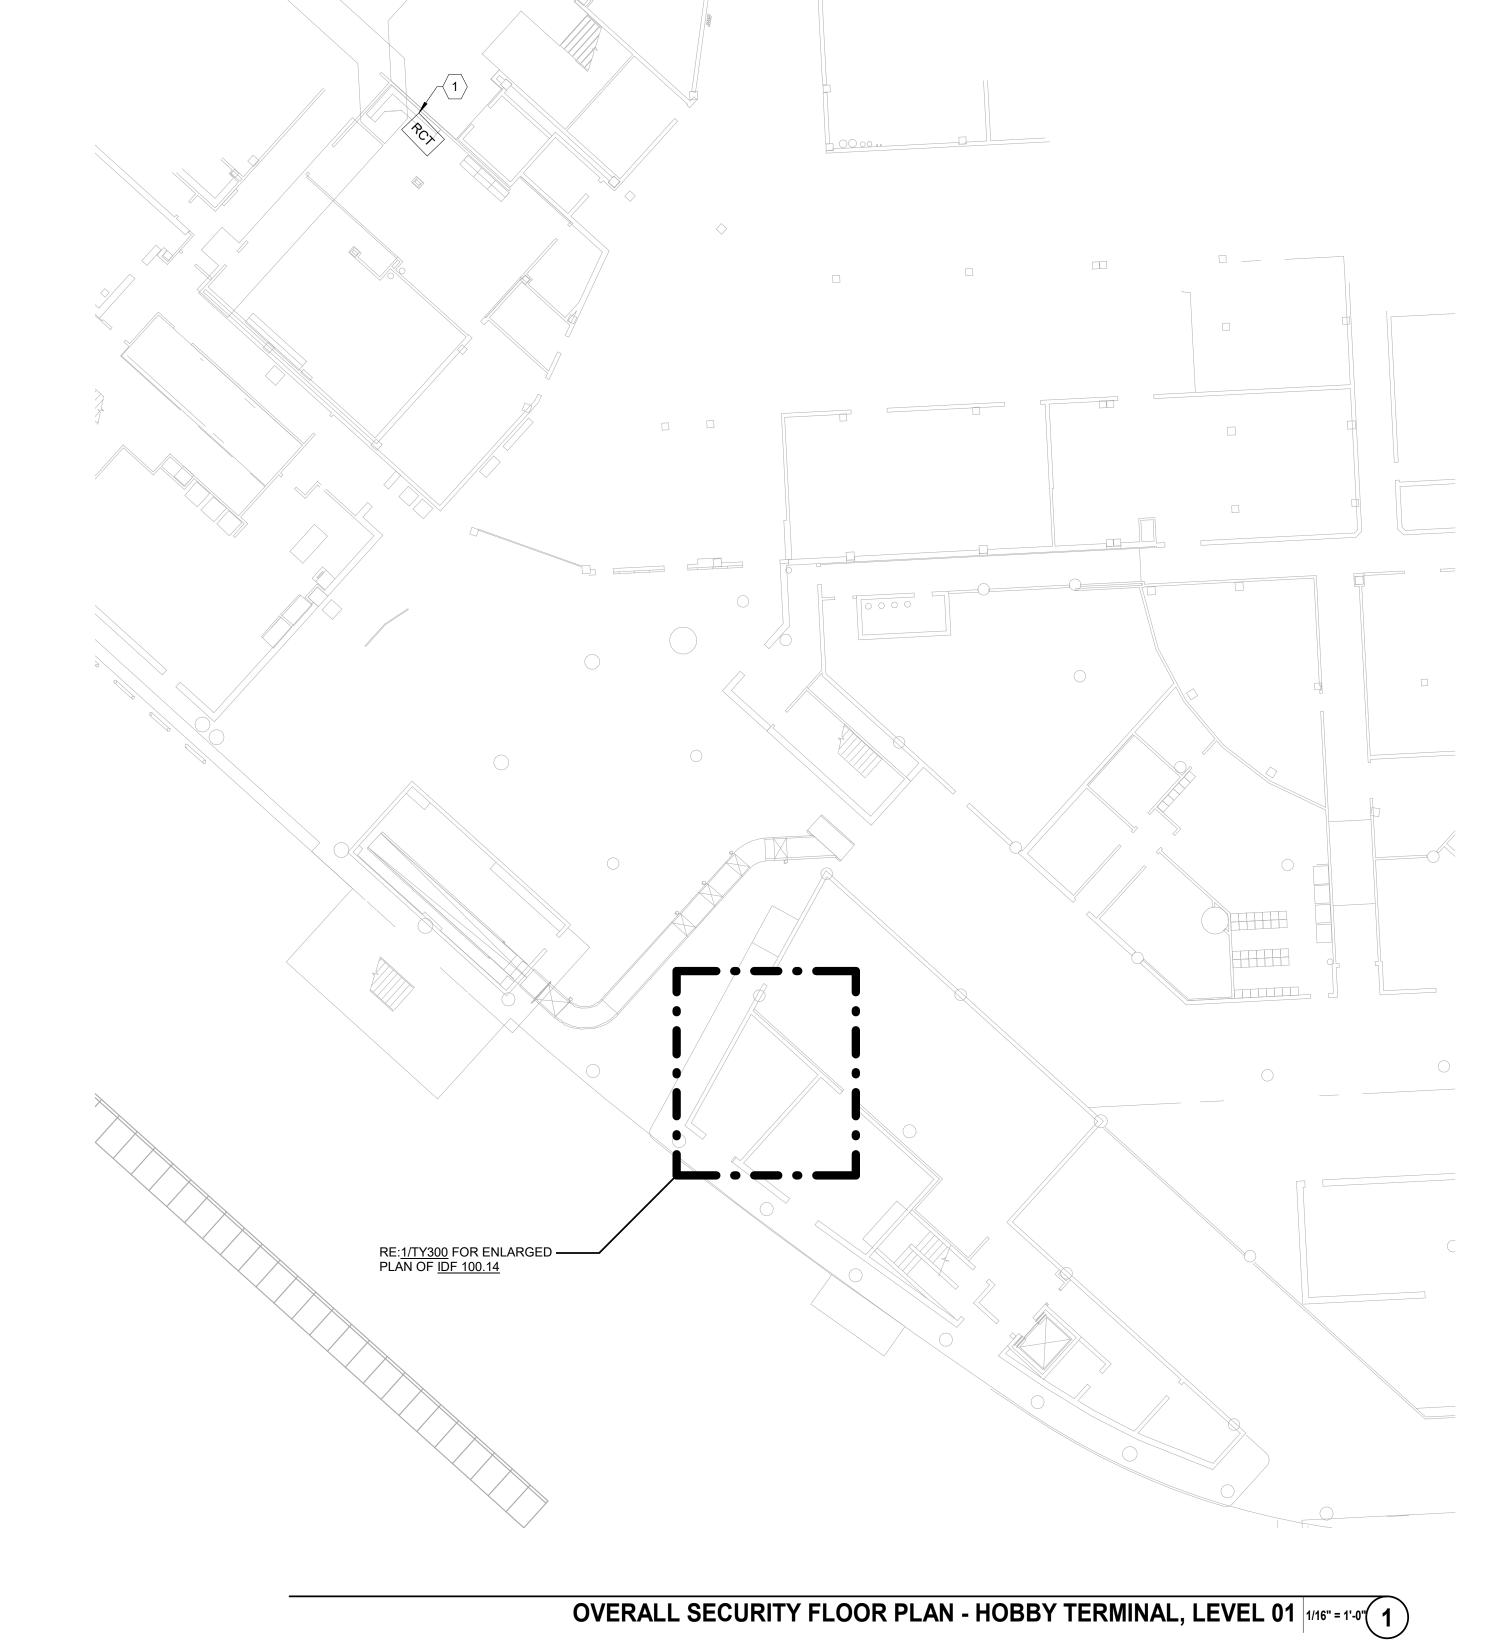
PROJECT LOCATION **WILLIAM HOBBY** HOU 7800 AIRPORT BLVD. HOUSTON, TX 77061

PROJECT NUMBER

1004345

SHEET TITLE **EQUIPMENT** SCHEDULES

SHEET NUMBER



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#### **GENERAL NOTES:**

- 1. ALL SECURITY DEVICES SHALL TERMINATE IN IDF 100.14.
- EXIT LANE CONTAINMENT DEVICES SHALL TERMINATE IN CCR AT IDF 100.14.

#### KEY NOTES:

PROVIDE FOUR (4) DATA DROPS FOR RCT, COORDINATE W/ TSA REPRESENTATIVE FOR LOCATION ON RCT PRIOR TO INSTALLATION. EXTEND 4 DATA DROPS TO CCR IN IDF 100.14

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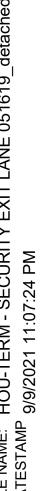
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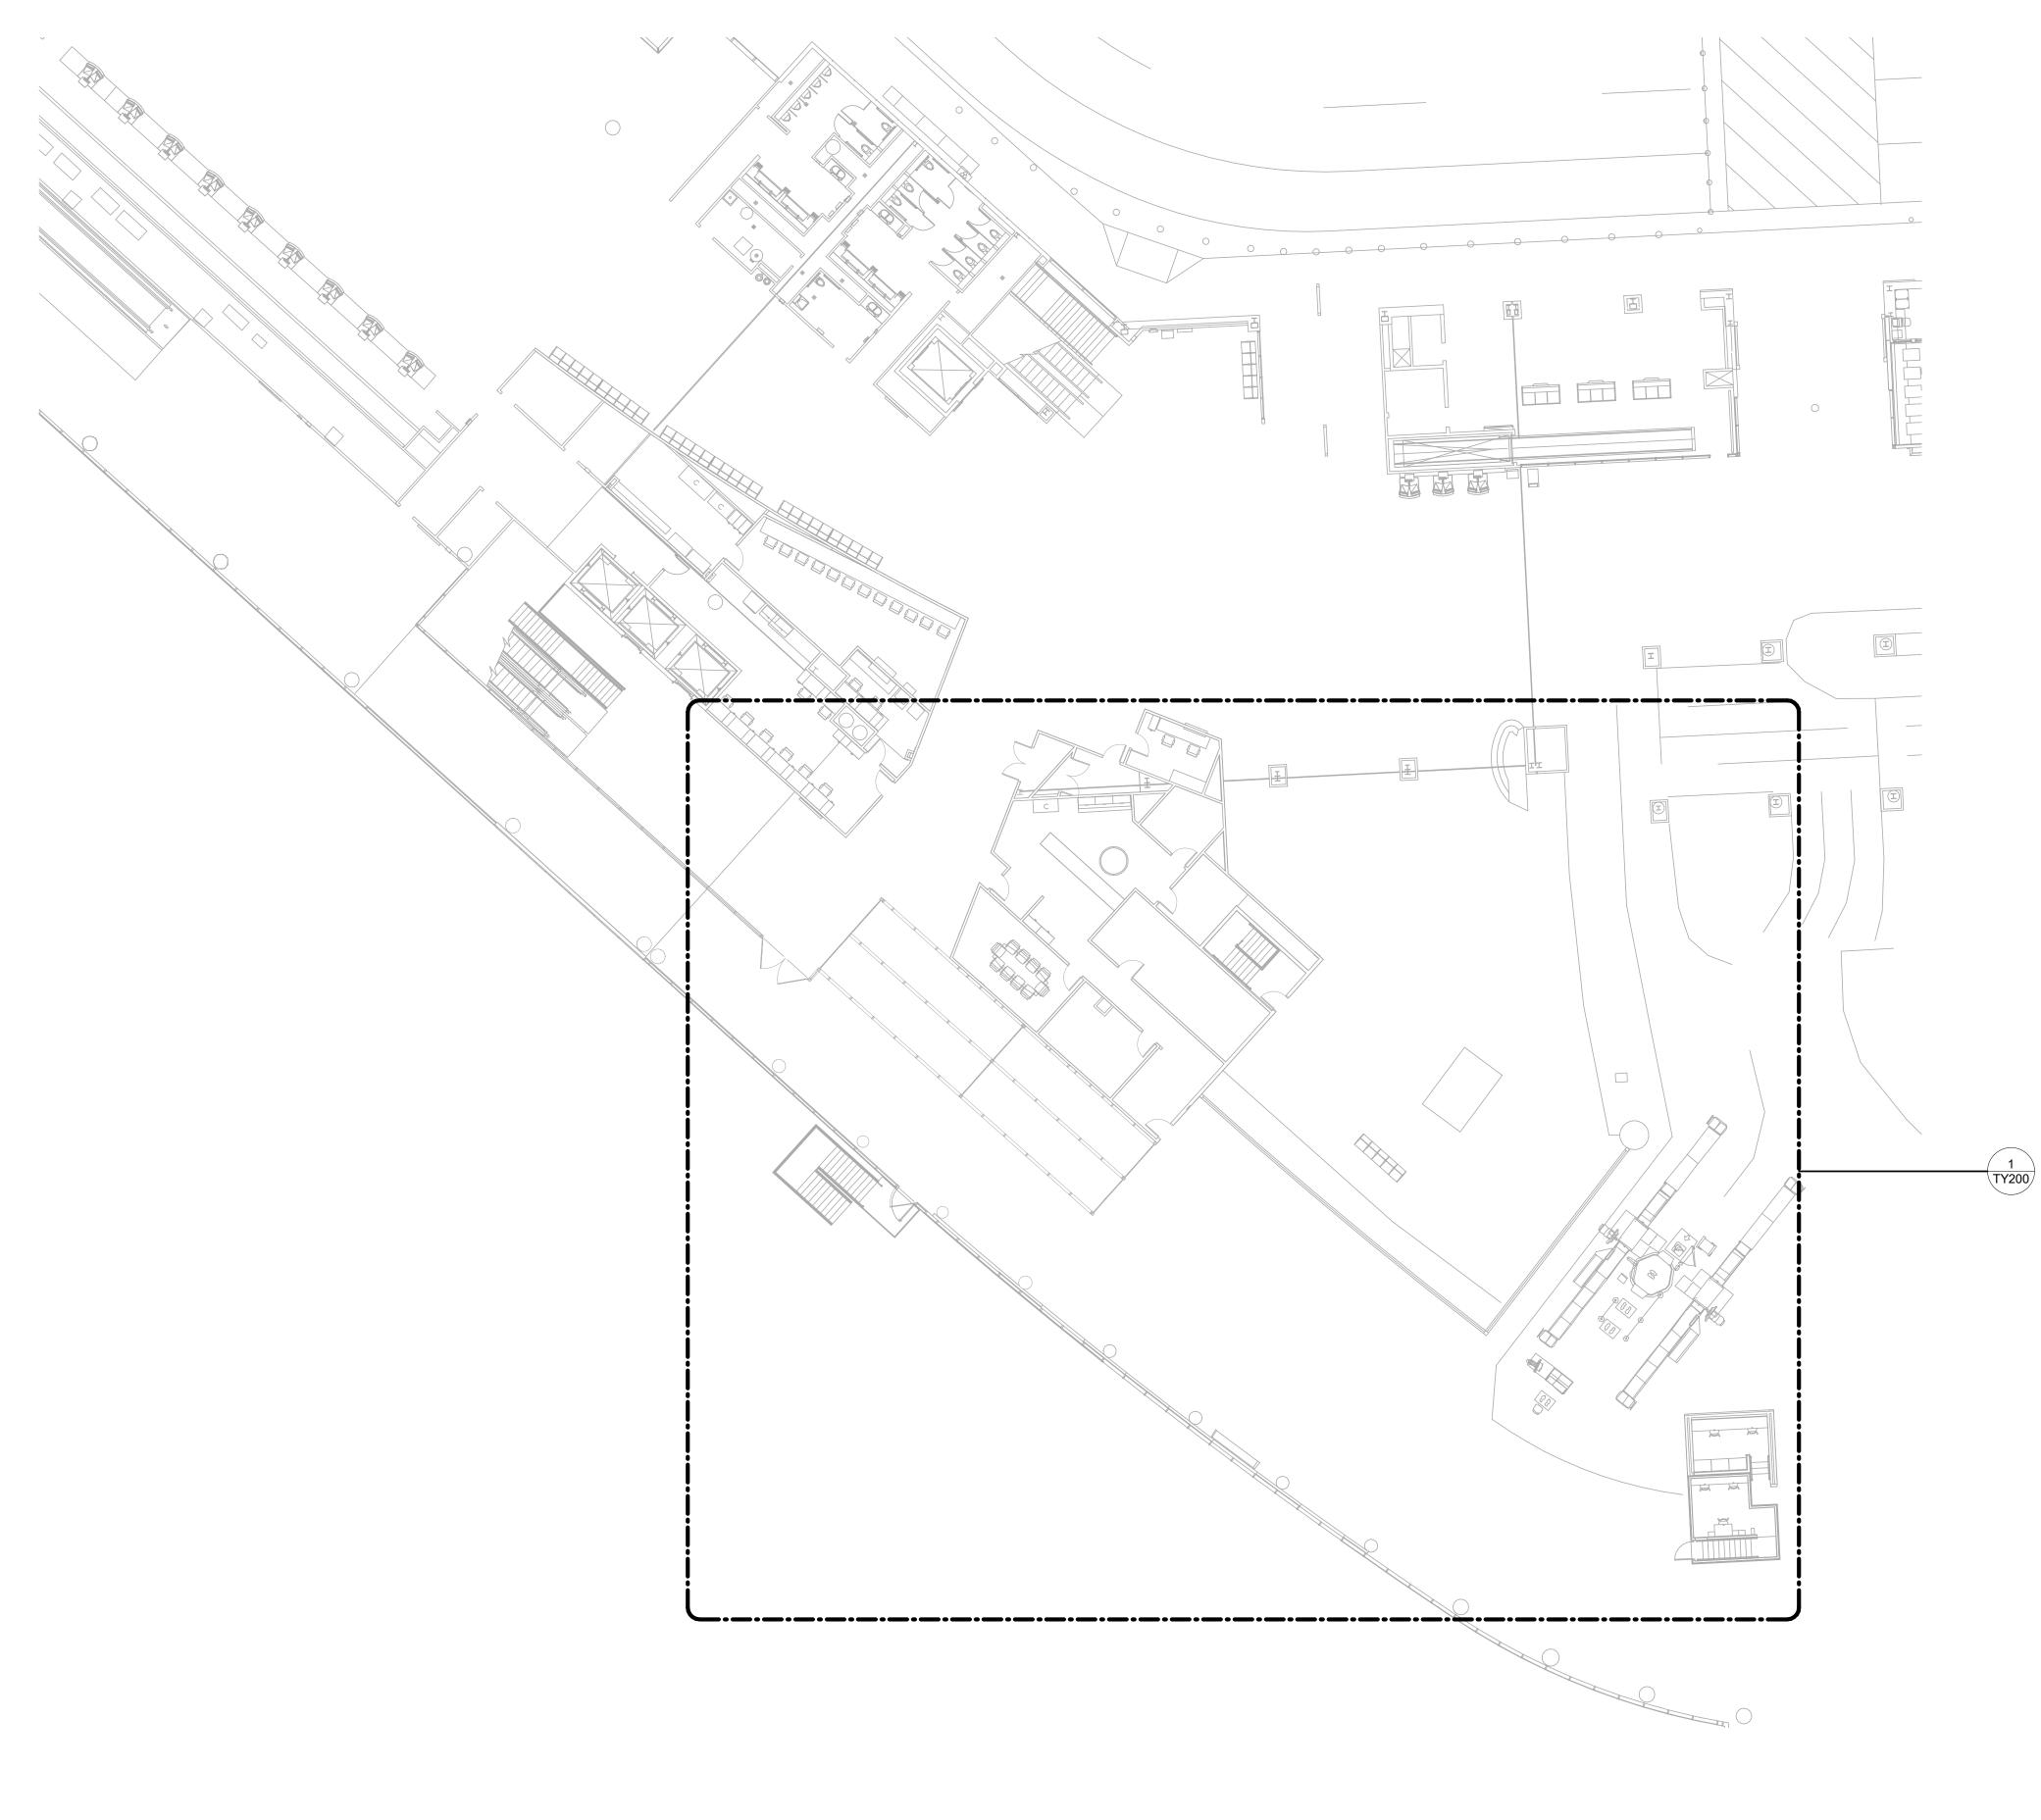
OVERALL SECURITY FLOOR PLAN - HOBBY TERMINAL, LEVEL SHEET NUMBER

PLAN NORTH 1:256 SCALE

0 2.56 5.12

25.6 m





OVERALL SECURITY FLOOR PLAN - HOBBY TERMINAL, LEVEL 02 1/16" = 1'-0" 1

PLAN NORTH 1:256 SCALE 0 2.56 5.12 25.6 m **CLIENT** 

HOUSTON AIRPORTS

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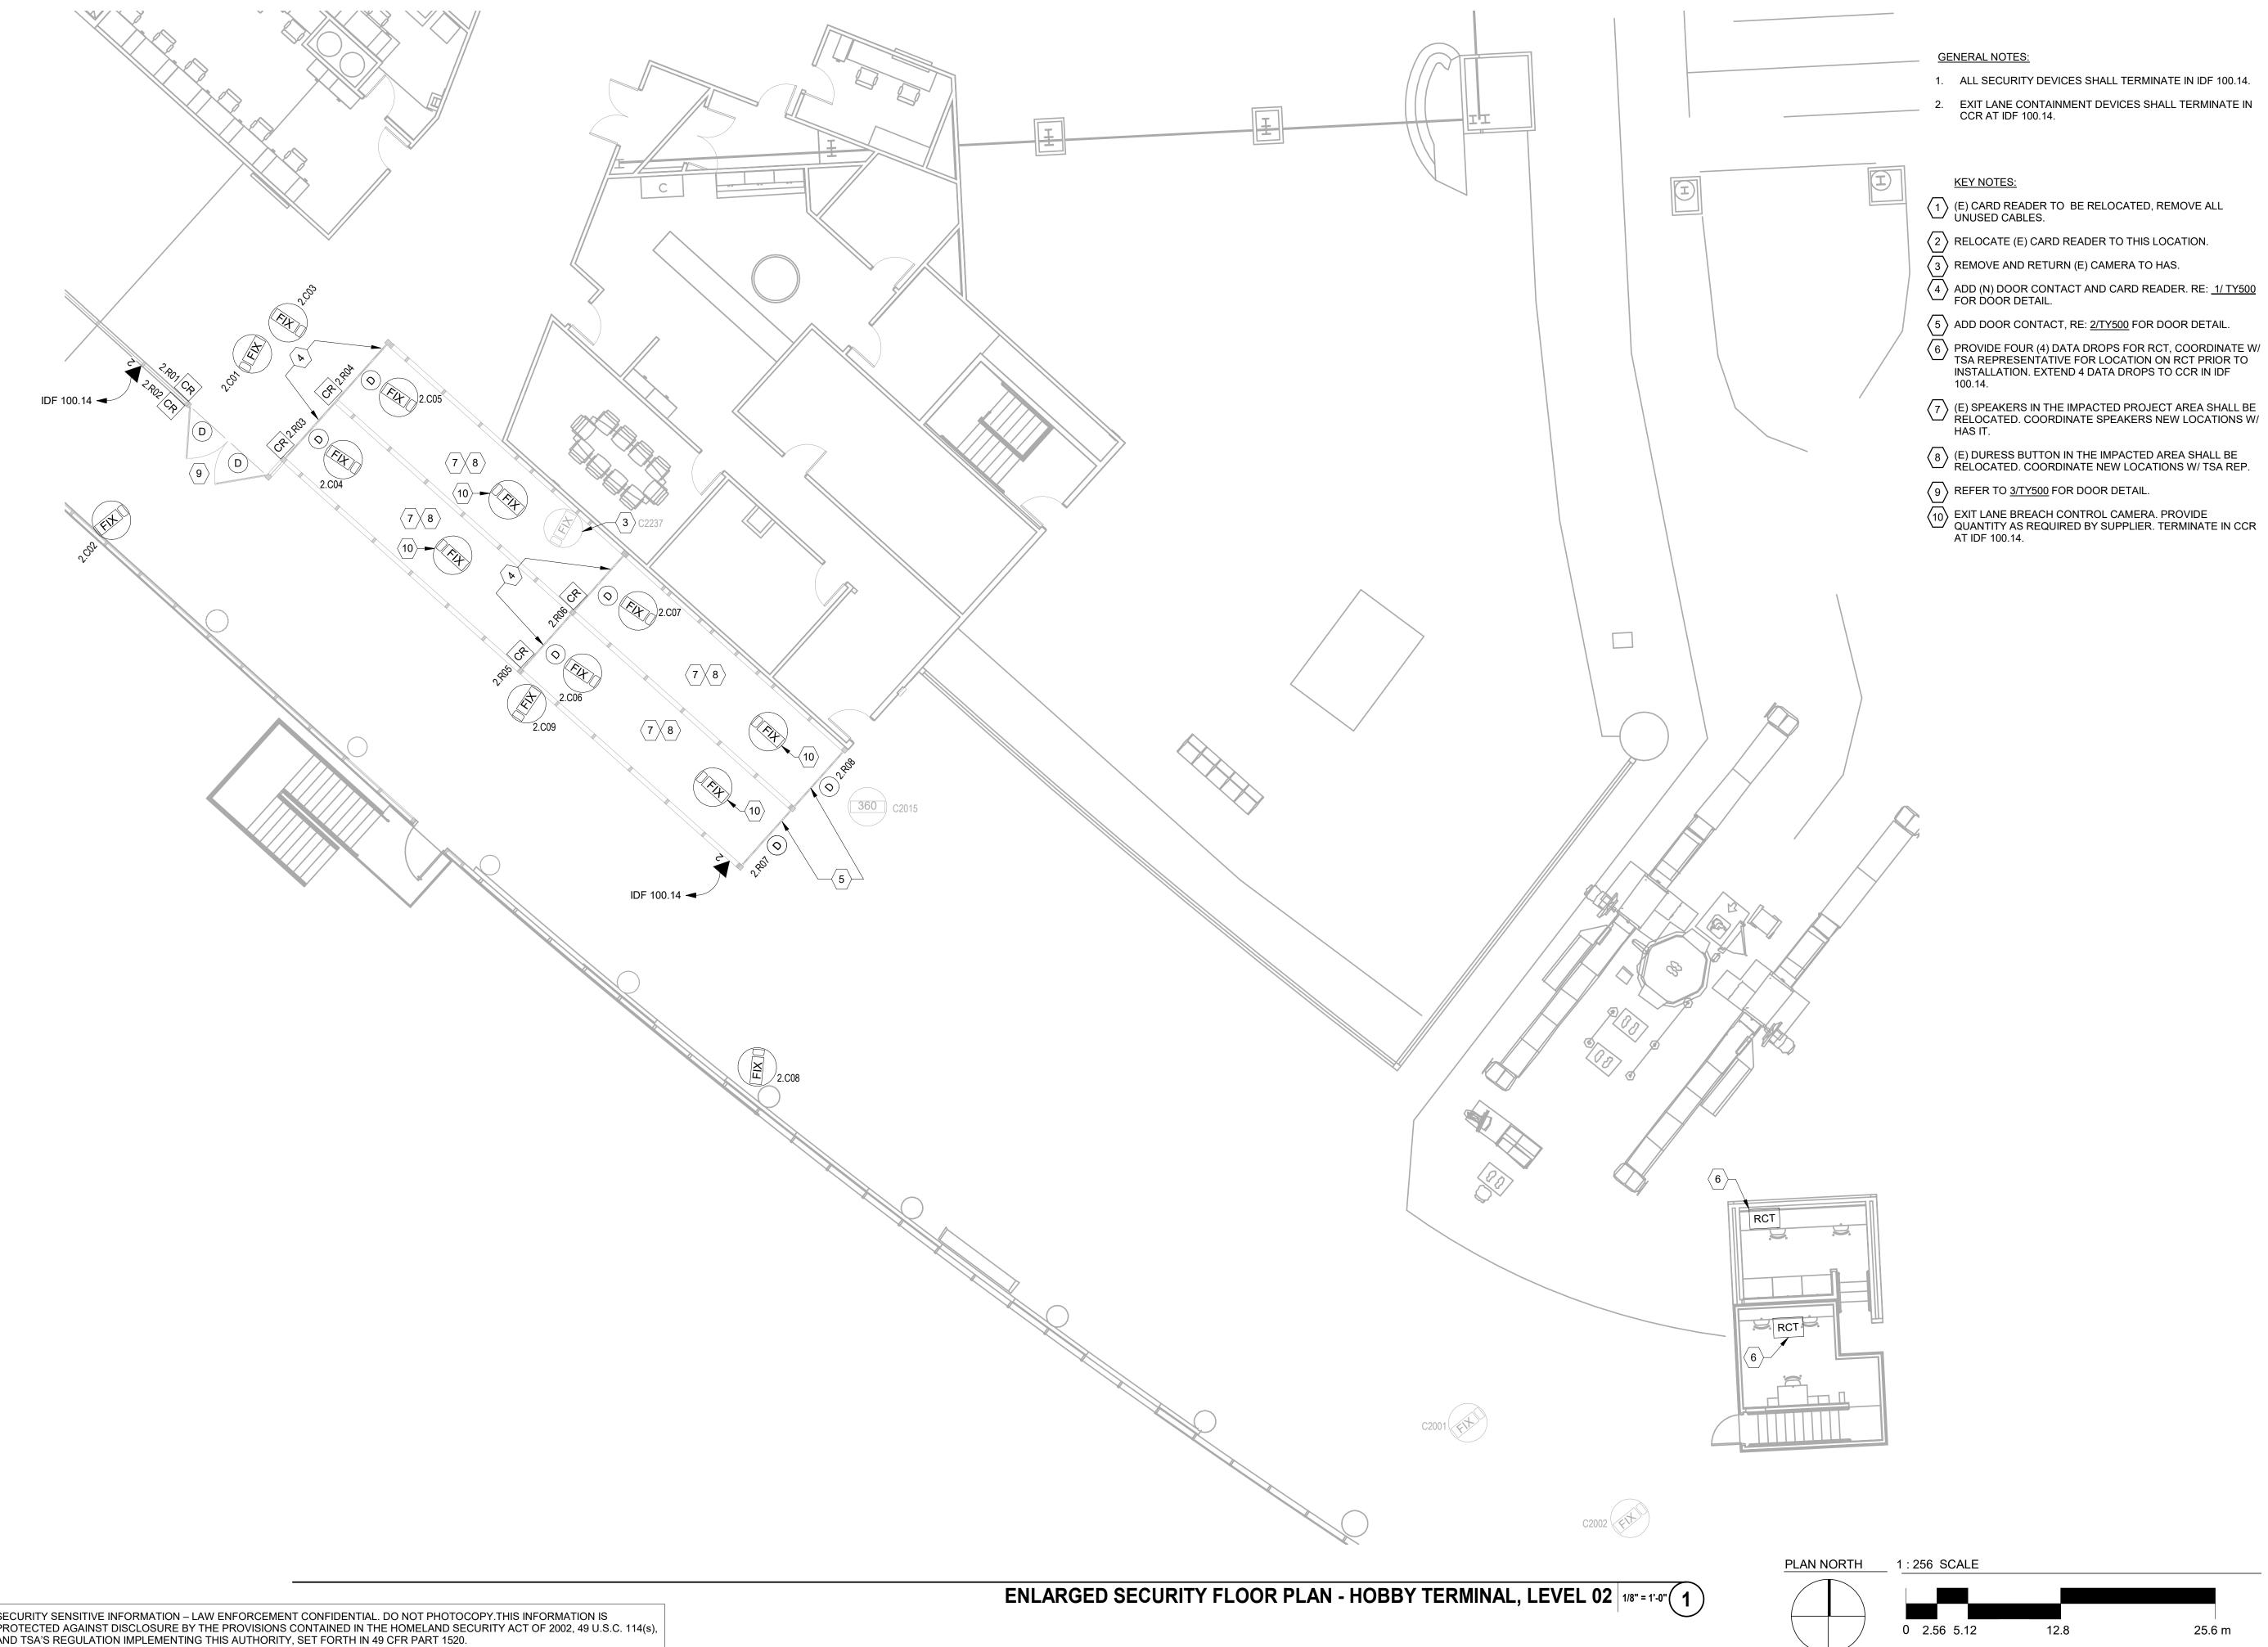
1004345

SHEET TITLE

OVERALL SECURITY FLOOR PLAN - HOBBY TERMINAL, LEVEL 02 SHEET NUMBER

TY101

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**CLIENT** 

HOUSTON **AIRPORTS** 

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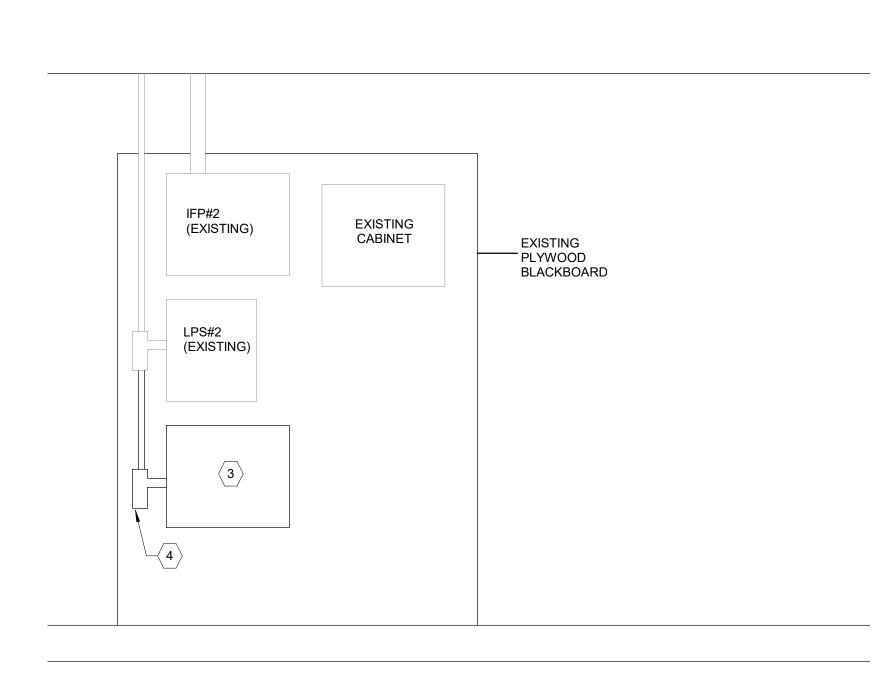
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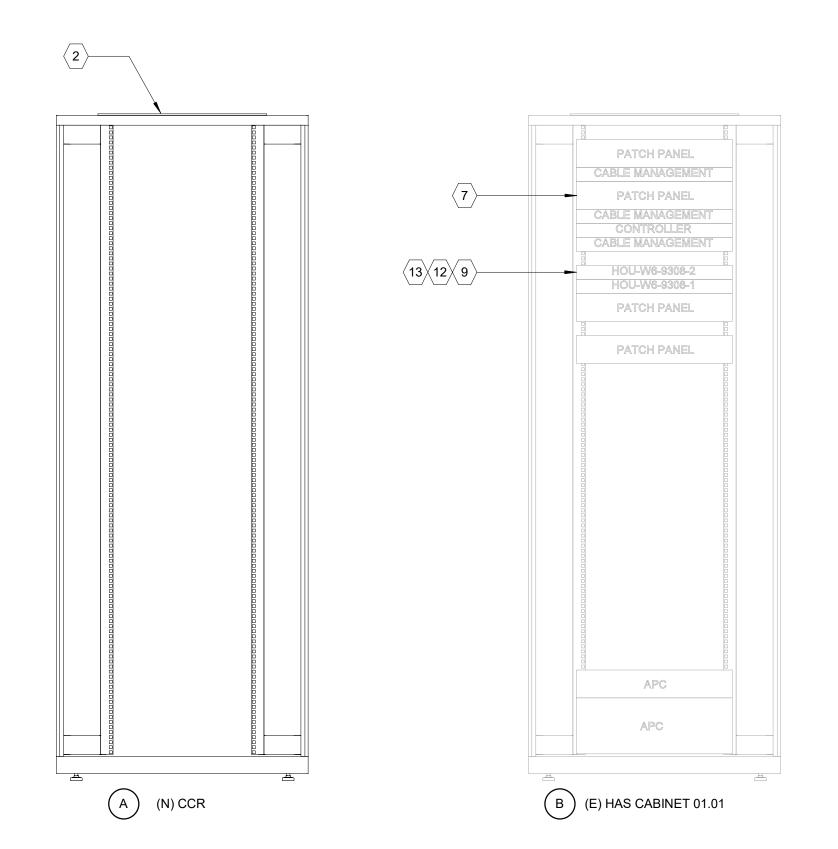
SHEET TITLE

**ENLARGED** SECURITY FLOOR PLAN - HOBBY TERMINAL, LEVEL 02 SHEET NUMBER




WALL ELEVATION AT IDF 100.14 11/2" = 1'-0' (3)

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RACK ELEVATIONS AT IDF 100.14 1" = 1'-0" (2)



ONE LINE DIAGRAM AT IDF 100.14 3/4" = 1'-0" (4)
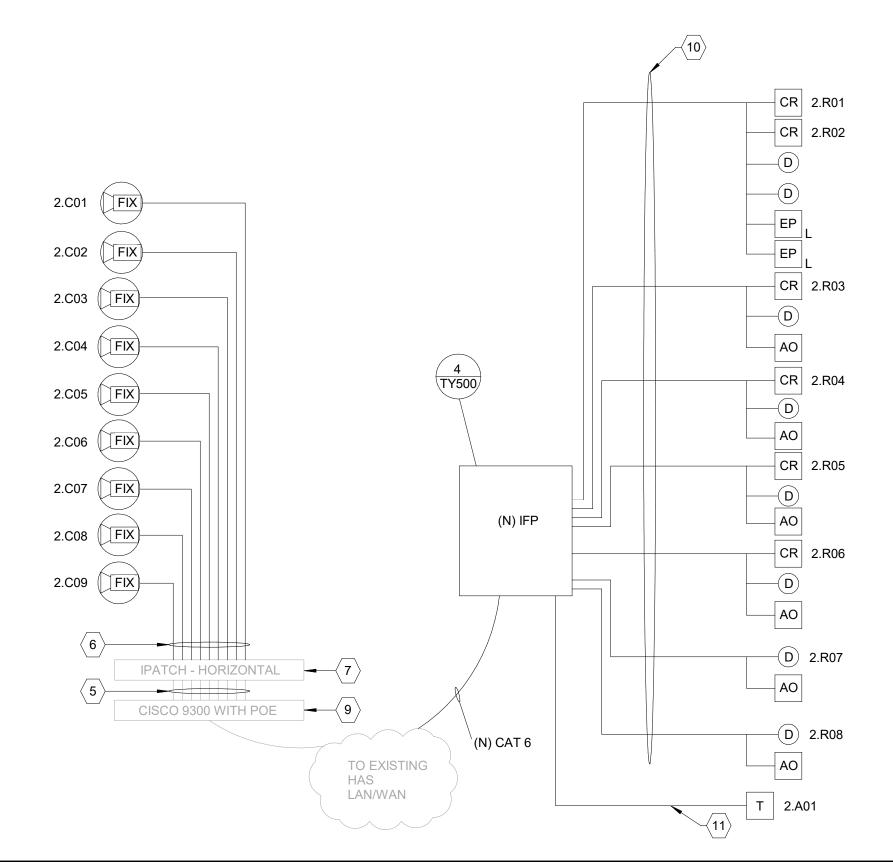
#### **KEY NOTES:**

- (1) COORDINATE REMOVAL OF EXISTING RACK. LEAVE SPACE FOR NEW CENTRAL CONTROL RACK (CCR).
- (2) CENTRAL CONTROL RACK (CCR), PROVIDED BY OTHER.
- PROVIDE (N) IFP W/ READER, INPUT, OUTPUT MODULES AND POWER SUPPLY AS REQUIRED FOR THIS PROJECT.
- 4 EXTEND 120VAC TO NEW IFP.
- $\langle 5 \rangle$  (E) CAT 6 PATCH CORD.
- 6 CAT 6, ONE (1) PER CAMERA (TYP).
- $\langle 7 \rangle$  (E) IPATCH HORIZONTAL, SYSTIMAX 360 48 PORT PATCH PANEL.
- $\langle 8 \rangle$  NOT USED.
- $\langle$  9 angle (E) 48 PORT NETWORK SWITCH.
- $\langle 10 \rangle$  COMPOSITE ACCESS CONTROL CABLE.
- $\langle$ 11angle 1 PAIR 22 AWG SHIELDED ALARM CABLE.
- TERMINATE CAMERAS AND (N) IFP IN THIS NETWORK SWITCH. COORDINATE PORTS ASSIGNMENT AND IP ADDRESSES W/ HAS IT.
- PROVIDE SIXTEEN (16) CAT 6 CABLES BETWEEN (E) HAS NETWORK SWITCH AND CCR FOR NETWORK CONNECTIVITY. COORDINATE WITH HAS IT FOR NETWORK PORTS ASSIGNMENT AND IP ADDRESS.
- PROVIDE 120VAC 20A POWER CIRCUIT FOR CCR (BY DIV 26, ELECTRICAL).

**AIRPORTS** 

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**ISSUE FOR REVIEW** 

DRAWING HISTORY 
 №.
 DATE
 DESCRIPTION

 1
 09-09-21
 FOR INFORMATION AND REFERENCE ONLY

PROJECT NAME **HOU-TERMINAL** - SECURITY **EXIT LANE** 

PROJECT LOCATION **WILLIAM HOBBY** HOU 7800 AIRPORT BLVD. HOUSTON, TX 77061

PROJECT NUMBER


1004345


SHEET TITLE

**ENLARGED PLAN** AT IDF 100.14

SHEET NUMBER

MONITORED AUTO FOLDING DOOR NTS (2)

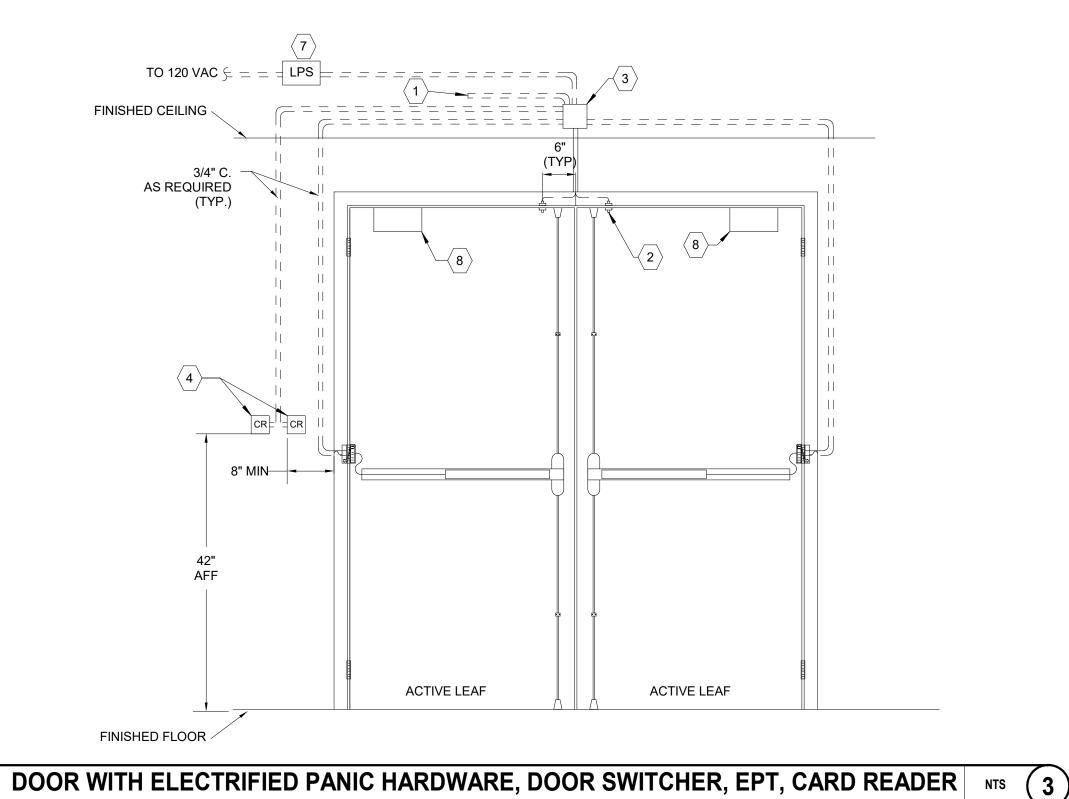

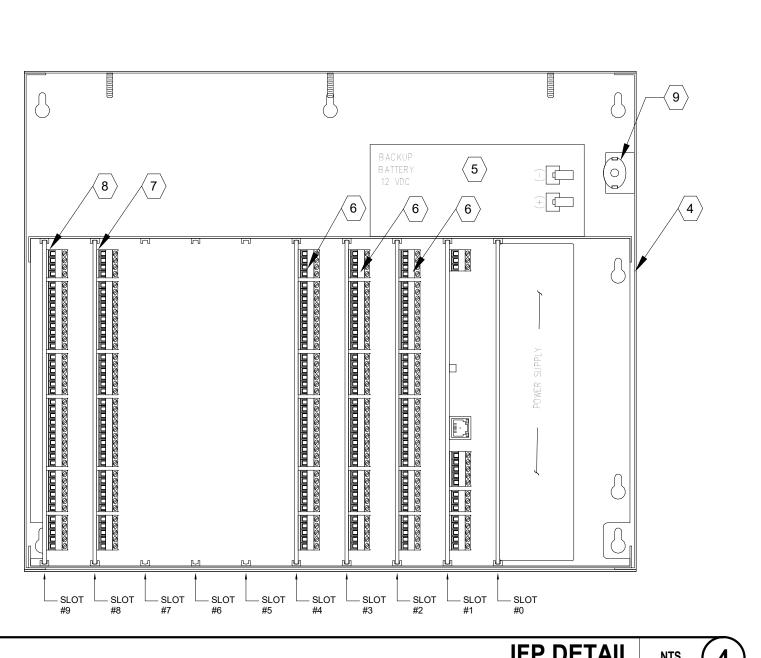

- 1. VIEW SHOWN IS FROM SECURED SIDE OF PORTAL. CONDUIT BOXED AND EQUIPMENT SHALL BE MOUNTED ON SECURED SIDE OF PORTAL, UNLESS OTHERWISE NOTED.
- 2. CONDUITS MAY BE COMBINED, IF COMBINED, CONTRACTOR SHALL ENSURE CONDUIT IS SIZED TO ACCEPT REQUIRED CONDUCTORS PER NEC.
- 3. COORDINATE MOUNTING LOCATIONS, ROUGH-IN AND FINISHES WITH THE
- 4. CONDUIT SHALL BE CONCEALED UNLESS OTHERWISE NOTED.
- 5. DOOR HARDWARE SHOWN FOR REFERENCE ONLY. TYPE OF HARDWARE MAY VARY. ALL DOOR HARDWARE SHALL HAVE KEY CYLINDER UNLESS NOTED OTHERWISE. DOOR HARDWARE BY DIV.8.
- 6. PROVIDE CONDUIT ONLY WHERE WIRING CANNOT ROUTE IN DOOR FRAME.
- 7. ALL SECURITY DOORS SHALL HAVE DOOR CLOSER.
- 8. COORDINATE WITH HAS FOR ADDRESSING SCHEME.
- 9. PROVIDE PATCH CABLE (CAT 6) FOR CONNECTIVITY TO THE NEAREST
- 10. CONFIGURE THE INTELLIGENT CONTROLLER (IC) TO BE ABLE TO DETECT STATIC IP AUTOMATICALLY.
- 11. PROVIDE BATTERY BACKUP TO SUPPORT FULL LOAD FOR 4 HOURS.
- 12. SUBMIT PROGRAMMING WORK SHEETS AS GENERAL SUBMITTAL REQUEST FROM HAS IT.
- 13. PROVIDE ADDITIONAL PANEL ENCLOSURE AND MODULE TO MEET REQUIREMENTS OF PROJECT.
- 14. PROVIDE FIRE ALARM RELAY AS REQUIRED FOR AUTO DOOR.

#### **KEY NOTES:**

- $\langle$  1  $\rangle$  1"C. TO NEAREST IDF. TERMINATE CABLES IN IFP.
- DOOR POSITION SWITCH, FLUSH MOUNT.
- MOUNT 4S J-BOX 6" AFC. OR AS APPROVED BY THE OWNER.
- PROVIDE FIELD PANEL ENCLOSURE WITH POWER SUPPLY AND BATTERY BACK UP. THE FIRST FIELD PANEL SHALL HAVE THE INTELLIGENT CONTROLLED MOUNTED TO SLOT #1.
- (5) BATTERY BACKUP SHALL BE SIZED TO CARRY FULL LOAD FOR FOUR (4)
- $\langle 6 \rangle$  DUAL READER MODULE. PROVIDE DUAL READER MODULES AS NECESSARY FOR THE PROJECT.
- $\langle$  7  $\rangle$  PROVIDE INPUT MODULE IN SLOT 8. QTY AS REQUIRED FOR PROJECT.
- PROVIDE OUTPUT MODULE IN SLOT 9. QTY AS REQUIRED FOR PROJECT.
- 9 TAMPER SWITCH
- $\langle 10 \rangle$  DOOR CLOSER

**GENERAL NOTES:** 

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PROJECT NAME **HOU-TERMINAL** - SECURITY

**EXIT LANE** PROJECT LOCATION

**WILLIAM HOBBY** HOU 7800 AIRPORT BLVD. HOUSTON, TX 77061

PROJECT NUMBER 1004345

SHEET TITLE


DOOR AND IFP **DETAILS** 

SHEET NUMBER

TY500

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TYPICAL CAMERA MOUNTING OPTION 1 - CEILING MOUNT FOR HD OR PTZ CAMERA NTS (1)

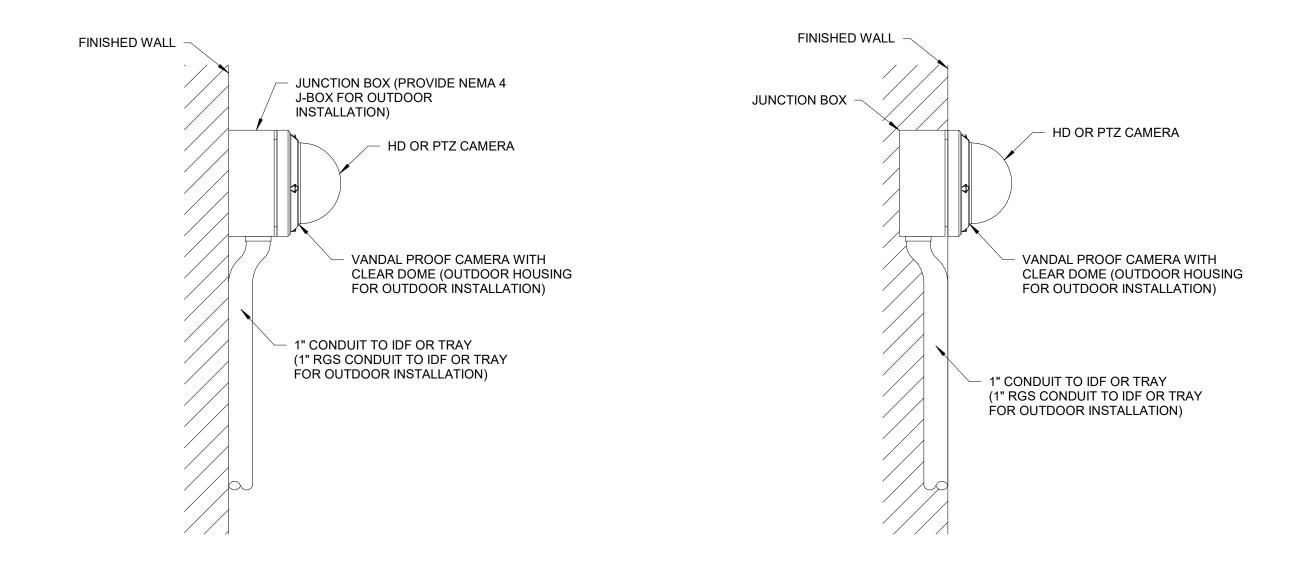

TYPICAL CAMERA MOUNTING OPTION 2 - WALL MOUNT FOR HD OR PTZ CAMERA NTS (2)

2)

ASTON AIRPORT SYSTEM
RECTOR OR DESIGN REPRESENTATIVE

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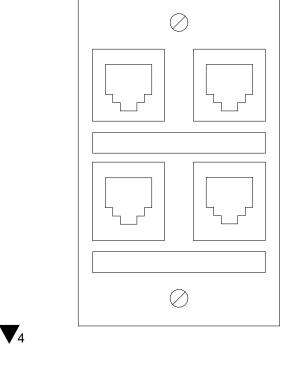
CAMERA DETAILS

SHEET NUMBER

TY501

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WORK AREA OUTLET (2) NTS 1



WORK AREA OUTLET (4) NTS (2)

CABLE LABEL WALL PLATE -END OF CABLE - CABLE LABEL - CABLE SHALL TERMINATE IN THE BACKSIDE OF THE PATCH PANEL AT THE INDICATED PORT (020).

COMMUNICATIONS CABLE LABELING NTS 3

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TELECOM DETAILS

SHEET NUMBER