


- 1. FOR PAVEMENT JOINT TYPES AND REINFORCEMENT PLAN, SEE SHEETS CP701-P1 THROUGH CP710-P6.
- 2. FOR PAVEMENT TYPICAL SECTIONS, SEE SHEETS CS001 THROUGH
- 3. FOR GEOMETRIC LAYOUT, SEE SHEETS CS101-P1 THROUGH
- 4. ALL PAVEMENT JOINTS SHALL MATCH INTO EXISTING PAVEMENT JOINTS AT TIE-IN LOCATIONS.
- THE CONTRACTOR SHALL SUBMIT A PROPOSED PAVING PLAN TO THE ENGINEER FOR APPROVAL. DOWELS SHALL BE INSTALLED IN ALL CONSTRUCTION JOINTS IN ACCORDANCE WITH SPECIFICATION P-501. INTERIOR SLAB LOCATIONS SHOWN WITH A DOWELED CONSTRUCTION JOINT MAY BE MODIFIED TO A DOWELED
- CLEAN UP OF WASTE MATERIAL SHALL BE CONTINUOUS DURING THE JOINT SAWCUTTING OPERATION. CLEAN UP SHALL USE A VACUUM
- 7. THE CONTRACTOR SHALL LOCATE AND PROTECT ALL UTILITIES AND PAVED AREAS TO REMAIN. ALL UTILITIES ARE TO REMAIN, UNLESS OTHERWISE NOTED. DEMOLITION ACTIVITIES SHALL BE CAREFULLY CONTROLLED TO PREVENT DAMAGE TO ADJACENT CONCRETE PAVEMENT, THE UNDERLYING MATERIAL, OR EXISTING STRUCTURES TO REMAIN IN-PLACE. ANY DAMAGE TO EXISTING STRUCTURES OR PAVEMENT SHALL BE IMMEDIATELY REPORTED TO REPRESENTATIVE AND REPAIRED WITH APPROVED MATERIALS AND PROCEDURES AT THE CONTRACTORS EXPENSE.
- 8. CARE SHALL BE TAKEN NOT TO UNDERMINE THE EXISTING PAVEMENT TO REMAIN.
 - STRUCTURES AND LIGHTS SHOWN ARE FOR REFERENCE ONLY. SEE RESPECTIVE SHEETS FOR DETAILED DESIGN INFORMATION AND

LEGEND:

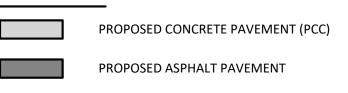

EXISTING PAVEMENT

REINFORCED PCC (CP502) PCC PAVEMENT JOINT - TYPE A (THICKENED EDGE ISOLATION)

PCC PAVEMENT JOINT - TYPE AG (THICKENED EDGE ISOLATION)

CP501

CP501

CP501

CP501

(CP503)

PCC PAVEMENT JOINT - TYPE A1 (REINFORCED ISOLATION)

PCC PAVEMENT JOINT - TYPE C (DOWELED CONTRACTION)

> (DOWELED CONSTRUCTION) PCC PAVEMENT JOINT - TYPE G

PCC ROADWAY JOINT - TYPE E1


PCC PAVEMENT JOINT - TYPE E

(JOINT BETWEEN PCC & HMA) PCC ISOLATION JOINT - TYPE AG1

———— ASPHALT PAVEMENT GRID

EXISTING PAVEMENT JOINT PROPOSED GEOMETRY OUTSIDE OF CURRENT PHASE (FOR REFERENCE ONLY)

PROPOSED AIRFIELD BASE CAN FIXTURE, SEE NOTE 9

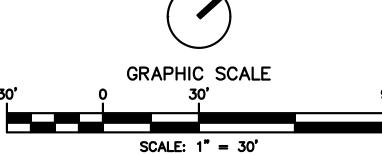



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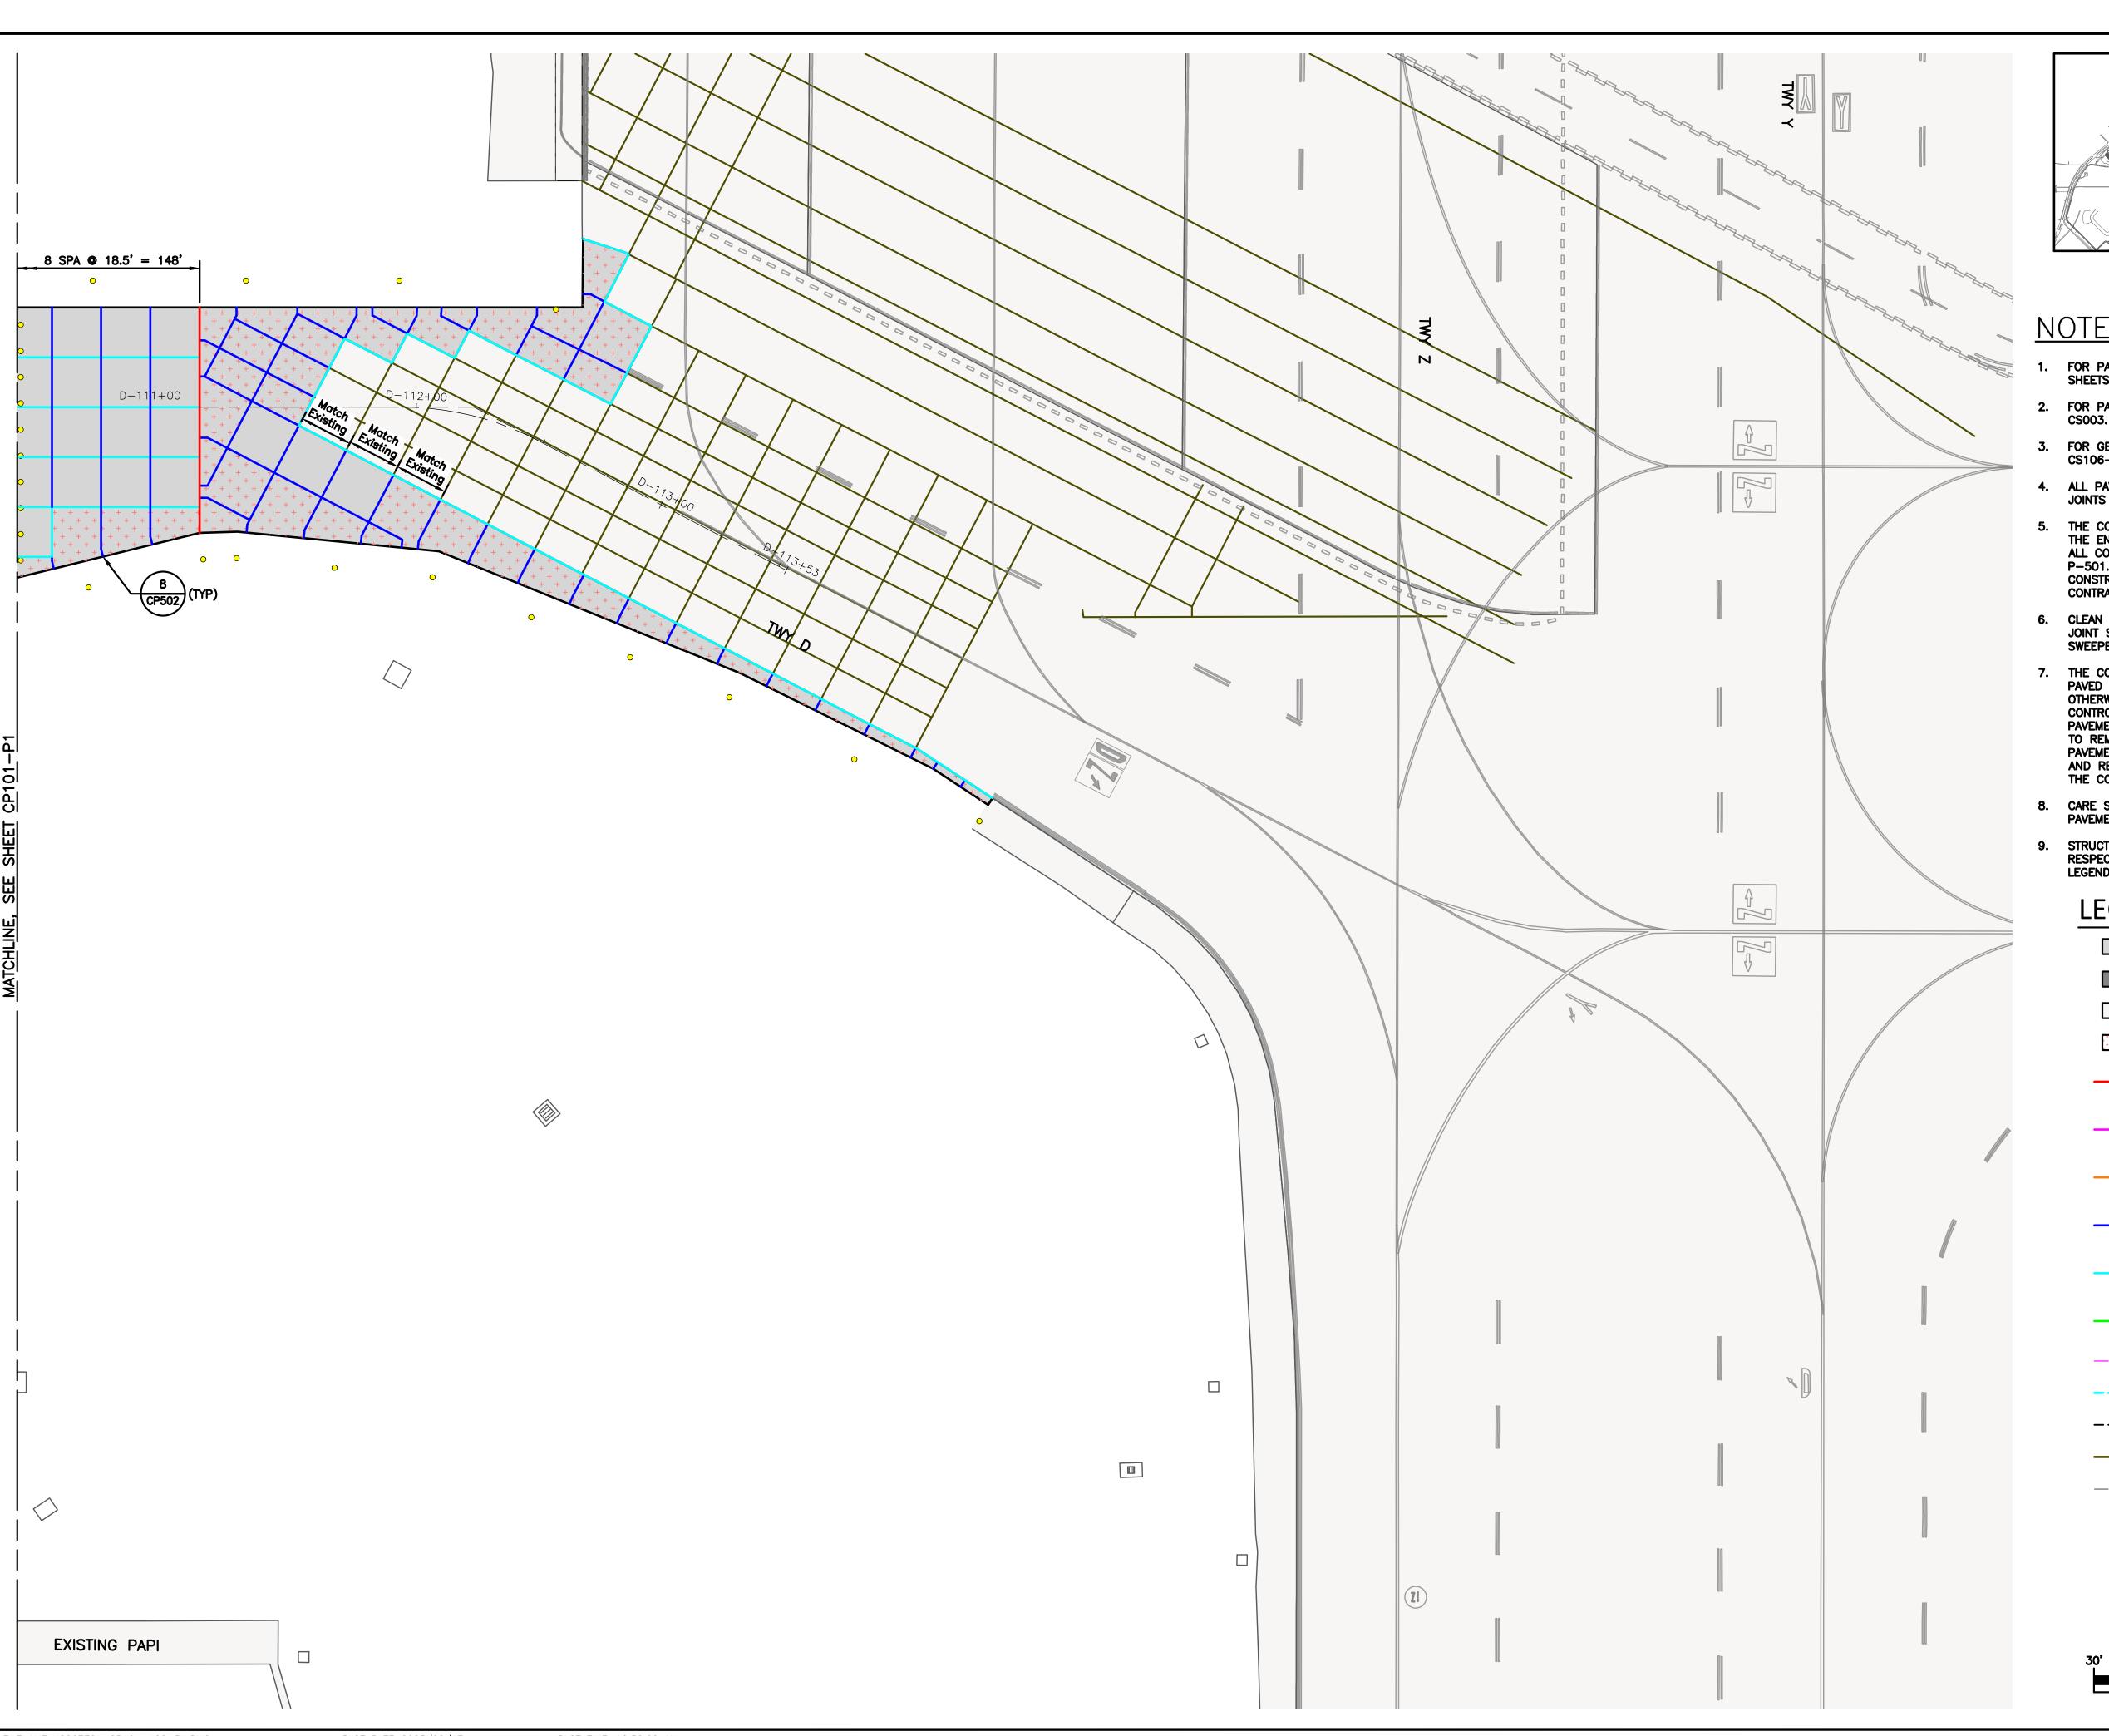
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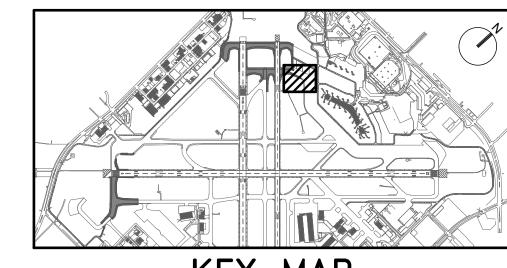
PROJECT MGR: S. CHILDERS **DESIGNER:** D. CRAWFORD DRAWN BY: C. MCLAIN R. EHTESHAM CHECKED BY: AS SHOWN SCALE: 02/24/2023



APPROVED BY: PROJECT NO: 770 C.I.P. NO: 3-48-0110-044

H.A.S. NO: SHEET NO:






NOTES:

- FOR PAVEMENT JOINT TYPES AND REINFORCEMENT PLAN, SEE SHEETS CP701-P1 THROUGH CP710-P6.
- 2. FOR PAVEMENT TYPICAL SECTIONS, SEE SHEETS CS001 THROUGH
- 3. FOR GEOMETRIC LAYOUT, SEE SHEETS CS101-P1 THROUGH
- 4. ALL PAVEMENT JOINTS SHALL MATCH INTO EXISTING PAVEMENT JOINTS AT TIE-IN LOCATIONS.
- THE CONTRACTOR SHALL SUBMIT A PROPOSED PAVING PLAN TO THE ENGINEER FOR APPROVAL. DOWELS SHALL BE INSTALLED IN ALL CONSTRUCTION JOINTS IN ACCORDANCE WITH SPECIFICATION P-501. INTERIOR SLAB LOCATIONS SHOWN WITH A DOWELED CONSTRUCTION JOINT MAY BE MODIFIED TO A DOWELED CONTRACTION JOINT, WITH APPROVAL OF THE ENGINEER.
- 6. CLEAN UP OF WASTE MATERIAL SHALL BE CONTINUOUS DURING THE JOINT SAWCUTTING OPERATION. CLEAN UP SHALL USE A VACUUM
- 7. THE CONTRACTOR SHALL LOCATE AND PROTECT ALL UTILITIES AND PAVED AREAS TO REMAIN. ALL UTILITIES ARE TO REMAIN, UNLESS OTHERWISE NOTED. DEMOLITION ACTIVITIES SHALL BE CAREFULLY CONTROLLED TO PREVENT DAMAGE TO ADJACENT CONCRETE PAVEMENT, THE UNDERLYING MATERIAL, OR EXISTING STRUCTURES TO REMAIN IN-PLACE. ANY DAMAGE TO EXISTING STRUCTURES OR PAVEMENT SHALL BE IMMEDIATELY REPORTED TO REPRESENTATIVE AND REPAIRED WITH APPROVED MATERIALS AND PROCEDURES AT THE CONTRACTORS EXPENSE.
- 8. CARE SHALL BE TAKEN NOT TO UNDERMINE THE EXISTING PAVEMENT TO REMAIN.
- 9. STRUCTURES AND LIGHTS SHOWN ARE FOR REFERENCE ONLY. SEE RESPECTIVE SHEETS FOR DETAILED DESIGN INFORMATION AND LEGEND.

LEGEND:

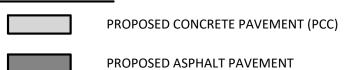

EXISTING PAVEMENT

REINFORCED PCC (CP502) PCC PAVEMENT JOINT - TYPE A (THICKENED EDGE ISOLATION)

PCC PAVEMENT JOINT - TYPE AG (THICKENED EDGE ISOLATION)

CP501

CP501

CP501

(CP503)

PCC PAVEMENT JOINT - TYPE A1 (REINFORCED ISOLATION)

PCC PAVEMENT JOINT - TYPE C (DOWELED CONTRACTION)

> PCC PAVEMENT JOINT - TYPE E (DOWELED CONSTRUCTION) (JOINT BETWEEN PCC & HMA)


PCC PAVEMENT JOINT - TYPE G PCC ISOLATION JOINT - TYPE AG1

PCC ROADWAY JOINT - TYPE E1 **————** ASPHALT PAVEMENT GRID

EXISTING PAVEMENT JOINT

PROPOSED GEOMETRY OUTSIDE OF CURRENT PHASE (FOR REFERENCE ONLY)

PROPOSED AIRFIELD BASE CAN FIXTURE, SEE NOTE 9

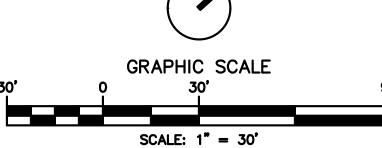



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PROJECT MGR: **DESIGNER:** DRAWN BY: CHECKED BY: AS SHOWN \= SCALE: 02/24/2023



APPROVED BY: DATE:


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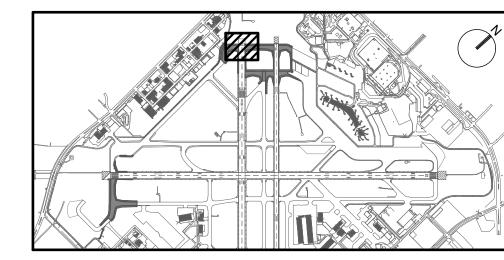
770 C.I.P. NO: 3-48-0110-044

H.A.S. NO: SHEET NO:

PLOT TIME: 10:52:00 AM FILENAME: H22C770A-CP101-102-P1.DWG

PLOT DATE: 2023/02/17



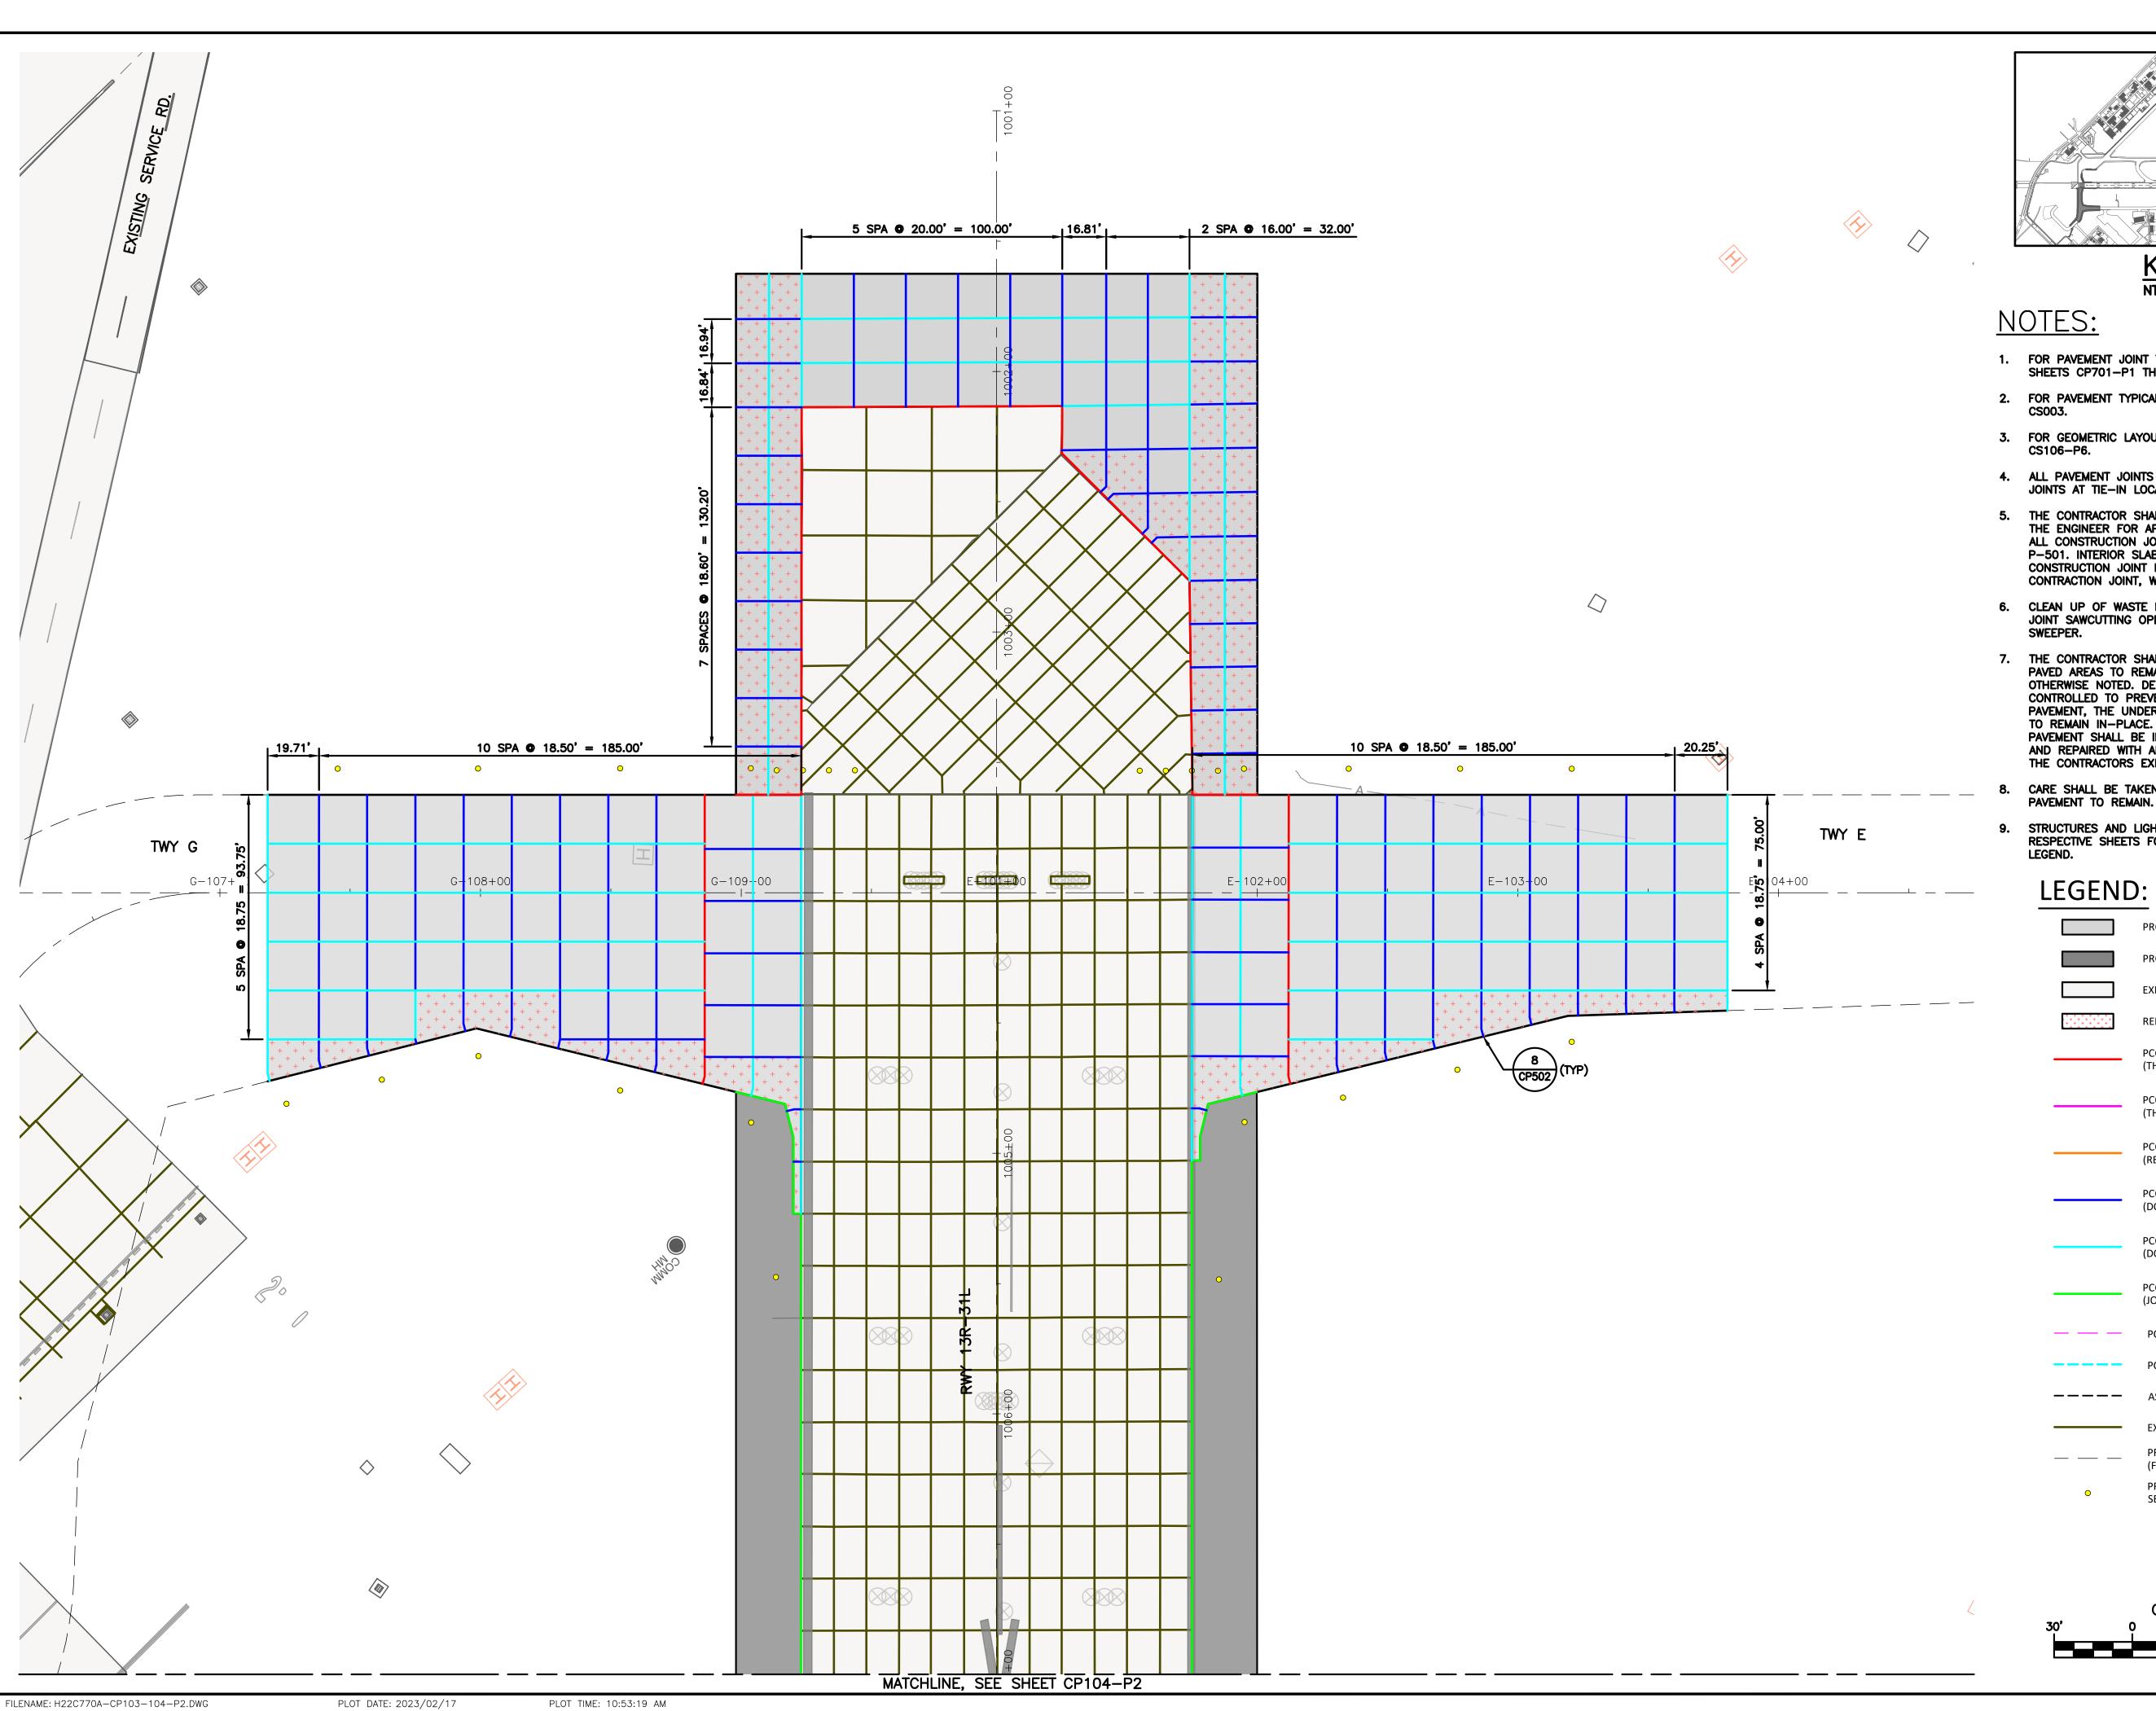

- 1. FOR PAVEMENT JOINT TYPES AND REINFORCEMENT PLAN, SEE SHEETS CP701-P1 THROUGH CP710-P6.
- 2. FOR PAVEMENT TYPICAL SECTIONS, SEE SHEETS CS001 THROUGH
- 3. FOR GEOMETRIC LAYOUT, SEE SHEETS CS101-P1 THROUGH
- 4. ALL PAVEMENT JOINTS SHALL MATCH INTO EXISTING PAVEMENT JOINTS AT TIE-IN LOCATIONS.
- 5. THE CONTRACTOR SHALL SUBMIT A PROPOSED PAVING PLAN TO THE ENGINEER FOR APPROVAL. DOWELS SHALL BE INSTALLED IN ALL CONSTRUCTION JOINTS IN ACCORDANCE WITH SPECIFICATION P-501. INTERIOR SLAB LOCATIONS SHOWN WITH A DOWELED CONSTRUCTION JOINT MAY BE MODIFIED TO A DOWELED CONTRACTION JOINT, WITH APPROVAL OF THE ENGINEER.
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- 8. CARE SHALL BE TAKEN NOT TO UNDERMINE THE EXISTING
- 9. STRUCTURES AND LIGHTS SHOWN ARE FOR REFERENCE ONLY. SEE RESPECTIVE SHEETS FOR DETAILED DESIGN INFORMATION AND LEGEND.

PROPOSED CONCRETE PAVEMENT (PCC) PROPOSED ASPHALT PAVEMENT

EXISTING PAVEMENT

REINFORCED PCC (CP502) PCC PAVEMENT JOINT - TYPE A (THICKENED EDGE ISOLATION)

> PCC PAVEMENT JOINT - TYPE AG (THICKENED EDGE ISOLATION)

CP501

CP501

CP501

CP501

(CP503)

PCC PAVEMENT JOINT - TYPE A1 (REINFORCED ISOLATION)

PCC PAVEMENT JOINT - TYPE C (DOWELED CONTRACTION)

(DOWELED CONSTRUCTION)

PCC PAVEMENT JOINT - TYPE E

PCC PAVEMENT JOINT - TYPE G (JOINT BETWEEN PCC & HMA) PCC ISOLATION JOINT - TYPE AG1

EXISTING PAVEMENT JOINT


PCC ROADWAY JOINT - TYPE E1

———— ASPHALT PAVEMENT GRID

PROPOSED GEOMETRY OUTSIDE OF CURRENT PHASE (FOR REFERENCE ONLY)

PROPOSED AIRFIELD BASE CAN FIXTURE, SEE NOTE 9



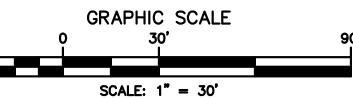

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TAXIWAY

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PROJECT MGR: S. CHILDERS D. CRAWFORD C. MCLAIN R. EHTESHAM CHECKED BY:


AS SHOWN

02/24/2023

DESIGNER:

DRAWN BY:

SCALE:

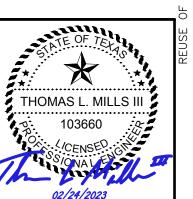


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HOUSTON AIRPORT SYSTEM


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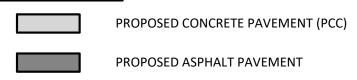
SHEET NO:





- 1. FOR PAVEMENT JOINT TYPES AND REINFORCEMENT PLAN, SEE SHEETS CP701-P1 THROUGH CP710-P6.
- 2. FOR PAVEMENT TYPICAL SECTIONS, SEE SHEETS CS001 THROUGH
- 3. FOR GEOMETRIC LAYOUT, SEE SHEETS CS101-P1 THROUGH
- 4. ALL PAVEMENT JOINTS SHALL MATCH INTO EXISTING PAVEMENT JOINTS AT TIE-IN LOCATIONS.
- 5. THE CONTRACTOR SHALL SUBMIT A PROPOSED PAVING PLAN TO THE ENGINEER FOR APPROVAL. DOWELS SHALL BE INSTALLED IN ALL CONSTRUCTION JOINTS IN ACCORDANCE WITH SPECIFICATION P-501. INTERIOR SLAB LOCATIONS SHOWN WITH A DOWELED CONSTRUCTION JOINT MAY BE MODIFIED TO A DOWELED CONTRACTION JOINT, WITH APPROVAL OF THE ENGINEER.
- 6. CLEAN UP OF WASTE MATERIAL SHALL BE CONTINUOUS DURING THE JOINT SAWCUTTING OPERATION. CLEAN UP SHALL USE A VACUUM
- 7. THE CONTRACTOR SHALL LOCATE AND PROTECT ALL UTILITIES AND PAVED AREAS TO REMAIN. ALL UTILITIES ARE TO REMAIN, UNLESS OTHERWISE NOTED. DEMOLITION ACTIVITIES SHALL BE CAREFULLY CONTROLLED TO PREVENT DAMAGE TO ADJACENT CONCRETE PAVEMENT, THE UNDERLYING MATERIAL, OR EXISTING STRUCTURES TO REMAIN IN-PLACE. ANY DAMAGE TO EXISTING STRUCTURES OR PAVEMENT SHALL BE IMMEDIATELY REPORTED TO REPRESENTATIVE AND REPAIRED WITH APPROVED MATERIALS AND PROCEDURES AT THE CONTRACTORS EXPENSE.
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- STRUCTURES AND LIGHTS SHOWN ARE FOR REFERENCE ONLY. SEE RESPECTIVE SHEETS FOR DETAILED DESIGN INFORMATION AND

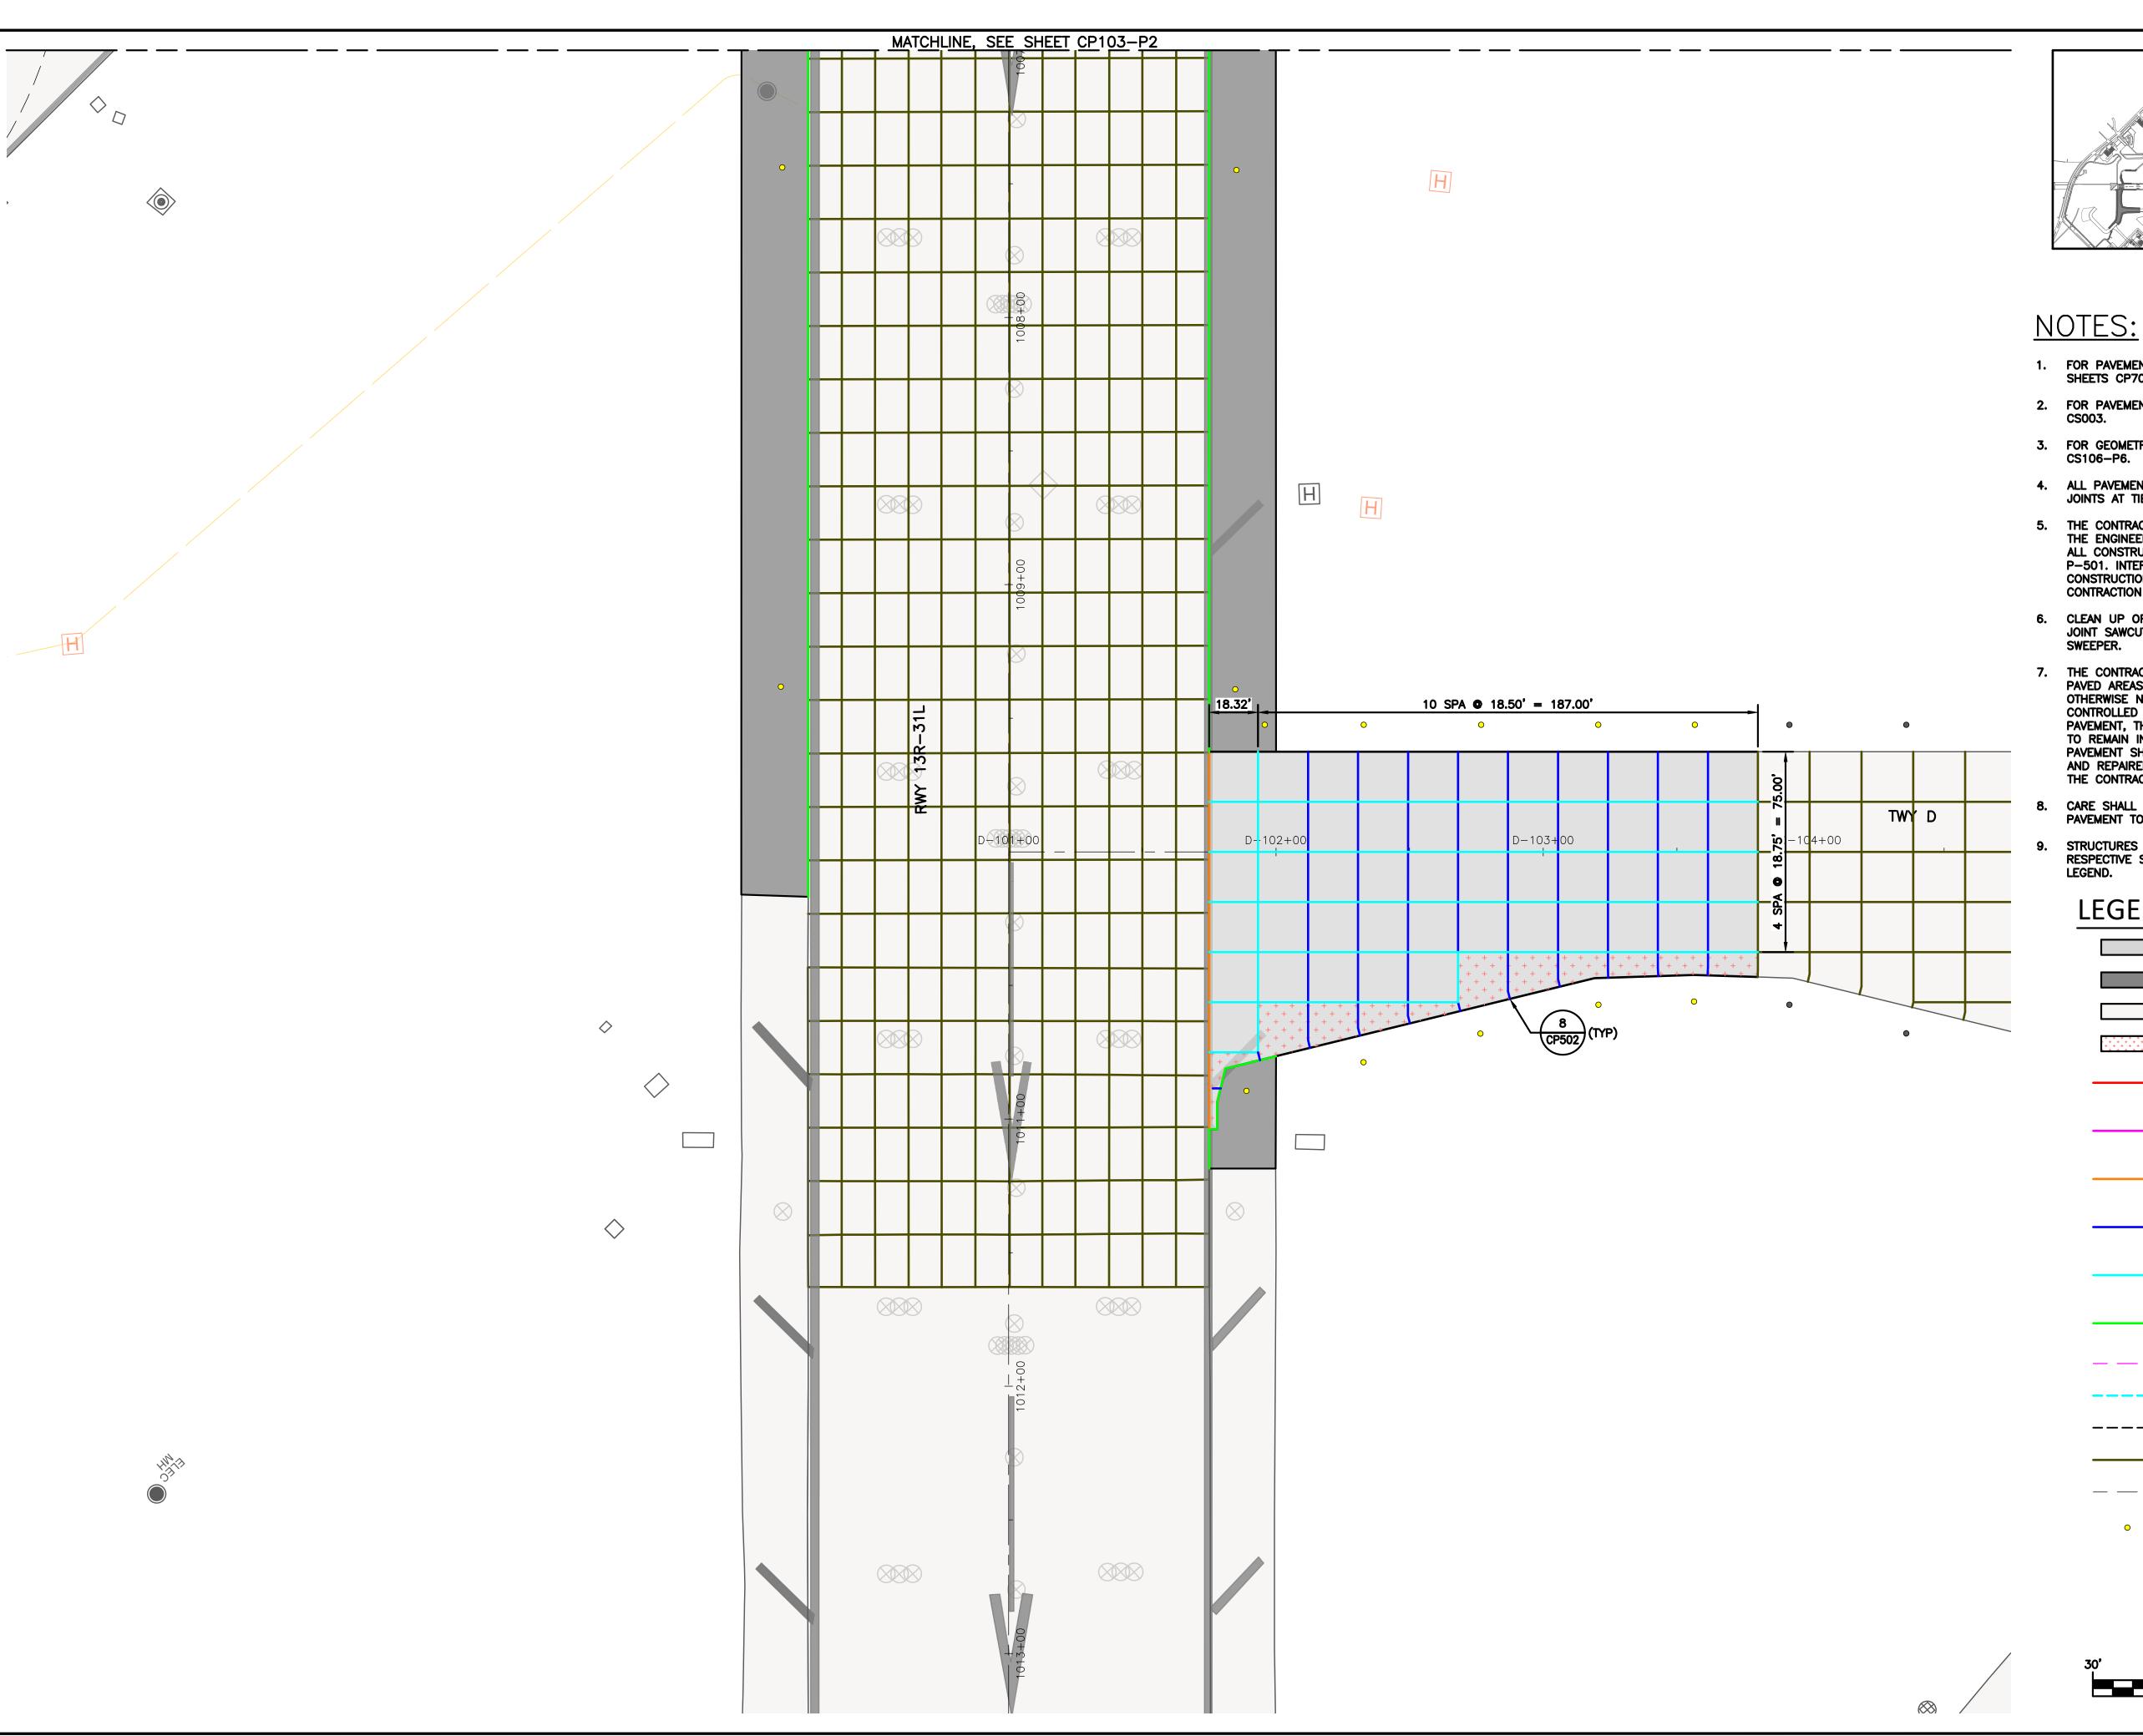LEGEND:

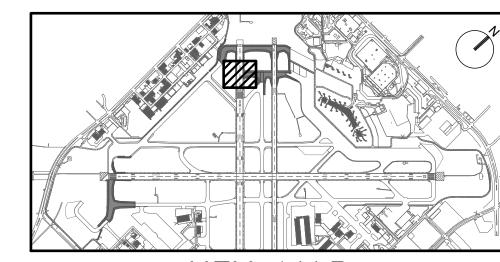

EXISTING PAVEMENT

REINFORCED PCC (CP502) PCC PAVEMENT JOINT - TYPE A (THICKENED EDGE ISOLATION)

PCC PAVEMENT JOINT - TYPE AG

CP501

CP501

CP501

(CP503)

(THICKENED EDGE ISOLATION) PCC PAVEMENT JOINT - TYPE A1

PCC PAVEMENT JOINT - TYPE C (DOWELED CONTRACTION)

(REINFORCED ISOLATION)

PCC PAVEMENT JOINT - TYPE E (DOWELED CONSTRUCTION)


PCC PAVEMENT JOINT - TYPE G (JOINT BETWEEN PCC & HMA)

PCC ISOLATION JOINT - TYPE AG1 PCC ROADWAY JOINT - TYPE E1

———— ASPHALT PAVEMENT GRID EXISTING PAVEMENT JOINT

> PROPOSED GEOMETRY OUTSIDE OF CURRENT PHASE (FOR REFERENCE ONLY)

PROPOSED AIRFIELD BASE CAN FIXTURE, SEE NOTE 9

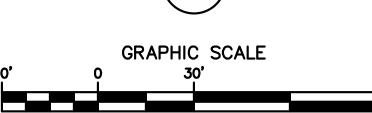

SCALE: 1" = 30'



HOUSTON


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REVISIONS NO. DESCRIPTION DATE BY ISSUED FOR BID 02/24/2023 SC

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PROJECT MGR: S. CHILDERS D. CRAWFORD **DESIGNER:** DRAWN BY: C. MCLAIN R. EHTESHAM CHECKED BY: SCALE: AS SHOWN 02/24/2023



APPROVED BY: DATE: DIRECTOR HOUSTON AIRPORT SYSTEM

PROJECT NO:

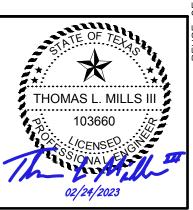
770 C.I.P. NO: 3-48-0110-044


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PLOT DATE: 2023/02/17


PLOT TIME: 10:54:14 AM



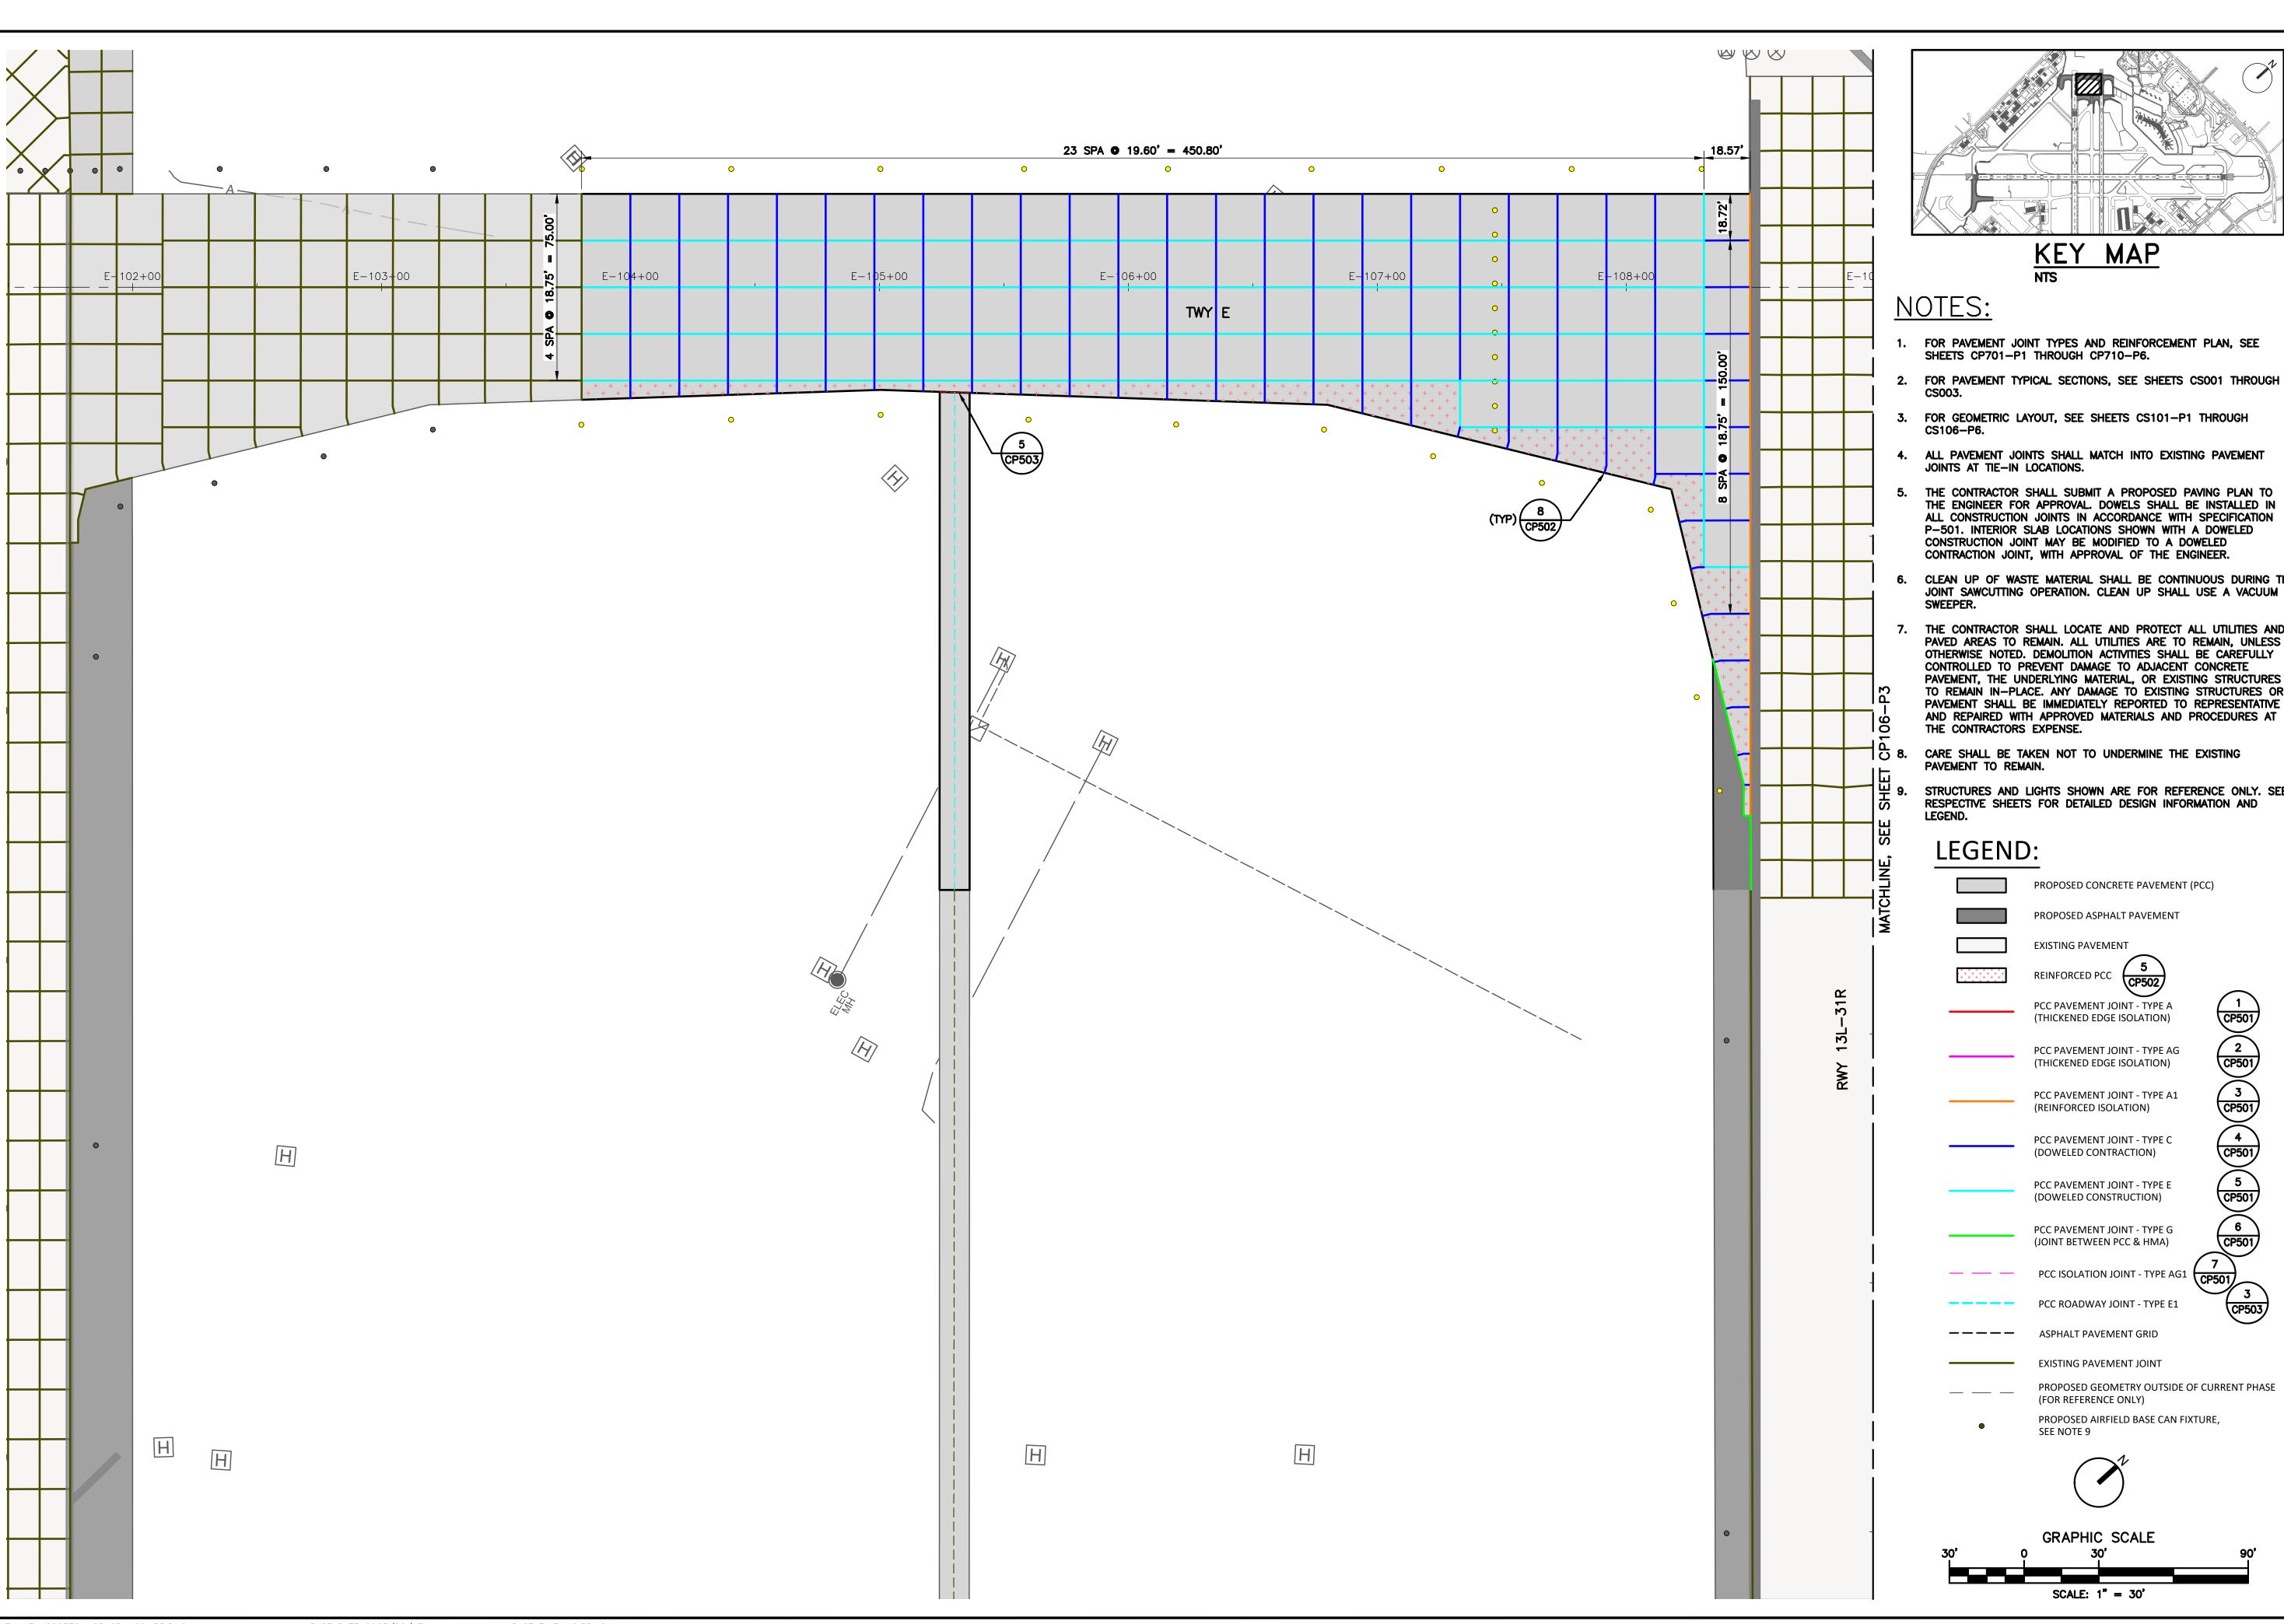

- 1. FOR PAVEMENT JOINT TYPES AND REINFORCEMENT PLAN, SEE SHEETS CP701-P1 THROUGH CP710-P6.
- FOR GEOMETRIC LAYOUT, SEE SHEETS CS101-P1 THROUGH
- 4. ALL PAVEMENT JOINTS SHALL MATCH INTO EXISTING PAVEMENT JOINTS AT TIE-IN LOCATIONS.
- THE CONTRACTOR SHALL SUBMIT A PROPOSED PAVING PLAN TO THE ENGINEER FOR APPROVAL. DOWELS SHALL BE INSTALLED IN ALL CONSTRUCTION JOINTS IN ACCORDANCE WITH SPECIFICATION P-501. INTERIOR SLAB LOCATIONS SHOWN WITH A DOWELED CONSTRUCTION JOINT MAY BE MODIFIED TO A DOWELED CONTRACTION JOINT, WITH APPROVAL OF THE ENGINEER.
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- STRUCTURES AND LIGHTS SHOWN ARE FOR REFERENCE ONLY. SEE RESPECTIVE SHEETS FOR DETAILED DESIGN INFORMATION AND

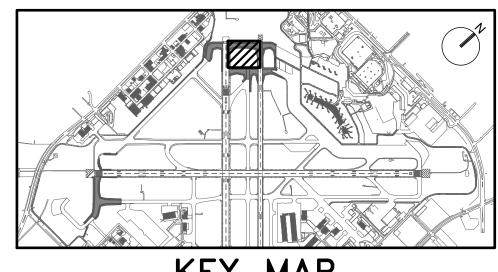LEGEND:

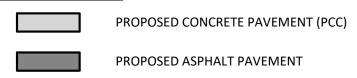

EXISTING PAVEMENT

REINFORCED PCC (CP502) PCC PAVEMENT JOINT - TYPE A (THICKENED EDGE ISOLATION)

PCC PAVEMENT JOINT - TYPE AG (THICKENED EDGE ISOLATION)

CP501

CP501

CP501

(CP503)

PCC PAVEMENT JOINT - TYPE A1 (REINFORCED ISOLATION)

PCC PAVEMENT JOINT - TYPE C (DOWELED CONTRACTION)

PCC PAVEMENT JOINT - TYPE E (DOWELED CONSTRUCTION)


PCC PAVEMENT JOINT - TYPE G (JOINT BETWEEN PCC & HMA) PCC ISOLATION JOINT - TYPE AG1

PCC ROADWAY JOINT - TYPE E1 **————** ASPHALT PAVEMENT GRID

EXISTING PAVEMENT JOINT

PROPOSED GEOMETRY OUTSIDE OF CURRENT PHASE (FOR REFERENCE ONLY)

PROPOSED AIRFIELD BASE CAN FIXTURE, SEE NOTE 9

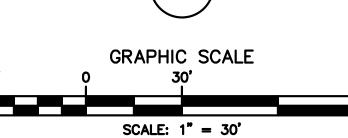

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REVISIONS NO. DESCRIPTION DATE BY

ISSUED FOR BID 02/24/2023 SC

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PROJECT MGR: S. CHILDERS D. CRAWFORD C. MCLAIN R. EHTESHAM CHECKED BY: AS SHOWN

02/24/2023

DESIGNER:

DRAWN BY:

SCALE:





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3-48-0110-044 H.A.S. NO: SHEET NO:

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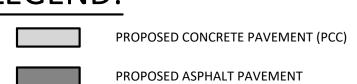
PLOT DATE: 2023/02/17



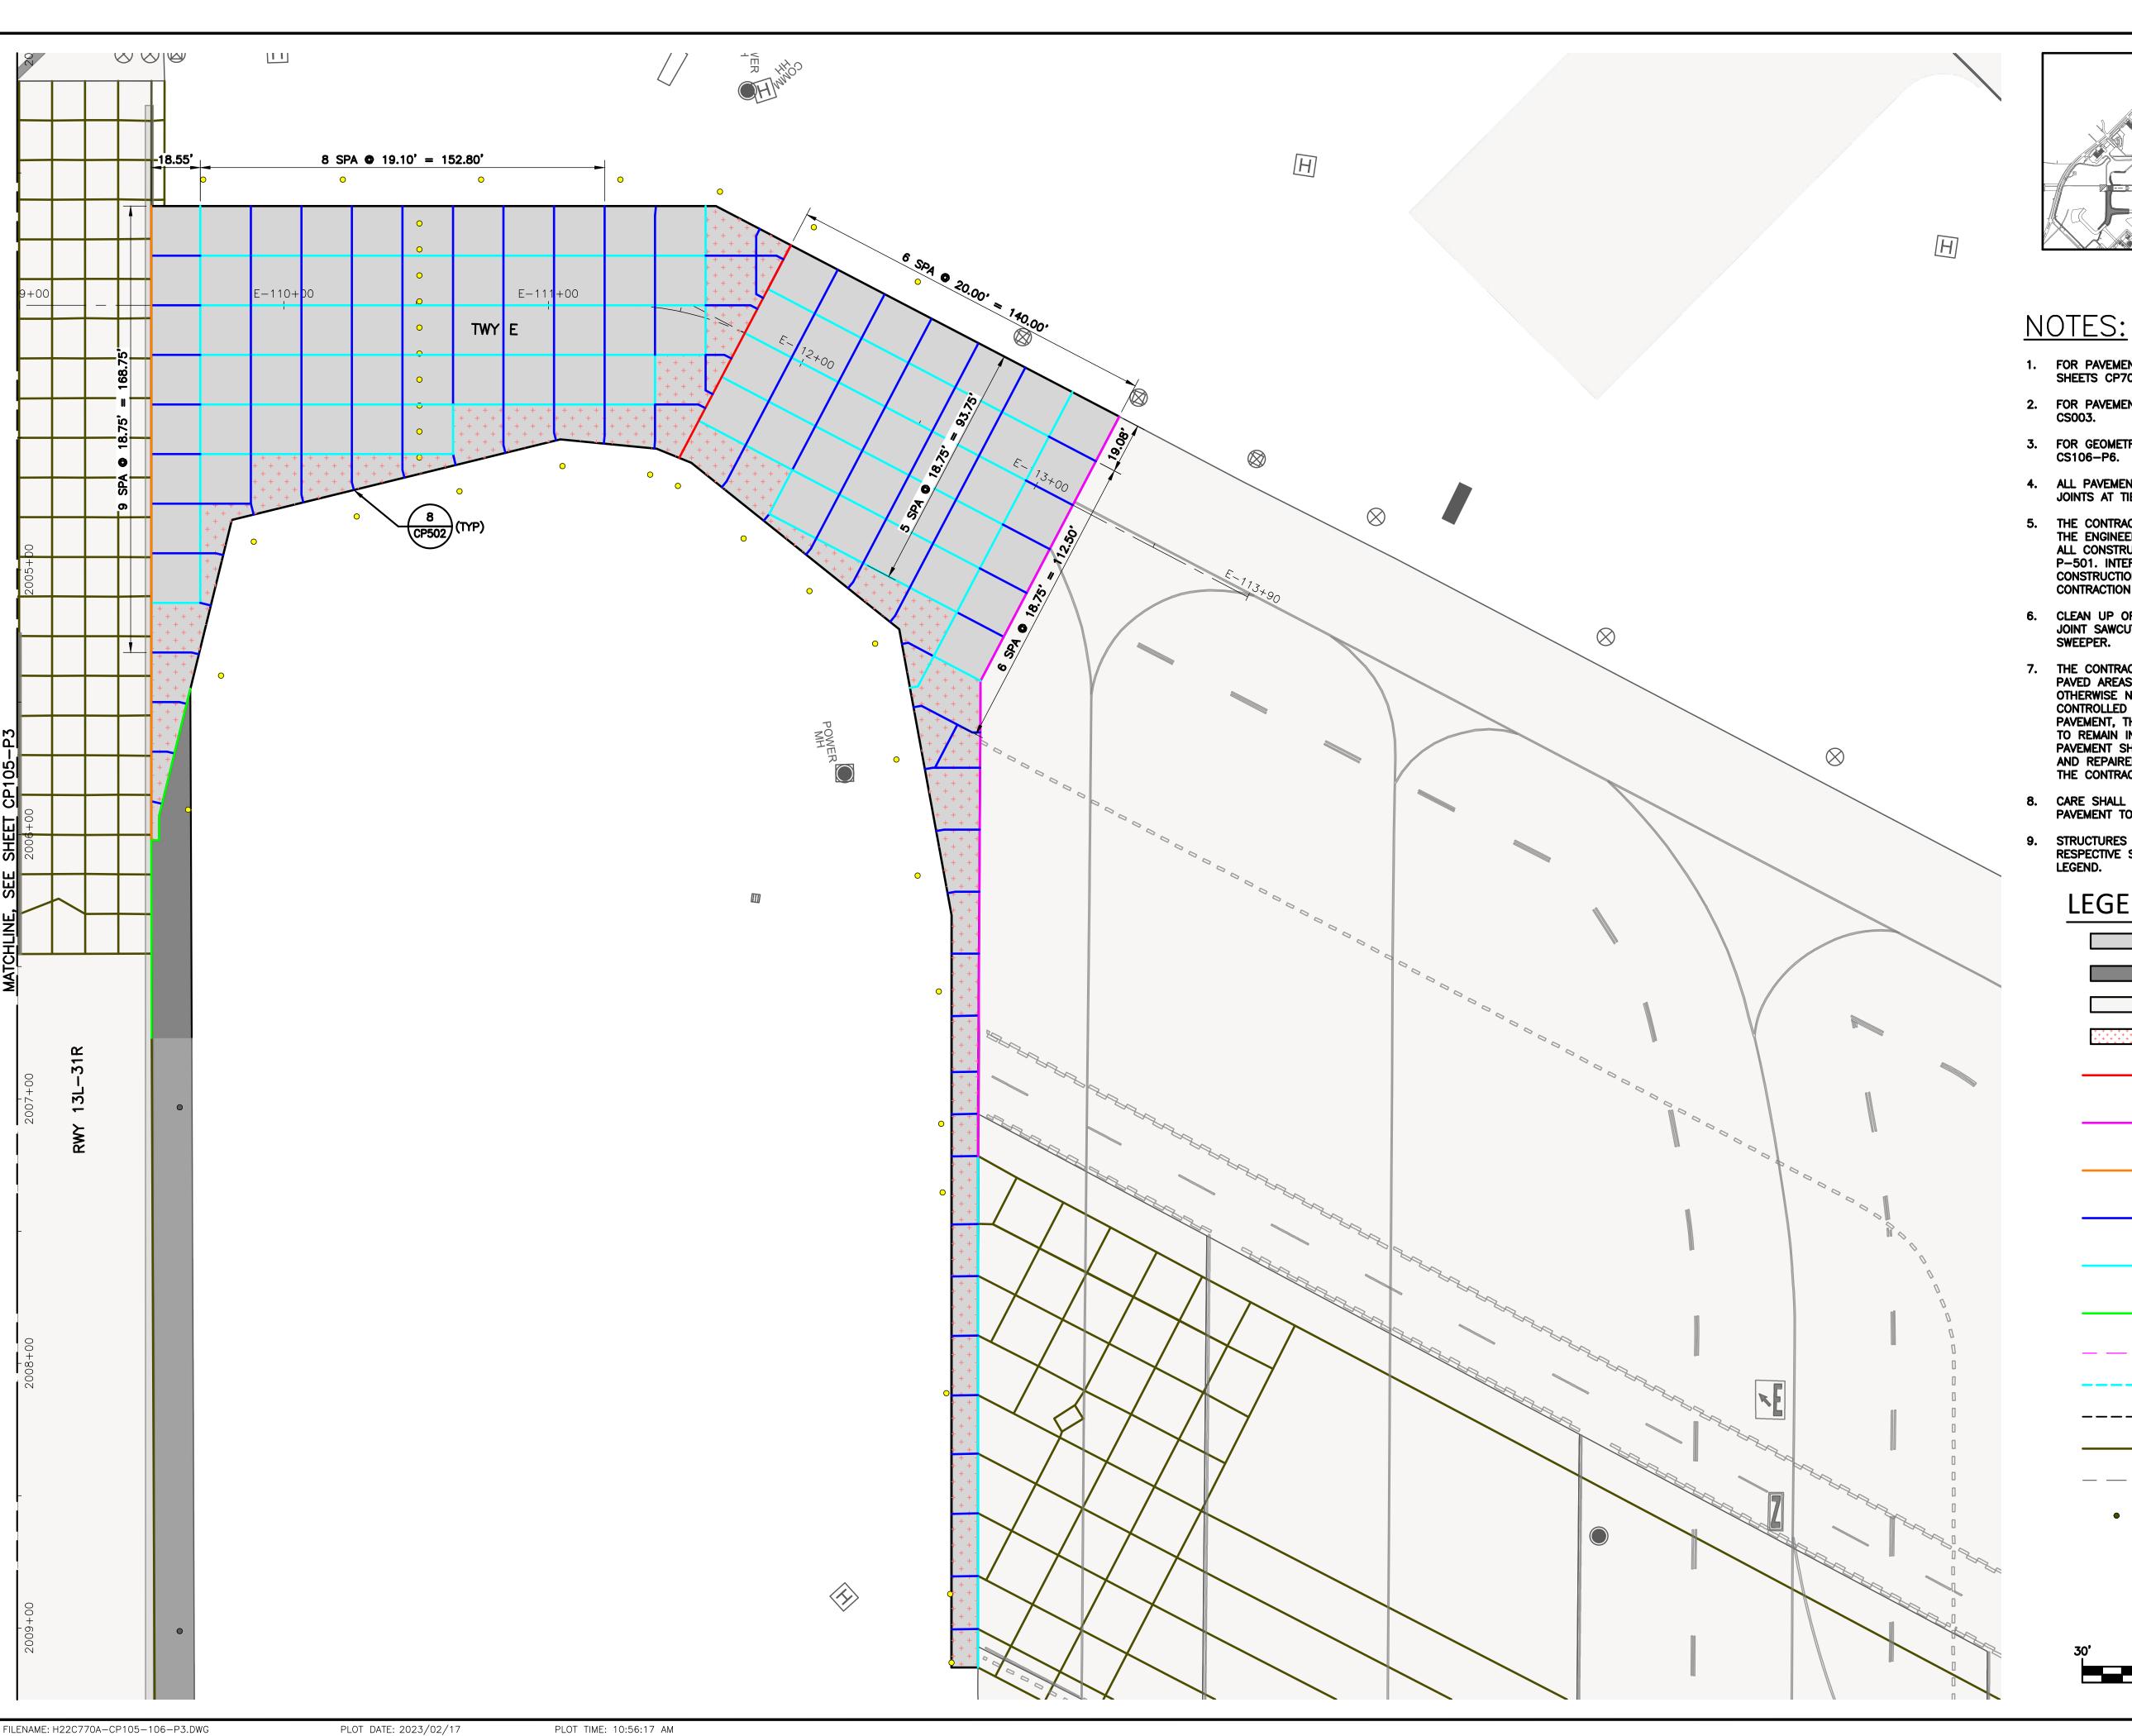

- 1. FOR PAVEMENT JOINT TYPES AND REINFORCEMENT PLAN, SEE SHEETS CP701-P1 THROUGH CP710-P6.
- 2. FOR PAVEMENT TYPICAL SECTIONS, SEE SHEETS CS001 THROUGH
- 3. FOR GEOMETRIC LAYOUT, SEE SHEETS CS101-P1 THROUGH
- 4. ALL PAVEMENT JOINTS SHALL MATCH INTO EXISTING PAVEMENT JOINTS AT TIE-IN LOCATIONS.
- 5. THE CONTRACTOR SHALL SUBMIT A PROPOSED PAVING PLAN TO THE ENGINEER FOR APPROVAL. DOWELS SHALL BE INSTALLED IN ALL CONSTRUCTION JOINTS IN ACCORDANCE WITH SPECIFICATION P-501. INTERIOR SLAB LOCATIONS SHOWN WITH A DOWELED CONSTRUCTION JOINT MAY BE MODIFIED TO A DOWELED CONTRACTION JOINT, WITH APPROVAL OF THE ENGINEER.
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- 8. CARE SHALL BE TAKEN NOT TO UNDERMINE THE EXISTING PAVEMENT TO REMAIN.
- 9. STRUCTURES AND LIGHTS SHOWN ARE FOR REFERENCE ONLY. SEE RESPECTIVE SHEETS FOR DETAILED DESIGN INFORMATION AND

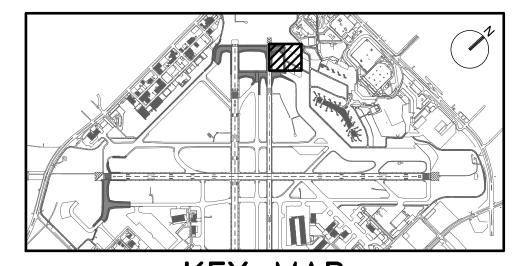LEGEND:



EXISTING PAVEMENT

REINFORCED PCC (CP502)

PCC PAVEMENT JOINT - TYPE A (THICKENED EDGE ISOLATION) PCC PAVEMENT JOINT - TYPE AG

CP501

CP501

CP501

(CP503)

(THICKENED EDGE ISOLATION) PCC PAVEMENT JOINT - TYPE A1

(REINFORCED ISOLATION) PCC PAVEMENT JOINT - TYPE C

(DOWELED CONTRACTION) PCC PAVEMENT JOINT - TYPE E

(DOWELED CONSTRUCTION)


PCC PAVEMENT JOINT - TYPE G (JOINT BETWEEN PCC & HMA)

PCC ISOLATION JOINT - TYPE AG1 PCC ROADWAY JOINT - TYPE E1

———— ASPHALT PAVEMENT GRID

EXISTING PAVEMENT JOINT PROPOSED GEOMETRY OUTSIDE OF CURRENT PHASE (FOR REFERENCE ONLY)

PROPOSED AIRFIELD BASE CAN FIXTURE, SEE NOTE 9

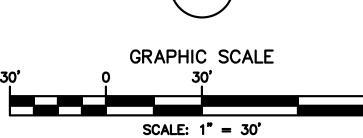



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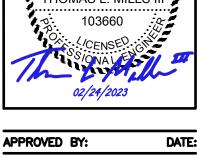
REVISIONS NO. DESCRIPTION DATE BY ISSUED FOR BID 02/24/2023 SC

PROJECT MGR: S. CHILDERS D. CRAWFORD C. MCLAIN

R. EHTESHAM CHECKED BY: SCALE: AS SHOWN 02/24/2023 THOMAS L. MILLS III

DESIGNER:


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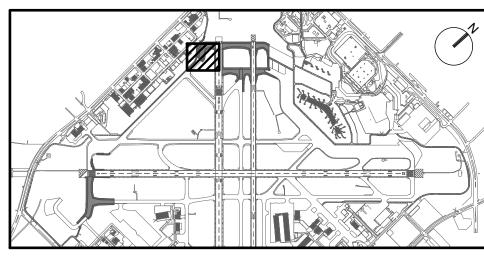


DIRECTOR HOUSTON AIRPORT SYSTEM PROJECT NO: 770

C.I.P. NO: 3-48-0110-044

H.A.S. NO: SHEET NO:



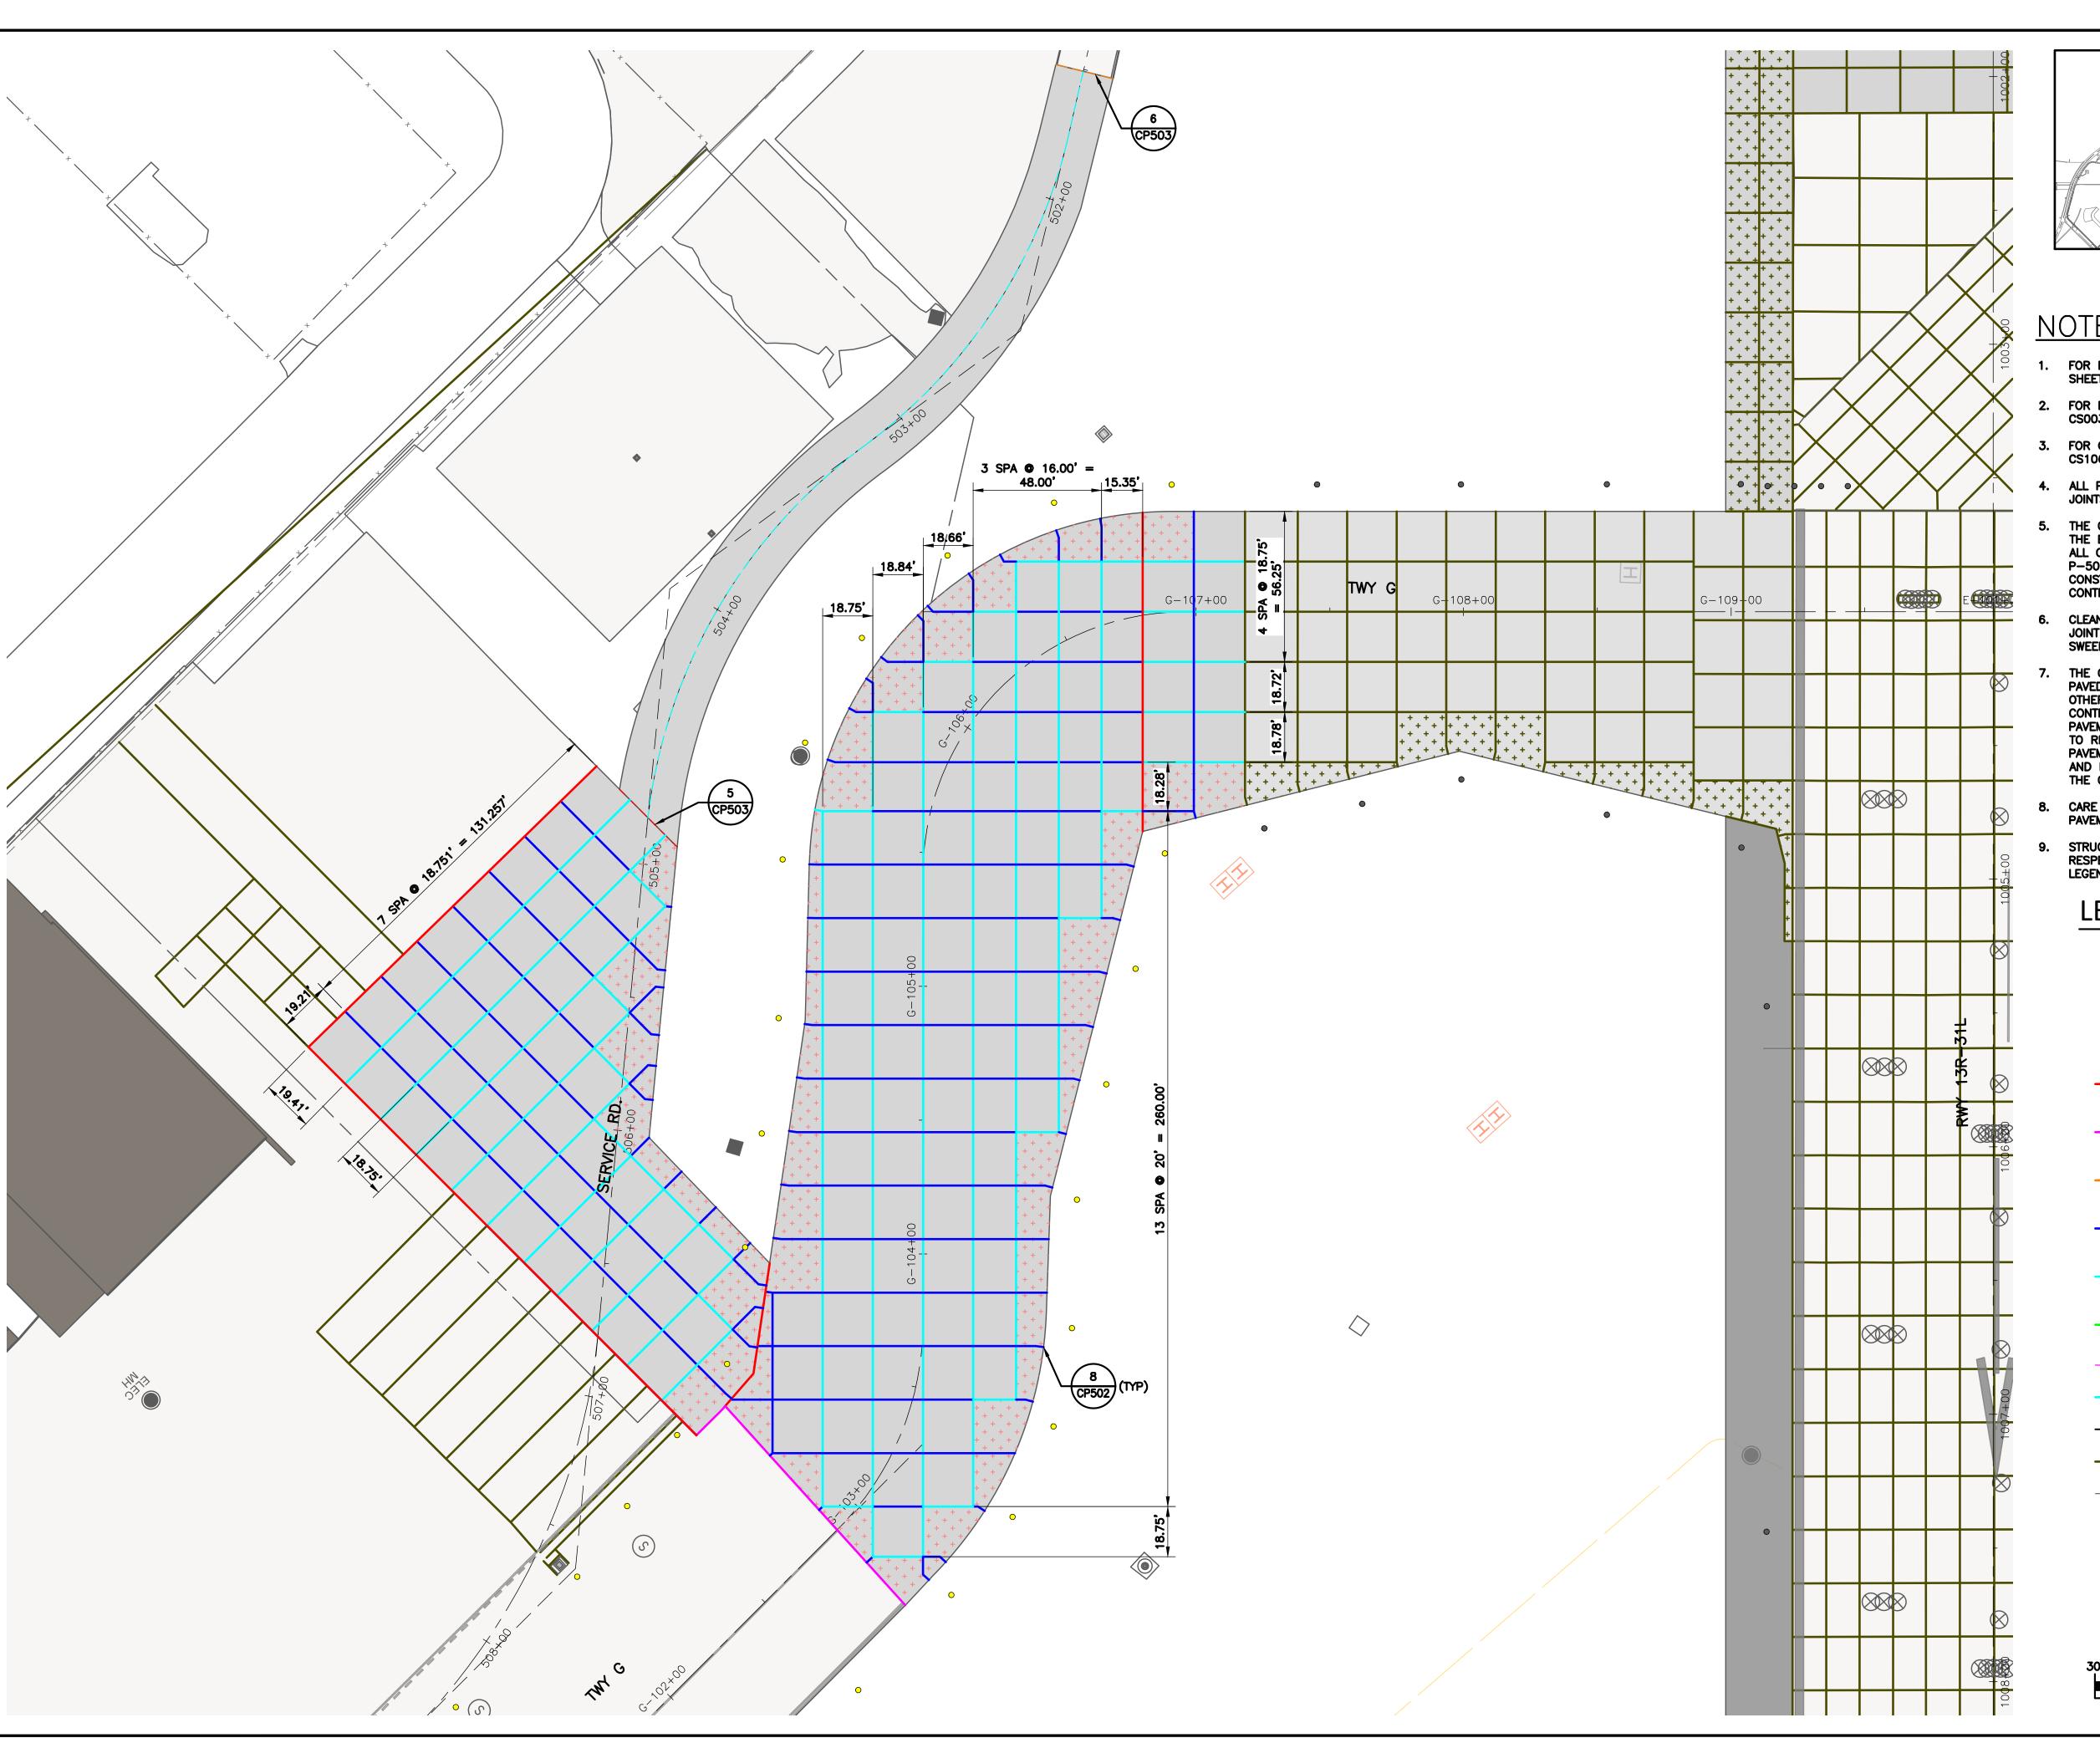

NOTES:

- 1. FOR PAVEMENT JOINT TYPES AND REINFORCEMENT PLAN, SEE SHEETS CP701-P1 THROUGH CP710-P6.
- 2. FOR PAVEMENT TYPICAL SECTIONS, SEE SHEETS CS001 THROUGH
 - FOR GEOMETRIC LAYOUT, SEE SHEETS CS101-P1 THROUGH
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- 8. CARE SHALL BE TAKEN NOT TO UNDERMINE THE EXISTING PAVEMENT TO REMAIN.
- STRUCTURES AND LIGHTS SHOWN ARE FOR REFERENCE ONLY. SEE RESPECTIVE SHEETS FOR DETAILED DESIGN INFORMATION AND LEGEND.

LEGEND:



EXISTING PAVEMENT

REINFORCED PCC (CP502) PCC PAVEMENT JOINT - TYPE A (THICKENED EDGE ISOLATION)

PCC PAVEMENT JOINT - TYPE AG (THICKENED EDGE ISOLATION)

CP501

CP501

CP501

CP501

CP501

(CP503)

PCC PAVEMENT JOINT - TYPE A1 (REINFORCED ISOLATION)

PCC PAVEMENT JOINT - TYPE C (DOWELED CONTRACTION)

(DOWELED CONSTRUCTION) PCC PAVEMENT JOINT - TYPE G (JOINT BETWEEN PCC & HMA)

PCC PAVEMENT JOINT - TYPE E


PCC ISOLATION JOINT - TYPE AG1

PCC ROADWAY JOINT - TYPE E1 **————** ASPHALT PAVEMENT GRID

EXISTING PAVEMENT JOINT

PROPOSED GEOMETRY OUTSIDE OF CURRENT PHASE (FOR REFERENCE ONLY)

PROPOSED AIRFIELD BASE CAN FIXTURE, SEE NOTE 9

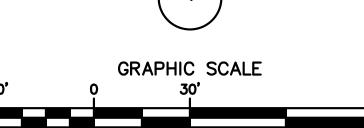

SCALE: 1" = 30'

HOUSTON AIRPORT SYSTEM WILLIAM P. HOBBY AIRPORT HOUSTON

5995 ROGERDALE ROAD


HOUSTON, TEXAS 77072 +1-832-351-6000 WWW.JACOBS.COM TEXAS P.E. FIRM F-2966

REVISIONS NO. DESCRIPTION DATE BY ISSUED FOR BID 02/24/2023 SC

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PROJECT MGR: S. CHILDERS D. CRAWFORD **DESIGNER:** DRAWN BY: C. MCLAIN R. EHTESHAM CHECKED BY: AS SHOWN

02/24/2023

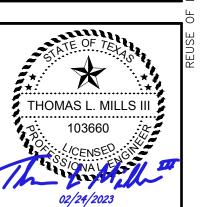

SCALE:

APPROVED BY:

DIRECTOR HOUSTON AIRPORT SYSTEM PROJECT NO: 770

C.I.P. NO: 3-48-0110-044 H.A.S. NO:

SHEET NO:

PLOT DATE: 2023/02/17 PLOT TIME: 10:59:45 AM


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- 1. FOR PAVEMENT JOINT TYPES AND REINFORCEMENT PLAN, SEE SHEETS CP701-P1 THROUGH CP710-P6.
- 2. FOR PAVEMENT TYPICAL SECTIONS, SEE SHEETS CS001 THROUGH
- 3. FOR GEOMETRIC LAYOUT, SEE SHEETS CS101-P1 THROUGH CS106-P6.
- 4. ALL PAVEMENT JOINTS SHALL MATCH INTO EXISTING PAVEMENT JOINTS AT TIE-IN LOCATIONS.
- 5. THE CONTRACTOR SHALL SUBMIT A PROPOSED PAVING PLAN TO THE ENGINEER FOR APPROVAL. DOWELS SHALL BE INSTALLED IN ALL CONSTRUCTION JOINTS IN ACCORDANCE WITH SPECIFICATION P-501. INTERIOR SLAB LOCATIONS SHOWN WITH A DOWELED CONSTRUCTION JOINT MAY BE MODIFIED TO A DOWELED CONTRACTION JOINT, WITH APPROVAL OF THE ENGINEER.
- 6. CLEAN UP OF WASTE MATERIAL SHALL BE CONTINUOUS DURING THE JOINT SAWCUTTING OPERATION. CLEAN UP SHALL USE A VACUUM
- 7. THE CONTRACTOR SHALL LOCATE AND PROTECT ALL UTILITIES AND PAVED AREAS TO REMAIN. ALL UTILITIES ARE TO REMAIN, UNLESS OTHERWISE NOTED. DEMOLITION ACTIVITIES SHALL BE CAREFULLY CONTROLLED TO PREVENT DAMAGE TO ADJACENT CONCRETE PAVEMENT, THE UNDERLYING MATERIAL, OR EXISTING STRUCTURES TO REMAIN IN-PLACE. ANY DAMAGE TO EXISTING STRUCTURES OR PAVEMENT SHALL BE IMMEDIATELY REPORTED TO REPRESENTATIVE AND REPAIRED WITH APPROVED MATERIALS AND PROCEDURES AT THE CONTRACTORS EXPENSE.
- 8. CARE SHALL BE TAKEN NOT TO UNDERMINE THE EXISTING PAVEMENT TO REMAIN.
- 9. STRUCTURES AND LIGHTS SHOWN ARE FOR REFERENCE ONLY. SEE RESPECTIVE SHEETS FOR DETAILED DESIGN INFORMATION AND

LEGEND:



EXISTING PAVEMENT

REINFORCED PCC (CP502) PCC PAVEMENT JOINT - TYPE A (THICKENED EDGE ISOLATION)
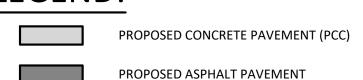
> PCC PAVEMENT JOINT - TYPE AG (THICKENED EDGE ISOLATION)

1 CP501

CP501

CP501

CP501

5 CP501

(CP503)

PCC PAVEMENT JOINT - TYPE A1 (REINFORCED ISOLATION)

PCC PAVEMENT JOINT - TYPE C (DOWELED CONTRACTION)

PCC PAVEMENT JOINT - TYPE E (DOWELED CONSTRUCTION)


PCC PAVEMENT JOINT - TYPE G (JOINT BETWEEN PCC & HMA)

PCC ISOLATION JOINT - TYPE AG1 PCC ROADWAY JOINT - TYPE E1

———— ASPHALT PAVEMENT GRID EXISTING PAVEMENT JOINT

PROPOSED GEOMETRY OUTSIDE OF CURRENT PHASE (FOR REFERENCE ONLY)

PROPOSED AIRFIELD BASE CAN FIXTURE, SEE NOTE 9

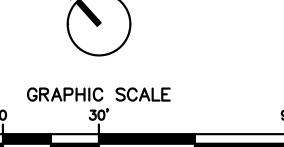

SCALE: 1" = 30'

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HOUSTON, TEXAS 77072

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REVISIONS NO. DESCRIPTION DATE BY ISSUED FOR BID 02/24/2023 SC

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PROJECT MGR: S. CHILDERS D. CRAWFORD C. MCLAIN

R. EHTESHAM

AS SHOWN

02/24/2023 THOMAS L. MILLS III

DESIGNER:

DRAWN BY:

SCALE:

CHECKED BY:


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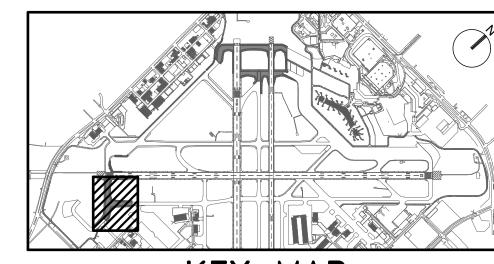
DIRECTOR HOUSTON AIRPORT SYSTEM

PROJECT NO: 770 C.I.P. NO:

3-48-0110-044 H.A.S. NO:

SHEET NO:



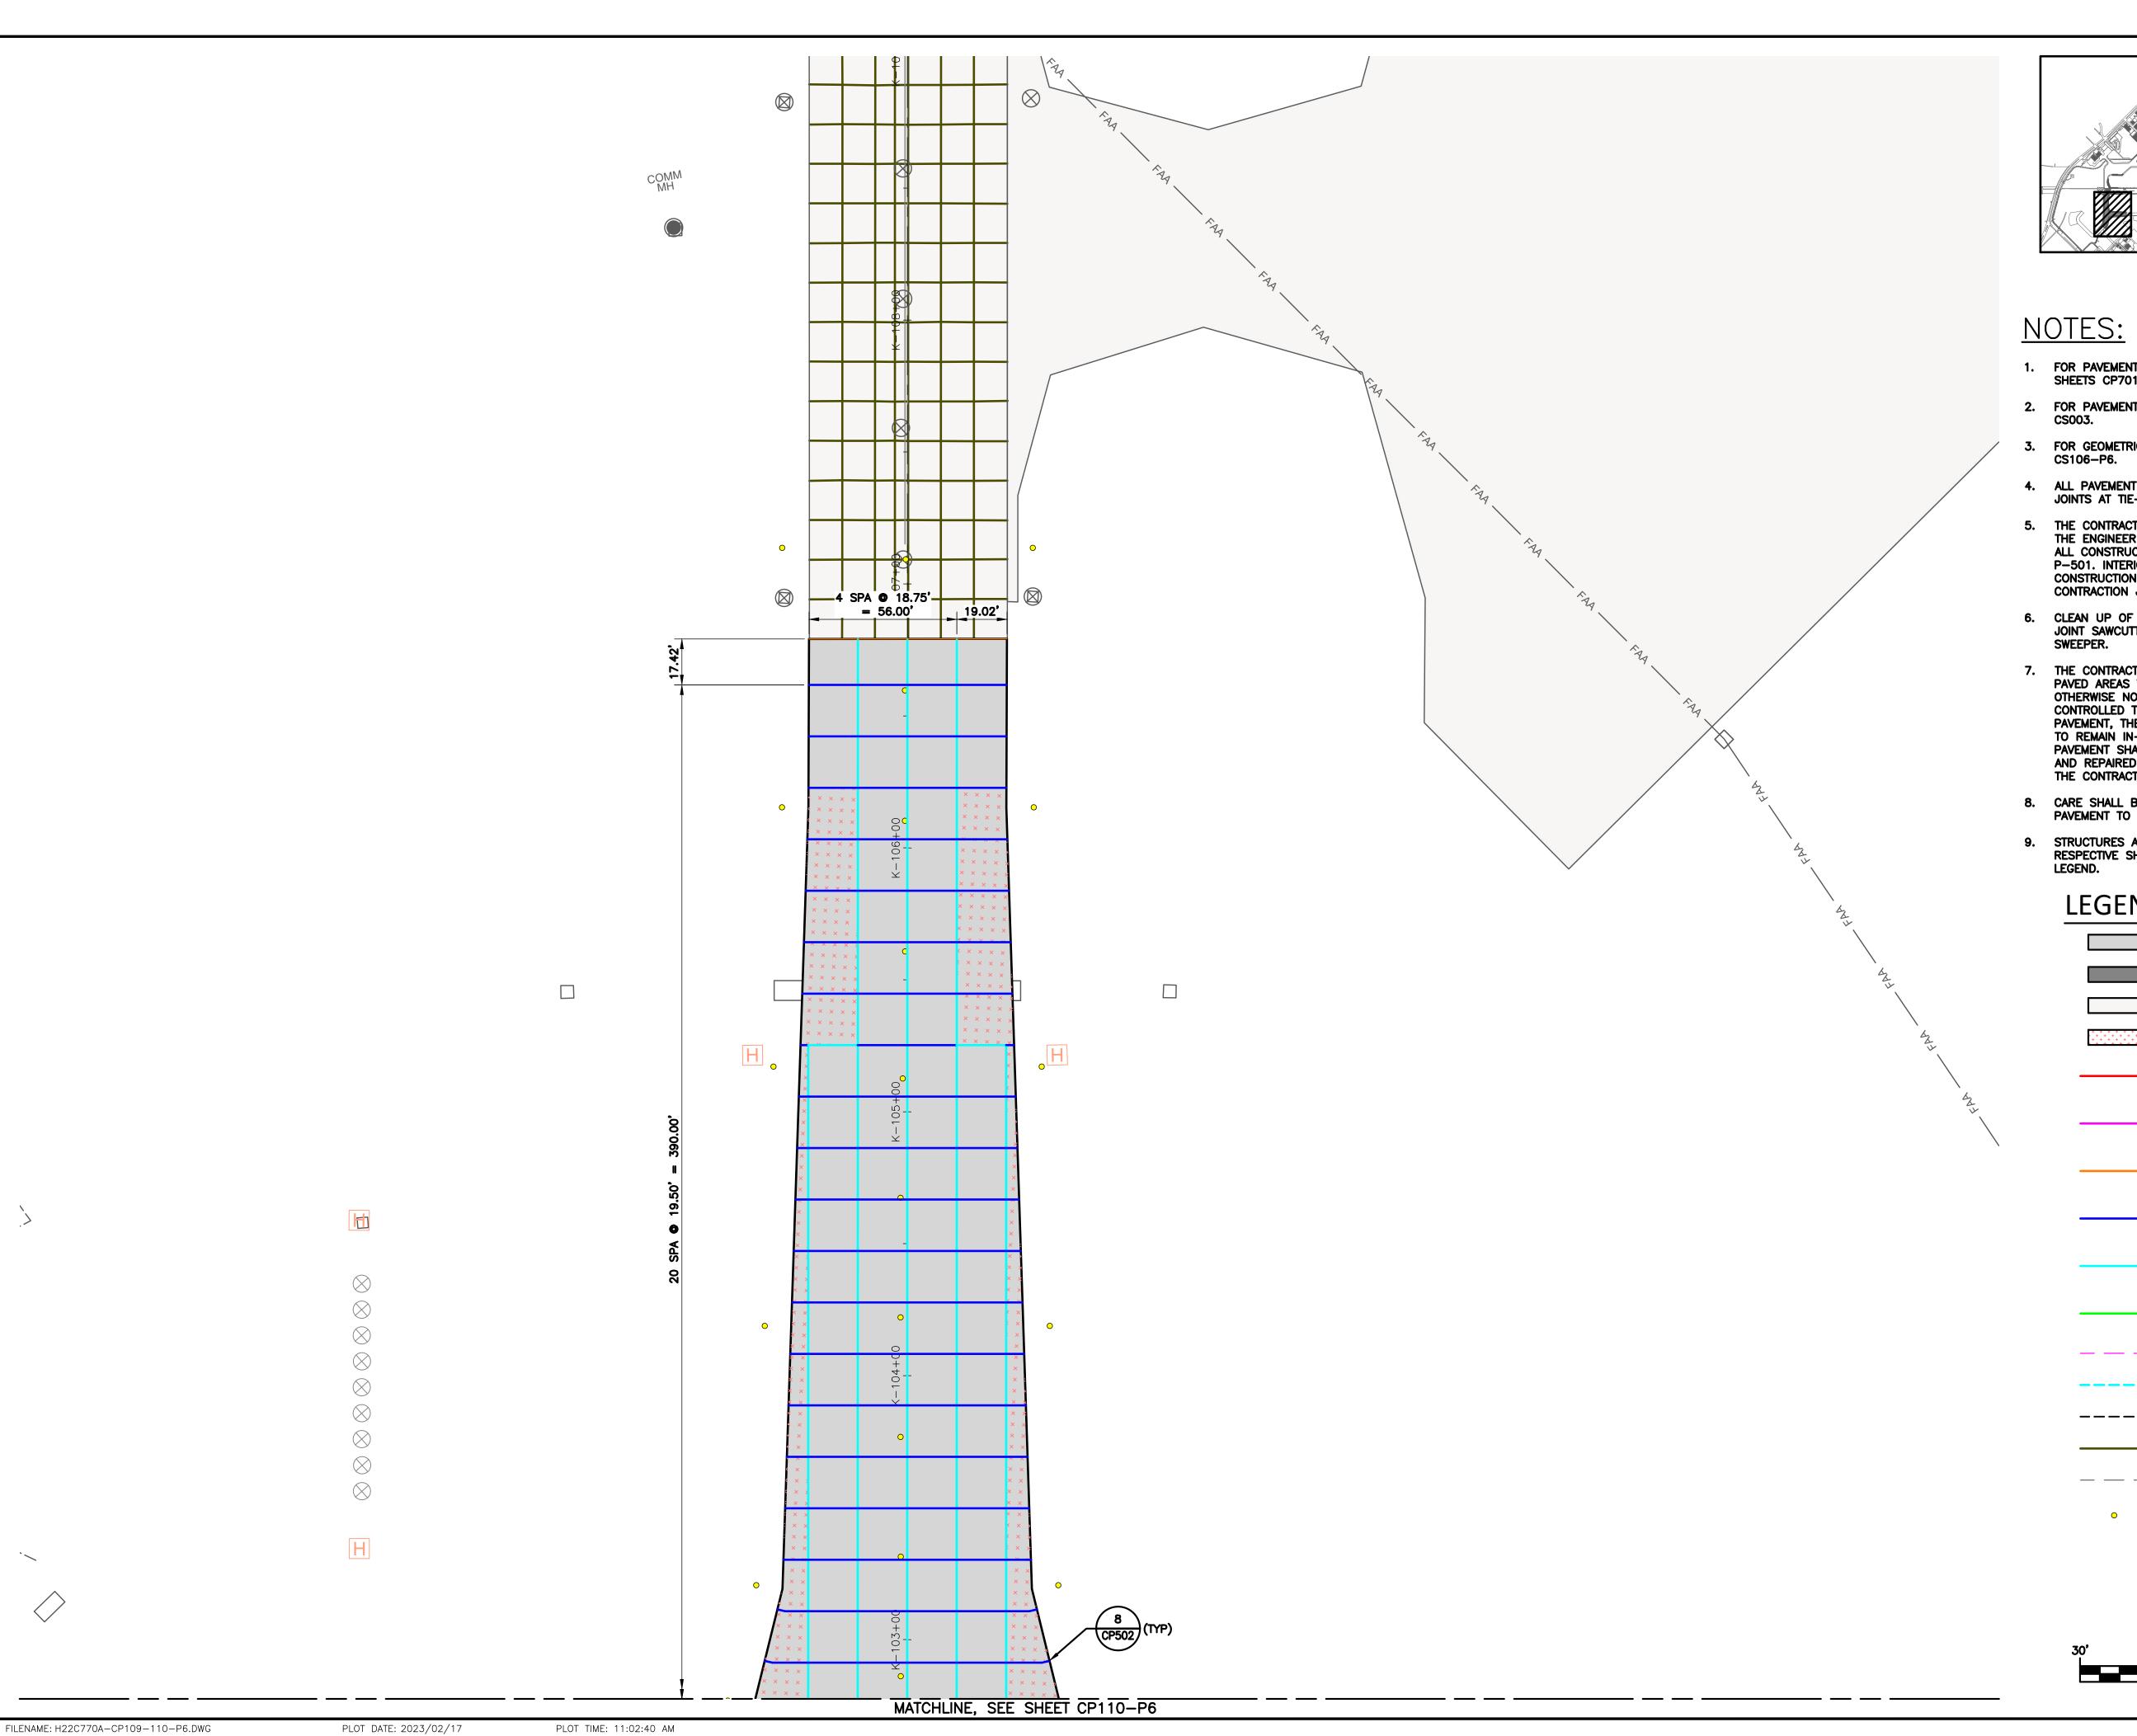

KEY MAP

- 1. FOR PAVEMENT JOINT TYPES AND REINFORCEMENT PLAN, SEE SHEETS CP701-P1 THROUGH CP710-P6.
- 2. FOR PAVEMENT TYPICAL SECTIONS, SEE SHEETS CS001 THROUGH
- 3. FOR GEOMETRIC LAYOUT, SEE SHEETS CS101-P1 THROUGH
- 4. ALL PAVEMENT JOINTS SHALL MATCH INTO EXISTING PAVEMENT JOINTS AT TIE-IN LOCATIONS.
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- 9. STRUCTURES AND LIGHTS SHOWN ARE FOR REFERENCE ONLY. SEE RESPECTIVE SHEETS FOR DETAILED DESIGN INFORMATION AND LEGEND.

LEGEND:

PROPOSED CONCRETE PAVEMENT (PCC) PROPOSED ASPHALT PAVEMENT

EXISTING PAVEMENT

REINFORCED PCC (CP502)

PCC PAVEMENT JOINT - TYPE A (THICKENED EDGE ISOLATION)

CP501

CP501

CP501

(CP503)

PCC PAVEMENT JOINT - TYPE AG (THICKENED EDGE ISOLATION)

PCC PAVEMENT JOINT - TYPE A1 (REINFORCED ISOLATION)

PCC PAVEMENT JOINT - TYPE C (DOWELED CONTRACTION)

PCC PAVEMENT JOINT - TYPE E

(DOWELED CONSTRUCTION) PCC PAVEMENT JOINT - TYPE G


(JOINT BETWEEN PCC & HMA) PCC ISOLATION JOINT - TYPE AG1

PCC ROADWAY JOINT - TYPE E1 **————** ASPHALT PAVEMENT GRID

EXISTING PAVEMENT JOINT

PROPOSED GEOMETRY OUTSIDE OF CURRENT PHASE (FOR REFERENCE ONLY)

PROPOSED AIRFIELD BASE CAN FIXTURE, SEE NOTE 9

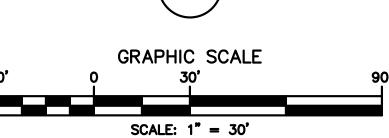



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REVISIONS NO. DESCRIPTION DATE BY

ISSUED FOR BID 02/24/2023 SC


RE 6A

PROJECT MGR: S. CHILDERS D. CRAWFORD C. MCLAIN R. EHTESHAM CHECKED BY: AS SHOWN

02/24/2023

DESIGNER:


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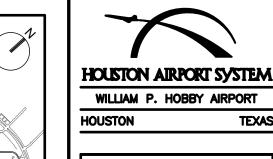


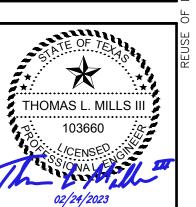APPROVED BY: DATE: DIRECTOR HOUSTON AIRPORT SYSTEM PROJECT NO:

770 C.I.P. NO: 3-48-0110-044

H.A.S. NO: SHEET NO:



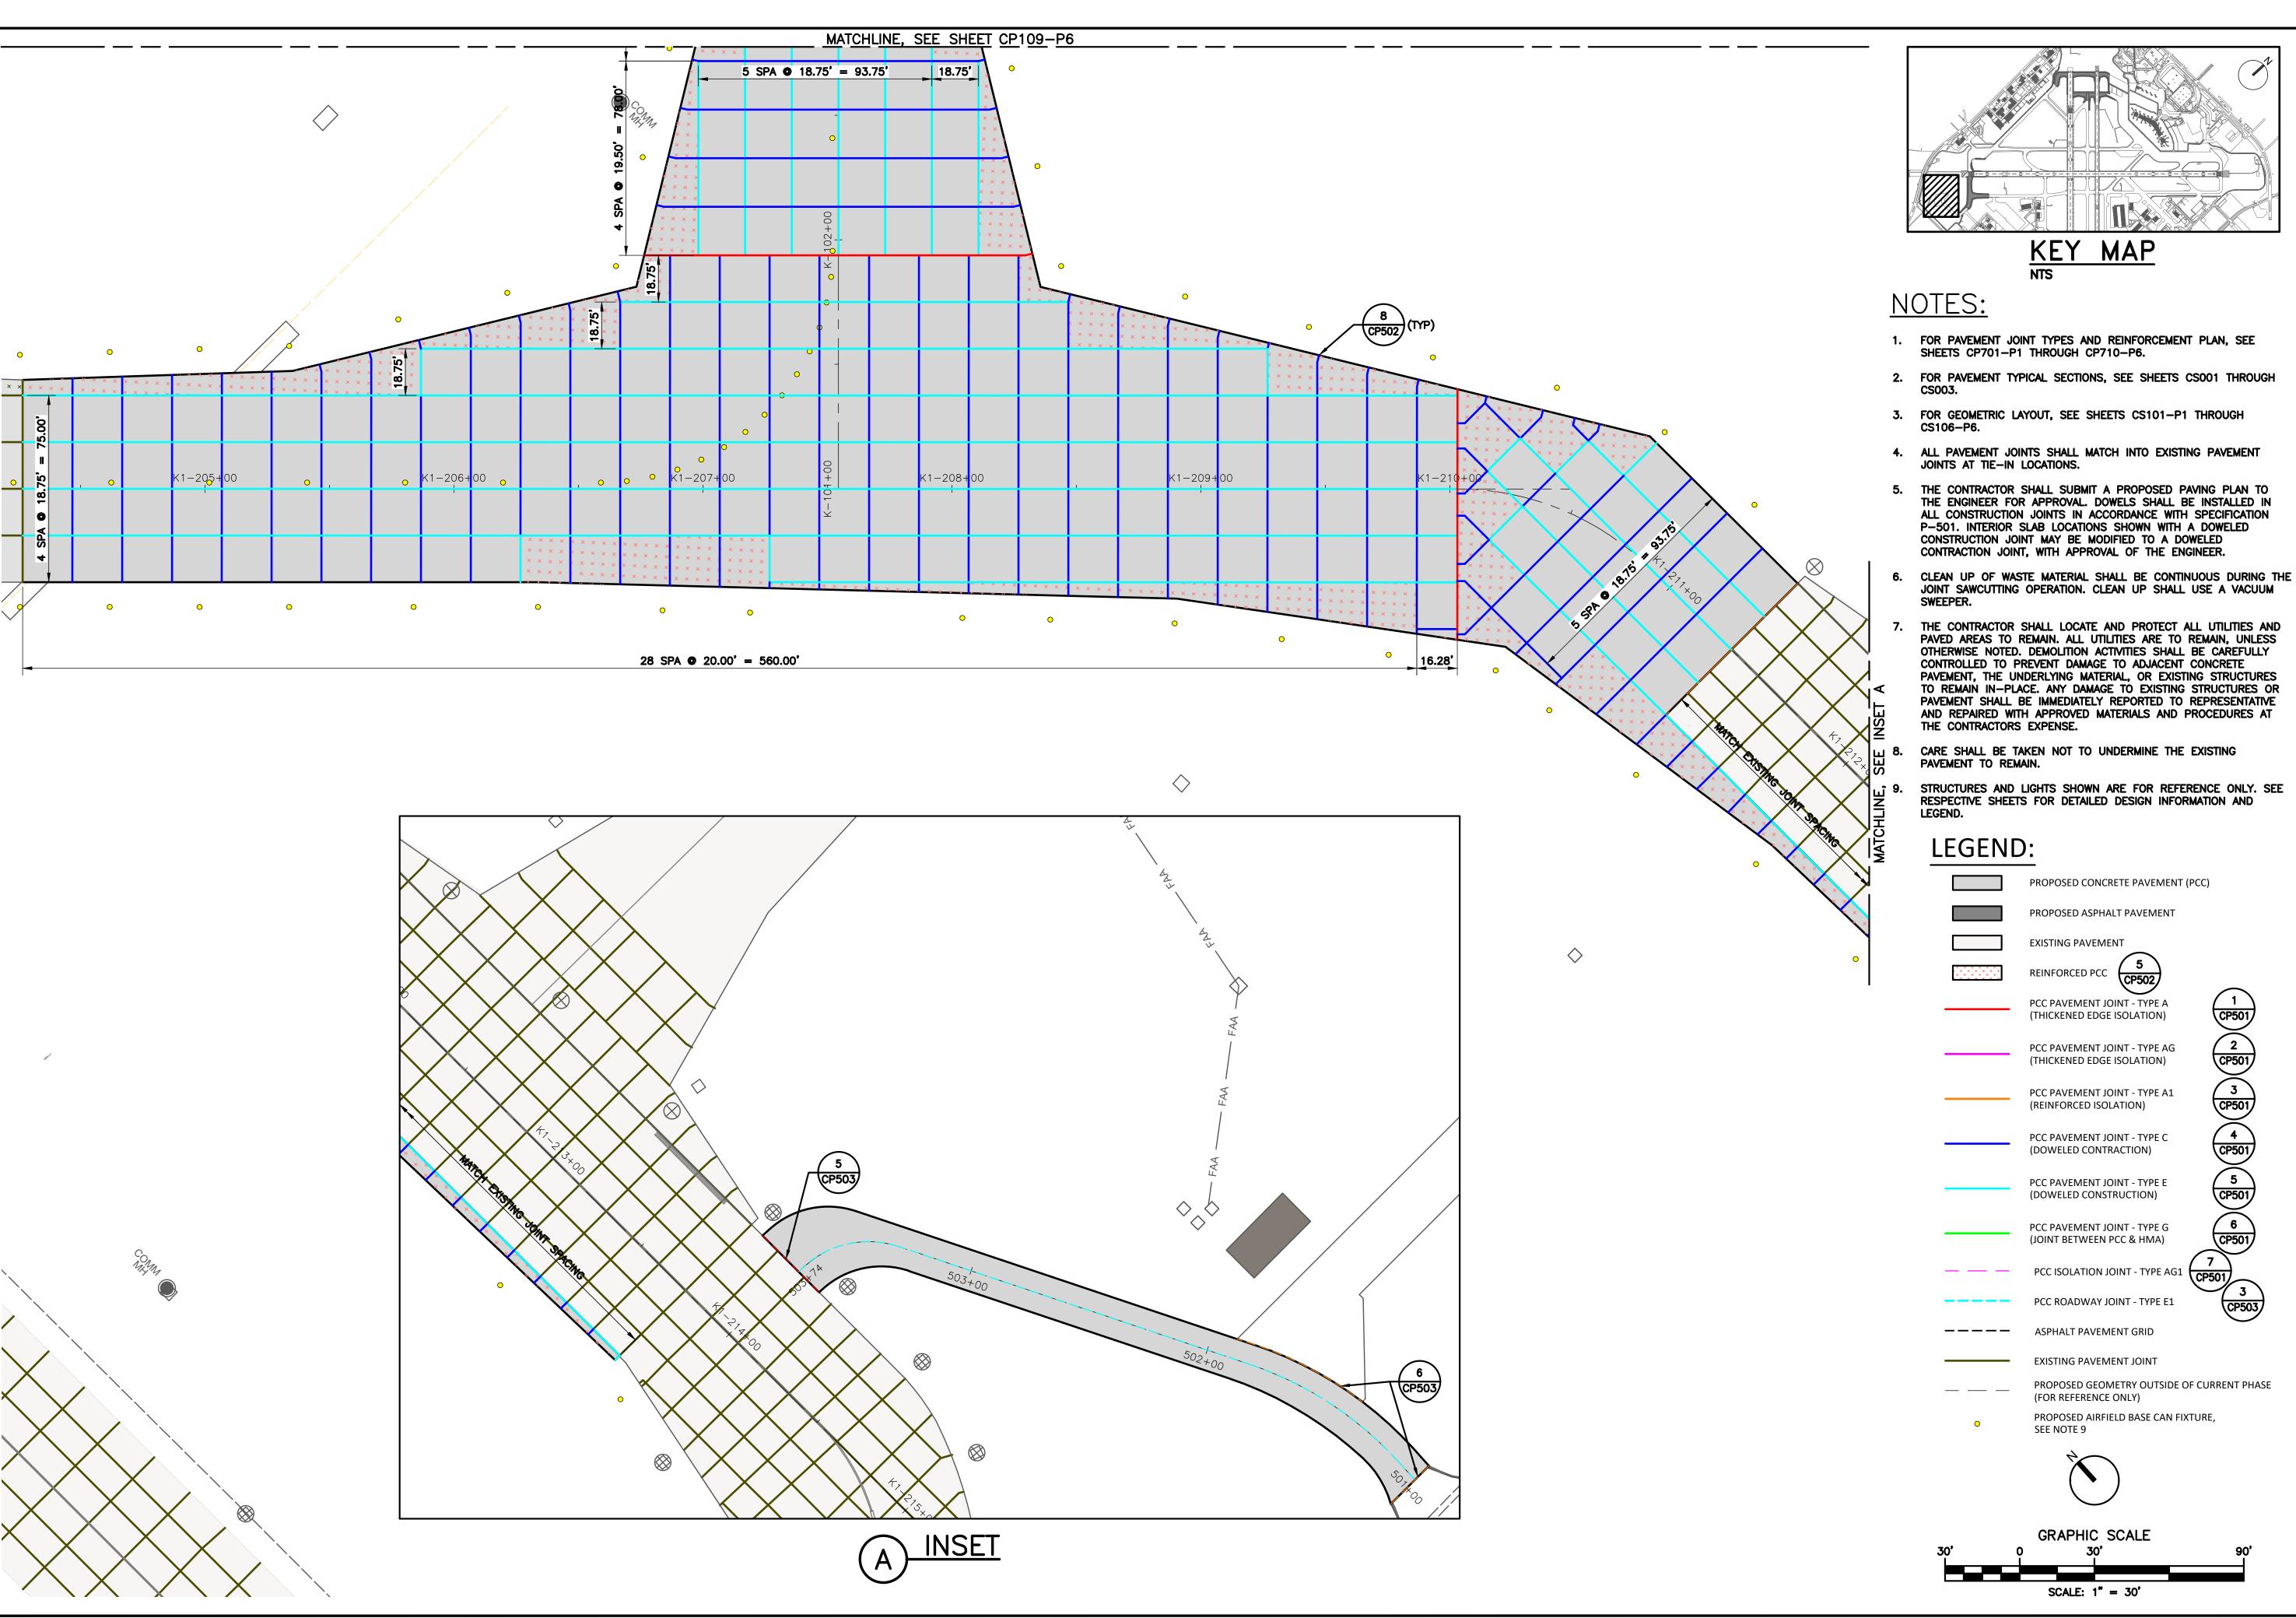

MAP

HOUSTON, TEXAS 77072

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REVISIONS NO. DESCRIPTION DATE BY

ISSUED FOR BID 02/24/2023 SC

RE 6A

PROJECT MGR: S. CHILDERS DESIGNER: D. CRAWFORD C. MCLAIN R. EHTESHAM CHECKED BY: AS SHOWN 02/24/2023


CP501

CP501

CP501

CP501

(CP503)

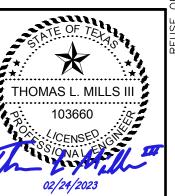

APPROVED BY: DATE:

DIRECTOR HOUSTON AIRPORT SYSTEM PROJECT NO:

770

C.I.P. NO: 3-48-0110-044 H.A.S. NO:


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PLOT DATE: 2023/02/17


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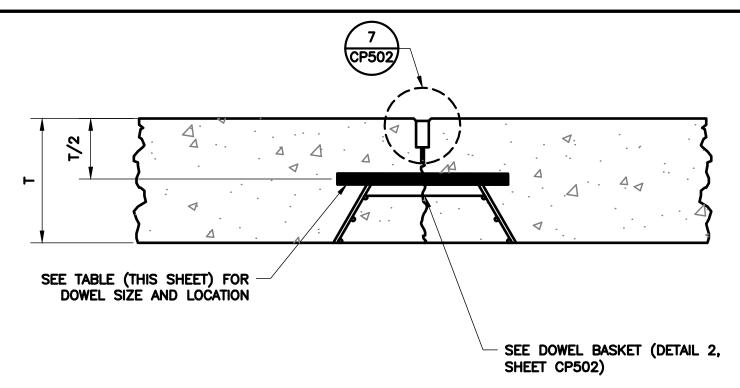
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TYPE 'A' THICKENED EDGE ISOLATION JOINT PCC-PCC TRANSITION




TYPE 'AG' THICKENED EDGE ISOLATION JOINT PCC-ASPHALT TRANSITION




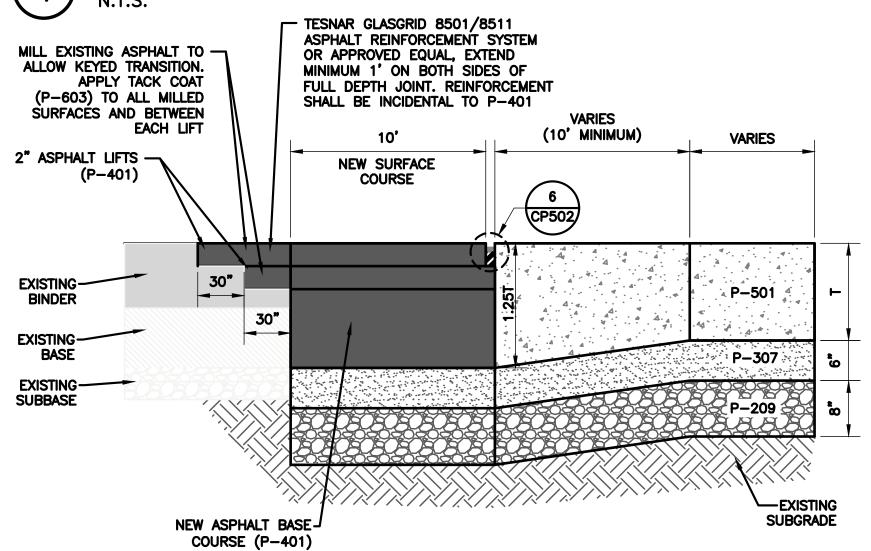

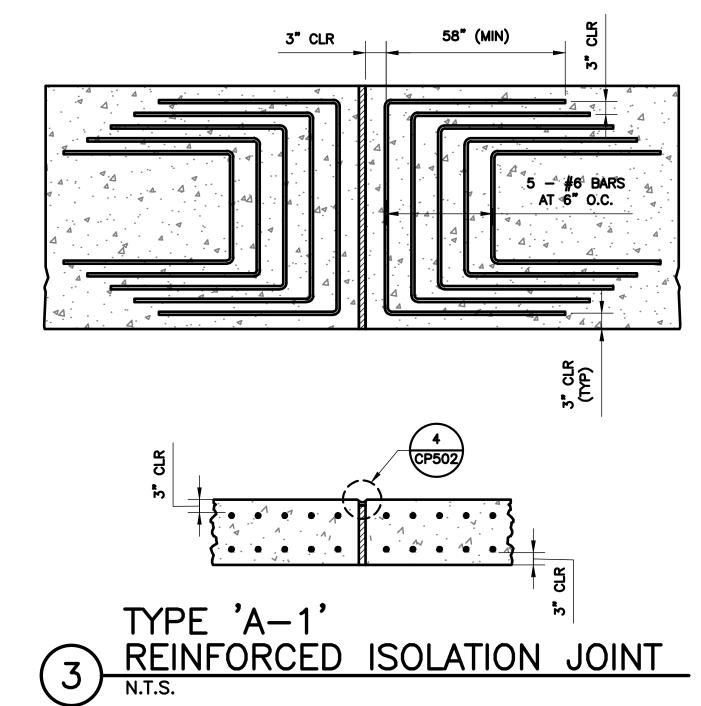
DOWELED CONTRACTION JOINT

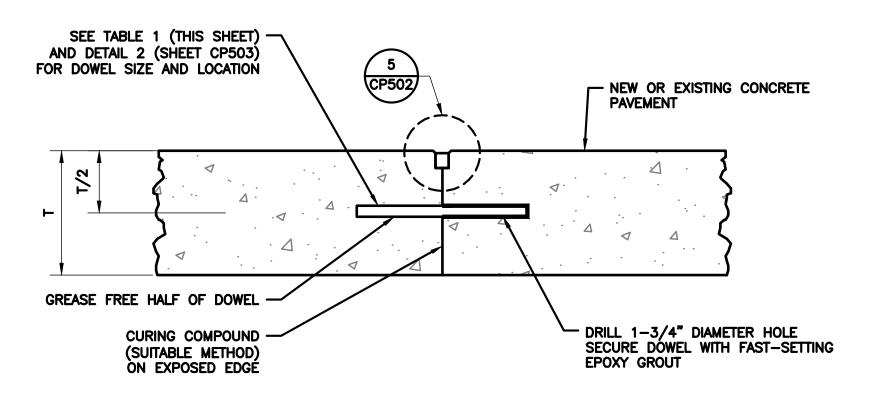

DOWELED CONSTRUCTION JOINT

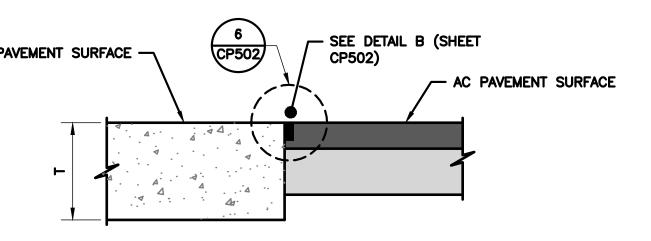

TYPE 'G' **BUTT CONSTRUCTION JOINT**

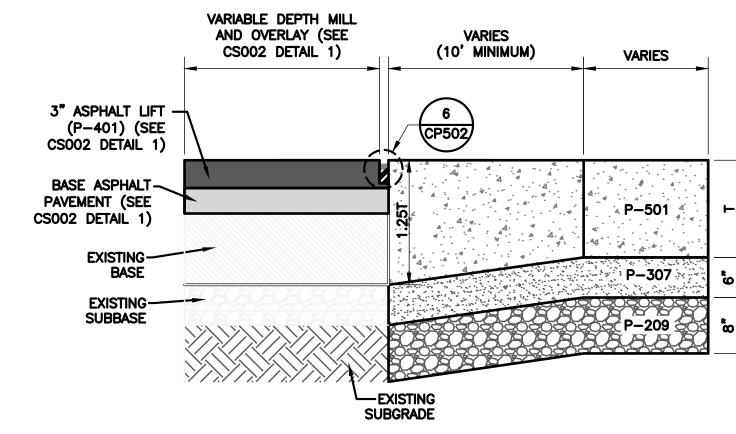

TYPE 'AG-1' THICKENED EDGE ISOLATION JOINT PCC-ASPHALT TRANSITION

GENERAL NOTES:

- 1. ALL JOINT CONSTRUCTION AND MATERIALS SHALL BE IN ACCORDANCE WITH SPECIFICATION P-501 OR AS NOTED. THE COST OF ALL JOINT CONSTRUCTION IS INCIDENTAL TO P-501.
- 2. THE CONTRACTOR MAY INTERCHANGE CONSTRUCTION JOINTS AND CONTRACTION JOINTS PER OWNER APPROVED SHOP DRAWINGS WITH ENGINEER'S APPROVAL.
- 3. EDGES OF CONCRETE SLABS SHALL BE COVERED WITH AN APPROVED CURING MATERIAL AT THE SAME TIME AS THE SURFACE IS CURED. AT FORMED LOCATIONS, SLAB SIDES SHALL BE CURED WHEN FORMS ARE REMVOED.
- 4. THE CONTRACTOR SHALL MAKE SPECIFICATIONS TO KEEP THE FINISH CONCRETE SURFACE FREE OF FOREIGN MATERIAL (I.E. AGGREGATE, OILS, ETC.) THROUGHOUT THE PROJECT. SWEEPERS, VACCUM TRUCKS, ETC. SHALL BE UTILIZED AS NECESSARY BY THE CONTRACTOR AND/OR AS DIRECTED BY THE REPRESENTATIVE TO MAINTAIN THIS PROVISION.
- 5. CONCRETE JOINT SPALLS, POP OUTS, AND OTHER CONCRETE SURFACE FAILURES, AS DEEMED EXCESSIVE BY THE REPRESENTATIVE AND WHICH CANNOT BE REASONABLY FILLED IN WITH JOINT SEALANT MATERIAL, SHALL BE REPAIRED BY THE CONTRACTOR AT NO EXPENSE TO THE AIRPORT AUTHORITY IN ACCORDANCE WITH SPECIFICATION P-501.
- 6. ANY PAVEMENT SHOWN WITH THICKENED EDGE JOINTS WILL BE PAID FOR AS NOMINAL THICKNESS (T) PAVEMENT.
- 7. JOINTS SHALL NOT INTERSECT THE EDGE OF PAVEMENT NOR ANY OTHER JOINT AT AN ANGLE OF LESS THAN 90', UNLESS OTHERWISE NOTED.

DRILLING AND BAR INSTALLATION NOTES:

- 1. DOWELS SHALL BE FULLY SHOP EPOXY COATED PER ASTM A1078.
- 2. PRIOR TO INSTALLATION IN CONTRACTION JOINTS, DOWELS SHALL BE LIGHTLY GREASED WITH A THIN COAT OF HIGH MELTING POINT GREASE OR APPROVED EQUAL AS INDICATED. IN CONSTRUCTION JOINTS, ONLY THE FREE END SHALL BE GREASED, AND ONLY AFTER INSERTION AND GROUTING INTO
- 3. ALL CONSTRUCTION JOINT DOWELS SHALL BE GANG-DRILLED AND EPOXY GROUTED. INSERTION EQUIPMENT WILL NOT BE ALLOWED.
- 4. DOWEL DRILLING METHOD SHALL BE CAPABLE OF MAINTAINING DRILL HOLES PARALLEL TO THE CONCRETE SURFACE AND NORMAL TO THE JOINT LINE WITHIN 1/4" +/- AT THE END OF THE DOWEL. DRILL HOLES SHALL BE ACCURATELY LAID OUT SO THAT THE MAXIMUM DEVIATION DOES NOT EXCEED 1" IN THE HORIZONTAL DIRECTION AND 1/2" IN THE VERTICAL DIRECTION. DRILL HOLE DIAMETER TO BE OF SUFFICIENT SIZE TO ACCEPT THE TYPE AND SIZE DOWEL REQUIRED.
- 5. AFTER DRILLING IS COMPLETE AND PRIOR TO THE INSTALLATION OF THE DOWELS, THE HOLES SHALL BE THOROUGHLY CLEANED TO REMOVE DRILLING DUST, CONCRETE CHIPS AND ANY OTHER MATERIAL DETRIMENTAL TO DEVELOPING A BOND.
- 6. EPOXY SHALL BE INJECTED UNIFORMLY TO THE ENTIRE CIRCUMFERENCE OF THE DOWEL HOLE SURFACE (CONTRACTOR SHALL NOT DIP AND INSERT DOWEL) AND SUFFICIENT MATERIAL PLACED IN THE HOLE SO THAT A SLIGHT AMOUNT WILL BE FORCED OUT FROM AROUND THE ENTIRE CIRCUMFERENCE WHEN THE DOWEL IS INSERTED AND TAPPED TO THE CORRECT POSITION. SMALL WEDGES MAY BE USED TO SUPPORT THE DOWEL IN CORRECT ALIGNMENT UNTIL THE MATERIAL HARDENS. THE TOLERANCE FOR DOWEL ALIGNMENT IN EITHER THE HORIZONTAL OR VERTICAL PLANE IS 1/8" PER FOOT OF DOWEL BAR.
- SUBMIT PROPOSED EPOXY MANUFACTURER INFORMATION FOR APPROVAL BY THE REPRESENTATIVE PRIOR TO STARTING WORK.
- 8. ALL LONGITUDINAL AND TRANSVERSE CONTRACTION JOINT DOWELS SHALL BE INSTALLED USING A WELDED WRED BASKET ASSEMBLY APPROVED BY THE REPRESENTATIVE FIRMLY ANCHORED TO THE BASE WITH A MINIMUM OF 6 GALVANIZED STRAPS AND NAILS PER ASSEMBLY. POSITION ANCHOR STRAPS ON ALTERNATING SIDES OF THE BASKET ASSEMBLY.
- 9. A TRANSVERSE CONSTRUCTION JOINT SHALL BE INSTALLED AT A PLANNED JOINT WHEN PAVING OPERATIONS ARE INTERRUPTED FOR MORE THAN 30 MINUTES. IF THE INTERRUPTION OCCURS BETWEEN PLANNED JOINTS, THE FRESH CONCRETE SHALL BE REMOVED BACK TO THE PREVIOUSLY INSTALLED JOINT. NO JOINTS WILL BE ALLOWED BETWEEN THE JOINTS SHOWN ON THE JOINTING
- 10. DOWEL BARS SHALL NOT BE PLACED MECHANICALLY.

JOINT SEALANT NOTES:

- 1. ALL JOINT CONSTRUCTION, MATERIALS AND JOINT SEALER SHALL BE IN ACCORDANCE WITH SPECIFICATION P-403, P-501, AND P-605 UNLESS OTHERWISE NOTED.
- 2. SEALANT RESERVOIR SHAPE FACTOR, W/D ,SHALL BE PER THE MANUFACTURER'S RECOMMENDATIONS.
- 3. ALL JOINT SEALANT RESERVOIRS SHOWN ON THIS SHEET SHALL BE VERIFIED BY THE SEALANT MANUFACTURER PRIOR TO CONSTRUCTION. REFER TO SECTION P-605 OF THE SPECIFICATIONS FOR FURTHER INFORMATION.
- 4. EXISTING JOINT SEALANT AND BACKER ROD SHALL BE COMPLETELY REMOVED BY SAWCUTTING
- 5. JOINT CLEANING SHALL BE ACCOMPLISHED BY COMPRESSED AIR OR OTHER APPROVED METHOD. OTHER CLEANING METHODS SHALL BE SUBMITTED TO THE REPRESENTATIVE FOR APPROVAL.
- 6. CONTRACTOR SHALL THOROUGHLY CLEAN ALL JOINTS, REMOVING ALL LOOSE MATERIAL AND SHALL THOROUGHLY SWEEP (VACUUM) PAVEMENT SURFACE TO THE SATISFACTION OF THE REPRESENTATIVE PRIOR TO ACCEPTANCE.
- 7. SAWCUT WIDTH SHALL BE 1/2" WIDE OR THE WIDTH OF THE EXISTING CONTRACTION OR CONSTRUCTION JOINTS AND 1" WIDE FOR EXPANSION JOINTS. NO EXTRA PAYMENT WILL BE MADE FOR SAWCUTS, CLEANING, BACKER ROD OR SEALANT IN JOINTS EXCEEDING DETAILED
- 8. SAWCUT DEPTHS SHALL BE TO THE DEPTHS SHOWN IN THE DETAILS OR THE DEPTH NECESSARY TO FULLY REMOVE EXISTING BACKER ROD. NO EXTRA PAYMENT WILL BE MADE FOR SAWCUTS IN EXCESS OF DETAILED DEPTHS.
- 9. THE CONTRACTOR SHALL VACUUM ALL SLURRY FROM SAWCUTTING ADJACENT PAVEMENT.

<u>DOWEL BASKET NOTES:</u>

- 1. BASKETS SHALL BE FIRMLY ANCHORED TO THE BASE.
- 2. ALL WIRE SIZES SHOWN ARE MINIMUM SIZES.
- 3. DOWELS SHALL BE HELD FIRMLY IN THE WELDED ASSEMBLY AS SHOWN

<u>CONCF</u>	RETE PA	<u>avemen</u>	T THICK	NESS 7	<u> TABLE</u>
SLAB THICKNESS (T)	T/2	1.25T	DOWEL DIAMETER	DOWEL LENGTH	DOWEL SPACING
16"	8*	20"	1 1/4"	20"	15"




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REVISIONS NO. DESCRIPTION DATE BY ISSUED FOR BID 02/24/2023 S

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S. CHILDERS D. CRAWFORD **DESIGNER:** C. MCLAIN R. EHTESHAM CHECKED BY: SCALE: AS SHOWN 02/24/2023



APPROVED BY:

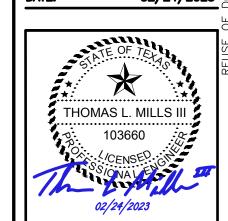HOUSTON AIRPORT SYSTEM

PROJECT NO:


770 C.I.P. NO: 3-48-0110-044

H.A.S. NO: SHEET NO:

PLOT DATE: 2023/02/17


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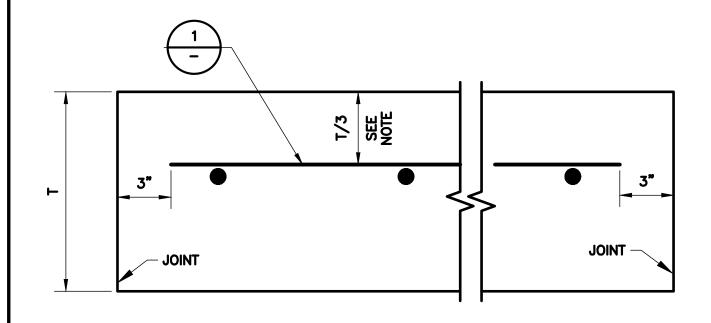
TAXIWAY PAVEMENT WELDED WIRE FABRIC DETAIL

SECTION END LAP/SIDE LAP

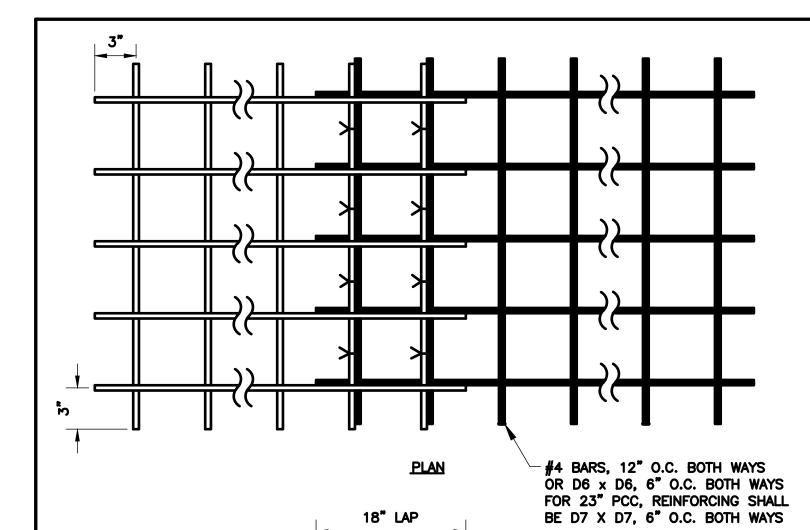


1. ANY PORTION OF THE BASKET IN CONTACT WITH THE SUBGRADE, INCLUDING CTB OR BOND BREAKER, SHALL BE EPOXY COATED.

TYPICAL DOWEL BASKET ASSEMBLY

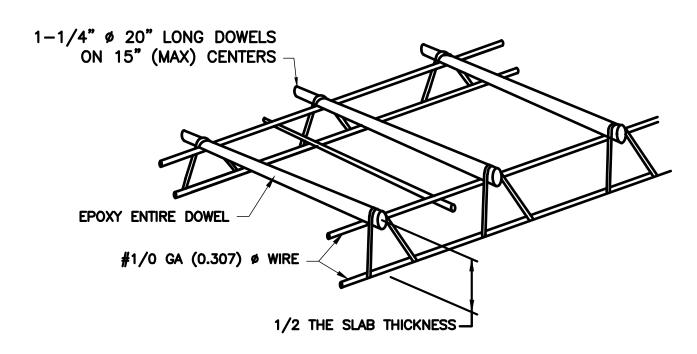


REINFORCING SHALL BE PLACED AT APPROXIMATELY THE UPPER 1/3 OF THE PANEL. IT MAY BE MOVED UP TO DECONFLICT WITH DOWELS, TO A MAXIMUM OF 1/1+1 FROM THE TOP OF SLAB.

REINFORCED PAVEMENT (TAXIWAY PAVEMENT)

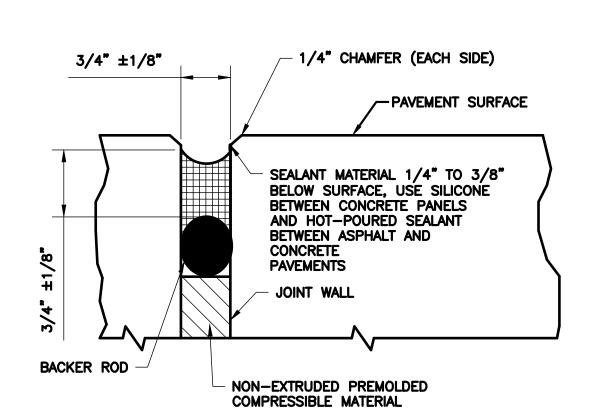


4 DETAIL A - ISOLATION JOINT

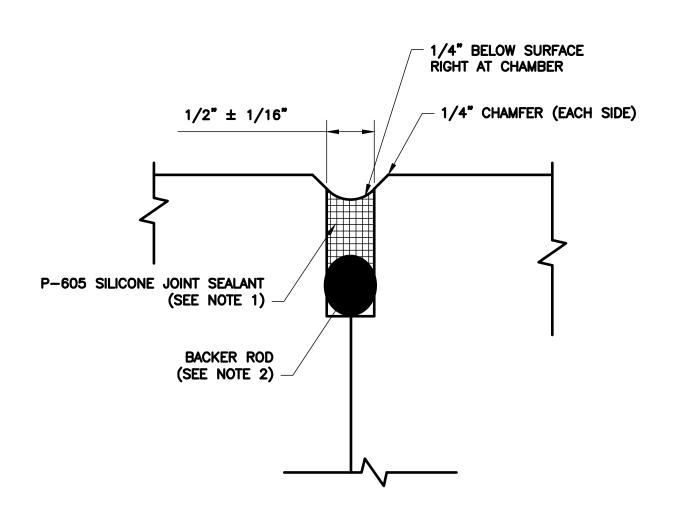


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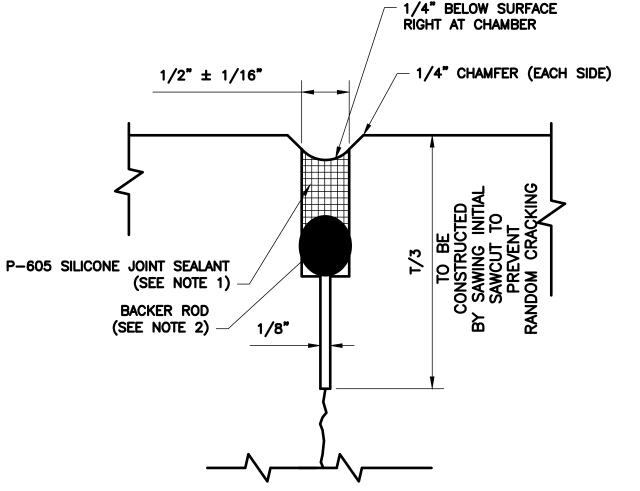
- 1. DEPTH PER MANUFACTURER'S GUIDELINES (BASED ON THE WIDTH).
- 2. BACKER ROD MATERIAL MUST BE COMPATIBLE WITH THE TYPE OF SEALANT USED AND SIZED TO PROVIDE THE DESIRED SHAPE FACTOR.

5 DETAIL C - CONSTRUCTION JOINT
N.T.S.

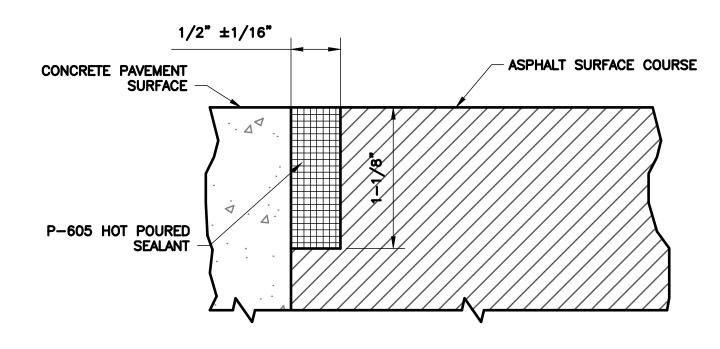


1. THE SHOULDER ASPHALT SURFACE COURSE (P-403) SHALL BE 0" TO 1/16" BELOW THE CONCRETE SURFACE.



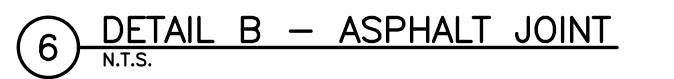



- 1. DEPTH PER MANUFACTURER'S GUIDELINES (BASED ON THE WIDTH).
- 2. BACKER ROD MATERIAL MUST BE COMPATIBLE WITH THE TYPE OF SEALANT USED AND SIZED TO PROVIDE THE DESIRED SHAPE FACTOR.

7 DETAIL D - CONTRACTION JOINT

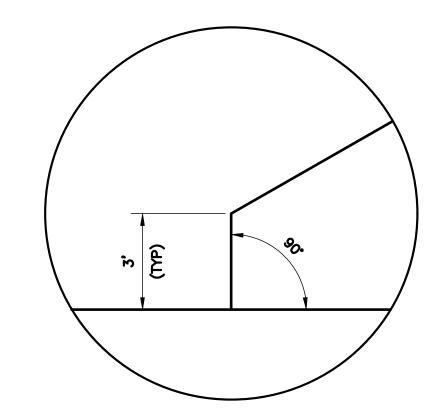

JOINT DOGLEG

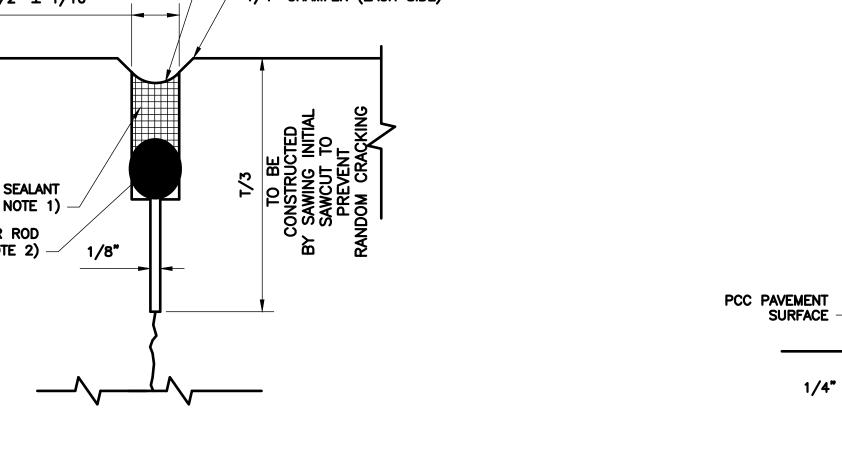

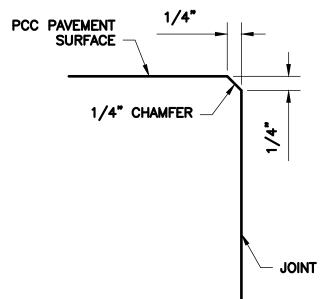

9 1/4 - INCH CHAMFER

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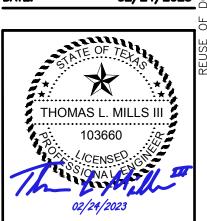
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NON-S

DETAILS JOINTING

S. CHILDERS **DESIGNER:** D. CRAWFORD C. MCLAIN R. EHTESHAM CHECKED BY: AS SHOWN 02/24/2023



APPROVED BY:

DIRECTOR HOUSTON AIRPORT SYSTEM

PROJECT NO:

770


C.I.P. NO: 3-48-0110-044


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FILENAME: H22C770A-CP501-503.DWG

PLOT DATE: 2023/02/17

PLOT TIME: 11:04:51 AM




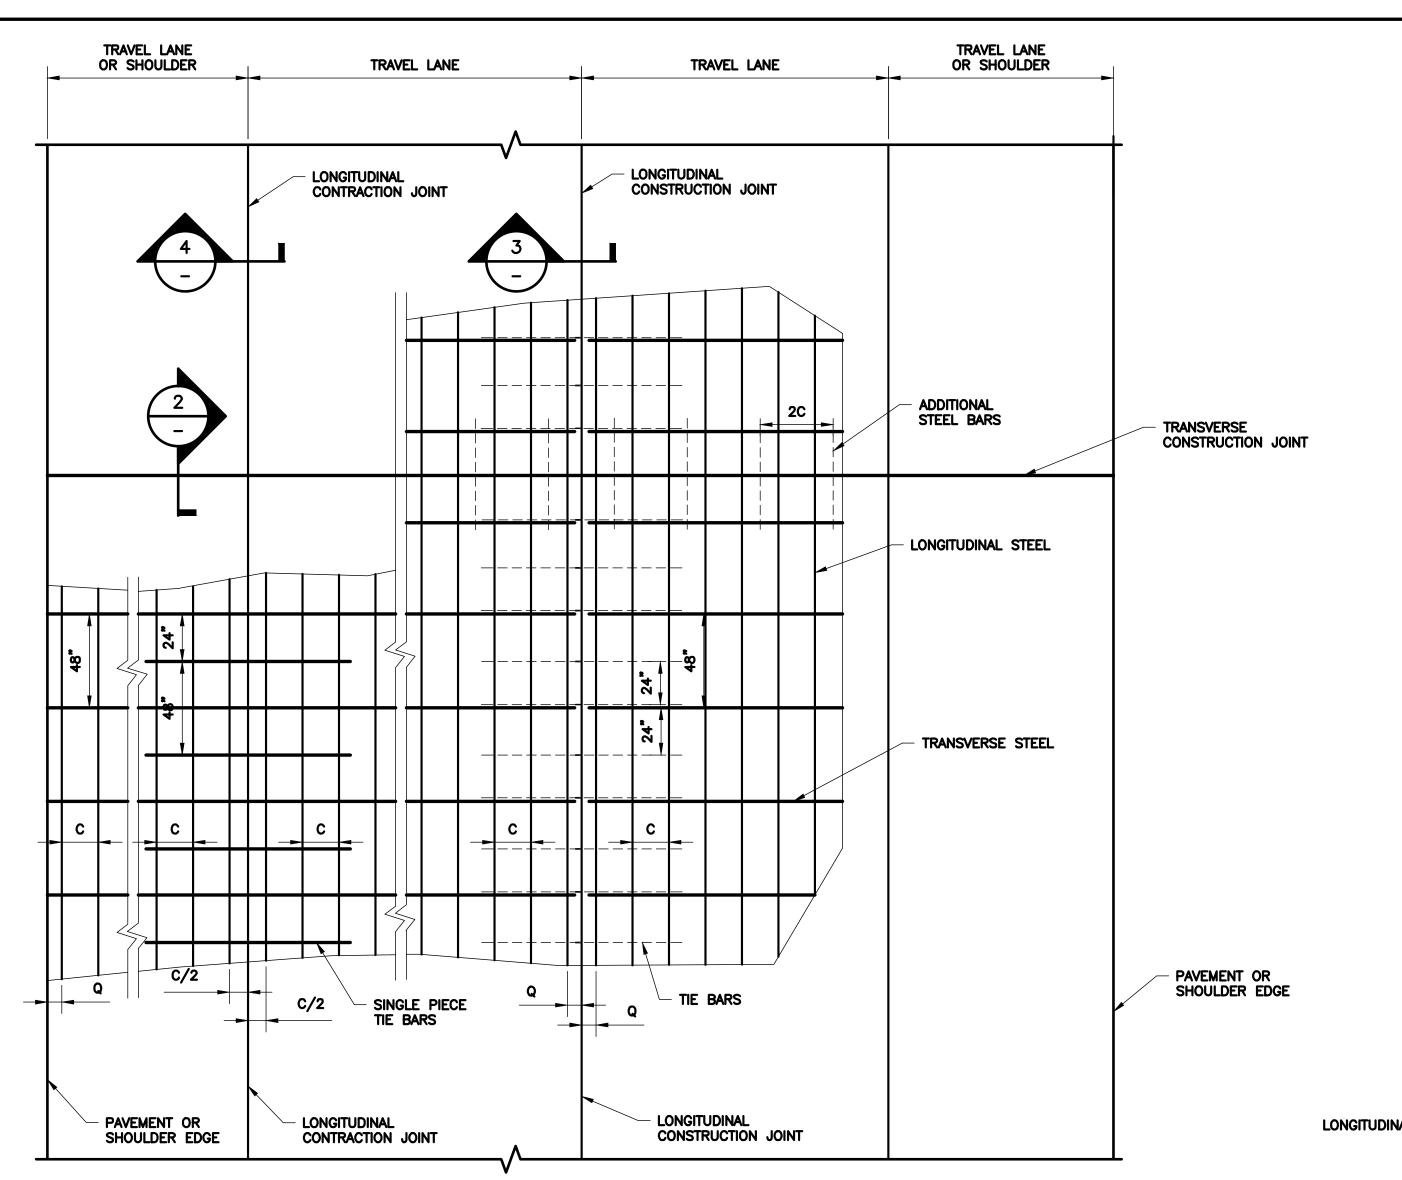

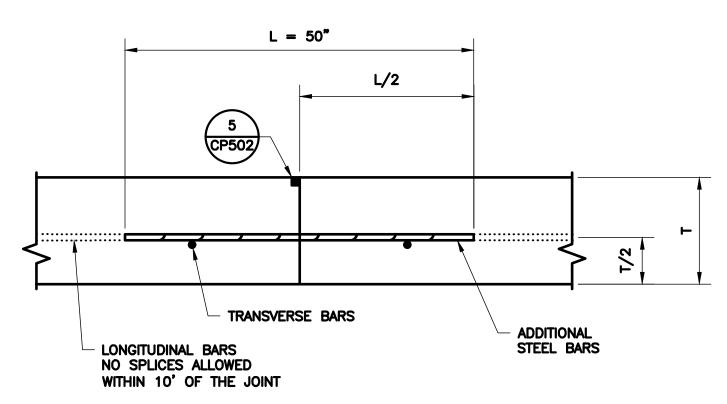
TRANSVERSE

CONSTRUCTION JOINT (X-X)

N.T.S.

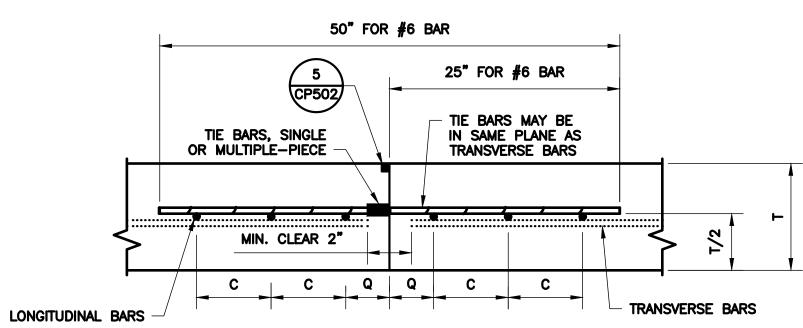

TYPE 'E1' – LONGITUDINAL CONSTRUCTION JOINT (Y-Y)

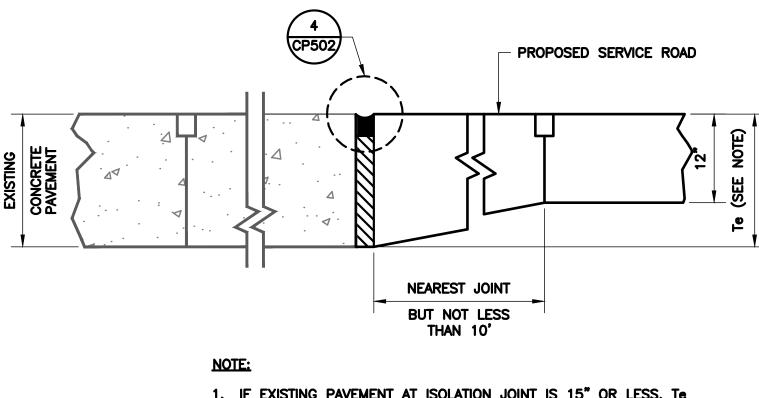


1. IF EXISTING PAVEMENT AT ISOLATION JOINT IS 15" OR LESS, TE SHALL MATCH THE EXISTING PAVEMENT THICKNESS. IF EXISTING PAVEMENT IS GREATER THAN 15", TE SHALL BE 15".

TYPE 'A2' ROADWAY

THICKENED EDGE ISOLATION JOINT

N.T.S.

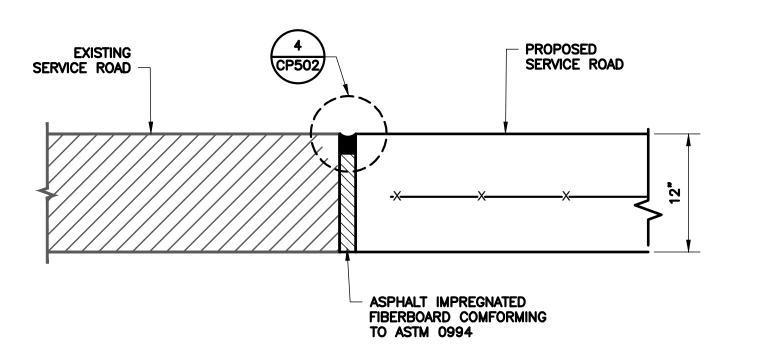

TYPE 'A3'
ROADWAY ISOLATION JOINT

N.T.S.


1 TYPICAL PAVEMENT LAYOUT N.T.S.

GENERAL NOTES:

- 1. ALL THE REINFORCING STEEL AND TIE BARS SHALL BE DEFORMED STEEL BARS CONFORMING TO ASTM A 615 (GRADE 60) OR ASTM A 996 (GRADE 60) OR ABOVE. STEEL BAR SIZES AND SPACINGS SHALL CONFORM TO TABLE NO.1 AND TABLE NO.2.
- 2. STEEL BAR PLACEMENT TOLERANCE SHALL BE +/- 1 IN. HORIZONTALLY AND +/- 0.5 IN. VERTICALLY. CALCULATED AVERAGE BAR SPACING (CONCRETE PLACEMENT WIDTH / NUMBER OF LONGITUDINAL BARS) SHALL CONFORM TO
- 3. PAVEMENT WIDTHS OF MORE THAN 15 FT. SHALL HAVE A LONGITUDINAL JOINT (SECTION Z-Z OR SECTION Y-Y). THESE JOINTS SHALL BE LOCATED WITHIN 6 IN. OF THE LANE LINE UNLESS THE JOINT LOCATION IS SHOWN ELSEWHERE ON THE PLANS.
- 4. REPLACE MISSING OR DAMAGED TIE BARS WITHOUT ADDITIONAL COMPENSATION BY DRILLING MIN.10 IN. DEEP AND GROUTING TIE BARS WITH TYPE III, CLASS C EPOXY. MEET THE PULL-OUT TEST REQUIREMENTS IN ITEM 361.
- 5. OMIT TIE BARS LOCATED WITHIN 18-IN. OF THE TRANSVERSE CONSTRUCTION JOINTS (SECTION X-X). USE HAND-OPERATED IMMERSION VIBRATORS TO CONSOLIDATE THE CONCRETE ADJACENT TO ALL FORMED JOINTS.
- 6. LONGITUDINAL REINFORCING STEEL SPLICES SHALL BE A MINIMUM OF 25 IN. STAGGER THE LAP LOCATIONS SO THAT NO MORE THAN 1/3 OF THE LONGITUDINAL STEEL IS SPLICED IN ANY GIVEN 12-FT. WIDTH AND 2-FT. LENGTH OF THE PAVEMENT.


TABLE NO.1						
LONGITUDINAL STEEL						
SLAB THICKNESS AND BAR REGULAR STEEL BARS			FIRST SPACING AT EDGE OR JOINT	AT TRAI CONSTRUC	STEEL BARS ISVERSE TION JOINT N X—X)	
T (IN.)	BAR SIZE	SPACING C (IN.)	SPACING Q. (IN.)	SPACING 2 X C (IN.)	LENGTH L (IN.)	
12.0	#6	6.0	3 TO 4	12	50	

	TABLE NO.2					
TRANSVERSE STEEL & TIE BARS						
SLAB THICKNESS	TRANSVEI	rse steel	TIE BARS AT LONGITUDINAL CONTRACTION JOINT (SECTION Z-Z) TIE BAR LONGITU CONSTRUCT (SECTION		UDINAL TION JOINT	
(IN.)	BAR SIZE	SPACING (IN.)	BAR SIZE	SPACING (IN.)	BAR SIZE	SPACING (IN.)
8.0 - 13.0	# 5	48	#6	48	#6	24

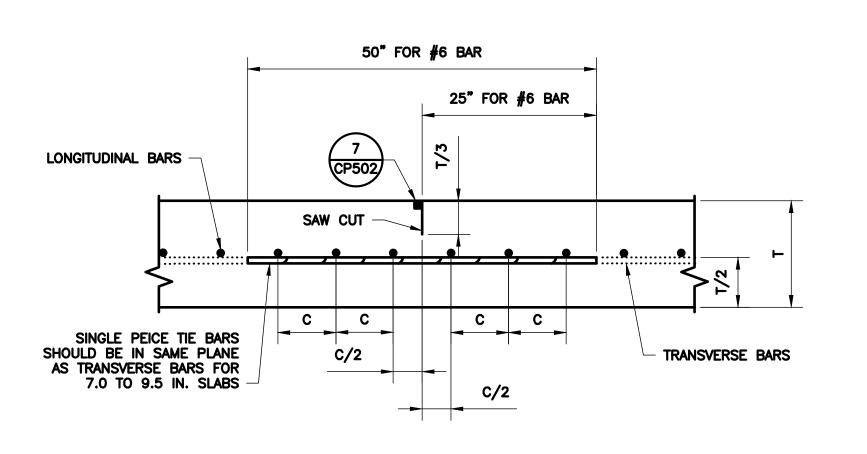

TYPE 'C1' - LONGITUDINAL
CONTRACTION JOINT (Z-Z)

N.T.S.

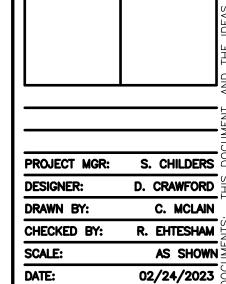

NON-ST

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REVISIONS


NO. DESCRIPTION DATE BY

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DETAIL

JOINTING

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HOUSTON ARPORT SYSTEM

PROJECT NO:

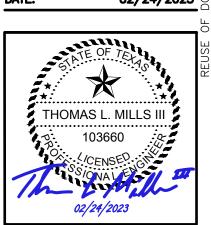770
c.i.p. No:
3-48-0110-044

H.A.S. NO:

N/A

SHEET NO:

CP50


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FILENAME: H22C770A-CP501-503.DWG PLOT DATE: 2

PLOT DATE: 2023/02/17


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PLOT TIME: 11:05:10 AM



NOTES

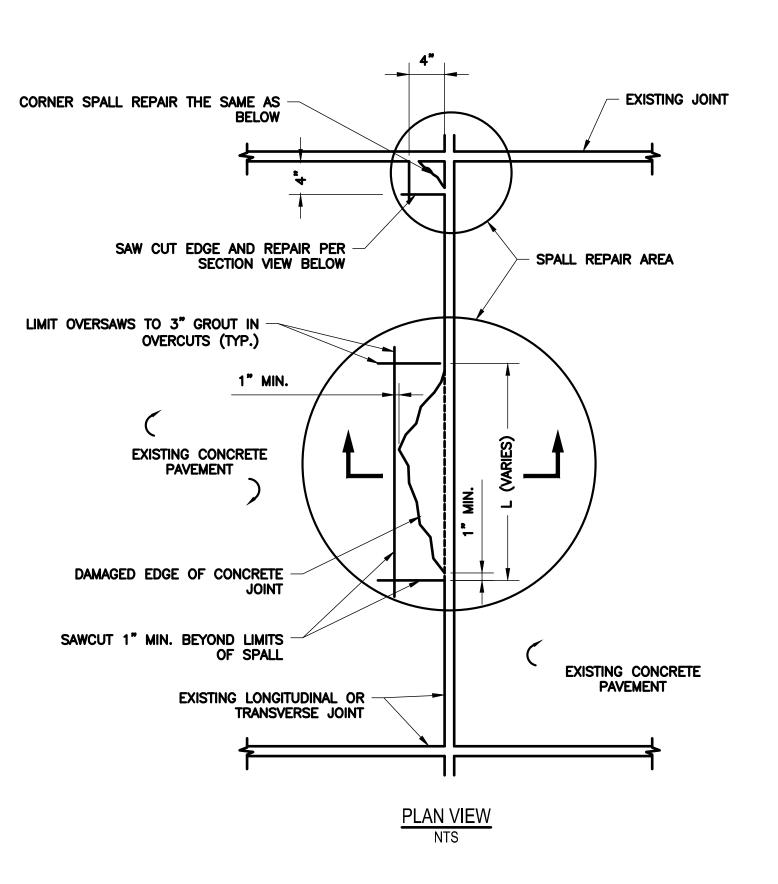- SAW CUT MINIMUM 1" CLEAR OF EXISTING SPALL, 2" MINIMUM DEPTH, REMOVE SPALLED CONCRETE AND EXISTING SEALANT WITH PATCH BOUNDARY.
- 2. SAW CUTS SHALL BE STRAIGHT LINES FORMING RECTANGULAR PATCHES SURROUNDING THE SPALLED AREA.
- REMOVE UNSOUND CONCRETE AND AT LEAST 1/2" OF VISUALLY SOUND CONCRETE BETWEEN SAW CUT AND THE JOINT. MAXIMUM ALLOWABLE PNEUMATIC HAMMER SIZE IS 30 POUNDS.
- 4. CLEAN AND DRY AREA TO BE PATCHED BY AIR BLASTING. JOINTS AND EXPOSED CONCRETE SURFACE SHALEB DUST-FREE PRIOR TO INSTALLATION OF
- 5. INSTALL NON ABSORBENT BOARDS WITHIN THE LIMITS OF THE JOINT SEAL ALONG THE LENGTH OF THE ADJACENT CONCRETE PANEL. PROVIDE A SECURE SEAL BETWEEN BOARDS AND EXISTING CONCRETE TO ENSURE NEW PATCHING MATERIAL DOES NOT PENETRATE INTO THE
- 6. PATCH SHALL BE TROWELED TOWARD THE PATCH PERIMETER, NOT AWAY FROM PATCHED PERIMETER.
- SPALLS DEEPER THAN 1/2 THE SLAB DEPTH OR SPALLS LONGER THAN 25% OF THE ADJACENT JOINT REQUIRE REPLACEMENT OF THE ENTIRE SLAB.
- 8. SPALLS LESS THAN ONE INCH WIDE AND LESS THAN THE DEPTH OF THE JOINT SEALANT RESERVOIR, SHALL BE FILLED WITH JOINT SEALANT MATERIAL.
- SECTION SHOWS SPALL REPAIR ON ONE SIDE OF THE JOINT. SOME CASES WILL REQUIRE REPAIR ON BOTH SIDES OF THE JOINT, HOWEVER THE METHODOLOGY SHALL BE FOLLOWED TO REPAIR BOTH SIDES.
- 10. JOINT SEALANT SHALL BE RE-ESTABLISHED PER SPECIFICATION P-605.



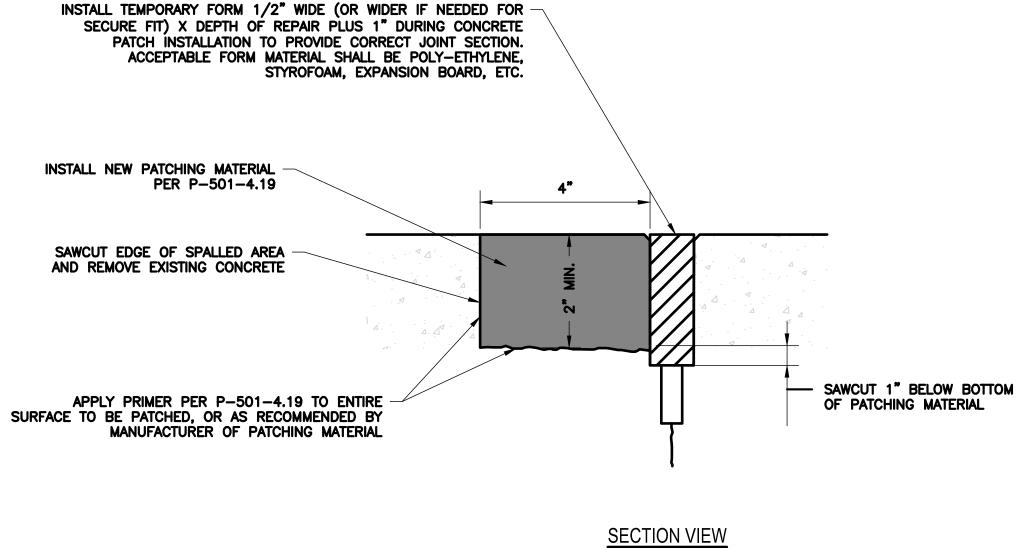



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JOINTING

PROJECT MGR:	S. CHILDERS
DESIGNER:	D. CRAWFORD
DRAWN BY:	D. CRAWFORD
CHECKED BY:	R. EHTESHAM
SCALE:	AS SHOWN
DATE:	02/24/2023



APPROVED BY:

DIRECTOR HOUSTON AIRPORT SYSTEM

PROJECT NO:

770 C.I.P. NO:


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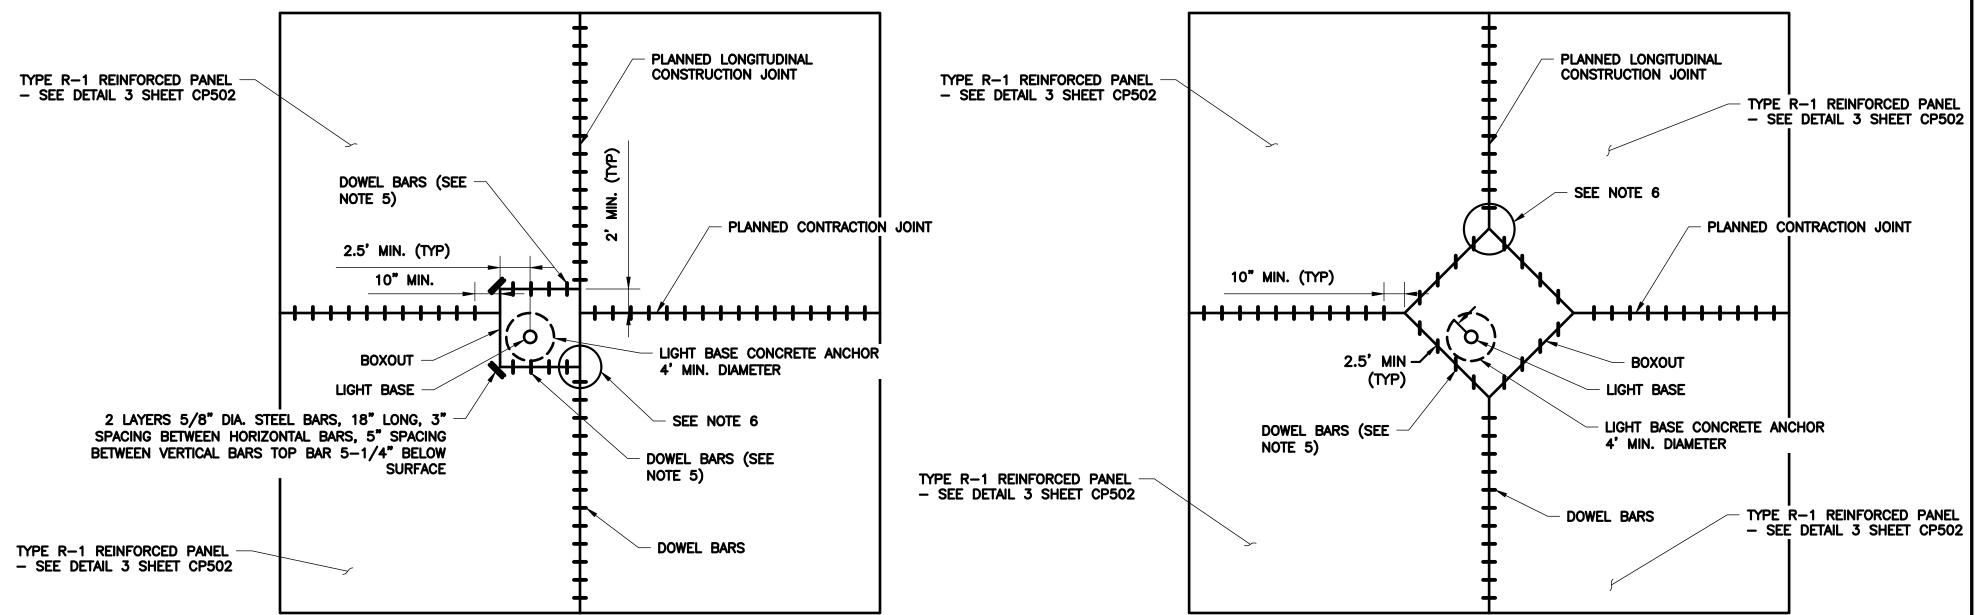
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INTERIOR SLAB BOXOUT

<u>EDGE SLAB BOXOUT — 2 PANELS</u>
N.T.S.

EDGE SLAB BOXOUT — 4 PANELS
N.T.S.

BOXOUT NOTES:

- 1. WHEN A BOXOUT IS USED ON A PLANNED CONTRACTION JOINT, THE JOINT SHALL BE CHANGED TO A CONSTRUCTION JOINT.
- 2. A BOXOUT IS NOT REQUIRED WHEN AN IN-PAVEMENT LIGHT BASE IS INSTALLED AT OR MORE THAN TWO FEET FROM A PLANNED JOINT. A BOXOUT MUST BE USED WHEN A LIGHT BASE MUST BE LOCATED CLOSER THAN TWO FEET TO A PLANNED CONSTRUCTION
- 3. WHEN MINIMUM CLEARANCE FROM THE INTERIOR BOXOUT TO A PLANNED JOINT CAN NOT BE ACHIEVED, AN EDGE BOXOUT SHALL
- 4. AN EDGE BOXOUT MUST INCORPORATE ALL OF THE PANEL DISTANCE BETWEEN A PLANNED JOINT AND THE LIGHT BASE. DO NOT CROSS A PLANNED JOINT WITH THE BOXOUT IF THERE IS AT LEAST 2' FROM THE LIGHT BASE TO THE PLANNED JOINT.
 BOXOUTS WHICH ARE REQUIRED TO CROSS A PLANNED JOINT MUST EXTEND A MINIMUM OF 2' BEYOND THE PLANNED JOINT.
- 5. DOWEL BARS SHALL BE ALIGNED PARALLEL WITH THE DIRECTION OF TRAFFIC ONLY. DOWELS SHALL BE SPACED AT 18" AND PLACED NO CLOSER THAN 10" FROM THE EDGE OF THE BOXOUT OR PLANNED JOINT.
- 6. DOWEL BAR SPACING ALONG A PLANNED PAVEMENT JOINT HAS PRECEDENCE OVER DOWL BAR SPACING ALONG THE BOXOUT JOINT. A DOWEL PLACED ALONG A BOXOUT JOINT MUST BE LOCATED AT LEAST 12" FROM THE END OF A DOWEL BAR PLACED ALONG THE INTERSECTING PAVEMENT JOINT.
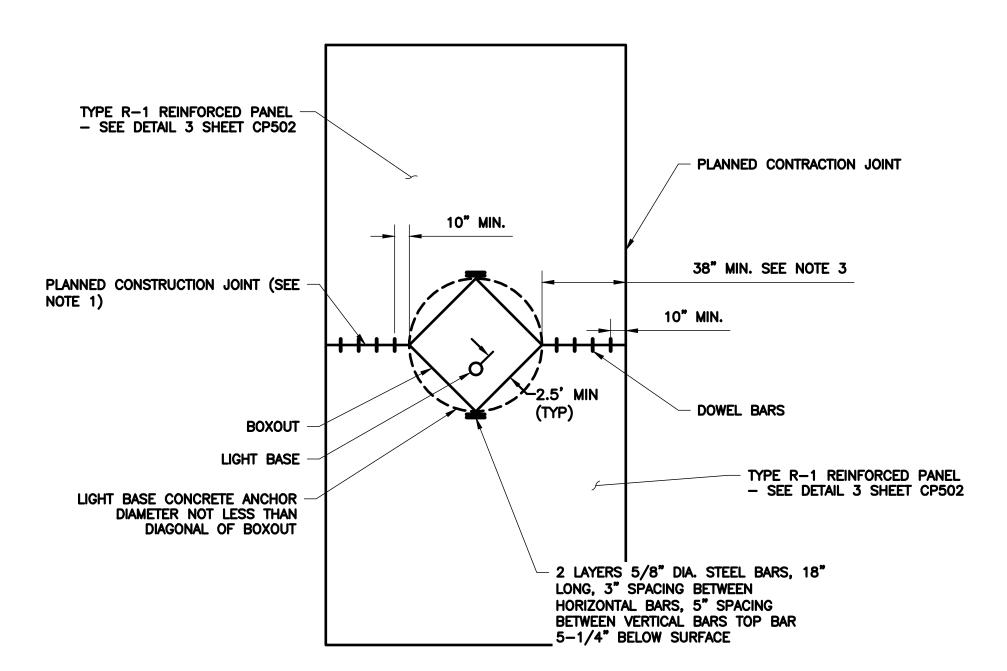
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> DETAIL JOINTING

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PROJECT MGR:	S. CHILDERS
DESIGNER:	D. CRAWFORD
DRAWN BY:	D. CRAWFORD
CHECKED BY:	R. EHTESHAM
SCALE:	AS SHOWN
DATE:	02/24/2023



APPROVED BY: DATE:

DIRECTOR HOUSTON AIRPORT SYSTEM

PROJECT NO: 770


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FILENAME: H22C770A-CP501-503.DWG

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PLOT TIME: 11:06:02 AM



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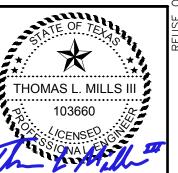
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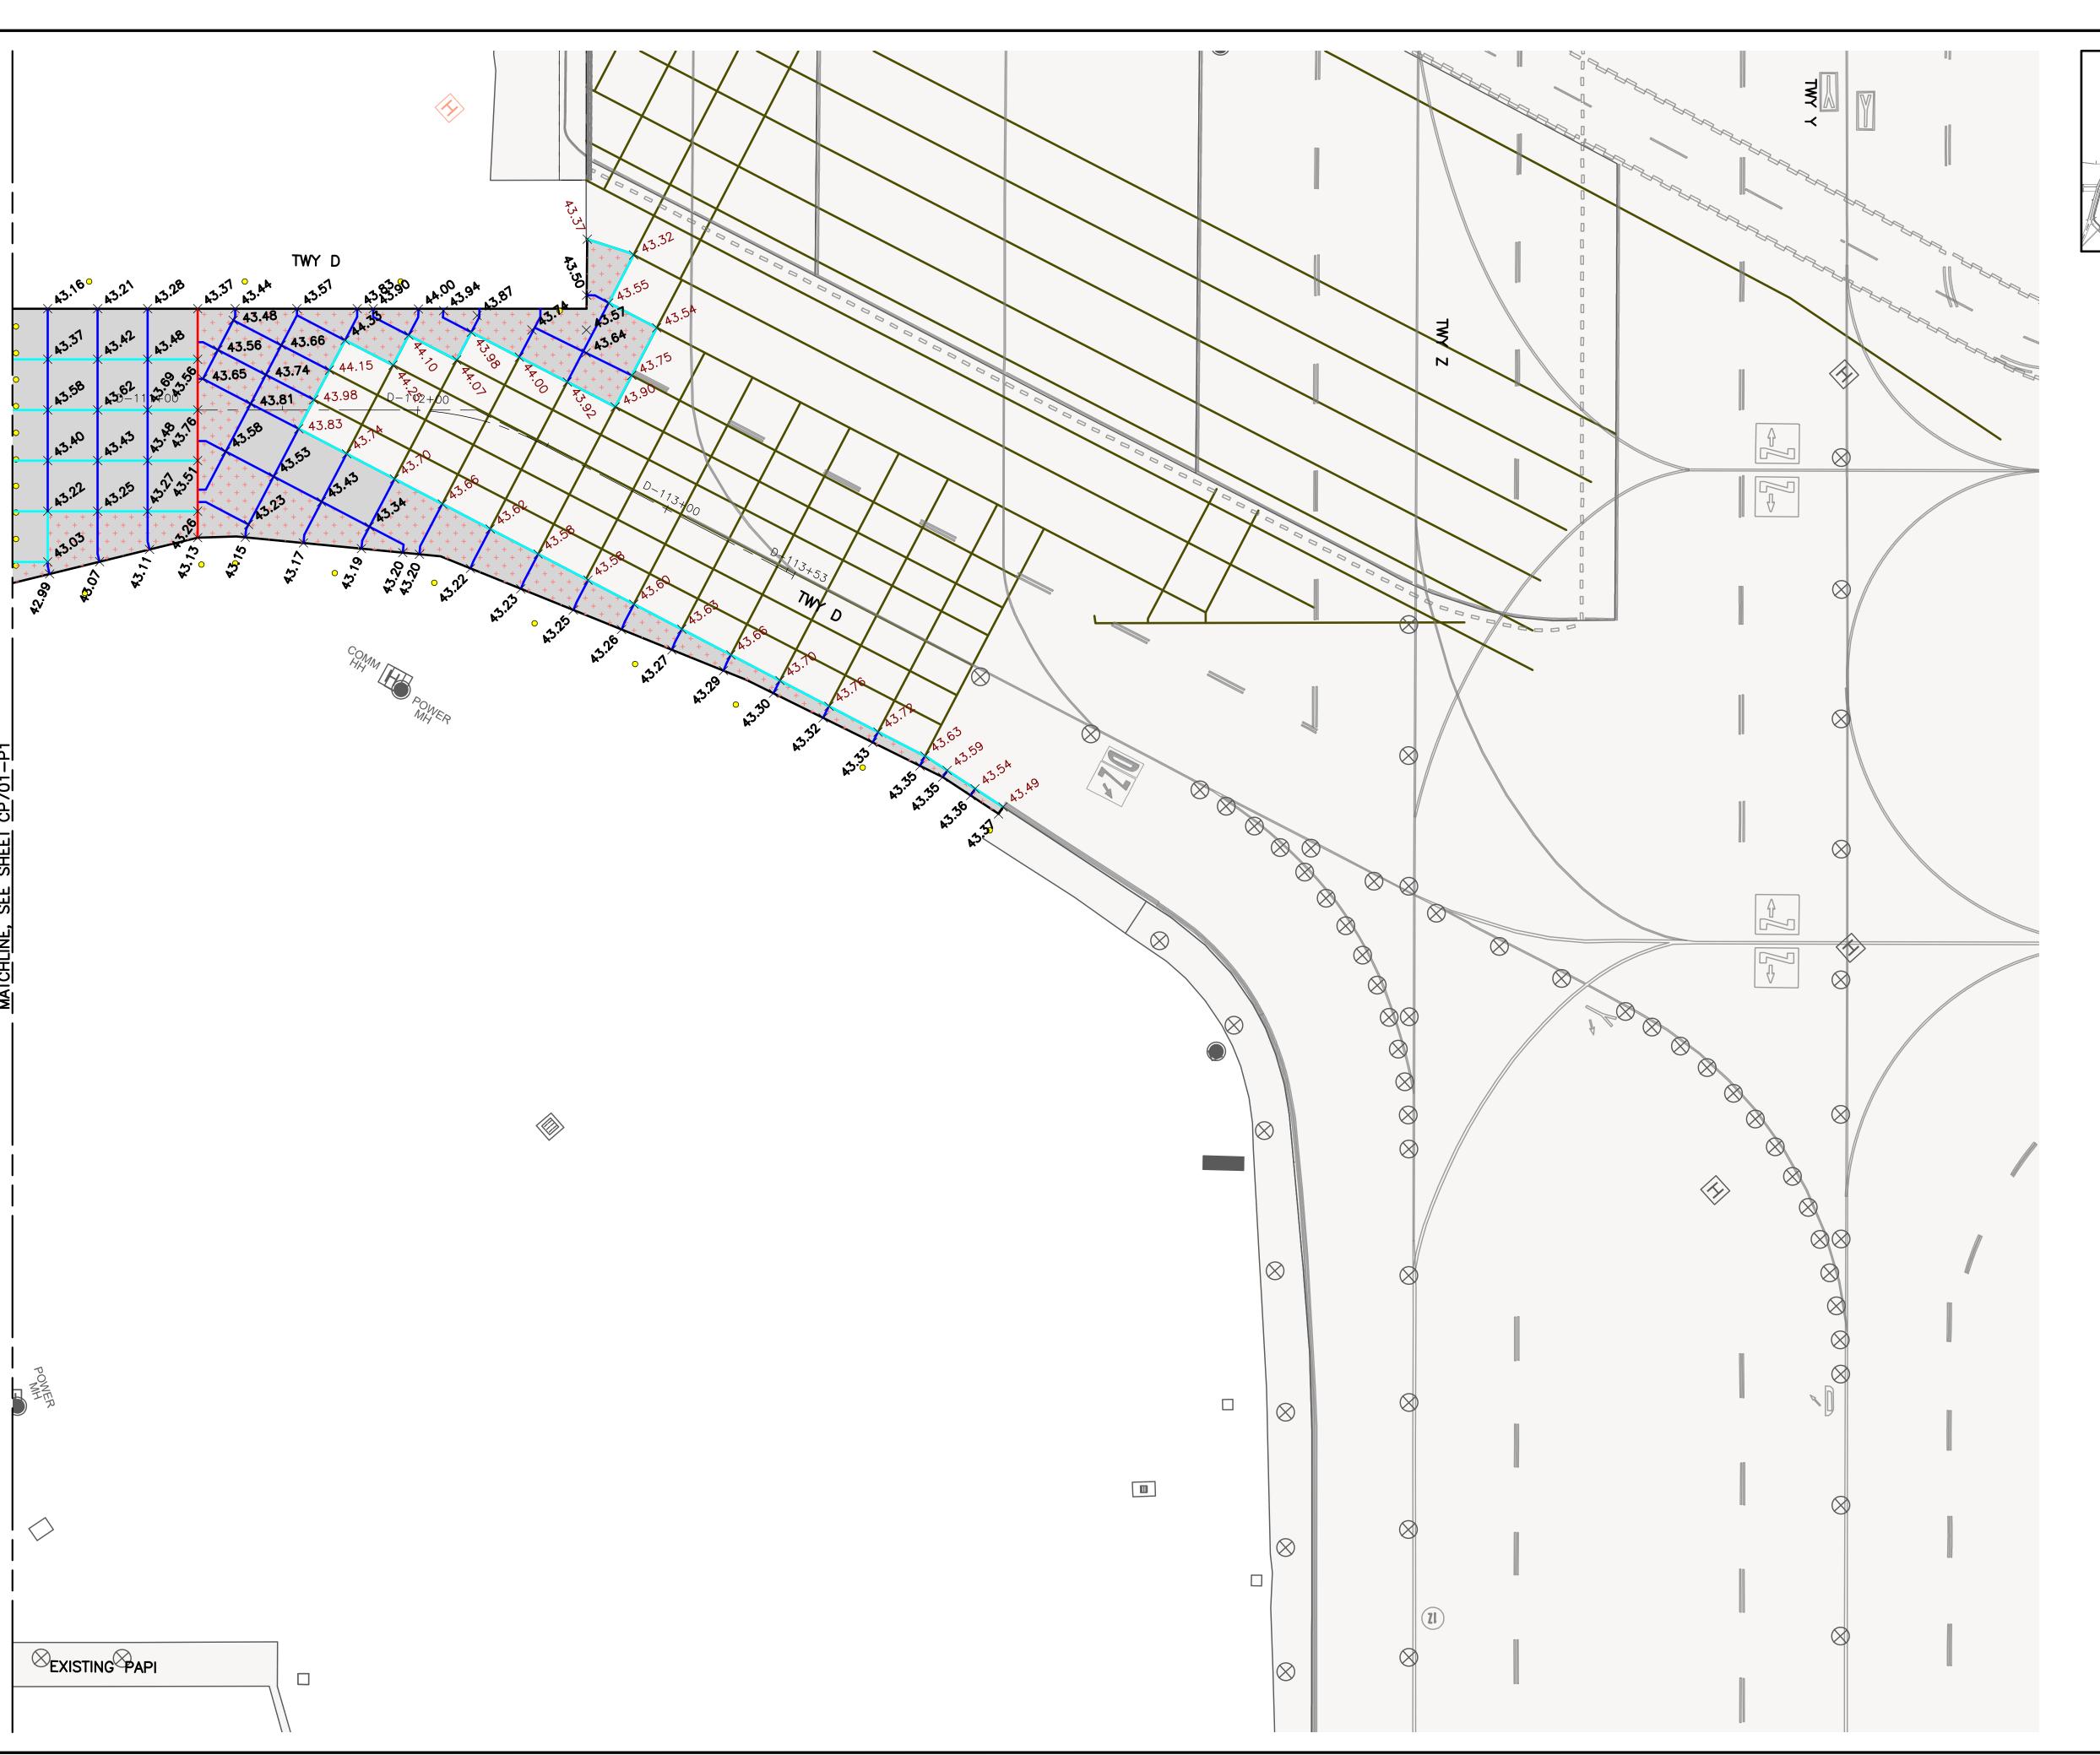



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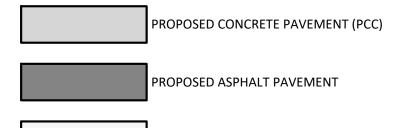


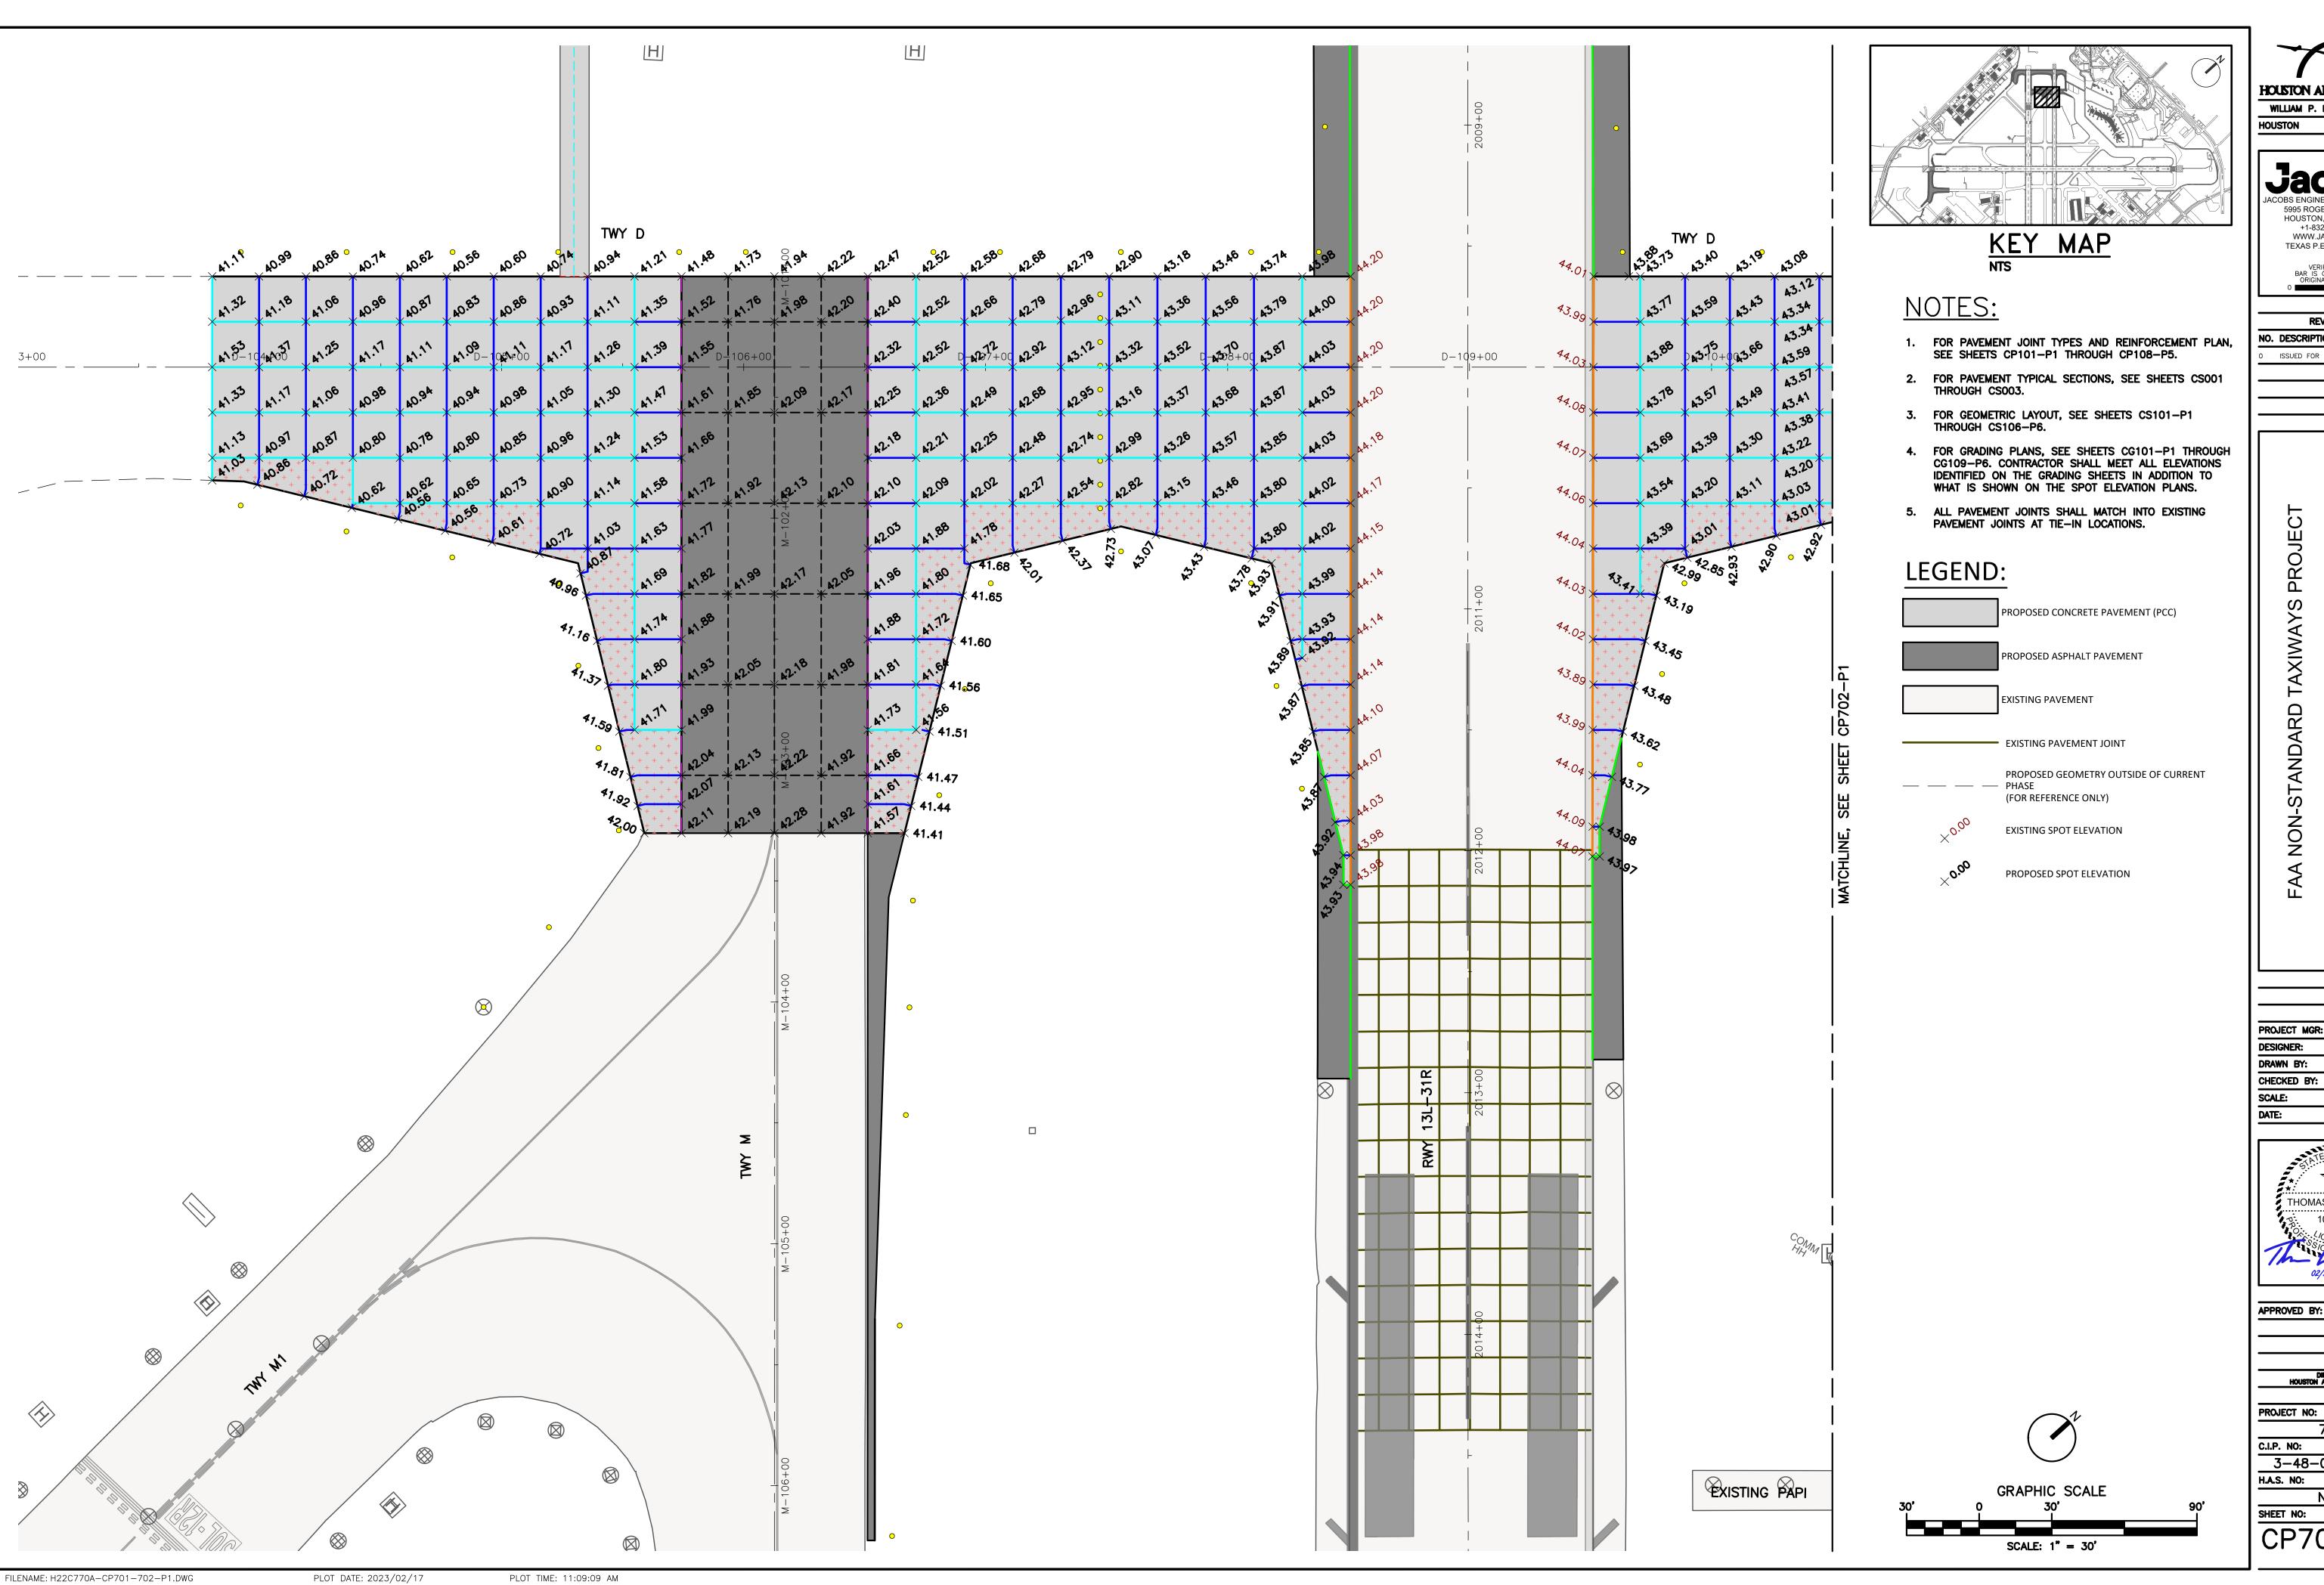MAP

NOTES:

- 1. FOR PAVEMENT JOINT TYPES AND REINFORCEMENT PLAN, SEE SHEETS CP101-P1 THROUGH CP108-P5.
- 2. FOR PAVEMENT TYPICAL SECTIONS, SEE SHEETS CS001 THROUGH CS003.
- 3. FOR GEOMETRIC LAYOUT, SEE SHEETS CS101-P1 THROUGH CS106-P6.
- 4. FOR GRADING PLANS, SEE SHEETS CG101-P1 THROUGH CG109-P6. CONTRACTOR SHALL MEET ALL ELEVATIONS IDENTIFIED ON THE GRADING SHEETS IN ADDITION TO WHAT IS SHOWN ON THE SPOT ELEVATION PLANS.
- 5. ALL PAVEMENT JOINTS SHALL MATCH INTO EXISTING PAVEMENT JOINTS AT TIE-IN LOCATIONS.

LEGEND:

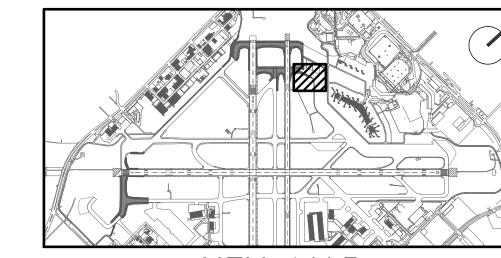


EXISTING PAVEMENT JOINT

PROPOSED GEOMETRY OUTSIDE OF CURRENT (FOR REFERENCE ONLY)

EXISTING PAVEMENT

EXISTING SPOT ELEVATION

PROPOSED SPOT ELEVATION

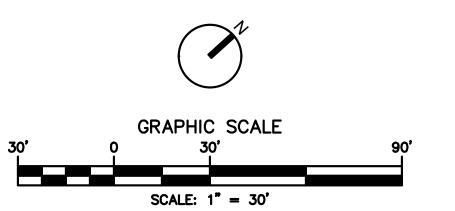



HOUSTON


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PROJECT MGR:

DESIGNER: DRAWN BY: CHECKED BY: SCALE: AS SHOWN 02/24/2023




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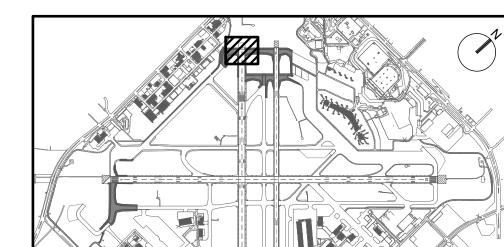
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3-48-0110-044 H.A.S. NO:

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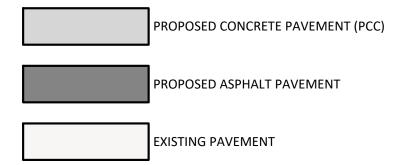
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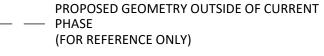


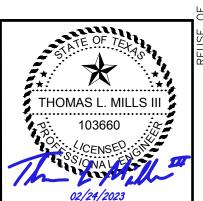KEY MAP

- 1. FOR PAVEMENT JOINT TYPES AND REINFORCEMENT PLAN, SEE SHEETS CP101-P1 THROUGH CP108-P5.
- 2. FOR PAVEMENT TYPICAL SECTIONS, SEE SHEETS CS001
- 3. FOR GEOMETRIC LAYOUT, SEE SHEETS CS101-P1 THROUGH CS106-P6.
- 4. FOR GRADING PLANS, SEE SHEETS CG101-P1 THROUGH CG109-P6. CONTRACTOR SHALL MEET ALL ELEVATIONS IDENTIFIED ON THE GRADING SHEETS IN ADDITION TO WHAT IS SHOWN ON THE SPOT ELEVATION PLANS.
- 5. ALL PAVEMENT JOINTS SHALL MATCH INTO EXISTING PAVEMENT JOINTS AT TIE-IN LOCATIONS.

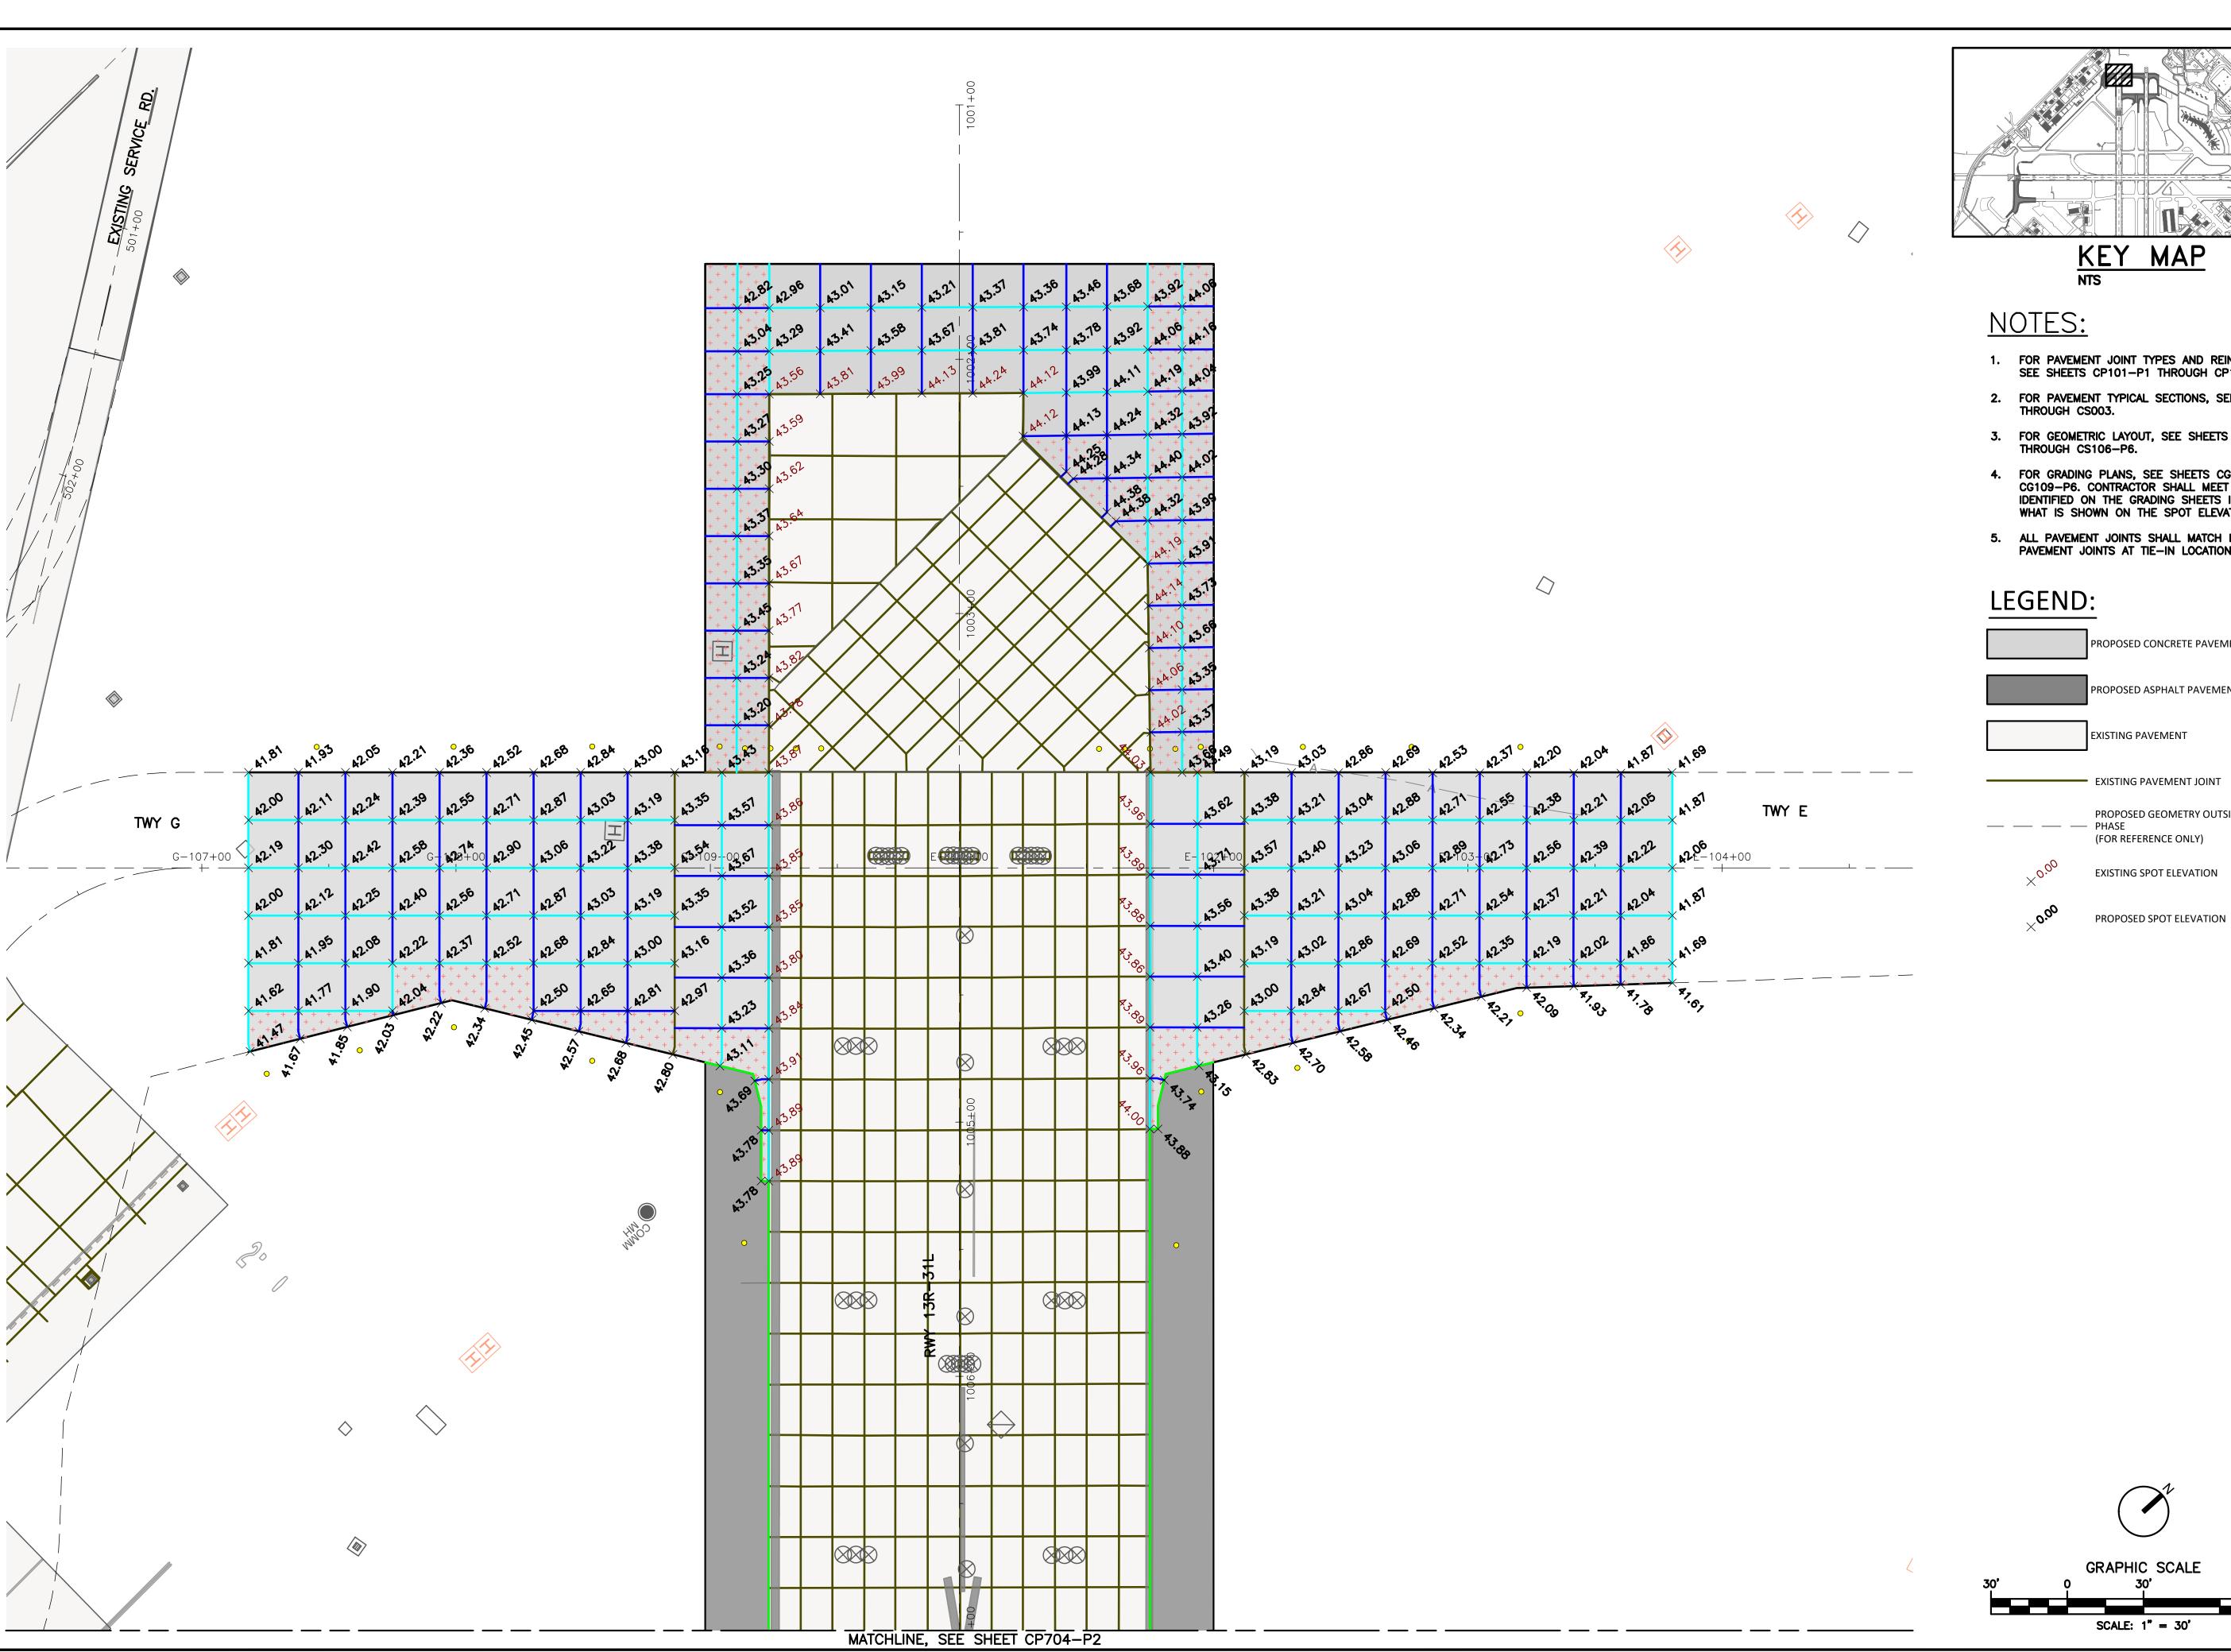

EXISTING PAVEMENT JOINT



EXISTING SPOT ELEVATION

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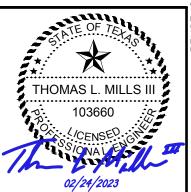
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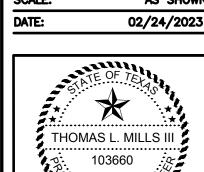


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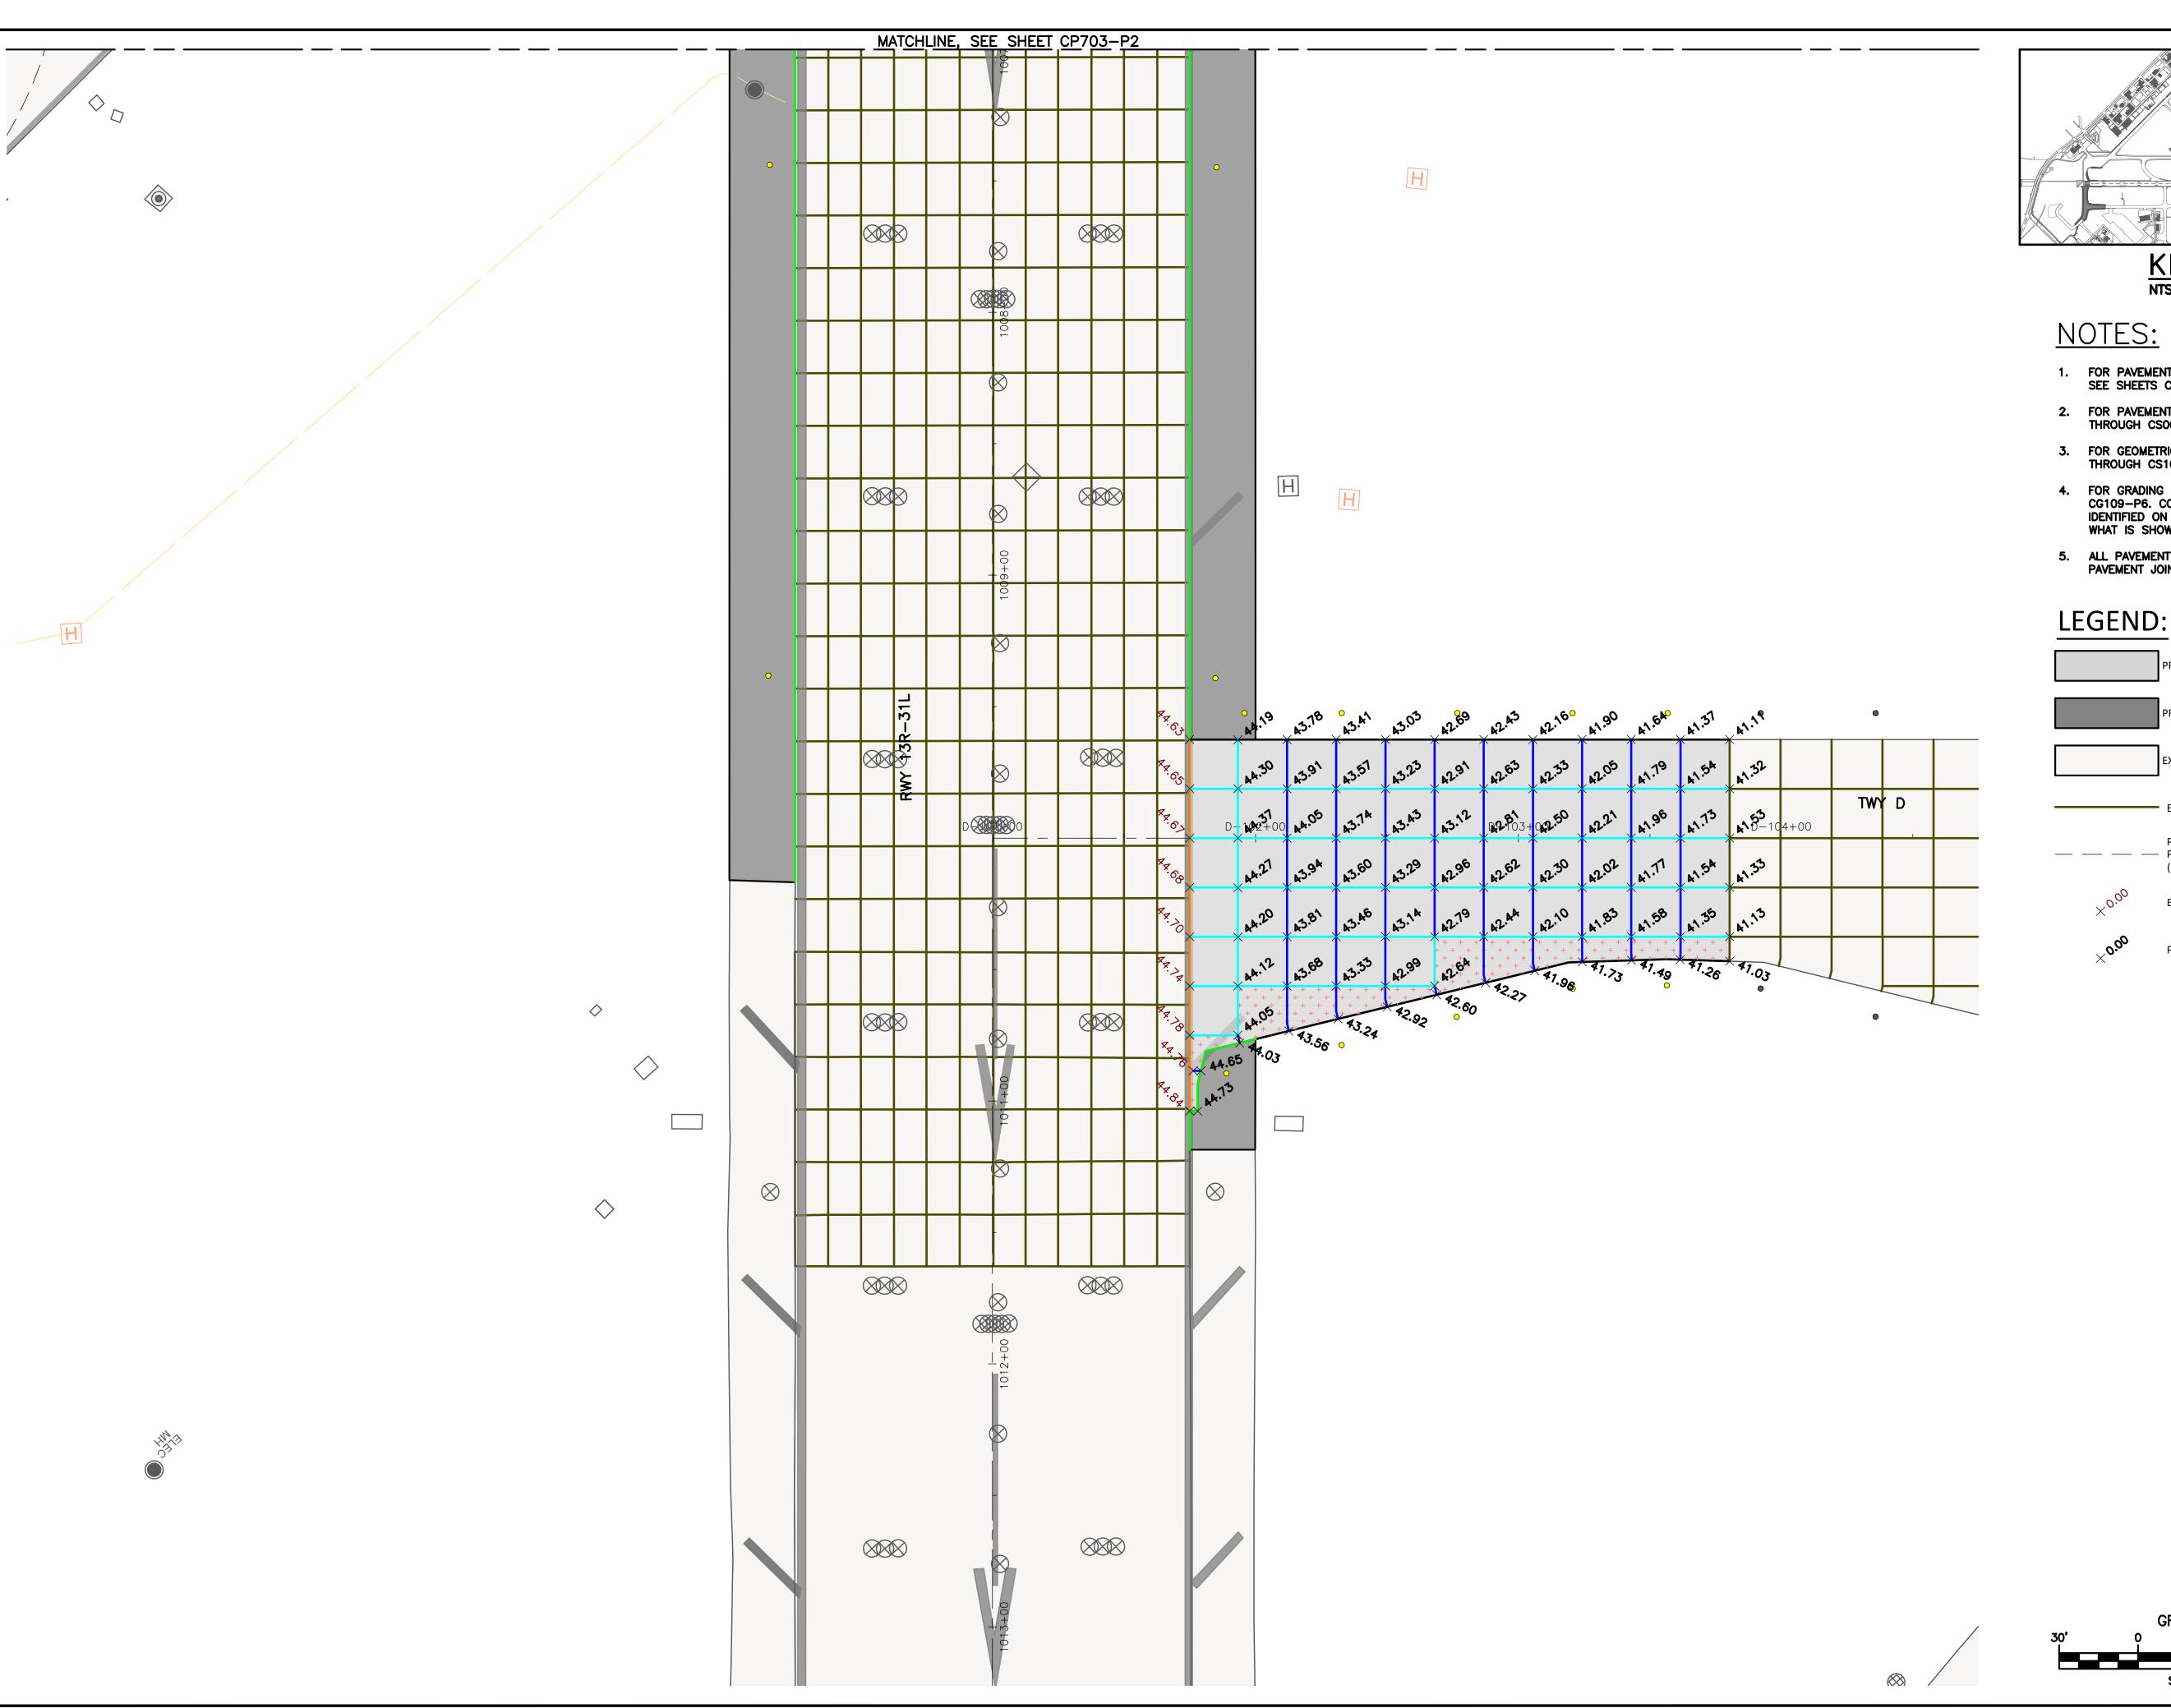
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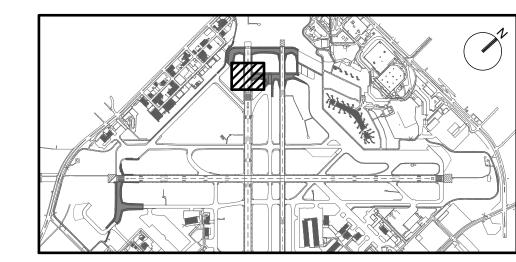


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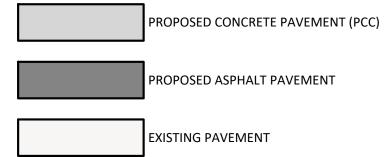
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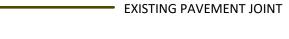





KEY MAP

- 1. FOR PAVEMENT JOINT TYPES AND REINFORCEMENT PLAN, SEE SHEETS CP101-P1 THROUGH CP108-P5.
- 2. FOR PAVEMENT TYPICAL SECTIONS, SEE SHEETS CS001 THROUGH CS003.
- 3. FOR GEOMETRIC LAYOUT, SEE SHEETS CS101-P1 THROUGH CS106-P6.
- 4. FOR GRADING PLANS, SEE SHEETS CG101-P1 THROUGH CG109-P6. CONTRACTOR SHALL MEET ALL ELEVATIONS IDENTIFIED ON THE GRADING SHEETS IN ADDITION TO WHAT IS SHOWN ON THE SPOT ELEVATION PLANS.
- 5. ALL PAVEMENT JOINTS SHALL MATCH INTO EXISTING PAVEMENT JOINTS AT TIE-IN LOCATIONS.





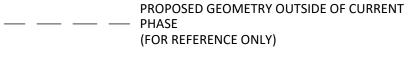

EXISTING SPOT ELEVATION

PROPOSED SPOT ELEVATION

SCALE: 1" = 30'

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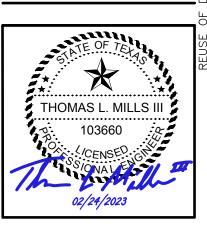


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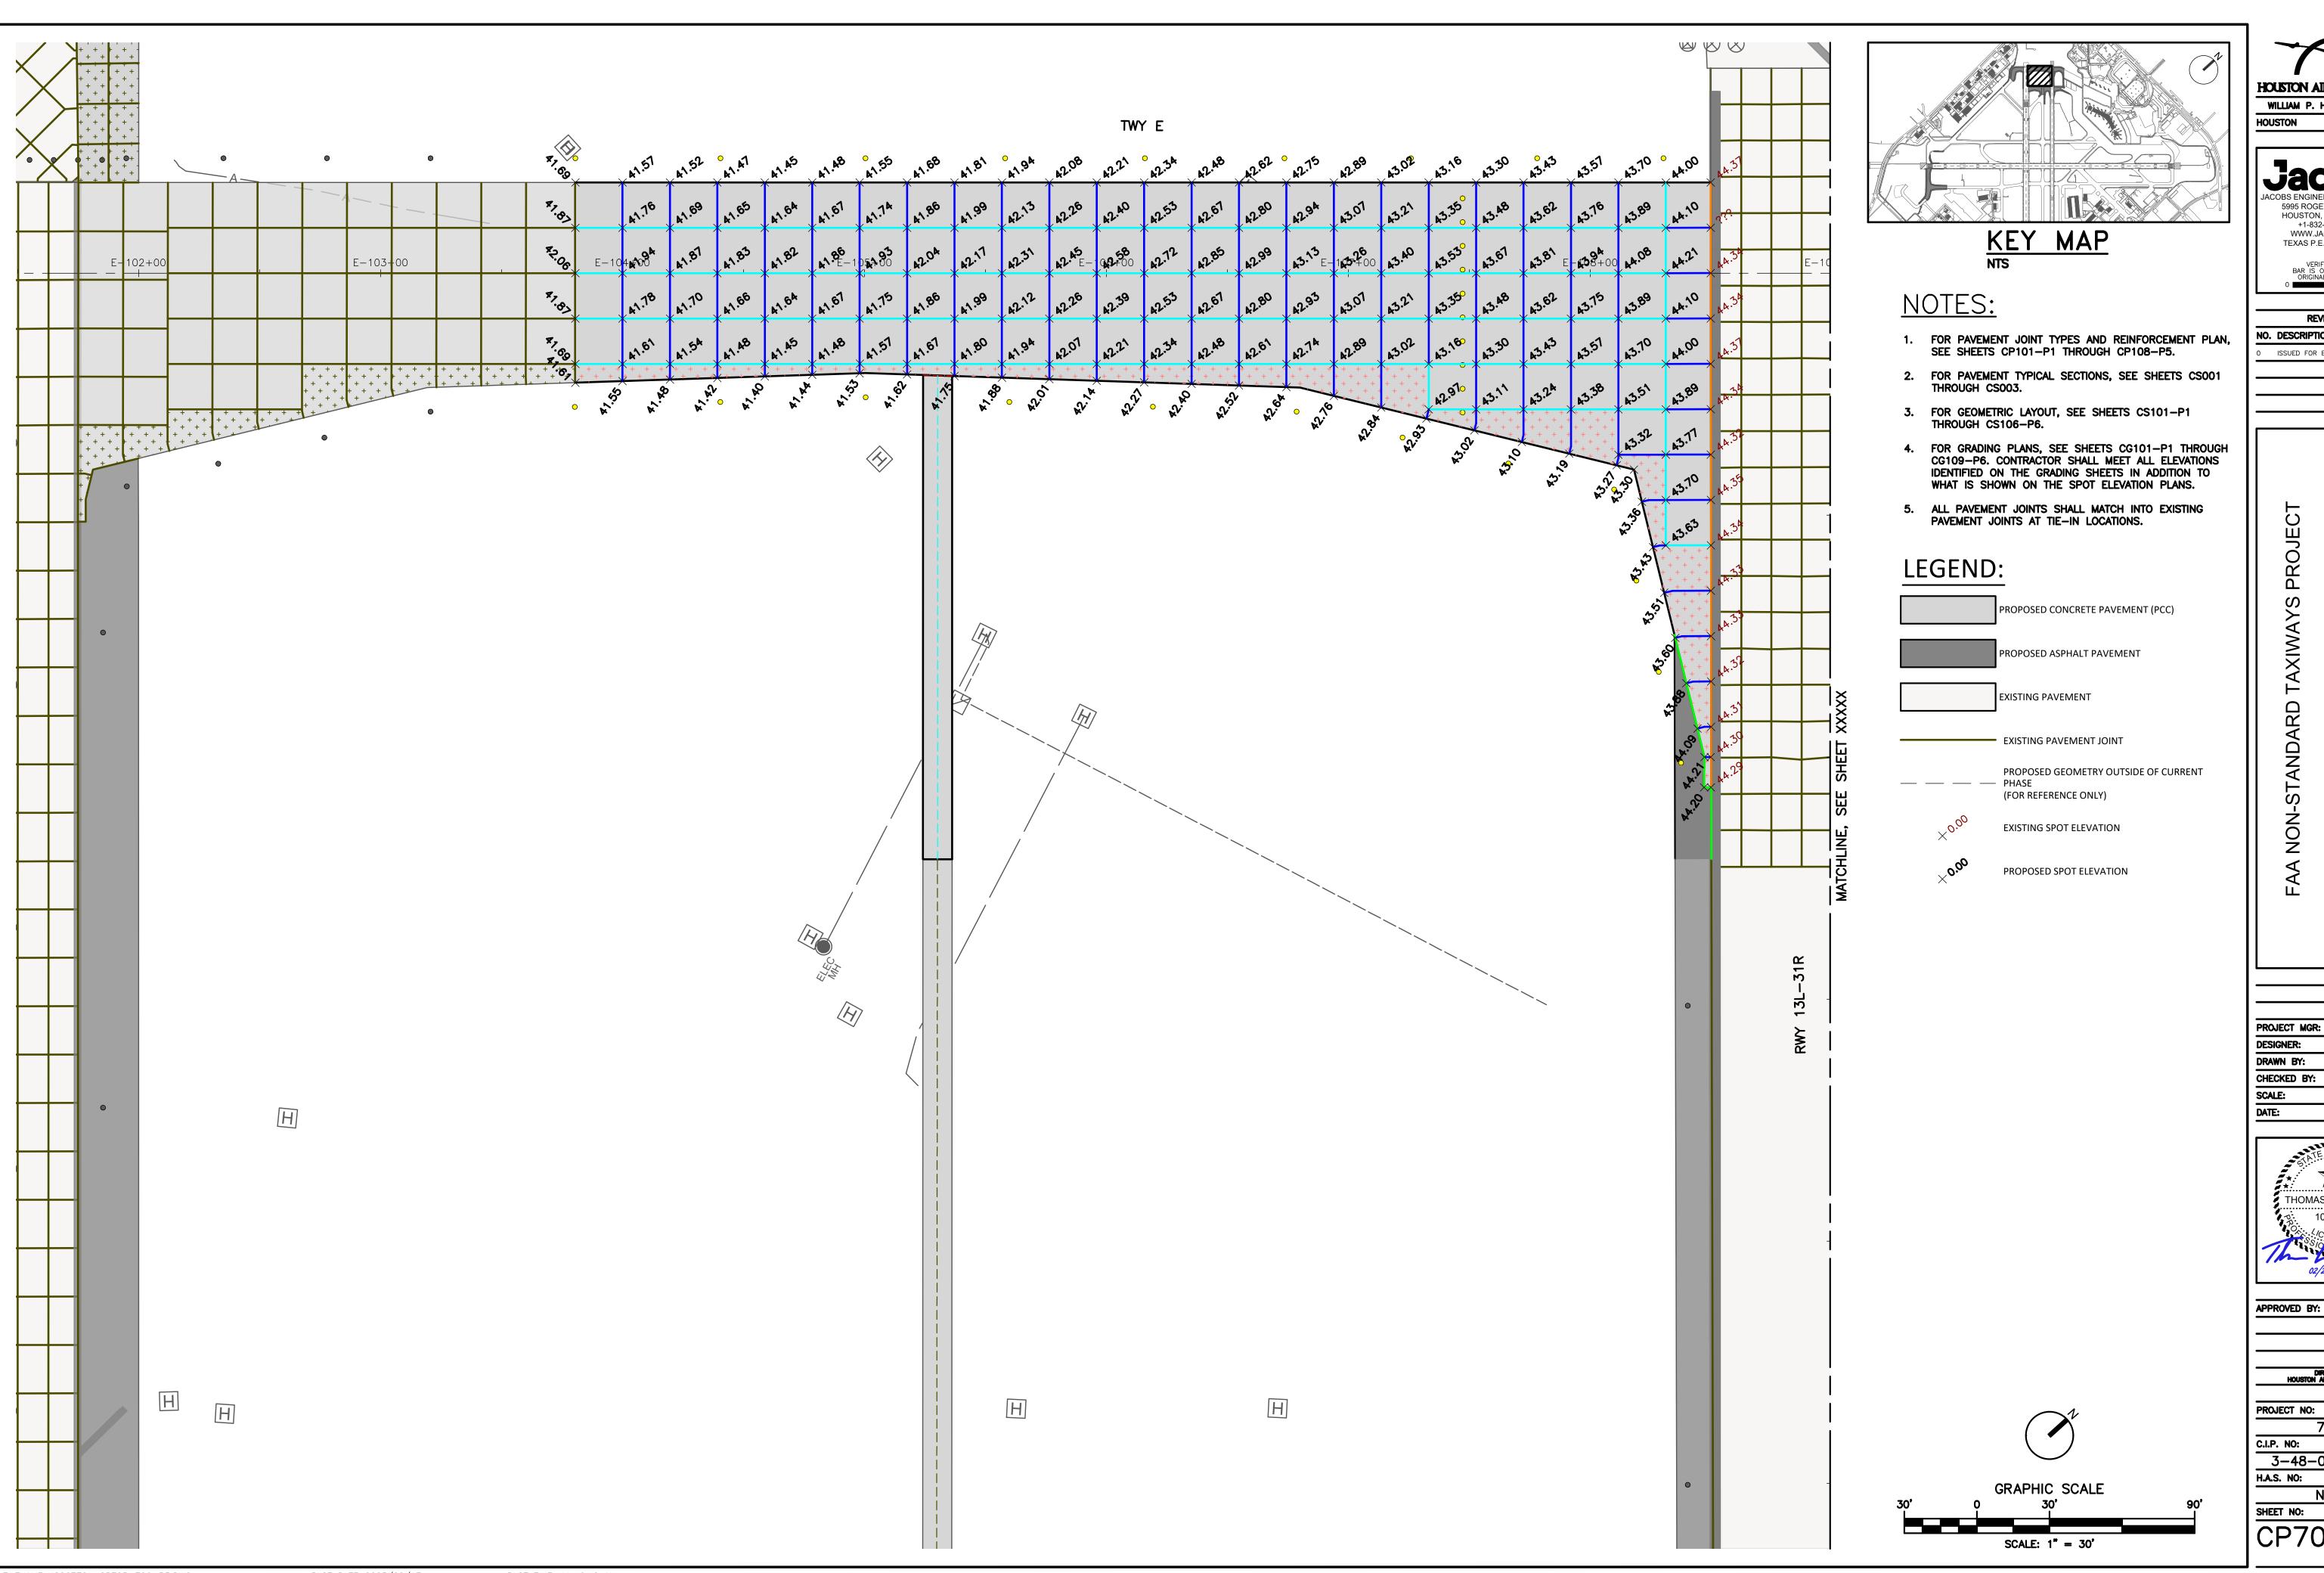
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DIRECTOR HOUSTON AIRPORT SYSTEM	

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PLOT TIME: 11:12:59 AM



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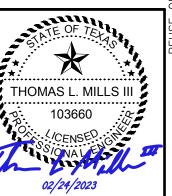
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02/24/2023




DIRECTOR HOUSTON AIRPORT SYSTEM


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3-48-0110-044 H.A.S. NO:

PLOT DATE: 2023/02/17 FILENAME: H22C770A-CP705-706-P3.DWG

PLOT TIME: 11:16:10 AM



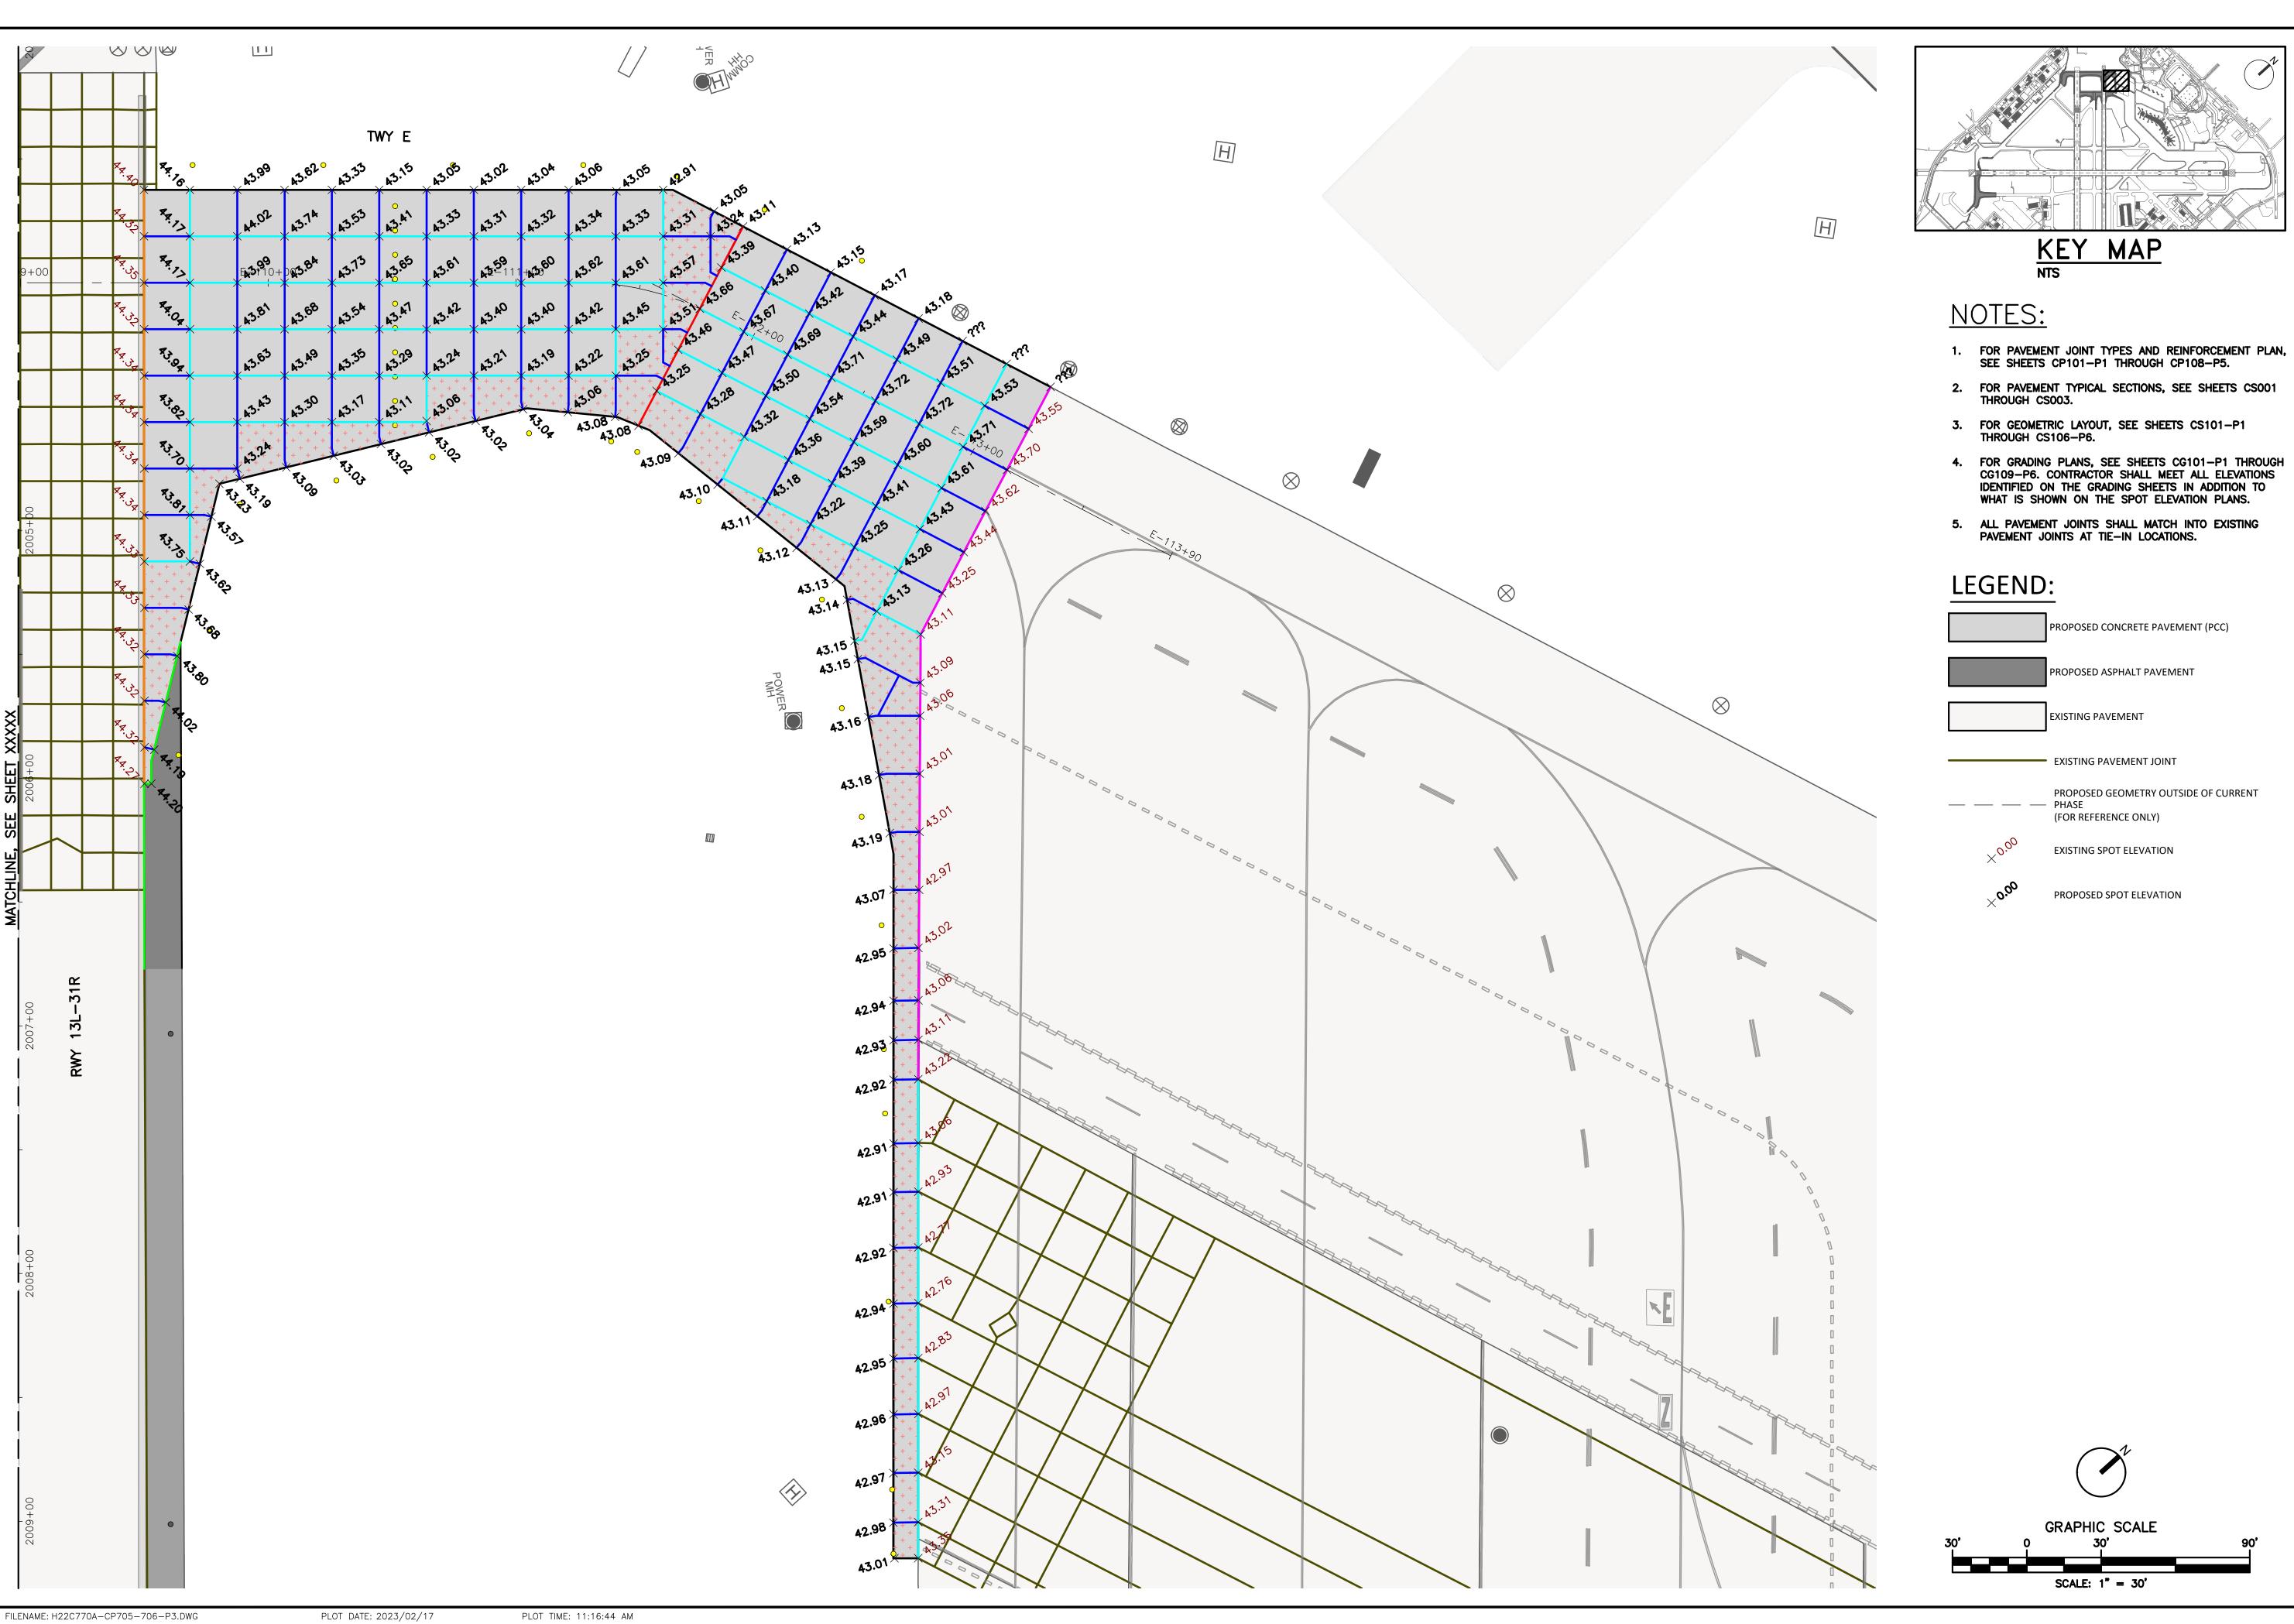

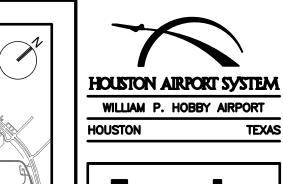

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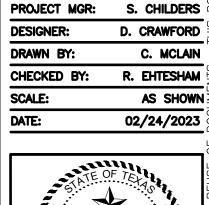
D. CRAWFORD R. EHTESHAM




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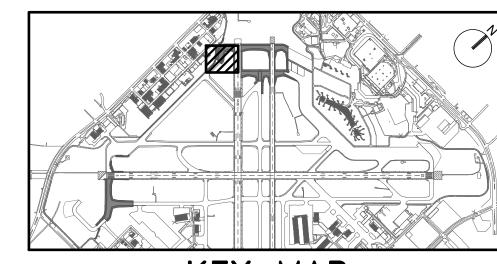
PLOT TIME: 11:16:44 AM

EXISTING SPOT ELEVATION



770 C.I.P. NO: 3-48-0110-044 H.A.S. NO:



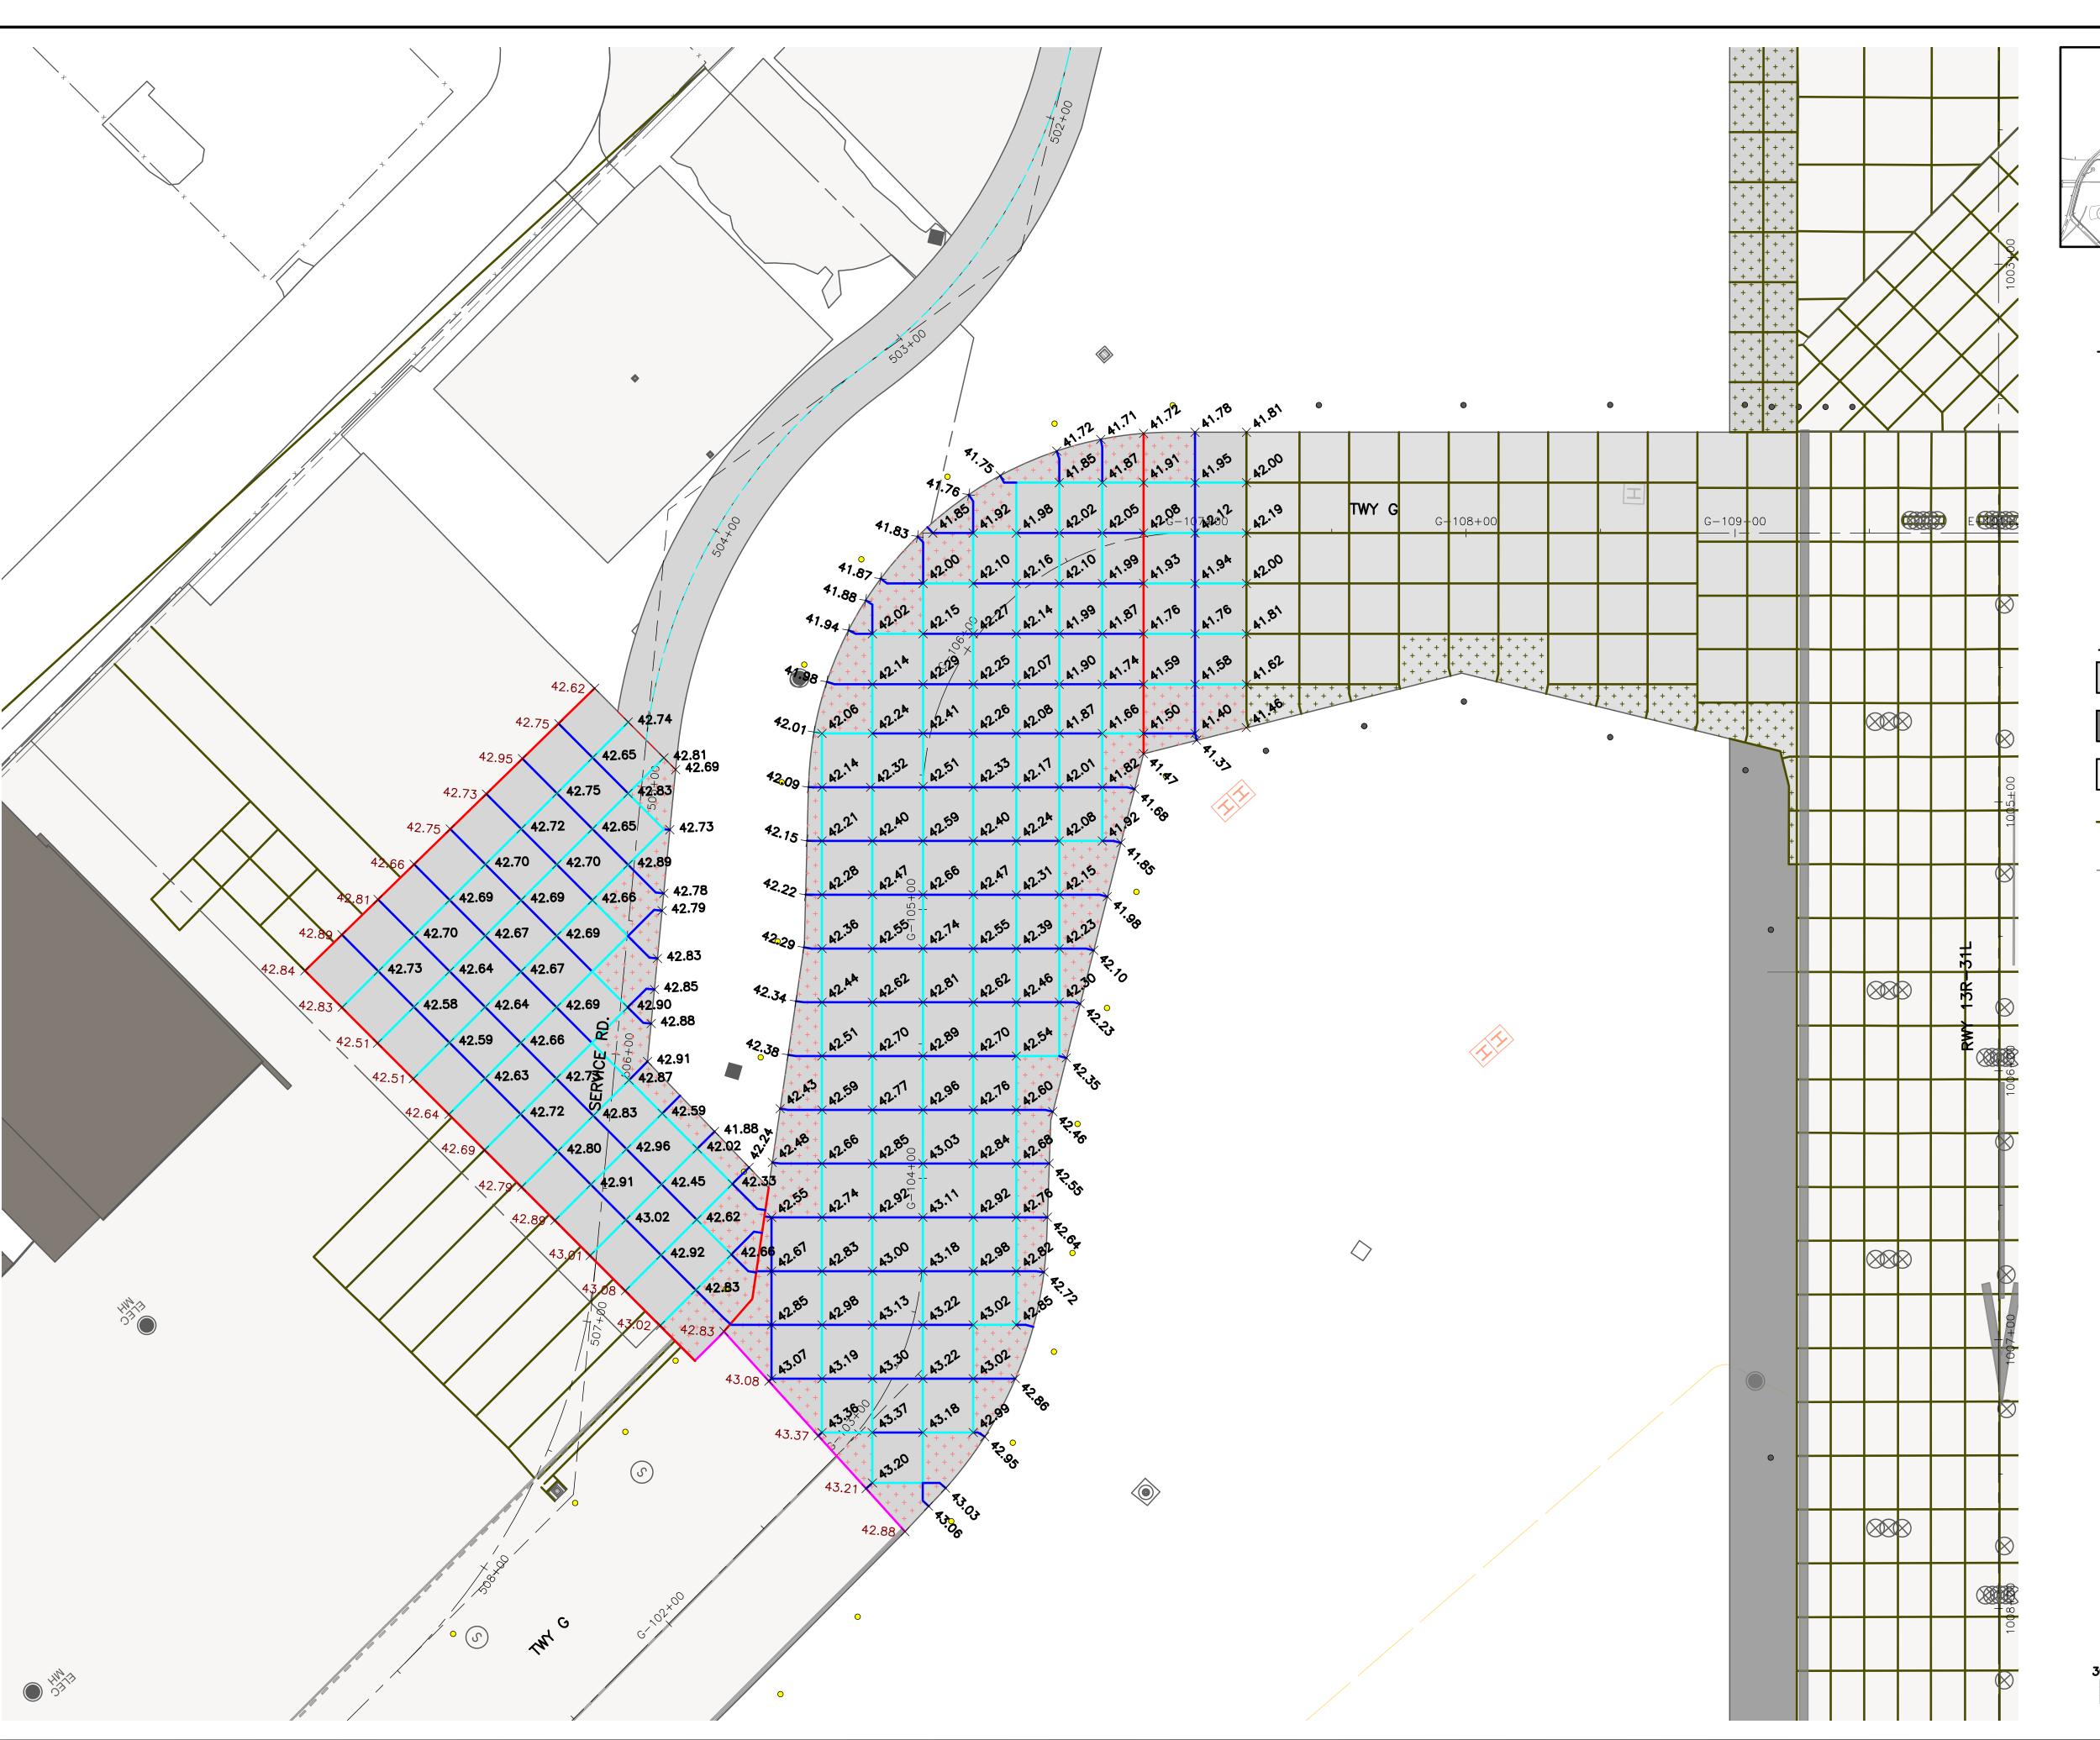

KEY MAP

NOTES:

- 1. FOR PAVEMENT JOINT TYPES AND REINFORCEMENT PLAN, SEE SHEETS CP101-P1 THROUGH CP108-P5.
- 2. FOR PAVEMENT TYPICAL SECTIONS, SEE SHEETS CS001 THROUGH CS003.
- 3. FOR GEOMETRIC LAYOUT, SEE SHEETS CS101-P1 THROUGH CS106-P6.
- 4. FOR GRADING PLANS, SEE SHEETS CG101-P1 THROUGH CG109-P6. CONTRACTOR SHALL MEET ALL ELEVATIONS IDENTIFIED ON THE GRADING SHEETS IN ADDITION TO WHAT IS SHOWN ON THE SPOT ELEVATION PLANS.
- 5. ALL PAVEMENT JOINTS SHALL MATCH INTO EXISTING PAVEMENT JOINTS AT TIE-IN LOCATIONS.

LEGEND:

PROPOSED CONCRETE PAVEMENT (PCC) PROPOSED ASPHALT PAVEMENT **EXISTING PAVEMENT**

EXISTING PAVEMENT JOINT

PROPOSED GEOMETRY OUTSIDE OF CURRENT (FOR REFERENCE ONLY)

EXISTING SPOT ELEVATION

PROPOSED SPOT ELEVATION

D. CRAWFORD C. MCLAIN R. EHTESHAM CHECKED BY: AS SHOWN 02/24/2023

PROJECT MGR: S. CHILDERS

HOUSTON AIRPORT SYSTEM WILLIAM P. HOBBY AIRPORT


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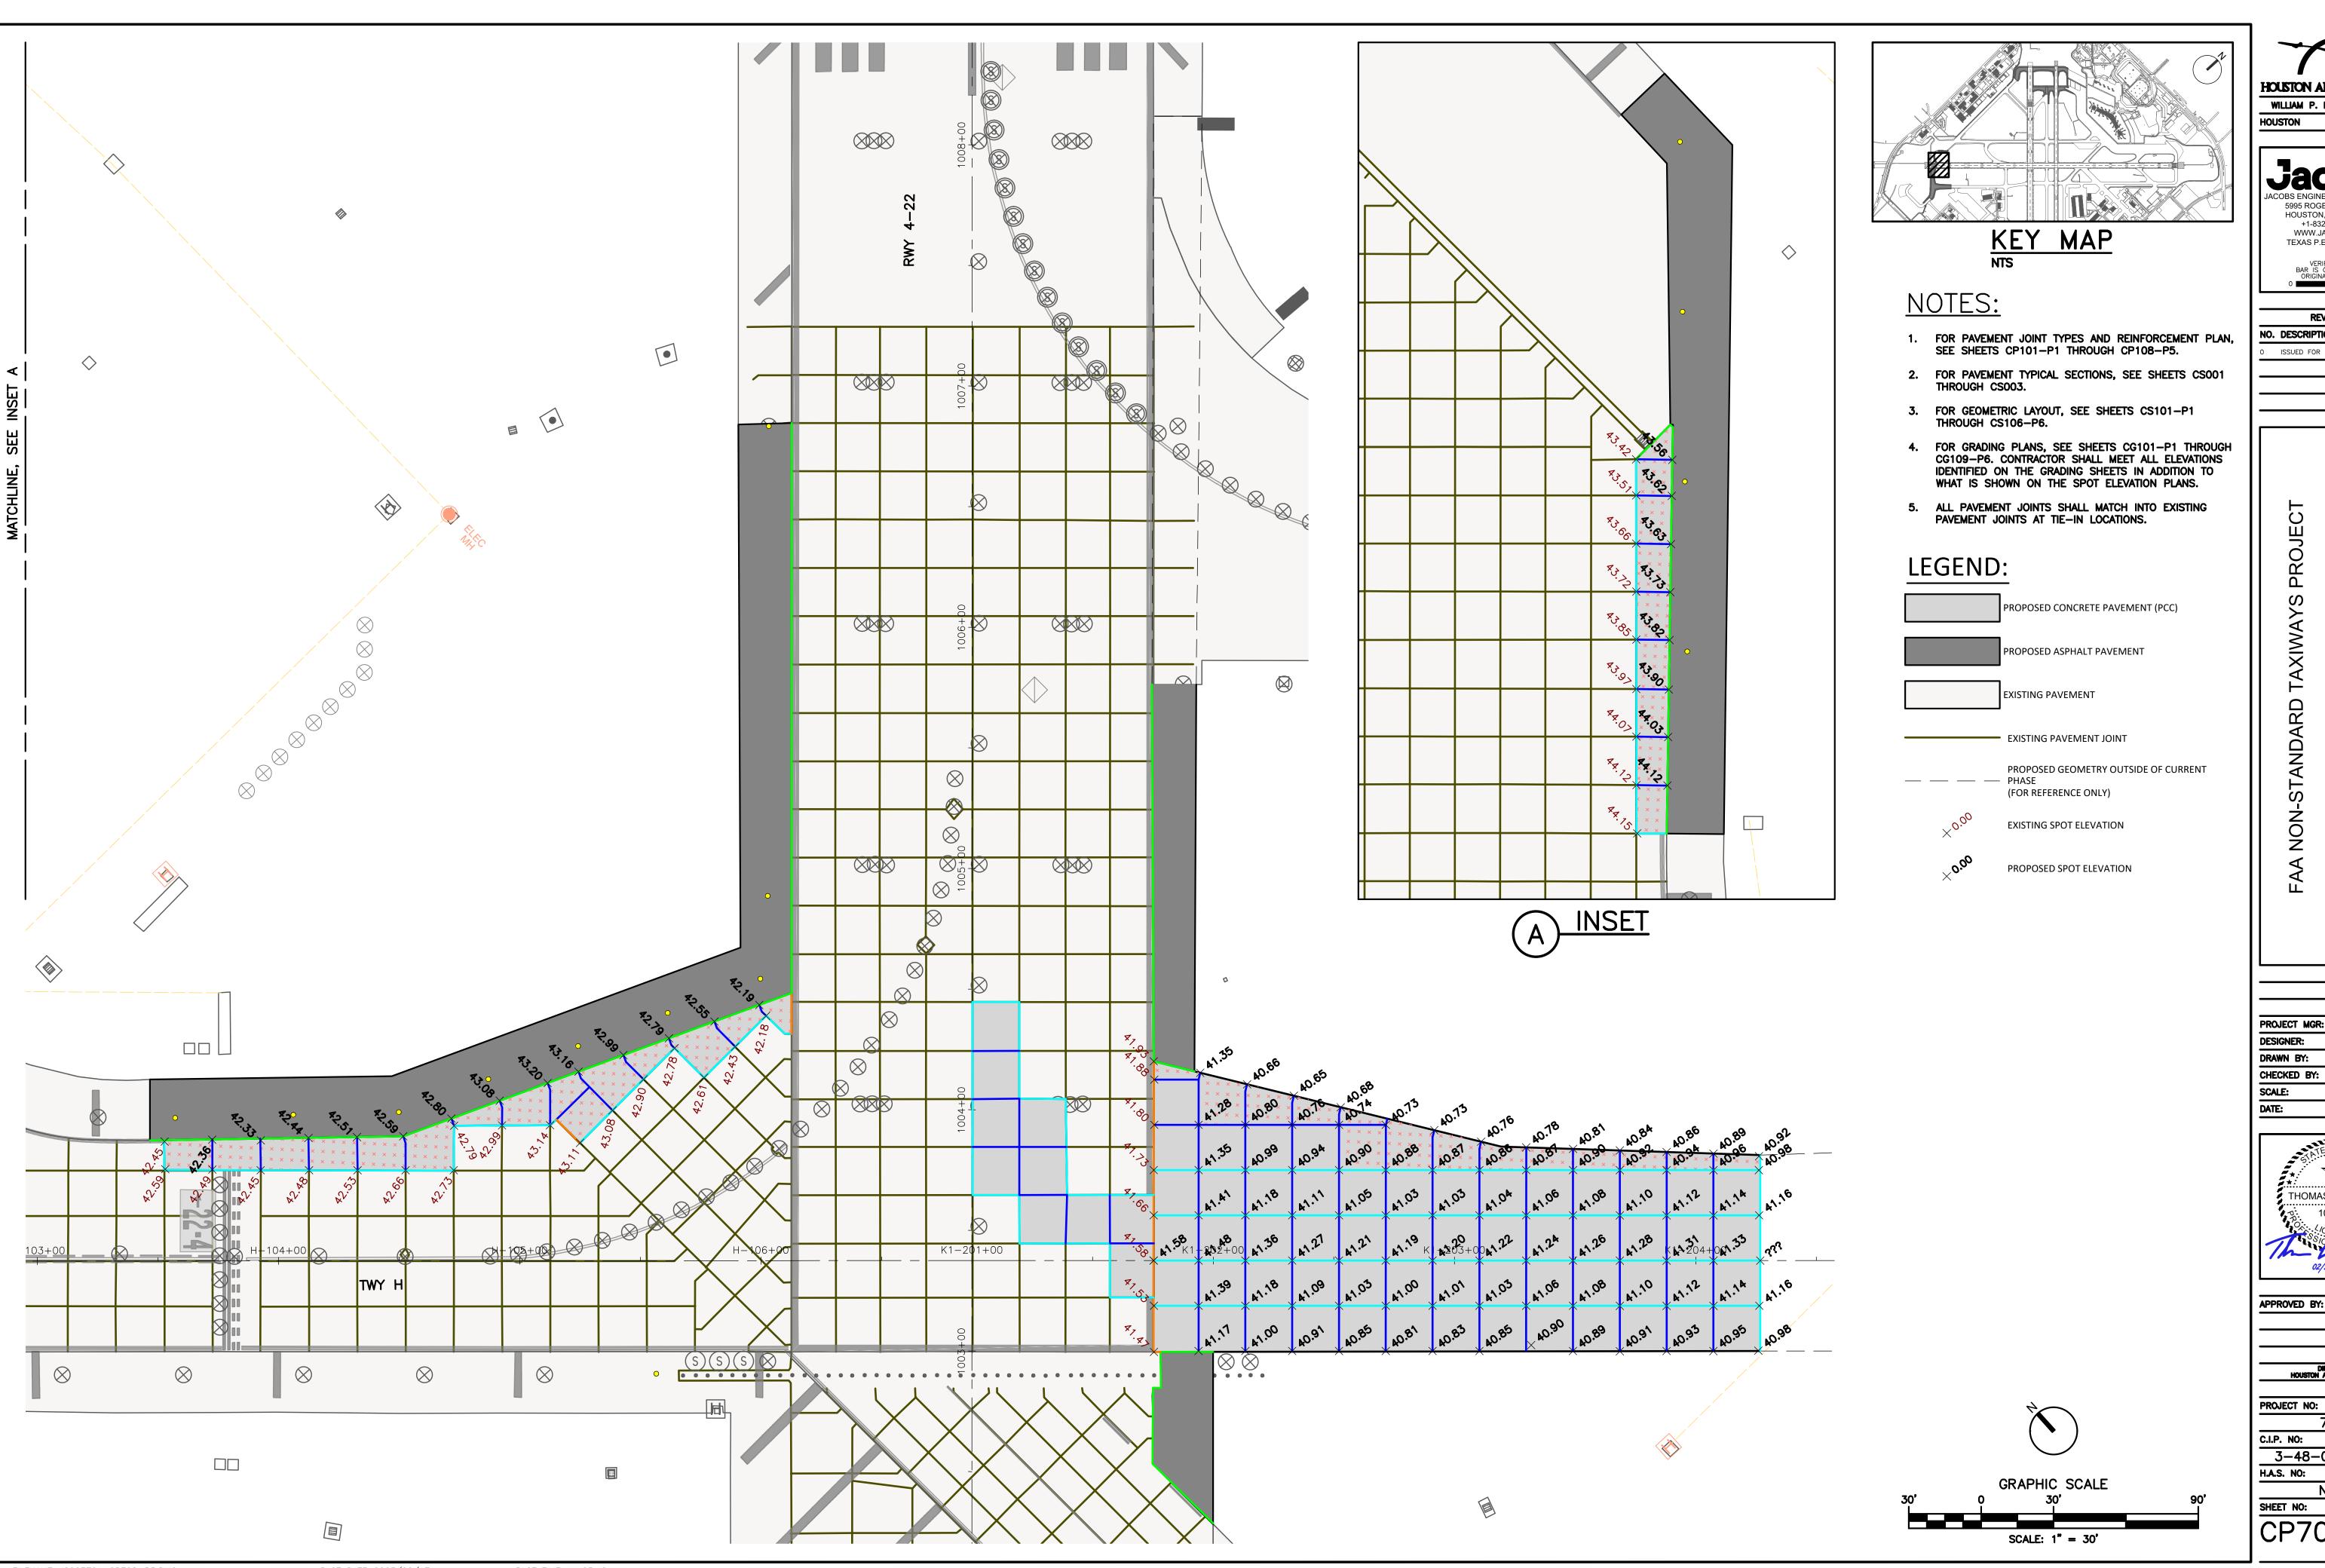
C.I.P. NO: 3-48-0110-044 H.A.S. NO:

PLOT DATE: 2023/02/17

FILENAME: H22C770A-CP707-P4.DWG

PLOT TIME: 11:18:53 AM

SCALE: 1" = 30'

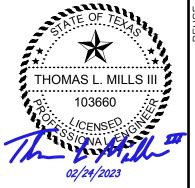

HOUSTON AIRPORT SYSTEM WILLIAM P. HOBBY AIRPORT


5995 ROGERDALE ROAD HOUSTON, TEXAS 77072

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NO. DESCRIPTION DATE BY ISSUED FOR BID 02/24/2023 SC

PROJECT MGR: S. CHILDERS D. CRAWFORD C. MCLAIN R. EHTESHAM AS SHOWN 02/24/2023




PROJECT NO: 770

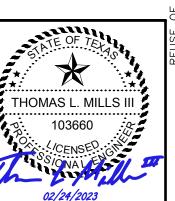
3-48-0110-044

FILENAME: H22C770A-CP708-P5.DWG

PLOT DATE: 2023/02/17


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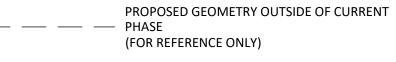


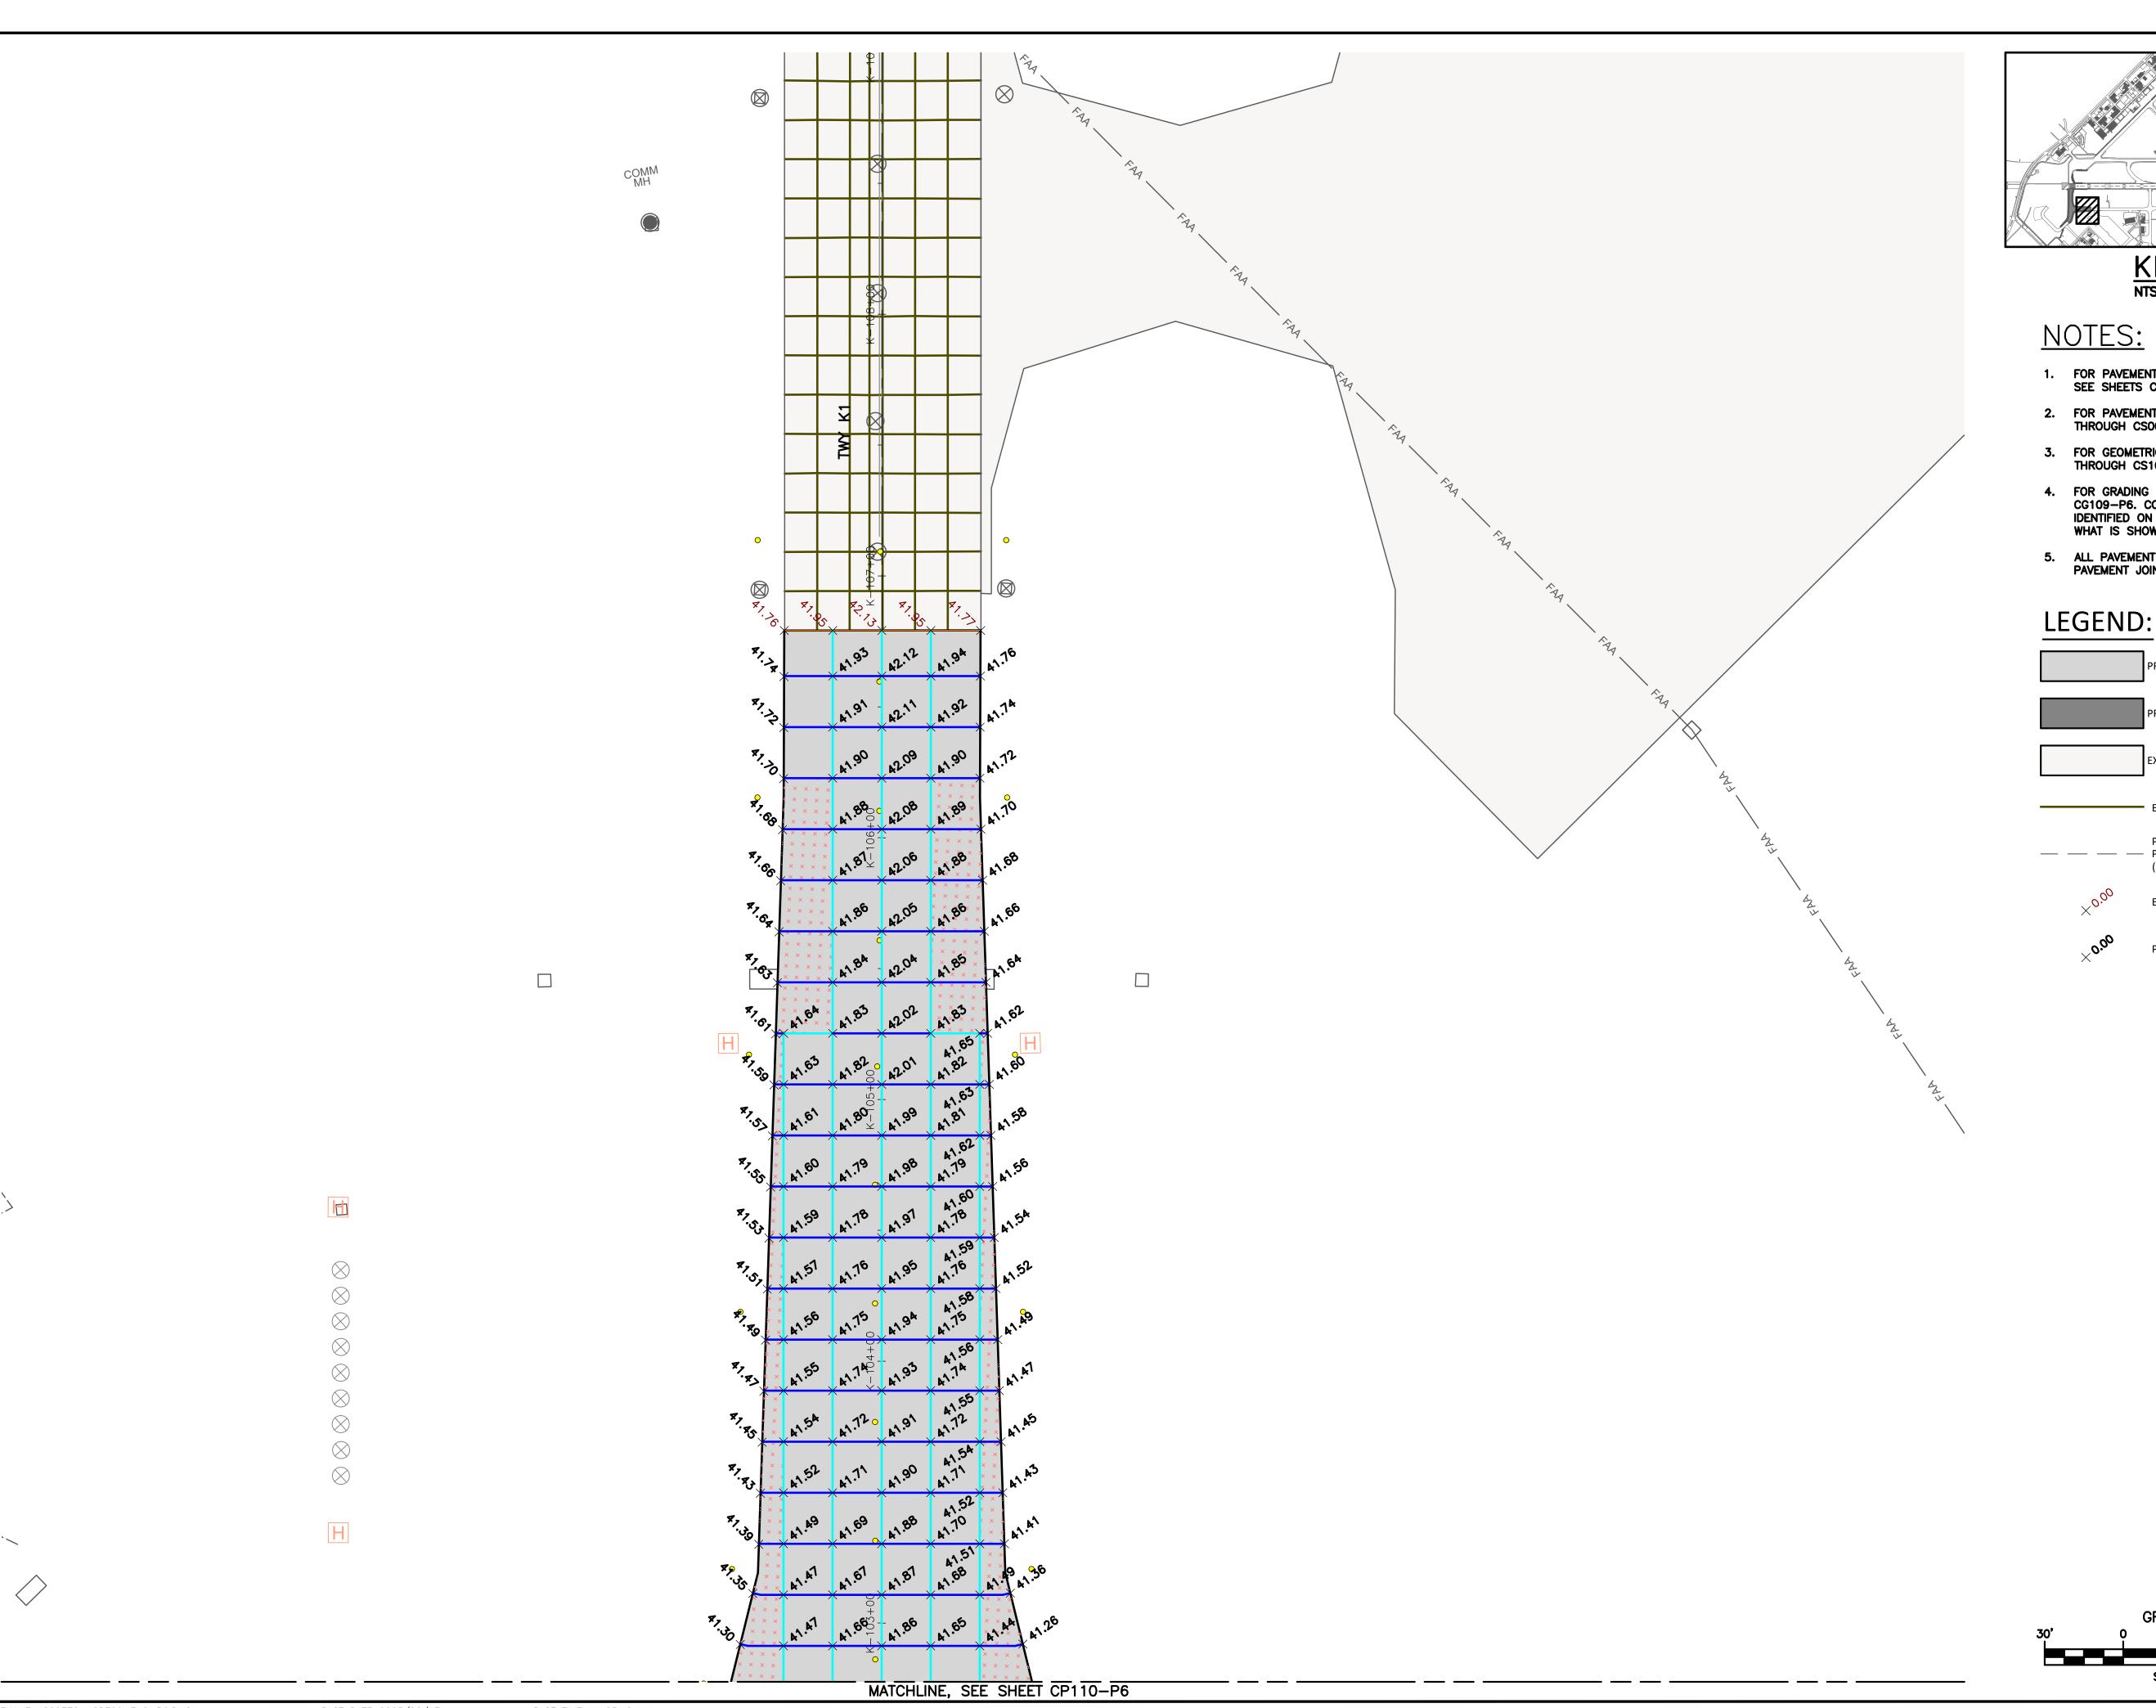KEY MAP

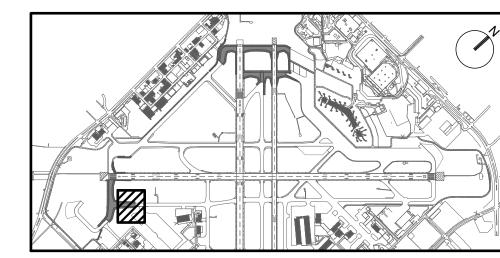- 1. FOR PAVEMENT JOINT TYPES AND REINFORCEMENT PLAN, SEE SHEETS CP101-P1 THROUGH CP108-P5.
- 2. FOR PAVEMENT TYPICAL SECTIONS, SEE SHEETS CS001 THROUGH CS003.
- 3. FOR GEOMETRIC LAYOUT, SEE SHEETS CS101-P1 THROUGH CS106-P6.
- 4. FOR GRADING PLANS, SEE SHEETS CG101-P1 THROUGH CG109-P6. CONTRACTOR SHALL MEET ALL ELEVATIONS IDENTIFIED ON THE GRADING SHEETS IN ADDITION TO WHAT IS SHOWN ON THE SPOT ELEVATION PLANS.
- 5. ALL PAVEMENT JOINTS SHALL MATCH INTO EXISTING PAVEMENT JOINTS AT TIE-IN LOCATIONS.





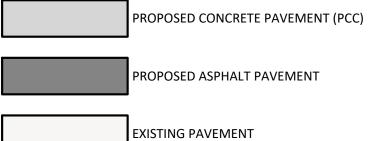




PROPOSED SPOT ELEVATION

SCALE: 1" = 30'

PROJECT MGR: S. CHILDERS DESIGNER: D. CRAWFORD DRAWN BY: C. MCLAIN

CHECKED BY:

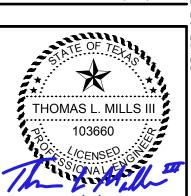

APPROVED BY:

PROJECT NO: 770

C.I.P. NO: 3-48-0110-044

PLOT TIME: 11:25:40 AM

FILENAME: H22C770A-CP709-710-P6.DWG

PLOT DATE: 2023/02/17

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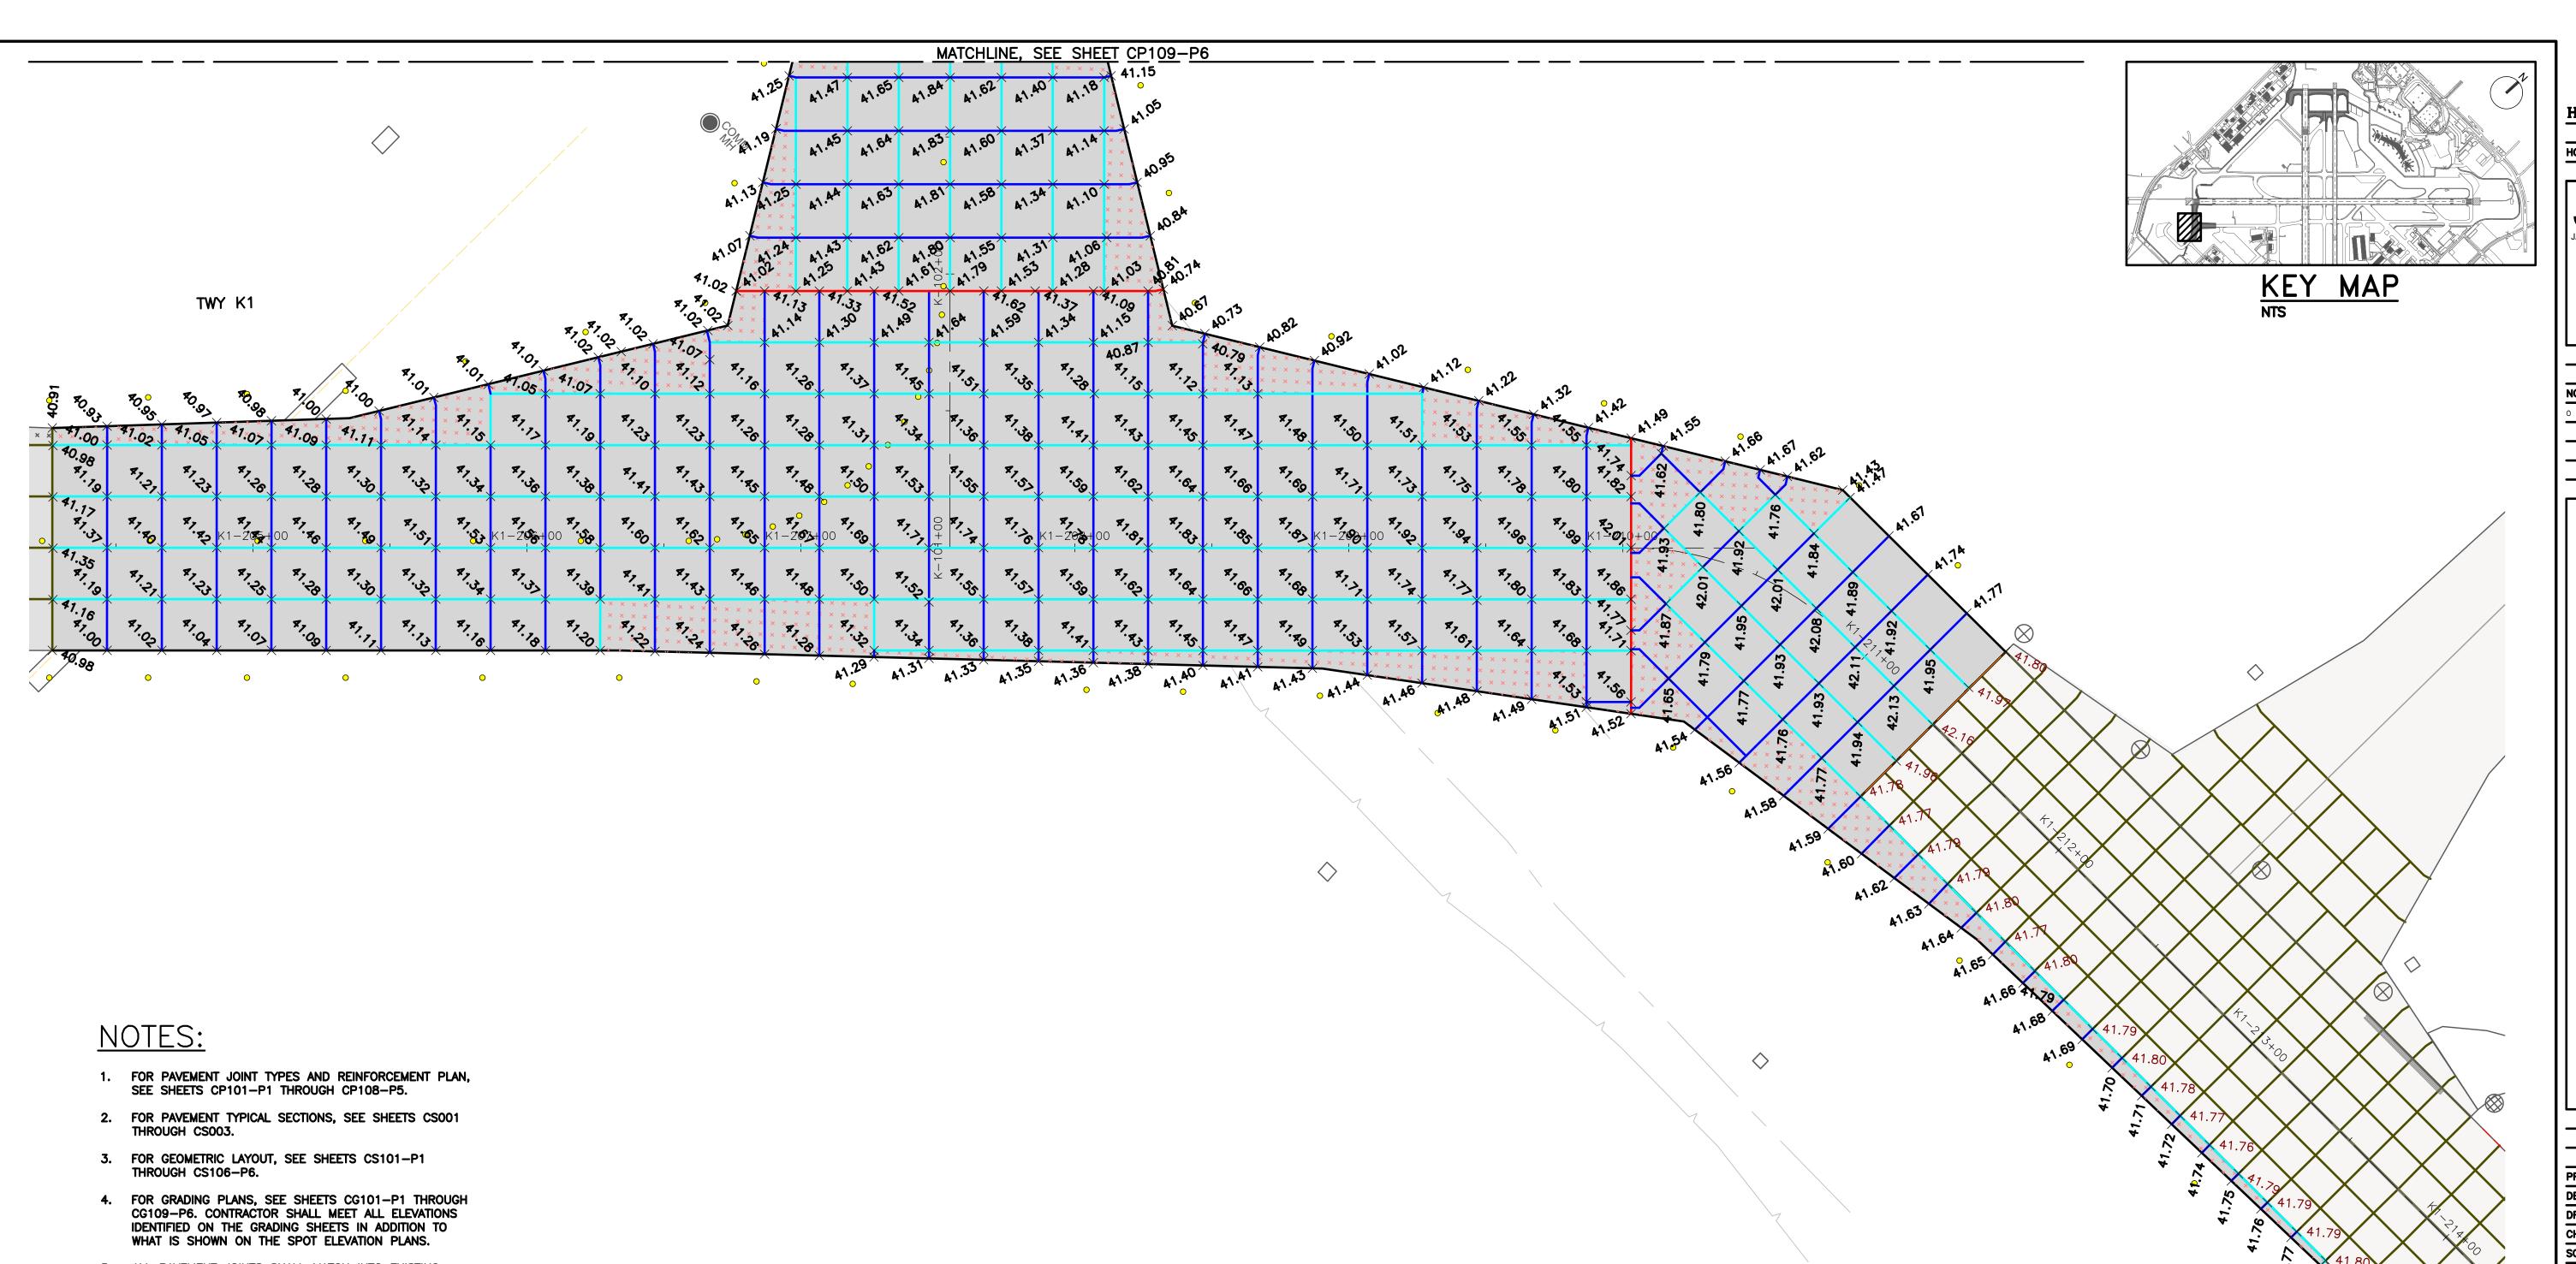
ISSUED FOR BID 02/24/2023 SC

AS SHOWN 02/24/2023

R. EHTESHAM

DIRECTOR HOUSTON AIRPORT SYSTEM


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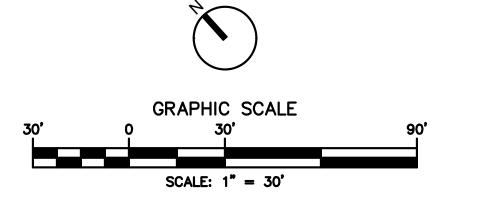


5. ALL PAVEMENT JOINTS SHALL MATCH INTO EXISTING PAVEMENT JOINTS AT TIE-IN LOCATIONS.

LEGEND:

FILENAME: H22C770A-CP709-710-P6.DWG



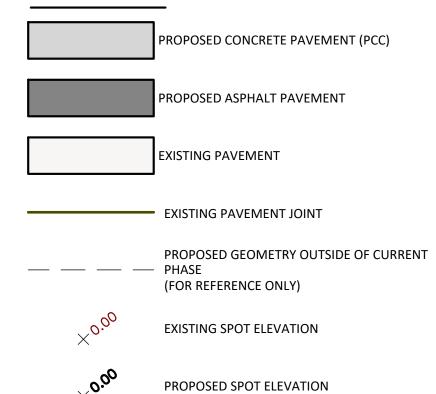

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IT SPOT ELEVATION PLAN - PHASE 6

PAVEMENT

PROJECT MGR: S. CHILDERS

DESIGNER: D. CRAWFORD

DRAWN BY: C. MCLAIN

CHECKED BY: R. EHTESHAM

SCALE: AS SHOWN

DATE: 02/24/2023



APPROVED BY: DATE:

DIRECTOR
HOUSTON AIRPORT SYSTEM


PROJECT NO: 770

C.I.P. NO: 3-48-0110-044 H.A.S. NO:

N/A SHEET NO:

710—F

PLOT TIME: 11:26:11 AM

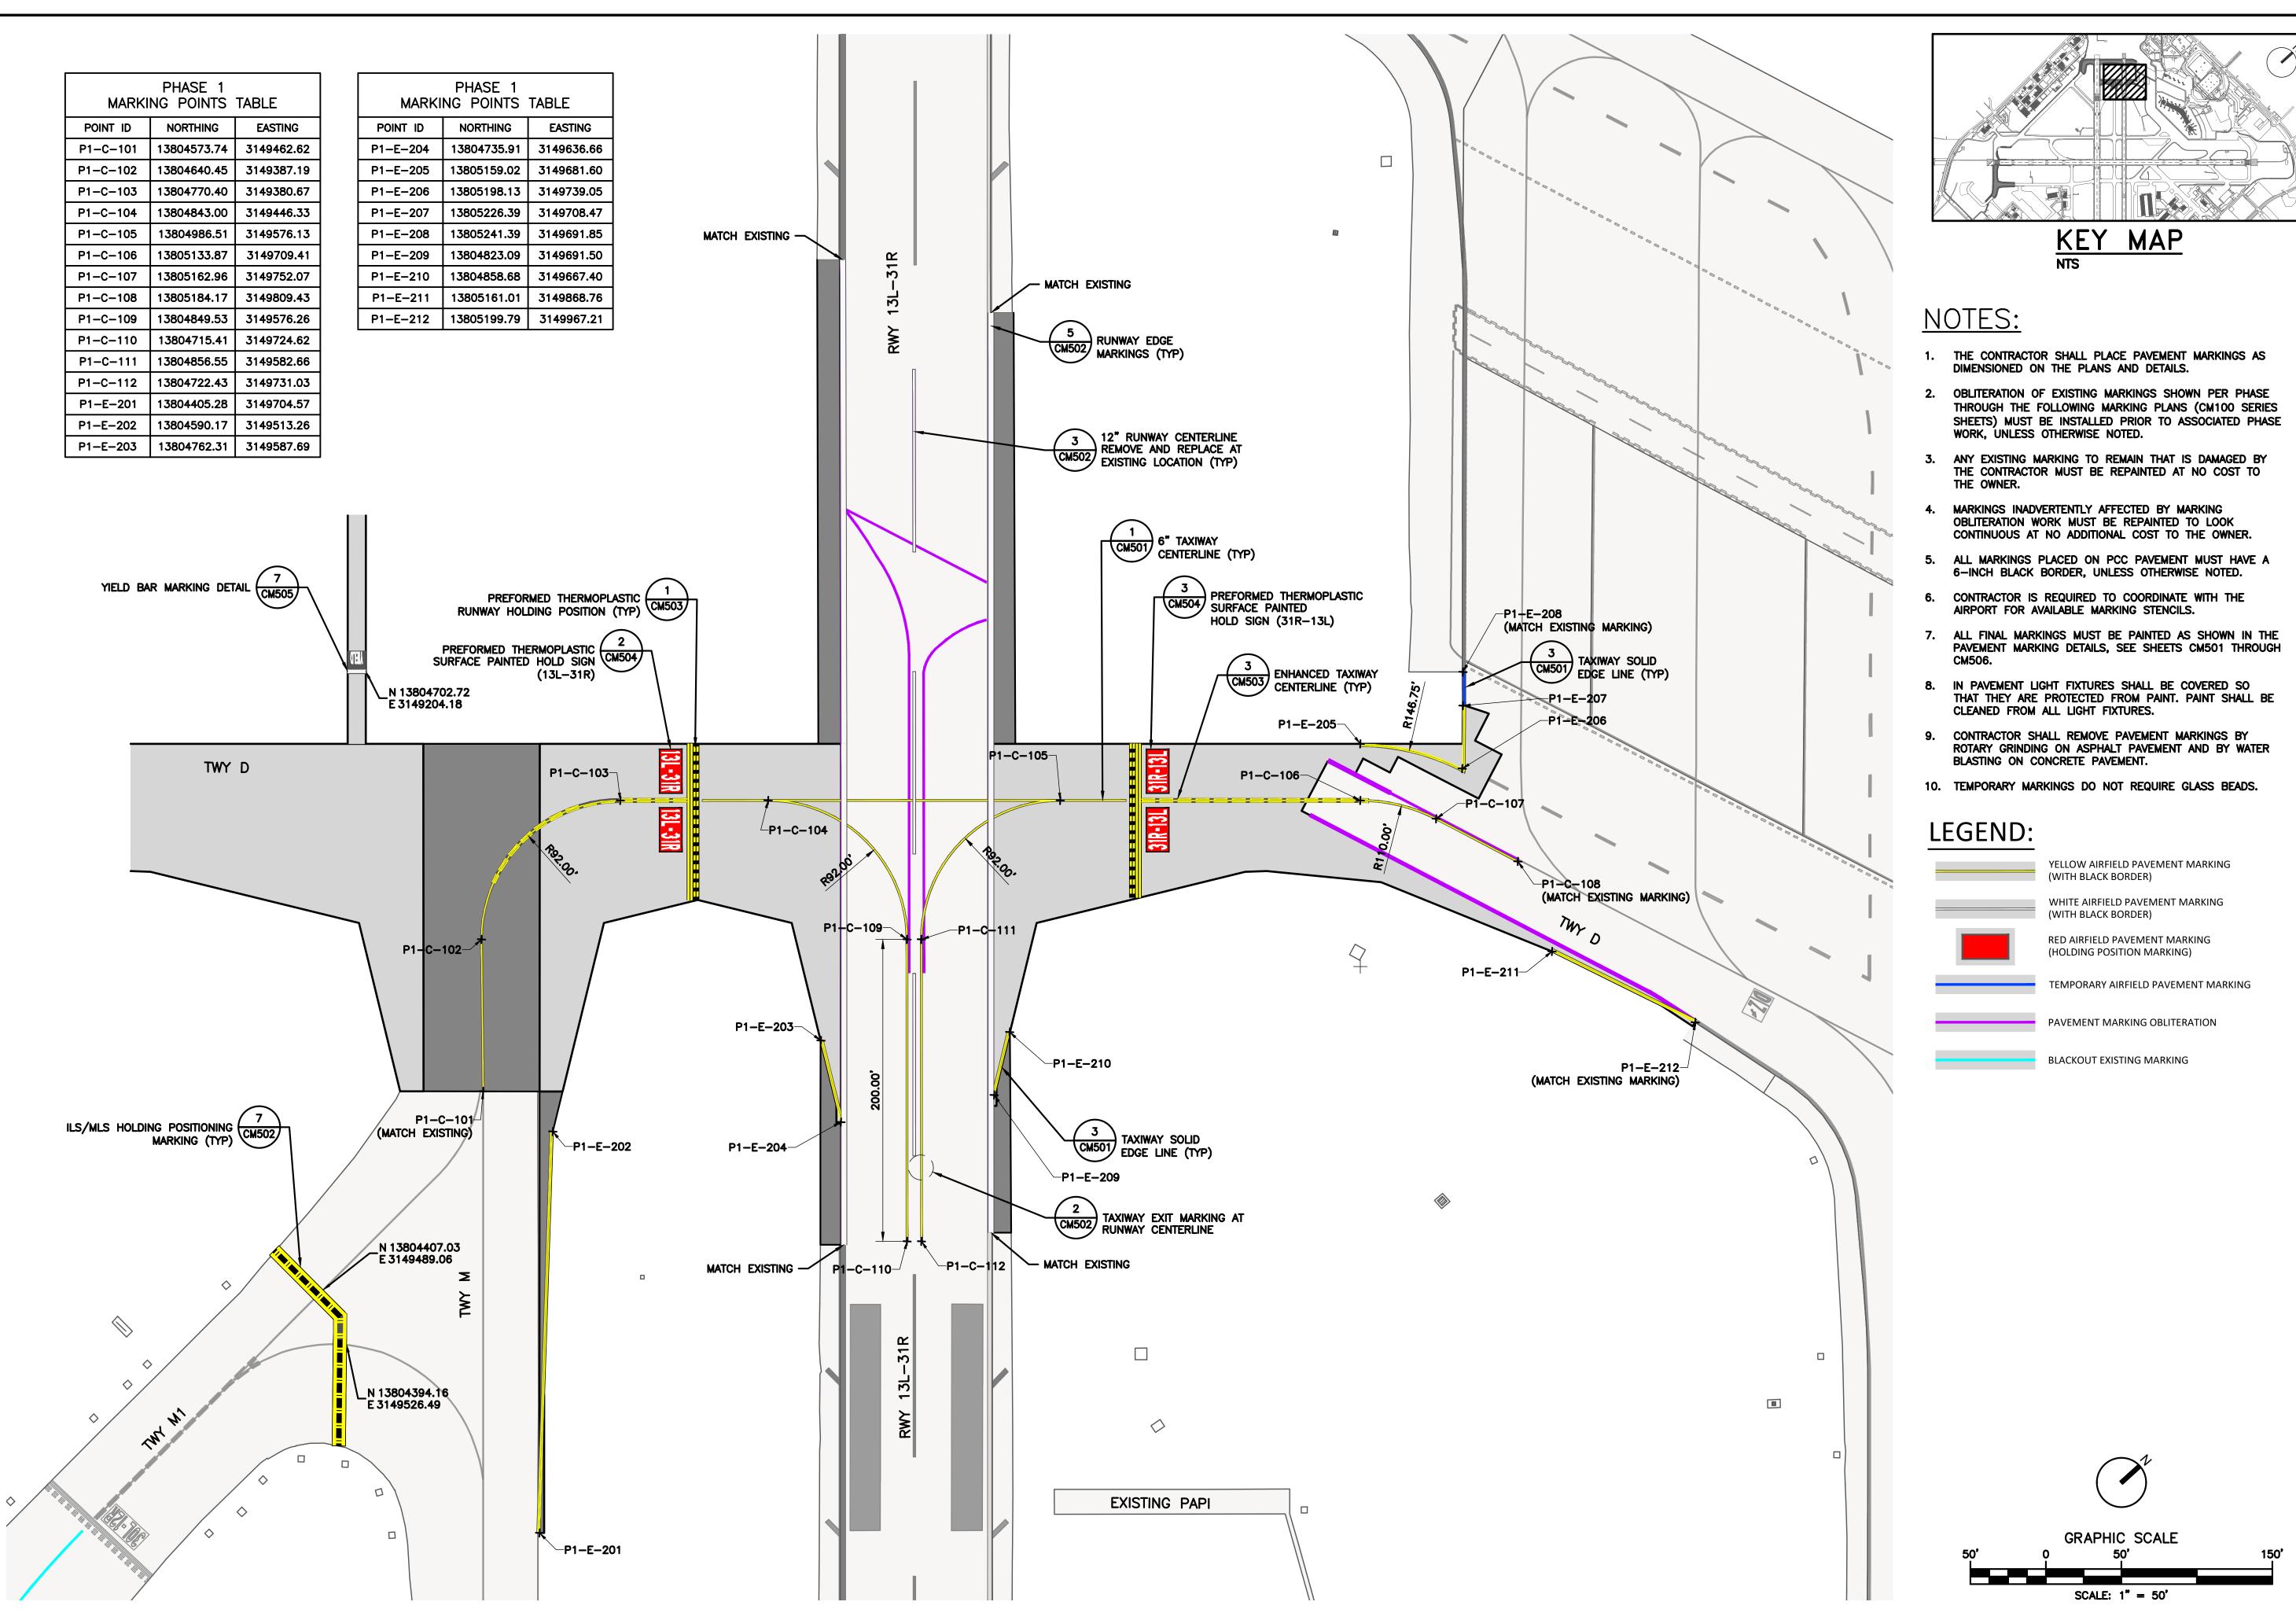



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PROJECT MGR: S. CHILDERS D. CRAWFORD **DESIGNER:** B. BARTLETT DRAWN BY: R. EHTESHAM CHECKED BY: SCALE: AS SHOWN 02/24/2023



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DIRECTOR HOUSTON AIRPORT SYSTEM

PROJECT NO:


770 C.I.P. NO: 3-48-0110-044


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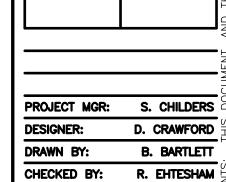
PLOT DATE: 2023/02/17

FILENAME: H22C770A-CM101-P1.DWG

PLOT TIME: 10:39:14 AM



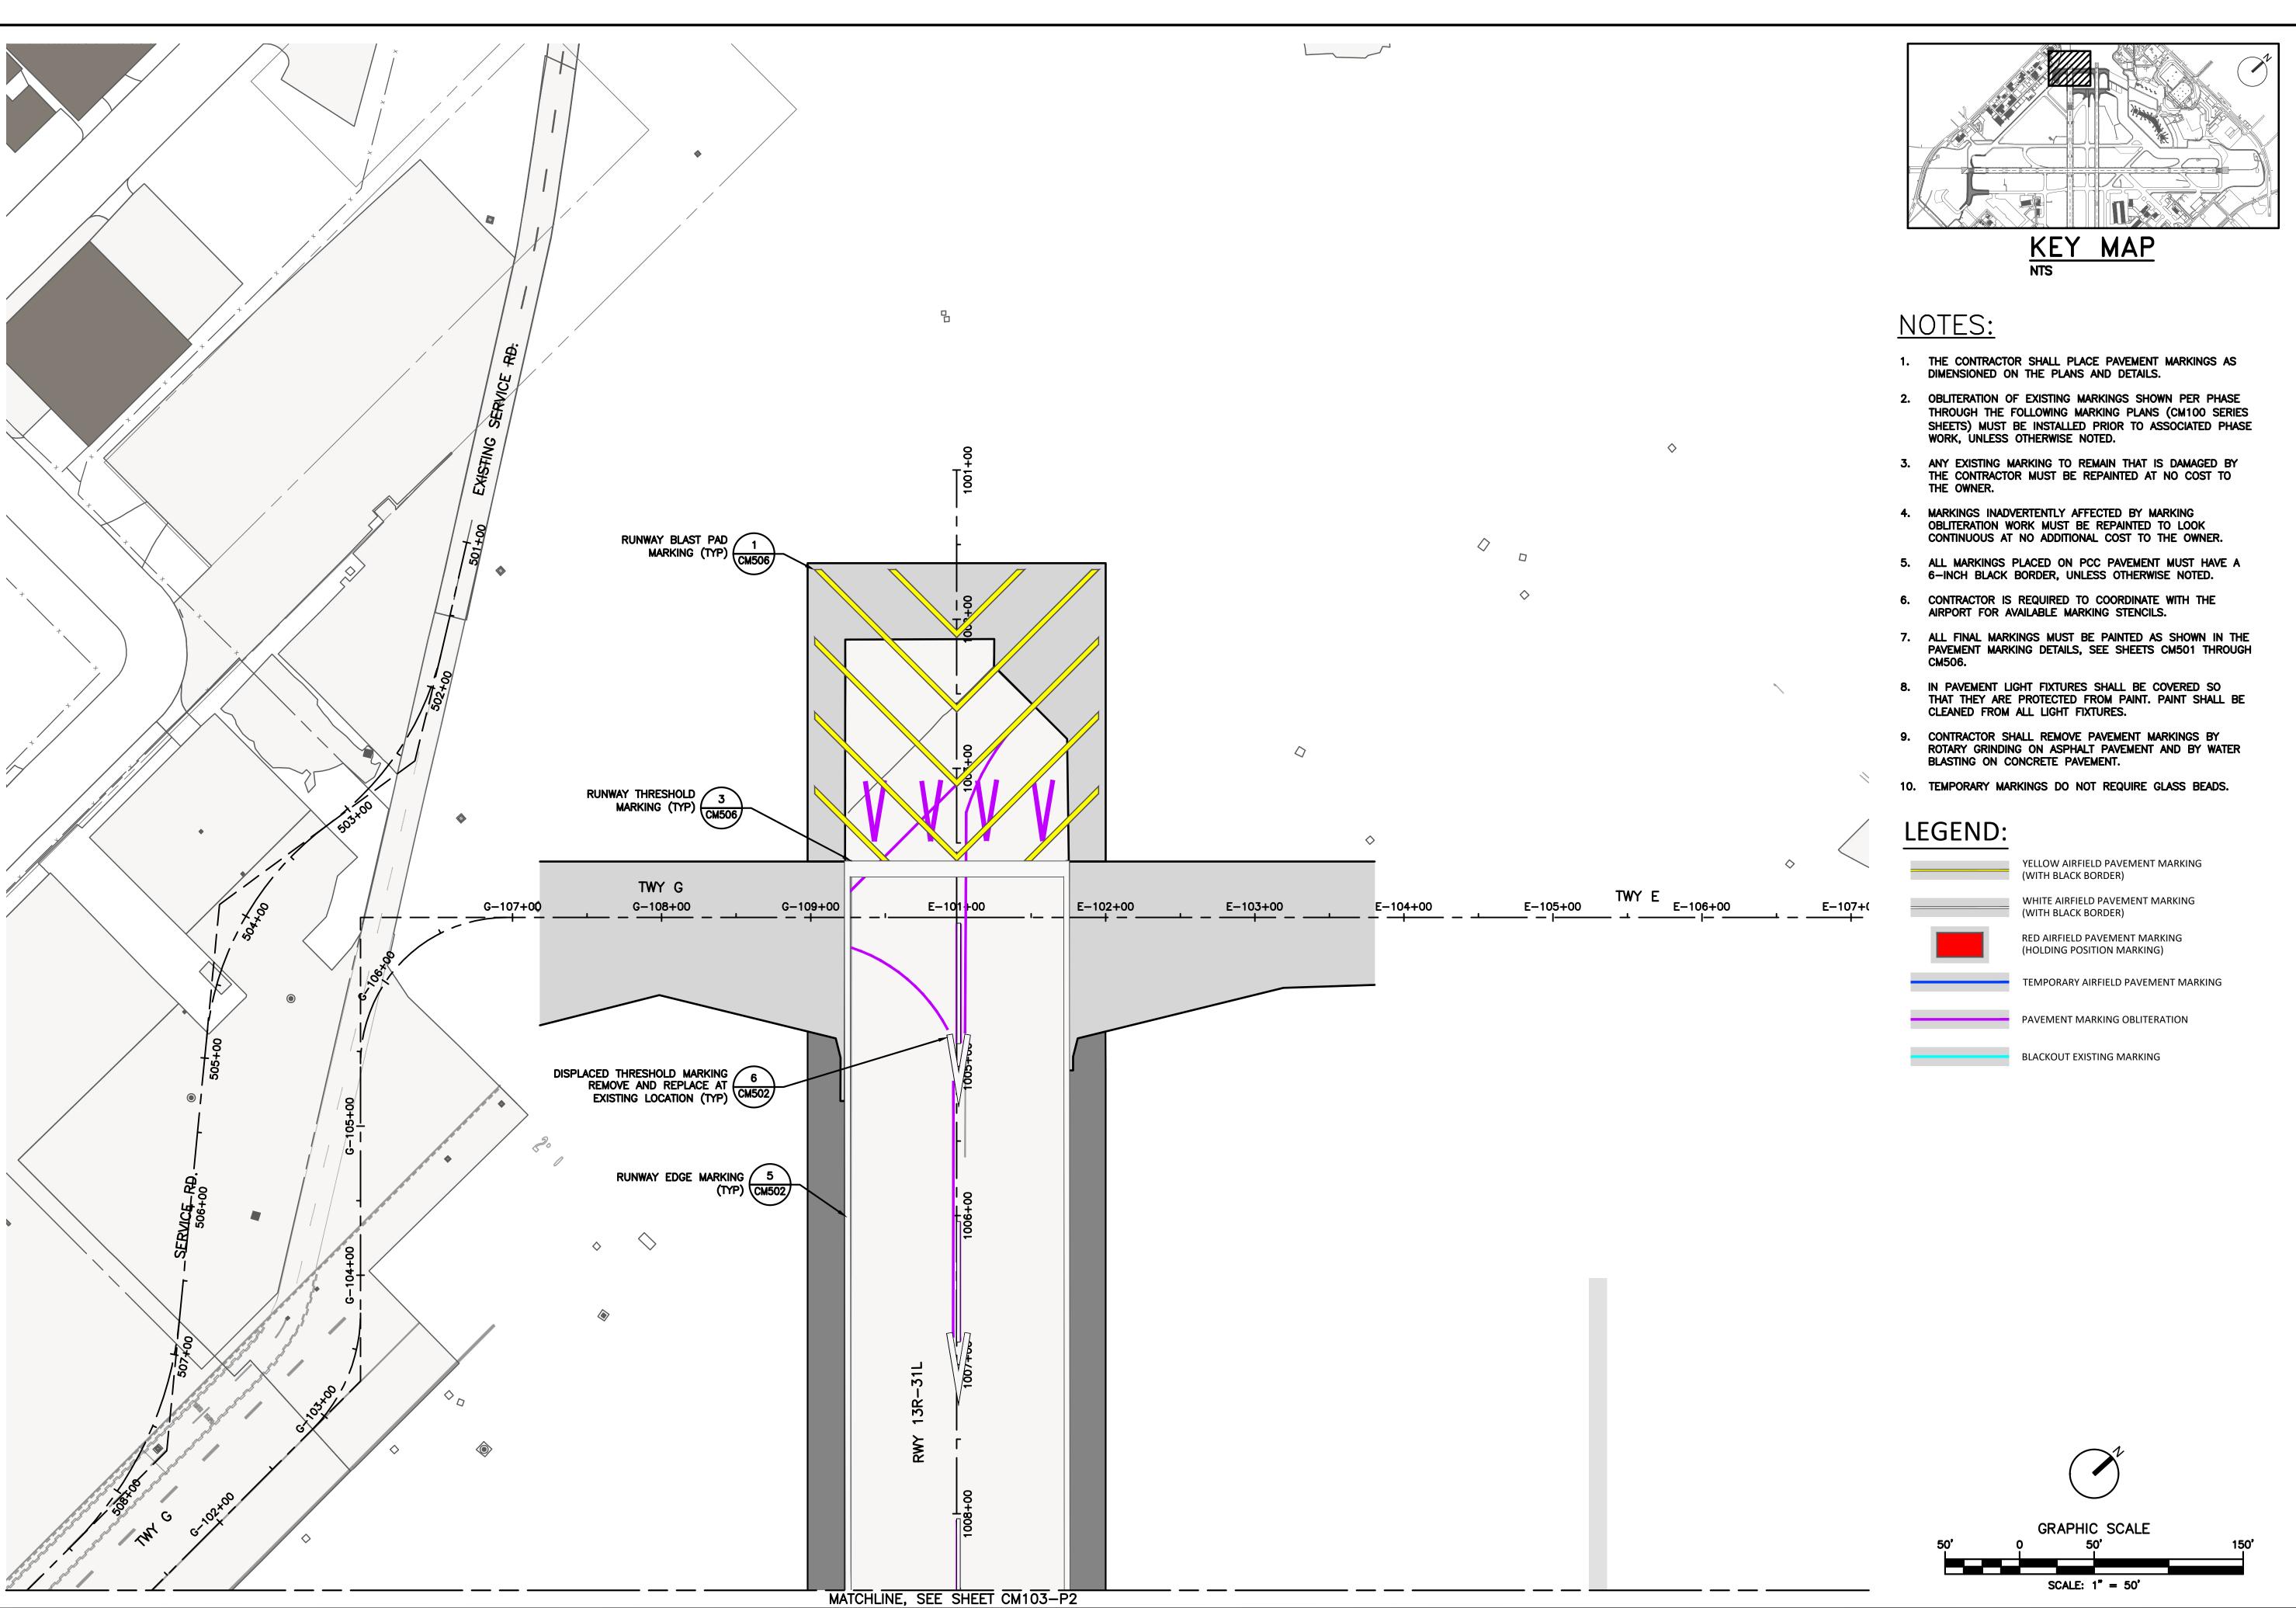

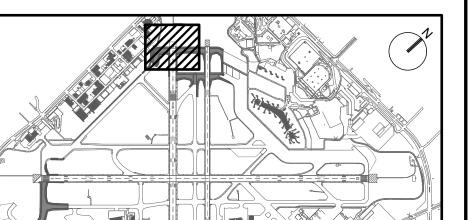

SCALE:

HOUSTON AIRPORT SYSTEM WILLIAM P. HOBBY AIRPORT

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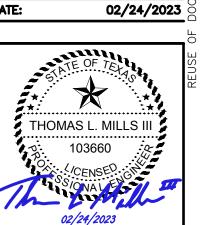
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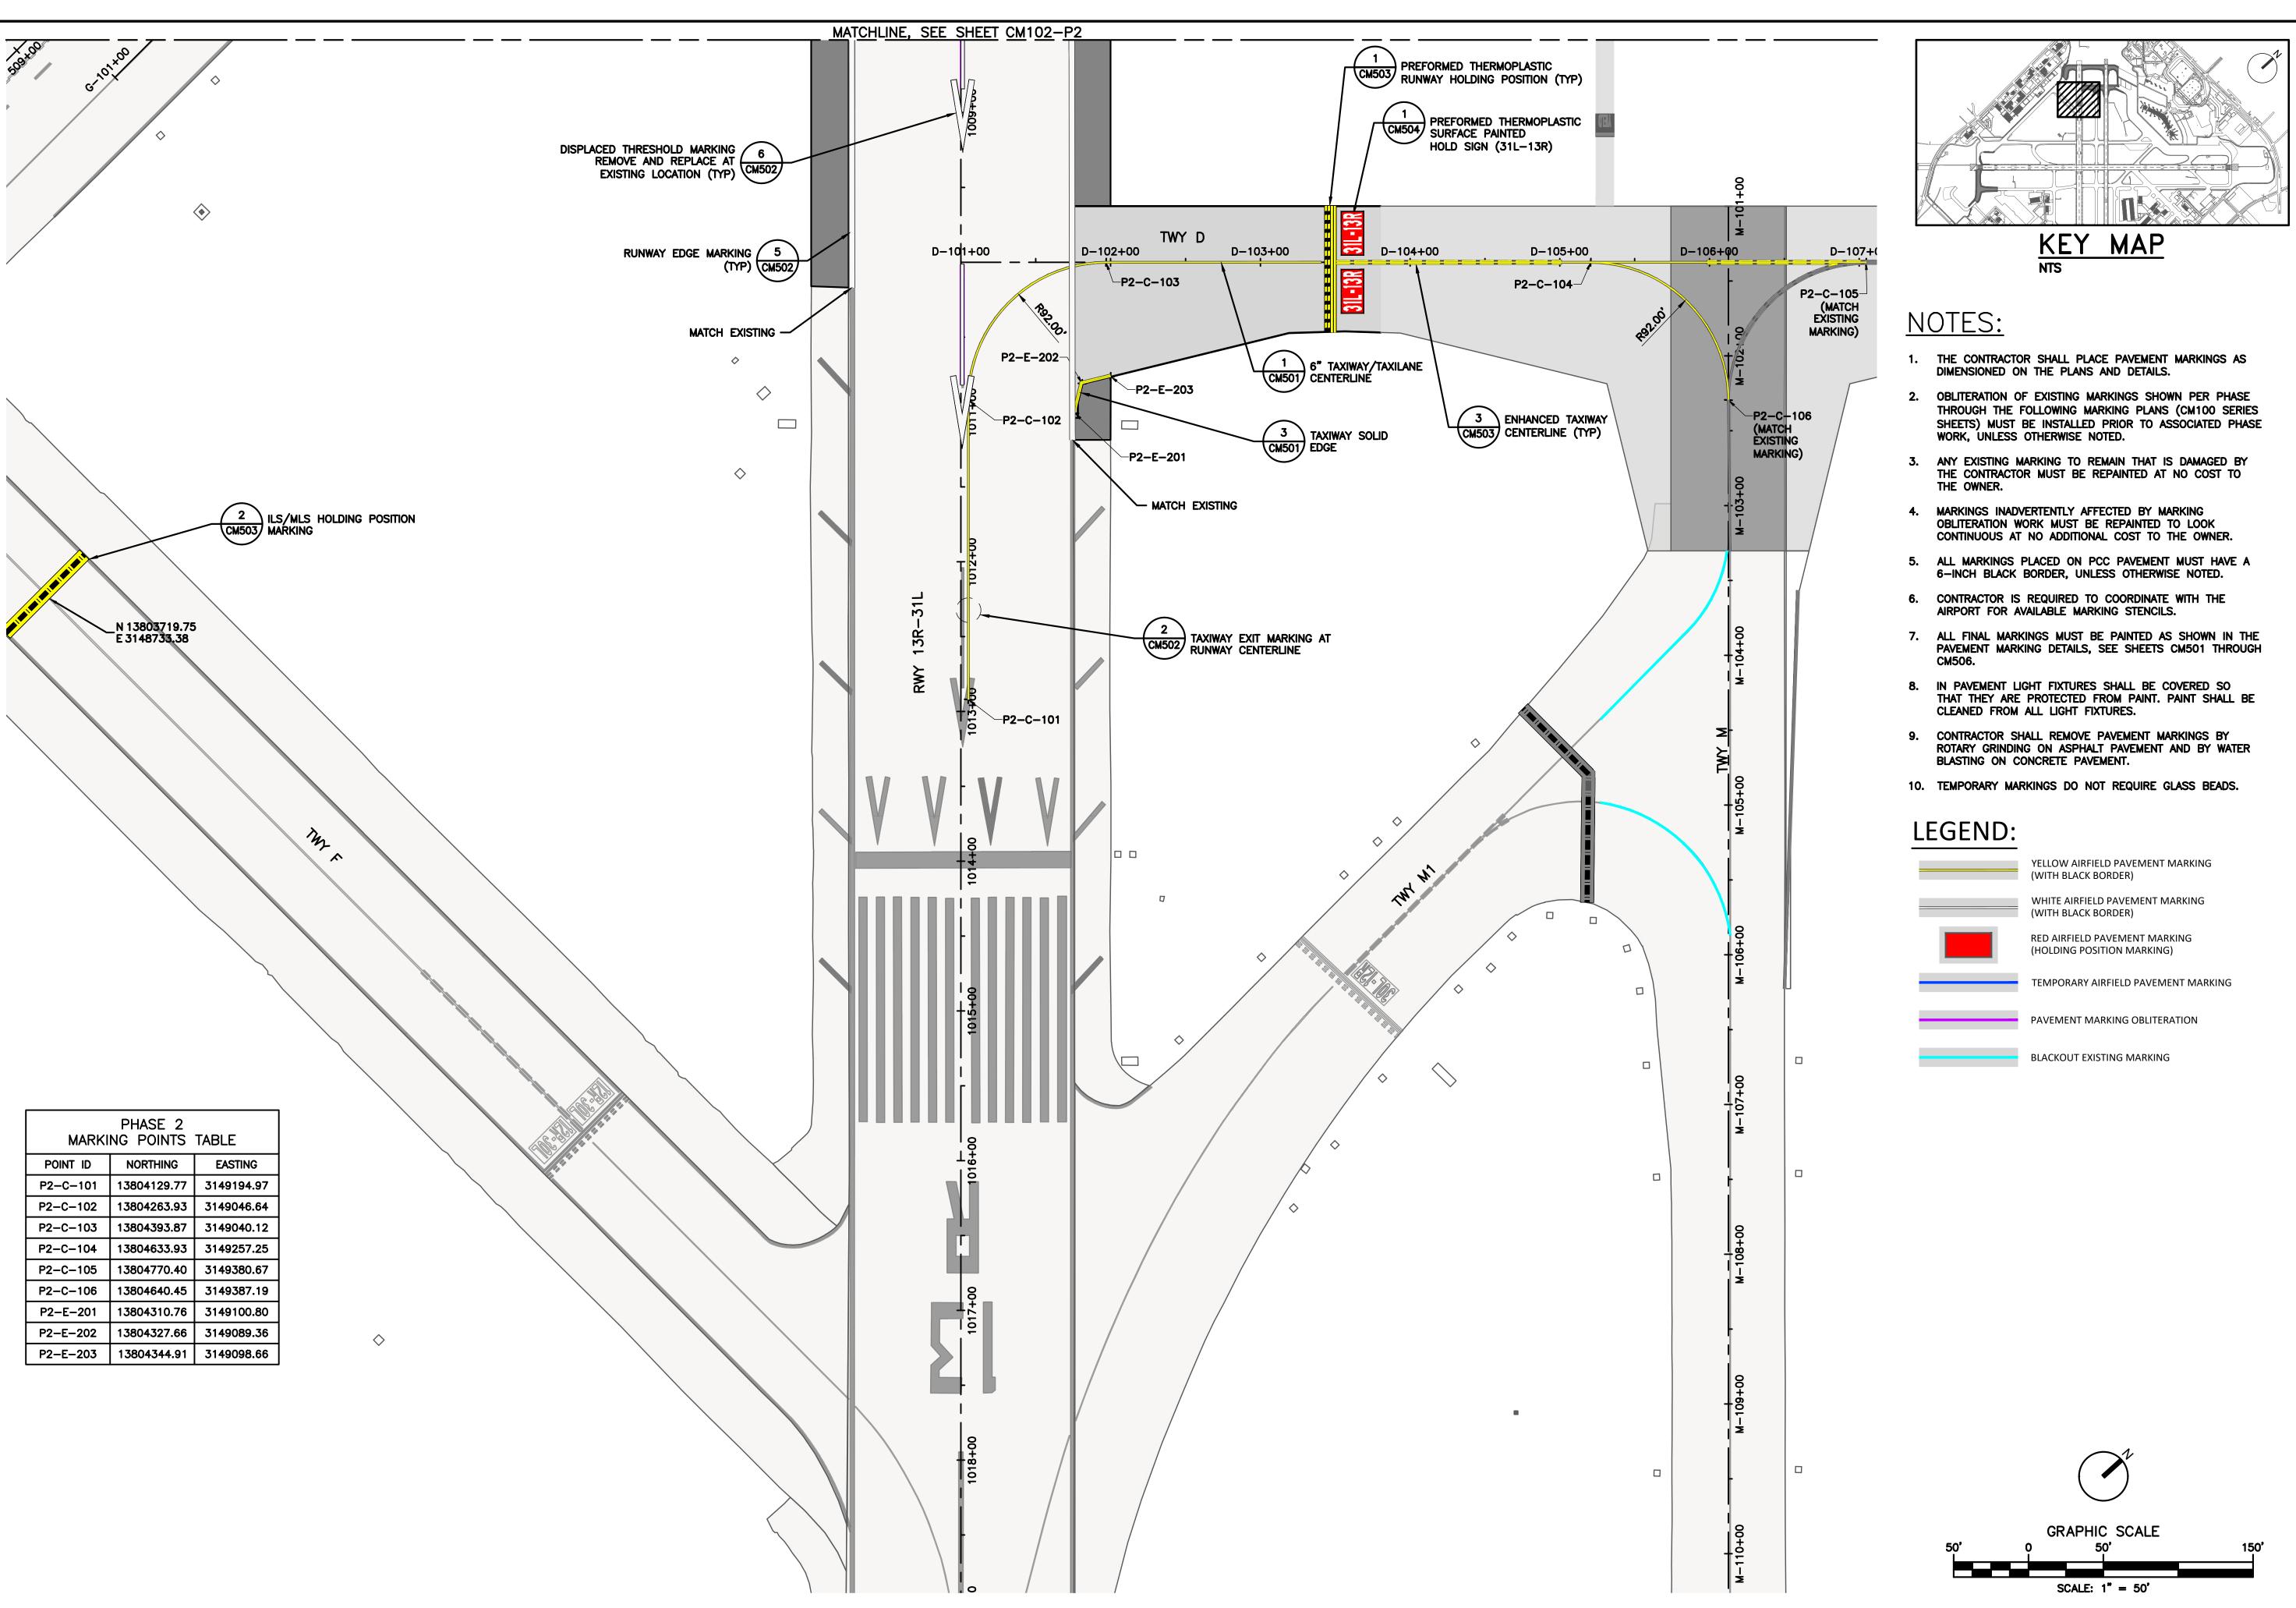
PROJECT NO: 770

C.I.P. NO: 3-48-0110-044 H.A.S. NO:

SHEET NO:

PLOT DATE: 2023/02/17 FILENAME: H22C770A-CM102-103-P2.DWG

PLOT TIME: 10:40:08 AM



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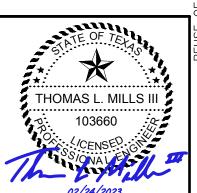
ISSUED FOR BID 02/24/2023 SC

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PROJECT MGR: **DESIGNER:** DRAWN BY:

CHECKED BY: AS SHOWN SCALE: 02/24/2023



APPROVED BY:

DIRECTOR HOUSTON AIRPORT SYSTEM

PROJECT NO:


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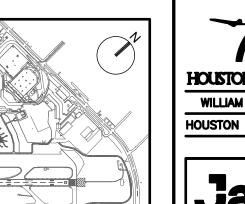
H.A.S. NO: SHEET NO:

PLOT DATE: 2023/02/17

FILENAME: H22C770A-CM102-103-P2.DWG

PLOT TIME: 10:41:19 AM



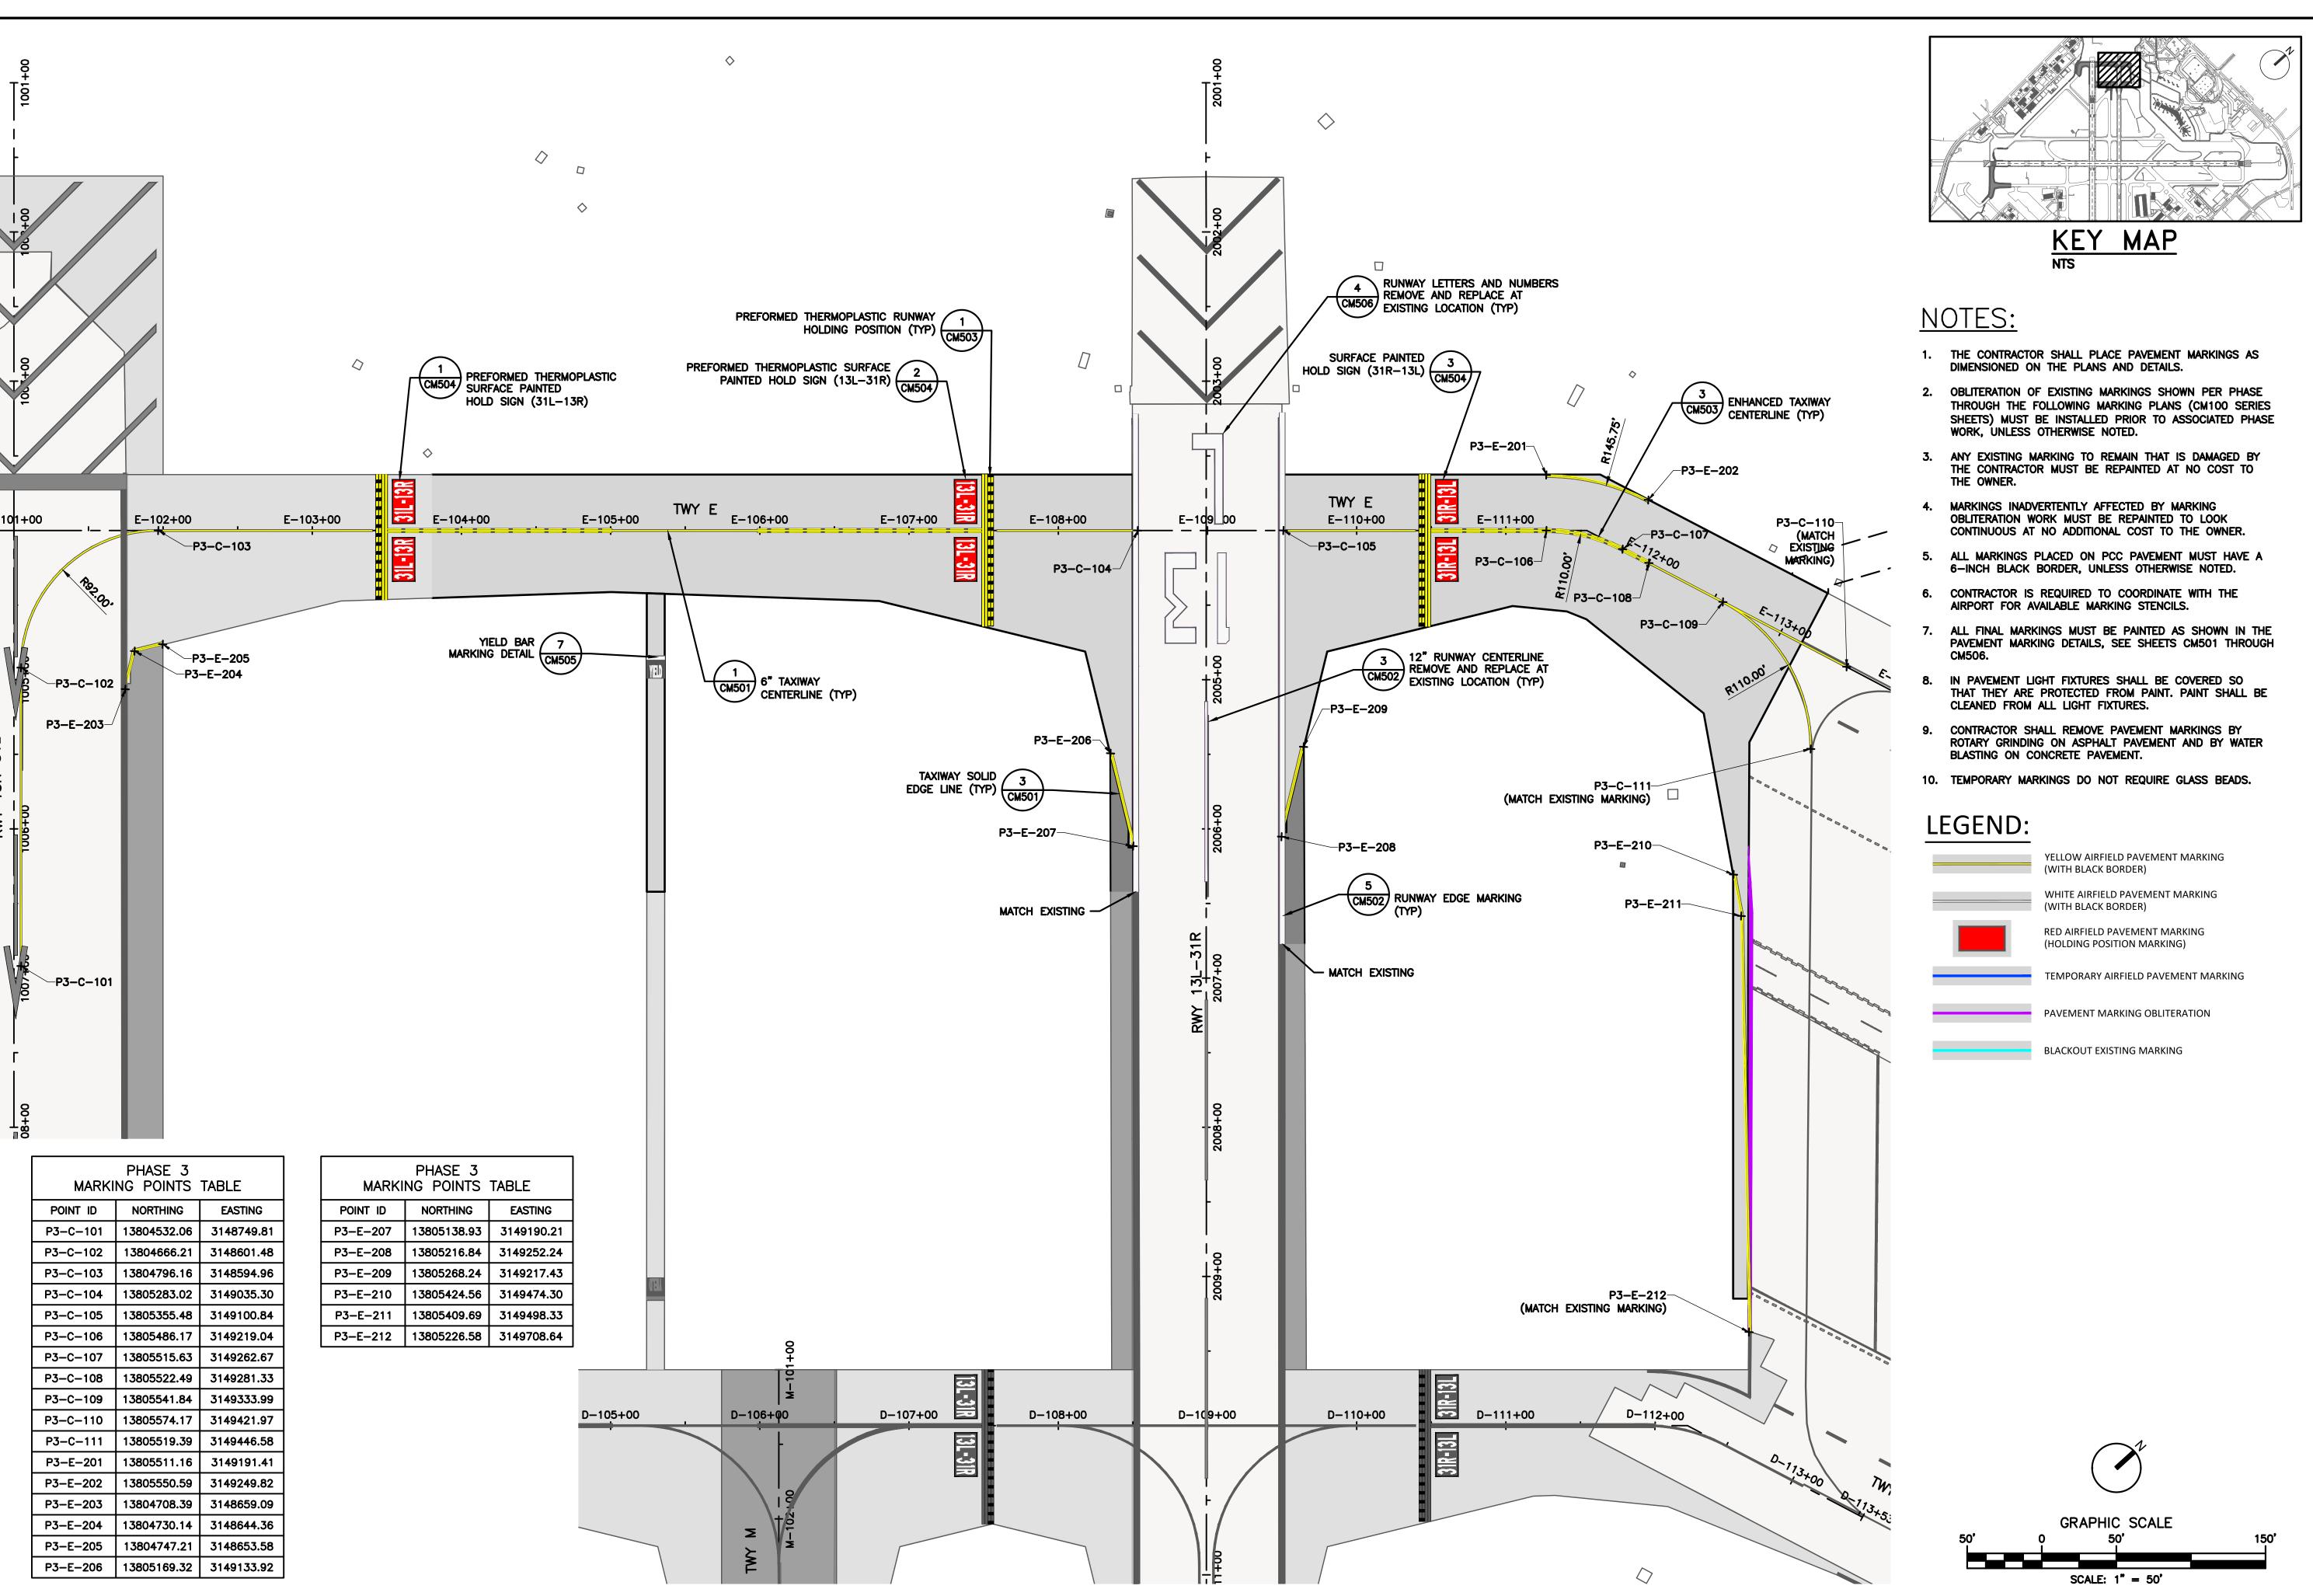



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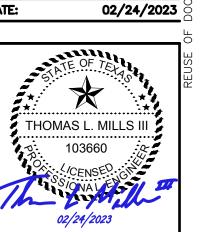
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PROJECT MGR: S. CHILDERS **DESIGNER:** D. CRAWFORD B. BARTLETT R. EHTESHAM CHECKED BY: SCALE: AS SHOWN



APPROVED BY:

HOUSTON AIRPORT SYSTEM PROJECT NO:

770


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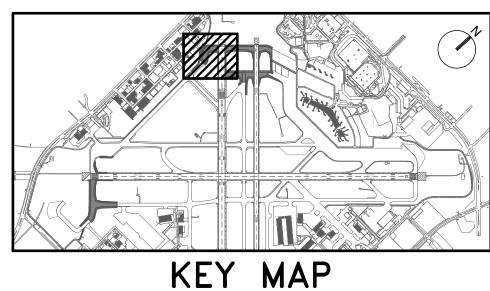
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PLOT DATE: 2023/02/17

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PLOT TIME: 10:42:19 AM






NOTES:

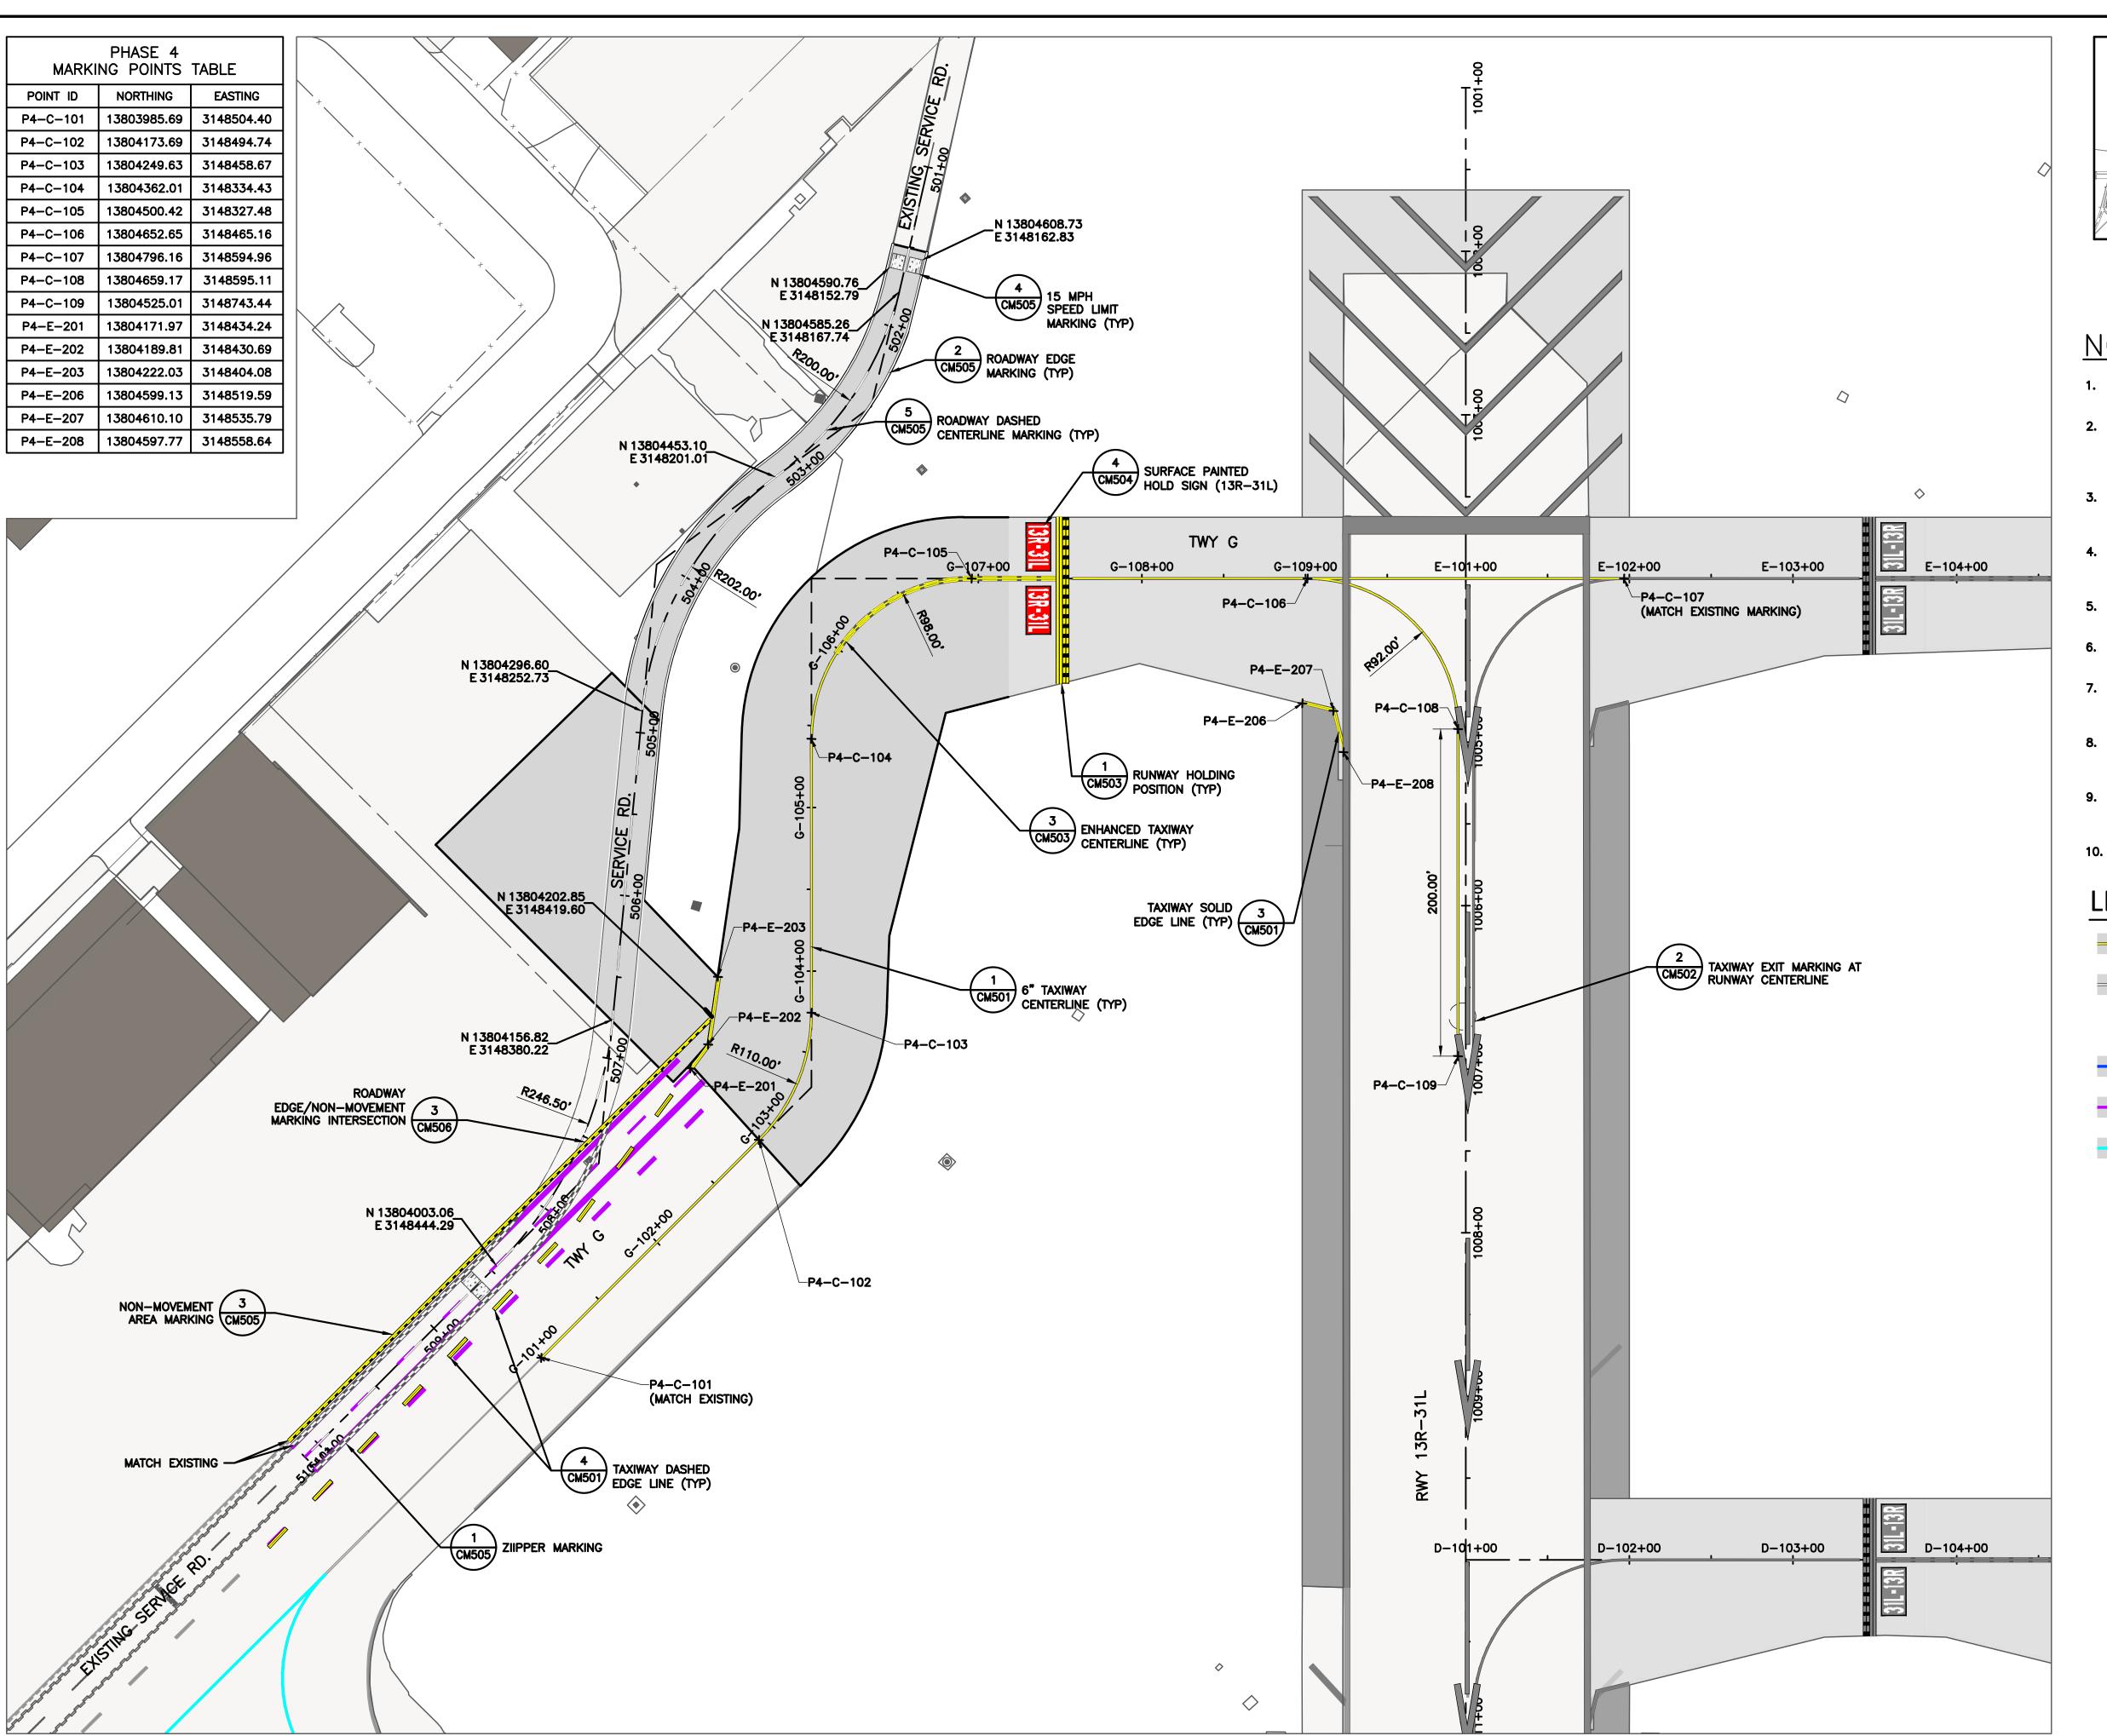- 1. THE CONTRACTOR SHALL PLACE PAVEMENT MARKINGS AS DIMENSIONED ON THE PLANS AND DETAILS.
- OBLITERATION OF EXISTING MARKINGS SHOWN PER PHASE THROUGH THE FOLLOWING MARKING PLANS (CM100 SERIES SHEETS) MUST BE INSTALLED PRIOR TO ASSOCIATED PHASE WORK, UNLESS OTHERWISE NOTED.
- ANY EXISTING MARKING TO REMAIN THAT IS DAMAGED BY THE CONTRACTOR MUST BE REPAINTED AT NO COST TO THE OWNER.
- MARKINGS INADVERTENTLY AFFECTED BY MARKING OBLITERATION WORK MUST BE REPAINTED TO LOOK CONTINUOUS AT NO ADDITIONAL COST TO THE OWNER.
- ALL MARKINGS PLACED ON PCC PAVEMENT MUST HAVE A 6-INCH BLACK BORDER. UNLESS OTHERWISE NOTED.
- CONTRACTOR IS REQUIRED TO COORDINATE WITH THE AIRPORT FOR AVAILABLE MARKING STENCILS.
- 7. ALL FINAL MARKINGS MUST BE PAINTED AS SHOWN IN THE PAVEMENT MARKING DETAILS, SEE SHEETS CM501 THROUGH CM506.
- 8. IN PAVEMENT LIGHT FIXTURES SHALL BE COVERED SO THAT THEY ARE PROTECTED FROM PAINT. PAINT SHALL BE CLEANED FROM ALL LIGHT FIXTURES.
 - CONTRACTOR SHALL REMOVE PAVEMENT MARKINGS BY ROTARY GRINDING ON ASPHALT PAVEMENT AND BY WATER BLASTING ON CONCRETE PAVEMENT.
- 10. TEMPORARY MARKINGS DO NOT REQUIRE GLASS BEADS.

LEGEND:

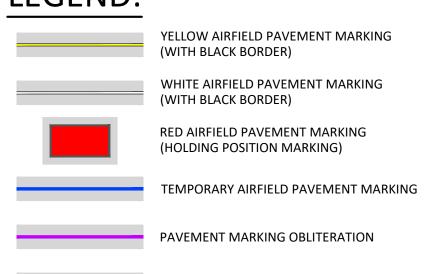

BLACKOUT EXISTING MARKING



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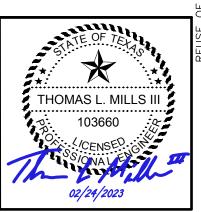
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PROJECT MGR: S. CHILDERS **DESIGNER:** D. CRAWFORD B. BARTLETT DRAWN BY: R. EHTESHAM CHECKED BY: SCALE: AS SHOWN

02/24/2023



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770 C.I.P. NO:

3-48-0110-044 H.A.S. NO:

FILENAME: H22C770A-CM105-P4.DWG


PLOT DATE: 2023/02/17

PLOT TIME: 10:43:31 AM

SCALE: 1" = 50'

PROJECT NO:

SHEET NO:

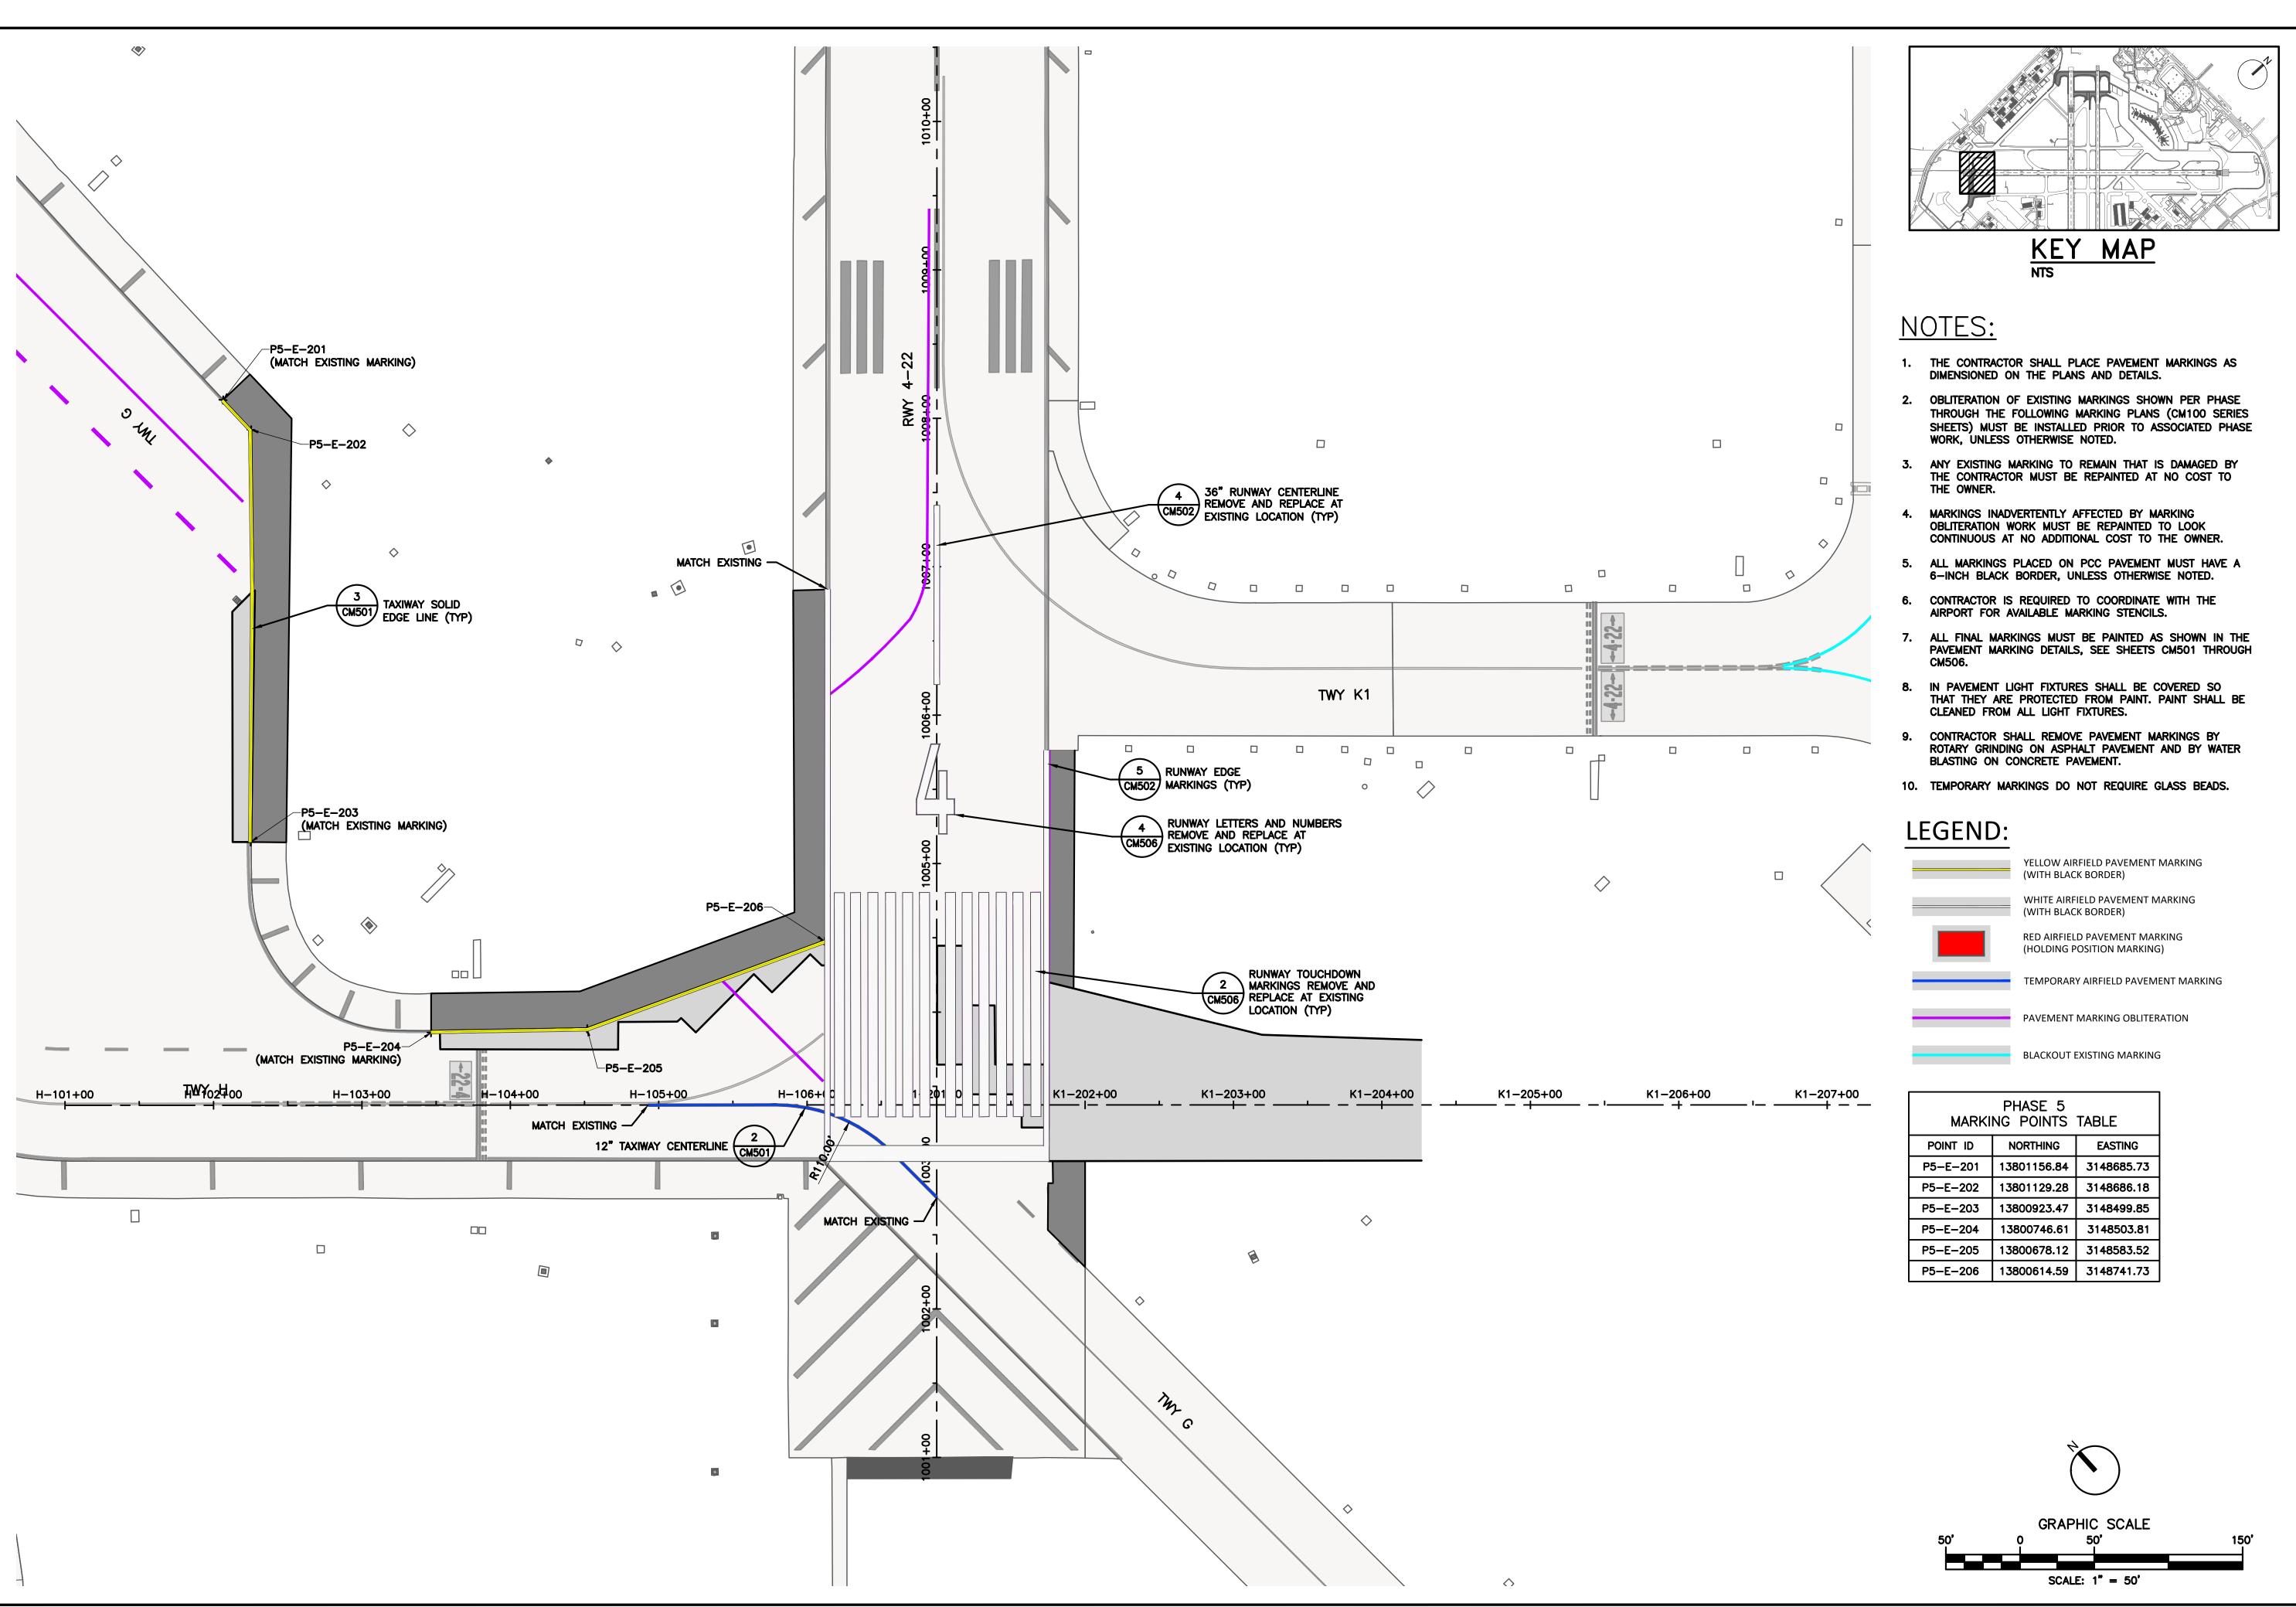

FILENAME: H22C770A-CM106-P5.DWG

PLOT DATE: 2023/02/17

PLOT TIME: 10:44:28 AM

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PROJECT MGR: S. CHILDERS D. CRAWFORD **DESIGNER:** DRAWN BY: B. BARTLETT R. EHTESHAM CHECKED BY: AS SHOWN

02/24/2023

DATE:



SCALE:


DIRECTOR HOUSTON AIRPORT SYSTEM


PROJECT NO: 770 C.I.P. NO:

APPROVED BY:

3-48-0110-044 H.A.S. NO:

N/A SHEET NO:

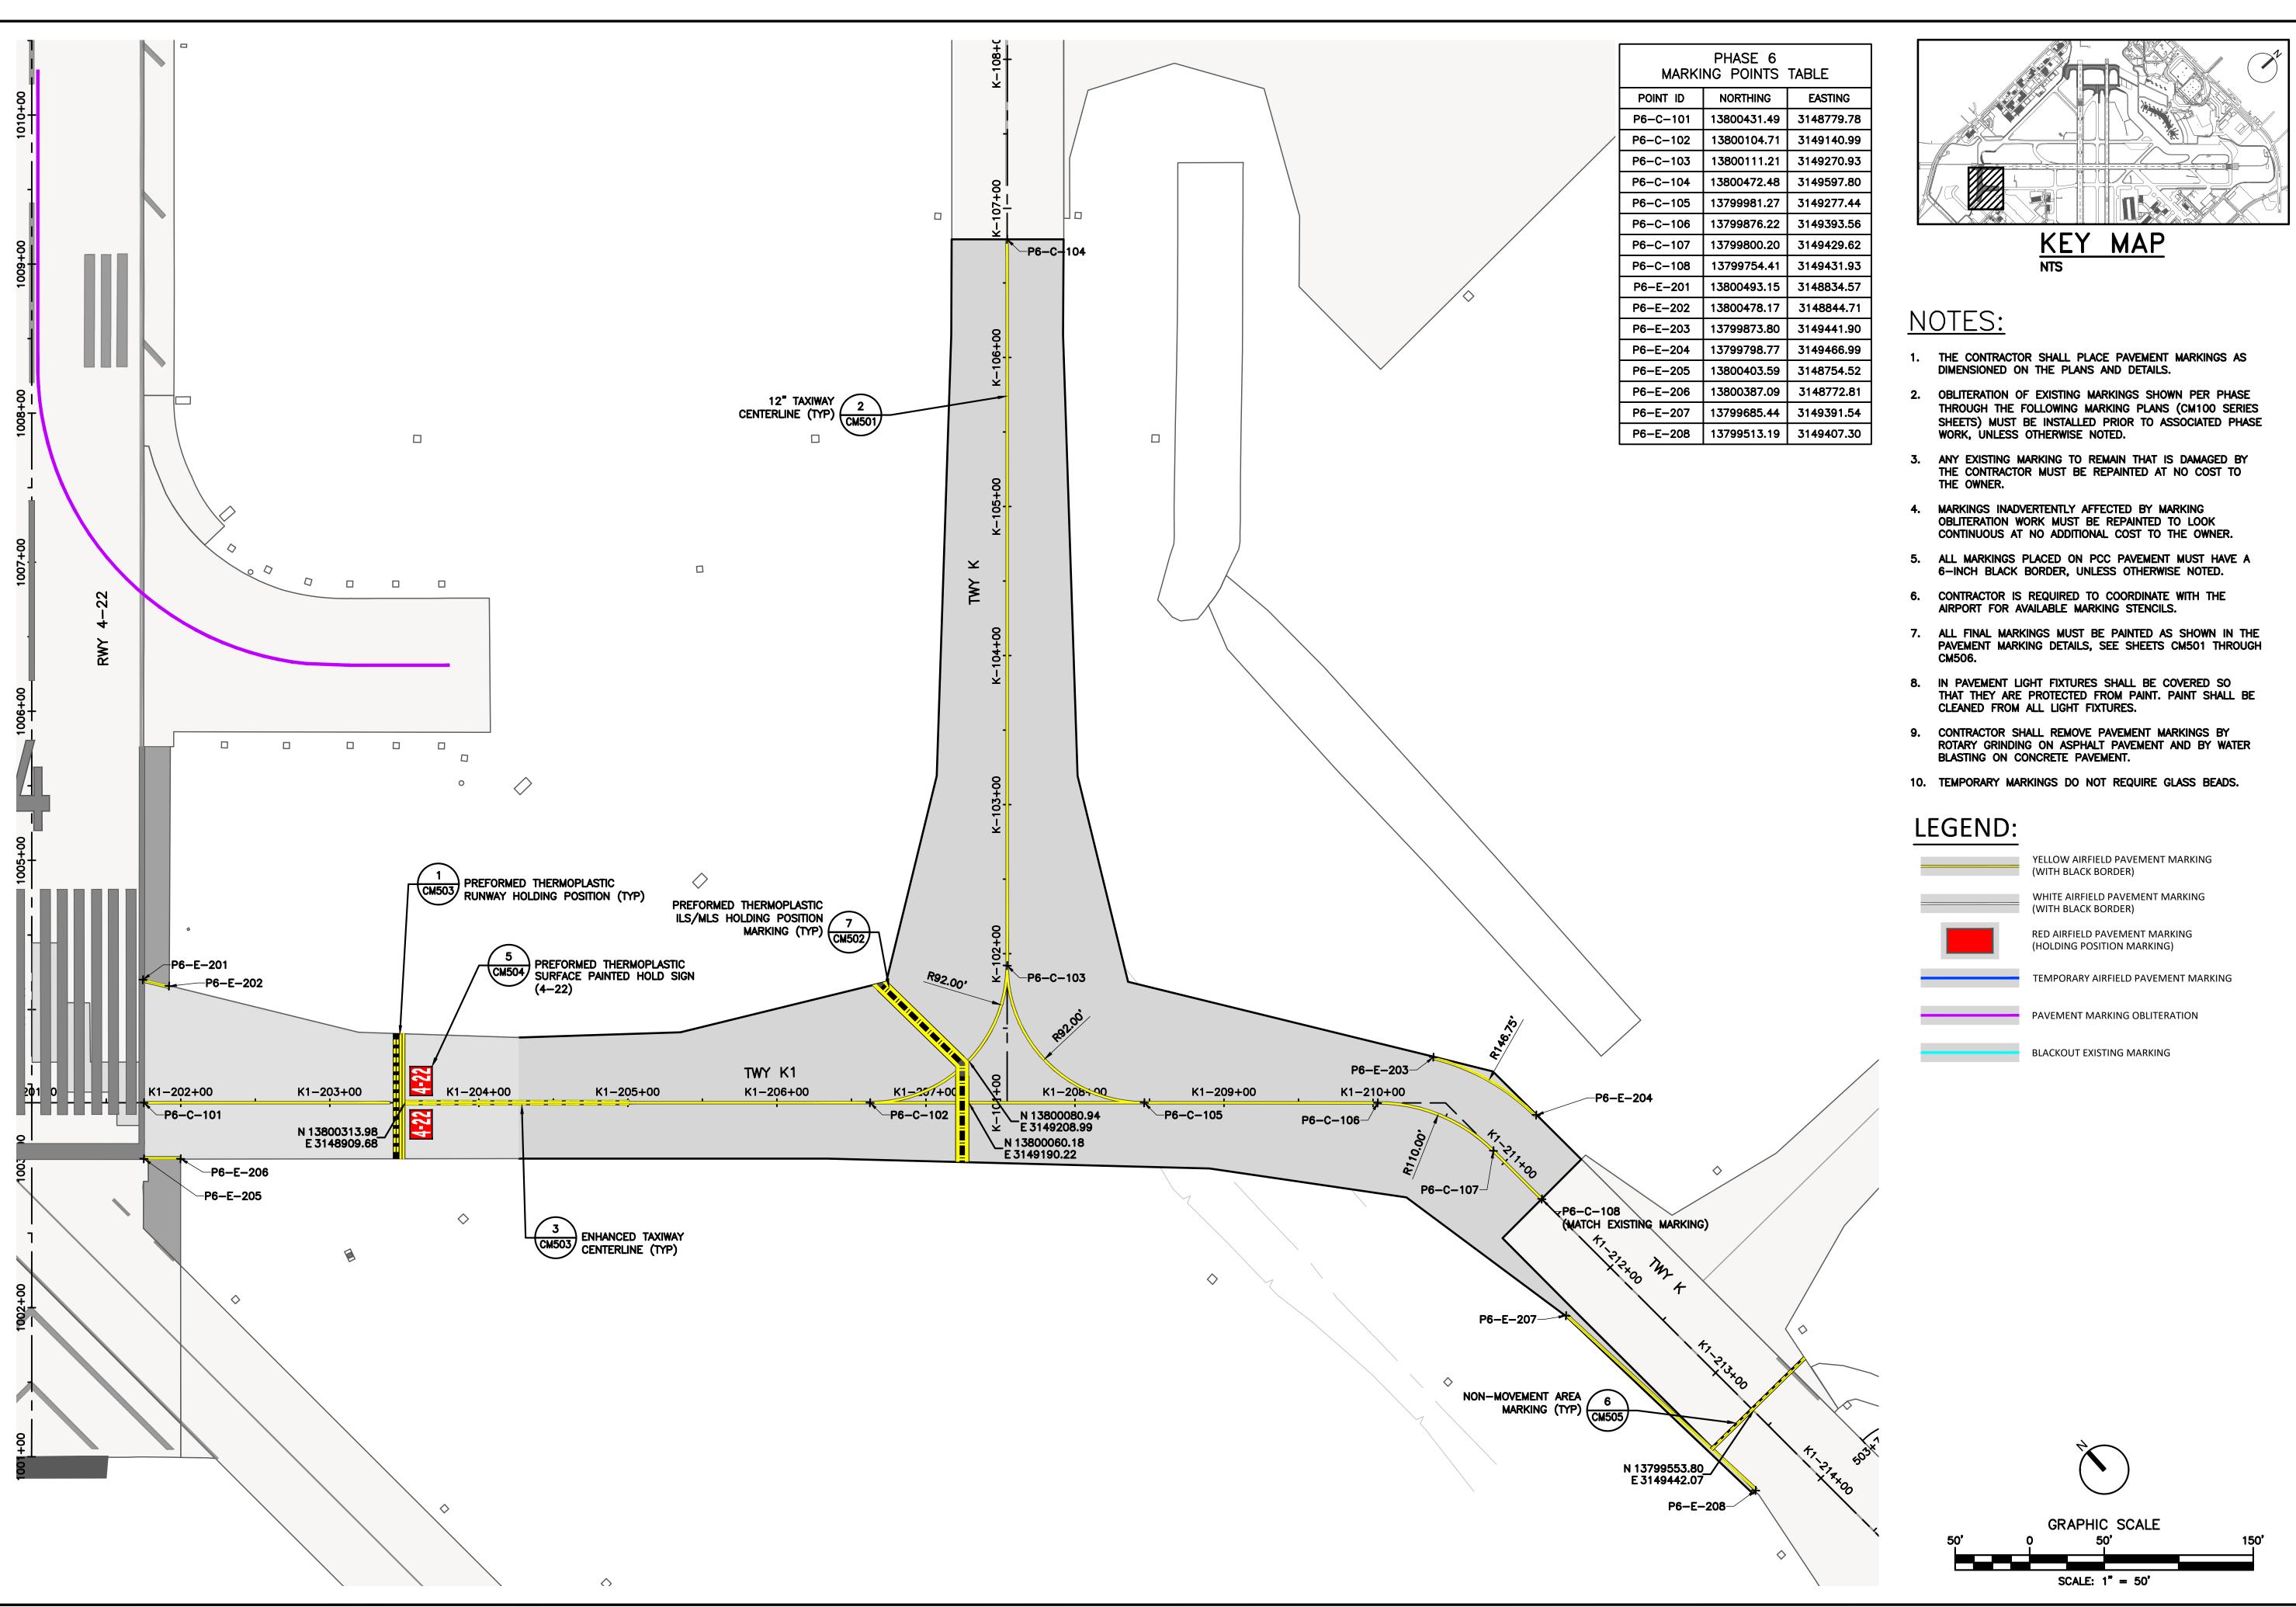

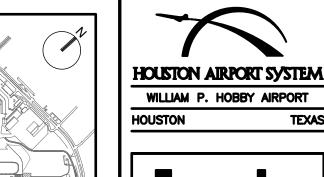



REVISIONS NO. DESCRIPTION DATE BY

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PROJECT MGR: S. CHILDERS **DESIGNER:** D. CRAWFORD B. BARTLETT DRAWN BY: R. EHTESHAM CHECKED BY: SCALE: AS SHOWN 02/24/2023

> THOMAS L. MILLS III 103660

APPROVED BY:

DIRECTOR HOUSTON AIRPORT SYSTEM PROJECT NO:


770 C.I.P. NO:

3-48-0110-044 H.A.S. NO:

SHEET NO:

PLOT DATE: 2023/02/17 PLOT TIME: 10:45:30 AM

FILENAME: H22C770A-CM107-P6.DWG

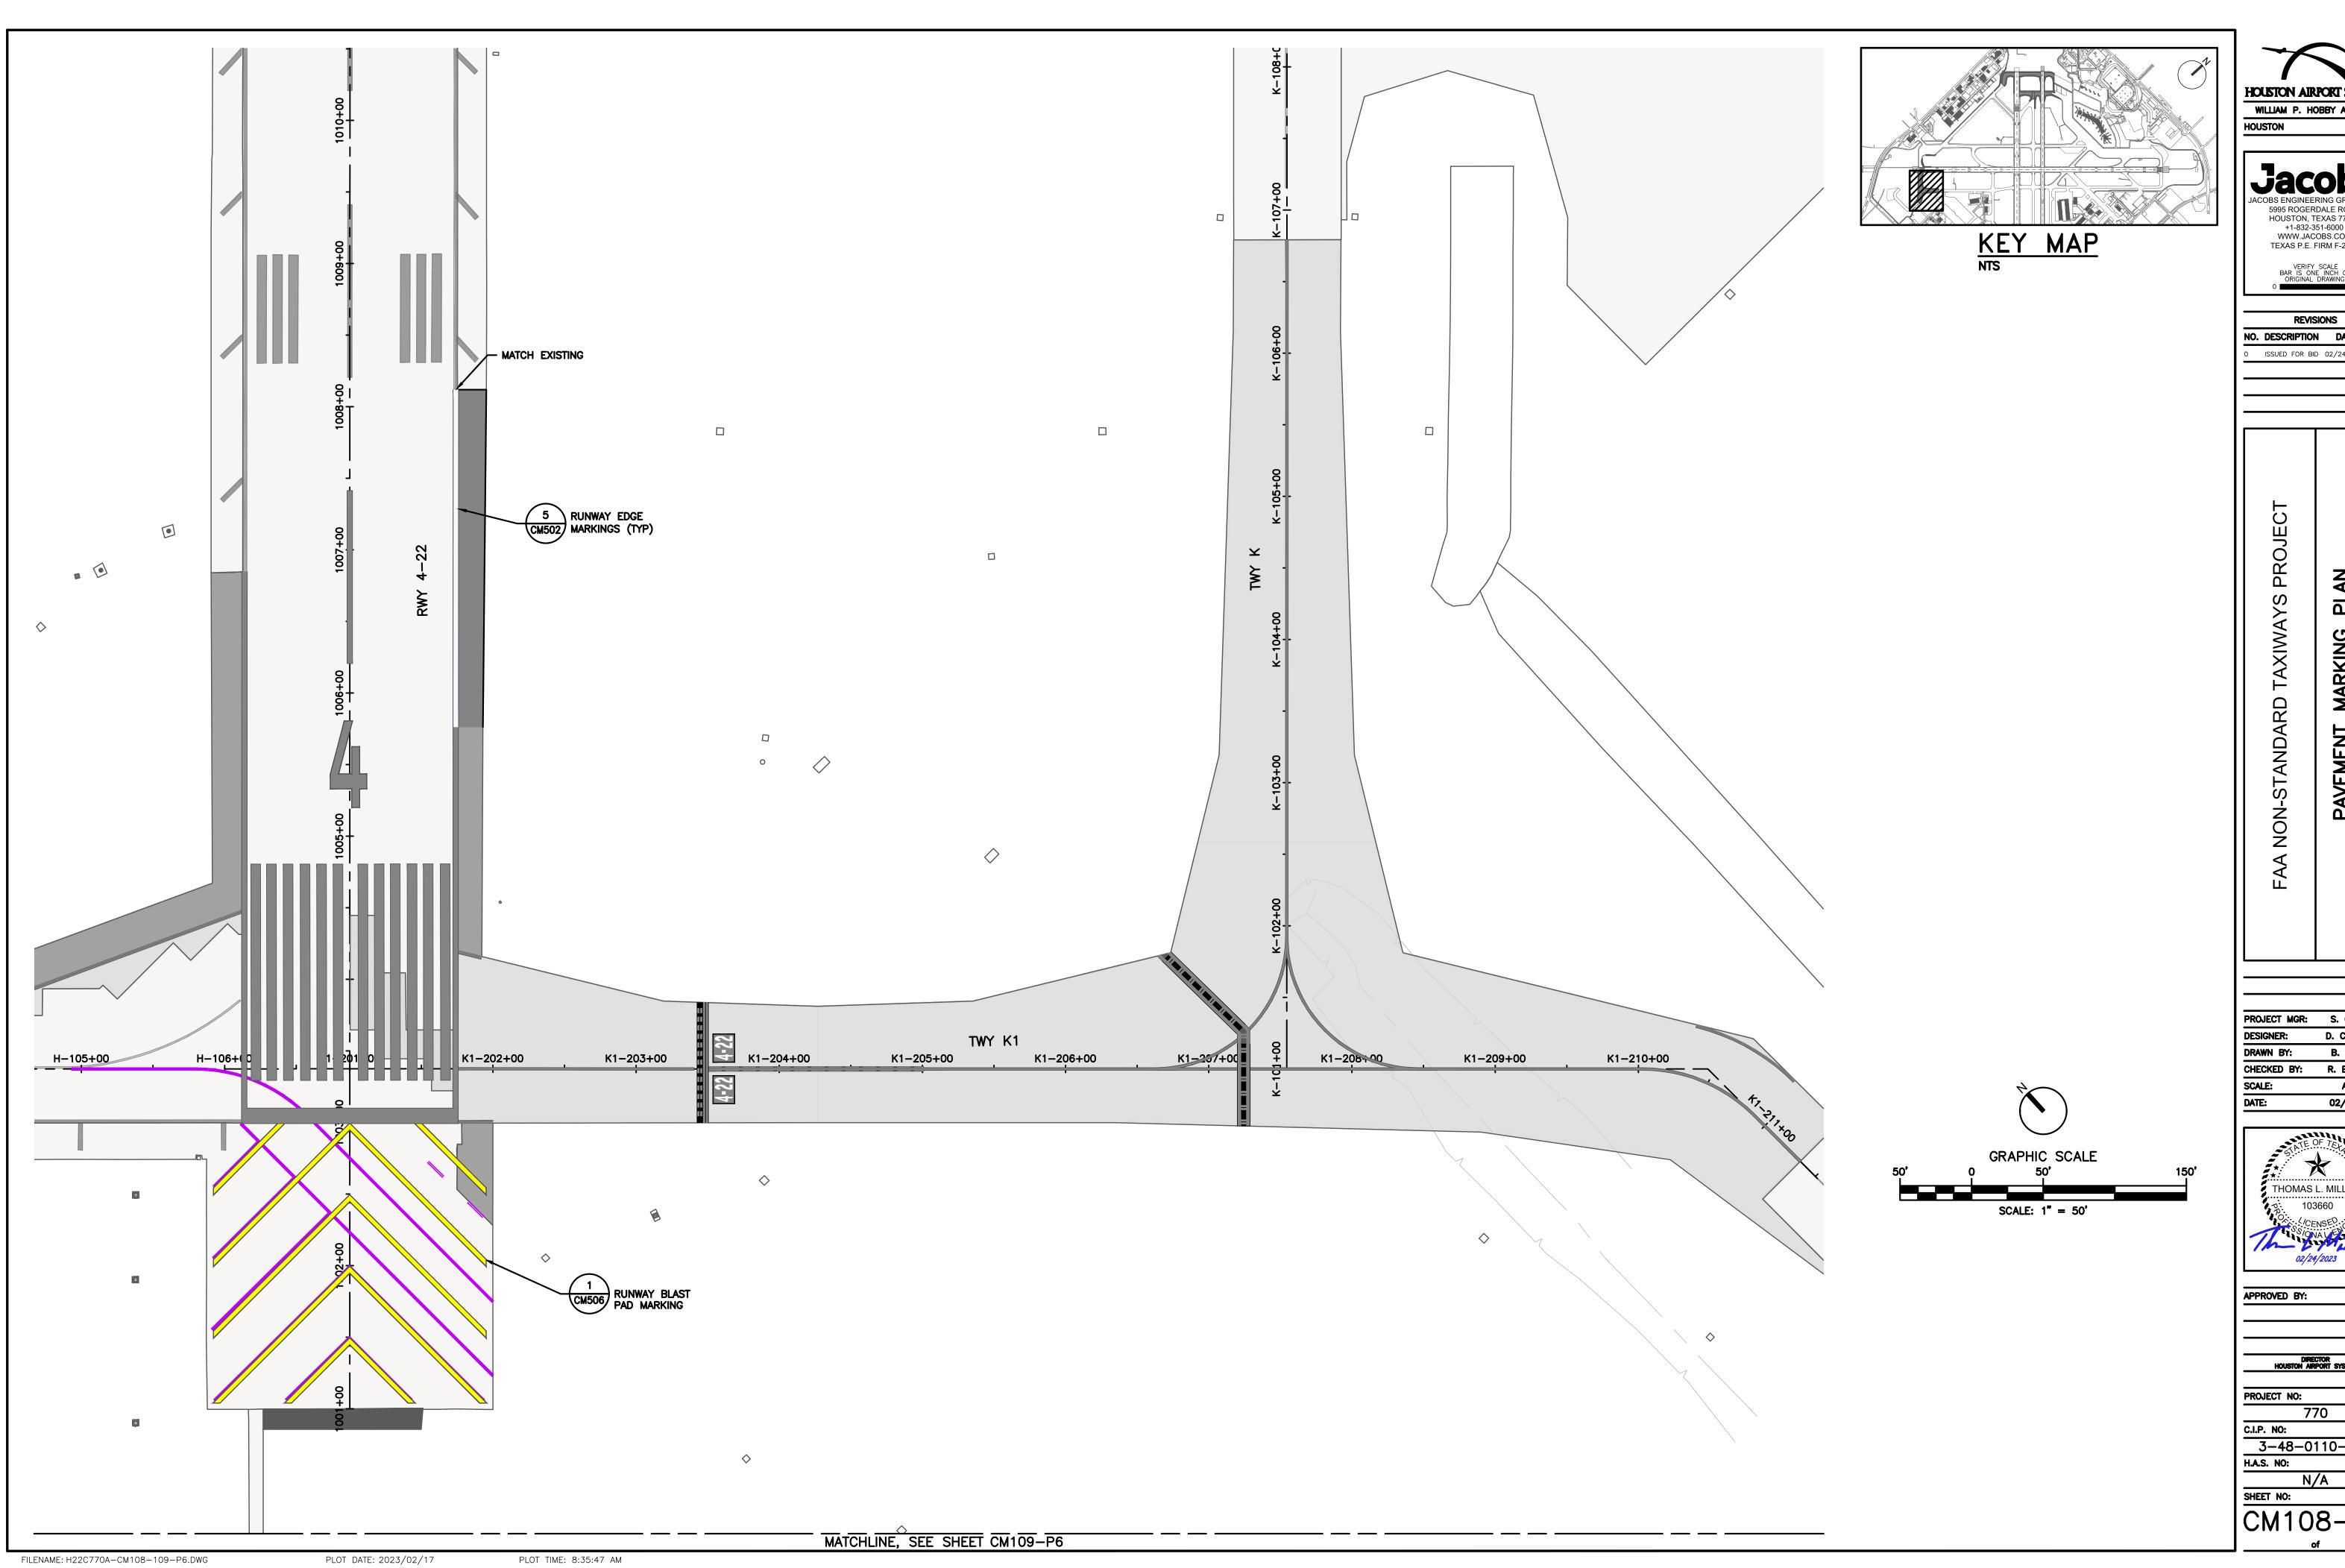

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PROJECT MGR: S. CHILDERS D. CRAWFORD B. BARTLETT R. EHTESHAM AS SHOWN


02/24/2023




DIRECTOR HOUSTON AIRPORT SYSTEM

770

3-48-0110-044

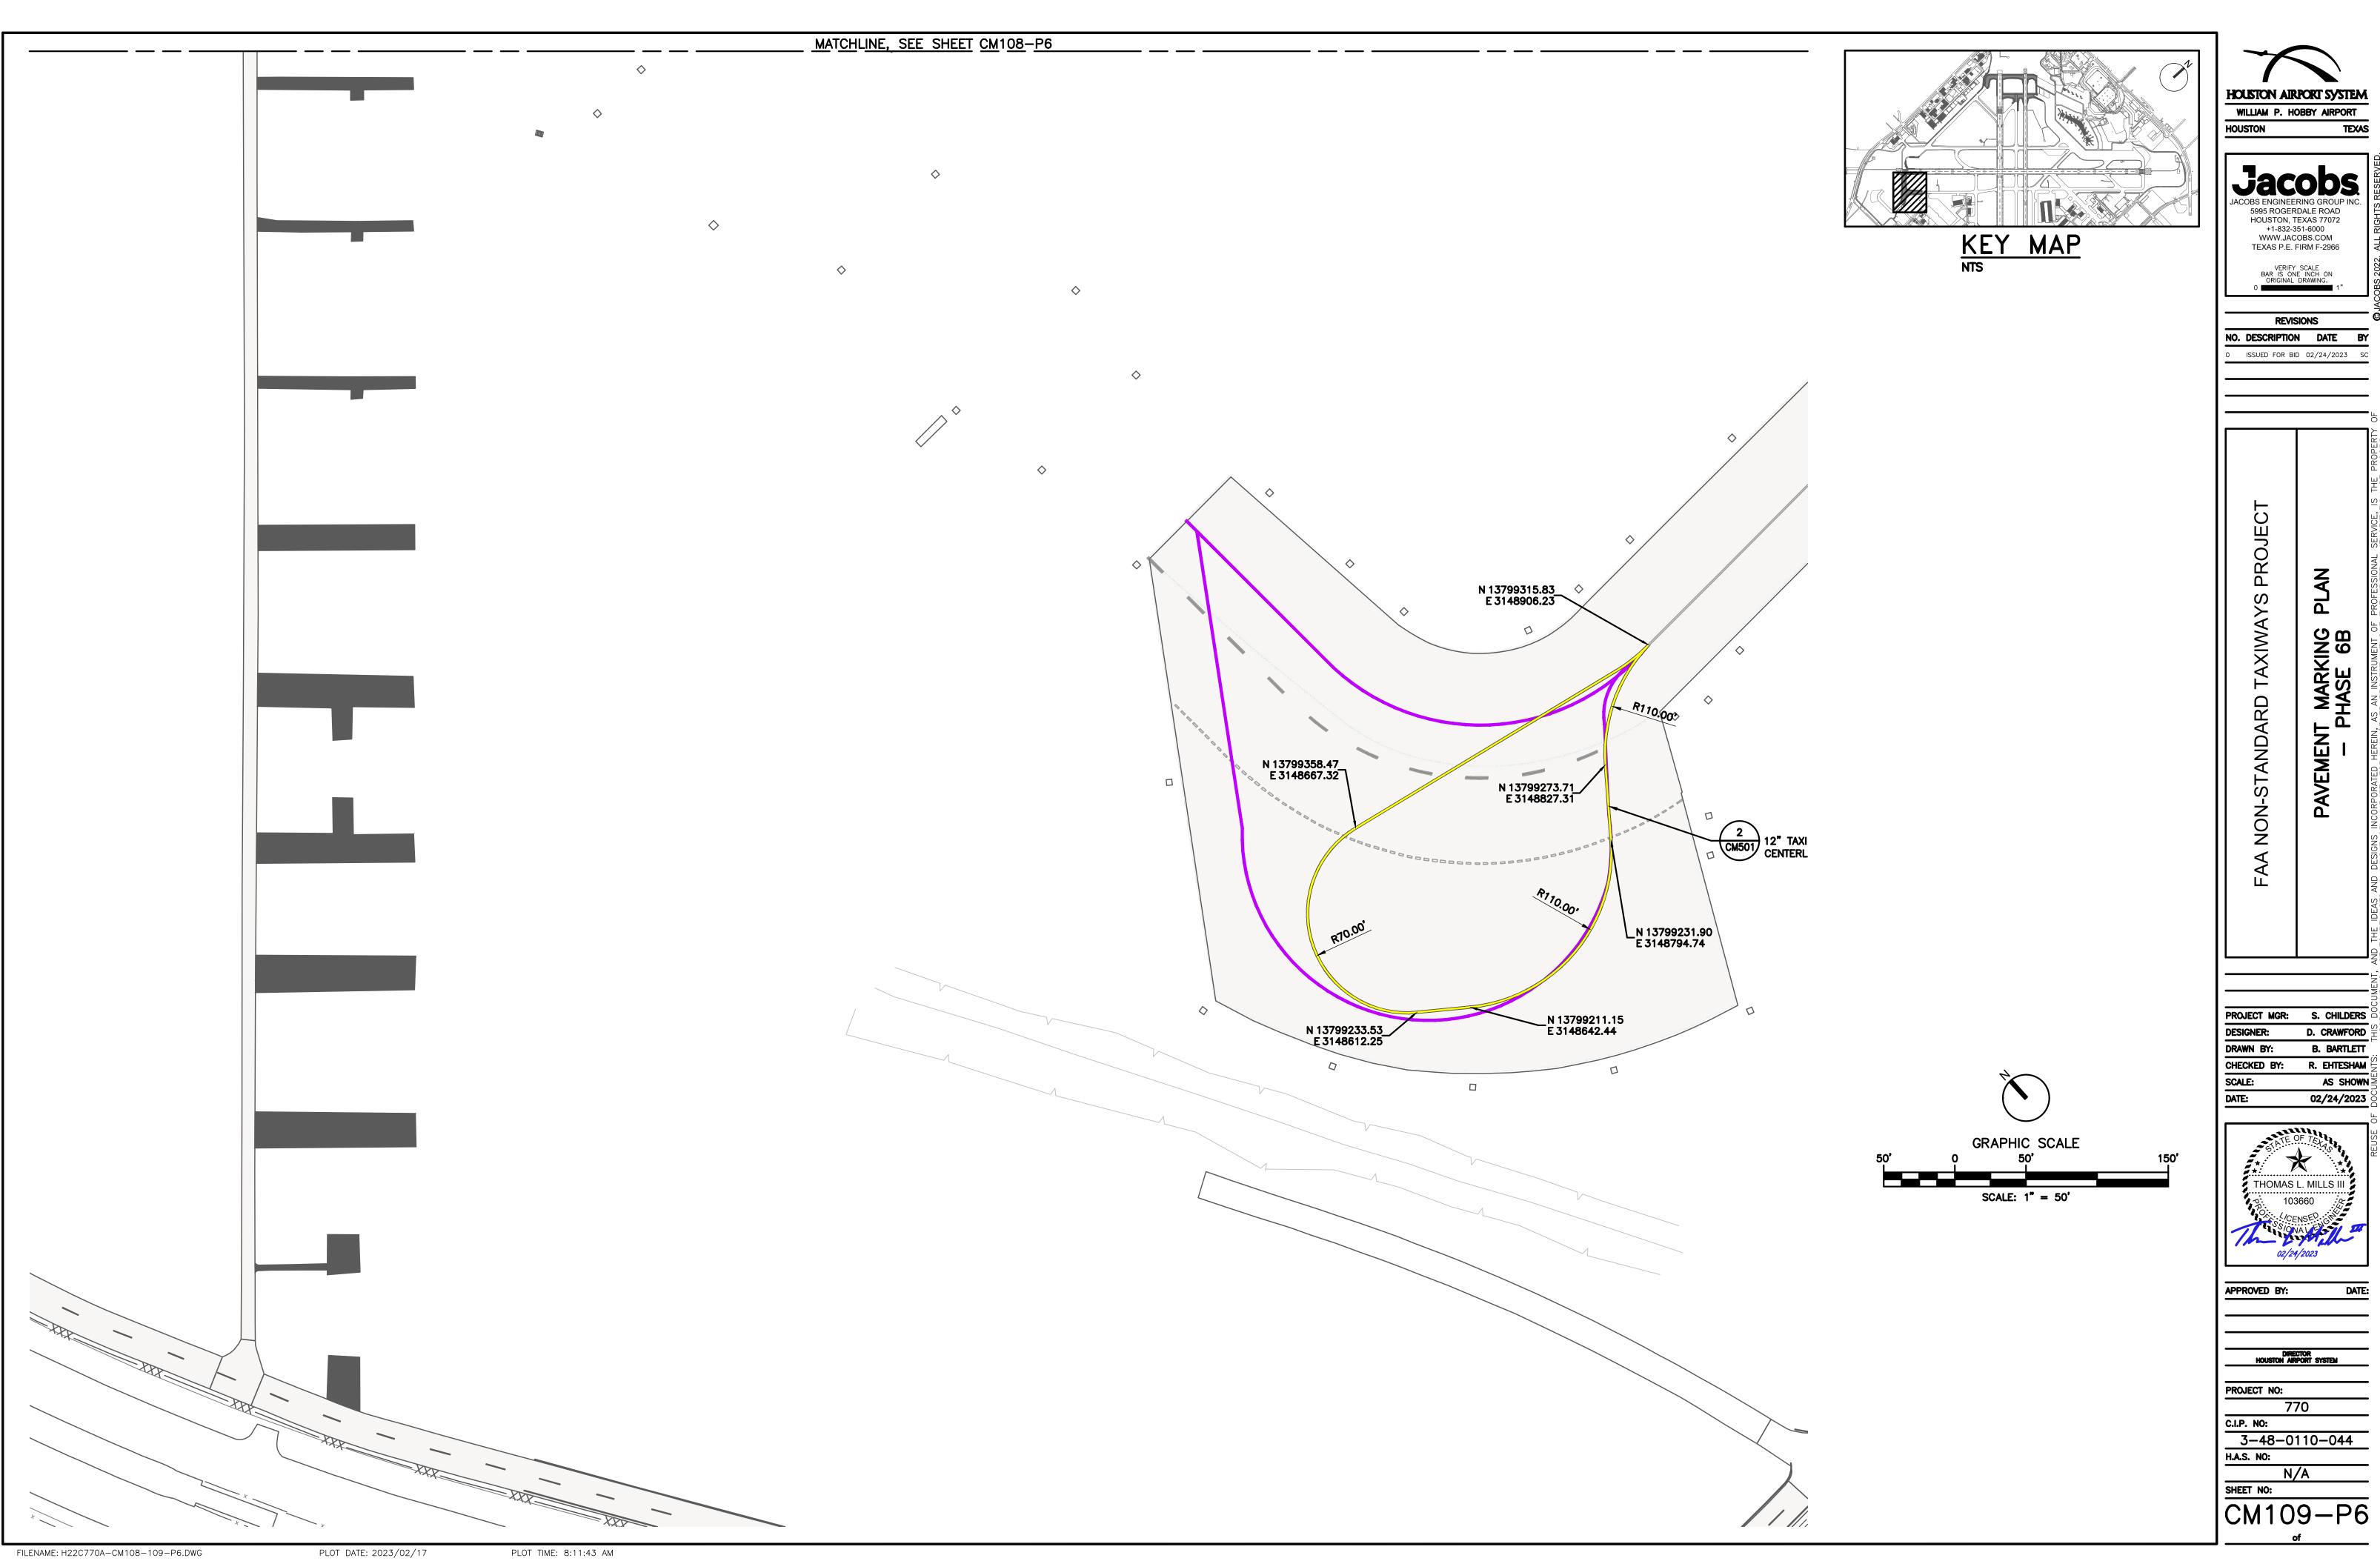




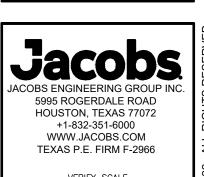

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PROJECT MGR:	s. Childers $^{ hinspace}$) נ
DESIGNER:	D. CRAWFORD $\stackrel{\circ}{\Xi}$	2
DRAWN BY:	B. BARTLETT	
CHECKED BY:	R. EHTESHAM	
SCALE:	,	,
DATE:	02/24/2023)

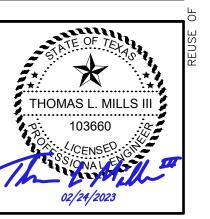


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APPROVED	BY:	DATE:	
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DIRECTOR HOUSTON AIRPORT SYSTEM PROJECT NO:


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3-48-0110-044




6" TAXIWAY/TAXILANE CENTERLINE

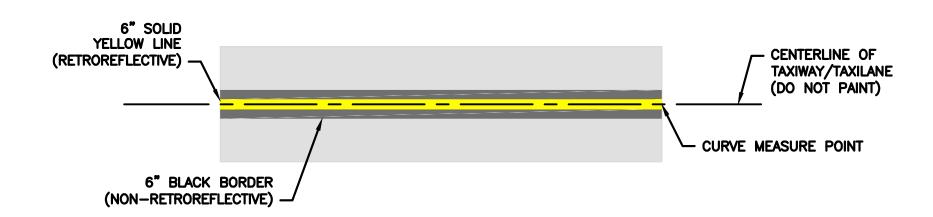
1" = 5'-0"

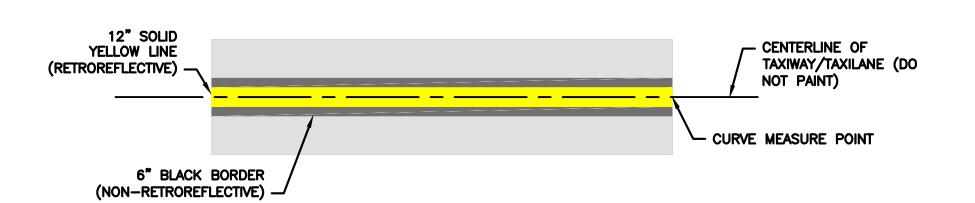

2 12" TAXIWAY/TAXILANE CENTERLINE

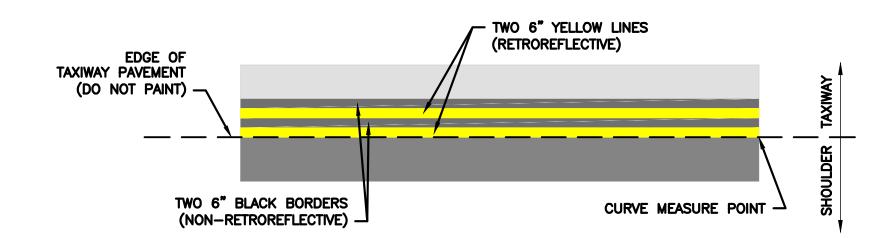

TAXIWAY SOLID EDGE

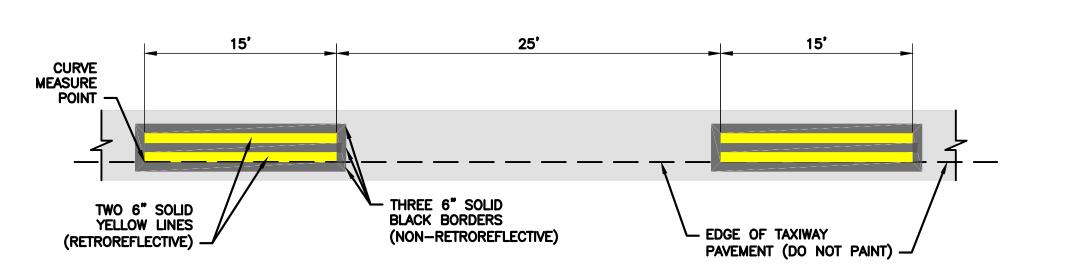

TAXIWAY EDGE DASHED MARKING

1" = 5'-0"

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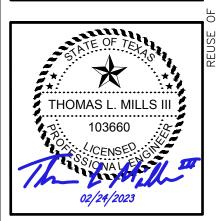
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TAXIWAYS PROJEC

NON-STANDARD

DETAILS MARKING

PROJECT MGR: S. CHILDERS DESIGNER: D. CRAWFORD B. BARTLETT CHECKED BY: R. EHTESHAM SCALE: AS SHOWN 02/24/2023



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DIRECTOR HOUSTON AIRPORT SYSTEM

PROJECT NO:


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H.A.S. NO:


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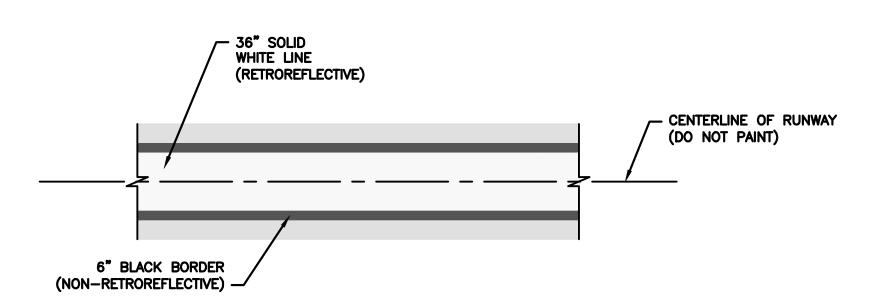
PLOT DATE: 2023/02/17 PLOT TIME: 10:46:36 AM


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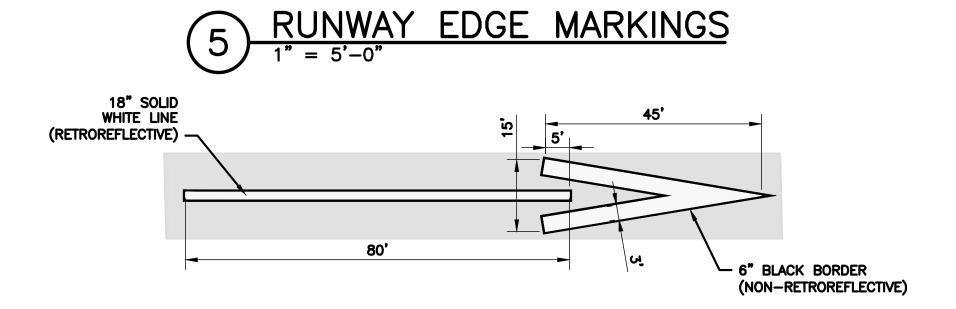






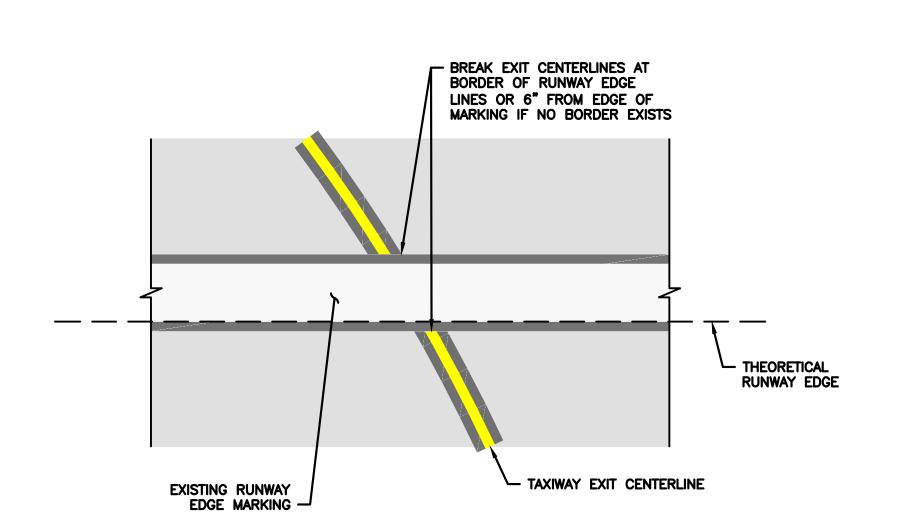


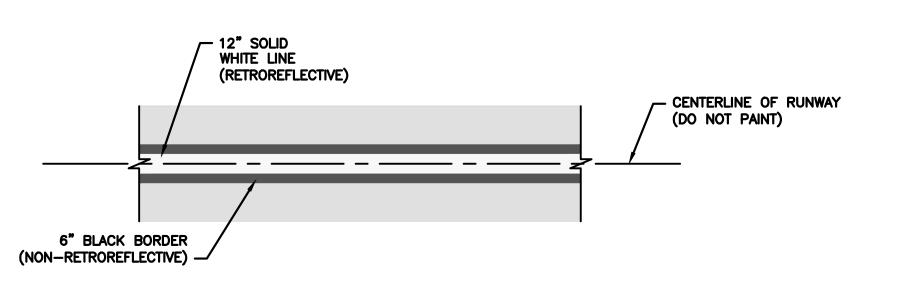

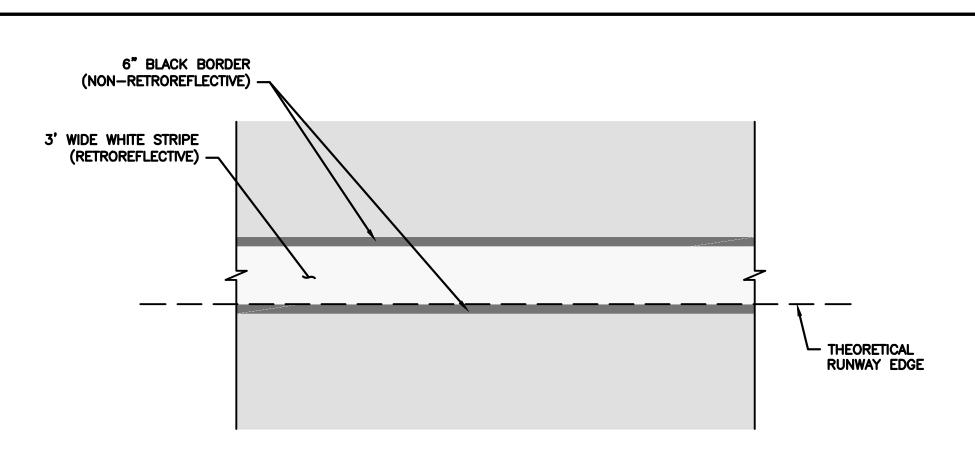


6 DISPLACED THRESHOLD MARKING

1" = 20'-0"

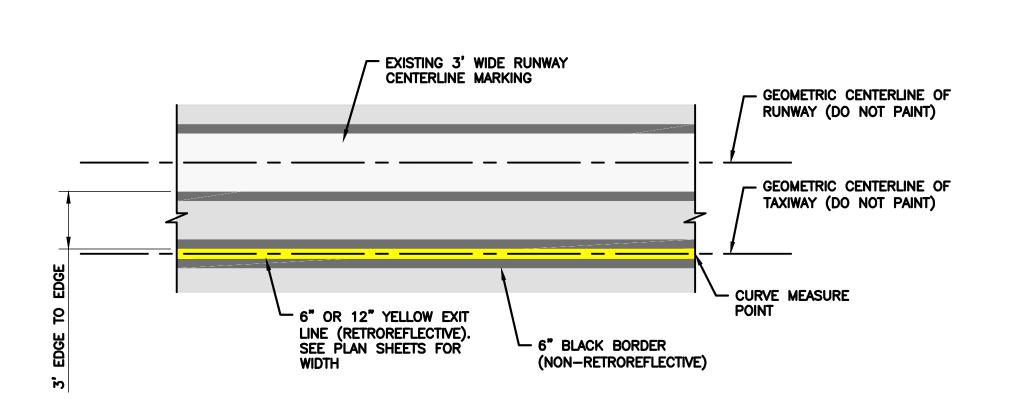

TAXIWAY EXIT AT RUNWAY CENTERLINE

1" = 5'-0"

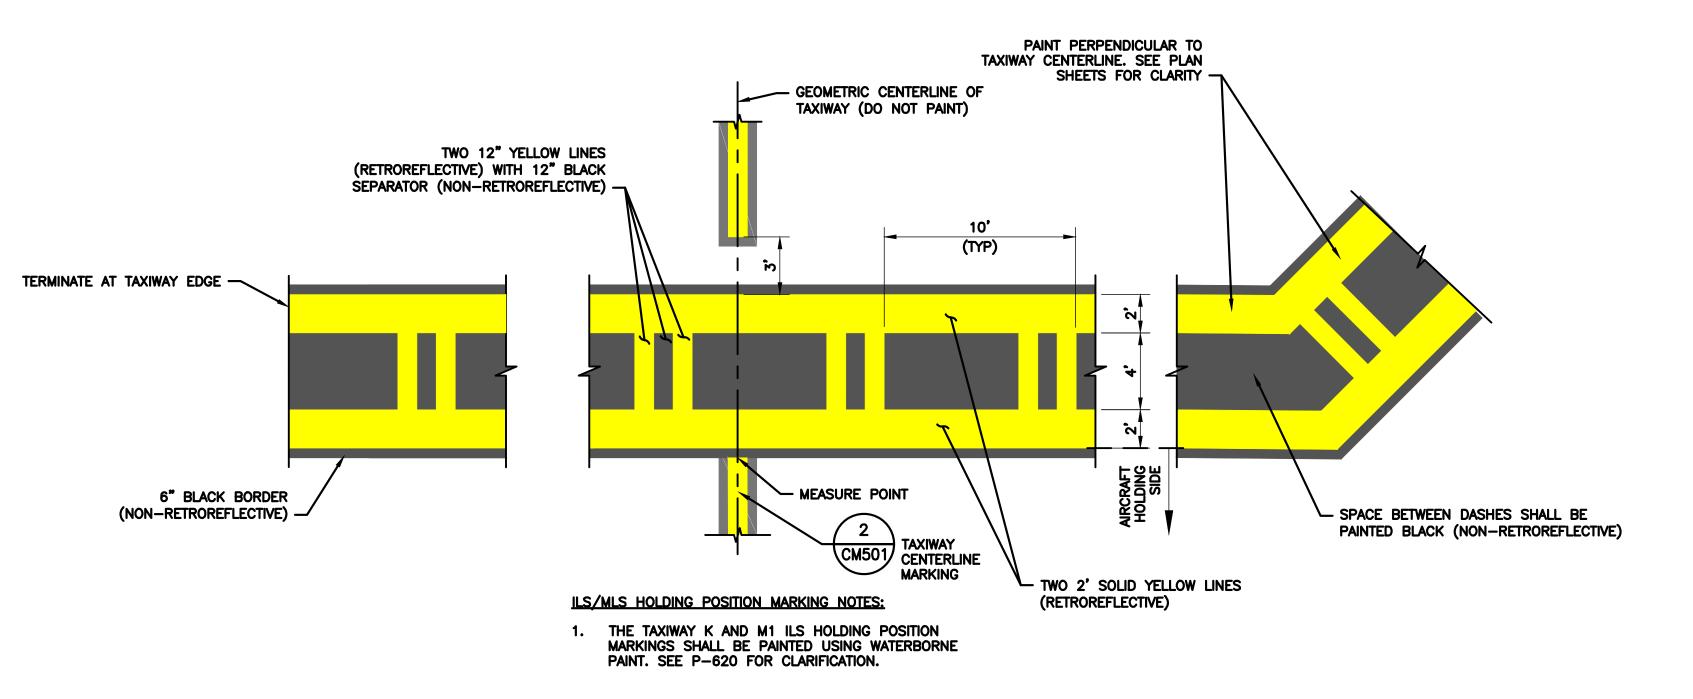

TAXIWAY K AND M1 ILS HOLD POSITION MARKING

1" = 5'-0"

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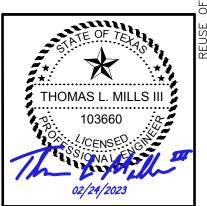
TAXIWAYS

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NON-ST

DETAILS MARKING

S. CHILDERS D. CRAWFORD B. BARTLETT R. EHTESHAM CHECKED BY: SCALE: AS SHOWN 02/24/2023



APPROVED BY:

DIRECTOR
HOUSTON AIRPORT SYSTEM

PROJECT NO: 770

C.I.P. NO: 3-48-0110-044

H.A.S. NO:

SHEET NO:

CM502


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PLOT DATE: 2023/02/17

PLOT TIME: 10:46:49 AM

RUNWAY HOLDING POSITION MARKING NOTES:


RUNWAY HOLDING POSITION MARKINGS SHALL BE PAINTED USING PREFORMED THERMOPLASTIC, UNLESS OTHERWISE NOTED. SEE SPECIFICATION P-620 FOR CLARIFICATION

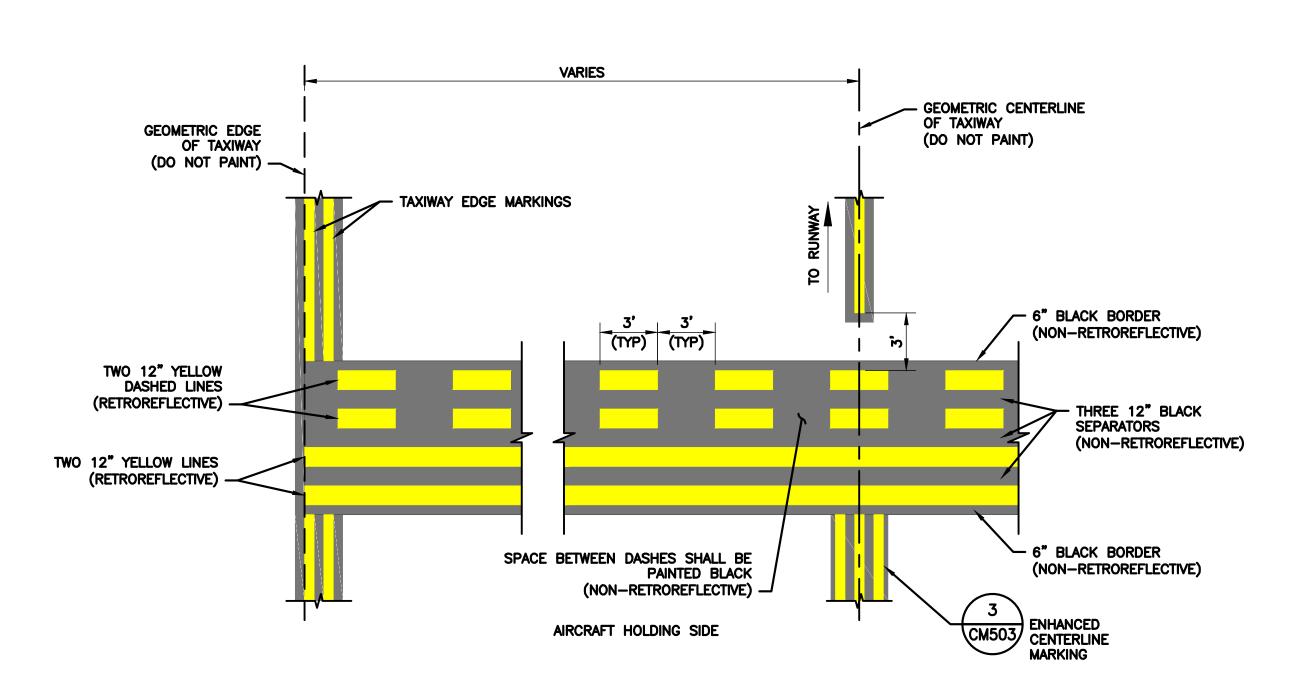

RUNWAY HOLDING POSITION MARKING


ILS/MLS HOLDING POSITION MARKING NOTES:

ILS HOLDING POSITION MARKINGS SHALL BE PAINTED USING PREFORMED THERMOPLASTIC, UNLESS OTHERWISE NOTED. SEE SPECIFICATION P-620 FOR CLARIFICATION

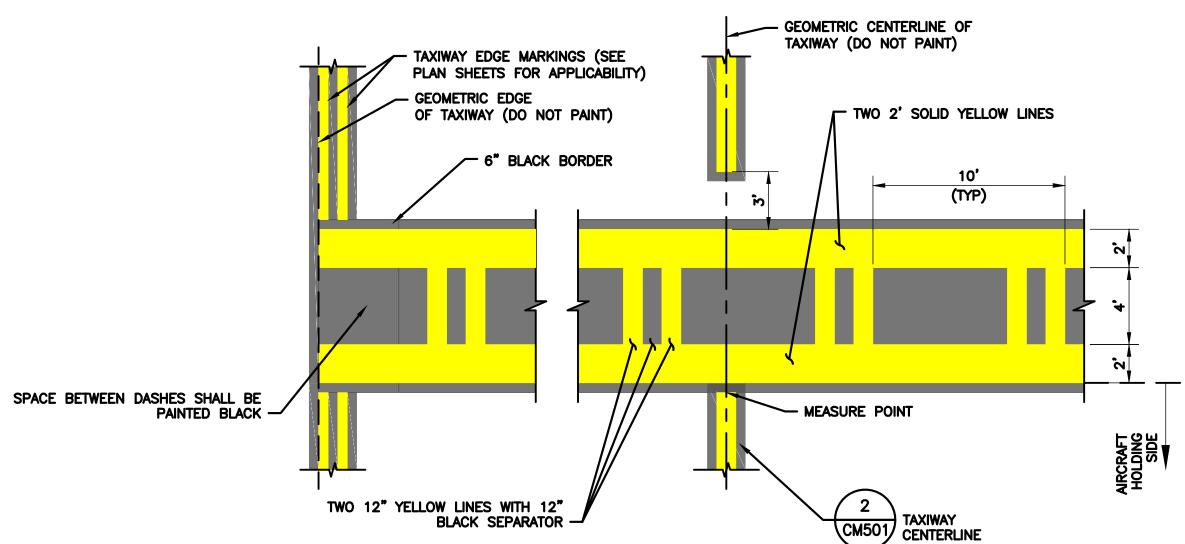

2) ILS/MLS HOLDING POSITION MARKING

1" = 5'-0"

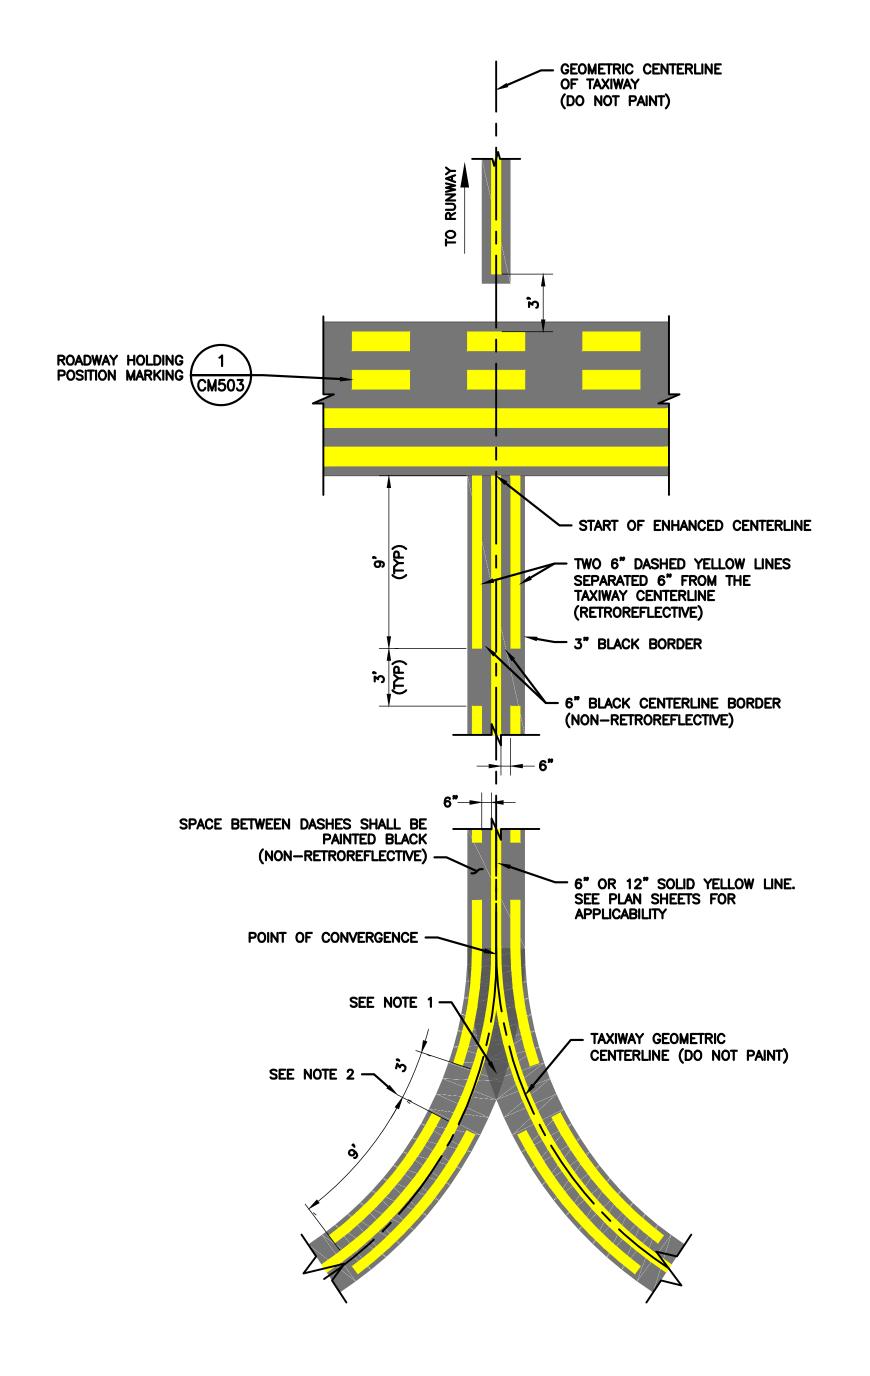

3 ENHANCED TAXIWAY CENTERLINE

1" = 5'-0"

ENHANCED TAXIWAY CENTERLINE NOTES:

- 1. V-SHAPED INNER DASHES START AND STOP WITH THE OUTSIDE 9' DASHES. IF THE V-SHAPED DASHED ARE LESS THAN 5' AT THE POINT OF CONVERGENCE, THEY MAY BE OMITTED.
- 2. RADIAL ENHANCED CENTERLINE MEASUREMENTS ARE TAKEN ALONG THE TAXIWAY GEOMETRIC CENTERLINE STRIPE.
- 3. TAXIWAY CENTERLINES ARE ENHANCED WITH TWELVE 9'-0" LONG STRIPES WITH 3'-0" SPACES ENDING WITH ONE 6'-0" LONG STRIPE TOTALING 150'-0" PRIOR TO RUNWAY HOLD BAR.
- 4. IF THE ENHANCED CENTERLINE INTERSECTS ANOTHER TAXIWAY LOCATED WITHIN 150'-0" OF THE RUNWAY HOLD POSITION MARKING, THE ENHANCED CENTERLINE SHALL TERMINATE 5'-0" PRIOR TO THE POINT OF INTERSECTION. SEE DETAIL 2 FOR CLARIFICATION.
- 5. END OF THE LAST SEGMENT SHALL BE CAPPED WITH A 6" BLACK BORDER

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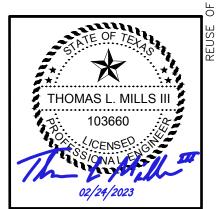
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ISSUED FOR BID 02/24/2023 SC

PROJECT MGR: S. CHILDERS **DESIGNER:** D. CRAWFORD B. BARTLETT R. EHTESHAM CHECKED BY: SCALE: AS SHOWN 02/24/2023



APPROVED BY:

DIRECTOR HOUSTON AIRPORT SYSTEM

PROJECT NO:

770 C.I.P. NO:

H.A.S. NO:

CM503


PLOT DATE: 2023/02/17

PLOT TIME: 10:47:06 AM

FILENAME: H22C770A-CM501-506.DWG

3-48-0110-044

SHEET NO:

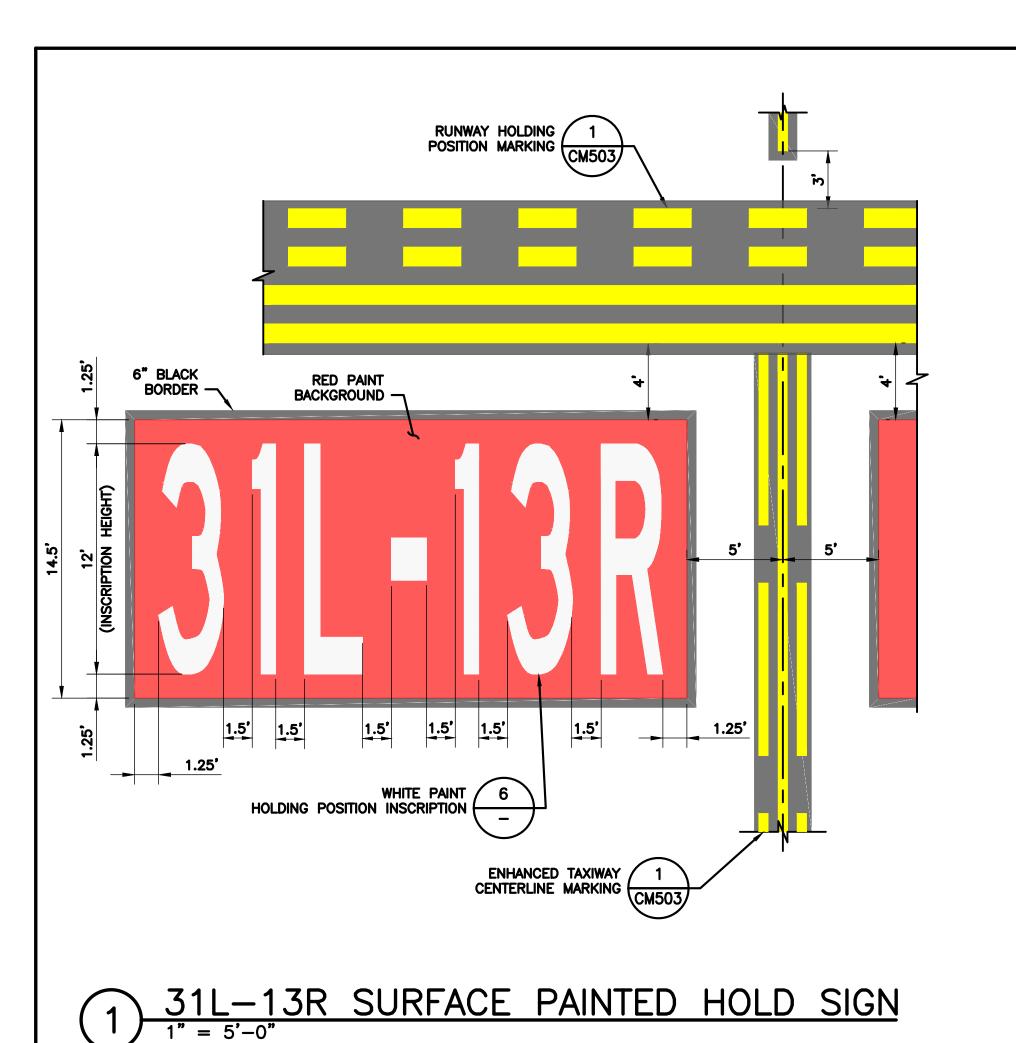

RUNWAY HOLDING 1
POSITION MARKING (CM503)

6" BLACK BORDER -

WHITE PAINT

RED PAINT -

1.5'

HOLDING POSITION WHITE PAINT 6


3 31R-13L SURFACE PAINTED HOLD SIGN

ENHANCED TAXIWAY CENTERLINE MARKING


6" BLACK BORDER

RED PAINT

WHITE PAINT HOLDING POSITION INSCRIPTION

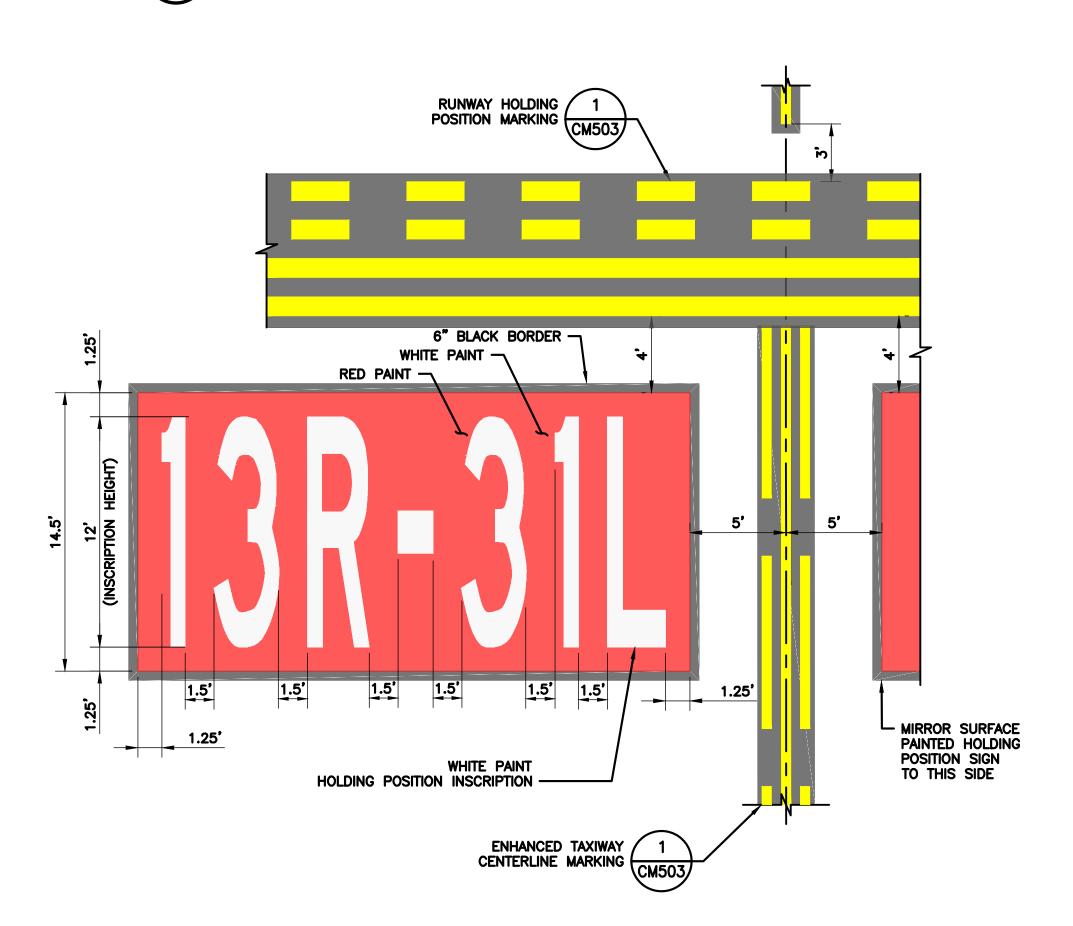



13R-31L SURFACE PAINTED HOLD SIGN

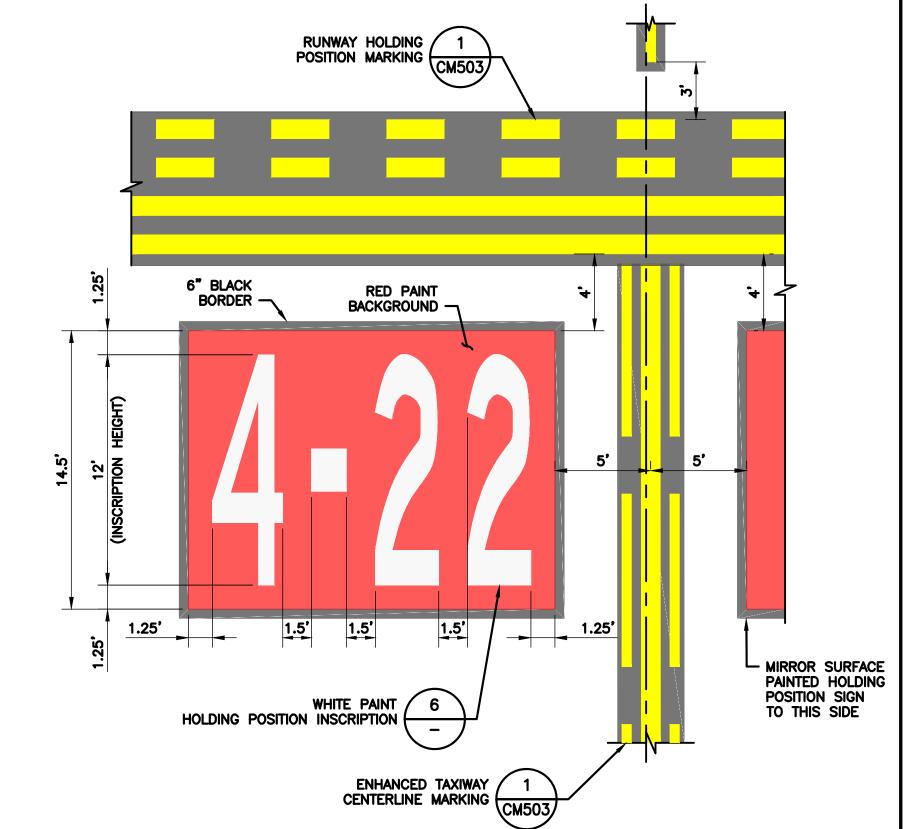




- SURFACE PAINTED HOLDING POSITION SIGN SHALL BE MARKED IN ACCORDANCE TO AC 150/5340-1M.
- FOR ALL SURFACE PAINTED LETTERING, USE STENCILS. THE CONTRACTOR SHALL PROVIDE THE PAVEMENT MARKING STENCILS TO THE AIRPORT AFTER PAVEMENT MARKINGS HAVE BEEN
- BOTH RED AND WHITE PAINT SHALL RECEIVE REFLECTIVE MEDIA; HOWEVER RED SHALL BE AT A REDUCED RATE AS SHOWN IN SPECIFICATION P-620. THE 6" BLACK BORDER DOES NOT RECEIVE REFLECTIVE MEDIA.
- SURFACE PAINTED HOLDING POSITION MARKINGS SHALL BE PAINTED USING PREFORMED THERMOPLASTIC, UNLESS OTHERWISE NOTED. SEE SPECIFICATION P-620 FOR CLARIFICATION

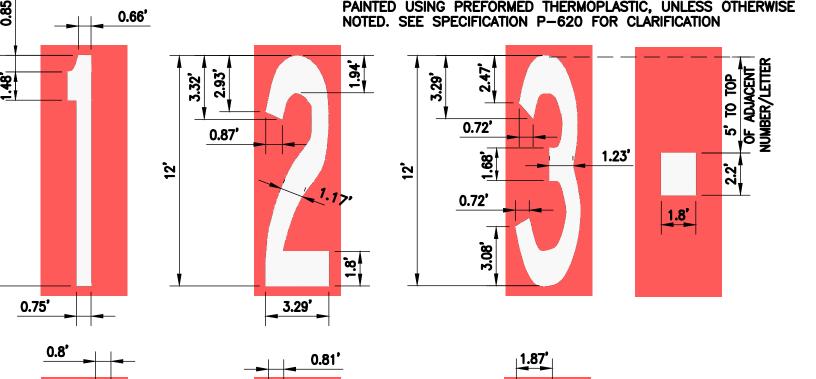

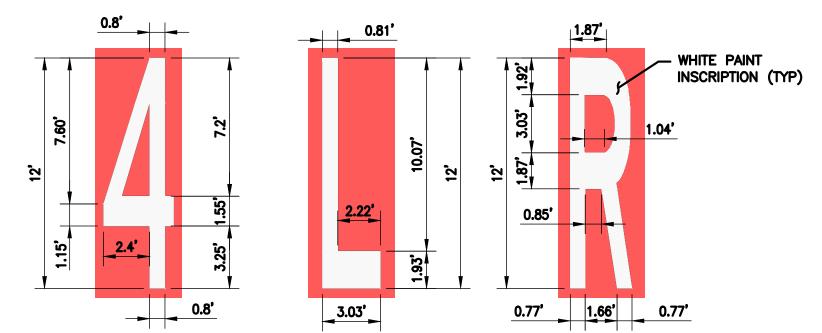

SURFACE PAINTED HOLDING POSITION INSCRIPTIONS

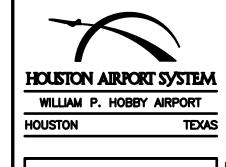


5995 ROGERDALE ROAD HOUSTON, TEXAS 77072 +1-832-351-6000 WWW.JACOBS.COM TEXAS P.E. FIRM F-2966

REVISIONS NO. DESCRIPTION DATE B' ISSUED FOR BID 02/24/2023 SC

PROJEC

DETAILS

S. CHILDERS D. CRAWFORD **DESIGNER:** B. BARTLETT R. EHTESHAM CHECKED BY: SCALE: AS SHOWN

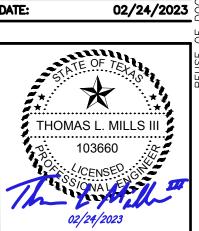

APPROVED BY:

DIRECTOR HOUSTON AIRPORT SYSTEM

PROJECT NO: 770

C.I.P. NO: 3-48-0110-044

H.A.S. NO:

SHEET NO: CM504

FILENAME: H22C770A-CM501-506.DWG

1.25'

PLOT DATE: 2023/02/17

1.5'

ENHANCED TAXIWAY CENTERLINE MARKING

13L-31R SURFACE PAINTED HOLD SIGN


1.25'

PLOT TIME: 10:47:21 AM

- MIRROR SURFACE PAINTED HOLDING POSITION SIGN

TO THIS SIDE

- MIRROR SURFACE PAINTED HOLDING POSITION SIGN TO THIS SIDE

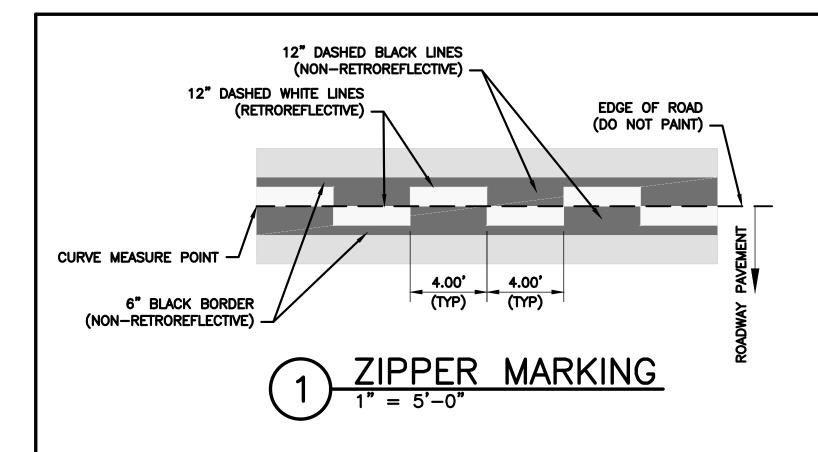


6" SOLID WHITE LINE

CURVE MEASURE POINT

FILENAME: H22C770A-CM501-506.DWG

(RETROREFLECTIVE)

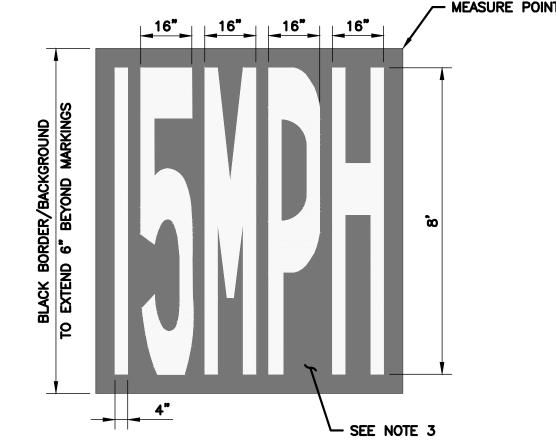


ROADWAY MARKING NOTES:

- LETTERING SHALL CONFORM TO THE LATEST VERSION OF STANDARD ALPHABETS FOR HIGHWAY SIGNS AND PAVEMENT MARKINGS (AASHTO, A POLICY ON GEOMETRIC DESIGN OF HIGHWAYS AND STREETS).
- 2. LETTERING SHALL BE CENTERED IN LANE.
- 3. SPACES BETWEEN LETTERS OR NUMBERS SHALL BE 4".
- 4. ALL LETTERS, ARROWS AND NUMBERS SHALL BE PAINTED WHITE ((RETROREFLECTIVE)).
- 5. 6" BLACK OUTLINE OR BACKGROUND IS REQUIRED ON CONCRETE PAVEMENTS AND SHALL BE (NON-RETROREFLECTIVE) UNLESS OTHERWISE NOTED.

- 6" BLACK BORDER

(NON-RETROREFLECTIVE)

15 MPH SPEED LIMIT MARKING

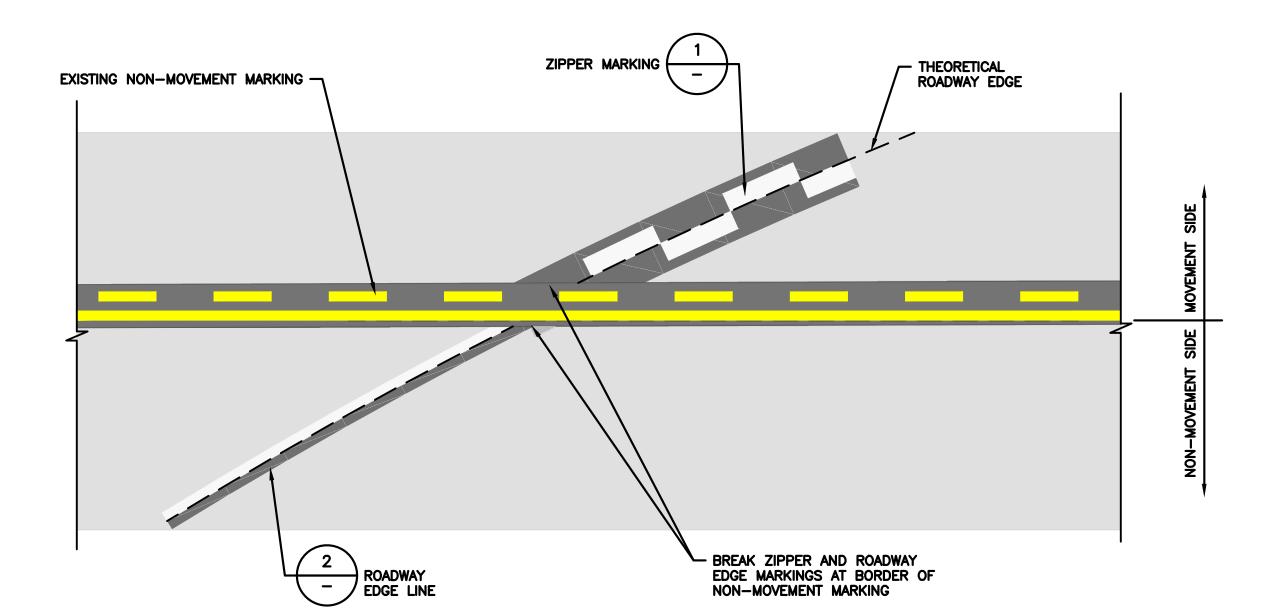


- EDGE OF ROAD


(DO NOT PAINT)

ROADWAY EDGE/NON-MOVEMENT MARKING INTERSECTION

1" = 5'-0"

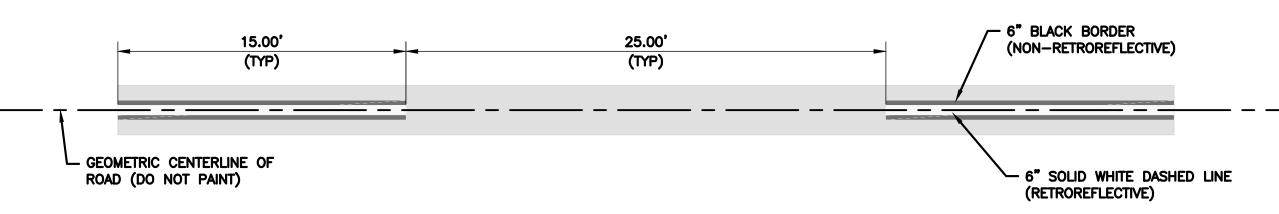


 $(5) \frac{\text{ROADWAY DASHED CENTERLINE MARKING}}{1" = 5'-0"}$

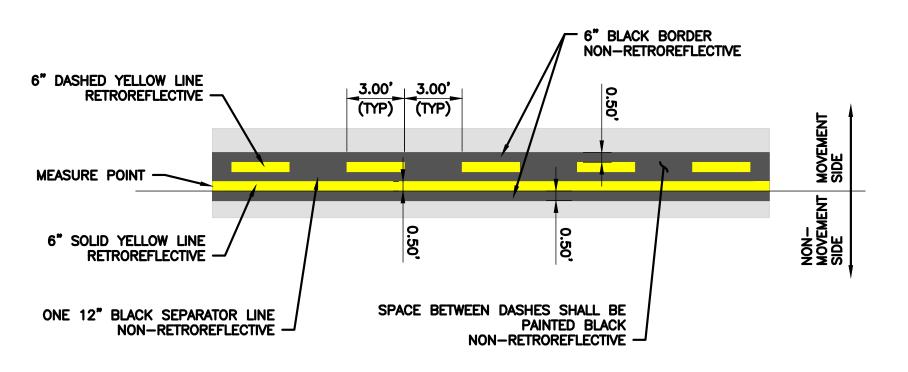

6 NON-MOVEMENT AREA MARKING DETAIL

1" = 5'-0"

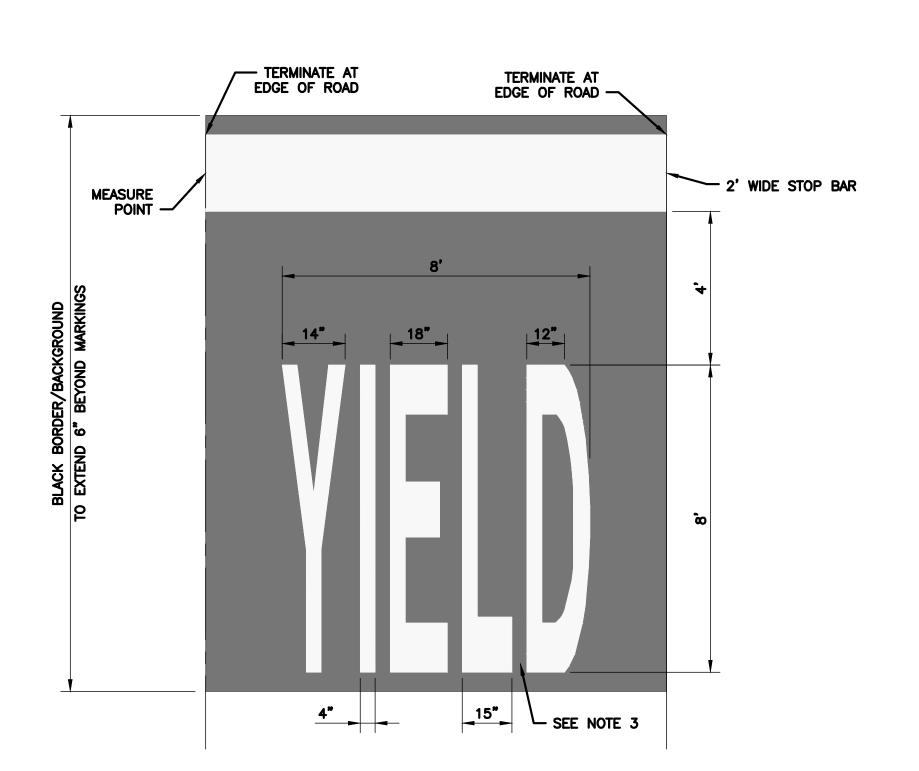

7) YIELD BAR MARKING DETAIL




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REVISIONS NO. DESCRIPTION DATE BY ISSUED FOR BID 02/24/2023 SC

DETAIL

D. CRAWFORD B. BARTLETT R. EHTESHAM 02/24/2023

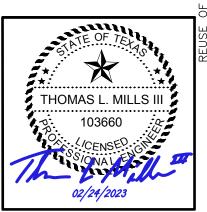


PROJECT NO: 770

C.I.P. NO: 3-48-0110-044

CM505

PLOT DATE: 2023/02/17


PLOT TIME: 10:47:36 AM

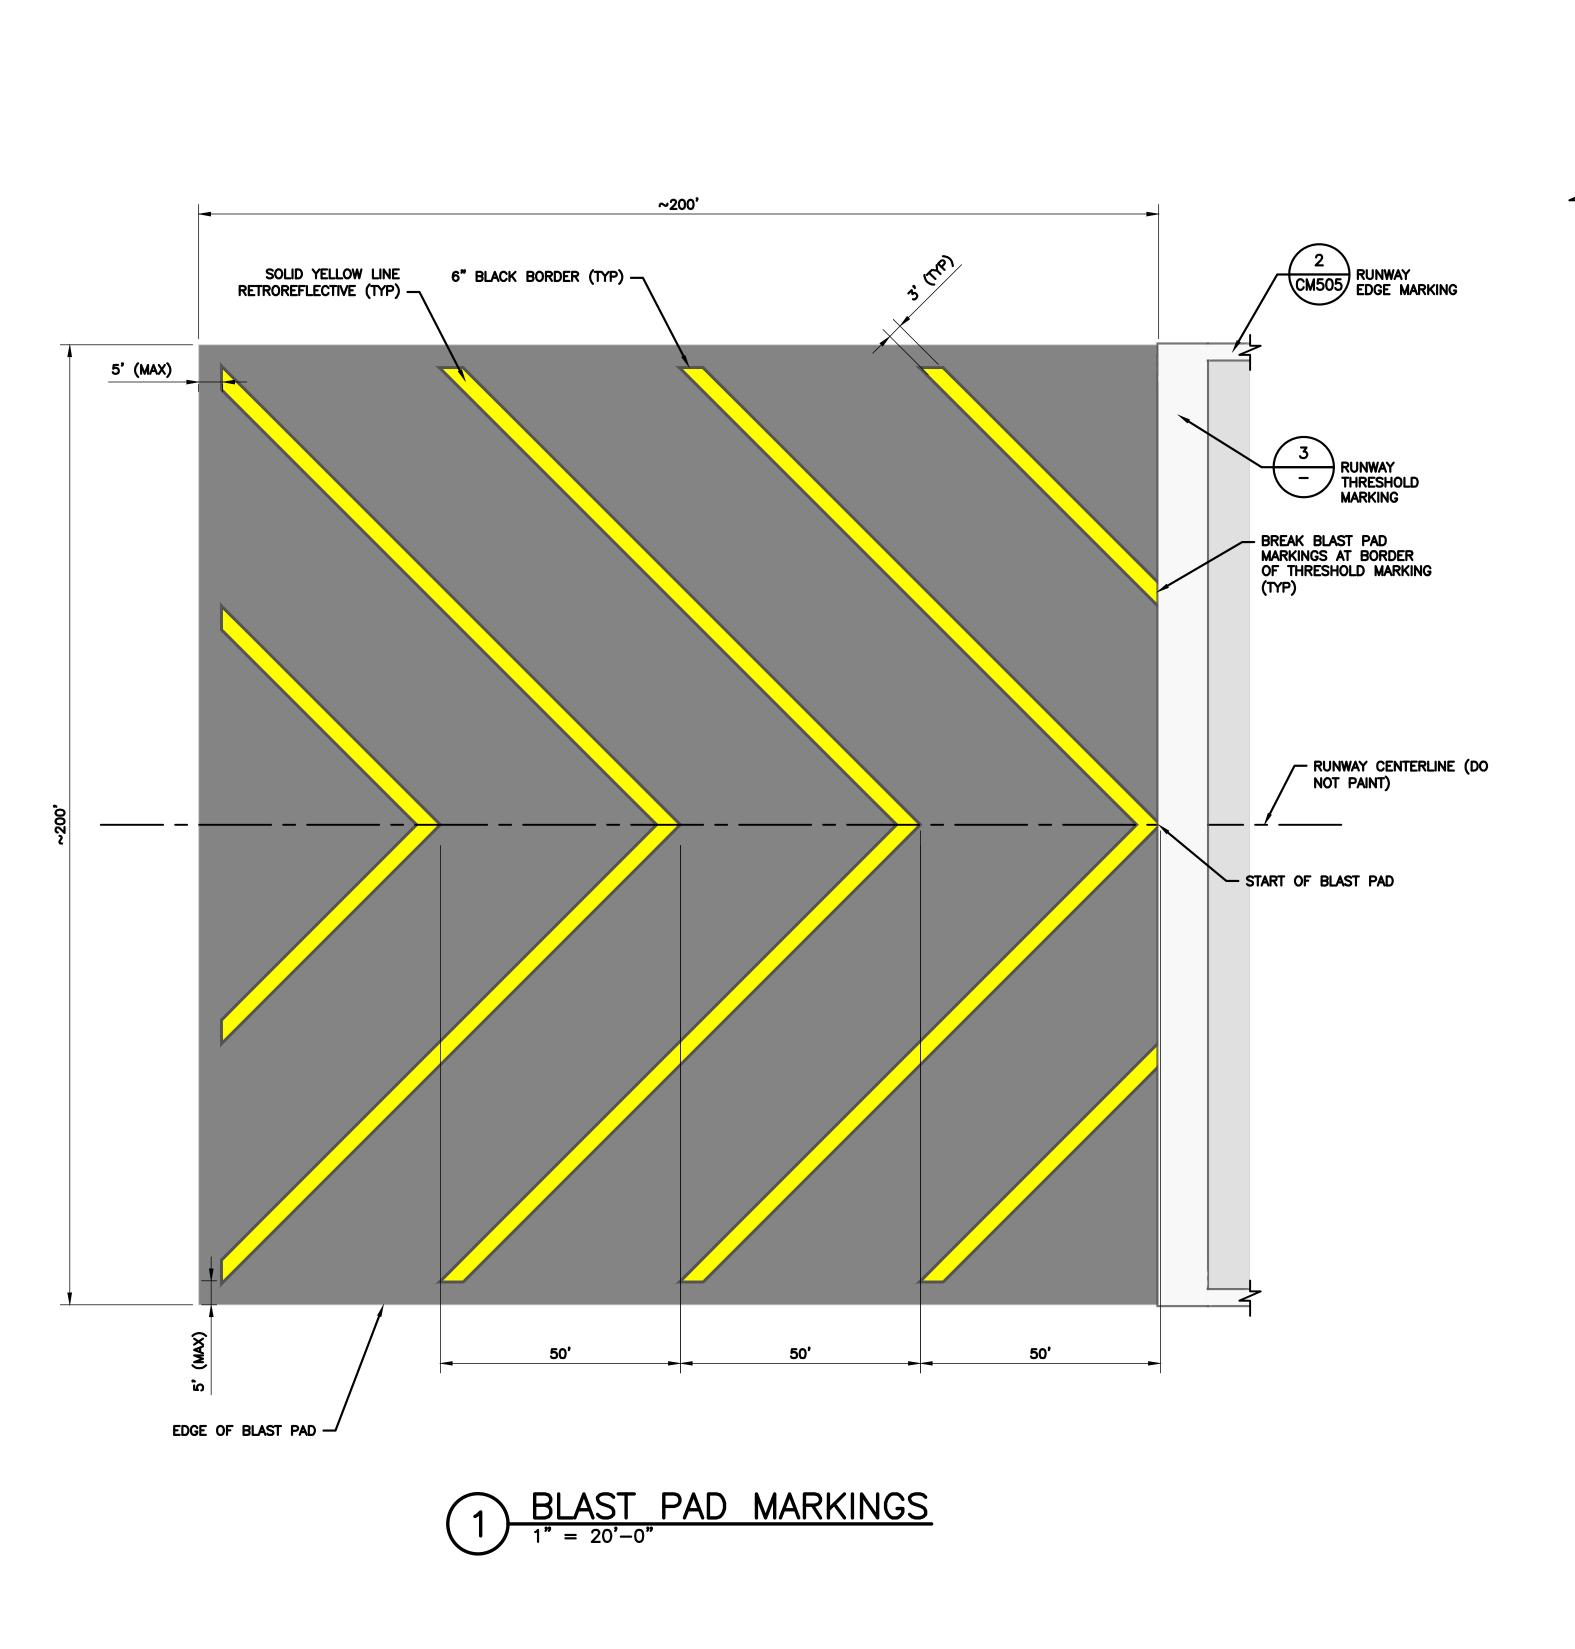




2 RUNWAY TOUCHDOWN MARKING

1" = 5'-0"

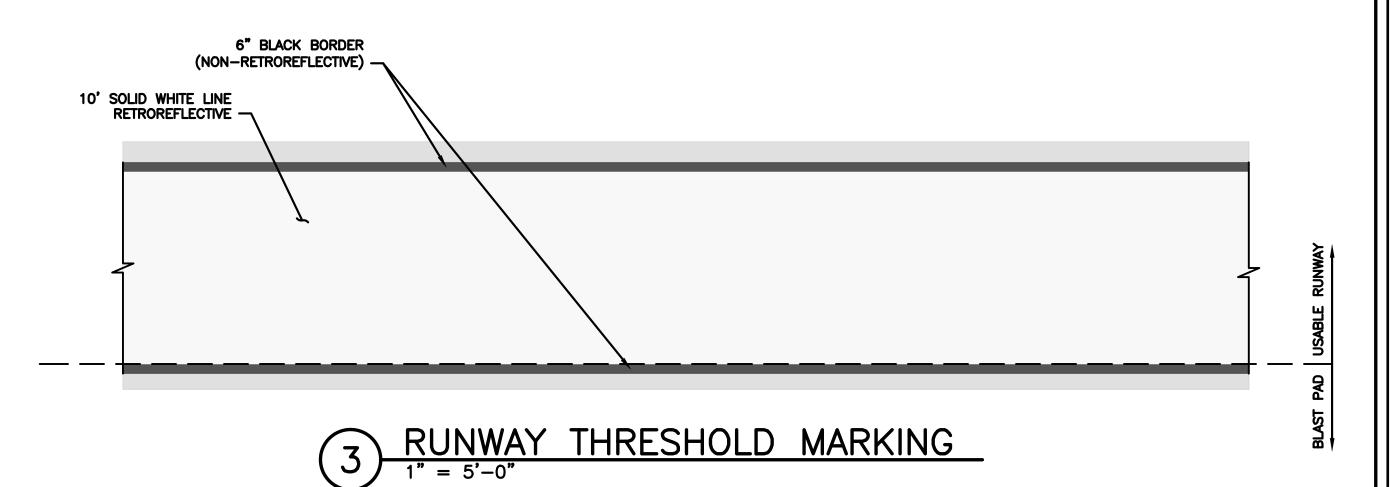

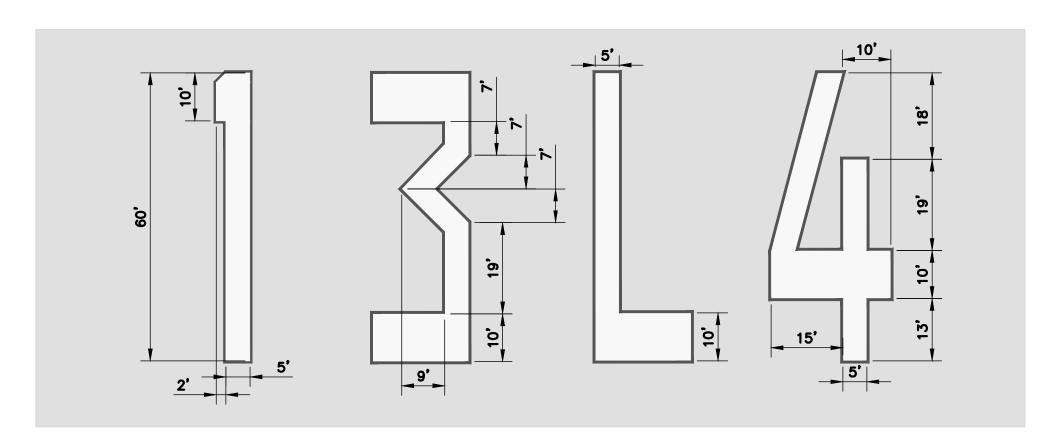

RUNWAY LETTERING AND NUMBERING NOTE:

- 1. FOLLOW DIMENSIONS FROM FAA ADVISORY CIRCULAR 150-5340-1M APPENDIX B WHEN PAINTING LETTERS AND NUMBERS.
- 2. ALL MARKINGS SHALL HAVE A 6" BLACK BORDER.

RUNWAY LETTERS AND NUMBERS

1" = 20'-0"



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REVISIONS NO. DESCRIPTION DATE BY


ISSUED FOR BID 02/24/2023 SC

DETAILS

PROJECT MGR:

DESIGNER: DRAWN BY: CHECKED BY:

SCALE: AS SHOWN 02/24/2023

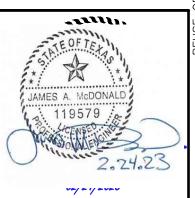

APPROVED BY:

DIRECTOR HOUSTON AIRPORT SYSTEM

PROJECT NO: 770

C.I.P. NO: 3-48-0110-044 H.A.S. NO:

SHEET NO:

CM506

FILENAME: H22C770A-CM501-506.DWG

PLOT DATE: 2023/02/17

PLOT TIME: 10:47:51 AM