

# IAH TERMINAL C GARAGE SIGNAGE & WAYFINDING TERMINAL C 3500 NORTH TERMINAL RD. HOUSTON, TX 77032

## ARCHITECT



### PGAL

3131 Briarpark Drive  
Suite 200  
Houston, TX 77042  
T 713-622-1444  
F 703-836-8027



## WAYFINDING DESIGNER



### LABOZAN ASSOC.

949 Lasalle Street  
Superior, CO 80027  
  
T 303- 494-7849  
F 303-218-8263

## STRUCTURAL



### HENDERSON ROGERS

2603 Augusta Drive  
Suite 800  
Houston, Tx 77057  
T 713-430-5800



**ARCHITECTURE  
ENGINEERING  
INTERIORS  
PLANNING**

ALEXANDRIA  
ATLANTA  
AUSTIN  
BOCA RATON  
CHICAGO  
DALLAS  
HOBOKEN  
HOUSTON  
LAS VEGAS  
LOS ANGELES

HAS DESIGN SIGN-OFF  
  
HAS - PROJECT MANAGER  
DESIGN AS SUBMITTED IS APPROVED  
FOR CONSTRUCTION DOCUMENTATION

DEPARTMENT OF AVIATION  
RECOMMENDED:  
  
HOUSTON AIRPORT SYSTEM  
DIRECTOR OR DESIGN REPRESENTATIVE  
HAS TIP # 24-103 - IAH

BSG PR#  
BSG-2024-111-IAH

PROJECT NUMBER  
1004395

SHEET TITLE  
COVER SHEET

SHEET NUMBER  
G0.00

**ISSUE FOR BID  
TABS2019011495**

**PROJECT No. 1004395**

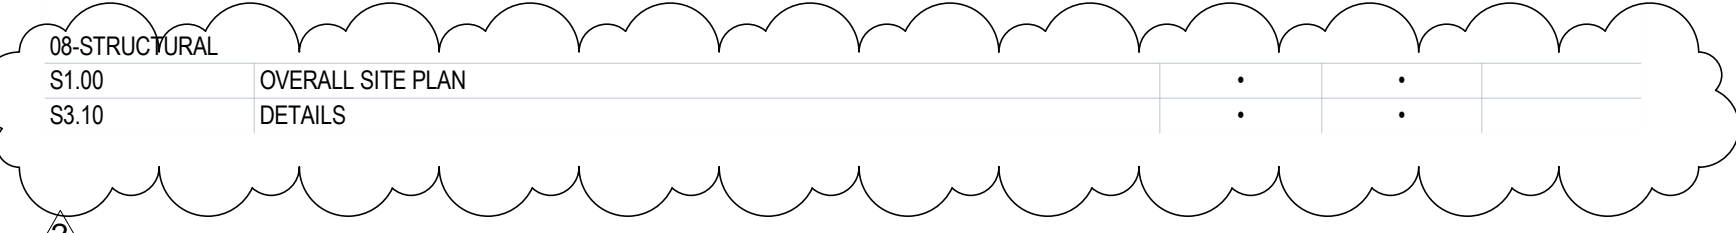
**08-23-2024**

## SHEET INDEX

Sheet No	Sheet Name	90%CD	IFP	PERMIT REVISION
00-General				
G0.00	COVER SHEET	.	.	
G0.01	SHEET INDEX	.	.	
G0.02	GENERAL PROJECT INFORMATION	.	.	
04 - DEMOLITION				
AD2.00A	LEVEL 01 - GARAGE - DEMO PLAN - SECTOR A	.	.	
AD2.00A.2	LEVEL 01 - GARAGE - DEMO PLAN - SECTOR A.2	.	.	
AD2.01A	LEVEL 01A - GARAGE - DEMO PLAN - SECTOR A	.	.	
AD2.02A	LEVEL 02 - GARAGE - DEMO PLAN - SECTOR A	.	.	
AD2.02C.1	LEVEL 02 - GARAGE - DEMO PLAN - SECTOR C	.	.	
AD2.02C.2	LEVEL 02 - GARAGE - DEMO PLAN - SECTOR C	.	.	
AD2.03A.1	LEVEL 03 - GARAGE - DEMO PLAN - SECTOR A	.	.	
AD2.03A.2	LEVEL 03 - GARAGE DEMO PLAN - SECTOR A.2	.	.	
AD2.03C.1	LEVEL 03 - GARAGE DEMO PLAN - SECTOR C	.	.	
AD2.03C.2	LEVEL 03 - GARAGE DEMO PLAN - SECTOR C	.	.	
AD2.04A.1	LEVEL 04 - GARAGE-DEMO PLAN - SECTOR A	.	.	
AD2.04A.2	LEVEL 04 - GARAGE-DEMO PLAN - SECTOR A	.	.	
AD2.04B.1	LEVEL 04 - GARAGE DEMO PLAN - SECTOR B	.	.	
AD2.04B.2	LEVEL 04 - GARAGE DEMO PLAN - SECTOR B	.	.	
AD2.04C.1	LEVEL 04 - GARAGE DEMO PLAN - SECTOR C	.	.	
AD2.04C.2	LEVEL 04 - GARAGE DEMO PLAN - SECTOR C	.	.	
AD2.05A.1	LEVEL 05 - GARAGE DEMO PLAN - SECTOR A	.	.	
AD2.05A.2	LEVEL 05 - GARAGE DEMO PLAN - SECTOR A	.	.	
AD2.05B.1	LEVEL 05 - GARAGE DEMO PLAN - SECTOR B	.	.	
AD2.05B.2	LEVEL 05 - GARAGE DEMO PLAN - SECTOR B	.	.	
AD2.05C.1	LEVEL 05 - GARAGE DEMO PLAN - SECTOR C	.	.	
AD2.05C.2	LEVEL 05 - GARAGE DEMO PLAN - SECTOR C	.	.	
AD2.06A.1	LEVEL 06 - GARAGE DEMO PLAN - SECTOR A	.	.	
AD2.06A.2	LEVEL 06 - GARAGE DEMO PLAN - SECTOR A	.	.	
AD2.06B.1	LEVEL 06 - GARAGE DEMO PLAN - SECTOR B	.	.	
AD2.06B.2	LEVEL 06 - GARAGE DEMO PLAN - SECTOR B	.	.	
AD2.06C.1	LEVEL 06 - GARAGE DEMO PLAN - SECTOR C	.	.	
AD2.06C.2	LEVEL 06 - GARAGE DEMO PLAN - SECTOR C	.	.	
AD2.07A	LEVEL 07 - GARAGE DEMO PLAN - SECTOR A	.	.	
AD2.07B	LEVEL 07 - GARAGE DEMO PLAN - SECTOR B	.	.	
05 - WAYFINDING DESIGN INTENT				
Sheet 1-1 - 1-2	1.1 INTRODUCTION	.	.	
Sheet 1-3 - 1-14	1.2 GRAPHIC STANDARDS - MESSAGES & TERMINOLOGY	.	.	
Sheet 1-15 - 1-16	1.3 GRAPHIC STANDARDS - TYPOGRAPHY	.	.	
Sheet 1-17	1.4 GRAPHIC STANDARDS - SYMBOLS	.	.	
Sheet 1-18 - 1-20	1.5 GRAPHIC STANDARDS - ARROWS	.	.	
Sheet 1-21	1.6 GRAPHIC STANDARDS - COLORS	.	.	
Sheet 1-22 - 1-24	1.7 SIGN TYPE INDEX - PARKING GARAGES C AND DE - VEHICULAR	.	.	
Sheet 1-25 - 1-27	1.8 SIGN TYPE INDEX - PARKING GARAGES C AND DE - PEDESTRIAN	.	.	
Sheet 1-28 - 1-29	1.9 SIGN TYPE INDEX - PARKING GARAGES C AND DE - REGULATORY	.	.	
Sheet 1-30	1.10 SIGN TYPE INDEX - SIGNS WITHIN TERMINAL / CONCOURSE AREAS	.	.	
Sheet 2-1 - 2-20	2.1 DESIGN INTENT - PARKING GARAGE - VEHICULAR SIGNS	.	.	
Sheet 2-21 - 2-37	2.2 DESIGN INTENT - PARKING GARAGE - PEDESTRIAN SIGNS	.	.	
Sheet 2-38 - 2-43	2.3 DESIGN INTENT - REGULATORY SIGNS	.	.	
Sheet 2-44 - 2-46	2.4 DESIGN INTENT - SIGNS WITHIN TERMINAL / CONCOURSE AREAS	.	.	
Sheet 3-1 - 3-5	3.1 DETAILS - PARKING GARAGE SIGNS	.	.	

## SHEET INDEX

Sheet No	Sheet Name	90%CD	IFP	PERMIT REVISION
06 - WAYFINDING LOCATION MESSAGES AND DETAILS				
Sheet 4-1	4.1 SIGN LOCATION PLAN - GARAGE C LEVEL 1- SECTOR 1 (C WEST)	.	.	
Sheet 4-2 - 4-13	4.2 MESSAGE SCHEDULE - GARAGE C LEVEL 1- SECTOR 1 (C WEST)	.	.	
Sheet 4-14	4.3 SIGN LOCATION PLAN - GARAGE C LEVEL 1A - SECTOR 1 (C WEST)	.	.	
Sheet 4-15 - 4-28	4.4 MESSAGE SCHEDULE - GARAGE C LEVEL 1A - SECTOR 1 (C WEST)	.	.	
Sheet 5-1	5.1 SIGN LOCATION PLAN - GARAGE C LEVEL 2- SECTOR 1 (C WEST)	.	.	
Sheet 5-2 - 5-18	5.2 MESSAGE SCHEDULE - GARAGE C LEVEL 2- SECTOR 1 (C WEST)	.	.	
Sheet 5-19	5.3 SIGN LOCATION PLAN - GARAGE C LEVEL 2- SECTOR 3 (C EAST)	.	.	
Sheet 5-20	5.4 MESSAGE SCHEDULE - GARAGE C LEVEL 2- SECTOR 3 (C EAST)	.	.	
Sheet 6-1	6.1 SIGN LOCATION PLAN - GARAGE C LEVEL 3- SECTOR 1 (C WEST)	.	.	
Sheet 6-2 - 6-18	6.2 MESSAGE SCHEDULE - GARAGE C LEVEL 3- SECTOR 1 (C WEST)	.	.	
Sheet 6-19	6.3 SIGN LOCATION PLAN - GARAGE C LEVEL 3- SECTOR 3 (C EAST)	.	.	
Sheet 6-20 - 6-33	6.4 MESSAGE SCHEDULE - GARAGE C LEVEL 3- SECTOR 3 (C EAST)	.	.	
Sheet 7-1	7.1 SIGN LOCATION PLAN - GARAGE C LEVEL 4- SECTOR 1 (C WEST)	.	.	
Sheet 7-2 - 7-21	7.2 MESSAGE SCHEDULE - GARAGE C LEVEL 4- SECTOR 1 (C WEST)	.	.	
Sheet 7-22	7.3 SIGN LOCATION PLAN - GARAGE C LEVEL 4- SECTOR 2 (C CENTRAL)	.	.	
Sheet 7-23 - 7-44	7.4 MESSAGE SCHEDULE - GARAGE C LEVEL 4- SECTOR 2 (C CENTRAL)	.	.	
Sheet 7-45	7.5 SIGN LOCATION PLAN - GARAGE C LEVEL 4- SECTOR 3 (C EAST)	.	.	
Sheet 7-46 - 7-63	7.6 MESSAGE SCHEDULE - GARAGE C LEVEL 4- SECTOR 3 (C EAST)	.	.	
Sheet 8-1	8.1 SIGN LOCATION PLAN - GARAGE C LEVEL 5- SECTOR 1 (C WEST)	.	.	
Sheet 8-2 - 8-21	8.2 MESSAGE SCHEDULE - GARAGE C LEVEL 5- SECTOR 1 (C WEST)	.	.	
Sheet 8-22	8.3 SIGN LOCATION PLAN - GARAGE C LEVEL 5- SECTOR 2 (C CENTRAL)	.	.	
Sheet 8-23 - 8-44	8.4 MESSAGE SCHEDULE - GARAGE C LEVEL 5- SECTOR 2 (C CENTRAL)	.	.	
Sheet 8-45	8.5 SIGN LOCATION PLAN - GARAGE C LEVEL 5- SECTOR 3 (C EAST)	.	.	
Sheet 8-46 - 8-63	8.6 MESSAGE SCHEDULE - GARAGE C LEVEL 5- SECTOR 3 (C EAST)	.	.	
Sheet 9-1	9.1 SIGN LOCATION PLAN - GARAGE C LEVEL 6- SECTOR 1 (C WEST)	.	.	
Sheet 9-2 - 9-21	9.2 MESSAGE SCHEDULE - GARAGE C LEVEL 6- SECTOR 1 (C WEST)	.	.	
Sheet 9-22	9.3 SIGN LOCATION PLAN - GARAGE C LEVEL 6- SECTOR 2 (C CENTRAL)	.	.	
Sheet 9-23 - 9-44	9.4 MESSAGE SCHEDULE - GARAGE C LEVEL 6- SECTOR 2 (C CENTRAL)	.	.	
Sheet 9-45	9.5 SIGN LOCATION PLAN - GARAGE C LEVEL 6- SECTOR 3 (C EAST)	.	.	
Sheet 9-46 - 9-57	9.6 MESSAGE SCHEDULE - GARAGE C LEVEL 6- SECTOR 3 (C EAST)	.	.	
Sheet 10-1	10.1 SIGN LOCATION PLAN - GARAGE C LEVEL 7- SECTOR 1 (C WEST)	.	.	
Sheet 10-2 - 10-12	10.2 MESSAGE SCHEDULE - GARAGE C LEVEL 7- SECTOR 1 (C WEST)	.	.	
Sheet 10-13	10.3 SIGN LOCATION PLAN - GARAGE C LEVEL 7- SECTOR 2 (C CENTRAL)	.	.	
Sheet 10-14 - 10-24	10.4 MESSAGE SCHEDULE - GARAGE C LEVEL 7- SECTOR 2 (C CENTRAL)	.	.	
07 - ADDITIONAL WAYFINDING MESSAGES AND DETAILS				
A2.00A	LEVEL 01 FLOOR PLAN	.	.	
A2.01A	LEVEL 01A FLOOR PLAN	.	.	
A2.02A	LEVEL 02A FLOOR PLAN	.	.	
A2.02C	LEVEL 02C FLOOR PLAN	.	.	
A2.03A	LEVEL 03A FLOOR PLAN	.	.	
A2.03C	LEVEL 03C FLOOR PLAN	.	.	
A2.04A	LEVEL 04A FLOOR PLAN	.	.	
A2.04B	LEVEL 04B FLOOR PLAN	.	.	
A2.04C	LEVEL 04C FLOOR PLAN	.	.	
A2.05A	LEVEL 05A FLOOR PLAN	.	.	
A2.05B	LEVEL 05B FLOOR PLAN	.	.	
A2.05C	LEVEL 05C FLOOR PLAN	.	.	
A2.06A	LEVEL 06A FLOOR PLAN	.	.	
A2.06B	LEVEL 06B FLOOR PLAN	.	.	
A2.06C	LEVEL 06C FLOOR PLAN	.	.	
A2.07A	LEVEL 07A FLOOR PLAN	.	.	
A2.07B	LEVEL 07B FLOOR PLAN	.	.	
AG3.000	SIGNAGE DETAILS & REGULATORY SIGNS	.	.	
08-STRUCTURAL				
S1.00	OVERALL SITE PLAN	.	.	
S3.10	DETAILS	.	.	



2

CLIENT



Client Name

ARCHITECT



**PGAL**  
 3131 BRIARPARK DR.  
 SUITE 200  
 HOUSTON, TX 77042  
 [T] 713 622 1444  
 [F] 713 968 9333  
 www.pgal.com

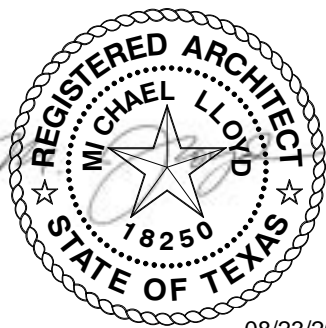
DEPARTMENT OF AVIATION

RECOMMENDED:

HOUSTON AIRPORT SYSTEM  
 DIRECTOR OR DESIGN REPRESENTATIVE

HAS TIP # 24-103 - IAH

REGISTRATION  
 Copyright © 2024



08/23/2024

**DRAWING HISTORY**

NO.	DATE	DESCRIPTION
01	04/10/2024	ISSUE FOR PERMIT
02	06/24/2024	PERMIT REVISION
03	08/23/2024	ISSUE FOR BID

**PROJECT NAME**  
 IAH TERMINAL C  
 GARAGE  
 SIGNAGE &  
 WAYFINDING

**PROJECT LOCATION**  
 TERMINAL C  
 3500 NORTH  
 TERMINAL RD.  
 HOUSTON, TX 77032

**PROJECT NUMBER**  
 1004395

**SHEET TITLE**  
 SHEET INDEX

**SHEET NUMBER**

G0.01

## PROJECT GENERAL DESCRIPTION

**OVERALL PROGRAM NAME:**  
IAH TERMINAL C GARAGE SIGNAGE & WAYFINDING

**PROJECT DESCRIPTION:**  
THIS PROJECT WILL REPLACE ALL EXISTING WAYFINDING SIGNAGE LOCATED IN TERMINAL C GARAGE AND ADDS NEW SIGNS AS NECESSARY. THIS IS COMPLETELY A WAYFINDING PROJECT.

## PROJECT GENERAL NOTES

- HOUSTON AIRPORT SYSTEMS (HAS) SHALL BE DESIGNATED AS "THE OWNER", PGAL ARCHITECTS SHALL BE DESIGNATED AS "THE ARCHITECT". GEORGE BUSH INTERCONTINENTAL AIRPORT (IAH) SHALL BE DESIGNATED AS "THE LANDLORD". THE GENERAL CONTRACTOR SHALL BE BOTH LICENSED AND BONDED IN TEXAS AND SHALL PROVIDE DOCUMENTS UPON REQUEST.
- THE WORK SHALL BE DONE IN ACCORDANCE WITH THE RULES AND REGULATIONS OF ALL APPLICABLE SAFETY AND BUILDING CODES, AND AS APPROVED BY THE AUTHORITY HAVING JURISDICTION, INCLUDING OBSERVING ALL RULES AND REGULATIONS IN AN AIRPORT SECURE ENVIRONMENT.
- THE GENERAL CONTRACTOR IS RESPONSIBLE FOR SECURING AND PAYING FOR ALL PERMITS REQUIRED FOR THE WORK AND FOR THE SCHEDULING OF ALL REQUIRED INSPECTIONS DURING THE COURSE OF THE WORK.
- REFER TO THE GENERAL NOTES, DESIGN NOTES AND KEYNOTES ON SHEETS 1-1 THROUGH 10-25, AND A33.000.
- THE CONTRACTOR SHALL VERIFY THAT THE DRAWINGS ARE THE LATEST ISSUE BEFORE COMMENCING CONSTRUCTION.
- 

## HAS STANDARDS

- THIS PROJECT IS TO FOLLOW HOUSTON AIRPORT SYSTEM (HAS) STANDARDS FOR ALL DISCIPLINES. HAS STANDARDS CAN BE FOUND AT THEIR WEBSITE, HTTP://WWW.HOUSTONAIRPORTS/BIZ/TIP.
- ANY CONFLICTS BETWEEN HAS STANDARDS AND BID/CONSTRUCTION DOCUMENTS ARE TO BE BROUGHT TO THE ARCHITECTS ATTENTION VIA RFI.
- ANY FLOOR PENETRATION WILL NEED TO BE X-RAY SCANNED. THIS INCLUDES BUT NOT LIMITED TO FLOOR ANCHORS, CORE, ETC. ALL SCANS ARE TO BE SUBMITTED TO HAS / EOR FOR REVIEW BEFORE WORK CAN BE PERFORMED.
- THE CONTRACTOR SHALL THOROUGHLY EXAMINE THE PREMISES AND SHALL BASE THE BID ON THE EXISTING CONDITIONS IN CONJUNCTION WITH THESE DOCUMENTS. THE CONTRACTOR SHALL NOTIFY THE ARCHITECT PRIOR TO THE BID OF ANY DISCREPANCIES FOUND WITH THESE DOCUMENTS OR CONFLICTS WITH EXISTING CONDITIONS VIA WRITTEN REQUEST FOR INFORMATION.
- PRIOR TO BEGINNING ANY CONSTRUCTION OR DEMOLITION, THE CONTRACTOR SHALL VERIFY THE GENERAL LAYOUT AND EXACT LAYOUT OF ALL WAYFINDING AND SIGNAGE AND REPORT ANY QUESTIONS OR DISCREPANCIES TO THE ARCHITECT FOR RESOLUTION VIA A WRITTEN REQUEST FOR INFORMATION.
- SIGNAGE HAS BEEN DESIGNED IN CONSIDERATION OF HAS 2023 DESIGN CRITERIA & 2021 IBC WITH COH AMENDMENTS.

## FACILITIES

- CORE DRILLING. THE CONTRACTOR SHALL SCAN THE AREA PRIOR TO CORE DRILLING OF CONCRETE STRUCTURES. THE CONTRACTOR SHALL USE THE GROUND PENETRATING RADAR (GPR) METHOD. THE CONTRACTOR SHALL SUBMIT A COPY OF THE GPR RESULTS TO AIRPORT STAFF, PRIOR TO CORE DRILLING, VERIFYING THAT THE AREA IS CLEAR OF CONDUITS/REBAR/PORT TENSION TENDONS/ETC.
- HOT WORK PERMIT. THE CONTRACTOR SHALL OBTAIN A HOT WORK PERMIT FROM THE AIRPORT FOR WELDING, CUTTING, GRINDING, OR ANY OTHER ACTIVITY INVOLVING OPEN FLAMES, SPARKS, OR OTHER IGNITION SOURCES THAT MAY CAUSE SMOKE, FIRE, OR CAN TRIGGER THE FIRE DETECTION SYSTEM.

## AIRSIDE / LANDSIDE

- THE CONTRACTOR SHALL NOT BLOCK THE TERMINAL C PASSENGER PATHS AND SHALL NOT BLOCK THE TSA CHECKPOINT AREAS.
- THE CONTRACTOR SHALL MAINTAIN THE PATH OF TRAVEL TO AND FROM THE WORK AREA IN A CLEAN MANNER. THE CONTRACTOR SHALL CLEAN THE PATH OF TRAVEL, AS NEEDED AND REMOVE ANY DUST/DEBRIS FROM THE PATH OF TRAVEL.

## SECURITY

- HAS APPROVAL OF THE REQUIRED "SECURITY PLAN" IS REQUIRED PRIOR TO THE START OF ANY WORK. THE SECURITY PLAN MUST BE SUBMITTED TO HAS FOR REVIEW AND APPROVAL. THE "SECURITY PLAN" SHALL INCLUDE BUT IS NOT LIMITED TO THE FOLLOWING:

- DATES AND TIME OF WORK
- CONTRACTOR NAME & CONTACT INFORMATION
- BADGING OF CONSTRUCTION PERSONNEL
- SUMMARY OF WORK, INCLUDING ATTACHED PLAN
- PERSONNEL & VEHICLE SECURITY CLEARANCE INFORMATION
- PERSONNEL & VEHICLE ACCESS INFORMATION. SHOW ALL PENETRATIONS OF THE SECURITY BOUNDARY. DESIGNATED ROUTE FOR WORKERS TO ACCESS VARIOUS WORK AREAS MUST BE PROVIDED & APPROVED. IDENTIFY THE PATH OF TRAVEL TO THE WORK SITE AND IDENTIFY ANY ELEVATORS AND OR DOORS TO BE USED TO ACCESS THE SITE.
- CONSTRUCTION DEBRIS - SHOW HOW CONSTRUCTION DEBRIS WILL BE DISPOSED OF OR TRANSPORTED OFF SITE
- SHOW PROPOSED LAYDOWN AREAS
- CONTACT AIRPORT SECURITY COMPLIANCE FOR TIMELINES FOR SUBMISSION AND COORDINATION OF WORK UNDER TSA GUIDELINES
- THE CONTRACTOR SHALL ATTEND A PRE-CONSTRUCTION MEETING PRIOR TO THE START OF WORK

## SHOP DRAWINGS & SUBMITTALS

- THE GENERAL CONTRACTOR SHALL PROVIDE THE ARCHITECT WITH SHOP DRAWINGS FOR REVIEW AND APPROVAL FOR ALL, BUT NOT LIMITED TO, THE FOLLOWING: MISC. STEEL, WAYFINDING AND SIGNAGE. SHOP DRAWINGS SHALL BE SUBMITTED IN THE FORM OF DIGITAL PDF PRINTS. SHOP DRAWINGS SHALL NOT BE REPRODUCTIONS OF CONTRACT DOCUMENTS.
- CONTRACTOR NEEDS TO PROVIDE A COMPLETE MESSAGE SCHEDULE AND COMPLETE FABRICATION / ASSEMBLY DETAILS FOR ALL SIGNS FOR VERIFICATION PURPOSES AND SIGNED AND SEALED ENGINEERED DRAWINGS FOR SIGNAGE MOUNTING AND SUPPORTS.
- THE GENERAL CONTRACTOR SHALL SUBMIT SHOP DRAWINGS AND SUBMITTALS, AND SHALL ORDER AND SCHEDULE DELIVERY OF MATERIALS TO AVOID DELAYS IN CONSTRUCTION. IF AN ITEM IS FOUND TO BE UNAVAILABLE OR TO HAVE A LONG LEAD TIME, THE GENERAL CONTRACTOR SHALL NOTIFY ARCHITECT IMMEDIATELY WITH A PROPOSED ALTERNATIVE.
- THE CONTRACTOR SHALL SUBMIT FINAL CLOSEOUT DOCUMENTS FOR REVIEW.

## PATCHING, REPAIR & FINISH WORK

- THE GENERAL CONTRACTOR SHALL INCLUDE ALL X-RAY AND CORE DRILL COSTS. THE GENERAL CONTRACTOR SHALL REVIEW AND COORDINATE THE SIZE AND LOCATION OF ALL SLAB OPENINGS WITH ALL RELATED DISCIPLINES. THE GENERAL CONTRACTOR SHALL SUBMIT PROPOSED LOCATIONS OF CORE DRILLING AND SLAB OPENINGS TO ARCHITECT AND STRUCTURAL ENGINEER OF RECORD FOR REVIEW AND APPROVAL PRIOR TO PROCEEDING WITH THE WORK.
- PATCH, REPAIR, AND INSTALL ALL FIREPROOFING AS REQUIRED BY CODE. FIREPROOF ALL NEW PENETRATIONS AS REQUIRED FOR APPROVAL BY THE AUTHORITY HAVING JURISDICTION.
- SLAB PENETRATIONS SHALL BE SEALED AS REQUIRED TO MAINTAIN FIRE RATING. USING MATERIALS AND METHODS APPROVED BY THE AUTHORITY HAVING JURISDICTION. EXPANSION MATERIAL SHALL BE APPROVED BY THE ARCHITECT.
- ALL DEBRIS SHALL BE REMOVED FROM THE SITE ON A DAILY BASIS, OR AS DIRECTED BY THE AUTHORITY HAVING JURISDICTION. UPON COMPLETION OF THE WORK, REMOVE ALL DEBRIS FROM THE BUILDING CREATED BY THE WORK PROVIDED UNDER THIS CONTRACT AND LEAVE ALL AREAS CLEAN. TRASH IS NOT PERMITTED TO BE BURNED ON SITE.
- ALL ABANDONED AND MISCELLANEOUS NAILS, HANGERS, STAPLES, WIRES, CONDUITS AND DEBRIS SHALL BE REMOVED FROM EXPOSED AREAS OF THE FLOORS, WALLS, AND CEILINGS. REMOVE ALL ABANDONED PIPE SLEEVES IN FLOOR SLABS. PATCH EXISTING SLAB AS REQUIRED TO MAINTAIN UL FIRE RATING OF FLOOR SLAB WHERE PIPES AND CONDUITS HAVE BEEN REMOVED.
- THE GENERAL CONTRACTOR SHALL CONTINUOUSLY CHECK ARCHITECTURAL AND STRUCTURAL CLEARANCES FOR ACCESSIBILITY OF EQUIPMENT AND MECHANICAL AND ELECTRICAL SYSTEMS. NO ALLOWANCES OF ANY KIND WILL BE MADE FOR THE GENERAL CONTRACTOR'S NEGLIGENCE TO FORESEE MEANS OF INSTALLING EQUIPMENT INTO POSITION.
- THE FINISHED WORK SHALL BE FIRM, WELL-ANCHORED, IN TRUE ALIGNMENT, PLUMB, LEVEL, WITH SMOOTH CLEAN, UNIFORM, APPEARANCE WITHOUT WAVES, DISTORTIONS, HOLES, MARKS, CRACKS, STAINS, OR DISCOLORATION. JOINTING SHALL BE CLOSE FITTING, NEAT AND WELL SCRIBED. THE FINISHED WORK SHALL HAVE NO EXPOSED UNSIGHTLY ANCHORS OR FASTENERS AND SHALL NOT PRESENT HAZARDOUS, UNSAFE CORNERS. ALL WORK SHALL HAVE THE PROVISION FOR EXPANSION, CONTRACTION AND SHRINKAGE AS NECESSARY TO PREVENT CRACKS, BUCKLING, AND WARPING DUE TO TEMPERATURE AND HUMIDITY CONDITIONS.
- GENERAL CONTRACTOR SHALL WAIVE "COMMON PRACTICE" AND "COMMON USAGE" AS CONSTRUCTION CRITERIA WHEREVER DETAILS AND CONTRACT DOCUMENTS OF GOVERNING CODES, ORDINANCES, ETC. REQUIRE QUANTITY OR BETTER QUALITY THAN COMMON PRACTICE OR COMMON USAGE WOULD REQUIRE.
- ATTACHMENTS, CONNECTIONS OR FASTENERS OF ANY NATURE ARE TO PROPERLY AND PERMANENTLY BE SECURED IN CONFORMANCE WITH INDUSTRY BEST PRACTICES. THE DRAWINGS HIGHLIGHT SPECIAL CONDITIONS ONLY AND BY NO MEANS ILLUSTRATE EVERY CONNECTION. THE CONTRACTOR IS RESPONSIBLE FOR IMPROVING CONNECTION ACCORDINGLY.
- THE GENERAL CONTRACTOR SHALL NOTIFY THE ARCHITECT OF ANY ACCESS PANELS WHICH MAY BE REQUIRED PRIOR TO PROCEEDING WITH THE WORK. CONTRACTOR SHALL BE RESPONSIBLE FOR COORDINATING ALL TRADES. REQUIRED ACCESS PANELS SHALL BE INCLUDED IN THE CONTRACTOR'S SCOPE OF WORK.

## PROJECT CONDITIONS

- THE TERM "BASE BUILDING" MEANS THE EXISTING STRUCTURES WITHIN THE PROPERTY SITE WHERE THE PROJECT AND THE WORK IS CONSTRUCTED.
- DRAWING FOR THE WORK IS BASED ON OWNER-FURNISHED BASE BUILDING DOCUMENTS AND UPON THE ARCHITECT'S LIMITED VISUAL OBSERVATIONS OF LATENT EXPOSED CONDITIONS AT THE TIME OF COMMENCING THE ARCHITECT'S DESIGN CONSULTING SERVICES.
- THE GENERAL CONTRACTOR SHALL REVIEW AND VERIFY EXISTING CONDITIONS AS PROVIDED IN THE CONSTRUCTION DOCUMENTS. THE CONTRACTOR SHALL NOTIFY THE ARCHITECT OF ALL DISCREPANCIES, ERRORS, INCONSISTENCIES OR AMBIGUITIES PRIOR TO PROCEEDING WITH THE WORK. ANY UNREPORTED DEFICIENCIES WILL BECOME THE RESPONSIBILITY OF THE GENERAL CONTRACTOR TO CORRECT.
- THE GENERAL CONTRACTOR SHALL BE RESPONSIBLE FOR, AND PROVIDE PROTECTION OF, ANY EXISTING FINISHES, MATERIALS, AND EQUIPMENT TO REMAIN. THE GENERAL CONTRACTOR SHALL REPAIR OR REPLACE ANY DAMAGED FINISHES, MATERIALS, AND EQUIPMENT AS A RESULT OF THE WORK. ALL EXISTING FINISHES TO REMAIN SHALL BE CLEANED AT THE COMPLETION OF CONSTRUCTION. THE GENERAL CONTRACTOR SHALL PHOTOGRAPH AND DOCUMENT ALL EXISTING DAMAGES, AND PROVIDE TO THE ARCHITECT, PRIOR TO PROCEEDING WITH THE WORK.
- THE GENERAL CONTRACTOR SHALL VERIFY THAT NO CONFLICTS EXIST BETWEEN THE LOCATIONS OF EXISTING AND PROPOSED NEW WAYFINDING AND SIGNAGE (INCLUDING BUT NOT LIMITED TO STRUCTURAL MEMBERS, PIPING, DUCT WORK, CONDUIT AND SPRINKLERS) AND THAT CLEARANCES FOR INSTALLATION ARE PROVIDED. ELEMENTS IN CONFLICT SHALL BE DOCUMENTED AND PROVIDED TO THE ARCHITECT PRIOR TO PROCEEDING WITH THE WORK.
- IN THE EVENT OF CONFLICT BETWEEN DATA SHOWN ON DRAWINGS AND DATA PROVIDED IN THE SPECIFICATION, THE GENERAL CONTRACTOR SHALL PROVIDE WRITTEN NOTIFICATION TO THE ARCHITECT OF ANY DISCREPANCIES, PRIOR TO PROCEEDING WITH THE WORK.
- THE GENERAL CONTRACTOR SHALL NOT PROCEED WITH WORK FOR WHICH HE EXPECTS ADDITIONAL COMPENSATION BEYOND THE CONTRACT AMOUNT WITHOUT WRITTEN AUTHORIZATION FROM THE ARCHITECT AND OWNER. FAILURE TO OBTAIN SUCH AUTHORIZATION SHALL INVALIDATE A CLAIM FOR EXTRA COMPENSATION. THE CONTRACTOR SHALL NOT PROCEED WITH WORK WHICH, IF COMPLETED IN STRICT CONFORMANCE WITH THE CONSTRUCTION DOCUMENTS, WILL RESULT IN ADDITIONAL WORK BEYOND THE SCOPE OF THE CONTRACT WITHOUT WRITTEN AUTHORIZATION FROM THE ARCHITECT AND OWNER. ANY FIELD CONDITIONS THAT SIGNIFICANTLY VARY FROM THE CONTRACT DOCUMENTS OR WILL RESULT IN ADDITIONAL WORK, SHALL BE BROUGHT TO THE ATTENTION OF THE ARCHITECT PRIOR TO PROCEEDING WITH WORK.
- DO NOT SCALE DRAWINGS. STATED & WRITTEN DIMENSIONS GOVERN. THE GENERAL CONTRACTOR SHALL VERIFY ALL DIMENSIONS IN THE FIELD AND SHALL BE RESPONSIBLE FOR THEIR ACCURACY. NO EXTRA CHARGE OR COMPENSATION SHALL BE ALLOWED BECAUSE OF DIFFERENCE BETWEEN ACTUAL DIMENSIONS AND THOSE INDICATED ON THE DRAWINGS, UNLESS THEY CONTRIBUTE TO A CHANGE IN THE SCOPE OF THE WORK. ANY DIFFERENCE FOUND SHALL BE SUBMITTED TO THE ARCHITECT FOR COORDINATION PRIOR TO ORDERING, MANUFACTURING, OR PROCEEDING WITH THE WORK. HORIZONTAL DIMENSIONS INDICATED ARE TO/FROM FACE OF FINISH, UNLESS NOTED OTHERWISE. VERTICAL DIMENSIONS ARE FROM TOP OF FLOOR SLAB EXCEPT WHERE NOTED TO BE ABOVE FINISHED FLOOR (AFF). DIMENSIONS ARE NOT ADJUSTABLE WITHOUT APPROVAL OF ARCHITECT UNLESS NOTED +/-.
- MATERIALS INDICATED TO BE REUSED MUST BE FREE OF DEFECTS AND BE IN GOOD CONDITION OR SHALL BE REPLACED WITH NEW. UNDER THIS CONTRACT, ANY MATERIAL INDICATED TO BE REUSED WHICH IS NOT FREE OF DEFECTS SHALL BE BROUGHT TO THE ATTENTION OF THE ARCHITECT VIA A WRITTEN REQUEST FOR INFORMATION PRIOR TO BEGINNING CONSTRUCTION.

## CONTRACTORS USE OF BUILDING

- CONTRACTOR IS RESPONSIBLE FOR COMPLYING WITH ALL BUILDING MANAGEMENT SECURITY REQUIREMENTS, INCLUDING PROJECT SITE ACCESS RULES.
- LIMIT USE OF BASE BUILDING FOR THE WORK AND FOR CONSTRUCTION OPERATIONS, TO ALLOW CONTINUED OCCUPANCY AND USE.
- CONFINE OPERATIONS WITHIN DESIGNATED STAGING AREAS AND COORDINATE USE OF BASE BUILDING FACILITIES AS APPROVED BY THE OWNER.
- THIS PROJECT WILL REQUIRE WORK WITHIN THE SIDA (SECURITY IDENTIFICATION DISPLAY AREA) AREAS. THE GENERAL CONTRACTOR AND HIS SUBCONTRACTORS ARE TO HAVE PROPER SECURITY TRAINING AND CREDENTIALS AS REQUIRED AND GRANTED BY HAS. THE CONTRACTOR AND THEIR SUBS ARE TO BE AWARE OF THEIR LOCATIONS WHILE WORKING IN THESE AREAS AND PROPER BADGING MUST BE DISPLAYED AT ALL TIMES. ALL COSTS ASSOCIATED WITH OBTAINING TRAINING AND CREDENTIALS TO ACCESS THE SIDA, ARE THE RESPONSIBILITY OF THE GENERAL CONTRACTOR AND SHALL BE COMPLETED PRIOR TO COMMENCEMENT OF WORK. COORDINATE ANY SECURITY DEVICE REMOVAL / RELOCATION WITH HAS PRIOR TO COMMENCEMENT OF WORK.
- MAINTAIN PROPER PATHS AND IDENTIFICATION OF EMERGENCY EGRESS.

CLIENT



Client Name

ARCHITECT



**PGAL**  
3131 BRIARPARK DR.  
SUITE 200  
HOUSTON, TX 77042  
[T] 713 622 1444  
[F] 713 968 9333  
www.pgal.com

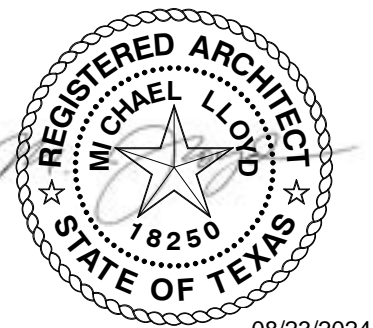
DEPARTMENT OF AVIATION  
RECOMMENDED:

HOUSTON AIRPORT SYSTEM  
DIRECTOR OR DESIGN REPRESENTATIVE

HAS TIP # 24-103 - IAH

REGISTRATION

Copyright © 2024



08/23/2024

DRAWING HISTORY

NO.	DATE	DESCRIPTION
01	04/10/2024	ISSUE FOR PERMIT
02	06/24/2024	PERMIT REVISION
03	08/23/2024	ISSUE FOR BID

PROJECT NAME

**IAH TERMINAL C  
GARAGE  
SIGNAGE &  
WAYFINDING**

PROJECT LOCATION

**TERMINAL C  
3500 NORTH  
TERMINAL RD.  
HOUSTON, TX 77032**

PROJECT NUMBER

**1004395**

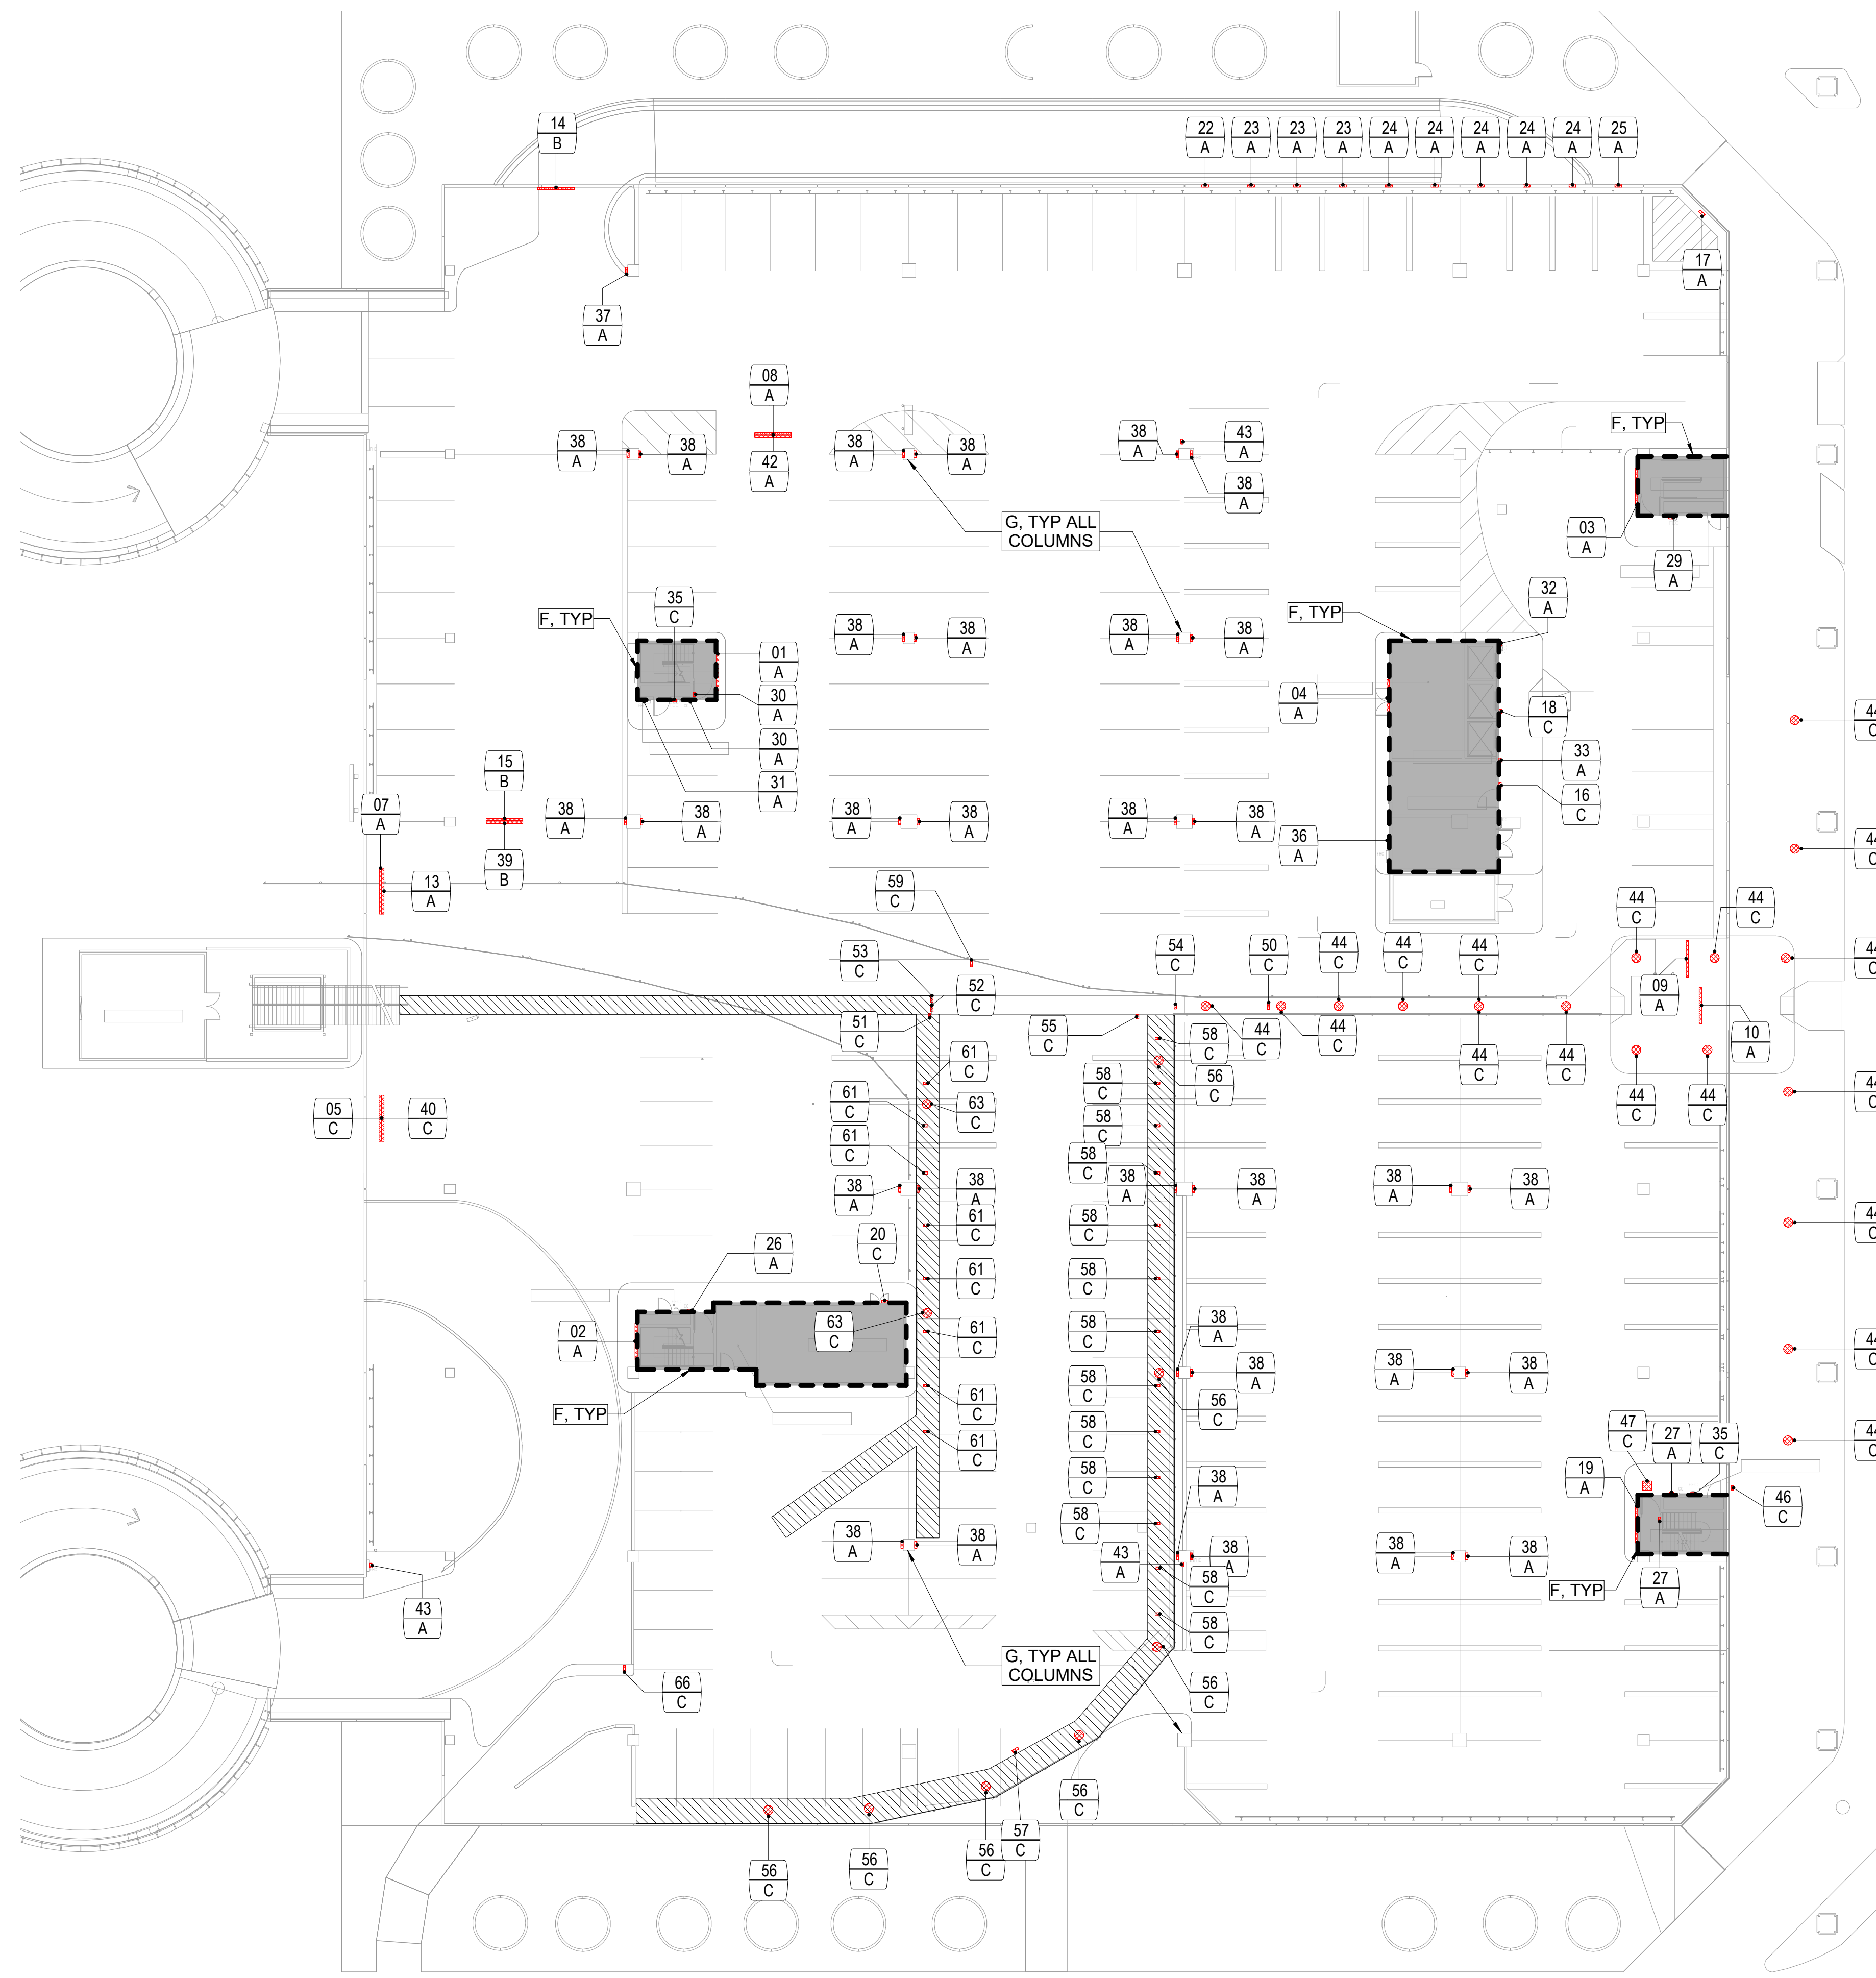
SHEET TITLE

**GENERAL PROJECT  
INFORMATION**

SHEET NUMBER

**G0.02**

FILE NAME: C:\Revit\Locals\TERM C SIGNAGE GARAGE\_DBhatti@pgal.com.rvt  
 DATE/TIME: 8/23/2024 4:39:53 PM



\*\* 48 +/- COLUMNS TO BE PAINTED IN THIS SECTOR, V.I.F.

LEVEL 01 - DEMO PLAN - OVERALL 3/64" = 1'-0" 1

IMAGE	MARK	NOTES
	01	A
	02	A
	03	A
	04	A
	05	C
	07	A
	08	A
	09	A
	10	A
	13	A
	14	B
	15	B
	16	C
	17	A

IMAGE REFERENCE


IMAGE	MARK	NOTES
	18	C
	25	A
	26	A
	27	A
	29	A
	30	A
	19	A
	20	C
	22	A
	23	A
	24	A

DEMO KEYNOTE


- A EXISTING SURFACE MOUNTED SIGN(S) TO BE REMOVED, PATCH/REPAIR AS REQUIRED.
- B EXISTING CEILING MOUNTED SIGN TO BE REMOVED, REMOVE SUSPENSION FRAME AND ATTACHMENTS FROM GARAGE STRUCTURAL CEILING. PATCH/REPAIR AS REQUIRED.
- C EXISTING SIGN(S) / ACCESSORY TO REMAIN.
- D EXISTING POLE MOUNTED SIGN TO BE REMOVED, PATCH/REPAIR AS REQUIRED.
- E EXISTING TUBE STEEL AND SUPPORT TO BE REMOVED, PATCH/REPAIR FLOOR AS REQUIRED.
- F CHEMICALLY STRIP OR SANDBLAST PAINT TO ORIGINAL BARE CONCRETE FINISH AND SKIM COAT WITH SIKA QUICK SMOOTH FINISH AT EXTERIOR WALL PERIMETER AT ELEVATOR AND STAIR CORES. TO BE PRIMED AND PAINTED.
- G CHEMICALLY STRIP OR SANDBLAST PAINT TO ORIGINAL BARE CONCRETE FINISH AND SKIM COAT WITH SIKA QUICK SMOOTH FINISH AT ALL GARAGE COLUMNS ONLY. TO BE PRIMED AND PAINTED. REFER TO "I" IN REGARDS TO APPROXIMATE COLUMN QUANTITY.

\*\*\* NOTE \*\*\*  
 UNLESS NOTED OTHERWISE, ALL REMOVED SIGNS ARE TO BE REPLACED WITH A NEW SIGN

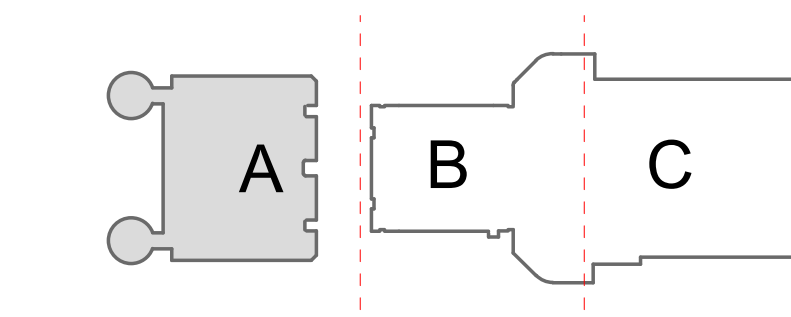KEY PLAN




1:256 SCALE

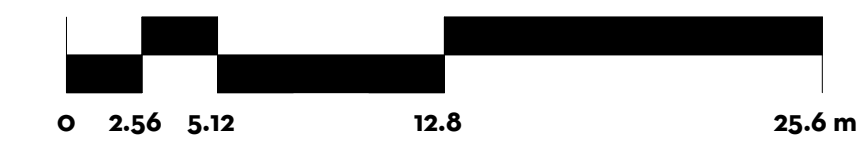

LEGEND

SIGN MARK	
KEYNOTE	

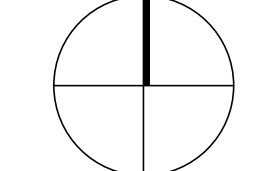PLAN NORTH



CLIENT



Client Name

ARCHITECT



PGAL  
 3131 BRIARPARK DR.  
 SUITE 200  
 HOUSTON, TX 77042  
 [T] 713 622 1444  
 [F] 713 968 9333  
 www.pgal.com

BSG PRJCT#  
 BSG-2024-111-IAH

DEPARTMENT OF AVIATION  
 RECOMMENDED:  
 HOUSTON AIRPORT SYSTEM  
 DIRECTOR OR DESIGN REPRESENTATIVE  
 HAS TIP # 24-103 - IAH

REGISTRATION  
 Copyright © 2024



DRAWING HISTORY

NO.	DATE	DESCRIPTION
01	04/10/2024	ISSUE FOR PERMIT
02	08/23/2024	ISSUE FOR BID

PROJECT NAME  
 IAH TERMINAL C  
 GARAGE  
 SIGNAGE &  
 WAYFINDING

PROJECT LOCATION  
 TERMINAL C  
 3500 NORTH  
 TERMINAL RD.  
 HOUSTON, TX 77032

PROJECT NUMBER  
 1004395

SHEET TITLE  
 LEVEL 01 - GARAGE  
 - DEMO PLAN -  
 SECTOR A

SHEET NUMBER

AD2.00A

IMAGE	MARK	NOTES
	31	A
	32	A
	33	A
	35	C
	36	A
	37	A
	38	A
	39	B












IMAGE	MARK	NOTES
	40	C
	42	A
	43	A
	44	C
	46	C
	47	C
	50	C
	51	C
	52	C
	53	C
	54	C








IMAGE	MARK	NOTES
	55	C
	56	C
	57	C
	58	C
	59	C
	61	C
	63	C
	66	C

IMAGE REFERENCE

DEMO KEYNOTE

- A. EXISTING SURFACE MOUNTED SIGN(S) TO BE REMOVED, PATCH/REPAIR AS REQUIRED.
- B. EXISTING CEILING MOUNTED SIGN TO BE REMOVED, REMOVE SUSPENSION FRAME AND ATTACHMENTS FROM GARAGE STRUCTURAL CEILING. PATCH/REPAIR AS REQUIRED.
- C. EXISTING SIGN(S) / ACCESSORY TO REMAIN.
- D. EXISTING POLE MOUNTED SIGN TO BE REMOVED, PATCH/REPAIR AS REQUIRED.
- E. EXISTING TUBE STEEL AND SUPPORT TO BE REMOVED, PATCH/REPAIR FLOOR AS REQUIRED.
- F. CHEMICALLY STRIP OR SANDBLAST PAINT TO ORIGINAL BARE CONCRETE FINISH AND SKIM COAT WITH SIKA QUICK SMOOTH FINISH AT EXTERIOR WALL PERIMETER AT ELEVATOR AND STAIR CORES. TO BE PRIMED AND PAINTED.
- G. CHEMICALLY STRIP OR SANDBLAST PAINT TO ORIGINAL BARE CONCRETE FINISH AND SKIM COAT WITH SIKA QUICK SMOOTH FINISH AT ALL GARAGE COLUMNS ONLY. TO BE PRIMED AND PAINTED. REFER TO " IN REGARDS TO APPROXIMATE COLUMN QUANTITY.

CLIENT



Client Name

ARCHITECT

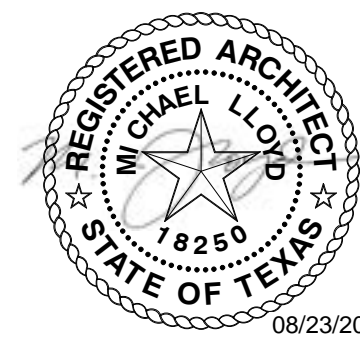


PGAL  
 3131 BRIARPARK DR.  
 SUITE 200  
 HOUSTON, TX 77042  
 [T] 713 622 1444  
 [F] 713 968 9333  
 www.pgal.com

BSG PRJCT#  
 BSG-2024-111-IAH

DEPARTMENT OF AVIATION  
 RECOMMENDED:  
 HOUSTON AIRPORT SYSTEM  
 DIRECTOR OR DESIGN REPRESENTATIVE  
 HAS TIP # 24-103 - IAH

REGISTRATION  
 Copyright © 2024



DRAWING HISTORY

NO.	DATE	DESCRIPTION
01	04/10/2024	ISSUE FOR PERMIT
02	08/23/2024	ISSUE FOR BID

PROJECT NAME  
 IAH TERMINAL C  
 GARAGE  
 SIGNAGE &  
 WAYFINDING

PROJECT LOCATION  
 TERMINAL C  
 3500 NORTH  
 TERMINAL RD.  
 HOUSTON, TX 77032


PROJECT NUMBER  
 1004395

SHEET TITLE  
 LEVEL 01 - GARAGE  
 - DEMO PLAN -  
 SECTOR A.2

SHEET NUMBER

AD2.00A.2

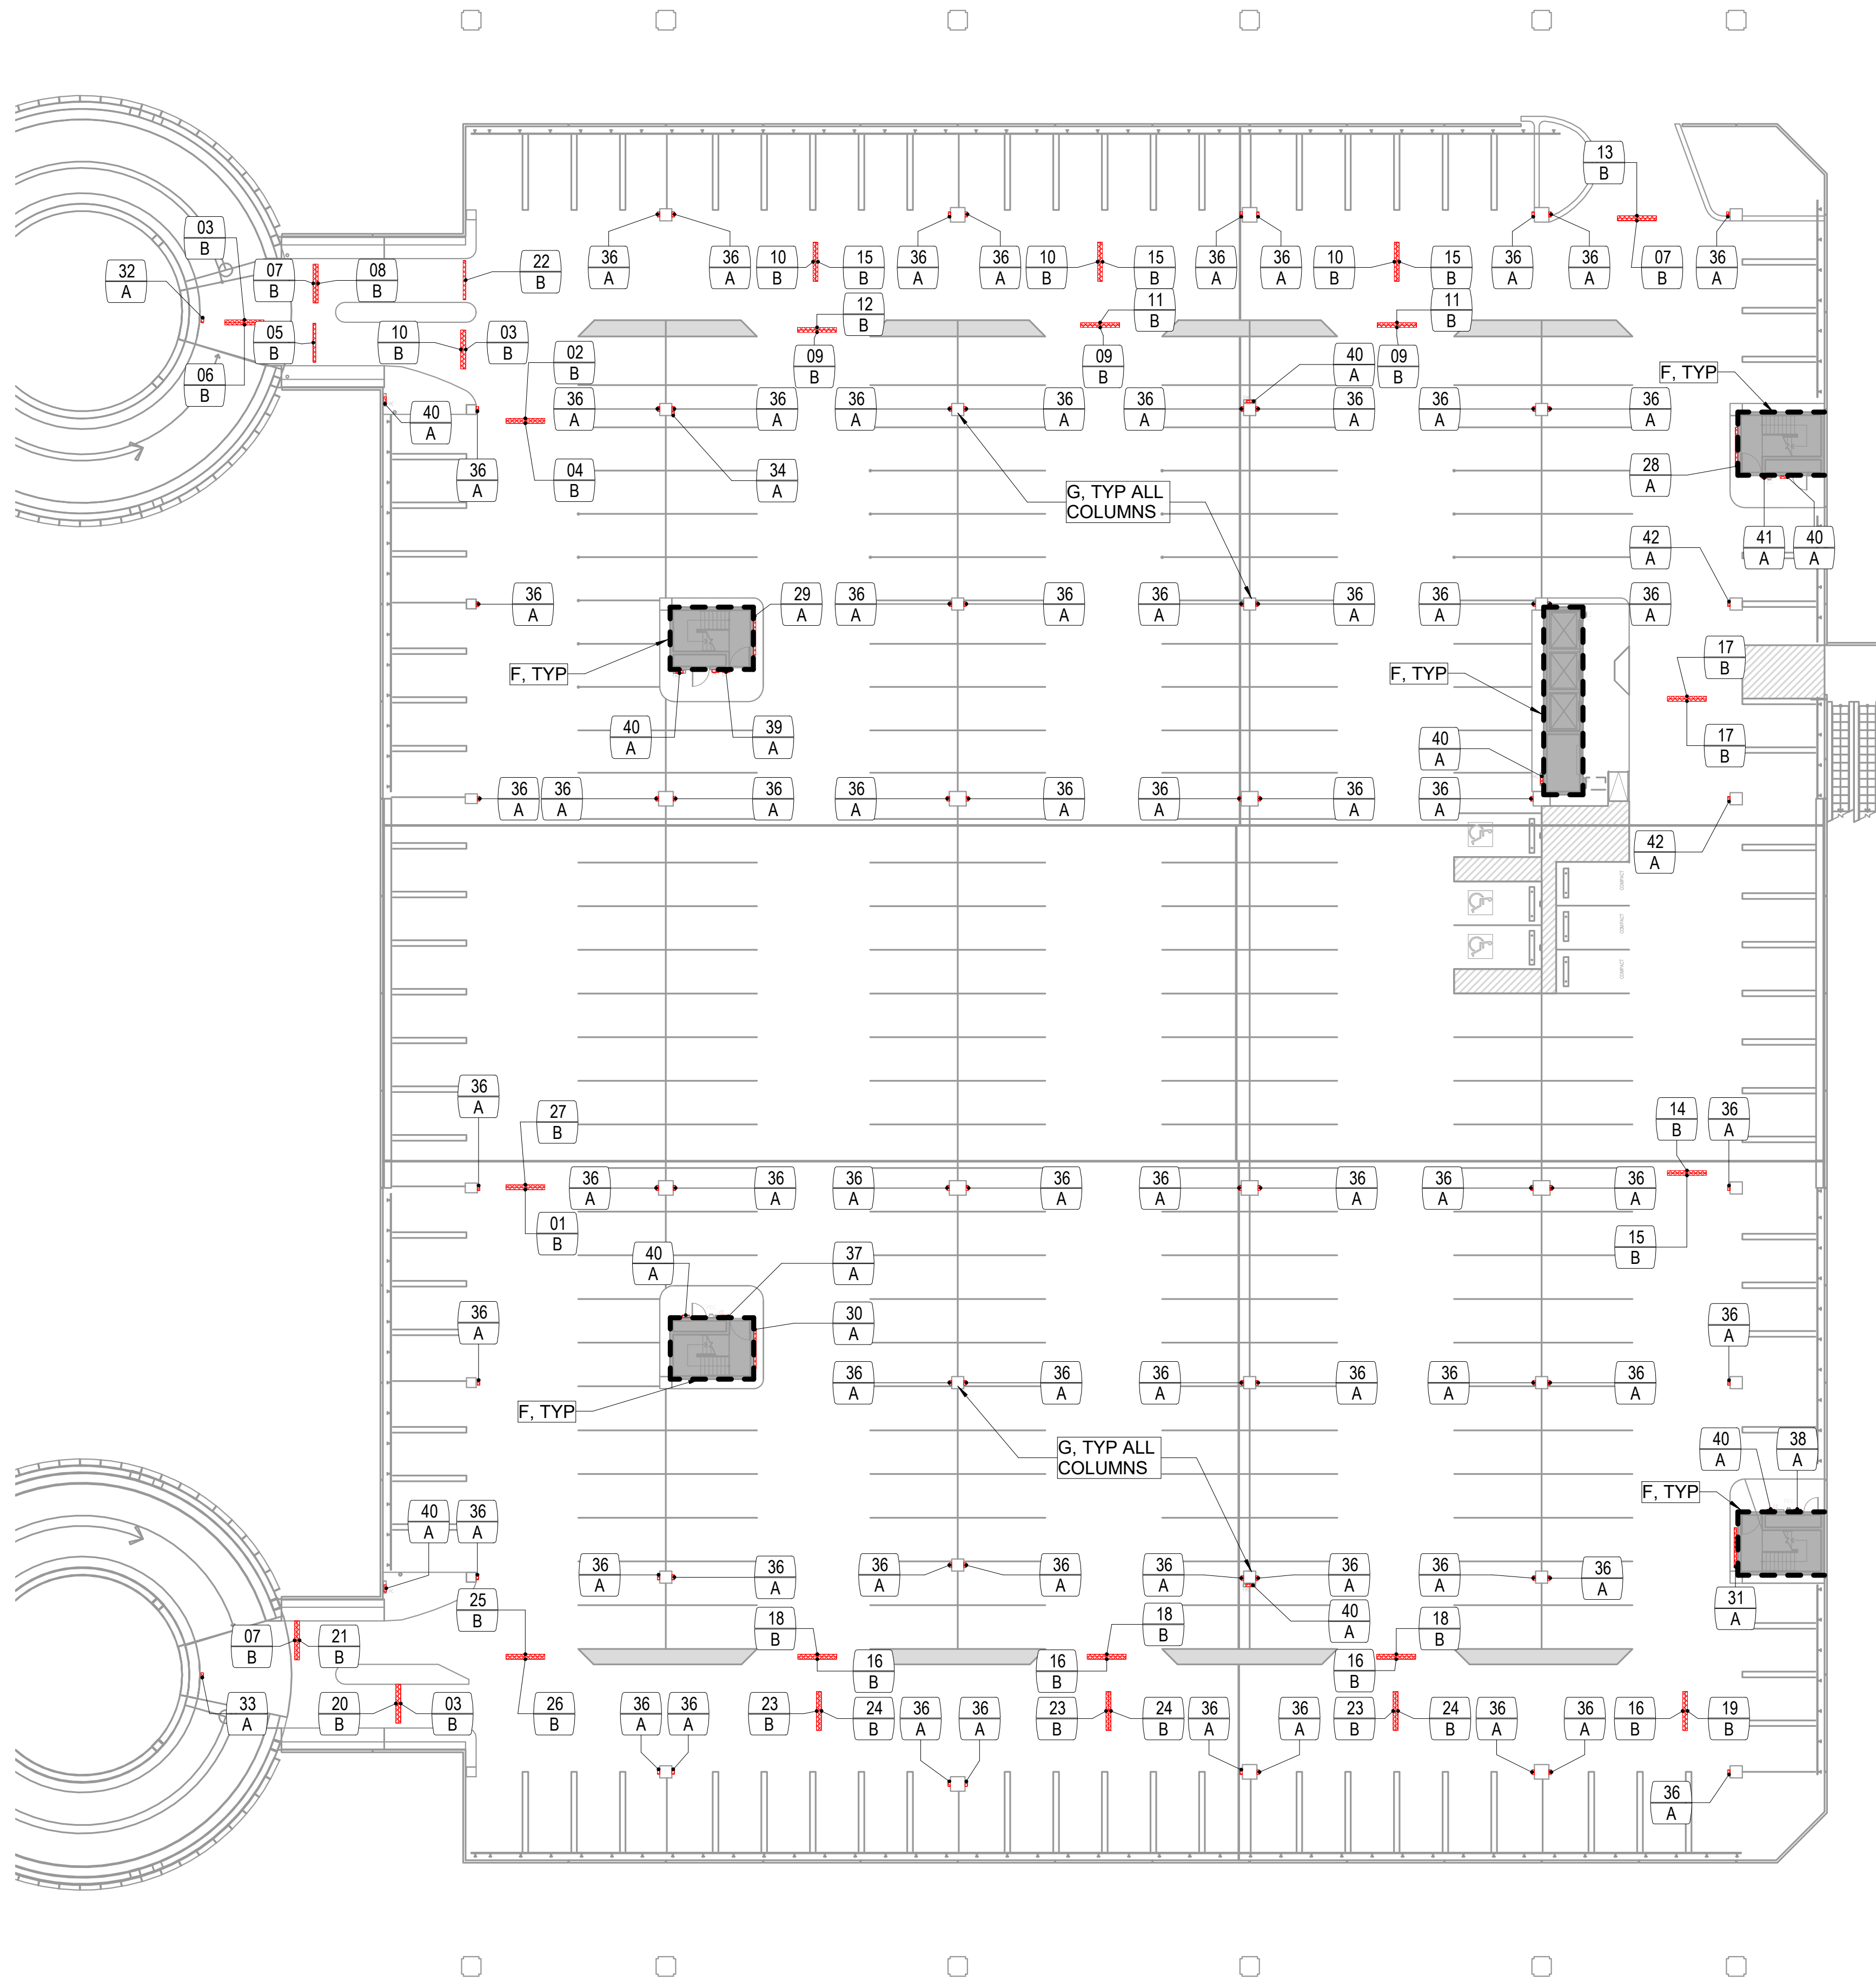FILE NAME: C:\Revit\Locals\TERM C SIGNAGE GARAGE\_DBhatti@pgal.com.rvt  
 DATE/TIME: 8/23/2024 4:40:06 PM



\*\* 48 +/- COLUMNS TO BE PAINTED IN THIS SECTOR, V.I.F.

LEVEL 01A - DEMO PLAN - OVERALL 3/64" = 1'-0" 1

IMAGE	MARK	NOTES
	01	B
	02	B
	03	B
	04	B
	05	B
	06	B
	07	B
	08	B
	09	B
	10	B
	11	B
	12	B
	13	B
	14	B
	15	B
	16	B
	17	B
	18	B
	19	B
	20	B
	21	B
	22	B
	23	B
	24	B
	25	B
	26	B
	27	B
	28	A
	29	A
	30	A
	31	A
	32	A
	33	A
	34	A

IMAGE REFERENCE


IMAGE	MARK	NOTES
	36	A
	37	A
	38	A
	39	A
	40	A
	41	A
	42	A

DEMO KEYNOTE

- A EXISTING SURFACE MOUNTED SIGN(S) TO BE REMOVED, PATCH/REPAIR AS REQUIRED.
- B EXISTING CEILING MOUNTED SIGN TO BE REMOVED, REMOVE SUSPENSION FRAME AND ATTACHMENTS FROM GARAGE STRUCTURAL CEILING. PATCH/REPAIR AS REQUIRED.
- C EXISTING SIGN(S) / ACCESSORY TO REMAIN.
- D EXISTING POLE MOUNTED SIGN TO BE REMOVED, PATCH/REPAIR AS REQUIRED.
- E EXISTING TUBE STEEL AND SUPPORT TO BE REMOVED, PATCH/REPAIR FLOOR AS REQUIRED.
- F CHEMICALLY STRIP OR SANDBLAST PAINT TO ORIGINAL BARE CONCRETE FINISH AND SKIM COAT WITH SIKA QUICK SMOOTH FINISH AT EXTERIOR WALL PERIMETER AT ELEVATOR AND STAIR CORES. TO BE PRIMED AND PAINTED.
- G CHEMICALLY STRIP OR SANDBLAST PAINT TO ORIGINAL BARE CONCRETE FINISH AND SKIM COAT WITH SIKA QUICK SMOOTH FINISH AT ALL GARAGE COLUMNS ONLY. TO BE PRIMED AND PAINTED. REFER TO \*\* IN REGARDS TO APPROXIMATE COLUMN QUANTITY.

\*\*\* NOTE \*\*\*  
 UNLESS NOTED OTHERWISE, ALL REMOVED SIGNS ARE TO BE REPLACED WITH A NEW SIGN

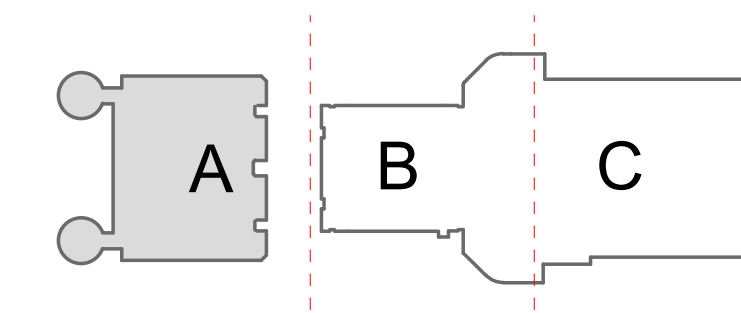
KEY PLAN




1: 256 SCALE



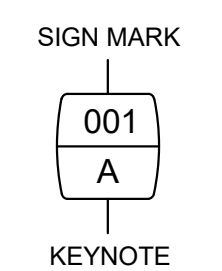LEGEND



PLAN NORTH

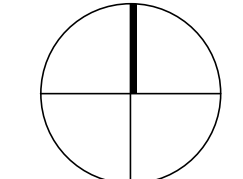

CLIENT



Client Name

ARCHITECT



PGAL  
 3131 BRIARPARK DR.  
 SUITE 200  
 HOUSTON, TX 77042  
 [T] 713 622 1444  
 [F] 713 968 9333  
 www.pgal.com

BSG PRJCT#  
 BSG-2024-111-IAH

DEPARTMENT OF AVIATION  
 RECOMMENDED:  
 HOUSTON AIRPORT SYSTEM  
 DIRECTOR OR DESIGN REPRESENTATIVE  
 HAS TIP # 24-103 - IAH

REGISTRATION  
 Copyright © 2024



DRAWING HISTORY

NO.	DATE	DESCRIPTION
01	04/10/2024	ISSUE FOR PERMIT
02	08/23/2024	ISSUE FOR BID

PROJECT NAME  
 IAH TERMINAL C  
 GARAGE  
 SIGNAGE &  
 WAYFINDING

PROJECT LOCATION  
 TERMINAL C  
 3500 NORTH  
 TERMINAL RD.  
 HOUSTON, TX 77032


PROJECT NUMBER  
 1004395

SHEET TITLE  
 LEVEL 01A -  
 GARAGE - DEMO  
 PLAN - SECTOR A

SHEET NUMBER

AD2.01A

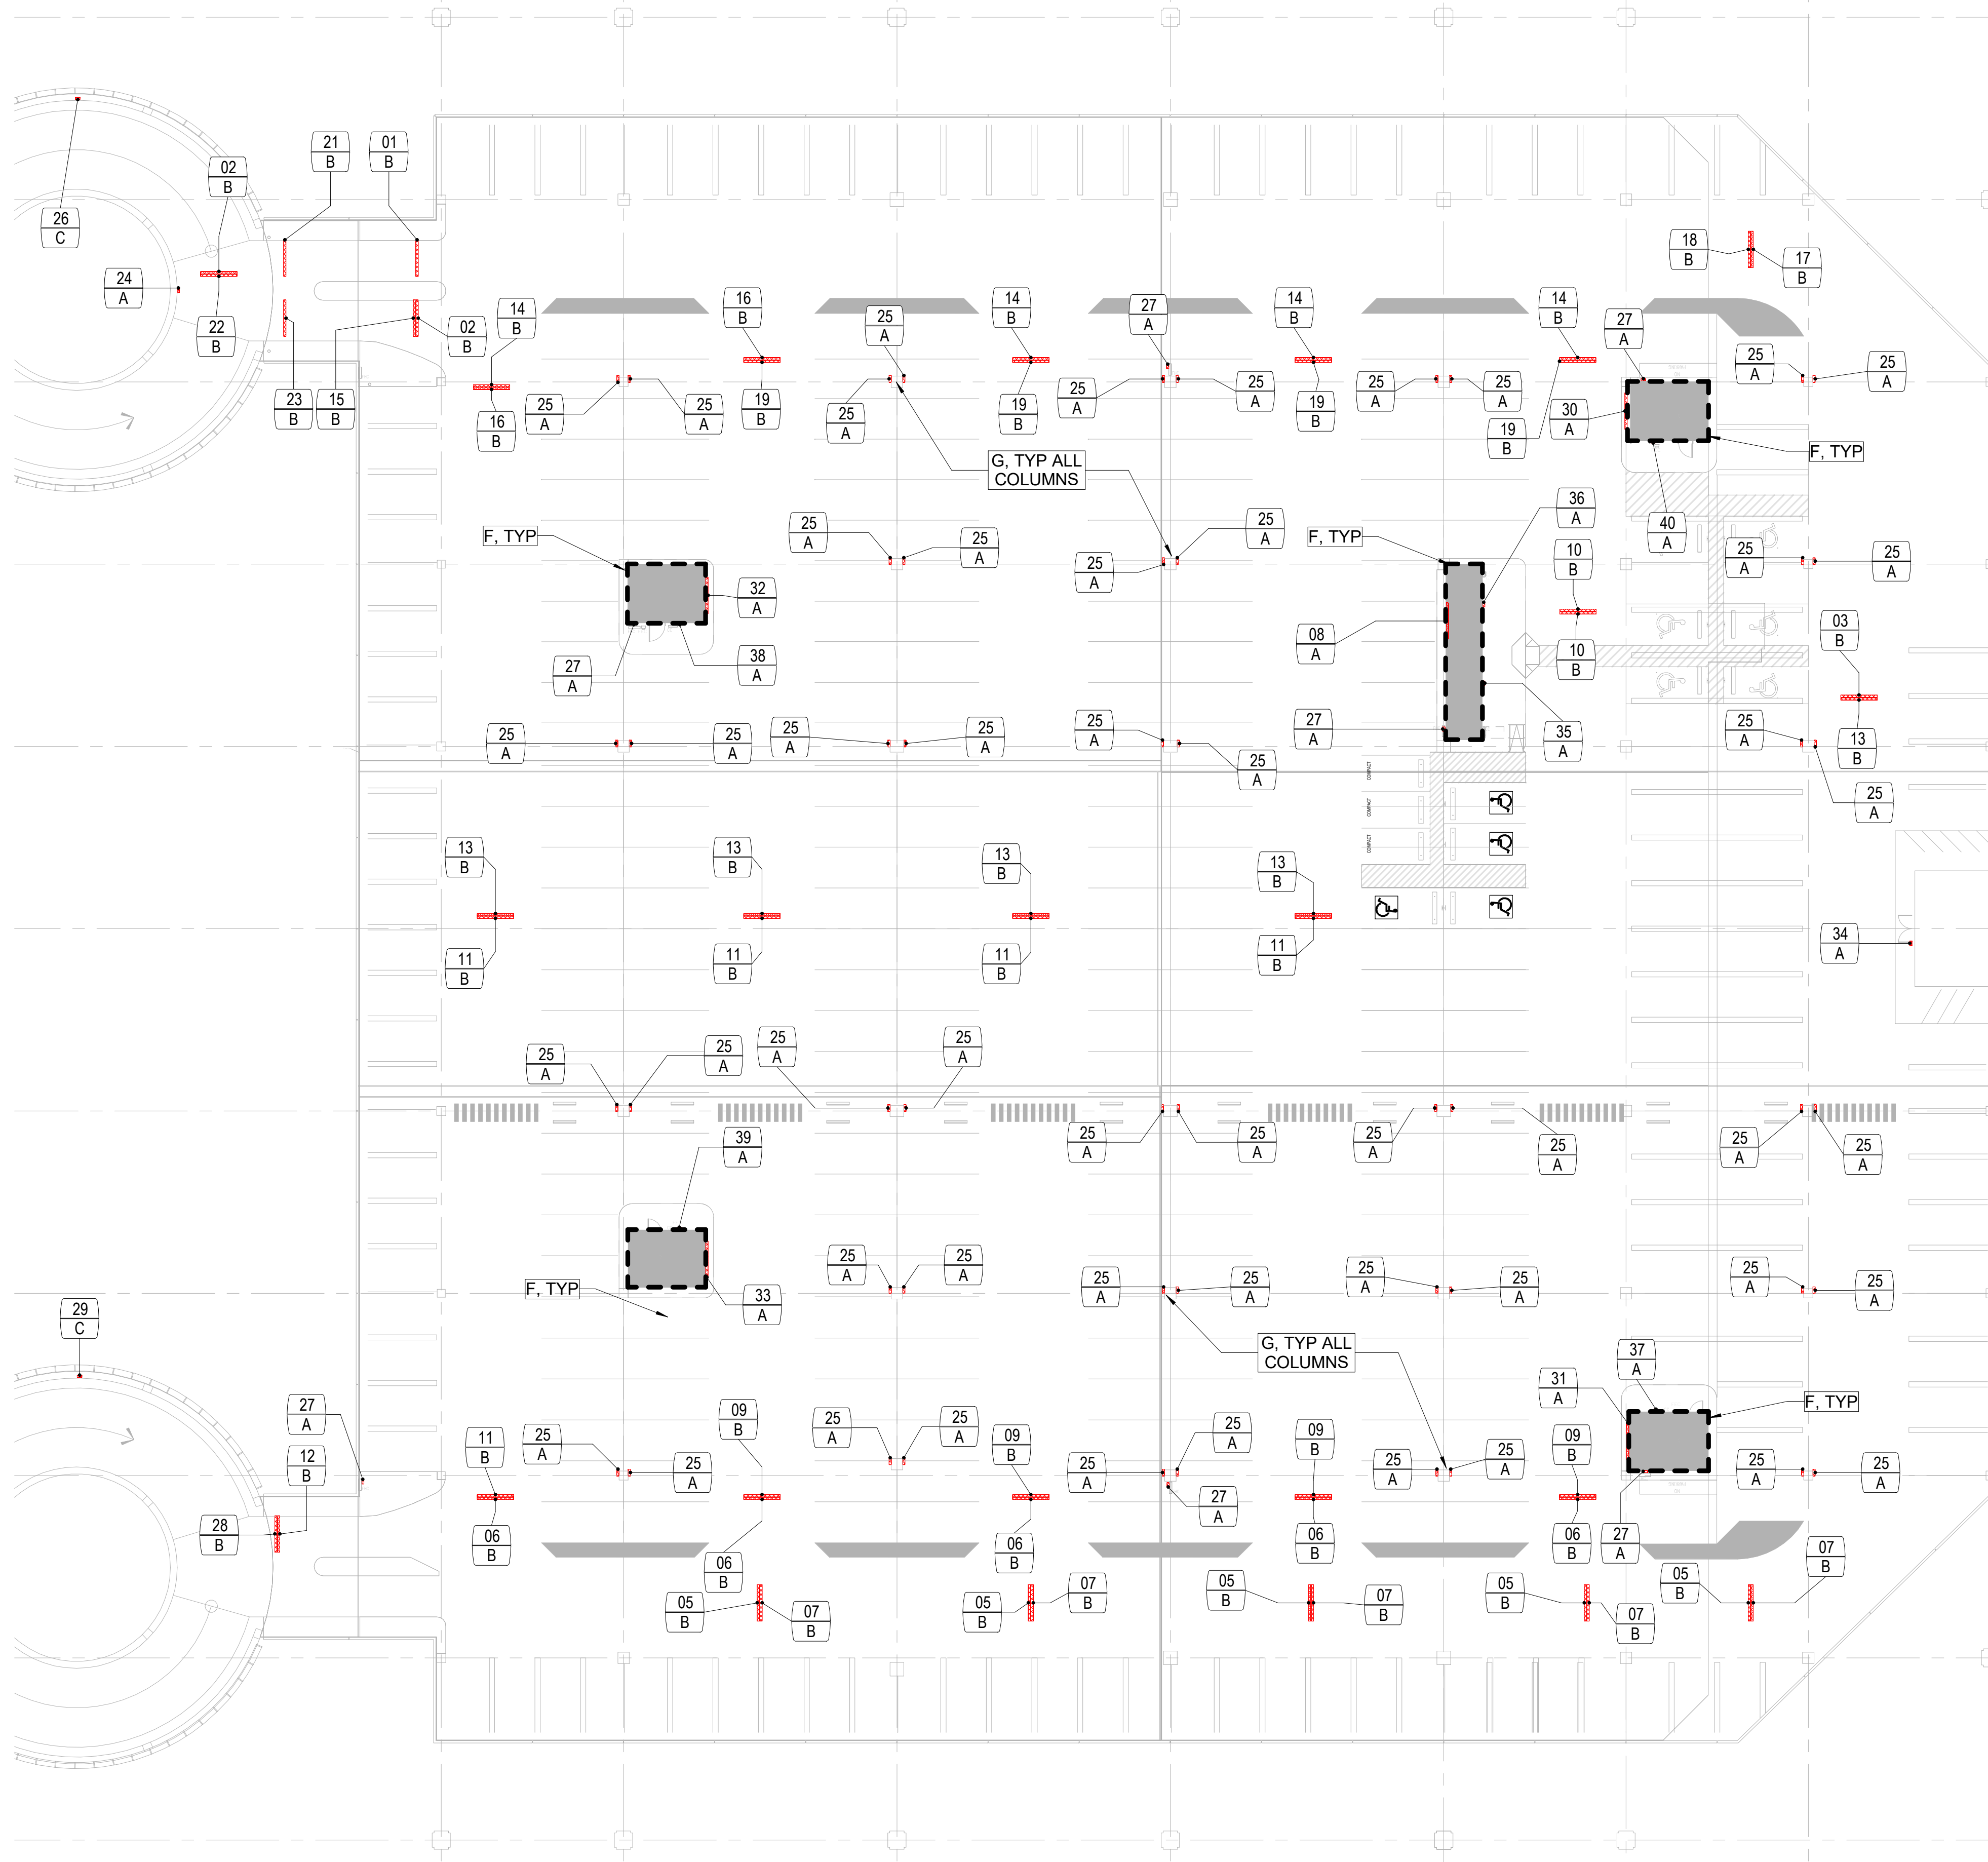FILE NAME: C:\Revit\Locals\TERM C SIGNAGE GARAGE\_DBhatti@pgal.com.rvt  
 DATE/TIME: 8/2/2024 4:40:13 PM



\*\* 48 +/- COLUMNS TO BE PAINTED IN THIS SECTOR, V.I.F.

LEVEL 02 - DEMO PLAN - SECTOR A 3/64" = 1'-0" 1

IMAGE	MARK	NOTES
	01	B
	02	B
	03	B
	05	B
	06	B
	07	B
	08	A
	09	B
	10	B
	11	B
	12	B
	13	B
	14	B
	16	B
	17	B
	18	B
	19	B
	21	B
	22	B
	23	B
	24	A
	25	A
	26	C
	27	A
	28	B

IMAGE REFERENCE

IMAGE	MARK	NOTES
	29	C
	30	A
	31	A
	32	A
	33	A
	34	A
	35	A
	36	A


IMAGE	MARK	NOTES
	37	A
	38	A
	39	A
	40	A

DEMO KEYNOTE

- A EXISTING SURFACE MOUNTED SIGN(S) TO BE REMOVED, PATCH/REPAIR AS REQUIRED.
- B EXISTING CEILING MOUNTED SIGN TO BE REMOVED, REMOVE SUSPENSION FRAME AND ATTACHMENTS FROM GARAGE STRUCTURAL CEILING. PATCH/REPAIR AS REQUIRED.
- C EXISTING SIGN(S) / ACCESSORY TO REMAIN.
- D EXISTING POLE MOUNTED SIGN TO BE REMOVED, PATCH/REPAIR AS REQUIRED.
- E EXISTING TUBE STEEL AND SUPPORT TO BE REMOVED, PATCH/REPAIR FLOOR AS REQUIRED.
- F CHEMICALLY STRIP OR SANDBLAST PAINT TO ORIGINAL BARE CONCRETE FINISH AND SKIM COAT WITH SIKA QUICK SMOOTH FINISH AT EXTERIOR WALL PERIMETER AT ELEVATOR AND STAIR CORES. TO BE PRIMED AND PAINTED.
- G CHEMICALLY STRIP OR SANDBLAST PAINT TO ORIGINAL BARE CONCRETE FINISH AND SKIM COAT WITH SIKA QUICK SMOOTH FINISH AT ALL GARAGE COLUMNS ONLY. TO BE PRIMED AND PAINTED. REFER TO \*\* IN REGARDS TO APPROXIMATE COLUMN QUANTITY.

\*\*\* NOTE \*\*\*  
 UNLESS NOTED OTHERWISE, ALL REMOVED SIGNS ARE TO BE REPLACED WITH A NEW SIGN

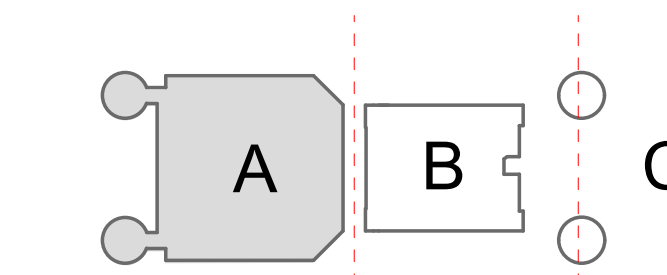
KEY PLAN




1:256 SCALE



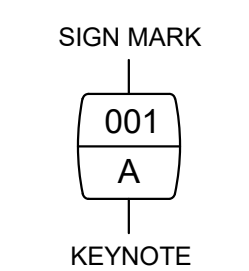LEGEND



PLAN NORTH

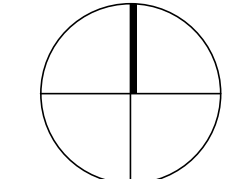

CLIENT



Client Name

ARCHITECT



PGAL  
 3131 BRIARPARK DR.  
 SUITE 200  
 HOUSTON, TX 77042  
 [T] 713 622 1444  
 [F] 713 968 9333  
 www.pgal.com

BSG PRJCT#  
 BSG-2024-111-IAH

DEPARTMENT OF AVIATION  
 RECOMMENDED:  
 HOUSTON AIRPORT SYSTEM  
 DIRECTOR OR DESIGN REPRESENTATIVE  
 HAS TIP # 24-103 - IAH

REGISTRATION  
 Copyright © 2024



DRAWING HISTORY

NO.	DATE	DESCRIPTION
01	04/10/2024	ISSUE FOR PERMIT
02	08/23/2024	ISSUE FOR BID

PROJECT NAME  
 IAH TERMINAL C  
 GARAGE  
 SIGNAGE &  
 WAYFINDING

PROJECT LOCATION  
 TERMINAL C  
 3500 NORTH  
 TERMINAL RD.  
 HOUSTON, TX 77032


PROJECT NUMBER  
 1004395

SHEET TITLE  
 LEVEL 02 - GARAGE  
 - DEMO PLAN -  
 SECTOR A

SHEET NUMBER

AD2.02A

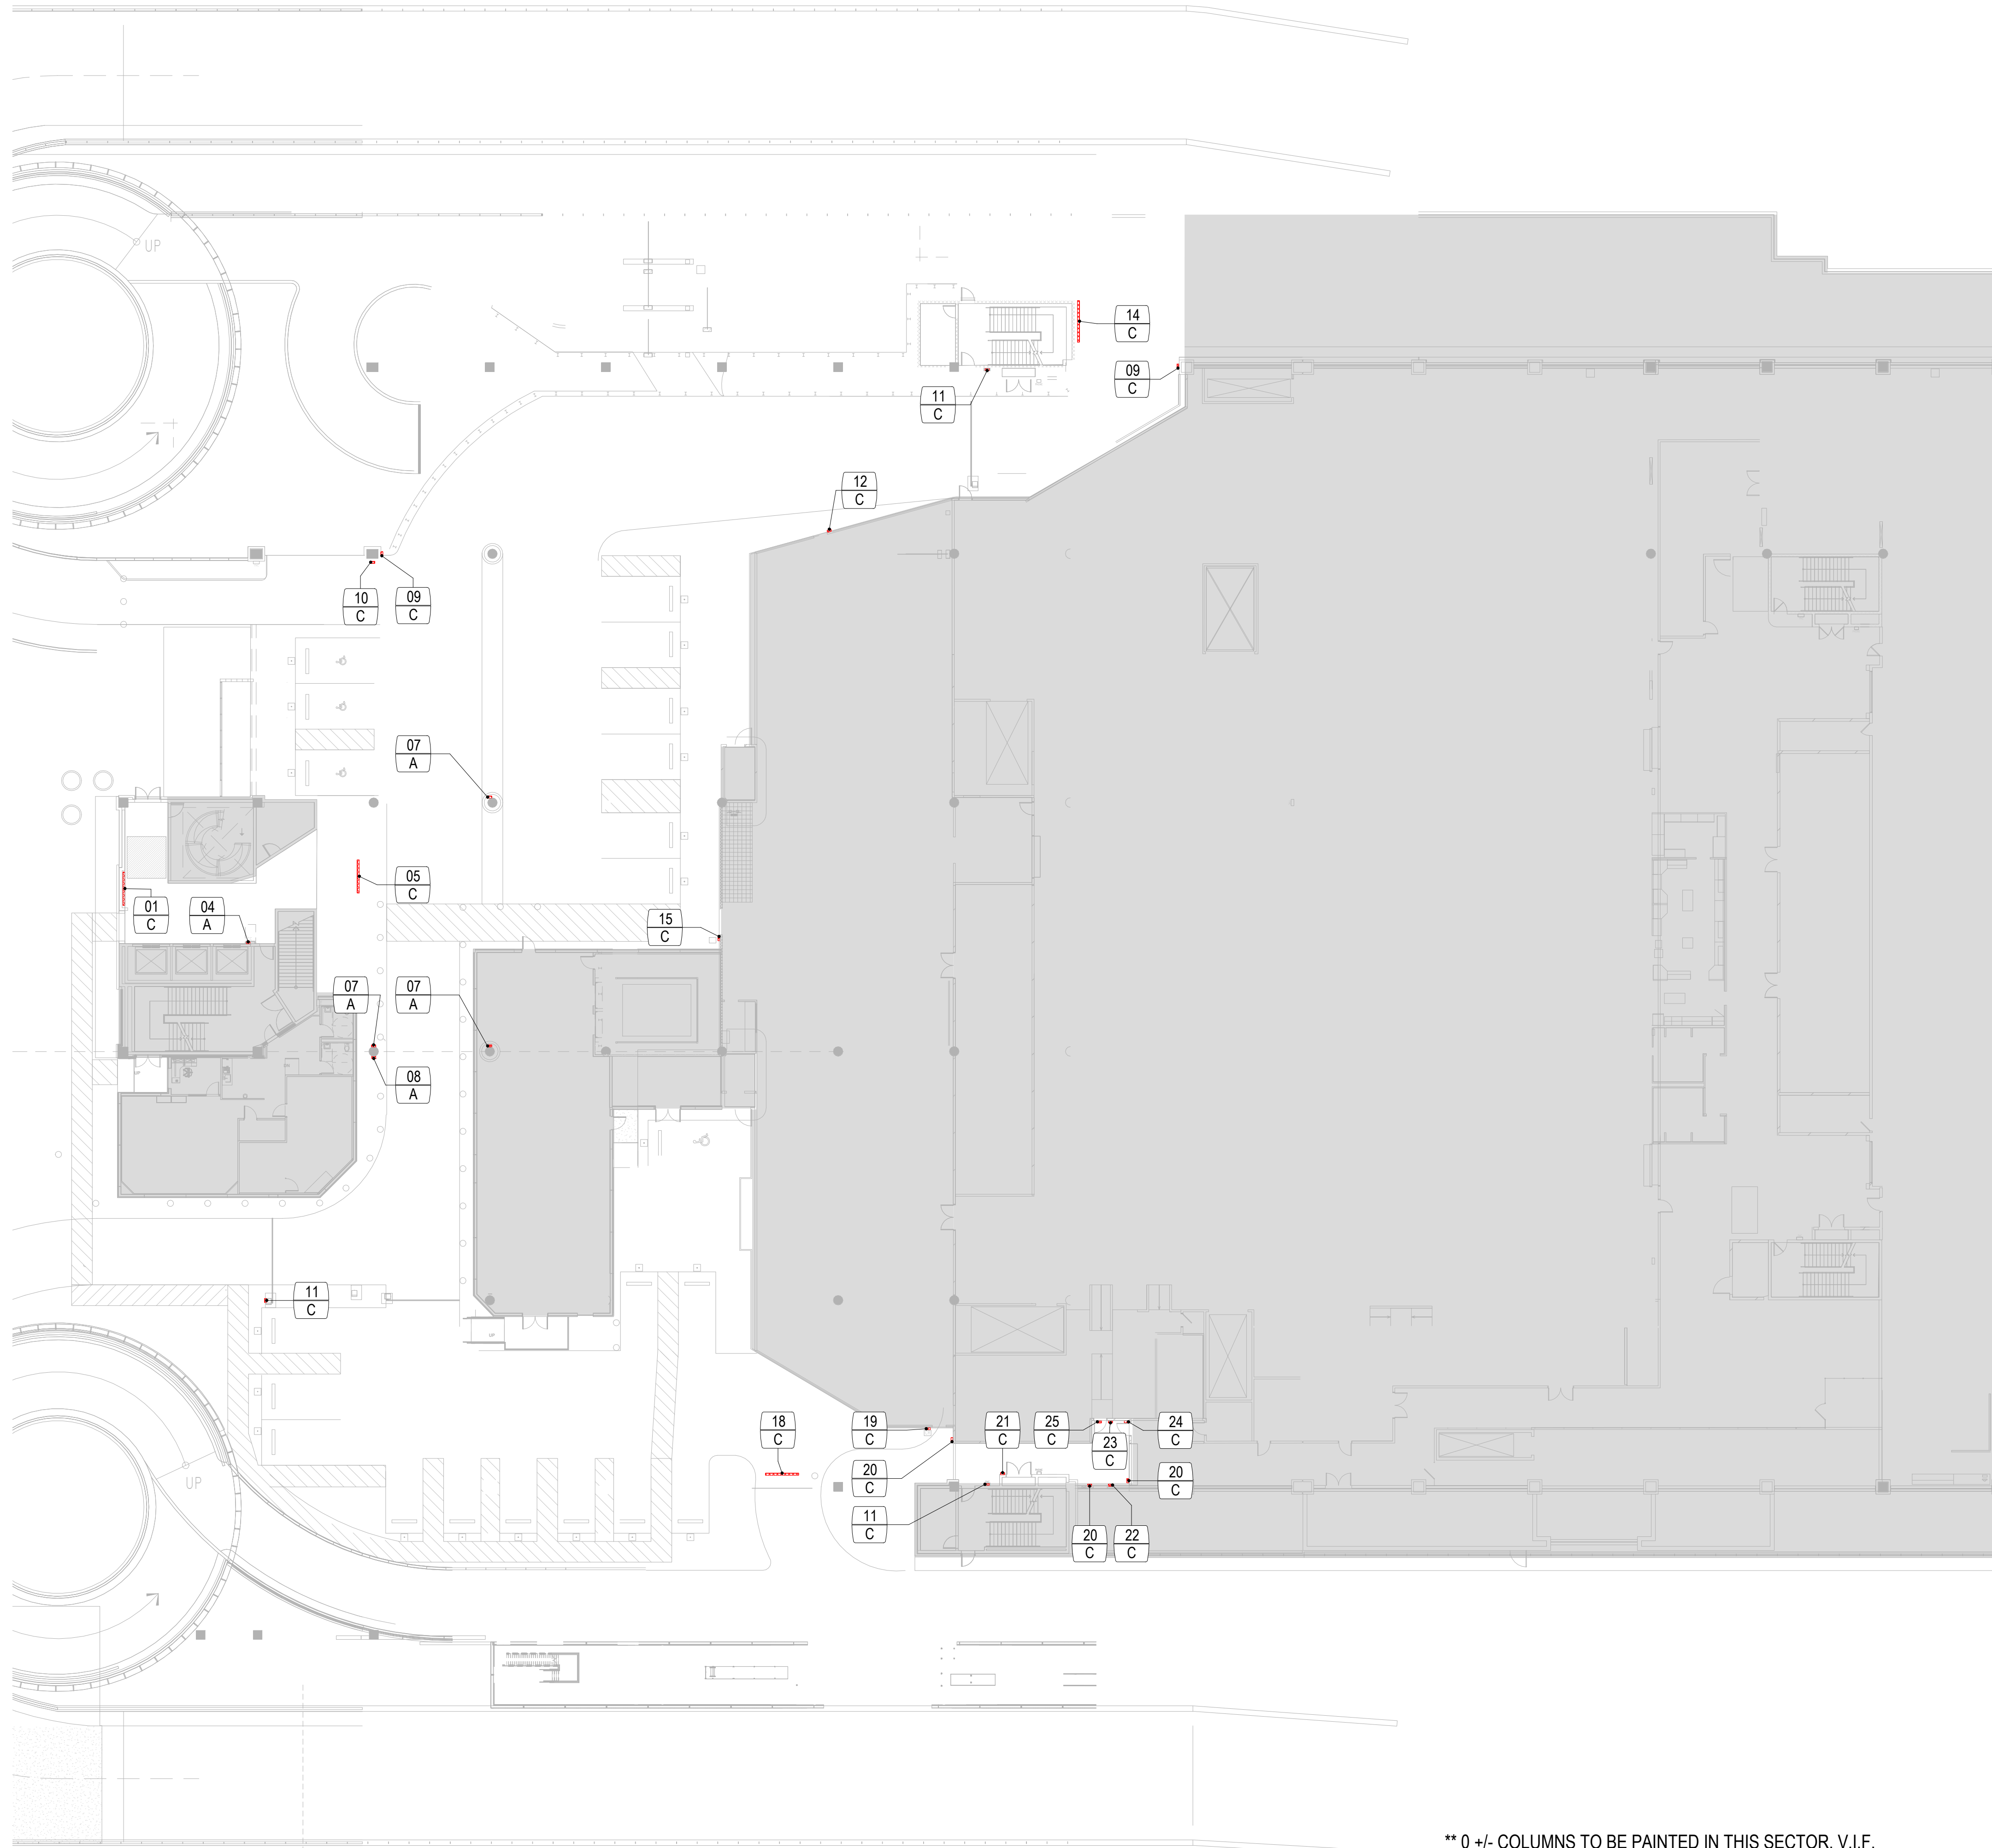FILE NAME: C:\Revit\Locals\TERM C SIGNAGE GARAGE\_DBhatti@pgal.com.rvt  
 DATE/TIME: 8/24/2024 4:40:22 PM



\*\* 0 +/- COLUMNS TO BE PAINTED IN THIS SECTOR, V.I.F.

LEVEL 02 - DEMO PLAN - SECTOR C 3/64" = 1'-0" 1

IMAGE REFERENCE


IMAGE	MARK	NOTES	IMAGE	MARK	NOTES
	01	C		12	C
	04	A		14	C
	05	C		15	C
	07	A			
	08	A			
	09	C			
	10	C			
	11	C			

DEMO KEYNOTE


- A EXISTING SURFACE MOUNTED SIGN(S) TO BE REMOVED, PATCH/REPAIR AS REQUIRED.
- B EXISTING CEILING MOUNTED SIGN TO BE REMOVED, REMOVE SUSPENSION FRAME AND ATTACHMENTS FROM GARAGE STRUCTURAL CEILING. PATCH/REPAIR AS REQUIRED.
- C EXISTING SIGN(S) / ACCESSORY TO REMAIN.
- D EXISTING POLE MOUNTED SIGN TO BE REMOVED, PATCH/REPAIR AS REQUIRED.
- E EXISTING TUBE STEEL AND SUPPORT TO BE REMOVED, PATCH/REPAIR FLOOR AS REQUIRED.
- F CHEMICALLY STRIP OR SANDBLAST PAINT TO ORIGINAL BARE CONCRETE FINISH AND SKIM COAT WITH SIKA QUICK SMOOTH FINISH AT EXTERIOR WALL PERIMETER AT ELEVATOR AND STAIR CORES. TO BE PRIMED AND PAINTED.
- G CHEMICALLY STRIP OR SANDBLAST PAINT TO ORIGINAL BARE CONCRETE FINISH AND SKIM COAT WITH SIKA QUICK SMOOTH FINISH AT ALL GARAGE COLUMNS ONLY. TO BE PRIMED AND PAINTED. REFER TO "\*" IN REGARDS TO APPROXIMATE COLUMN QUANTITY.

\*\*\* NOTE \*\*\*  
 UNLESS NOTED OTHERWISE, ALL REMOVED SIGNS ARE TO BE REPLACED WITH A NEW SIGN

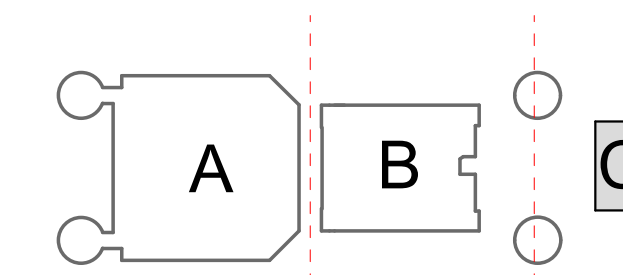
KEY PLAN




1: 256 SCALE

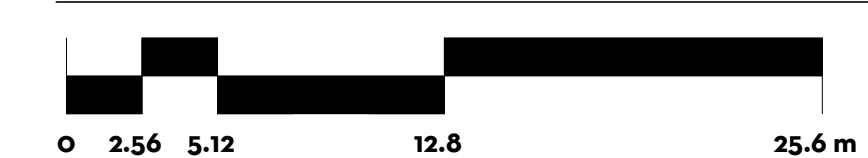

LEGEND

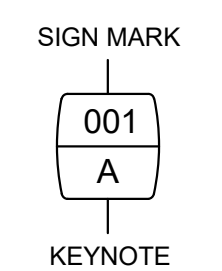

PLAN NORTH

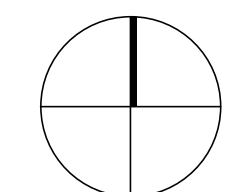

CLIENT



Client Name

ARCHITECT



PGAL  
 3131 BRIARPARK DR.  
 SUITE 200  
 HOUSTON, TX 77042  
 [T] 713 622 1444  
 [F] 713 968 9333  
 www.pgal.com

BSG PRJCT#  
 BSG-2024-111-IAH

DEPARTMENT OF AVIATION  
 RECOMMENDED:  
 HOUSTON AIRPORT SYSTEM  
 DIRECTOR OR DESIGN REPRESENTATIVE  
 HAS TIP # 24-103 - IAH

REGISTRATION  
 Copyright © 2024



DRAWING HISTORY

NO.	DATE	DESCRIPTION
01	04/10/2024	ISSUE FOR PERMIT
02	08/23/2024	ISSUE FOR BID

PROJECT NAME  
 IAH TERMINAL C  
 GARAGE  
 SIGNAGE &  
 WAYFINDING

PROJECT LOCATION  
 TERMINAL C  
 3500 NORTH  
 TERMINAL RD.  
 HOUSTON, TX 77032

PROJECT NUMBER  
 1004395

SHEET TITLE  
 LEVEL 02 - GARAGE  
 - DEMO PLAN -  
 SECTOR C

SHEET NUMBER

AD2.02C.1



FILE NAME: C:\Revit\Locals\TERM C SIGNAGE GARAGE\_DBhatti@pgal.com.rvt  
 DATE/TIME: 8/23/2024 4:40:25 PM

IMAGE REFERENCE

IMAGE	MARK	NOTES
	18	C
	19	C
	20	C
	21	C
	22	C
	23	C
	24	C
	25	C

DEMO KEYNOTE

- A EXISTING SURFACE MOUNTED SIGN(S) TO BE REMOVED, PATCH/REPAIR AS REQUIRED.
- B EXISTING CEILING MOUNTED SIGN TO BE REMOVED, REMOVE SUSPENSION FRAME AND ATTACHMENTS FROM GARAGE STRUCTURAL CEILING. PATCH/REPAIR AS REQUIRED.
- C EXISTING SIGN(S) / ACCESSORY TO REMAIN.
- D EXISTING POLE MOUNTED SIGN TO BE REMOVED, PATCH/REPAIR AS REQUIRED.
- E EXISTING TUBE STEEL AND SUPPORT TO BE REMOVED, PATCH/REPAIR FLOOR AS REQUIRED.
- F CHEMICALLY STRIP OR SANDBLAST PAINT TO ORIGINAL BARE CONCRETE FINISH AND SKIM COAT WITH SIKA QUICK SMOOTH FINISH AT EXTERIOR WALL PERIMETER AT ELEVATOR AND STAIR CORES. TO BE PRIMED AND PAINTED.
- G CHEMICALLY STRIP OR SANDBLAST PAINT TO ORIGINAL BARE CONCRETE FINISH AND SKIM COAT WITH SIKA QUICK SMOOTH FINISH AT ALL GARAGE COLUMNS ONLY. TO BE PRIMED AND PAINTED. REFER TO \*\* IN REGARDS TO APPROXIMATE COLUMN QUANTITY.

CLIENT



Client Name

ARCHITECT



PGAL  
 3131 BRIARPARK DR.  
 SUITE 200  
 HOUSTON, TX 77042  
 [T] 713 622 1444  
 [F] 713 968 9333  
 www.pgal.com

BSG PRJCT#  
 BSG-2024-111-IAH

DEPARTMENT OF AVIATION  
 RECOMMENDED:  
 HOUSTON AIRPORT SYSTEM  
 DIRECTOR OR DESIGN REPRESENTATIVE  
 HAS TIP # 24-103 - IAH

REGISTRATION  
 Copyright © 2024



DRAWING HISTORY

NO.	DATE	DESCRIPTION
01	04/10/2024	ISSUE FOR PERMIT
02	08/23/2024	ISSUE FOR BID

PROJECT NAME  
 IAH TERMINAL C  
 GARAGE  
 SIGNAGE &  
 WAYFINDING

PROJECT LOCATION  
 TERMINAL C  
 3500 NORTH  
 TERMINAL RD.  
 HOUSTON, TX 77032


PROJECT NUMBER  
 1004395

SHEET TITLE  
 LEVEL 02 - GARAGE  
 - DEMO PLAN -  
 SECTOR C

SHEET NUMBER

AD2.02C.2

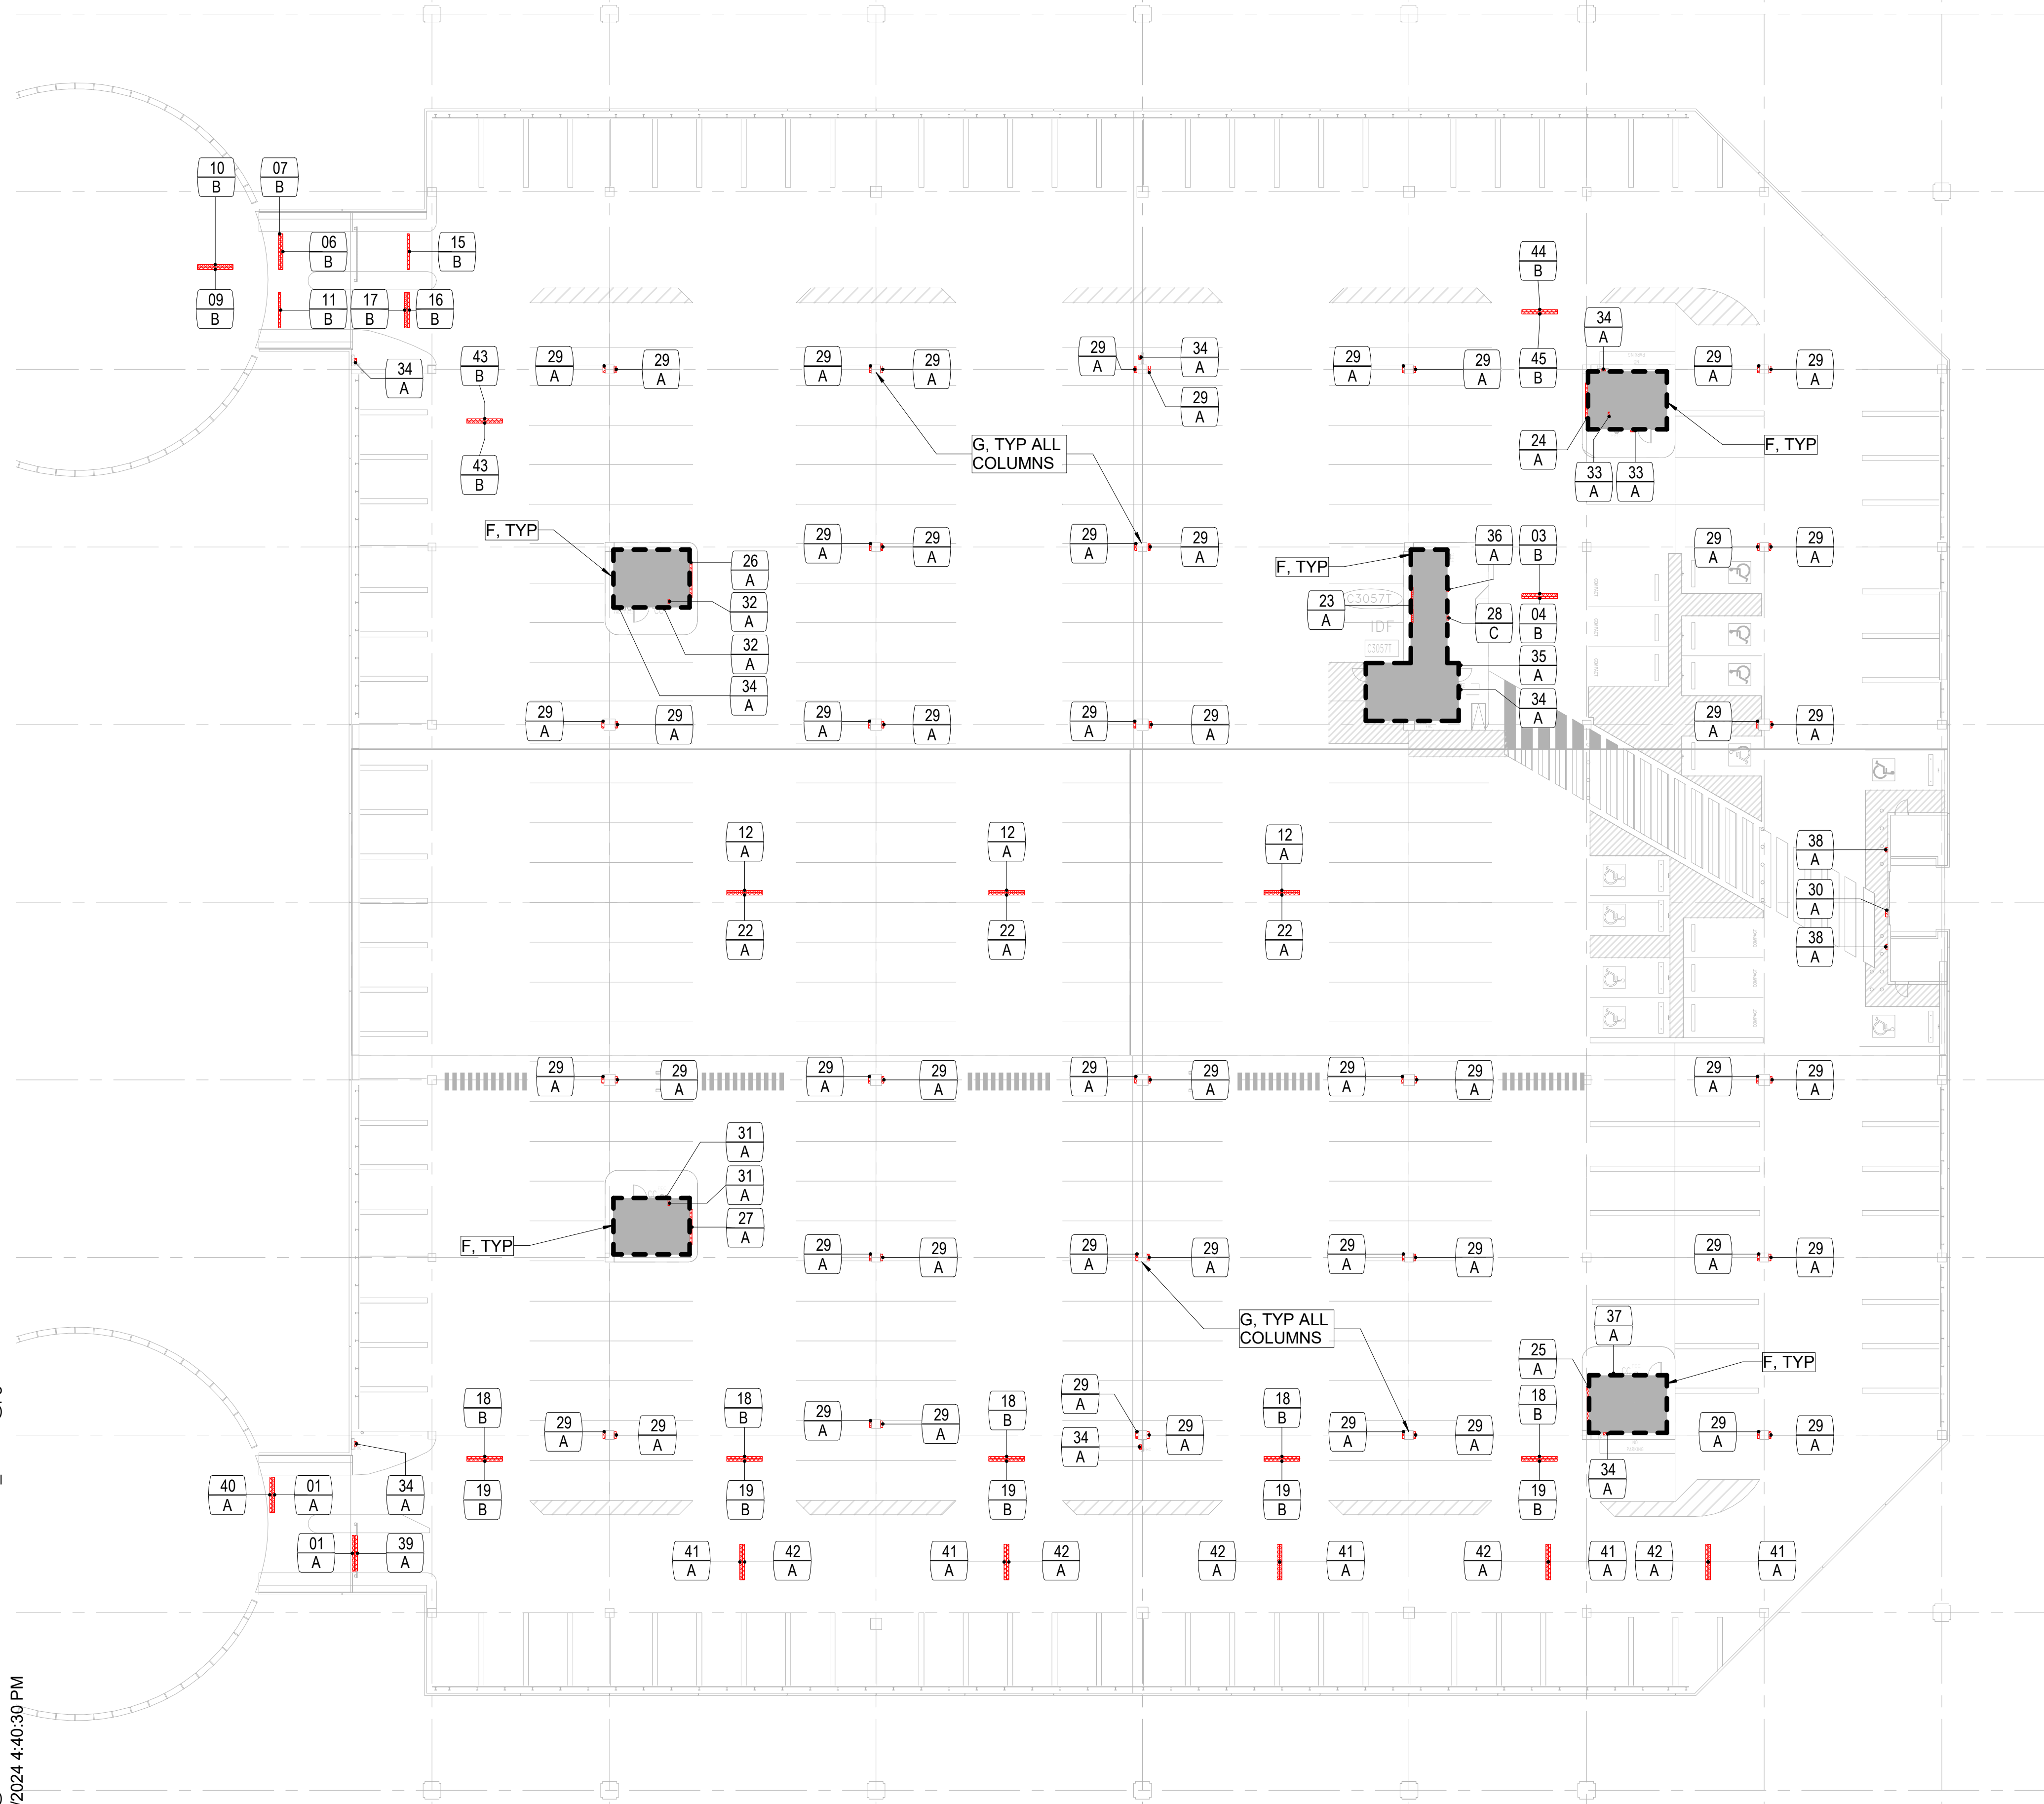FILE NAME: C:\Revit\Local\TERM C SIGNAGE GARAGE\_DBhatti@pgal.com.rvt  
 DATE/TIME: 4/8/2024 4:40:30 PM



\*\* 62 +/- COLUMNS TO BE PAINTED IN THIS SECTOR, V.I.F.

**LEVEL 03 - DEMO PLAN - SECTOR A** 3/64" = 1'-0" 1

IMAGE	MARK	NOTES
	01	A
	03	B
	04	B
	06	B
	07	B
	09	B
	10	B
	11	B
	12	A
	15	B
	16	B
	17	B
	18	B
	19	B
	22	A
	23	A
	24	A
	25	A
	26	A
	27	A


IMAGE	MARK	NOTES
	28	C
	29	A
	43	B
	44	B
	45	B

**DEMO KEYNOTE**

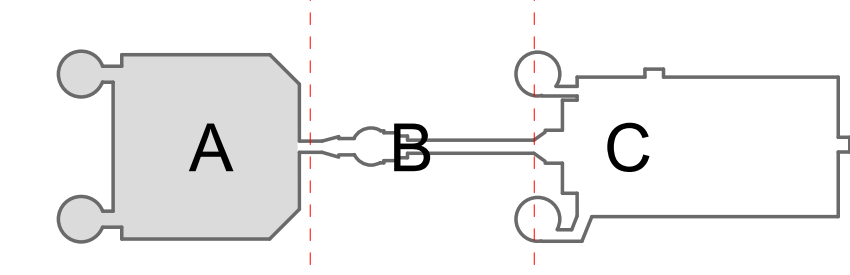- A EXISTING SURFACE MOUNTED SIGN(S) TO BE REMOVED, PATCH/REPAIR AS REQUIRED.
- B EXISTING CEILING MOUNTED SIGN TO BE REMOVED, REMOVE SUSPENSION FRAME AND ATTACHMENTS FROM GARAGE STRUCTURAL CEILING. PATCH/REPAIR AS REQUIRED.
- C EXISTING SIGN(S) / ACCESSORY TO REMAIN.
- D EXISTING POLE MOUNTED SIGN TO BE REMOVED, PATCH/REPAIR AS REQUIRED.
- E EXISTING TUBE STEEL AND SUPPORT TO BE REMOVED, PATCH/REPAIR FLOOR AS REQUIRED.
- F CHEMICALLY STRIP OR SANDBLAST PAINT TO ORIGINAL BARE CONCRETE FINISH AND SKIM COAT WITH SIKA QUICK SMOOTH FINISH AT EXTERIOR WALL PERIMETER AT ELEVATOR AND STAIR CORES. TO BE PRIMED AND PAINTED.
- G CHEMICALLY STRIP OR SANDBLAST PAINT TO ORIGINAL BARE CONCRETE FINISH AND SKIM COAT WITH SIKA QUICK SMOOTH FINISH AT ALL GARAGE COLUMNS ONLY. TO BE PRIMED AND PAINTED. REFER TO \*\* IN REGARDS TO APPROXIMATE COLUMN QUANTITY.

\*\*\* NOTE \*\*\*  
 UNLESS NOTED OTHERWISE, ALL REMOVED SIGNS ARE TO BE REPLACED WITH A NEW SIGN

**KEY PLAN**




1:256 SCALE



**LEGEND**

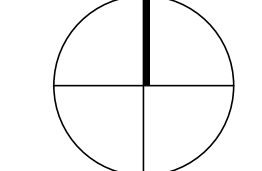	SIGN MARK
	KEYNOTE

**PLAN NORTH**



Client Name

ARCHITECT



PGAL  
 3131 BRIARPARK DR.  
 SUITE 200  
 HOUSTON, TX 77042  
 [T] 713 622 1444  
 [F] 713 968 9333  
 www.pgal.com

BSG PRJCT#  
 BSG-2024-111-IAH

DEPARTMENT OF AVIATION  
 RECOMMENDED:  
 HOUSTON AIRPORT SYSTEM  
 DIRECTOR OR DESIGN REPRESENTATIVE  
 HAS TIP # 24-103 - IAH

REGISTRATION  
 Copyright © 2024



**DRAWING HISTORY**

NO.	DATE	DESCRIPTION
01	04/10/2024	ISSUE FOR PERMIT
02	08/23/2024	ISSUE FOR BID

**PROJECT NAME**  
 IAH TERMINAL C  
 GARAGE  
 SIGNAGE &  
 WAYFINDING

**PROJECT LOCATION**  
 TERMINAL C  
 3500 NORTH  
 TERMINAL RD.  
 HOUSTON, TX 77032

**PROJECT NUMBER**  
 1004395

**SHEET TITLE**  
 LEVEL 03 - GARAGE  
 - DEMO PLAN -  
 SECTOR A

**SHEET NUMBER**

AD2.03A.1

IMAGE REFERENCE


IMAGE	MARK	NOTES
	30	A

IMAGE	MARK	NOTES
	31	A
	32	A
	33	A
	34	A
	35	A
	36	A
	37	A
	38	A
	39	A
	40	A
	41	A
	42	A

CLIENT



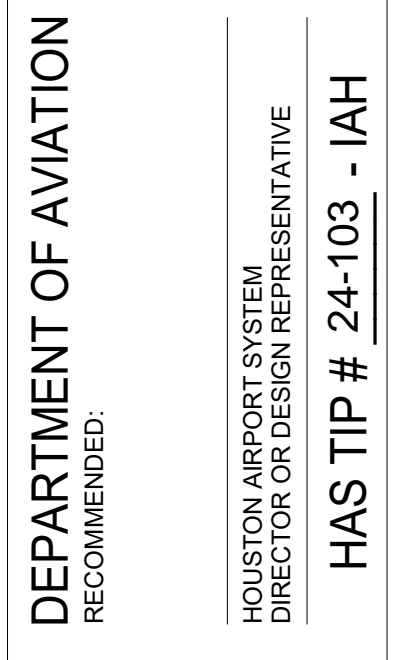
Client Name

ARCHITECT




PGAL  
 3131 BRIARPARK DR.  
 SUITE 200  
 HOUSTON, TX 77042  
 [T] 713 622 1444  
 [F] 713 968 9333  
 www.pgal.com

BSG PRJCT#  
 BSG-2024-111-IAH



REGISTRATION  
 Copyright © 2024

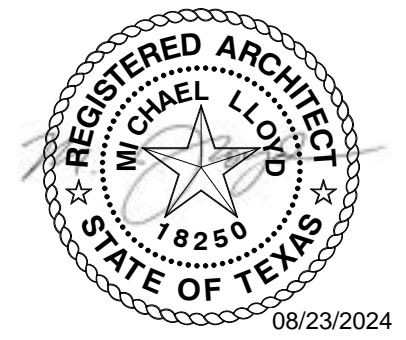

DRAWING HISTORY

NO.	DATE	DESCRIPTION
01	04/10/2024	ISSUE FOR PERMIT
02	08/23/2024	ISSUE FOR BID

PROJECT NAME  
 IAH TERMINAL C  
 GARAGE  
 SIGNAGE &  
 WAYFINDING

PROJECT LOCATION  
 TERMINAL C  
 3500 NORTH  
 TERMINAL RD.  
 HOUSTON, TX 77032


PROJECT NUMBER  
 1004395

SHEET TITLE  
 LEVEL 03 - GARAGE  
 DEMO PLAN -  
 SECTOR A.2

SHEET NUMBER

AD2.03A.2

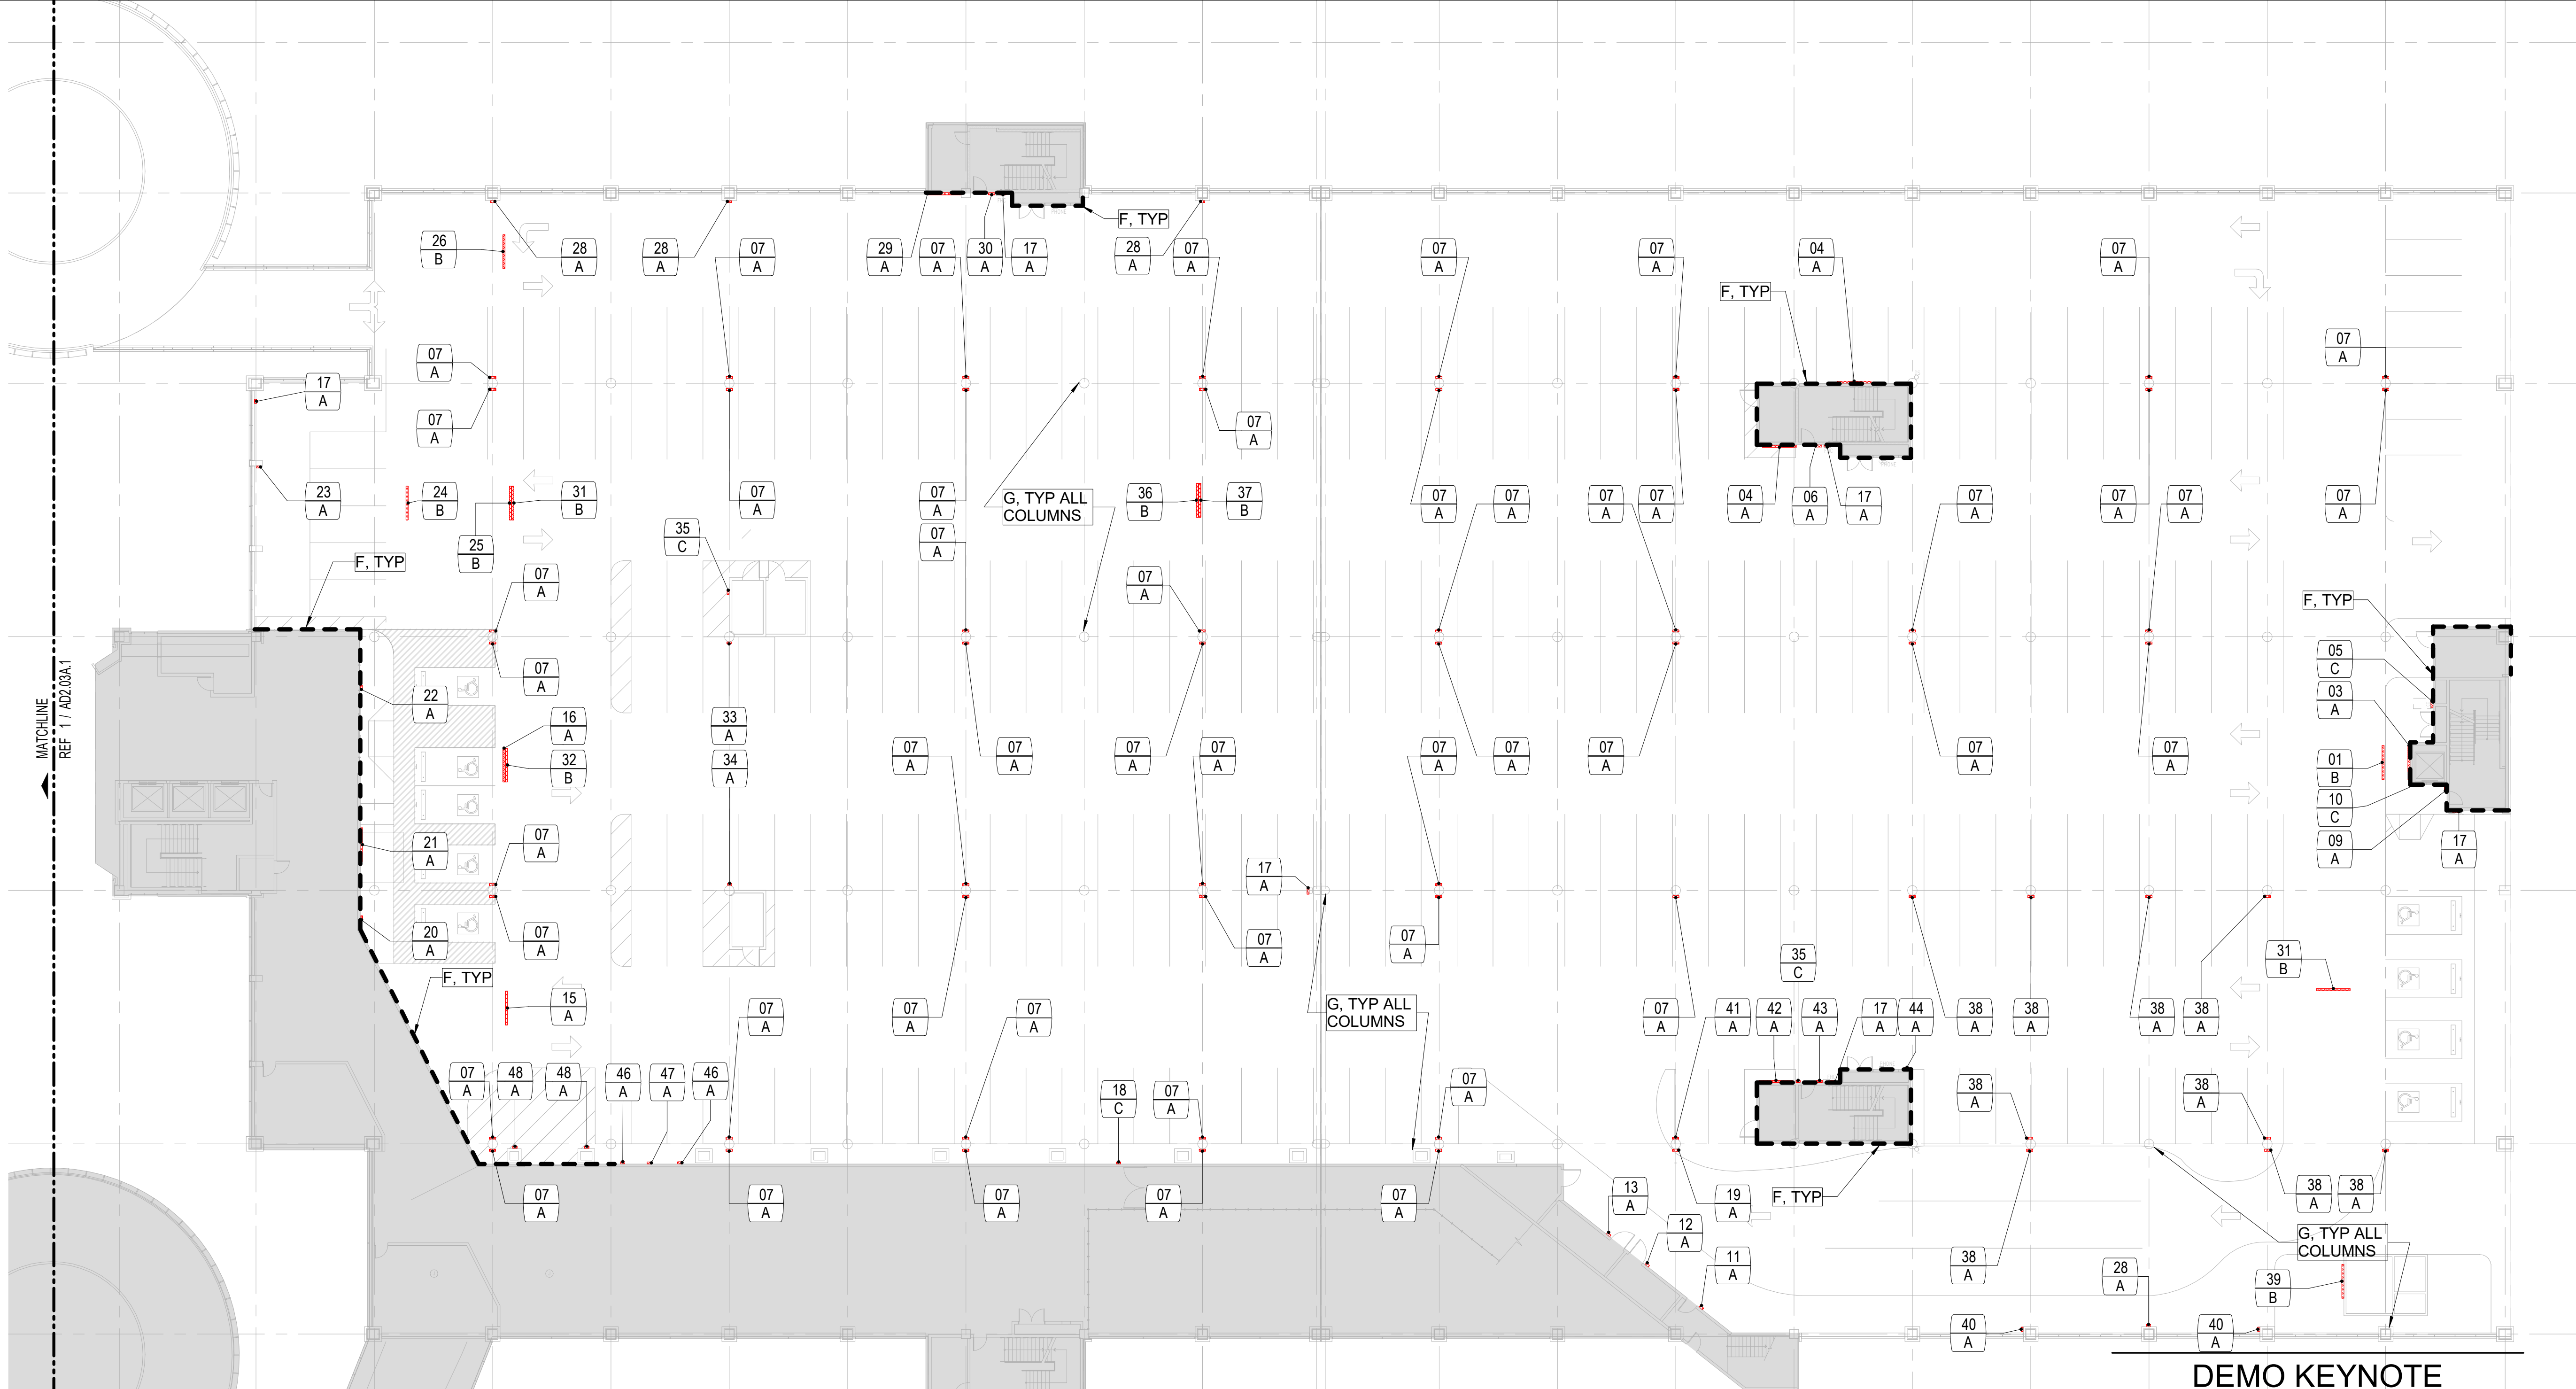FILE NAME: C:\Revit\Locals\TERM C SIGNAGE GARAGE\_DBhatti@pgal.com.rvt  
 DATE/TIME: 8/23/2024 4:40:37 PM





**\*\* 100 +/- COLUMNS TO BE PAINTED IN THIS SECTOR, V.I.F. LEVEL 03 - DEMO PLAN - SECTOR C 3/64" = 1'-0" 1**

**DEMO KEYNOTE**

- A EXISTING SURFACE MOUNTED SIGN(S) TO BE REMOVED, PATCH/REPAIR AS REQUIRED.
- B EXISTING CEILING MOUNTED SIGN TO BE REMOVED, REMOVE SUSPENSION FRAME AND ATTACHMENTS FROM GARAGE STRUCTURAL CEILING. PATCH/REPAIR AS REQUIRED.
- C EXISTING SIGN(S) / ACCESSORY TO REMAIN.
- D EXISTING POLE MOUNTED SIGN TO BE REMOVED, PATCH/REPAIR AS REQUIRED.
- E EXISTING TUBE STEEL AND SUPPORT TO BE REMOVED, PATCH/REPAIR FLOOR AS REQUIRED.
- F CHEMICALLY STRIP OR SANDBLAST PAINT TO ORIGINAL BARE CONCRETE FINISH AND SKIM COAT WITH SIKA QUICK SMOOTH FINISH AT EXTERIOR WALL PERIMETER AT ELEVATOR AND STAIR CORES. TO BE PRIMED AND PAINTED.
- G CHEMICALLY STRIP OR SANDBLAST PAINT TO ORIGINAL BARE CONCRETE FINISH AND SKIM COAT WITH SIKA QUICK SMOOTH FINISH AT ALL GARAGE COLUMNS ONLY. TO BE PRIMED AND PAINTED. REFER TO \*\* IN REGARDS TO APPROXIMATE COLUMN QUANTITY.

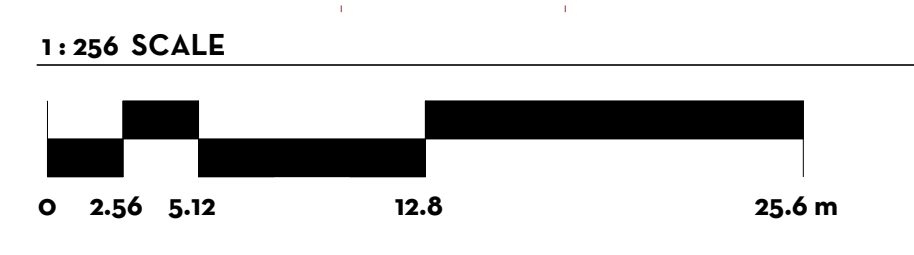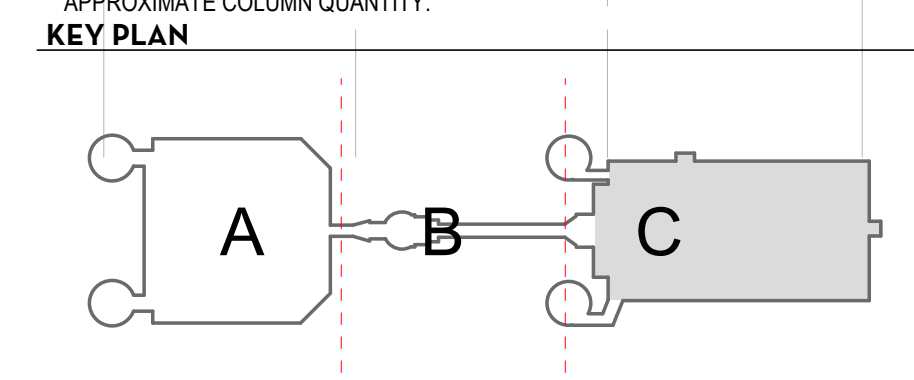
**\*\*\* NOTE \*\*\***  
 UNLESS NOTED OTHERWISE, ALL REMOVED SIGNS ARE TO BE REPLACED WITH A NEW SIGN



**LEGEND**

SIGN MARK  
 001  
 A

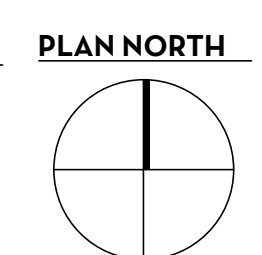KEYNOTE



CLIENT  
 Client Name



ARCHITECT  
 PGAL  
 3131 BRIARPARK DR.  
 SUITE 200  
 HOUSTON, TX 77042  
 [T] 713 622 1444  
 [F] 713 968 9333  
 www.pgal.com

BSG PRJCT#  
 BSG-2024-111-IAH

DEPARTMENT OF AVIATION  
 RECOMMENDED:  
 HOUSTON AIRPORT SYSTEM  
 DIRECTOR OR DESIGN REPRESENTATIVE  
 HAS TIP # 24-103 - IAH

REGISTRATION  
 Copyright © 2024



**DRAWING HISTORY**

NO.	DATE	DESCRIPTION
01	04/10/2024	ISSUE FOR PERMIT
02	08/23/2024	ISSUE FOR BID

**PROJECT NAME**  
 IAH TERMINAL C  
 GARAGE  
 SIGNAGE &  
 WAYFINDING

**PROJECT LOCATION**  
 TERMINAL C  
 3500 NORTH  
 TERMINAL RD.  
 HOUSTON, TX 77032

**PROJECT NUMBER**  
 1004395

**SHEET TITLE**  
 LEVEL 03 - GARAGE  
 DEMO PLAN -  
 SECTOR C

**SHEET NUMBER**

**AD2.03C.1**

IMAGE	MARK	NOTES
	01	B
	03	A
	04	A
	05	C
	06	A
	07	A
	09	A

IMAGE	MARK	NOTES
	10	C
	11	A
	12	A
	13	A
	15	A

IMAGE	MARK	NOTES
	16	A
	17	A
	18	C
	19	A
	20	A
	21	A
	22	A
	23	A
	24	B
	25	B
	26	B
	28	A

IMAGE REFERENCE

IMAGE	MARK	NOTES
	29	A
	30	A
	31	B
	32	B
	33	A
	34	A
	35	C
	36	B
	37	B
	38	A
	39	B
	40	A
	41	A

IMAGE	MARK	NOTES
	42	A
	43	A
	44	A
	46	A
	47	A
	48	A

CLIENT



Client Name

ARCHITECT

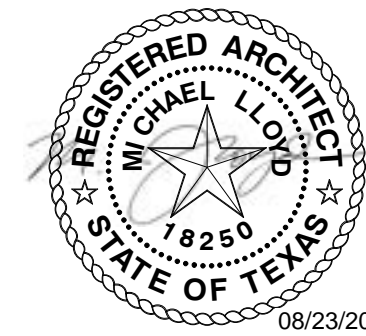


PGAL  
 3131 BRIARPARK DR.  
 SUITE 200  
 HOUSTON, TX 77042  
 [T] 713 622 1444  
 [F] 713 968 9333  
 www.pgal.com

BSG PRJCT#  
 BSG-2024-111-IAH

DEPARTMENT OF AVIATION  
 RECOMMENDED:  
 HOUSTON AIRPORT SYSTEM  
 DIRECTOR OR DESIGN REPRESENTATIVE  
 HAS TIP # 24-103 - IAH

REGISTRATION  
 Copyright © 2024



DRAWING HISTORY

NO.	DATE	DESCRIPTION
01	04/10/2024	ISSUE FOR PERMIT
02	08/23/2024	ISSUE FOR BID

PROJECT NAME  
 IAH TERMINAL C  
 GARAGE  
 SIGNAGE &  
 WAYFINDING

PROJECT LOCATION  
 TERMINAL C  
 3500 NORTH  
 TERMINAL RD.  
 HOUSTON, TX 77032

PROJECT NUMBER  
 1004395

SHEET TITLE  
 LEVEL 03 - GARAGE  
 DEMO PLAN -  
 SECTOR C

SHEET NUMBER

AD2.03C.2

DEMO KEYNOTE

- A. EXISTING SURFACE MOUNTED SIGN(S) TO BE REMOVED, PATCH/REPAIR AS REQUIRED.
- B. EXISTING CEILING MOUNTED SIGN TO BE REMOVED, REMOVE SUSPENSION FRAME AND ATTACHMENTS FROM GARAGE STRUCTURAL CEILING. PATCH/REPAIR AS REQUIRED.
- C. EXISTING SIGN(S) / ACCESSORY TO REMAIN.
- D. EXISTING POLE MOUNTED SIGN TO BE REMOVED, PATCH/REPAIR AS REQUIRED.
- E. EXISTING TUBE STEEL AND SUPPORT TO BE REMOVED, PATCH/REPAIR FLOOR AS REQUIRED.
- F. CHEMICALLY STRIP OR SANDBLAST PAINT TO ORIGINAL BARE CONCRETE FINISH AND SKIM COAT WITH SIKA QUICK SMOOTH FINISH AT EXTERIOR WALL PERIMETER AT ELEVATOR AND STAIR CORES. TO BE PRIMED AND PAINTED.
- G. CHEMICALLY STRIP OR SANDBLAST PAINT TO ORIGINAL BARE CONCRETE FINISH AND SKIM COAT WITH SIKA QUICK SMOOTH FINISH AT ALL GARAGE COLUMNS ONLY. TO BE PRIMED AND PAINTED. REFER TO \*\* IN REGARDS TO APPROXIMATE COLUMN QUANTITY.

FILE NAME: C:\Revit\Localis\TERM C SIGNAGE GARAGE\_DBhatti@pgal.com.rvt  
 DATE/TIME: 4/8/2024 4:40:46 PM


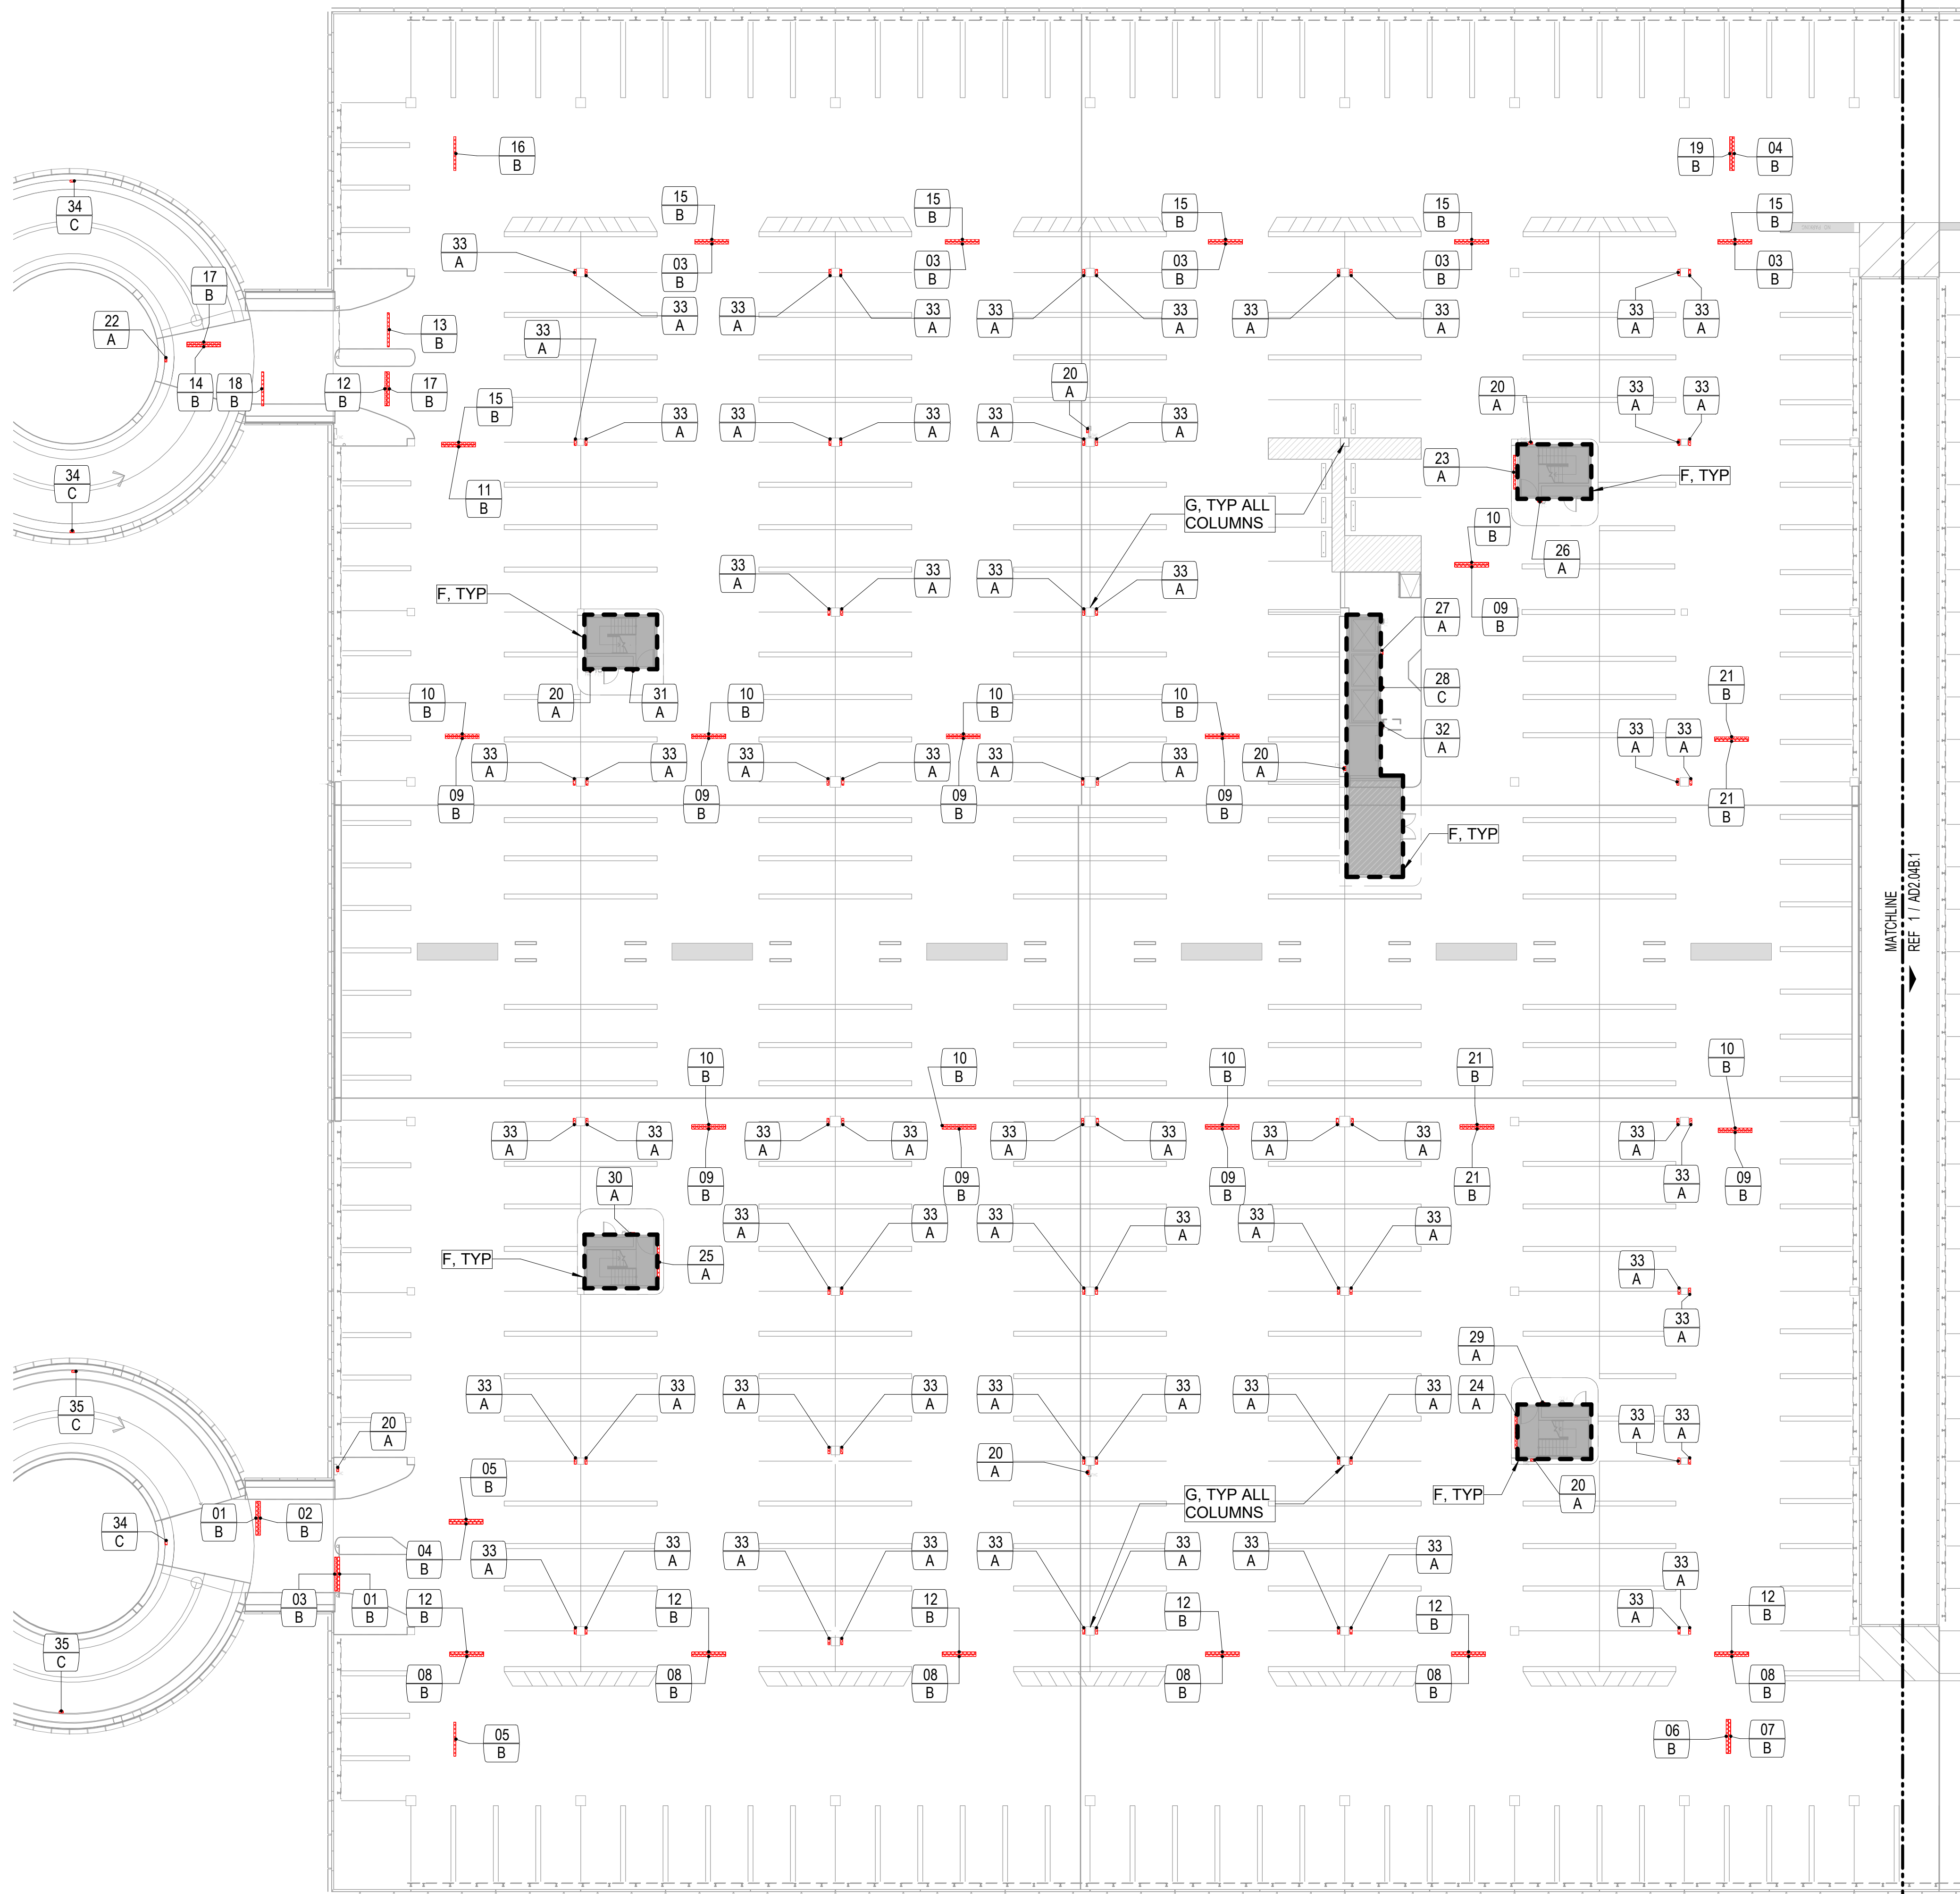


IMAGE REFERENCE




IMAGE	MARK	NOTES
	01	B
	02	B
	03	B
	04	B
	05	B
	06	B
	07	B
	08	B
	09	B
	10	B
	11	B
	12	B
	13	B
	14	B
	15	B
	16	B
	17	B
	18	B
	19	B
	20	A
	21	B
	22	A
	23	A
	24	A
	25	A

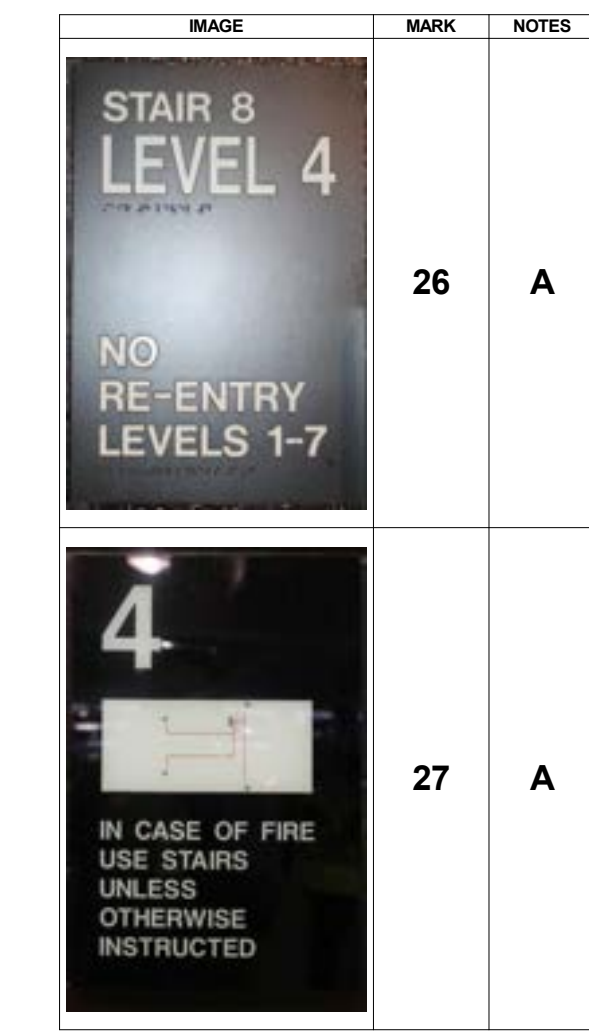

DEMO KEYNOTE

- A EXISTING SURFACE MOUNTED SIGN(S) TO BE REMOVED, PATCH/REPAIR AS REQUIRED.
- B EXISTING CEILING MOUNTED SIGN TO BE REMOVED, REMOVE SUSPENSION FRAME AND ATTACHMENTS FROM GARAGE STRUCTURAL CEILING. PATCH/REPAIR AS REQUIRED.
- C EXISTING SIGN(S) / ACCESSORY TO REMAIN.
- D EXISTING POLE MOUNTED SIGN TO BE REMOVED, PATCH/REPAIR AS REQUIRED.
- E EXISTING TUBE STEEL AND SUPPORT TO BE REMOVED, PATCH/REPAIR FLOOR AS REQUIRED.
- F CHEMICALLY STRIP OR SANDBLAST PAINT TO ORIGINAL BARE CONCRETE FINISH AND SKIM COAT WITH SIKA QUICK SMOOTH FINISH AT EXTERIOR WALL PERIMETER AT ELEVATOR AND STAIR CORES. TO BE PRIMED AND PAINTED.
- G CHEMICALLY STRIP OR SANDBLAST PAINT TO ORIGINAL BARE CONCRETE FINISH AND SKIM COAT WITH SIKA QUICK SMOOTH FINISH AT ALL GARAGE COLUMNS ONLY. TO BE PRIMED AND PAINTED. REFER TO \*\* IN REGARDS TO APPROXIMATE COLUMN QUANTITY.

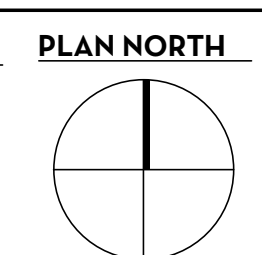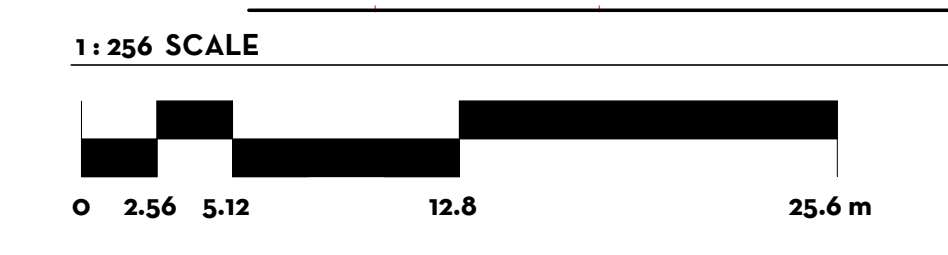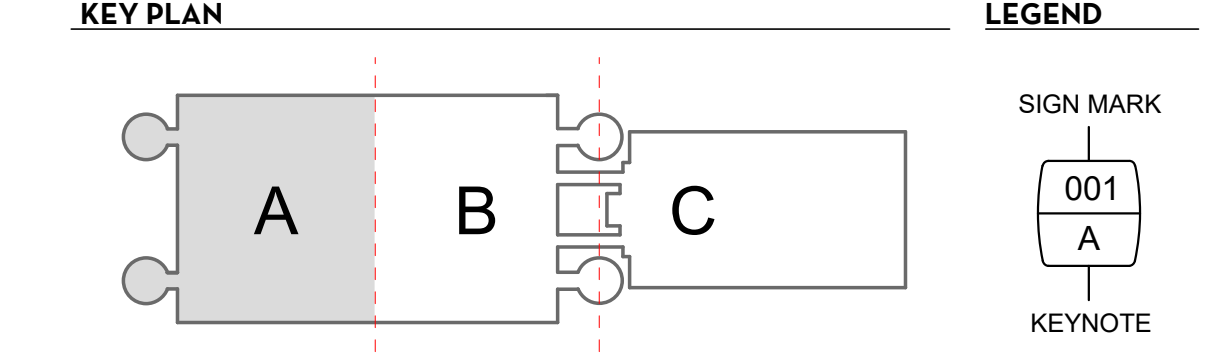\*\*\* NOTE \*\*\*  
 UNLESS NOTED OTHERWISE, ALL REMOVED SIGNS ARE TO BE REPLACED WITH A NEW SIGN



Client Name

ARCHITECT

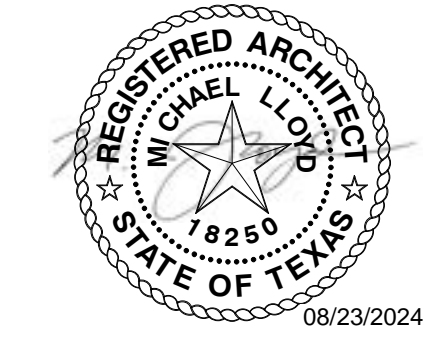


PGAL  
 3131 BRIARPARK DR.  
 SUITE 200  
 HOUSTON, TX 77042  
 [T] 713 622 1444  
 [F] 713 968 9333  
 www.pgal.com

BSG PRJCT#  
 BSG-2024-111-IAH

DEPARTMENT OF AVIATION  
 RECOMMENDED:  
 HOUSTON AIRPORT SYSTEM  
 DIRECTOR OR DESIGN REPRESENTATIVE  
 HAS TIP # 24-103 - IAH

REGISTRATION  
 Copyright © 2024



DRAWING HISTORY

NO.	DATE	DESCRIPTION
01	04/10/2024	ISSUE FOR PERMIT
02	08/23/2024	ISSUE FOR BID

PROJECT NAME  
 IAH TERMINAL C  
 GARAGE  
 SIGNAGE &  
 WAYFINDING

PROJECT LOCATION  
 TERMINAL C  
 3500 NORTH  
 TERMINAL RD.  
 HOUSTON, TX 77032

PROJECT NUMBER  
 1004395

SHEET TITLE  
 LEVEL 04 -  
 GARAGE-DEMO  
 PLAN - SECTOR A

SHEET NUMBER

AD2.04A.1

FILE NAME: C:\Revit\Locals\TERM C SIGNAGE GARAGE\_DBhatti@pgal.com.rvt  
 DATE/TIME: 8/23/2024 4:40:48 PM

IMAGE REFERENCE

IMAGE	MARK	NOTES	IMAGE	MARK	NOTES
	28	C		29	A
				30	A
				31	A
				32	A
				33	A
				34	C
				35	C

DEMO KEYNOTE

- A. EXISTING SURFACE MOUNTED SIGN(S) TO BE REMOVED, PATCH/REPAIR AS REQUIRED.
- B. EXISTING CEILING MOUNTED SIGN TO BE REMOVED, REMOVE SUSPENSION FRAME AND ATTACHMENTS FROM GARAGE STRUCTURAL CEILING. PATCH/REPAIR AS REQUIRED.
- C. EXISTING SIGN(S) / ACCESSORY TO REMAIN.
- D. EXISTING POLE MOUNTED SIGN TO BE REMOVED, PATCH/REPAIR AS REQUIRED.
- E. EXISTING TUBE STEEL AND SUPPORT TO BE REMOVED, PATCH/REPAIR FLOOR AS REQUIRED.
- F. CHEMICALLY STRIP OR SANDBLAST PAINT TO ORIGINAL BARE CONCRETE FINISH AND SKIM COAT WITH SIKA QUICK SMOOTH FINISH AT EXTERIOR WALL PERIMETER AT ELEVATOR AND STAIR CORES. TO BE PRIMED AND PAINTED.
- G. CHEMICALLY STRIP OR SANDBLAST PAINT TO ORIGINAL BARE CONCRETE FINISH AND SKIM COAT WITH SIKA QUICK SMOOTH FINISH AT ALL GARAGE COLUMNS ONLY. TO BE PRIMED AND PAINTED. REFER TO \*\* IN REGARDS TO APPROXIMATE COLUMN QUANTITY.

CLIENT



Client Name

ARCHITECT

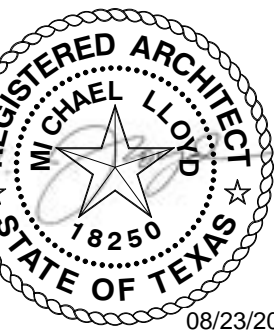


PGAL  
 3131 BRIARPARK DR.  
 SUITE 200  
 HOUSTON, TX 77042  
 [T] 713 622 1444  
 [F] 713 968 9333  
 www.pgal.com

BSG PRJCT#  
 BSG-2024-111-IAH

DEPARTMENT OF AVIATION  
 RECOMMENDED:  
 HOUSTON AIRPORT SYSTEM  
 DIRECTOR OR DESIGN REPRESENTATIVE  
 HAS TIP # 24-103 - IAH

REGISTRATION  
 Copyright © 2024



DRAWING HISTORY

NO.	DATE	DESCRIPTION
01	04/10/2024	ISSUE FOR PERMIT
02	08/23/2024	ISSUE FOR BID

PROJECT NAME  
 IAH TERMINAL C  
 GARAGE  
 SIGNAGE &  
 WAYFINDING

PROJECT LOCATION  
 TERMINAL C  
 3500 NORTH  
 TERMINAL RD.  
 HOUSTON, TX 77032


PROJECT NUMBER  
 1004395

SHEET TITLE  
 LEVEL 04 -  
 GARAGE-DEMO  
 PLAN - SECTOR A

SHEET NUMBER

AD2.04A.2

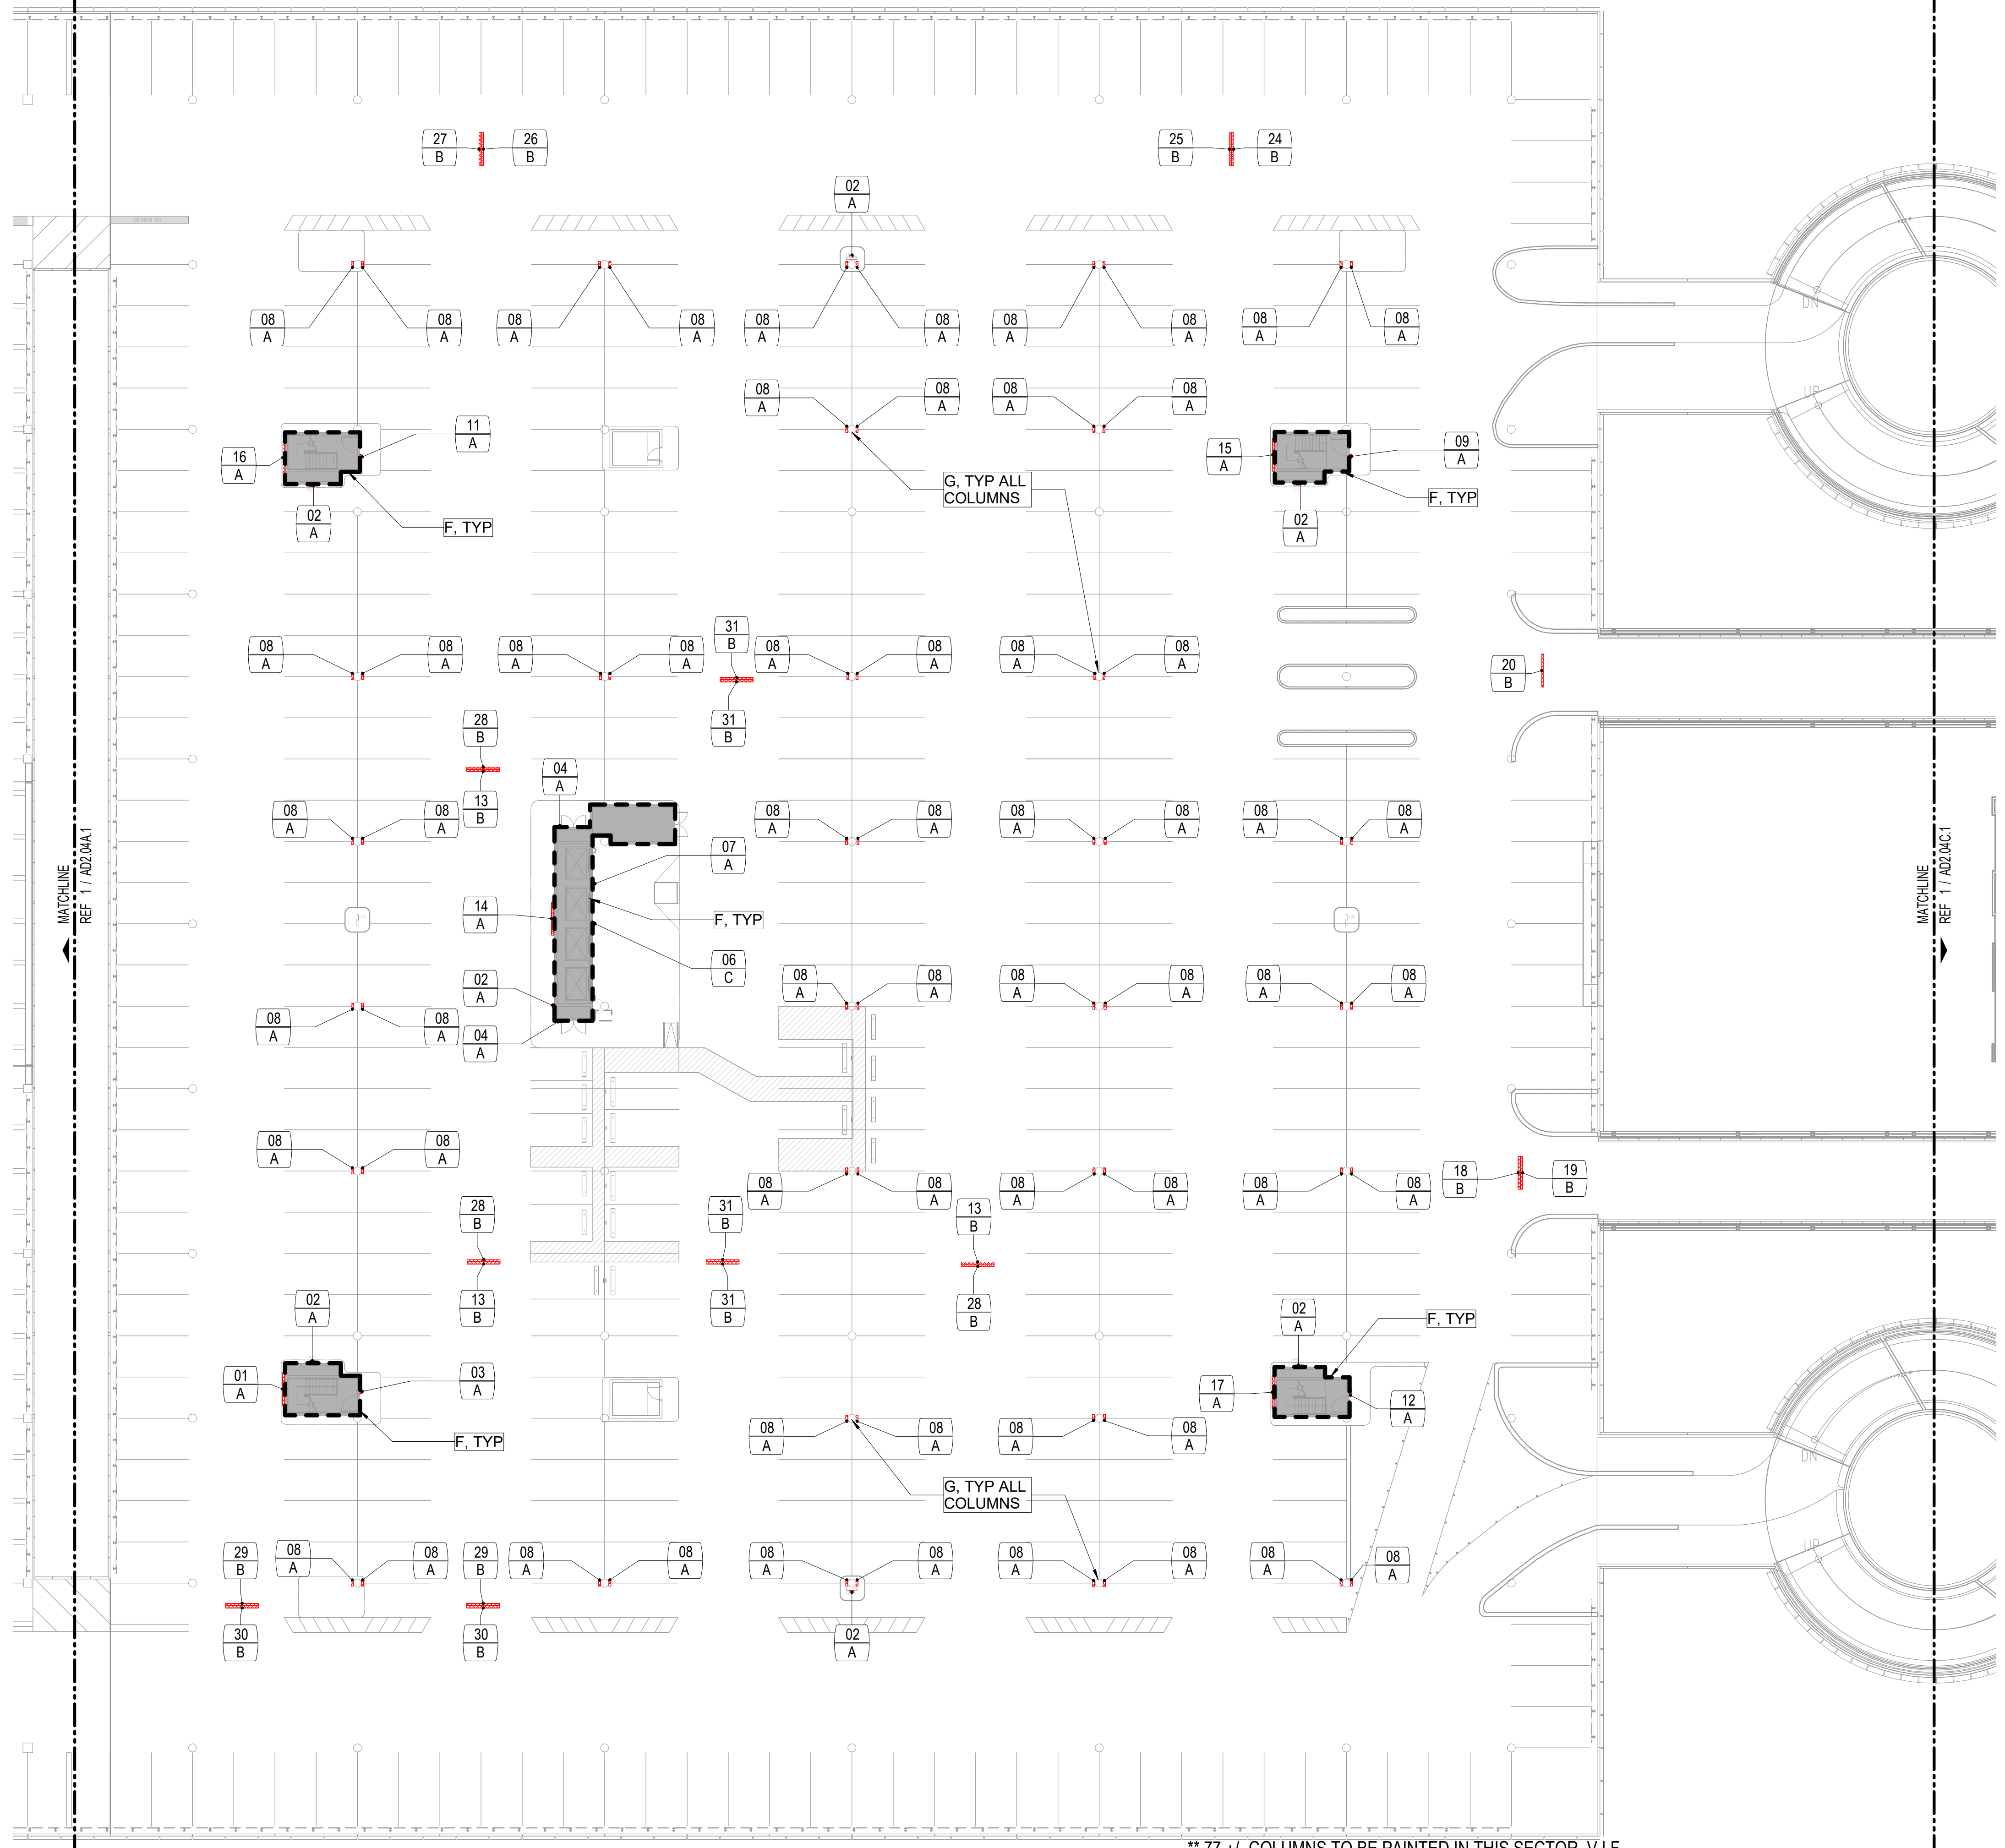FILE NAME: C:\Revit\Local\TERM C SIGNAGE GARAGE\_DBhatti@pgal.com.rvt  
 DATE/TIME: 4/8/2024 4:40:52 PM



\*\* 77 +/- COLUMNS TO BE PAINTED IN THIS SECTOR. V.I.F.  
 LEVEL 04 - DEMO PLAN - SECTOR B 3/64" = 1'-0" 1

IMAGE REFERENCE


IMAGE	MARK	NOTES
	01	A
	02	A
	03	A
	04	A

IMAGE	MARK	NOTES
	06	C

DEMO KEYNOTE

- A EXISTING SURFACE MOUNTED SIGN(S) TO BE REMOVED, PATCH/REPAIR AS REQUIRED.
- B EXISTING CEILING MOUNTED SIGN TO BE REMOVED, REMOVE SUSPENSION FRAME AND ATTACHMENTS FROM GARAGE STRUCTURAL CEILING. PATCH/REPAIR AS REQUIRED.
- C EXISTING SIGN(S) / ACCESSORY TO REMAIN.
- D EXISTING POLE MOUNTED SIGN TO BE REMOVED, PATCH/REPAIR AS REQUIRED.
- E EXISTING TUBE STEEL AND SUPPORT TO BE REMOVED, PATCH/REPAIR FLOOR AS REQUIRED.
- F CHEMICALLY STRIP OR SANDBLAST PAINT TO ORIGINAL BARE CONCRETE FINISH AND SKIM COAT WITH SIKA QUICK SMOOTH FINISH AT EXTERIOR WALL PERIMETER AT ELEVATOR AND STAIR CORES. TO BE PRIMED AND PAINTED.
- G CHEMICALLY STRIP OR SANDBLAST PAINT TO ORIGINAL BARE CONCRETE FINISH AND SKIM COAT WITH SIKA QUICK SMOOTH FINISH AT ALL GARAGE COLUMNS ONLY. TO BE PRIMED AND PAINTED. REFER TO "\*" IN REGARDS TO APPROXIMATE COLUMN QUANTITY.

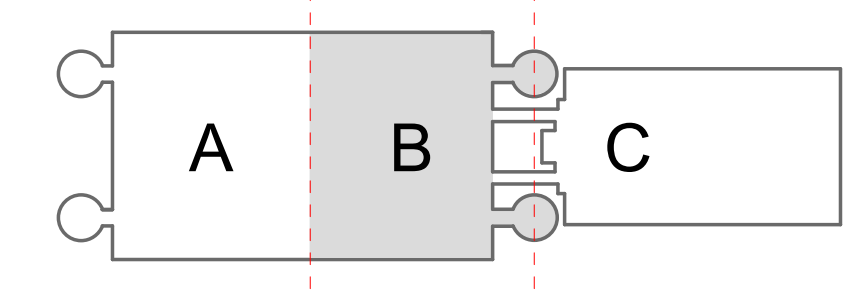KEY PLAN




1:256 SCALE




\*\*\* NOTE \*\*\*  
 UNLESS NOTED OTHERWISE, ALL REMOVED SIGNS ARE TO BE REPLACED WITH A NEW SIGN

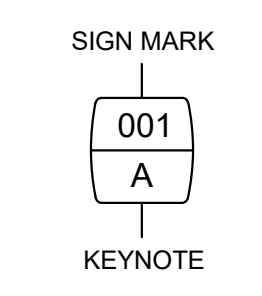LEGEND



PLAN NORTH

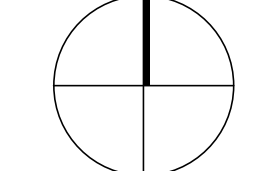

CLIENT



Client Name

ARCHITECT



PGAL  
 3131 BRIARPARK DR.  
 SUITE 200  
 HOUSTON, TX 77042  
 [T] 713 622 1444  
 [F] 713 968 9333  
 www.pgal.com

BSG PRJCT#  
 BSG-2024-111-IAH

DEPARTMENT OF AVIATION  
 RECOMMENDED:  
 HOUSTON AIRPORT SYSTEM  
 DIRECTOR OR DESIGN REPRESENTATIVE  
 HAS TIP # 24-103 - IAH

REGISTRATION  
 Copyright © 2024



DRAWING HISTORY

NO.	DATE	DESCRIPTION
01	04/10/2024	ISSUE FOR PERMIT
02	08/23/2024	ISSUE FOR BID

PROJECT NAME  
 IAH TERMINAL C  
 GARAGE  
 SIGNAGE &  
 WAYFINDING

PROJECT LOCATION  
 TERMINAL C  
 3500 NORTH  
 TERMINAL RD.  
 HOUSTON, TX 77032

PROJECT NUMBER  
 1004395

SHEET TITLE  
 LEVEL 04 - GARAGE  
 DEMO PLAN -  
 SECTOR B

SHEET NUMBER

AD2.04B.1



FILE NAME: C:\Revit\Locals\TERM C SIGNAGE GARAGE\_DBhatti@pgal.com.rvt  
 DATE/TIME: 8/23/2024 4:40:53 PM

IMAGE REFERENCE





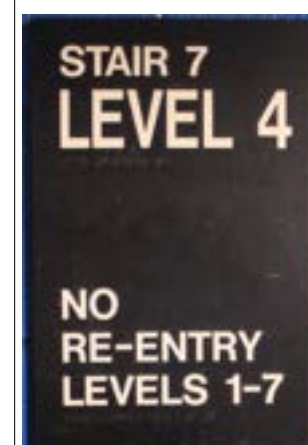


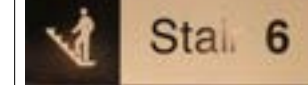
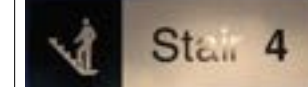
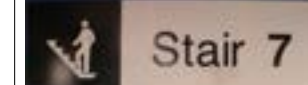











IMAGE	MARK	NOTES
	07	A
	08	A
	09	A
	11	A

IMAGE	MARK	NOTES
	12	A
	13	B
	14	A
	15	A
	16	A
	17	A
	18	B
	19	B
	20	B
	24	B
	25	B
	26	B
	27	B
	28	B
	29	B
	30	B
	31	B

DEMO KEYNOTE

- A EXISTING SURFACE MOUNTED SIGN(S) TO BE REMOVED, PATCH/REPAIR AS REQUIRED.
- B EXISTING CEILING MOUNTED SIGN TO BE REMOVED, REMOVE SUSPENSION FRAME AND ATTACHMENTS FROM GARAGE STRUCTURAL CEILING. PATCH/REPAIR AS REQUIRED.
- C EXISTING SIGN(S) / ACCESSORY TO REMAIN.
- D EXISTING POLE MOUNTED SIGN TO BE REMOVED, PATCH/REPAIR AS REQUIRED.
- E EXISTING TUBE STEEL AND SUPPORT TO BE REMOVED, PATCH/REPAIR FLOOR AS REQUIRED.
- F CHEMICALLY STRIP OR SANDBLAST PAINT TO ORIGINAL BARE CONCRETE FINISH AND SKIM COAT WITH SIKA QUICK SMOOTH FINISH AT EXTERIOR WALL PERIMETER AT ELEVATOR AND STAIR CORES. TO BE PRIMED AND PAINTED.
- G CHEMICALLY STRIP OR SANDBLAST PAINT TO ORIGINAL BARE CONCRETE FINISH AND SKIM COAT WITH SIKA QUICK SMOOTH FINISH AT ALL GARAGE COLUMNS ONLY. TO BE PRIMED AND PAINTED. REFER TO "" IN REGARDS TO APPROXIMATE COLUMN QUANTITY.

CLIENT



Client Name

ARCHITECT



PGAL  
 3131 BRIARPARK DR.  
 SUITE 200  
 HOUSTON, TX 77042  
 [T] 713 622 1444  
 [F] 713 968 9333  
 www.pgal.com

BSG PRJCT#  
 BSG-2024-111-IAH

DEPARTMENT OF AVIATION  
 RECOMMENDED:  
 HOUSTON AIRPORT SYSTEM  
 DIRECTOR OR DESIGN REPRESENTATIVE  
 HAS TIP # 24-103 - IAH

REGISTRATION  
 Copyright © 2024



DRAWING HISTORY

NO.	DATE	DESCRIPTION
01	04/10/2024	ISSUE FOR PERMIT
02	08/23/2024	ISSUE FOR BID

PROJECT NAME

IAH TERMINAL C  
 GARAGE  
 SIGNAGE &  
 WAYFINDING

PROJECT LOCATION

TERMINAL C  
 3500 NORTH  
 TERMINAL RD.  
 HOUSTON, TX 77032

PROJECT NUMBER

1004395

SHEET TITLE


LEVEL 04 - GARAGE  
 DEMO PLAN -  
 SECTOR B

SHEET NUMBER

AD2.04B.2



NO.	DATE	DESCRIPTION
01	04/10/2024	ISSUE FOR PERMIT
02	08/23/2024	ISSUE FOR BID

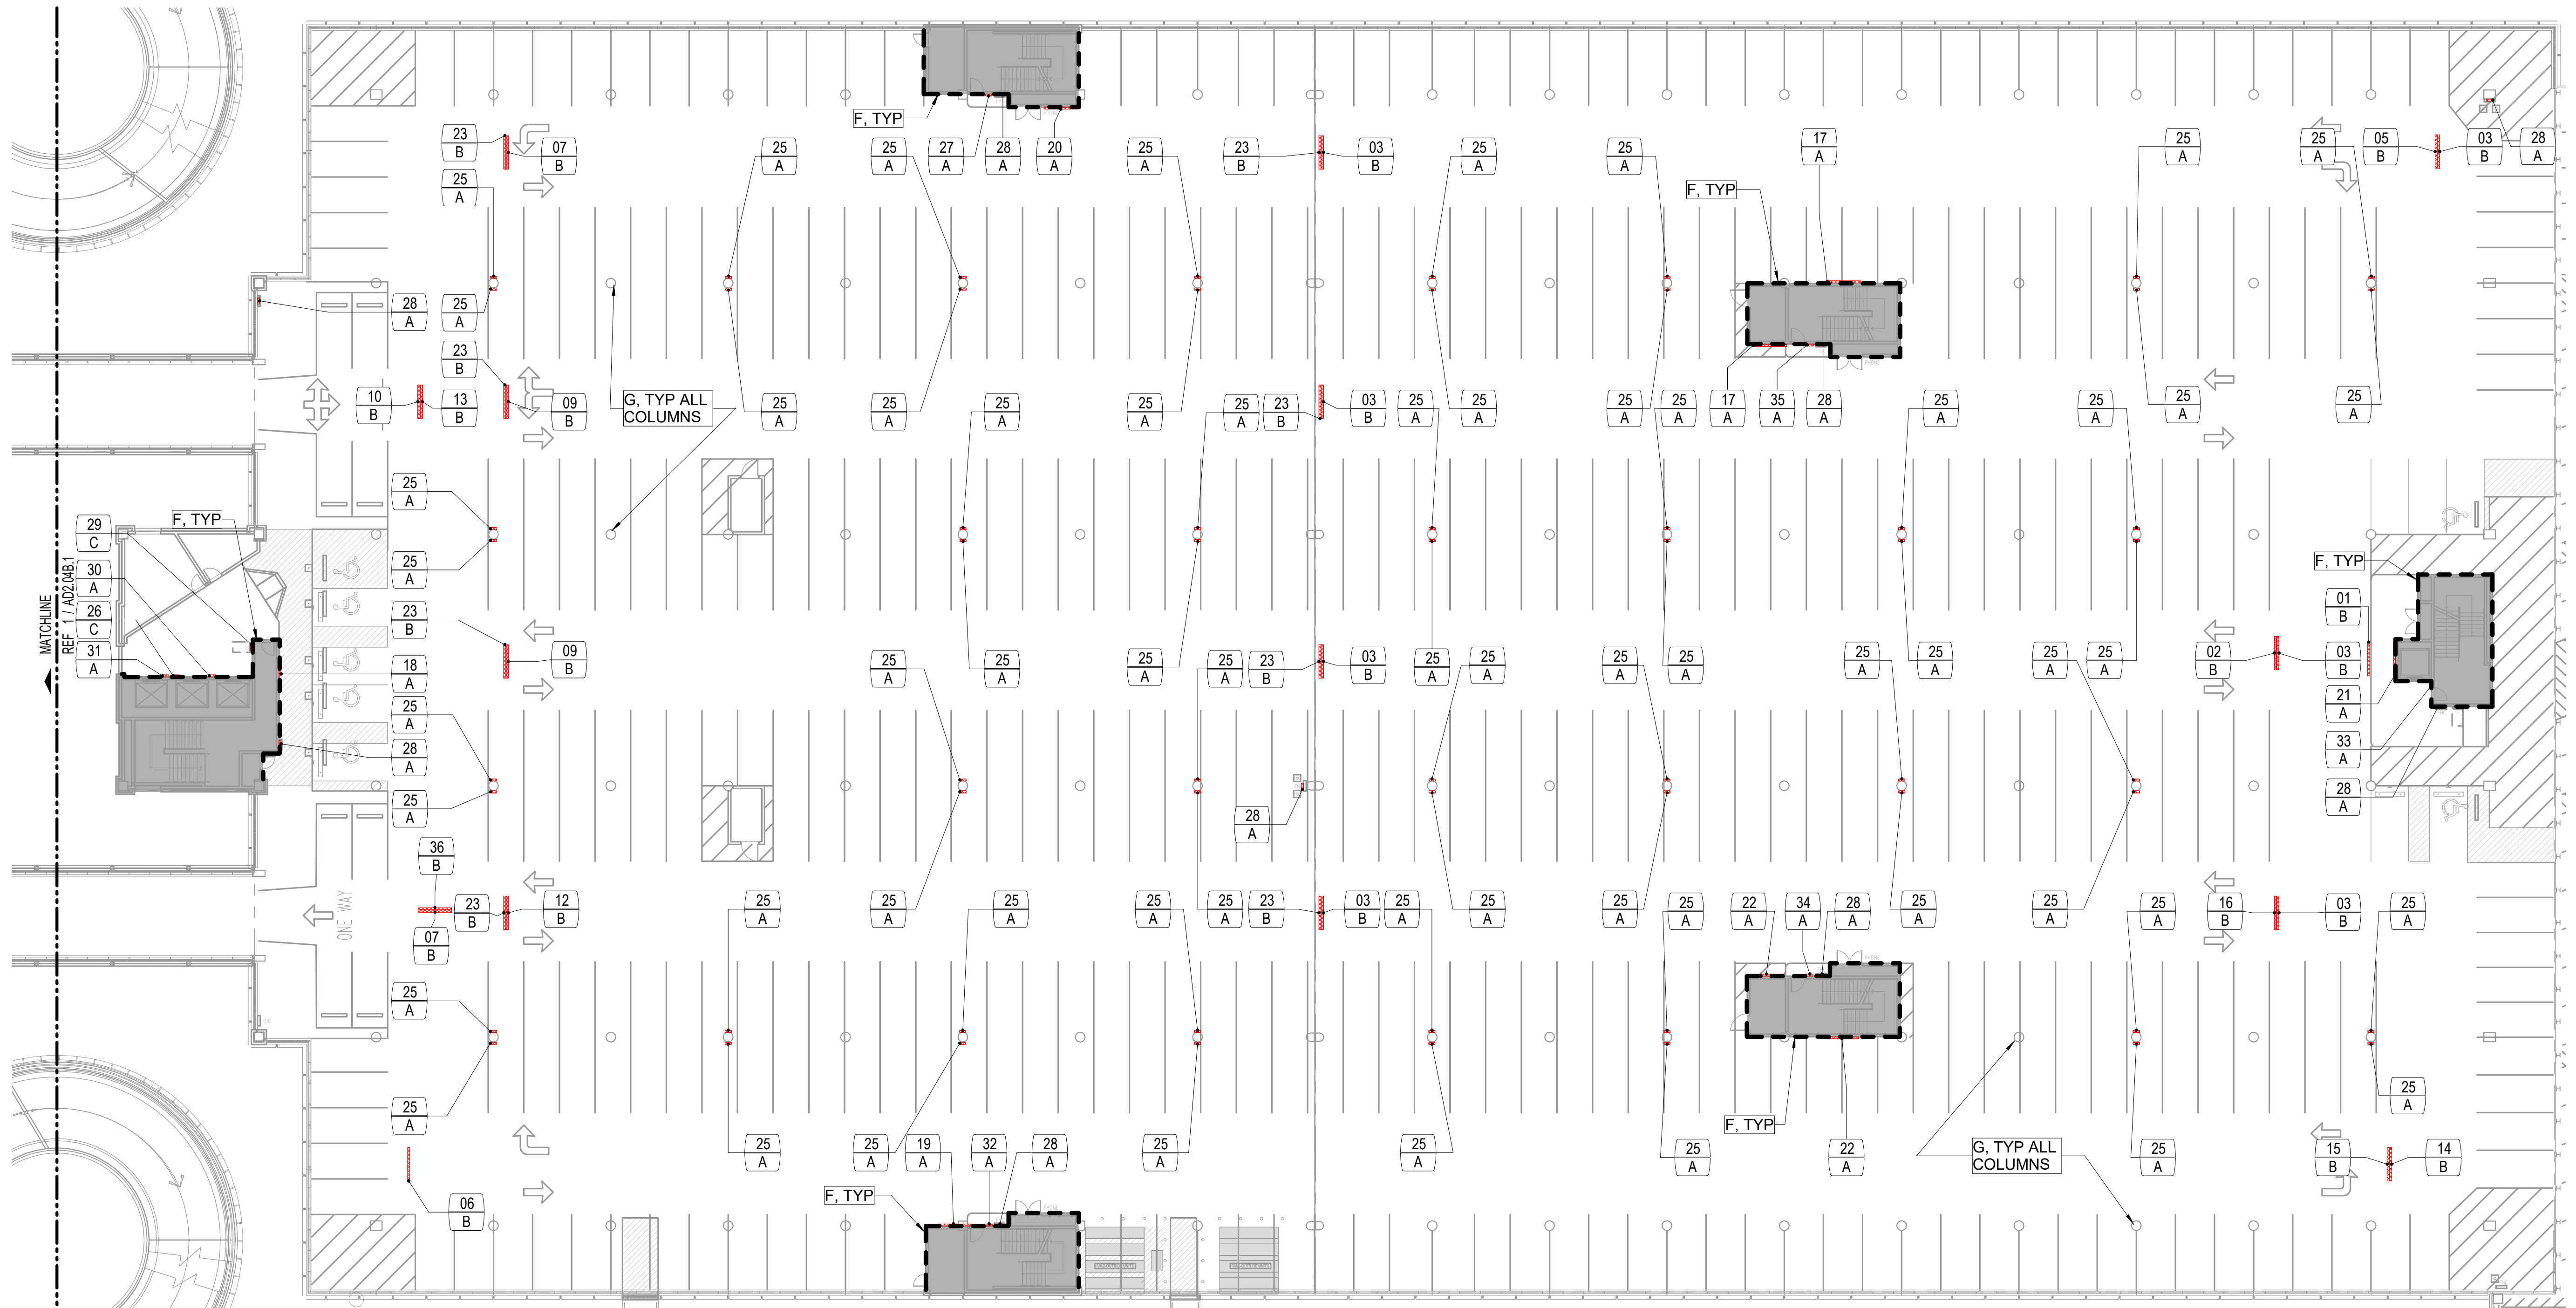


\*\* 114 +/- COLUMNS TO BE PAINTED IN THIS SECTOR, V.I.F.  
**LEVEL 04 - DEMO PLAN - SECTOR C** 3/64" = 1'-0" 1

**DEMO KEYNOTE**

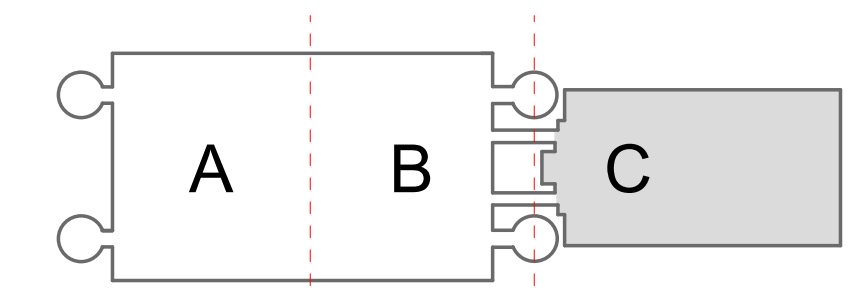
- A EXISTING SURFACE MOUNTED SIGN(S) TO BE REMOVED, PATCH/REPAIR AS REQUIRED.
- B EXISTING CEILING MOUNTED SIGN TO BE REMOVED, REMOVE SUSPENSION FRAME AND ATTACHMENTS FROM GARAGE STRUCTURAL CEILING, PATCH/REPAIR AS REQUIRED.
- C EXISTING SIGN(S)/ ACCESSORY TO REMAIN.
- D EXISTING POLE MOUNTED SIGN TO BE REMOVED, PATCH/REPAIR AS REQUIRED.
- E EXISTING TUBE STEEL AND SUPPORT TO BE REMOVED, PATCH/REPAIR FLOOR AS REQUIRED.
- F CHEMICALLY STRIP OR SANDBLAST PAINT TO ORIGINAL BARE CONCRETE FINISH AND SKIM COAT WITH SIKA QUICK SMOOTH FINISH AT EXTERIOR WALL PERIMETER AT ELEVATOR AND STAIR CORES. TO BE PRIMED AND PAINTED.
- G CHEMICALLY STRIP OR SANDBLAST PAINT TO ORIGINAL BARE CONCRETE FINISH AND SKIM COAT WITH SIKA QUICK SMOOTH FINISH AT ALL GARAGE COLUMNS ONLY. TO BE PRIMED AND PAINTED. REFER TO "\*" IN REGARDS TO APPROXIMATE COLUMN QUANTITY.

\*\*\* NOTE \*\*\*  
 UNLESS NOTED OTHERWISE, ALL REMOVED SIGNS ARE TO BE REPLACED WITH A NEW SIGN


**KEY PLAN**




1:256 SCALE

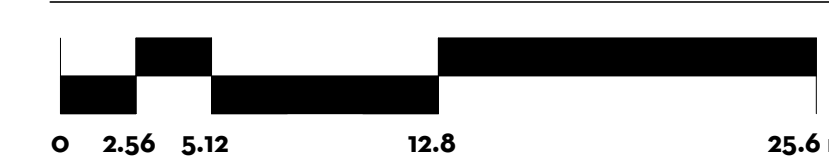

**LEGEND**

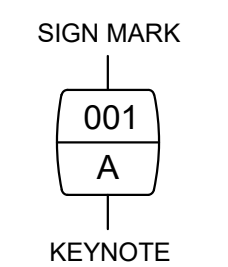

**PLAN NORTH**

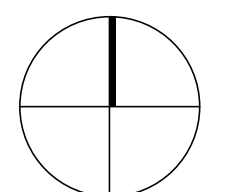

FILE NAME: C:\Revit\Locals\TERM C SIGNAGE GARAGE\_DBhatti@pgal.com.rvt  
 DATE/TIME: 8/23/2024 4:40:59 PM

IMAGE	MARK	NOTES
	01	B
	02	B
	03	B
	05	B
	06	B
	07	B
	09	B
	10	B
	12	B
	13	B
	14	B
	15	B
	16	B
	17	A
	18	A
	19	A
	20	A
	21	A
	22	A
	23	B
	25	A

IMAGE REFERENCE

IMAGE	MARK	NOTES
	26	C
	27	A
	28	A
	29	C
	30	A
	31	A
	32	A
	33	A
	34	A
	35	A
	36	B

DEMO KEYNOTE

- A EXISTING SURFACE MOUNTED SIGN(S) TO BE REMOVED, PATCH/REPAIR AS REQUIRED.
- B EXISTING CEILING MOUNTED SIGN TO BE REMOVED, REMOVE SUSPENSION FRAME AND ATTACHMENTS FROM GARAGE STRUCTURAL CEILING. PATCH/REPAIR AS REQUIRED.
- C EXISTING SIGN(S) / ACCESSORY TO REMAIN.
- D EXISTING POLE MOUNTED SIGN TO BE REMOVED, PATCH/REPAIR AS REQUIRED.
- E EXISTING TUBE STEEL AND SUPPORT TO BE REMOVED, PATCH/REPAIR FLOOR AS REQUIRED.
- F CHEMICALLY STRIP OR SANDBLAST PAINT TO ORIGINAL BARE CONCRETE FINISH AND SKIM COAT WITH SIKA QUICK SMOOTH FINISH AT EXTERIOR WALL PERIMETER AT ELEVATOR AND STAIR CORES. TO BE PRIMED AND PAINTED.
- G CHEMICALLY STRIP OR SANDBLAST PAINT TO ORIGINAL BARE CONCRETE FINISH AND SKIM COAT WITH SIKA QUICK SMOOTH FINISH AT ALL GARAGE COLUMNS ONLY. TO BE PRIMED AND PAINTED. REFER TO \*\* IN REGARDS TO APPROXIMATE COLUMN QUANTITY.

CLIENT



Client Name

ARCHITECT



PGAL  
 3131 BRIARPARK DR.  
 SUITE 200  
 HOUSTON, TX 77042  
 [T] 713 622 1444  
 [F] 713 968 9333  
 www.pgal.com

BSG PRJCT#  
 BSG-2024-111-IAH

DEPARTMENT OF AVIATION  
 RECOMMENDED:  
 HOUSTON AIRPORT SYSTEM  
 DIRECTOR OR DESIGN REPRESENTATIVE  
 HAS TIP # 24-103 - IAH

REGISTRATION  
 Copyright © 2024



DRAWING HISTORY

NO.	DATE	DESCRIPTION
01	04/10/2024	ISSUE FOR PERMIT
02	08/23/2024	ISSUE FOR BID

PROJECT NAME  
 IAH TERMINAL C  
 GARAGE  
 SIGNAGE &  
 WAYFINDING

PROJECT LOCATION  
 TERMINAL C  
 3500 NORTH  
 TERMINAL RD.  
 HOUSTON, TX 77032

PROJECT NUMBER  
 1004395

SHEET TITLE  
 LEVEL 04 - GARAGE  
 DEMO PLAN -  
 SECTOR C

SHEET NUMBER

AD2.04C.2

FILE NAME: C:\Revit\Locals\TERM C SIGNAGE GARAGE\_DBhatti@pgal.com.rvt  
 DATE/TIME: 8/23/2024 4:41:06 PM

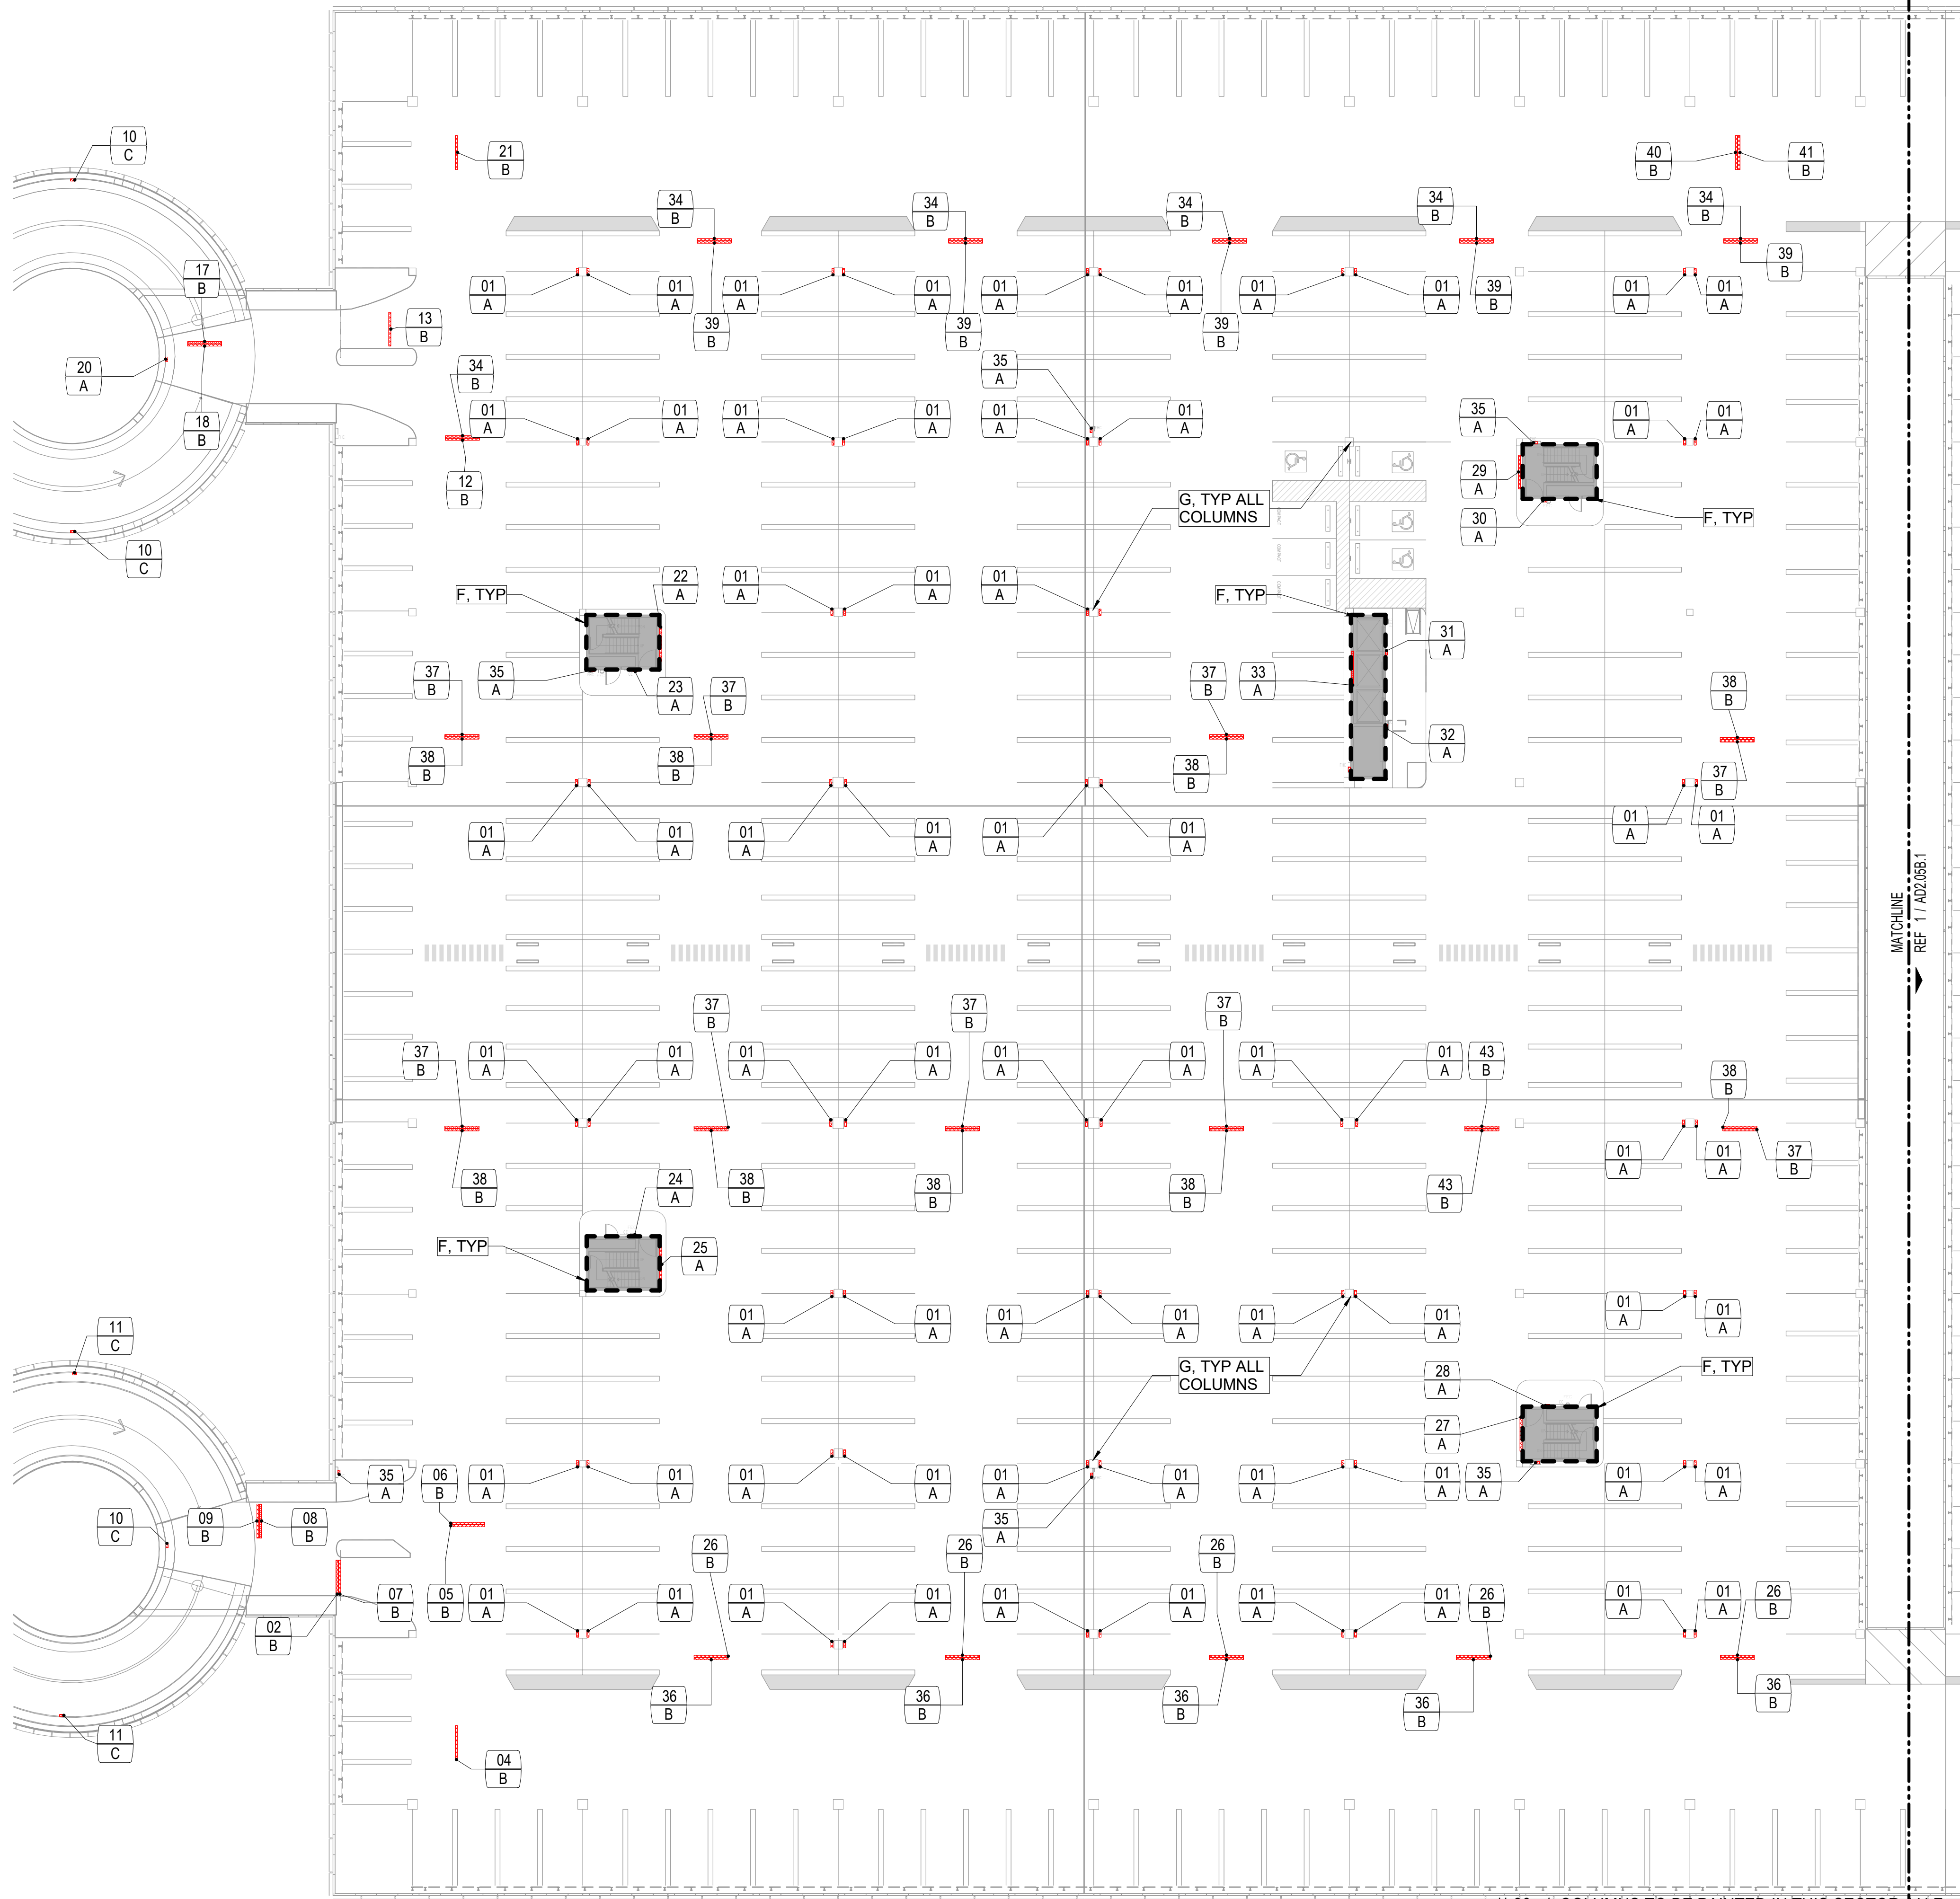


IMAGE REFERENCE

IMAGE	MARK	NOTES
	01	A
	02	B
	04	B
	05	B
	06	B
	07	B
	08	B
	09	B
	10	C
	11	C
	12	B
	13	B
	17	B
	18	B


IMAGE	MARK	NOTES
	20	A
	21	B
	22	A
	23	A
	24	A
	25	A
	26	B
	27	A
	35	A

DEMO KEYNOTE


- A EXISTING SURFACE MOUNTED SIGN(S) TO BE REMOVED, PATCH/REPAIR AS REQUIRED.
- B EXISTING CEILING MOUNTED SIGN TO BE REMOVED, REMOVE SUSPENSION FRAME AND ATTACHMENTS FROM GARAGE STRUCTURAL CEILING. PATCH/REPAIR AS REQUIRED.
- C EXISTING SIGN(S) / ACCESSORY TO REMAIN.
- D EXISTING POLE MOUNTED SIGN TO BE REMOVED, PATCH/REPAIR AS REQUIRED.
- E EXISTING TUBE STEEL AND SUPPORT TO BE REMOVED, PATCH/REPAIR FLOOR AS REQUIRED.
- F CHEMICALLY STRIP OR SANDBLAST PAINT TO ORIGINAL BARE CONCRETE FINISH AND SKIM COAT WITH SIKA QUICK SMOOTH FINISH AT EXTERIOR WALL PERIMETER AT ELEVATOR AND STAIR CORES. TO BE PRIMED AND PAINTED.
- G CHEMICALLY STRIP OR SANDBLAST PAINT TO ORIGINAL BARE CONCRETE FINISH AND SKIM COAT WITH SIKA QUICK SMOOTH FINISH AT ALL GARAGE COLUMNS ONLY. TO BE PRIMED AND PAINTED. REFER TO \*\* IN REGARDS TO APPROXIMATE COLUMN QUANTITY.

\*\*\* NOTE \*\*\*  
 UNLESS NOTED OTHERWISE, ALL REMOVED SIGNS ARE TO BE REPLACED WITH A NEW SIGN

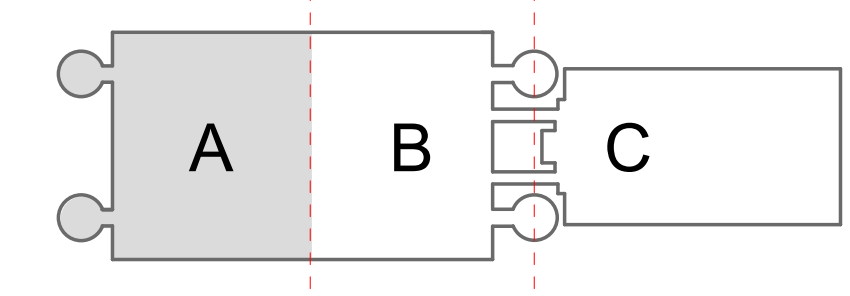KEY PLAN



1:256 SCALE

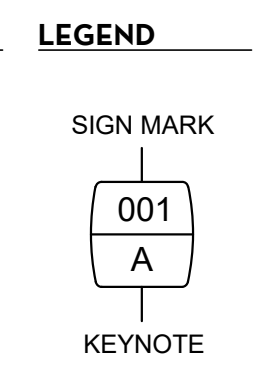

PLAN NORTH

\*\* 80 +/- COLUMNS TO BE PAINTED IN THIS SECTOR. M.I.F.  
 LEVEL 05 - DEMO PLAN - SECTOR A 3/64" = 1'-0" 1

CLIENT



Client Name

ARCHITECT

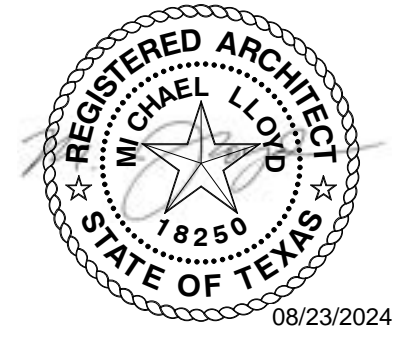


PGAL  
 3131 BRIARPARK DR.  
 SUITE 200  
 HOUSTON, TX 77042  
 [T] 713 622 1444  
 [F] 713 968 9333  
 www.pgal.com

BSG PRJCT#  
 BSG-2024-111-IAH

DEPARTMENT OF AVIATION  
 RECOMMENDED:  
 HOUSTON AIRPORT SYSTEM  
 DIRECTOR OR DESIGN REPRESENTATIVE  
 HAS TIP # 24-103 - IAH

REGISTRATION  
 Copyright © 2024



DRAWING HISTORY

NO.	DATE	DESCRIPTION
01	04/10/2024	ISSUE FOR PERMIT
02	08/23/2024	ISSUE FOR BID

PROJECT NAME  
 IAH TERMINAL C  
 GARAGE  
 SIGNAGE &  
 WAYFINDING

PROJECT LOCATION  
 TERMINAL C  
 3500 NORTH  
 TERMINAL RD.  
 HOUSTON, TX 77032

PROJECT NUMBER  
 1004395

SHEET TITLE  
 LEVEL 05 - GARAGE  
 DEMO PLAN -  
 SECTOR A

SHEET NUMBER

AD2.05A.1

FILE NAME: C:\Revit\Locals\TERM C SIGNAGE GARAGE\_DBhatti@pgal.com.rvt  
 DATE/TIME: 8/23/2024 4:41:11 PM

IMAGE REFERENCE

IMAGE	MARK	NOTES
	28	A
	29	A
	30	A
	31	A
	32	A
	33	A
	34	B
	35	A
	36	B
	37	B
	38	B
	39	B
	40	B
	41	B
	43	B

DEMO KEYNOTE

- A. EXISTING SURFACE MOUNTED SIGN(S) TO BE REMOVED, PATCH/REPAIR AS REQUIRED.
- B. EXISTING CEILING MOUNTED SIGN TO BE REMOVED, REMOVE SUSPENSION FRAME AND ATTACHMENTS FROM GARAGE STRUCTURAL CEILING. PATCH/REPAIR AS REQUIRED.
- C. EXISTING SIGN(S) / ACCESSORY TO REMAIN.
- D. EXISTING POLE MOUNTED SIGN TO BE REMOVED, PATCH/REPAIR AS REQUIRED.
- E. EXISTING TUBE STEEL AND SUPPORT TO BE REMOVED, PATCH/REPAIR FLOOR AS REQUIRED.
- F. CHEMICALLY STRIP OR SANDBLAST PAINT TO ORIGINAL BARE CONCRETE FINISH AND SKIM COAT WITH SIKA QUICK SMOOTH FINISH AT EXTERIOR WALL PERIMETER AT ELEVATOR AND STAIR CORES. TO BE PRIMED AND PAINTED.
- G. CHEMICALLY STRIP OR SANDBLAST PAINT TO ORIGINAL BARE CONCRETE FINISH AND SKIM COAT WITH SIKA QUICK SMOOTH FINISH AT ALL GARAGE COLUMNS ONLY. TO BE PRIMED AND PAINTED. REFER TO "\*" IN REGARDS TO APPROXIMATE COLUMN QUANTITY.

CLIENT



Client Name

ARCHITECT



PGAL  
 3131 BRIARPARK DR.  
 SUITE 200  
 HOUSTON, TX 77042  
 [T] 713 622 1444  
 [F] 713 968 9333  
 www.pgal.com

BSG PRJCT#  
 BSG-2024-111-IAH

DEPARTMENT OF AVIATION  
 RECOMMENDED:  
 HOUSTON AIRPORT SYSTEM  
 DIRECTOR OR DESIGN REPRESENTATIVE  
 HAS TIP # 24-103 - IAH

REGISTRATION  
 Copyright © 2024



DRAWING HISTORY

NO.	DATE	DESCRIPTION
01	04/10/2024	ISSUE FOR PERMIT
02	08/23/2024	ISSUE FOR BID

PROJECT NAME

IAH TERMINAL C  
 GARAGE  
 SIGNAGE &  
 WAYFINDING

PROJECT LOCATION

TERMINAL C  
 3500 NORTH  
 TERMINAL RD.  
 HOUSTON, TX 77032

PROJECT NUMBER


1004395

SHEET TITLE

LEVEL 05 - GARAGE  
 DEMO PLAN -  
 SECTOR A

SHEET NUMBER

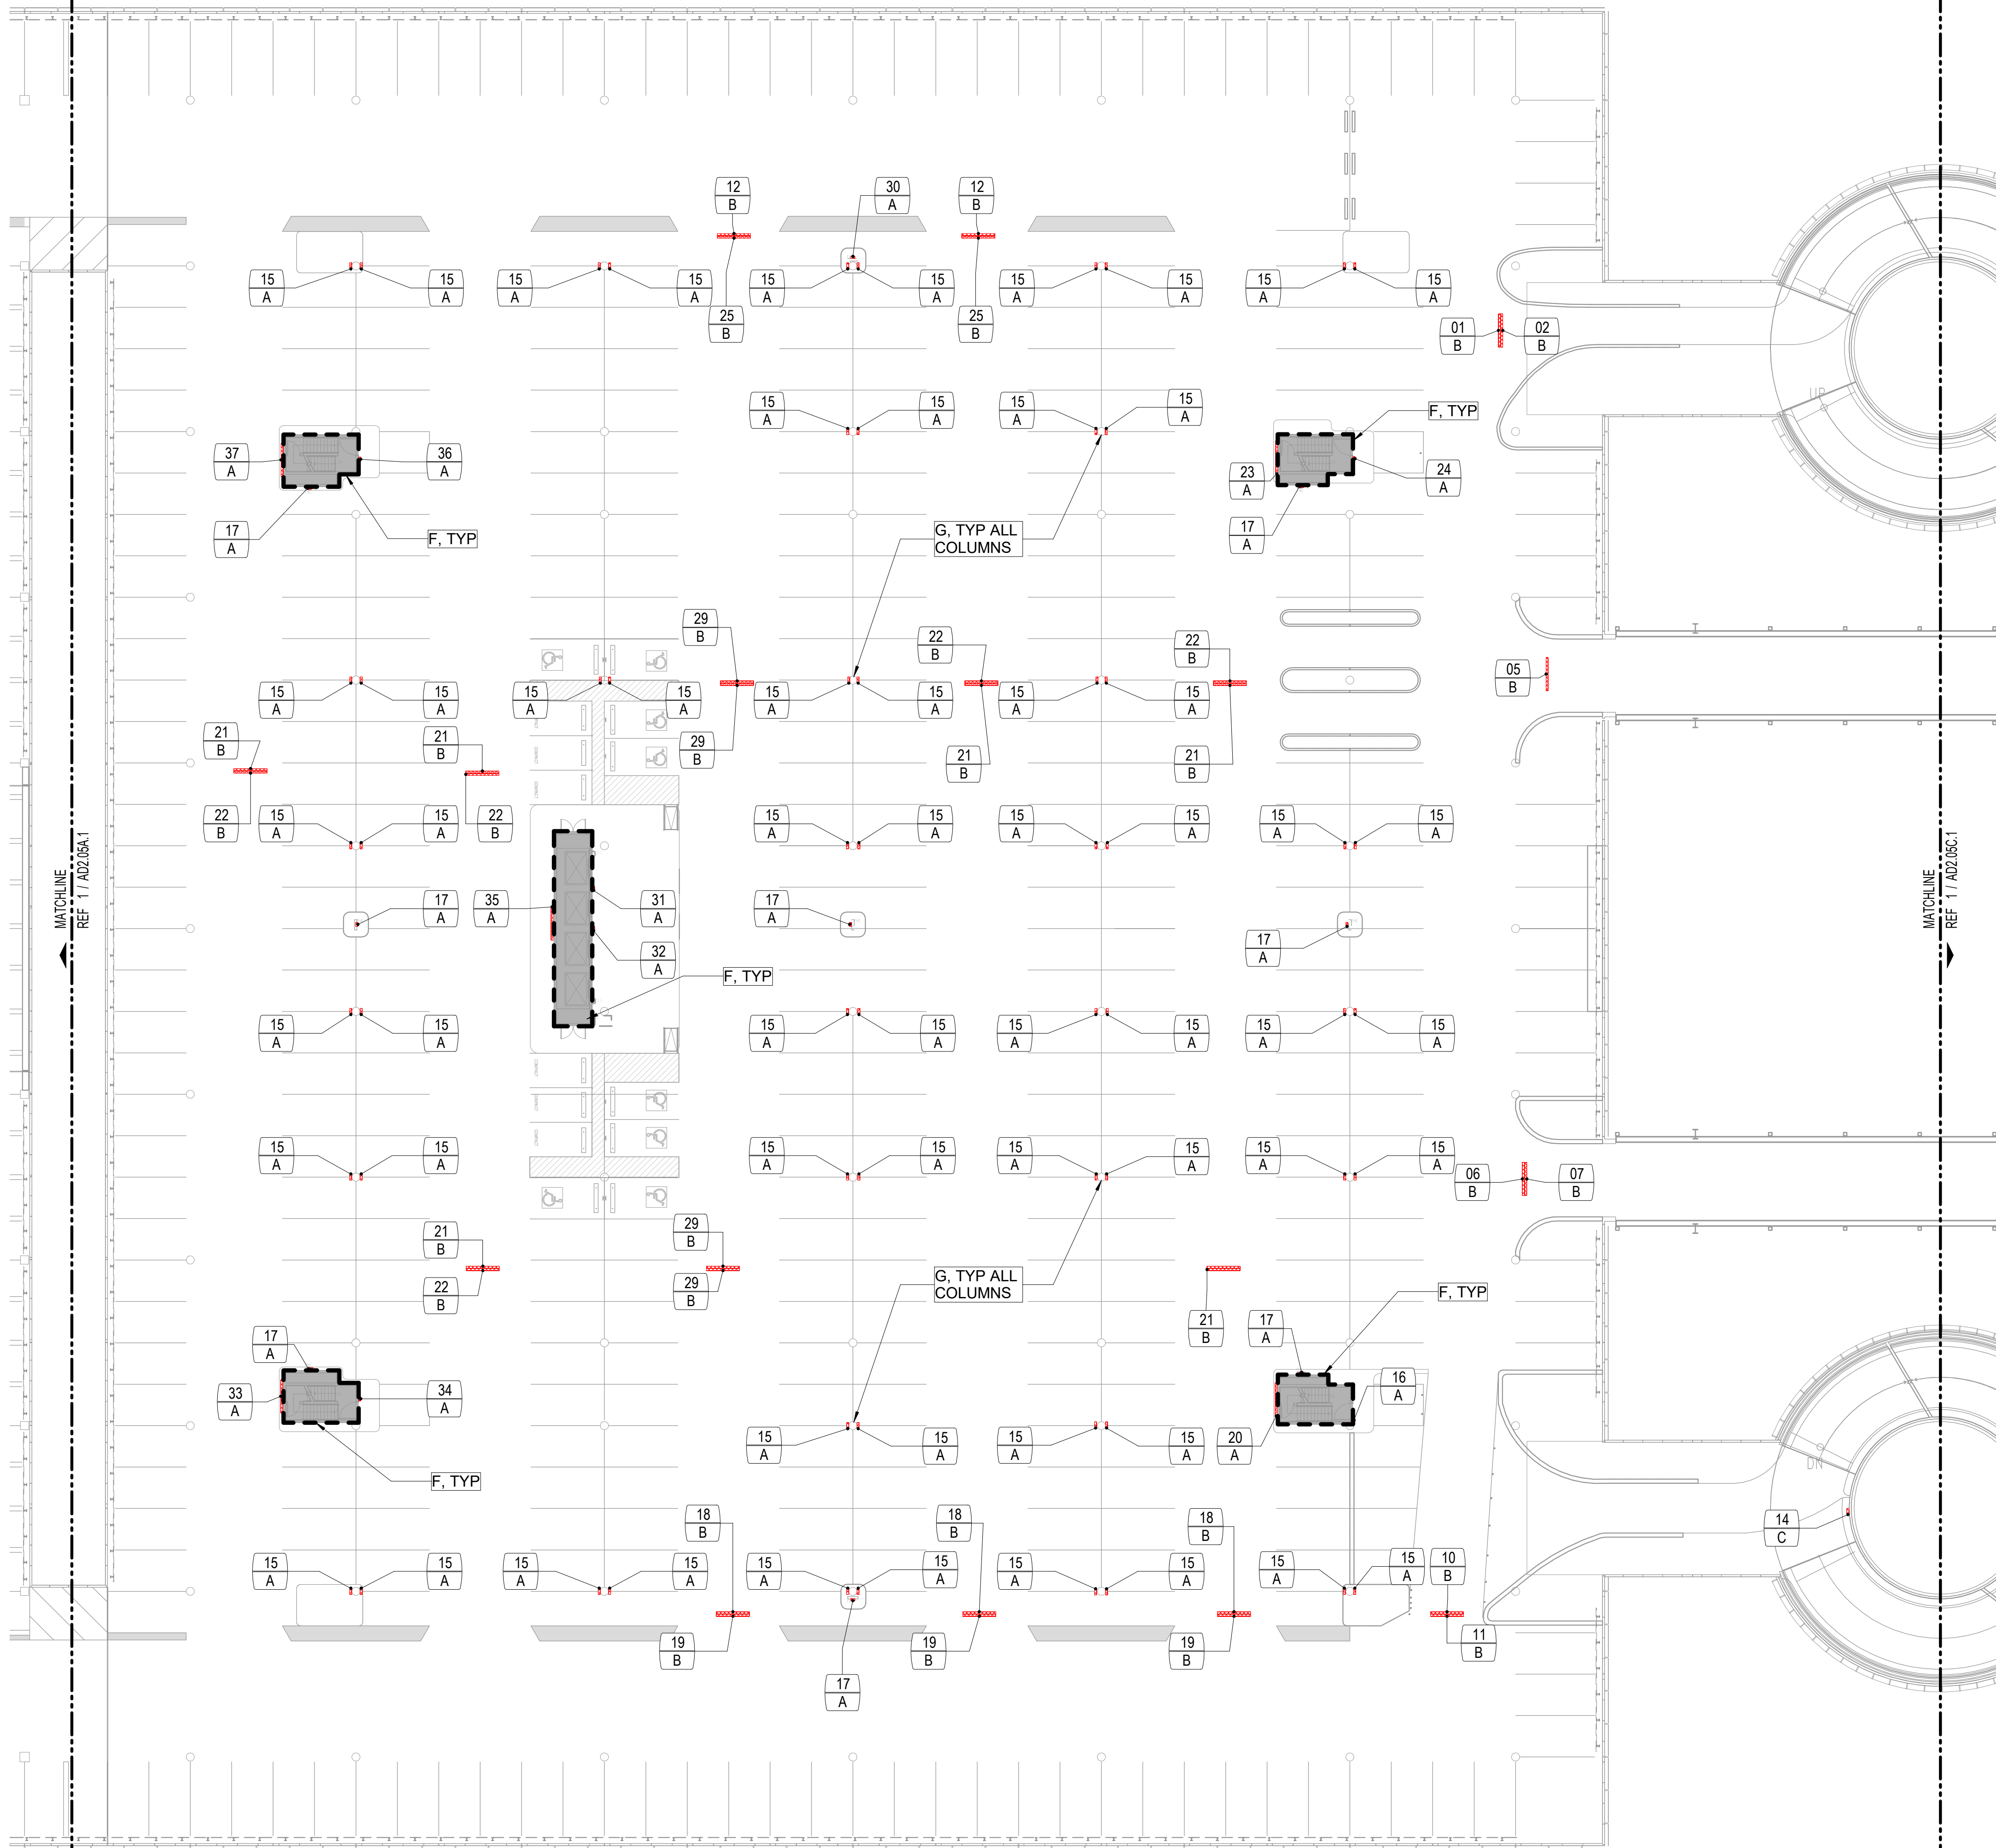AD2.05A.2



\*\* 77 +/- COLUMNS TO BE PAINTED IN THIS SECTOR, V.I.F.  
 LEVEL 05 - DEMO PLAN - SECTOR B 3/64" = 1'-0" 1

IMAGE REFERENCE

IMAGE	MARK	NOTES
	01	B
	02	B
	05	B
	06	B
	07	B
	10	B
	11	B
	12	B
	14	C
	15	A
	16	A
	17	A
	18	B

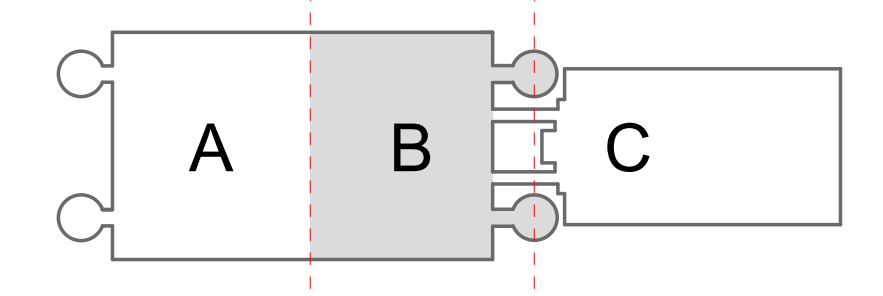
  

IMAGE	MARK	NOTES
	19	B
	20	A
	21	B
	22	B
	23	A
	24	A
	25	B
	29	B

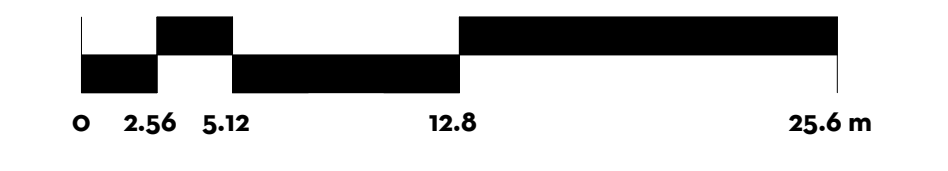
DEMO KEYNOTE

- A EXISTING SURFACE MOUNTED SIGN(S) TO BE REMOVED, PATCH/REPAIR AS REQUIRED.
- B EXISTING CEILING MOUNTED SIGN TO BE REMOVED, REMOVE SUSPENSION FRAME AND ATTACHMENTS FROM GARAGE STRUCTURAL CEILING. PATCH/REPAIR AS REQUIRED.
- C EXISTING SIGN(S) / ACCESSORY TO REMAIN.
- D EXISTING POLE MOUNTED SIGN TO BE REMOVED, PATCH/REPAIR AS REQUIRED.
- E EXISTING TUBE STEEL AND SUPPORT TO BE REMOVED, PATCH/REPAIR FLOOR AS REQUIRED.
- F CHEMICALLY STRIP OR SANDBLAST PAINT TO ORIGINAL BARE CONCRETE FINISH AND SKIM COAT WITH SIKA QUICK SMOOTH FINISH AT EXTERIOR WALL PERIMETER AT ELEVATOR AND STAIR CORES. TO BE PRIMED AND PAINTED.
- G CHEMICALLY STRIP OR SANDBLAST PAINT TO ORIGINAL BARE CONCRETE FINISH AND SKIM COAT WITH SIKA QUICK SMOOTH FINISH AT ALL GARAGE COLUMNS ONLY. TO BE PRIMED AND PAINTED. REFER TO \*\* IN REGARDS TO APPROXIMATE COLUMN QUANTITY.

KEY PLAN




1:256 SCALE




\*\*\* NOTE \*\*\*  
 UNLESS NOTED OTHERWISE, ALL REMOVED SIGNS ARE TO BE REPLACED WITH A NEW SIGN

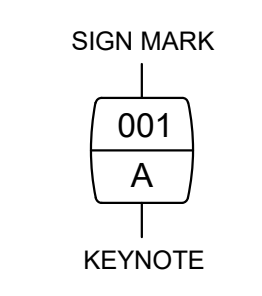LEGEND



PLAN NORTH

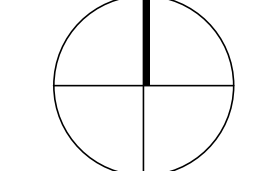

CLIENT  
  
 HOUSTON AIRPORTS  
 Client Name

ARCHITECT  
  
 PGAL  
 3131 BRIARPARK DR.  
 SUITE 200  
 HOUSTON, TX 77042  
 [T] 713 622 1444  
 [F] 713 968 9333  
 www.pgal.com

BSG PRJCT#  
 BSG-2024-111-IAH  
 DEPARTMENT OF AVIATION  
 RECOMMENDED:  
 HOUSTON AIRPORT SYSTEM  
 DIRECTOR OR DESIGN REPRESENTATIVE  
 HAS TIP # 24-103 - IAH

REGISTRATION  
 Copyright © 2024






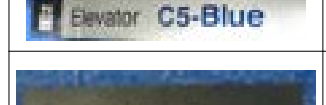

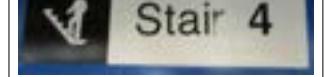
DRAWING HISTORY

NO.	DATE	DESCRIPTION
01	04/10/2024	ISSUE FOR PERMIT
02	08/23/2024	ISSUE FOR BID

PROJECT NAME  
 IAH TERMINAL C  
 GARAGE  
 SIGNAGE &  
 WAYFINDING  
 PROJECT LOCATION  
 TERMINAL C  
 3500 NORTH  
 TERMINAL RD.  
 HOUSTON, TX 77032  
 PROJECT NUMBER  
 1004395  
 SHEET TITLE  
 LEVEL 05 - GARAGE  
 DEMO PLAN -  
 SECTOR B  
 SHEET NUMBER  
 AD2.05B.1

FILE NAME: C:\Revit\Locals\TERM C SIGNAGE GARAGE\_DBhatti@pgal.com.rvt  
 DATE/TIME: 8/23/2024 4:41:21 PM

IMAGE REFERENCE

IMAGE	MARK	NOTES
	30	A
	31	A
	32	A
	33	A
	34	A
	35	A
	36	A
	37	A

DEMO KEYNOTE

- A EXISTING SURFACE MOUNTED SIGN(S) TO BE REMOVED, PATCH/REPAIR AS REQUIRED.
- B EXISTING CEILING MOUNTED SIGN TO BE REMOVED, REMOVE SUSPENSION FRAME AND ATTACHMENTS FROM GARAGE STRUCTURAL CEILING. PATCH/REPAIR AS REQUIRED.
- C EXISTING SIGN(S) / ACCESSORY TO REMAIN.
- D EXISTING POLE MOUNTED SIGN TO BE REMOVED, PATCH/REPAIR AS REQUIRED.
- E EXISTING TUBE STEEL AND SUPPORT TO BE REMOVED, PATCH/REPAIR FLOOR AS REQUIRED.
- F CHEMICALLY STRIP OR SANDBLAST PAINT TO ORIGINAL BARE CONCRETE FINISH AND SKIM COAT WITH SIKA QUICK SMOOTH FINISH AT EXTERIOR WALL PERIMETER AT ELEVATOR AND STAIR CORES. TO BE PRIMED AND PAINTED.
- G CHEMICALLY STRIP OR SANDBLAST PAINT TO ORIGINAL BARE CONCRETE FINISH AND SKIM COAT WITH SIKA QUICK SMOOTH FINISH AT ALL GARAGE COLUMNS ONLY. TO BE PRIMED AND PAINTED. REFER TO \*\* IN REGARDS TO APPROXIMATE COLUMN QUANTITY.

CLIENT



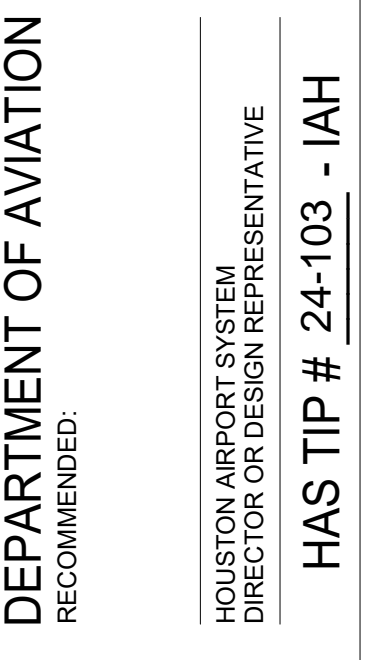
Client Name

ARCHITECT




PGAL  
 3131 BRIARPARK DR.  
 SUITE 200  
 HOUSTON, TX 77042  
 [T] 713 622 1444  
 [F] 713 968 9333  
 www.pgal.com

BSG PRJCT#  
 BSG-2024-111-IAH



REGISTRATION  
 Copyright © 2024

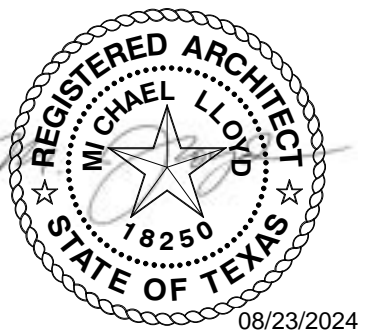

DRAWING HISTORY

NO.	DATE	DESCRIPTION
01	04/10/2024	ISSUE FOR PERMIT
02	08/23/2024	ISSUE FOR BID

PROJECT NAME  
 IAH TERMINAL C  
 GARAGE  
 SIGNAGE &  
 WAYFINDING

PROJECT LOCATION  
 TERMINAL C  
 3500 NORTH  
 TERMINAL RD.  
 HOUSTON, TX 77032


PROJECT NUMBER  
 1004395

SHEET TITLE  
 LEVEL 05 - GARAGE  
 DEMO PLAN -  
 SECTOR B

SHEET NUMBER

AD2.05B.2

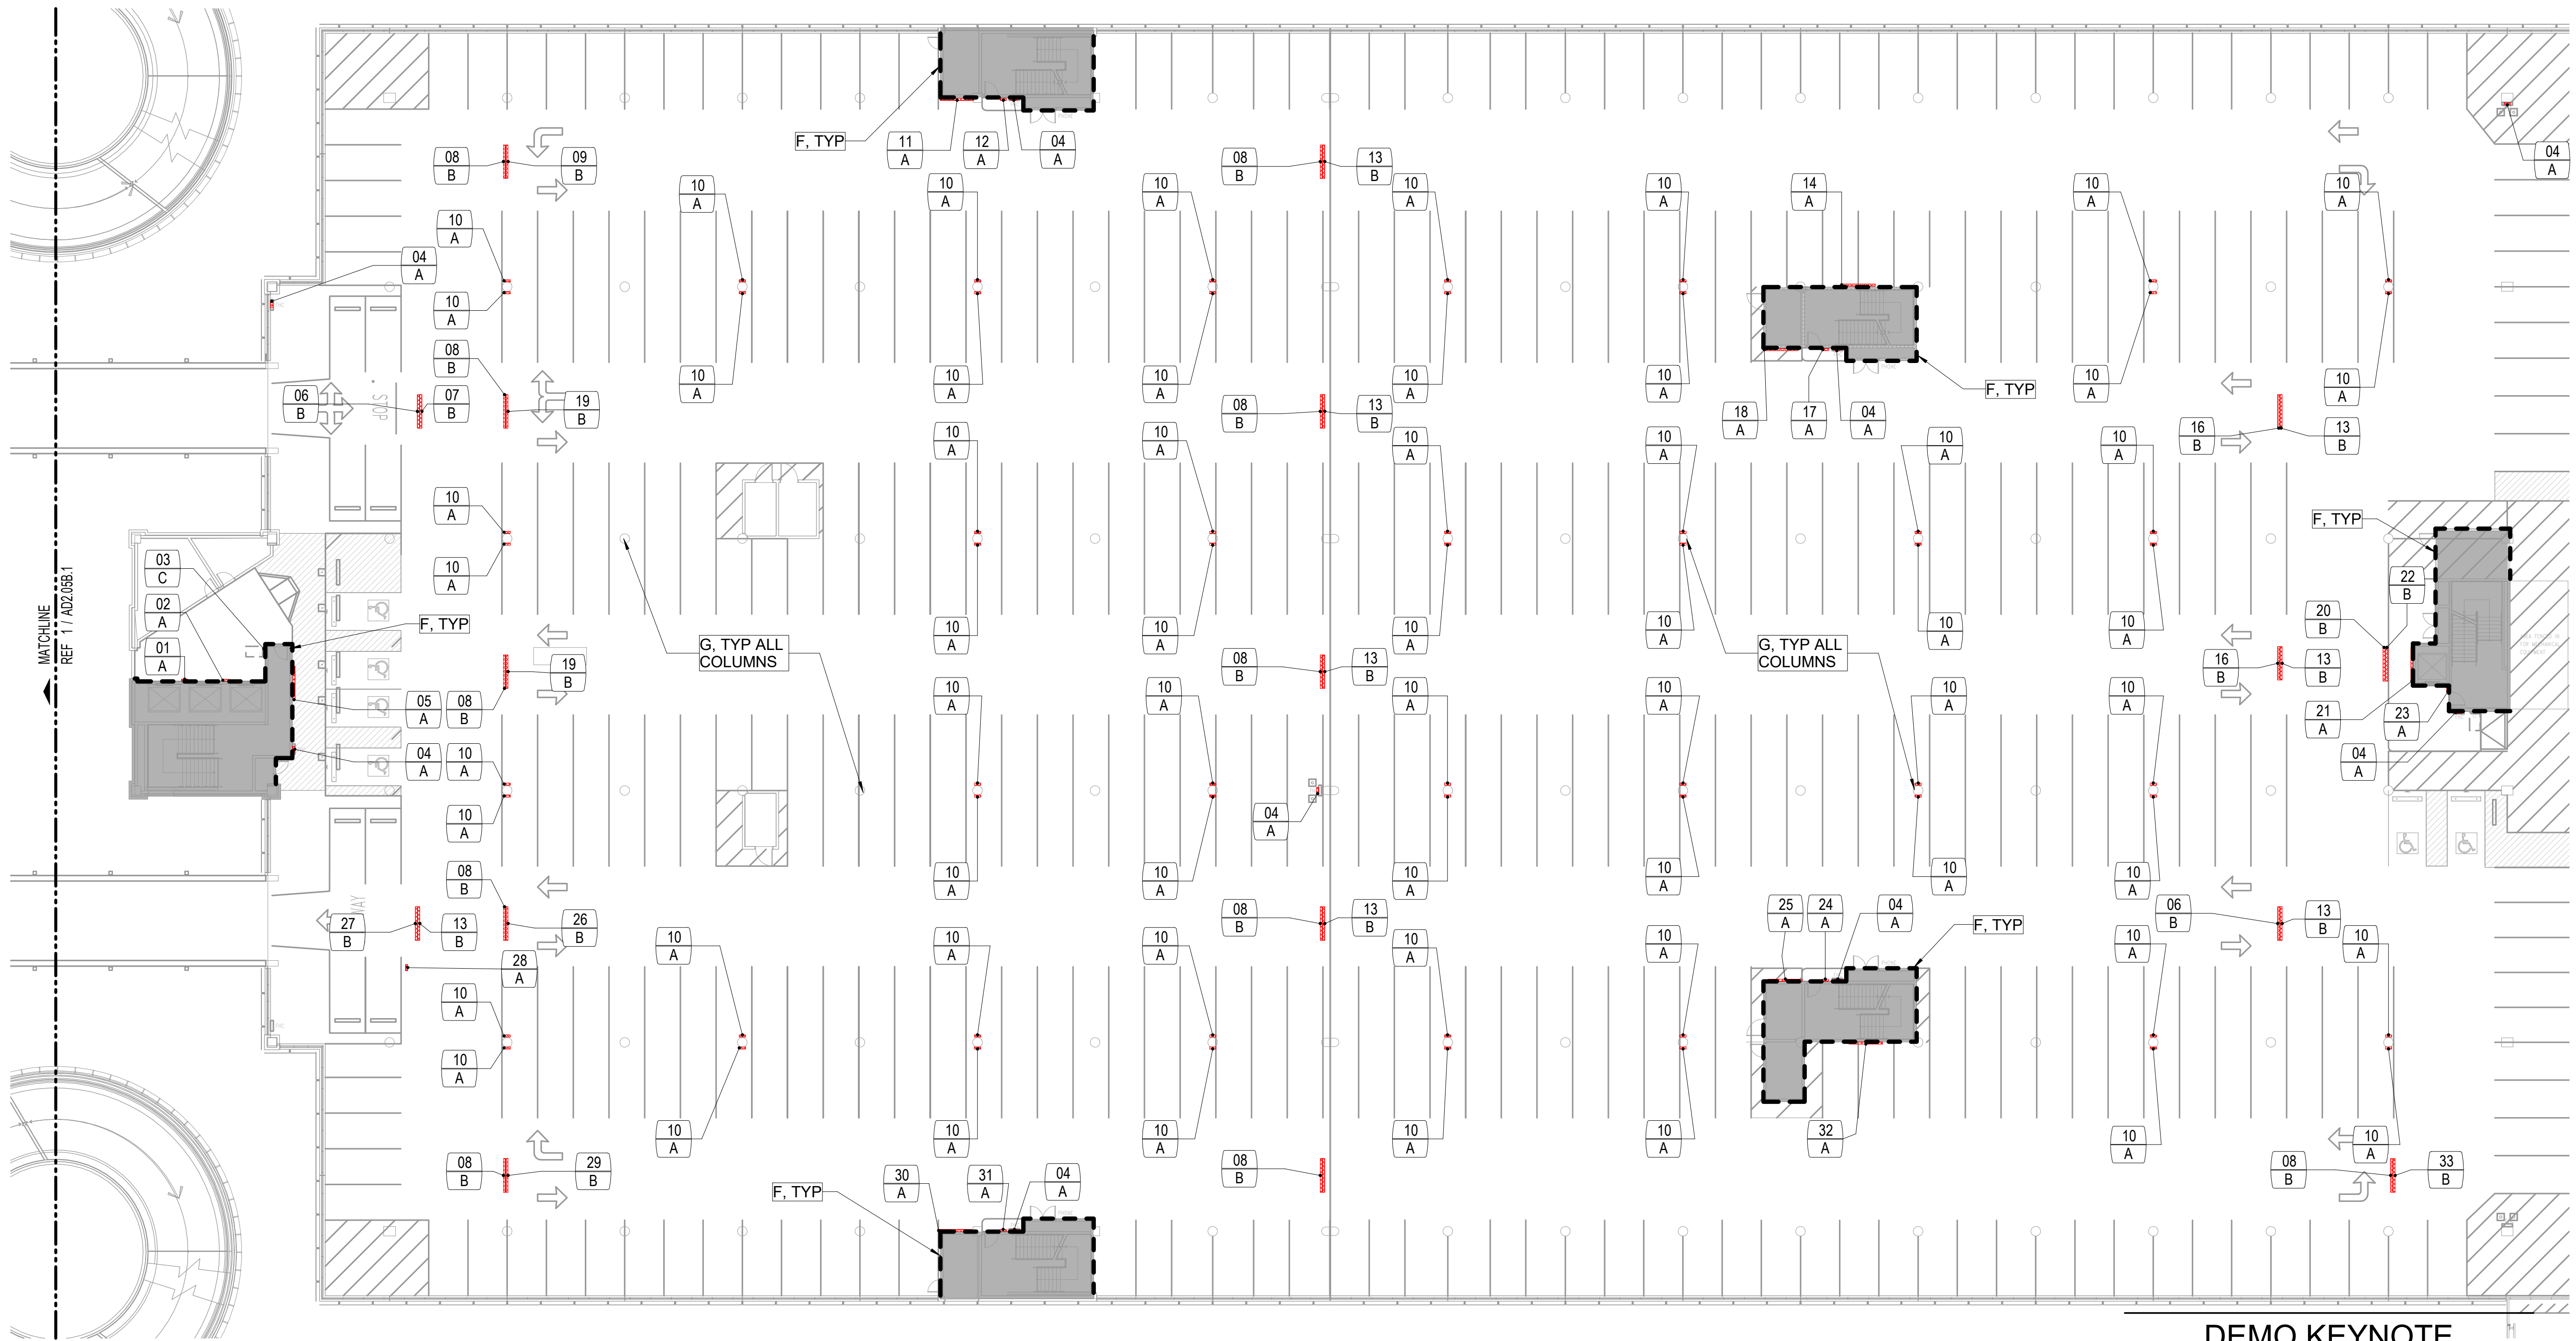FILE NAME: C:\Revit\Locals\TERM C SIGNAGE GARAGE\_DBhatti@pgal.com.rvt  
 DATE/TIME: 8/23/2024 4:41:25 PM




\*\* 114 +/- COLUMNS TO BE PAINTED IN THIS SECTOR, V.I.F.  
 LEVEL 05 - DEMO PLAN - SECTOR C 3/64" = 1'-0" 1

**DEMO KEYNOTE**

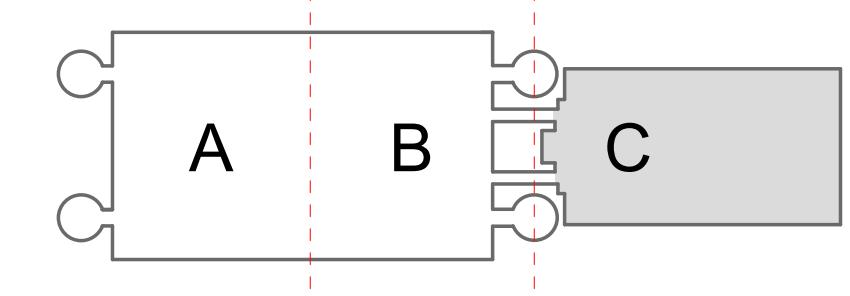
- A EXISTING SURFACE MOUNTED SIGN(S) TO BE REMOVED, PATCH/REPAIR AS REQUIRED.
- B EXISTING CEILING MOUNTED SIGN TO BE REMOVED, REMOVE SUSPENSION FRAME AND ATTACHMENTS FROM GARAGE STRUCTURAL CEILING. PATCH/REPAIR AS REQUIRED.
- C EXISTING SIGN(S) / ACCESSORY TO REMAIN.
- D EXISTING POLE MOUNTED SIGN TO BE REMOVED, PATCH/REPAIR AS REQUIRED.
- E EXISTING TUBE STEEL AND SUPPORT TO BE REMOVED, PATCH/REPAIR FLOOR AS REQUIRED.
- F CHEMICALLY STRIP OR SANDBLAST PAINT TO ORIGINAL BARE CONCRETE FINISH AND SKIM COAT WITH SIKA QUICK SMOOTH FINISH AT EXTERIOR WALL PERIMETER AT ELEVATOR AND STAIR CORES. TO BE PRIMED AND PAINTED.
- G CHEMICALLY STRIP OR SANDBLAST PAINT TO ORIGINAL BARE CONCRETE FINISH AND SKIM COAT WITH SIKA QUICK SMOOTH FINISH AT ALL GARAGE COLUMNS ONLY. TO BE PRIMED AND PAINTED. REFER TO "\*" IN REGARDS TO APPROXIMATE COLUMN QUANTITY.

**\*\*\* NOTE \*\*\***  
 UNLESS NOTED OTHERWISE, ALL REMOVED SIGNS ARE TO BE REPLACED WITH A NEW SIGN

**KEY PLAN**



1:256 SCALE

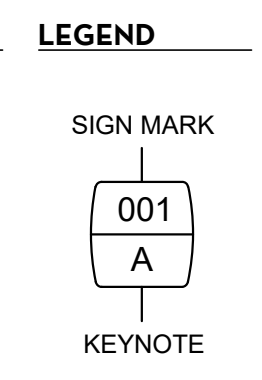

**PLAN NORTH**



**DRAWING HISTORY**

NO.	DATE	DESCRIPTION
01	04/10/2024	ISSUE FOR PERMIT
02	08/23/2024	ISSUE FOR BID

**PROJECT NAME**  
 IAH TERMINAL C  
 GARAGE  
 SIGNAGE &  
 WAYFINDING

**PROJECT LOCATION**  
 TERMINAL C  
 3500 NORTH  
 TERMINAL RD.  
 HOUSTON, TX 77032

**PROJECT NUMBER**  
 1004395

**SHEET TITLE**  
 LEVEL 05 - GARAGE  
 DEMO PLAN -  
 SECTOR C

**SHEET NUMBER**

AD2.05C.1



FILE NAME: C:\@Revit\Locals\TERM C SIGNAGE GARAGE\_DBhatti@pgal.com.rvt  
 DATE/TIME: 8/23/2024 4:41:26 PM

IMAGE	MARK	NOTES
	01	A
	02	A
	03	C
	04	A
	05	A
	06	B
	07	B
	08	B
	09	B
	10	A
	11	A

IMAGE REFERENCE

IMAGE	MARK	NOTES
	12	A
	13	B
	14	A
	16	B
	17	A
	18	A
	19	B
	20	B
	21	A
	22	B
	23	A
	24	A
	25	A

IMAGE	MARK	NOTES
	26	B
	27	B
	28	A
	29	B
	30	A
	31	A
	32	A
	33	B

DEMO KEYNOTE

- A EXISTING SURFACE MOUNTED SIGN(S) TO BE REMOVED, PATCH/REPAIR AS REQUIRED.
- B EXISTING CEILING MOUNTED SIGN TO BE REMOVED, REMOVE SUSPENSION FRAME AND ATTACHMENTS FROM GARAGE STRUCTURAL CEILING. PATCH/REPAIR AS REQUIRED.
- C EXISTING SIGN(S) / ACCESSORY TO REMAIN.
- D EXISTING POLE MOUNTED SIGN TO BE REMOVED, PATCH/REPAIR AS REQUIRED.
- E EXISTING TUBE STEEL AND SUPPORT TO BE REMOVED, PATCH/REPAIR FLOOR AS REQUIRED.
- F CHEMICALLY STRIP OR SANDBLAST PAINT TO ORIGINAL BARE CONCRETE FINISH AND SKIM COAT WITH SIKA QUICK SMOOTH FINISH AT EXTERIOR WALL PERIMETER AT ELEVATOR AND STAIR CORES. TO BE PRIMED AND PAINTED.
- G CHEMICALLY STRIP OR SANDBLAST PAINT TO ORIGINAL BARE CONCRETE FINISH AND SKIM COAT WITH SIKA QUICK SMOOTH FINISH AT ALL GARAGE COLUMNS ONLY. TO BE PRIMED AND PAINTED. REFER TO "" IN REGARDS TO APPROXIMATE COLUMN QUANTITY.

CLIENT



Client Name

ARCHITECT

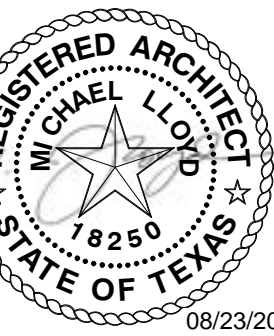


PGAL  
 3131 BRIARPARK DR.  
 SUITE 200  
 HOUSTON, TX 77042  
 [T] 713 622 1444  
 [F] 713 968 9333  
 www.pgal.com

BSG PRJCT#  
 BSG-2024-111-IAH

DEPARTMENT OF AVIATION  
 RECOMMENDED:  
 HOUSTON AIRPORT SYSTEM  
 DIRECTOR OR DESIGN REPRESENTATIVE  
 HAS TIP # 24-103 - IAH

REGISTRATION  
 Copyright © 2024



DRAWING HISTORY

NO.	DATE	DESCRIPTION
01	04/10/2024	ISSUE FOR PERMIT
02	08/23/2024	ISSUE FOR BID

PROJECT NAME  
 IAH TERMINAL C  
 GARAGE  
 SIGNAGE &  
 WAYFINDING

PROJECT LOCATION  
 TERMINAL C  
 3500 NORTH  
 TERMINAL RD.  
 HOUSTON, TX 77032

PROJECT NUMBER  
 1004395

SHEET TITLE  
 LEVEL 05 - GARAGE  
 DEMO PLAN -  
 SECTOR C

SHEET NUMBER

AD2.05C.2

FILE NAME: C:\Revit\Locals\TERM C SIGNAGE GARAGE\_DBhatti@pgal.com.rvt  
 DATE/TIME: 8/23/2024 4:41:36 PM

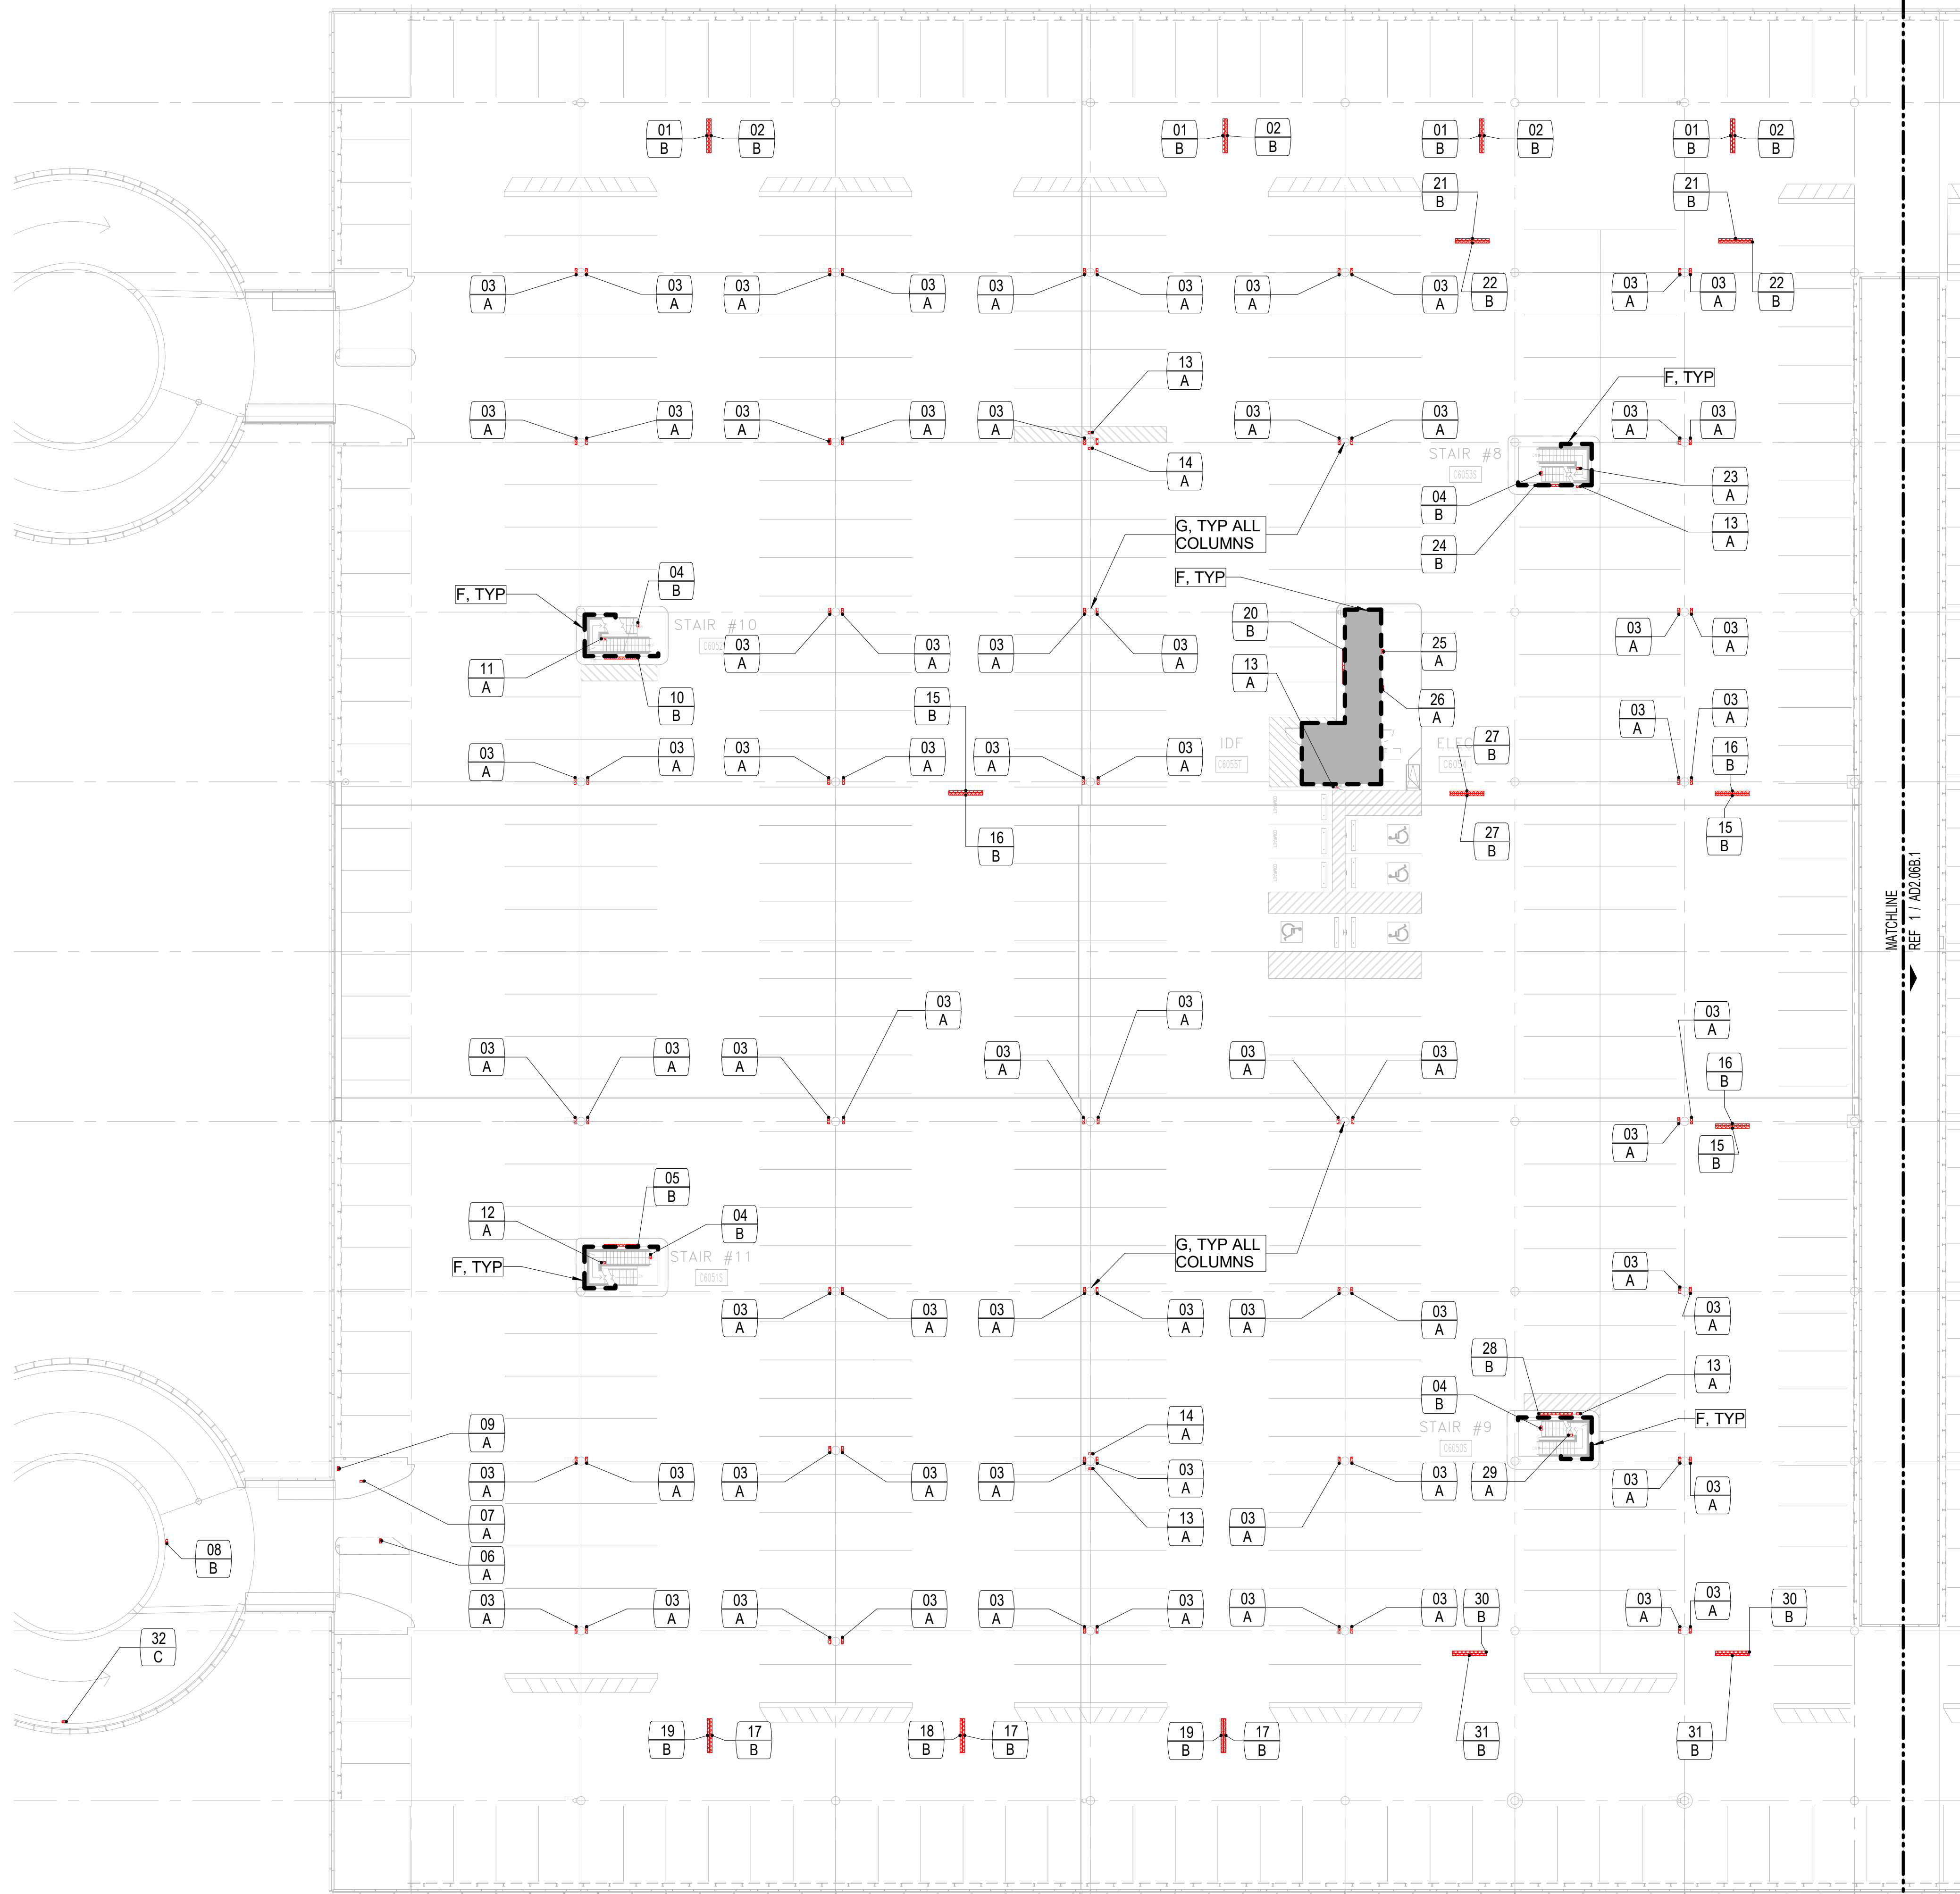


IMAGE REFERENCE

IMAGE	MARK	NOTES
	01	B
	02	B
	03	A
	04	B
	05	B
	06	A
	07	A
	08	B
	09	A


IMAGE	MARK	NOTES
	10	B
	11	A

DEMO KEYNOTE

- A EXISTING SURFACE MOUNTED SIGN(S) TO BE REMOVED. PATCH/REPAIR AS REQUIRED.
- B EXISTING CEILING MOUNTED SIGN TO BE REMOVED. REMOVE SUSPENSION FRAME AND ATTACHMENTS FROM GARAGE STRUCTURAL CEILING. PATCH/REPAIR AS REQUIRED.
- C EXISTING SIGN(S) / ACCESSORY TO REMAIN.
- D EXISTING POLE MOUNTED SIGN TO BE REMOVED. PATCH/REPAIR AS REQUIRED.
- E EXISTING TUBE STEEL AND SUPPORT TO BE REMOVED. PATCH/REPAIR FLOOR AS REQUIRED.
- F CHEMICALLY STRIP OR SANDBLAST PAINT TO ORIGINAL BARE CONCRETE FINISH AND SKIM COAT WITH SIKA QUICK SMOOTH FINISH AT EXTERIOR WALL PERIMETER AT ELEVATOR AND STAIR CORES. TO BE PRIMED AND PAINTED.
- G CHEMICALLY STRIP OR SANDBLAST PAINT TO ORIGINAL BARE CONCRETE FINISH AND SKIM COAT WITH SIKA QUICK SMOOTH FINISH AT ALL GARAGE COLUMNS ONLY. TO BE PRIMED AND PAINTED. REFER TO \*\* IN REGARDS TO APPROXIMATE COLUMN QUANTITY.

\*\*\* NOTE \*\*\*  
 UNLESS NOTED OTHERWISE, ALL REMOVED SIGNS ARE TO BE REPLACED WITH A NEW SIGN

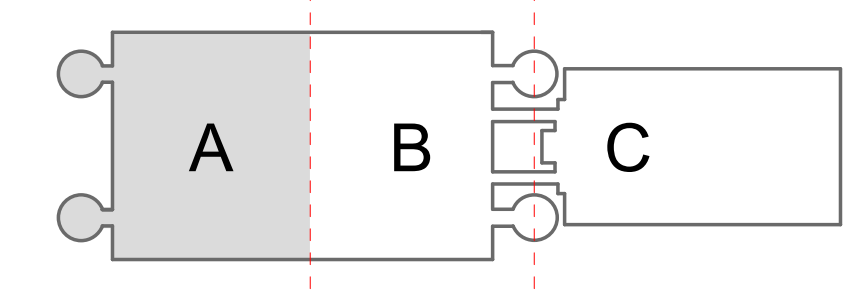
KEY PLAN




1:256 SCALE



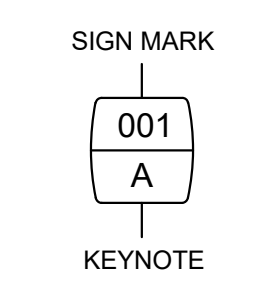LEGEND



PLAN NORTH

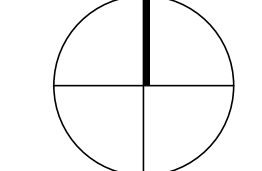

CLIENT



Client Name

ARCHITECT



PGAL  
 3131 BRIARPARK DR.  
 SUITE 200  
 HOUSTON, TX 77042  
 [T] 713 622 1444  
 [F] 713 968 9333  
 www.pgal.com

BSG PRJCT#  
 BSG-2024-111-IAH

DEPARTMENT OF AVIATION  
 RECOMMENDED:  
 HOUSTON AIRPORT SYSTEM  
 DIRECTOR OR DESIGN REPRESENTATIVE  
 HAS TIP # 24-103 - IAH

REGISTRATION  
 Copyright © 2024



DRAWING HISTORY

NO.	DATE	DESCRIPTION
01	04/10/2024	ISSUE FOR PERMIT
02	08/23/2024	ISSUE FOR BID

PROJECT NAME  
 IAH TERMINAL C  
 GARAGE  
 SIGNAGE &  
 WAYFINDING

PROJECT LOCATION  
 TERMINAL C  
 3500 NORTH  
 TERMINAL RD.  
 HOUSTON, TX 77032

PROJECT NUMBER  
 1004395

SHEET TITLE  
 LEVEL 06 - GARAGE  
 DEMO PLAN -  
 SECTOR A

SHEET NUMBER

AD2.06A.1

IMAGE	MARK	NOTES
	12	A
	13	A
	14	A
	15	B
	16	B
	17	B
	18	B
	19	B
	20	B
	21	B
	22	B

IMAGE REFERENCE

IMAGE	MARK	NOTES
	23	A
	24	B
	25	A
	26	A
	27	B
	28	B

IMAGE	MARK	NOTES
	29	A
	30	B
	31	B
	32	C

DEMO KEYNOTE

- A EXISTING SURFACE MOUNTED SIGN(S) TO BE REMOVED, PATCH/REPAIR AS REQUIRED.
- B EXISTING CEILING MOUNTED SIGN TO BE REMOVED, REMOVE SUSPENSION FRAME AND ATTACHMENTS FROM GARAGE STRUCTURAL CEILING. PATCH/REPAIR AS REQUIRED.
- C EXISTING SIGN(S) / ACCESSORY TO REMAIN.
- D EXISTING POLE MOUNTED SIGN TO BE REMOVED, PATCH/REPAIR AS REQUIRED.
- E EXISTING TUBE STEEL AND SUPPORT TO BE REMOVED, PATCH/REPAIR FLOOR AS REQUIRED.
- F CHEMICALLY STRIP OR SANDBLAST PAINT TO ORIGINAL BARE CONCRETE FINISH AND SKIM COAT WITH SIKA QUICK SMOOTH FINISH AT EXTERIOR WALL PERIMETER AT ELEVATOR AND STAIR CORES. TO BE PRIMED AND PAINTED.
- G CHEMICALLY STRIP OR SANDBLAST PAINT TO ORIGINAL BARE CONCRETE FINISH AND SKIM COAT WITH SIKA QUICK SMOOTH FINISH AT ALL GARAGE COLUMNS ONLY. TO BE PRIMED AND PAINTED. REFER TO "\*" IN REGARDS TO APPROXIMATE COLUMN QUANTITY.

CLIENT



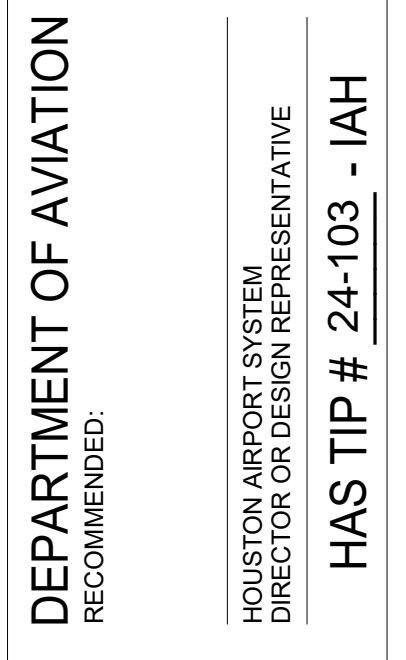
Client Name

ARCHITECT



PGAL  
 3131 BRIARPARK DR.  
 SUITE 200  
 HOUSTON, TX 77042  
 [T] 713 622 1444  
 [F] 713 968 9333  
 www.pgal.com

BSG PRJCT#  
 BSG-2024-111-IAH



REGISTRATION  
 Copyright © 2024



DRAWING HISTORY

NO.	DATE	DESCRIPTION
01	04/10/2024	ISSUE FOR PERMIT
02	08/23/2024	ISSUE FOR BID

PROJECT NAME  
 IAH TERMINAL C  
 GARAGE  
 SIGNAGE &  
 WAYFINDING

PROJECT LOCATION  
 TERMINAL C  
 3500 NORTH  
 TERMINAL RD.  
 HOUSTON, TX 77032


PROJECT NUMBER  
 1004395

SHEET TITLE  
 LEVEL 06 - GARAGE  
 DEMO PLAN -  
 SECTOR A

SHEET NUMBER

AD2.06A.2

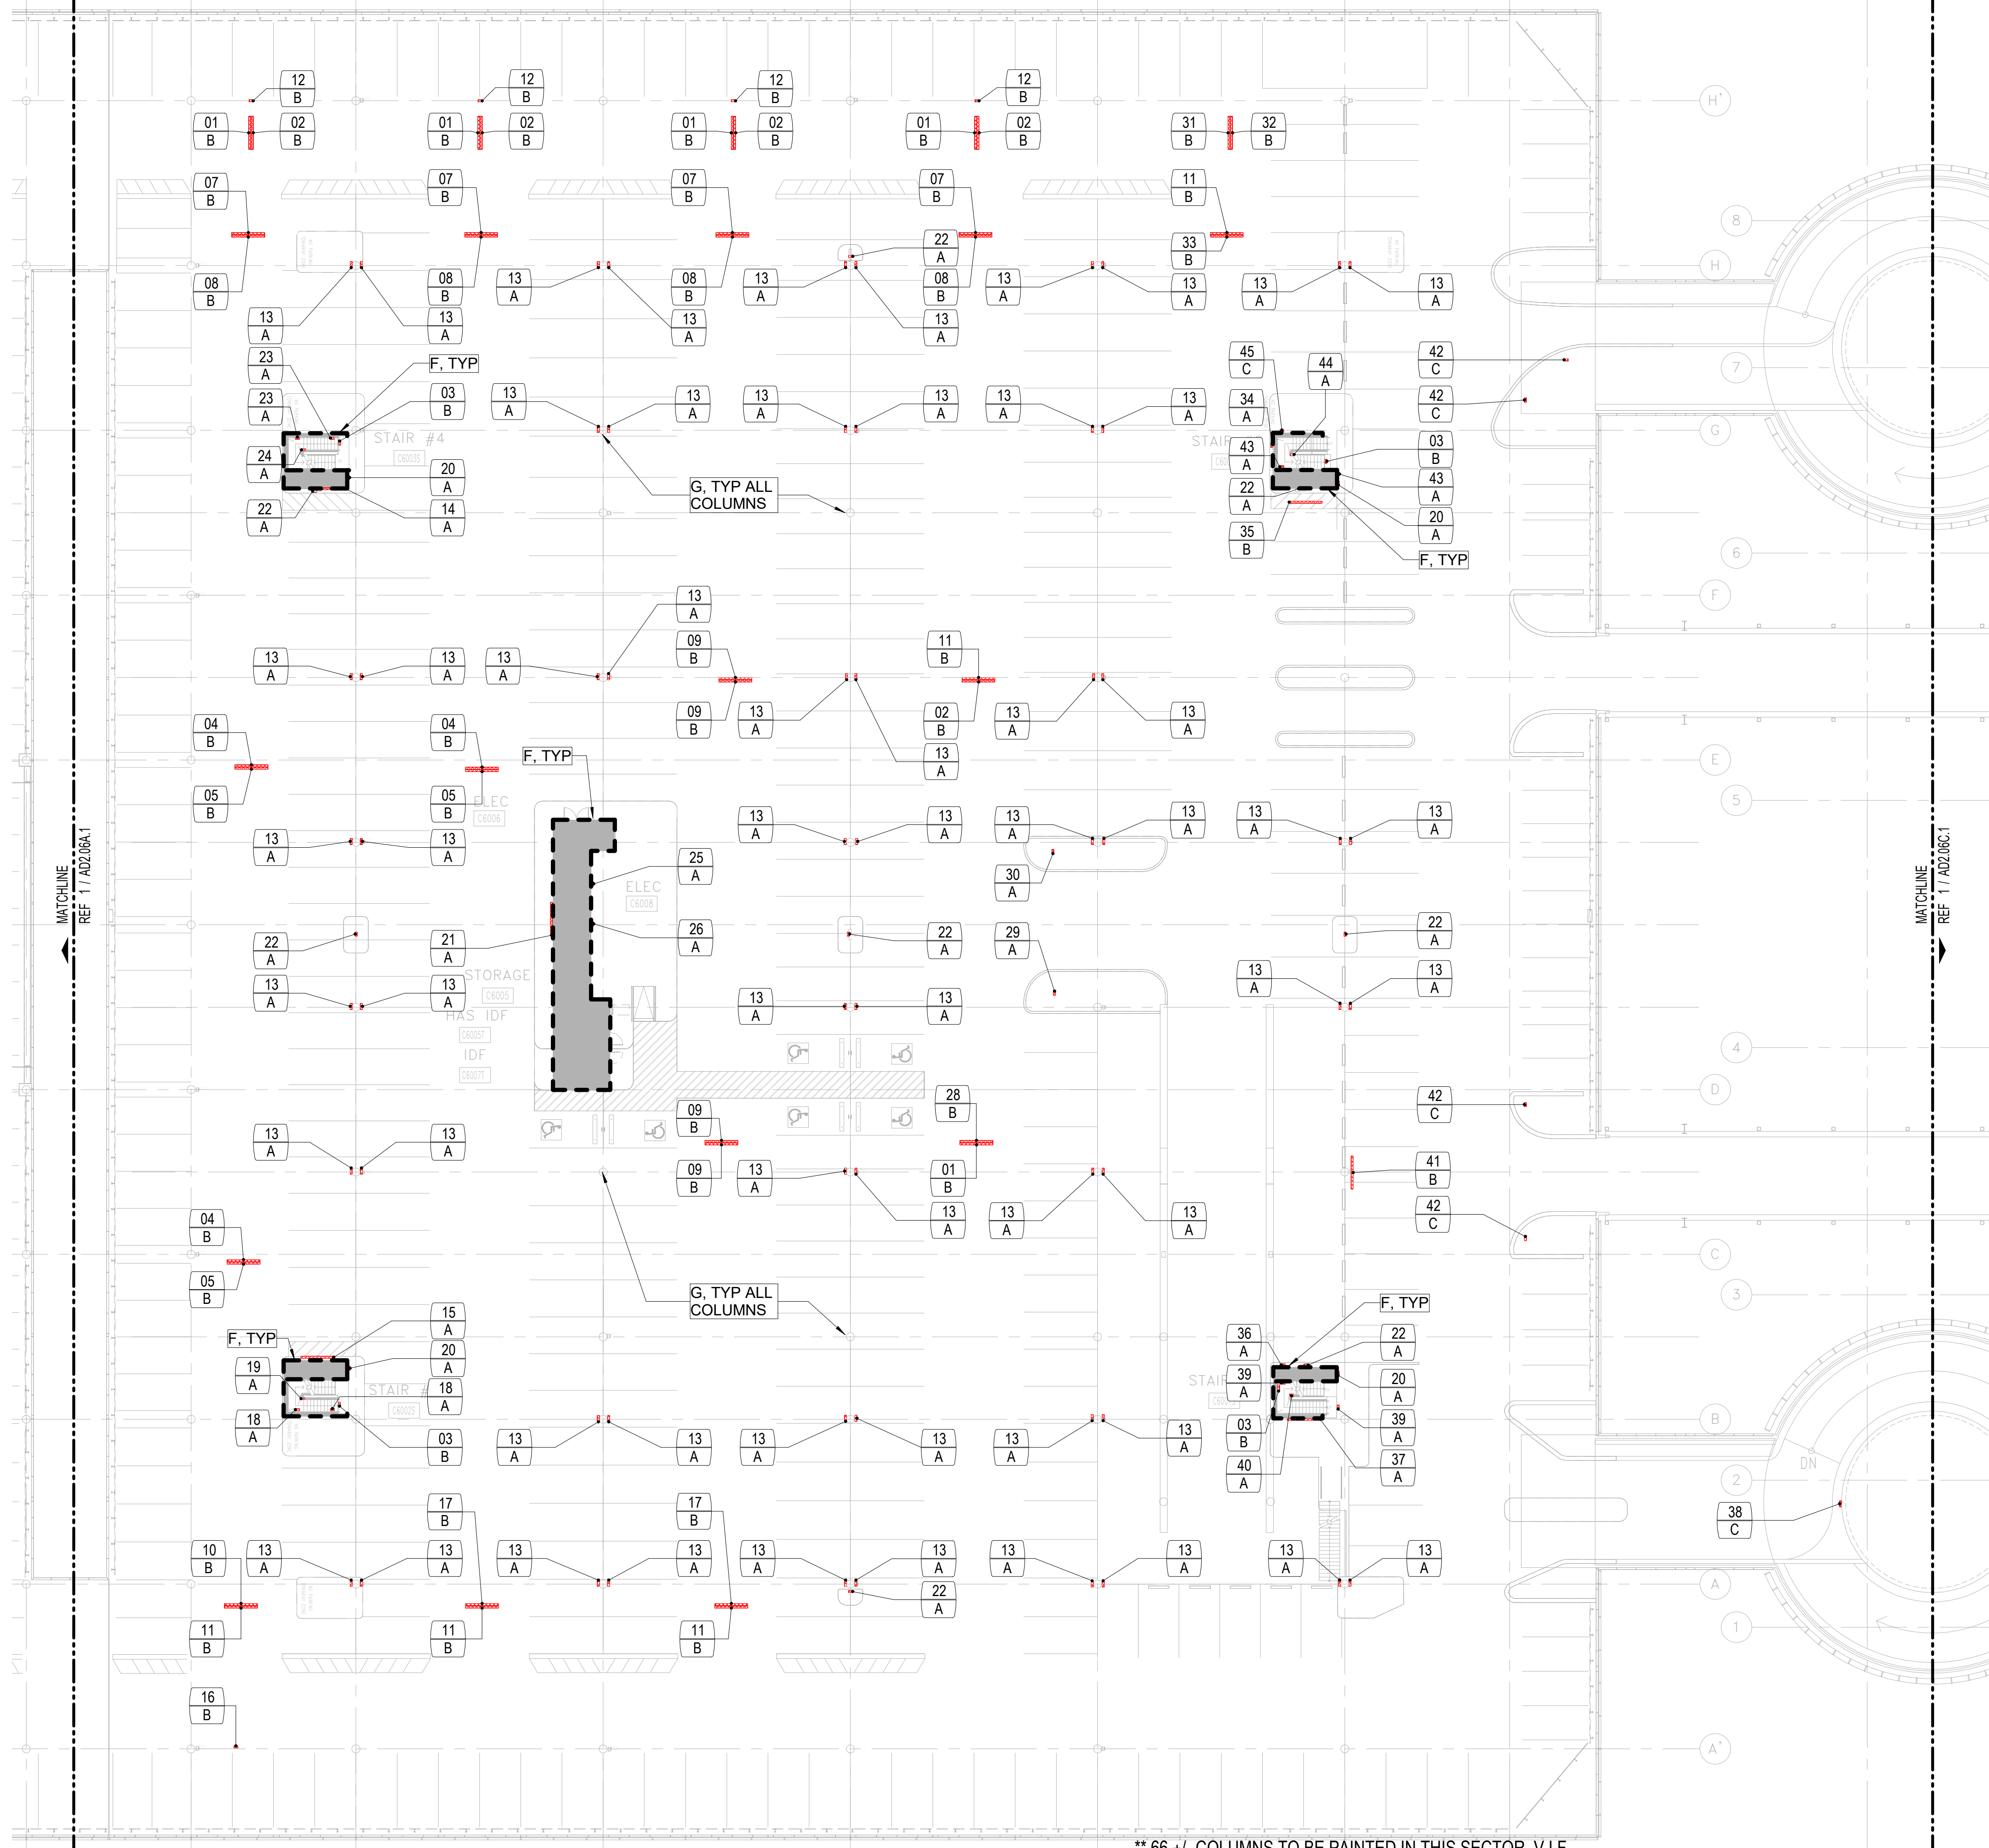FILE NAME: C:\Revit\Locals\TERM C SIGNAGE GARAGE\_DBhatti@pgal.com.rvt  
 DATE/TIME: 4/8/2024 4:41:45 PM



\*\* 66 +/- COLUMNS TO BE PAINTED IN THIS SECTOR, V.I.F.  
**LEVEL 06 - DEMO PLAN - SECTOR B** 3/64" = 1'-0" 1

**IMAGE REFERENCE**


IMAGE	MARK	NOTES
	01	B
	02	B
	03	B
	04	B
	05	B
	07	B
	08	B
	09	B
	10	B
	11	B
	12	B
	13	A
	14	A
	15	A
	16	B
	17	B

**DEMO KEYNOTE**


- A EXISTING SURFACE MOUNTED SIGN(S) TO BE REMOVED, PATCH/REPAIR AS REQUIRED.
- B EXISTING CEILING MOUNTED SIGN TO BE REMOVED, REMOVE SUSPENSION FRAME AND ATTACHMENTS FROM GARAGE STRUCTURAL CEILING. PATCH/REPAIR AS REQUIRED.
- C EXISTING SIGN(S) / ACCESSORY TO REMAIN.
- D EXISTING POLE MOUNTED SIGN TO BE REMOVED, PATCH/REPAIR AS REQUIRED.
- E EXISTING TUBE STEEL AND SUPPORT TO BE REMOVED, PATCH/REPAIR FLOOR AS REQUIRED.
- F CHEMICALLY STRIP OR SANDBLAST PAINT TO ORIGINAL BARE CONCRETE FINISH AND SKIM COAT WITH SIKA QUICK SMOOTH FINISH AT EXTERIOR WALL PERIMETER AT ELEVATOR AND STAIR CORES. TO BE PRIMED AND PAINTED.
- G CHEMICALLY STRIP OR SANDBLAST PAINT TO ORIGINAL BARE CONCRETE FINISH AND SKIM COAT WITH SIKA QUICK SMOOTH FINISH AT ALL GARAGE COLUMNS ONLY. TO BE PRIMED AND PAINTED. REFER TO \*\* IN REGARDS TO APPROXIMATE COLUMN QUANTITY.

\*\*\* NOTE \*\*\*  
 UNLESS NOTED OTHERWISE, ALL REMOVED SIGNS ARE TO BE REPLACED WITH A NEW SIGN

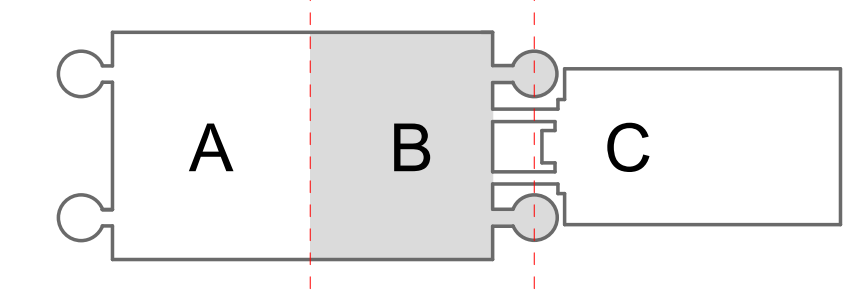**KEY PLAN**




1:256 SCALE

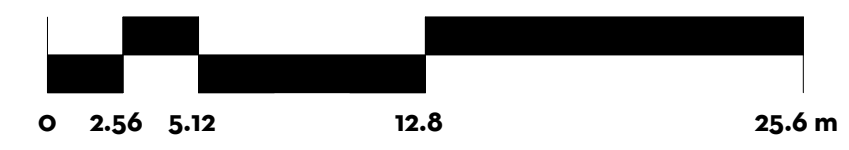

**LEGEND**

SIGN MARK	
KEYNOTE	

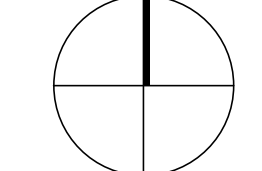**PLAN NORTH**



**CLIENT**



Client Name

**ARCHITECT**

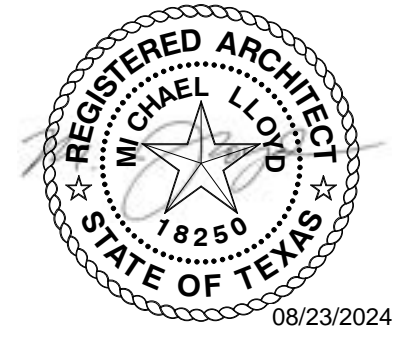


PGAL  
 3131 BRIARPARK DR.  
 SUITE 200  
 HOUSTON, TX 77042  
 [T] 713 622 1444  
 [F] 713 968 9333  
 www.pgal.com

BSG PRJCT#  
 BSG-2024-111-IAH

DEPARTMENT OF AVIATION  
 RECOMMENDED:  
 HOUSTON AIRPORT SYSTEM  
 DIRECTOR OR DESIGN REPRESENTATIVE  
 HAS TIP # 24-103 - IAH

REGISTRATION  
 Copyright © 2024



**DRAWING HISTORY**

NO.	DATE	DESCRIPTION
01	04/10/2024	ISSUE FOR PERMIT
02	08/23/2024	ISSUE FOR BID

**PROJECT NAME**  
 IAH TERMINAL C  
 GARAGE  
 SIGNAGE &  
 WAYFINDING

**PROJECT LOCATION**  
 TERMINAL C  
 3500 NORTH  
 TERMINAL RD.  
 HOUSTON, TX 77032

**PROJECT NUMBER**  
 1004395

**SHEET TITLE**  
 LEVEL 06 - GARAGE  
 DEMO PLAN -  
 SECTOR B

**SHEET NUMBER**

**AD2.06B.1**

IMAGE	MARK	NOTES
	18	A
	19	A
	20	A
	21	A
	22	A
	23	A
	24	A
	25	A

IMAGE	MARK	NOTES
	26	A
	28	B
	29	A
	30	A
	31	B
	32	B
	33	B
	34	A
	35	B
	36	A
	37	A
	38	C
	39	A

IMAGE REFERENCE

IMAGE	MARK	NOTES
	40	A
	41	B
	42	C
	43	A

IMAGE	MARK	NOTES
	44	A
	45	C

DEMO KEYNOTE

- A EXISTING SURFACE MOUNTED SIGN(S) TO BE REMOVED, PATCH/REPAIR AS REQUIRED.
- B EXISTING CEILING MOUNTED SIGN TO BE REMOVED, REMOVE SUSPENSION FRAME AND ATTACHMENTS FROM GARAGE STRUCTURAL CEILING. PATCH/REPAIR AS REQUIRED.
- C EXISTING SIGN(S) / ACCESSORY TO REMAIN.
- D EXISTING POLE MOUNTED SIGN TO BE REMOVED, PATCH/REPAIR AS REQUIRED.
- E EXISTING TUBE STEEL AND SUPPORT TO BE REMOVED, PATCH/REPAIR FLOOR AS REQUIRED.
- F CHEMICALLY STRIP OR SANDBLAST PAINT TO ORIGINAL BARE CONCRETE FINISH AND SKIM COAT WITH SIKA QUICK SMOOTH FINISH AT EXTERIOR WALL PERIMETER AT ELEVATOR AND STAIR CORES. TO BE PRIMED AND PAINTED.
- G CHEMICALLY STRIP OR SANDBLAST PAINT TO ORIGINAL BARE CONCRETE FINISH AND SKIM COAT WITH SIKA QUICK SMOOTH FINISH AT ALL GARAGE COLUMNS ONLY. TO BE PRIMED AND PAINTED. REFER TO \*\* IN REGARDS TO APPROXIMATE COLUMN QUANTITY.

CLIENT



Client Name

ARCHITECT

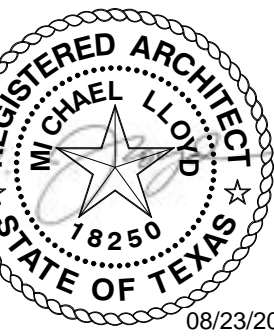


PGAL  
 3131 BRIARPARK DR.  
 SUITE 200  
 HOUSTON, TX 77042  
 [T] 713 622 1444  
 [F] 713 968 9333  
 www.pgal.com

BSG PRJCT#  
 BSG-2024-111-IAH

DEPARTMENT OF AVIATION  
 RECOMMENDED:  
 HOUSTON AIRPORT SYSTEM  
 DIRECTOR OR DESIGN REPRESENTATIVE  
 HAS TIP # 24-103 - IAH

REGISTRATION  
 Copyright © 2024



DRAWING HISTORY

NO.	DATE	DESCRIPTION
01	04/10/2024	ISSUE FOR PERMIT
02	08/23/2024	ISSUE FOR BID

PROJECT NAME  
 IAH TERMINAL C  
 GARAGE  
 SIGNAGE &  
 WAYFINDING

PROJECT LOCATION  
 TERMINAL C  
 3500 NORTH  
 TERMINAL RD.  
 HOUSTON, TX 77032


PROJECT NUMBER  
 1004395

SHEET TITLE  
 LEVEL 06 - GARAGE  
 DEMO PLAN -  
 SECTOR B

SHEET NUMBER

AD2.06B.2

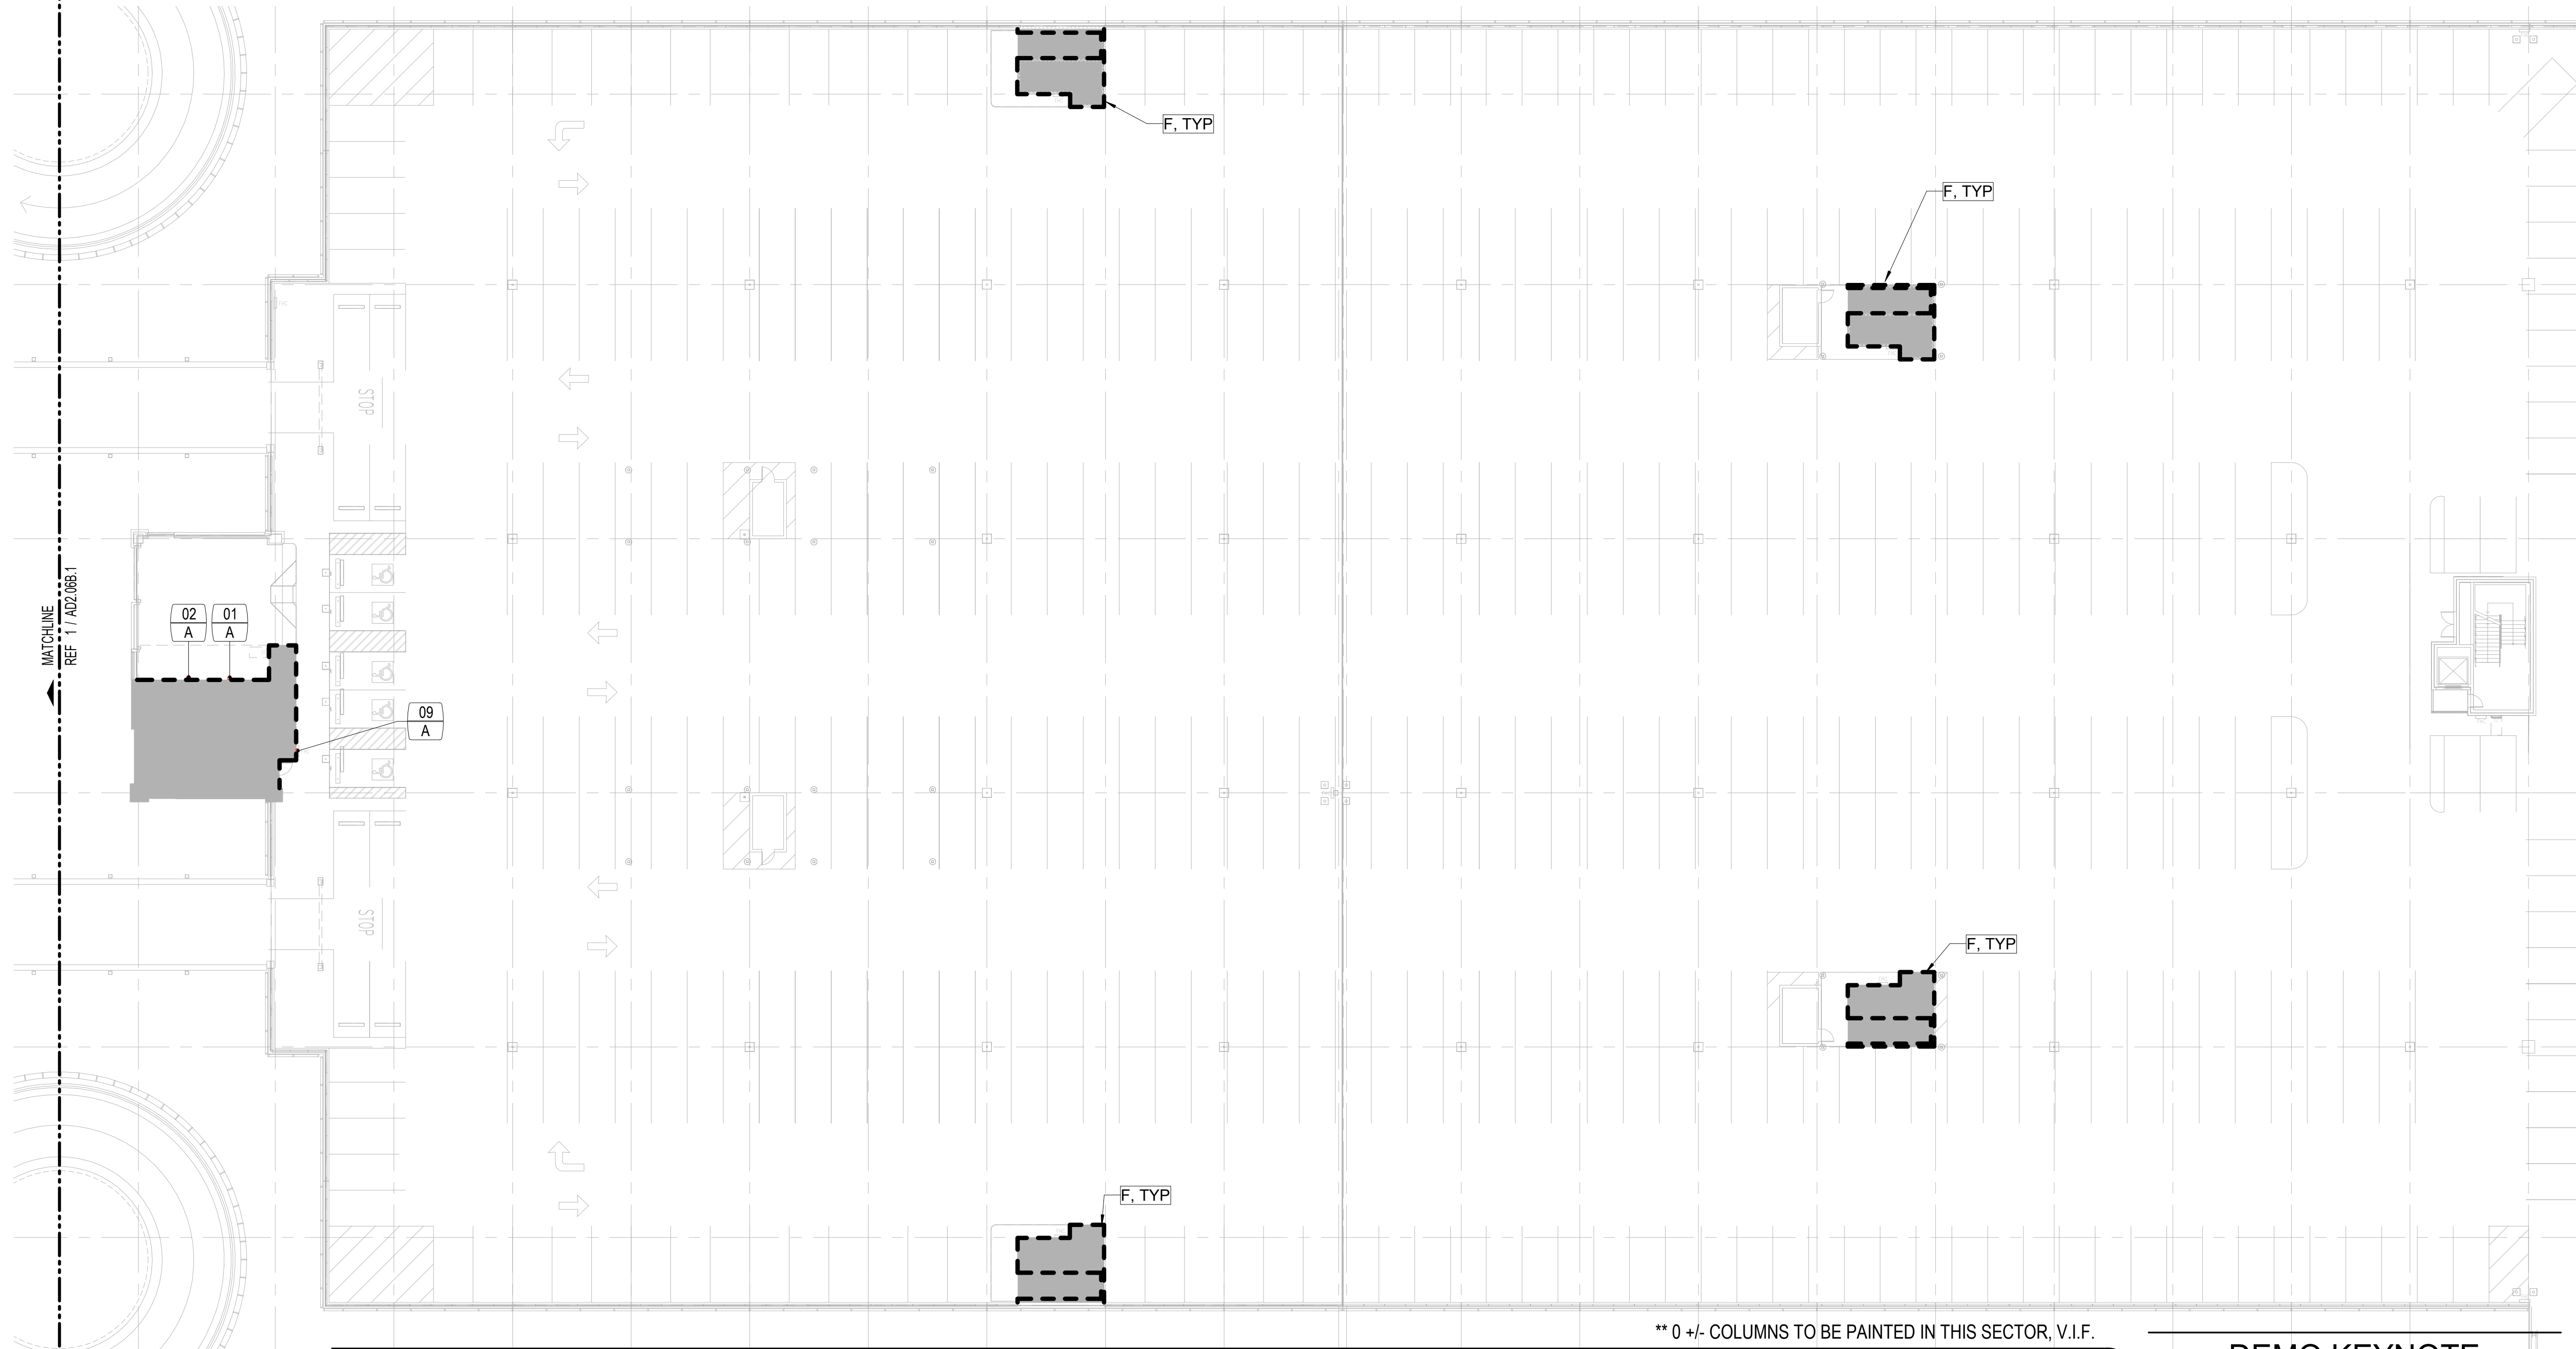FILE NAME: C:\Revit\Locals\TERM C SIGNAGE GARAGE\_DBhatti@pgal.com.rvt  
 DATE/TIME: 8/2024 4:41:53 PM




\*\* 0 +/- COLUMNS TO BE PAINTED IN THIS SECTOR, V.I.F.

**LEVEL 06 - DEMO PLAN - SECTOR C**  $\frac{3/64"}{1"} = 1'-0"$  1


**DEMO KEYNOTE**

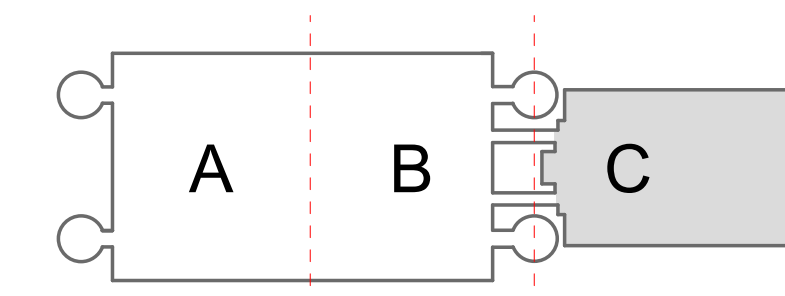- A EXISTING SURFACE MOUNTED SIGN(S) TO BE REMOVED, PATCH/REPAIR AS REQUIRED.
- B EXISTING CEILING MOUNTED SIGN TO BE REMOVED, REMOVE SUSPENSION FRAME AND ATTACHMENTS FROM GARAGE STRUCTURAL CEILING. PATCH/REPAIR AS REQUIRED.
- C EXISTING SIGN(S) / ACCESSORY TO REMAIN.
- D EXISTING POLE MOUNTED SIGN TO BE REMOVED, PATCH/REPAIR AS REQUIRED.
- E EXISTING TUBE STEEL AND SUPPORT TO BE REMOVED, PATCH/REPAIR FLOOR AS REQUIRED.
- F CHEMICALLY STRIP OR SANDBLAST PAINT TO ORIGINAL BARE CONCRETE FINISH AND SKIM COAT WITH SIKA QUICK SMOOTH FINISH AT EXTERIOR WALL PERIMETER AT ELEVATOR AND STAIR CORES. TO BE PRIMED AND PAINTED.
- G CHEMICALLY STRIP OR SANDBLAST PAINT TO ORIGINAL BARE CONCRETE FINISH AND SKIM COAT WITH SIKA QUICK SMOOTH FINISH AT ALL GARAGE COLUMNS ONLY. TO BE PRIMED AND PAINTED. REFER TO \*\* IN REGARDS TO APPROXIMATE COLUMN QUANTITY.

**KEY PLAN**




1:256 SCALE

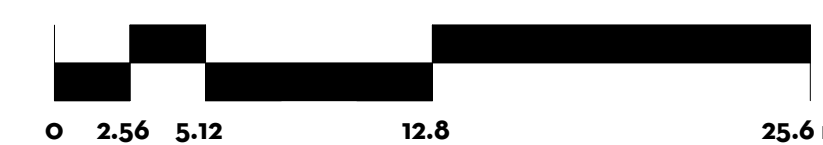


\*\*\* NOTE \*\*\*  
 UNLESS NOTED OTHERWISE, ALL REMOVED SIGNS ARE TO BE REPLACED WITH A NEW SIGN

**LEGEND**

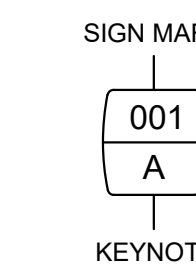

**PLAN NORTH**

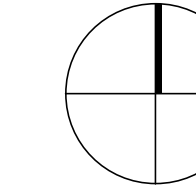

CLIENT



Client Name

ARCHITECT

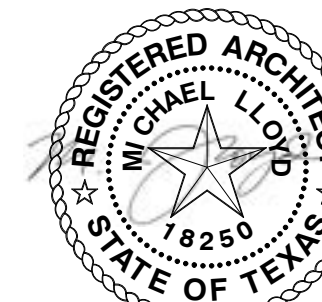


PGAL  
 3131 BRIARPARK DR.  
 SUITE 200  
 HOUSTON, TX 77042  
 [T] 713 622 1444  
 [F] 713 968 9333  
 www.pgal.com

BSG PRJCT#  
 BSG-2024-111-IAH

DEPARTMENT OF AVIATION  
 RECOMMENDED:  
 HOUSTON AIRPORT SYSTEM  
 DIRECTOR OR DESIGN REPRESENTATIVE  
 HAS TIP # 24-103 - IAH

REGISTRATION  
 Copyright © 2024



**DRAWING HISTORY**

NO.	DATE	DESCRIPTION
01	04/10/2024	ISSUE FOR PERMIT
02	08/23/2024	ISSUE FOR BID

**PROJECT NAME**  
 IAH TERMINAL C  
 GARAGE  
 SIGNAGE &  
 WAYFINDING

**PROJECT LOCATION**  
 TERMINAL C  
 3500 NORTH  
 TERMINAL RD.  
 HOUSTON, TX 77032

**PROJECT NUMBER**  
 1004395




**SHEET TITLE**  
 LEVEL 06 - GARAGE  
 DEMO PLAN -  
 SECTOR C

**SHEET NUMBER**

**AD2.06C.1**

FILE NAME: C:\Revit\Locals\TERM C SIGNAGE GARAGE\_DBhatti@pgal.com.rvt  
 DATE/TIME: 8/23/2024 4:41:54 PM

IMAGE REFERENCE

IMAGE	MARK	NOTES
	01	A
	02	A
	09	A

DEMO KEYNOTE

- A EXISTING SURFACE MOUNTED SIGN(S) TO BE REMOVED, PATCH/REPAIR AS REQUIRED.
- B EXISTING CEILING MOUNTED SIGN TO BE REMOVED, REMOVE SUSPENSION FRAME AND ATTACHMENTS FROM GARAGE STRUCTURAL CEILING. PATCH/REPAIR AS REQUIRED.
- C EXISTING SIGN(S) / ACCESSORY TO REMAIN.
- D EXISTING POLE MOUNTED SIGN TO BE REMOVED, PATCH/REPAIR AS REQUIRED.
- E EXISTING TUBE STEEL AND SUPPORT TO BE REMOVED, PATCH/REPAIR FLOOR AS REQUIRED.
- F CHEMICALLY STRIP OR SANDBLAST PAINT TO ORIGINAL BARE CONCRETE FINISH AND SKIM COAT WITH SIKA QUICK SMOOTH FINISH AT EXTERIOR WALL PERIMETER AT ELEVATOR AND STAIR CORES. TO BE PRIMED AND PAINTED.
- G CHEMICALLY STRIP OR SANDBLAST PAINT TO ORIGINAL BARE CONCRETE FINISH AND SKIM COAT WITH SIKA QUICK SMOOTH FINISH AT ALL GARAGE COLUMNS ONLY. TO BE PRIMED AND PAINTED. REFER TO \*\* IN REGARDS TO APPROXIMATE COLUMN QUANTITY.

CLIENT



Client Name

ARCHITECT

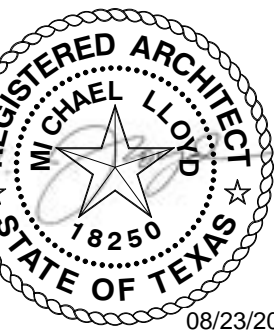


PGAL  
 3131 BRIARPARK DR.  
 SUITE 200  
 HOUSTON, TX 77042  
 [T] 713 622 1444  
 [F] 713 968 9333  
 www.pgal.com

BSG PRJCT#  
 BSG-2024-111-IAH

DEPARTMENT OF AVIATION  
 RECOMMENDED:  
 HOUSTON AIRPORT SYSTEM  
 DIRECTOR OR DESIGN REPRESENTATIVE  
 HAS TIP # 24-103 - IAH

REGISTRATION  
 Copyright © 2024



DRAWING HISTORY

NO.	DATE	DESCRIPTION
01	04/10/2024	ISSUE FOR PERMIT
02	08/23/2024	ISSUE FOR BID

PROJECT NAME

IAH TERMINAL C  
 GARAGE  
 SIGNAGE &  
 WAYFINDING

PROJECT LOCATION

TERMINAL C  
 3500 NORTH  
 TERMINAL RD.  
 HOUSTON, TX 77032

PROJECT NUMBER

1004395


SHEET TITLE

LEVEL 06 - GARAGE  
 DEMO PLAN -  
 SECTOR C

SHEET NUMBER

AD2.06C.2

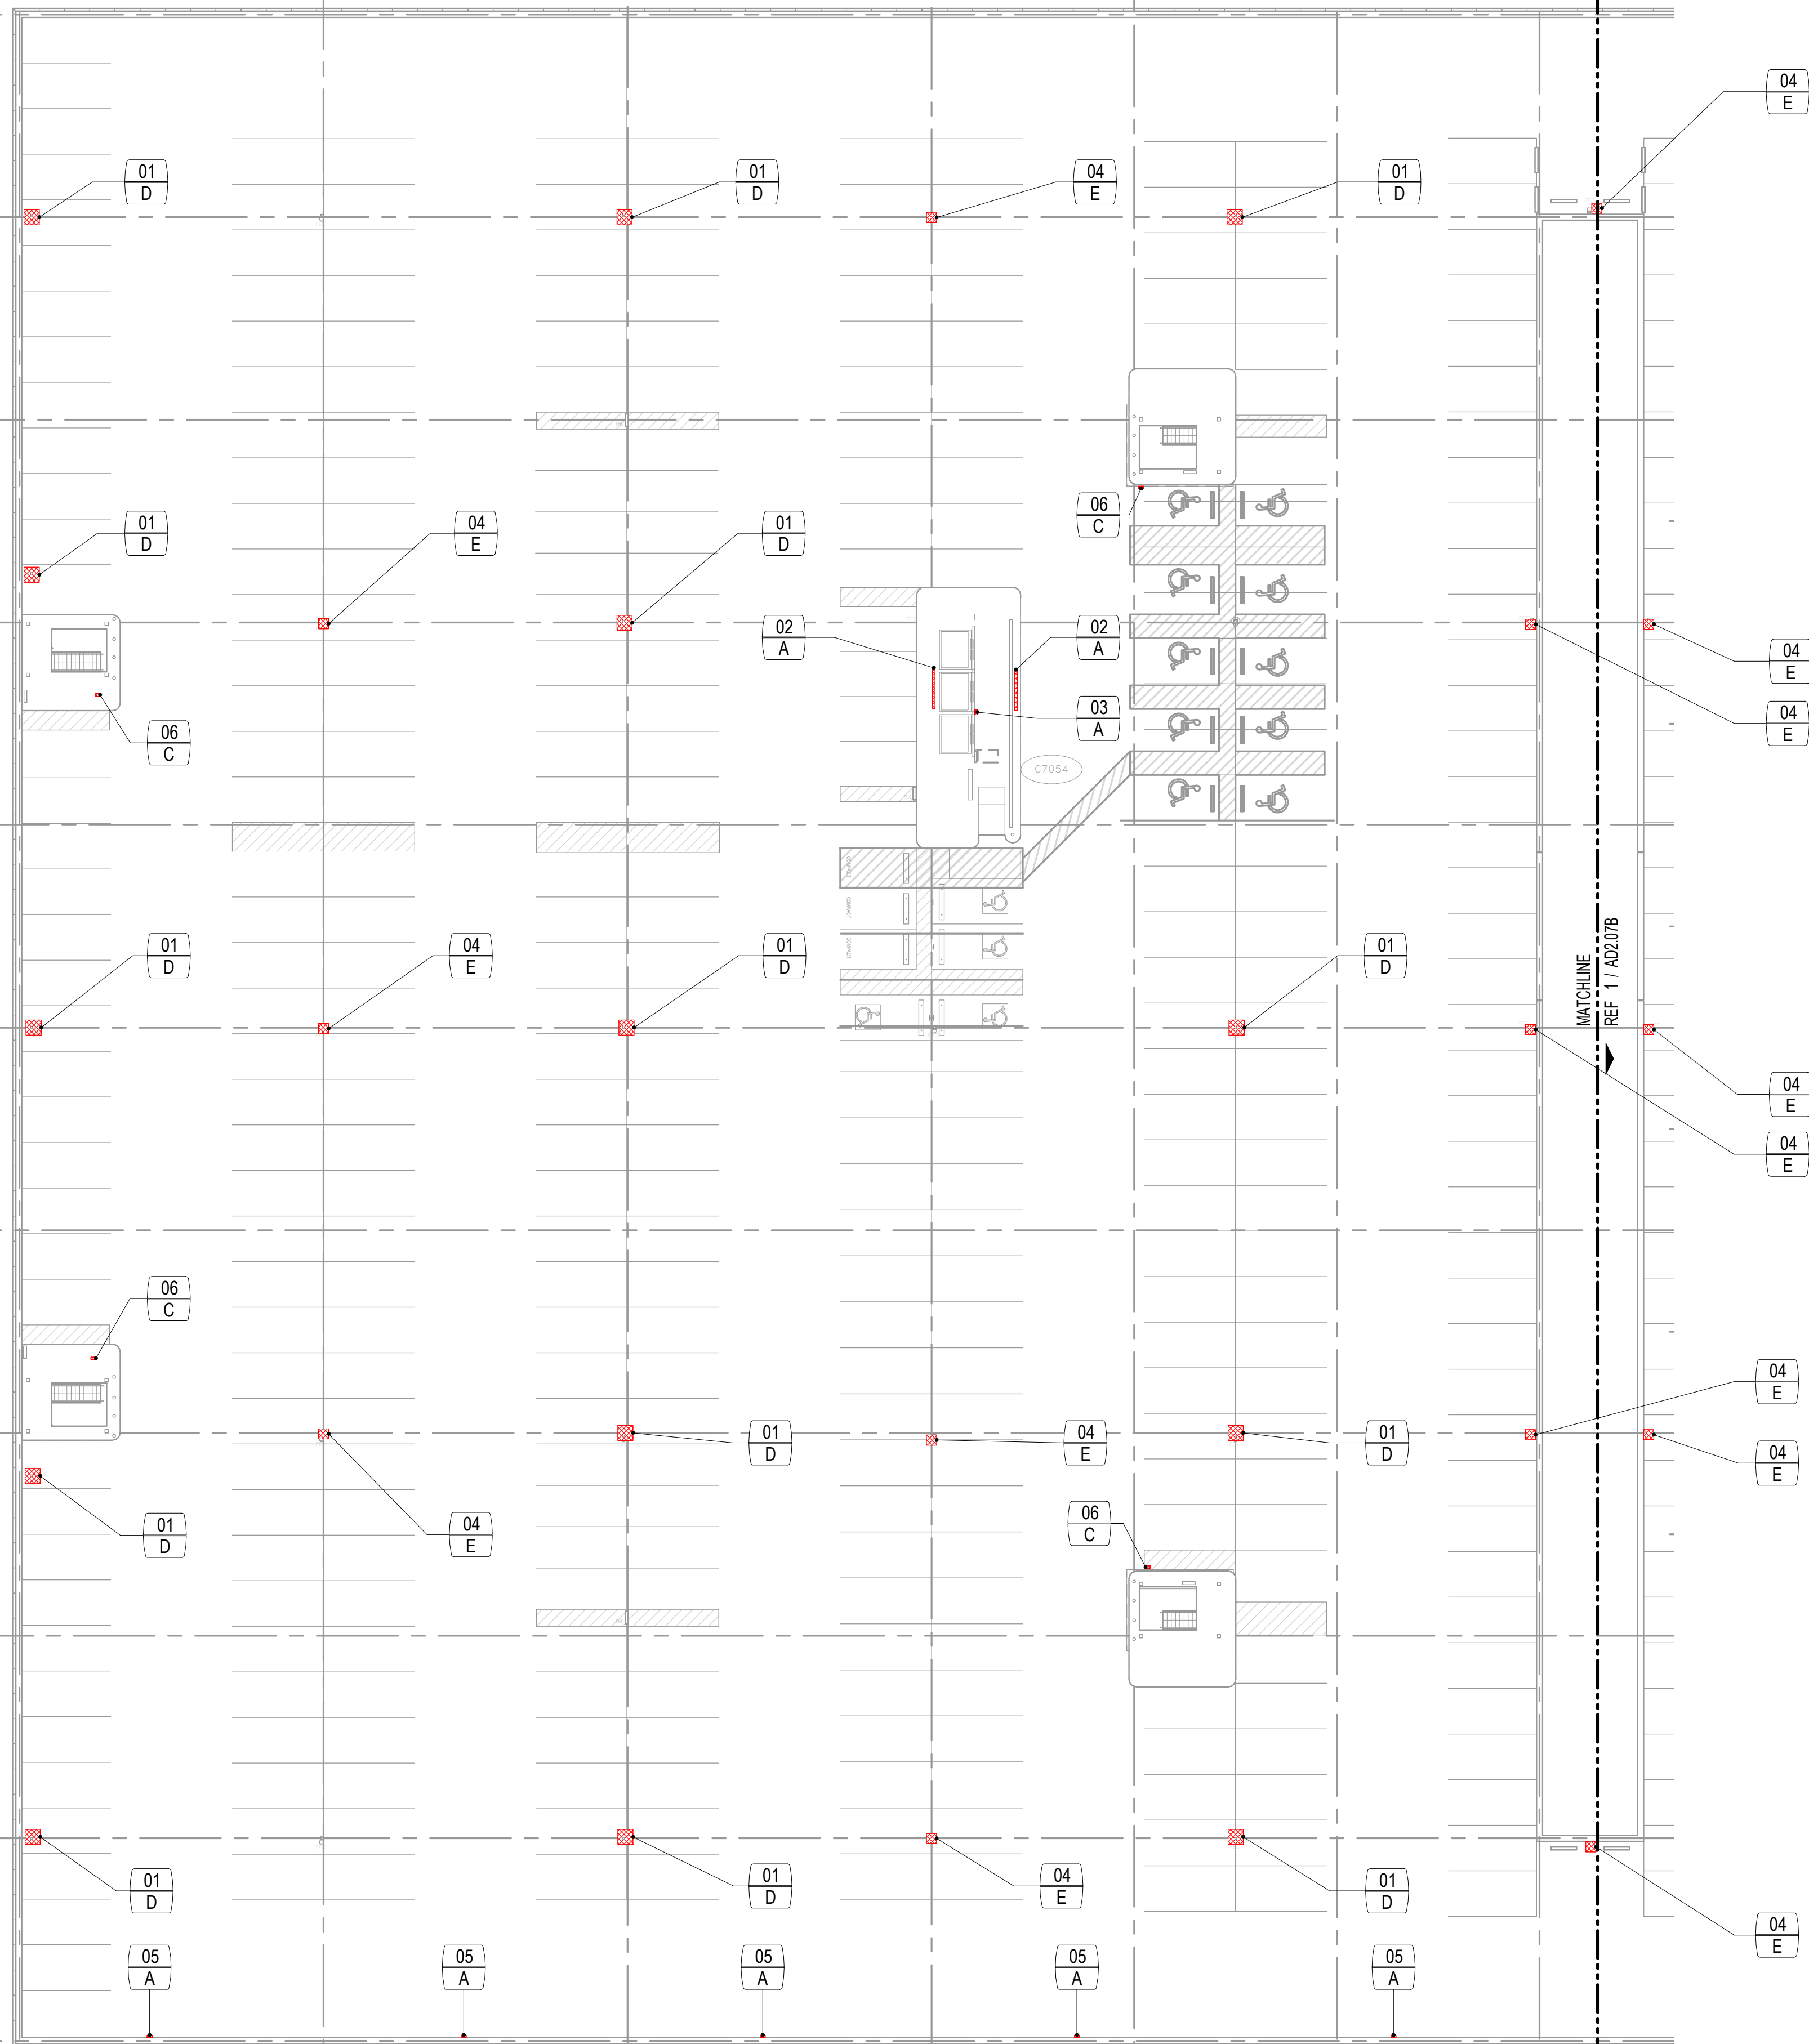FILE NAME: C:\Revit\Locals\TERM C SIGNAGE GARAGE\_DBhatti@pgal.com.rvt  
 DATE/TIME: 8/23/2024 4:41:56 PM



\*\* 0 +/- COLUMNS TO BE PAINTED IN THIS SECTOR, V.I.F.

LEVEL 07 - DEMO PLAN - SECTOR A 3/64" = 1'-0" 1

IMAGE	MARK	NOTES
	01	D
	02	A
	03	A

IMAGE REFERENCE


IMAGE	MARK	NOTES
	04	E
	06	C
	05	A

DEMO KEYNOTE


- A EXISTING SURFACE MOUNTED SIGN(S) TO BE REMOVED, PATCH/REPAIR AS REQUIRED.
- B EXISTING CEILING MOUNTED SIGN TO BE REMOVED, REMOVE SUSPENSION FRAME AND ATTACHMENTS FROM GARAGE STRUCTURAL CEILING. PATCH/REPAIR AS REQUIRED.
- C EXISTING SIGN(S) / ACCESSORY TO REMAIN.
- D EXISTING POLE MOUNTED SIGN TO BE REMOVED, PATCH/REPAIR AS REQUIRED.
- E EXISTING TUBE STEEL AND SUPPORT TO BE REMOVED, PATCH/REPAIR FLOOR AS REQUIRED.
- F CHEMICALLY STRIP OR SANDBLAST PAINT TO ORIGINAL BARE CONCRETE FINISH AND SKIM COAT WITH SIKA QUICK SMOOTH FINISH AT EXTERIOR WALL PERIMETER AT ELEVATOR AND STAIR CORES. TO BE PRIMED AND PAINTED.
- G CHEMICALLY STRIP OR SANDBLAST PAINT TO ORIGINAL BARE CONCRETE FINISH AND SKIM COAT WITH SIKA QUICK SMOOTH FINISH AT ALL GARAGE COLUMNS ONLY. TO BE PRIMED AND PAINTED. REFER TO "\*" IN REGARDS TO APPROXIMATE COLUMN QUANTITY.

\*\*\* NOTE \*\*\*  
 UNLESS NOTED OTHERWISE, ALL REMOVED SIGNS ARE TO BE REPLACED WITH A NEW SIGN

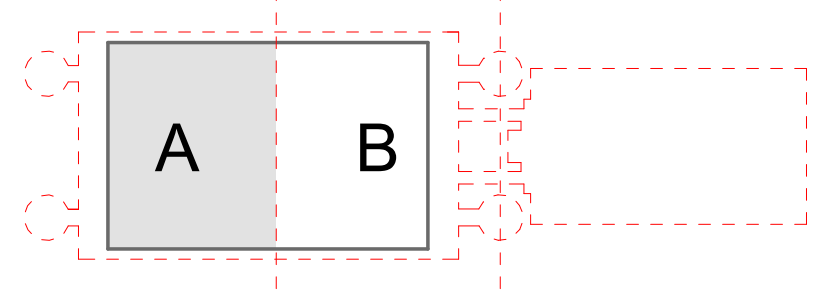
KEY PLAN




1:256 SCALE

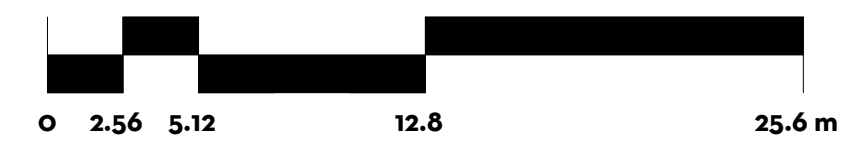

LEGEND

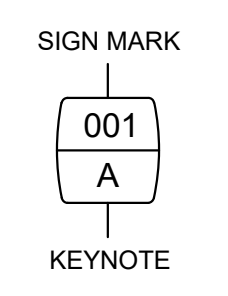

PLAN NORTH

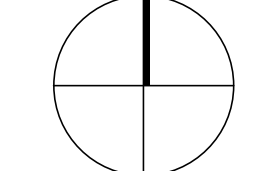

CLIENT



Client Name

ARCHITECT



PGAL  
 3131 BRIARPARK DR.  
 SUITE 200  
 HOUSTON, TX 77042  
 [T] 713 622 1444  
 [F] 713 968 9333  
 www.pgal.com

BSG PRJCT#  
 BSG-2024-111-IAH

DEPARTMENT OF AVIATION  
 RECOMMENDED:  
 HOUSTON AIRPORT SYSTEM  
 DIRECTOR OR DESIGN REPRESENTATIVE  
 HAS TIP # 24-103 - IAH

REGISTRATION  
 Copyright © 2024



DRAWING HISTORY

NO.	DATE	DESCRIPTION
01	04/10/2024	ISSUE FOR PERMIT
02	08/23/2024	ISSUE FOR BID

PROJECT NAME  
 IAH TERMINAL C  
 GARAGE  
 SIGNAGE &  
 WAYFINDING

PROJECT LOCATION  
 TERMINAL C  
 3500 NORTH  
 TERMINAL RD.  
 HOUSTON, TX 77032

PROJECT NUMBER  
 1004395

SHEET TITLE  
 LEVEL 07 - GARAGE  
 DEMO PLAN -  
 SECTOR A

SHEET NUMBER

AD2.07A



FILE NAME: C:\Revit\Locals\TERM C SIGNAGE GARAGE\_DBhatti@pgal.com.rvt  
 DATE/TIME: 8/23/2024 4:41:59 PM

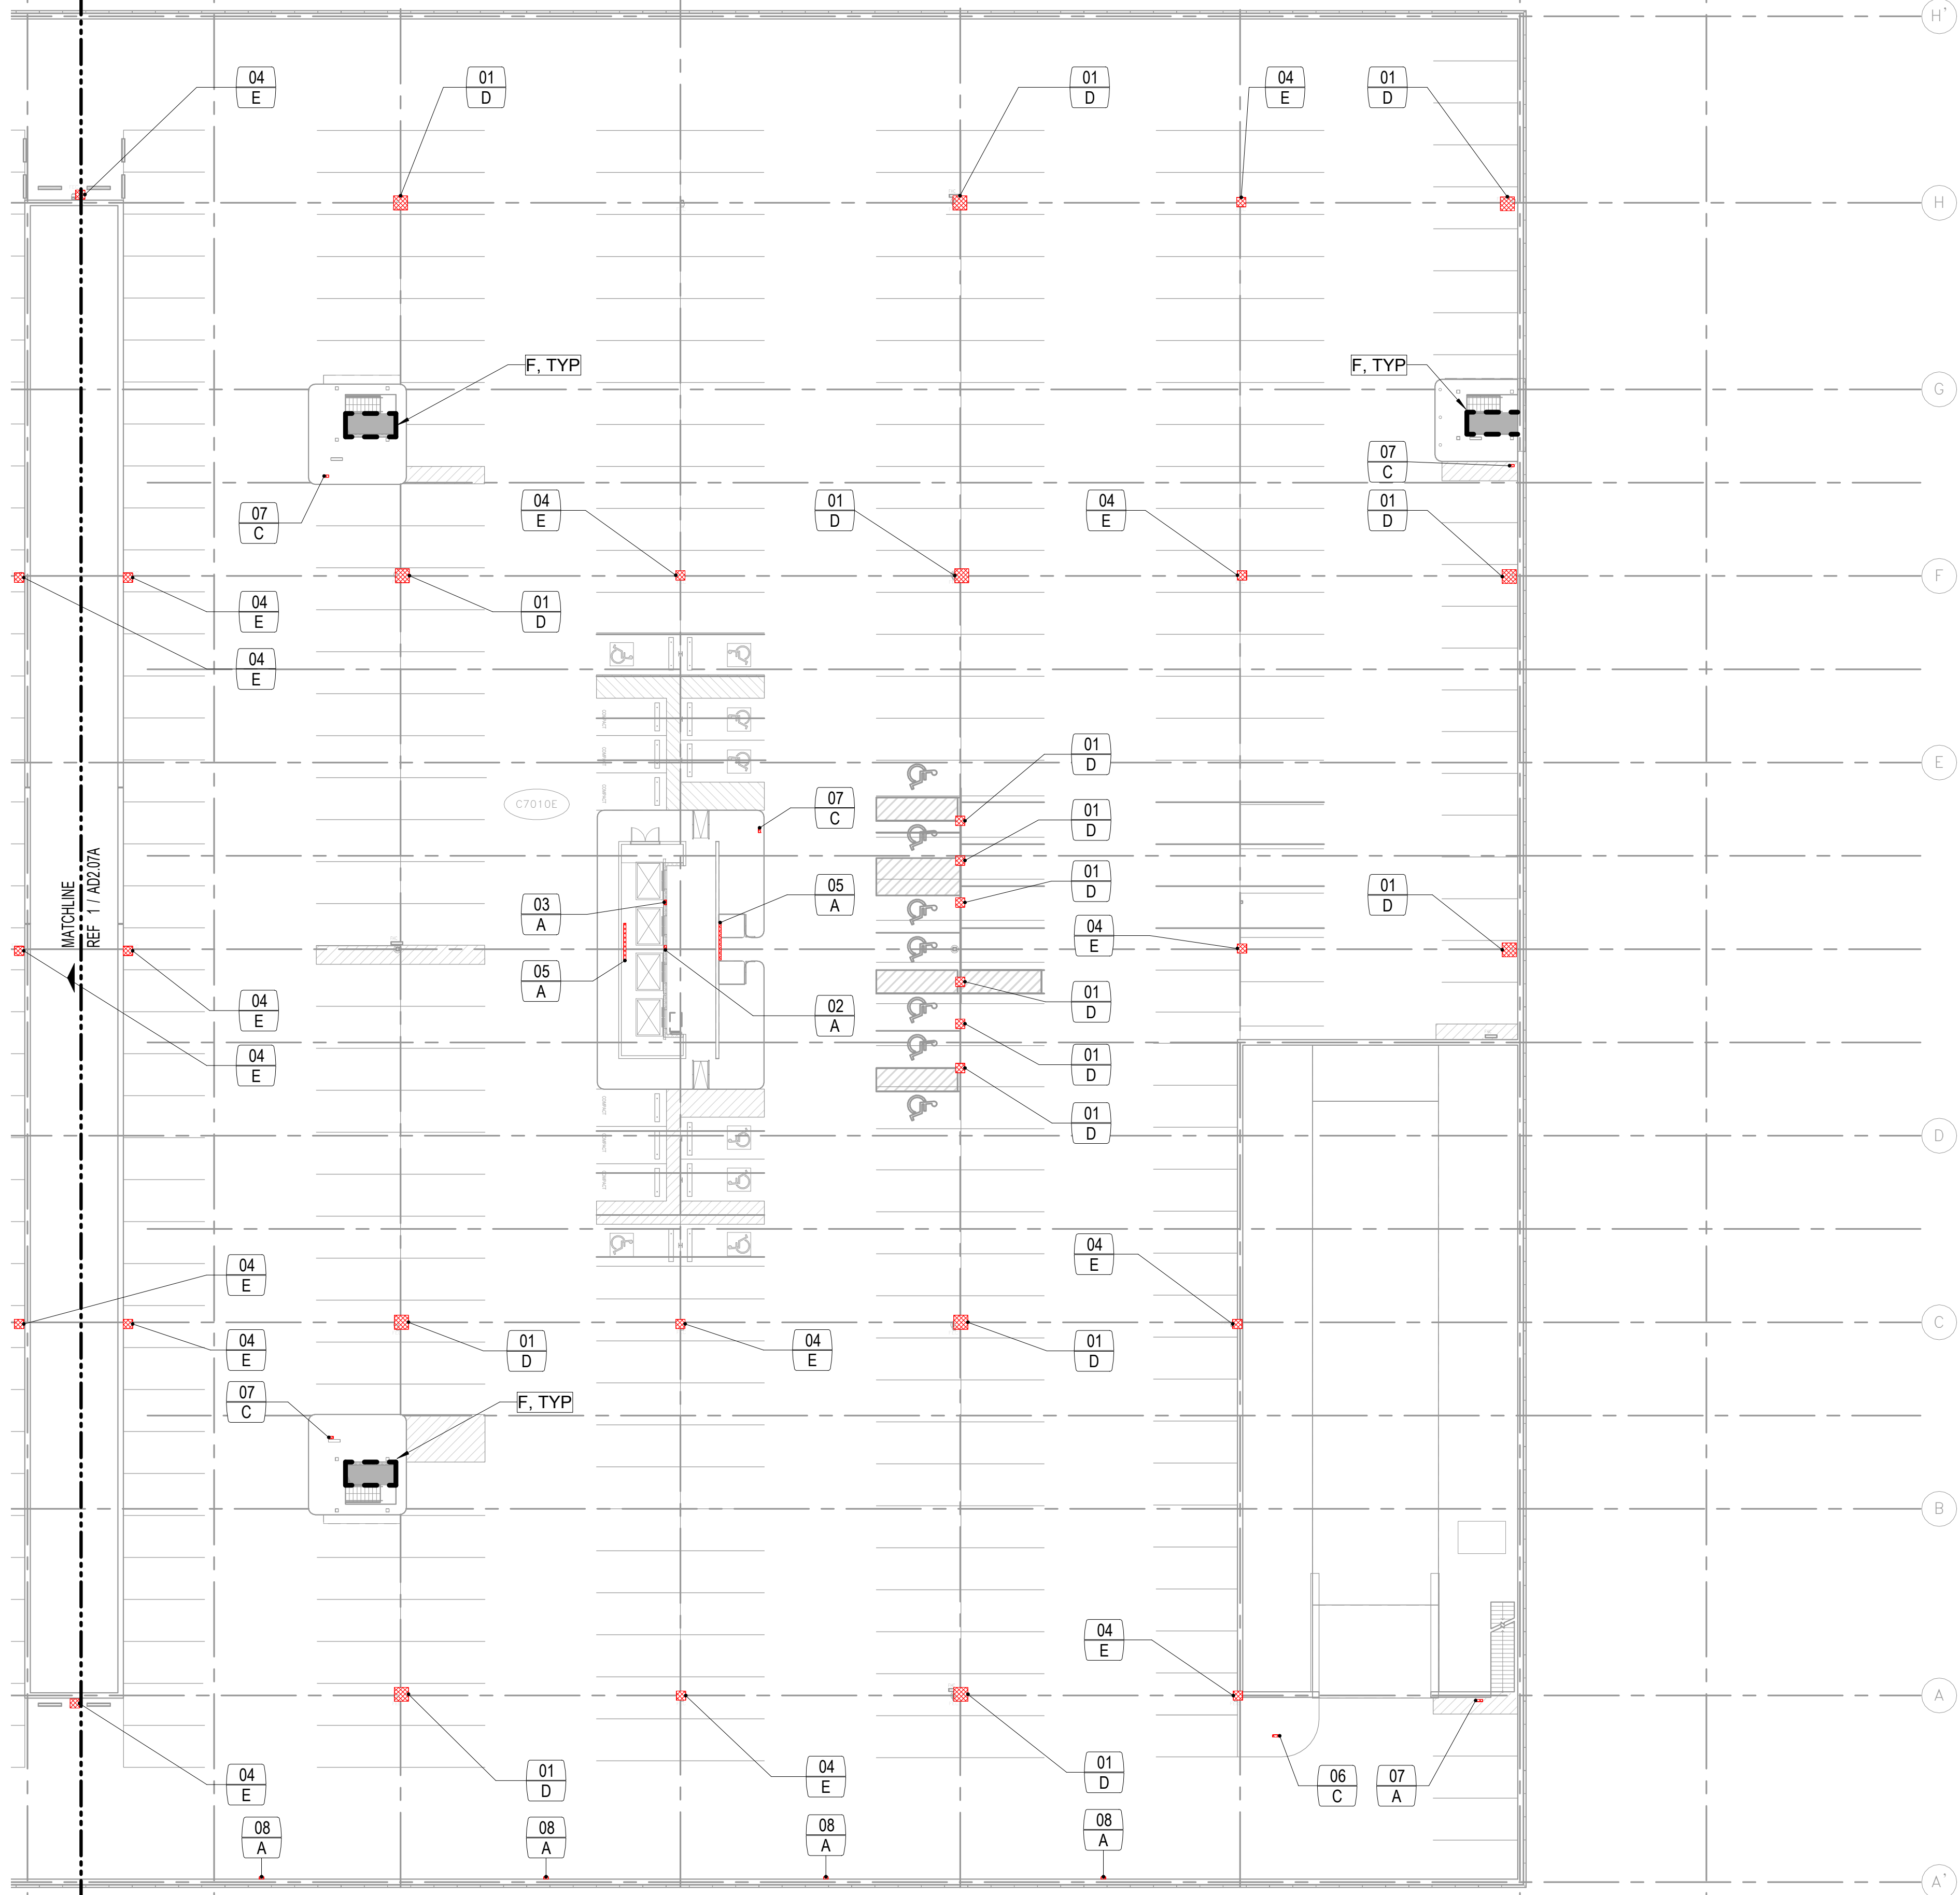


IMAGE	MARK	NOTES
	01 D	
	02 A	
	03 A	

IMAGE REFERENCE


IMAGE	MARK	NOTES
	04 E	
	07 C	
	05 A	
	06 C	
	08 A	

DEMO KEYNOTE

- A EXISTING SURFACE MOUNTED SIGN(S) TO BE REMOVED, PATCH/REPAIR AS REQUIRED.
- B EXISTING CEILING MOUNTED SIGN TO BE REMOVED, REMOVE SUSPENSION FRAME AND ATTACHMENTS FROM GARAGE STRUCTURAL CEILING. PATCH/REPAIR AS REQUIRED.
- C EXISTING SIGN(S) / ACCESSORY TO REMAIN.
- D EXISTING POLE MOUNTED SIGN TO BE REMOVED, PATCH/REPAIR AS REQUIRED.
- E EXISTING TUBE STEEL AND SUPPORT TO BE REMOVED, PATCH/REPAIR FLOOR AS REQUIRED.
- F CHEMICALLY STRIP OR SANDBLAST PAINT TO ORIGINAL BARE CONCRETE FINISH AND SKIM COAT WITH SIKA QUICK SMOOTH FINISH AT EXTERIOR WALL PERIMETER AT ELEVATOR AND STAIR CORES. TO BE PRIMED AND PAINTED.
- G CHEMICALLY STRIP OR SANDBLAST PAINT TO ORIGINAL BARE CONCRETE FINISH AND SKIM COAT WITH SIKA QUICK SMOOTH FINISH AT ALL GARAGE COLUMNS ONLY. TO BE PRIMED AND PAINTED. REFER TO "\*" IN REGARDS TO APPROXIMATE COLUMN QUANTITY.

\*\*\* NOTE \*\*\*  
 UNLESS NOTED OTHERWISE, ALL REMOVED SIGNS ARE TO BE REPLACED WITH A NEW SIGN

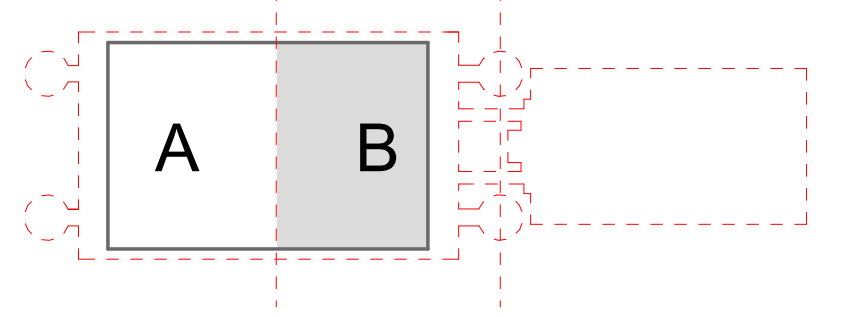
KEY PLAN




1: 256 SCALE



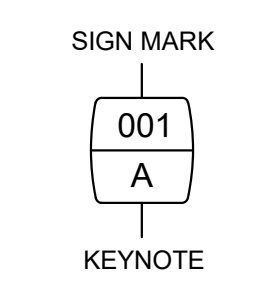LEGEND



PLAN NORTH

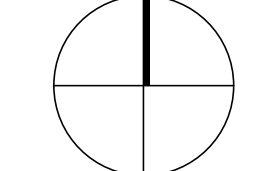

\*\* 0 +/- COLUMNS TO BE PAINTED IN THIS SECTOR, V.I.F.  
 LEVEL 07 - DEMO PLAN - SECTOR B 3/64" = 1'-0" 1

CLIENT  
  
 Client Name

ARCHITECT  
  
 PGAL

PGAL  
 3131 BRIARPARK DR.  
 SUITE 200  
 HOUSTON, TX 77042  
 [T] 713 622 1444  
 [F] 713 968 9333  
 www.pgal.com

BSG PRJCT#  
 BSG-2024-111-IAH

DEPARTMENT OF AVIATION  
 RECOMMENDED:  
 HOUSTON AIRPORT SYSTEM  
 DIRECTOR OR DESIGN REPRESENTATIVE  
 HAS TIP # 24-103 - IAH

REGISTRATION  
 Copyright © 2024



DRAWING HISTORY

NO.	DATE	DESCRIPTION
01	04/10/2024	ISSUE FOR PERMIT
02	08/23/2024	ISSUE FOR BID

PROJECT NAME  
 IAH TERMINAL C  
 GARAGE  
 SIGNAGE &  
 WAYFINDING

PROJECT LOCATION  
 TERMINAL C  
 3500 NORTH  
 TERMINAL RD.  
 HOUSTON, TX 77032

PROJECT NUMBER  
 1004395

SHEET TITLE  
 LEVEL 07 - GARAGE  
 DEMO PLAN -  
 SECTOR B

SHEET NUMBER

AD2.07B

# HOUSTON AIRPORT SYSTEM

## GEORGE BUSH INTERCONTINENTAL AIRPORT

Wayfinding Signage Design Intent Documents: **C Garage**

Wayfinding Updates Issue Date: 4-10-2024 100% CD Issued for Permit



**1.0 OVERVIEW & STANDARDS**

1.1 Introduction 1-1
1.2 Graphic Standards - Messages & Terminology 1-3
1.3 Graphic Standards - Typography 1-14
1.4 Graphic Standards - Symbols 1-16
1.5 Graphic Standards - Arrows 1-17
1.6 Graphic Standards - Colors 1-20
1.7 Sign Type Index - Parking C and D/E: Vehicular 1-21
1.8 Sign Type Index - Parking C and D/E: Pedestrian 1-24
1.9 Sign Type Index - Parking C and D/E: Regulatory 1-27

**2.0 DESIGN INTENT**

2.1 Design Intent - Parking Garage: Vehicular Signs 2-1
2.2 Design Intent - Parking Garage: Pedestrian Signs 2-17
2.3 Design Intent - Misc. Other Areas: Pedestrian Signs 2-29
2.4 Design Intent - Regulatory Signs 2-33

**3.0 DESIGN INTENT - SIGNAGE DETAILS**

3.1 Details - Parking Garage Signs 3-1

**4.0 LOCATION PLANS & MESSAGE SCHEDULES: LEVELS 1 AND 1A**

4.1 Sign Location Plan - Garage C: Level 1 - Sector 1 (C West) 4-1
4.2 Message Schedule - Garage C: Level 1 - Sector 1 (C West) 4-2
4.3 Sign Location Plan - Garage C: Level 1a - Sector 1 (C West) 4-14
4.4 Message Schedule - Garage C: Level 1a - Sector 1 (C West) 4-15

**5.0 LOCATION PLANS & MESSAGE SCHEDULES: LEVEL 2**

5.1 Sign Location Plan - Garage C: Level 2 - Sector 1 (C West) 5-1
5.2 Message Schedule - Garage C: Level 2 - Sector 1 (C West) 5-2
5.3 Sign Location Plan - Garage D/E: Level 2 - Sector 3 (D/E) 5-19
5.4 Message Schedule - Garage D/E: Level 2 - Sector 3 (D/E) 5-20

**6.0 LOCATION PLANS & MESSAGE SCHEDULES: LEVEL 3**

6.1 Sign Location Plan - Garage C: Level 3 - Sector 1 (C West) 6-1
6.2 Message Schedule - Garage C: Level 3 - Sector 1 (C West) 6-2
6.3 Sign Location Plan - Garage D/E: Level 3 - Sector 3 (D/E) 6-19
6.4 Message Schedule - Garage D/E: Level 3 - Sector 3 (D/E) 6-20

**7.0 LOCATION PLANS & MESSAGE SCHEDULES: LEVEL 4**

7.1 Sign Location Plan - Garage C: Level 4 - Sector 1 (C West) 7-1
7.2 Message Schedule - Garage C: Level 4 - Sector 1 (C West) 7-2
7.3 Sign Location Plan - Garage C: Level 4 - Sector 2 (C Central) 7-22
7.4 Message Schedule - Garage C: Level 4 - Sector 2 (C Central) 7-23
7.5 Sign Location Plan - Garage D/E: Level 4 - Sector 3 (D/E) 7-31
7.6 Message Schedule - Garage D/E: Level 4 - Sector 3 (D/E) 7-32

**8.0 LOCATION PLANS & MESSAGE SCHEDULES: LEVEL 5**

8.1 Sign Location Plan - Garage C: Level 5 - Sector 1 (C West) 8-1
8.2 Message Schedule - Garage C: Level 5 - Sector 1 (C West) 8-2
8.3 Sign Location Plan - Garage C: Level 5 - Sector 2 (C Central) 8-22
8.4 Message Schedule - Garage C: Level 5 - Sector 2 (C Central) 8-23
8.5 Sign Location Plan - Garage D/E: Level 5 - Sector 3 (D/E) 8-44
8.6 Message Schedule - Garage D/E: Level 5 - Sector 3 (D/E) 8-45

**9.0 LOCATION PLANS & MESSAGE SCHEDULES: LEVEL 6**

9.1 Sign Location Plan - Garage C: Level 6 - Sector 1 (C West) 9-1
9.2 Message Schedule - Garage C: Level 6 - Sector 1 (C West) 9-2
9.3 Sign Location Plan - Garage C: Level 6 - Sector 2 (C Central) 9-22
9.4 Message Schedule - Garage C: Level 6 - Sector 2 (C Central) 9-23
9.5 Sign Location Plan - Garage D/E: Level 6 - Sector 3 (D/E) 9-45
9.6 Message Schedule - Garage D/E: Level 6 - Sector 3 (D/E) 9-46

**10.0 LOCATION PLANS & MESSAGE SCHEDULES: LEVEL 7**

10.1 Sign Location Plan - Garage C: Level 7 - Sector 1 (C West) 10-1
10.2 Message Schedule - Garage C: Level 7 - Sector 1 (C West) 10-2
10.3 Sign Location Plan - Garage C: Level 7 - Sector 2 (C Central) 10-13
10.4 Message Schedule - Garage C: Level 7 - Sector 2 (C Central) 10-14

NOTE: Listings in this Table of Contents are clickable links; clicking on a listing will navigate directly to that page

# 1.0

## **1.0 OVERVIEW & STANDARDS**

- 1.1 Introduction
- 1.2 Graphic Standards - Messages & Terminology
- 1.3 Graphic Standards - Typography
- 1.4 Graphic Standards - Symbols
- 1.5 Graphic Standards - Arrows
- 1.6 Graphic Standards - Colors
- 1.7 Sign Type Index - Parking C and D/E: Vehicular
- 1.8 Sign Type Index - Parking C and D/E: Pedestrian
- 1.9 Sign Type Index - Parking C and D/E: Regulatory

## INTRODUCTION

Airports can be complex and difficult spaces to navigate. Numerous factors affect public perception and levels of customer service with the associated airport. This is particularly true when airport modifications or upgrade programs are undertaken. Older terminals and roadways typically have outdated and inconsistent wayfinding signage systems not reflective of current world principles and standards, and improvement projects create even more challenges for individuals functioning within the airport's wayfinding processes.

As an airport continues to evolve, it is important that its wayfinding and signage systems be designed to accommodate changes in a holistic manner. It must be understood that regardless of an individual facility's demarcation, the wayfinding pathways extend to and from the surrounding roadways, parking, curbsides, terminals and concourse areas. Facility architecture, services, functions and amenities, as well as vertical and horizontal routes, must always be carefully considered and viewed as part of the airport's interconnected and overall wayfinding system. A solid understanding of graphic/visual cues and human behavioral responses to wayfinding processes is paramount, and the established wayfinding system must also function seamlessly, within the built environment, without user hesitation or confusion, regardless of what area of the airport is being navigated.

## BACKGROUND

Over the next several years, Houston Airport System (HAS) will be implementing major transformations within all of their Houston Metropolitan Area airport properties, including George Bush Intercontinental (IAH), William P. Hobby Airport (HOU) and Ellington Field (EFD). These terminals and their associated facilities, as well as their surrounding roadway systems, will be improved and/or expanded, creating continually changing wayfinding conditions.

Recognizing the complexity of their redevelopment plans, HAS commissioned Labozan Associates, Inc. (LAI) to provide wayfinding analysis and evaluation of the overall existing wayfinding signage programs at all three Houston airport properties. Starting with IAH, LAI developed and presented several conceptual signage options that established a new holistic and refreshed "HAS Branded" wayfinding signage system. Through the use of computer-rendered "before and after" walk-through simulations (focused on typical wayfinding pathways throughout all IAH terminal facility and roadway areas), the analysis identified potential discrepancies that may occur as a result of the Airport's redevelopment plans, as well as how the new wayfinding system would address those issues holistically. HAS staff and stakeholders reviewed and approved the final conceptual wayfinding system option during a multi-phased consensus-building process. This newly approved HAS branded wayfinding system will be implemented within all current and future Houston area HAS airport property improvement programs.

## PURPOSE

This document presents information regarding the general design intent and planned implementation of HAS' new wayfinding signage system within IAH's Parking Garages C and D/E. It will present the new HAS parking/garage wayfinding signage system with regards to specific graphic design standards, general wayfinding signage design intent detailing, general sign location plans and typical examples of graphic depictions of messaging per sign locations within the scope of the IAH's Parking C Garage wayfinding program.

## SCOPE

The scope of this document includes the general design intent, criteria and descriptions for the updated HAS wayfinding signage system as they pertain to implementation within IAH Parking C Garage wayfinding program. This includes:

- Overview
- Graphic Standards
- Design Intent
- Sign Location Plans & Message Schedules (typical only)

Signs regulated by this document:

- All in scope new HAS parking/garage wayfinding system signage (as shown within this document and within public-use areas only), including directional, identification and informational wayfinding signs

Signs NOT regulated by this document:

- Terminal/Concourse signage
- Garage/Parking signage
- Roadways signage
- Tenant/concession/retail/advertising signs and standards
- Directory map artwork
- FIDS/BIDS/CUTE systems
- Regulatory or life-safety/egress signs
- Egress evacuation map artwork
- Branded Airline elements/systems/signs
- Rental car facilities/areas/signs
- Non-public, back-of-the-house, office or airside/runway/exterior areas/signs
- Sign demolition plans/details/etc
- Existing/non-updated (aka "older" or "original") IAH wayfinding signage

## DOCUMENT ORGANIZATION

This document is organized into the following chapters:

### 1.0 Overview & Standards

Includes the purpose, background, scope of work, general requirements and descriptions of the HAS wayfinding system. Also includes specific graphic and design criteria/universal standards applicable to all HAS wayfinding signage:

- Messages & Terminology - includes standardized HAS message hierarchy and terminology for each category organized by sign type/message priority (primary, secondary and tertiary).
- Typography - includes descriptions/uses of HAS wayfinding typography.
- Symbol Standards - includes a list of all HAS wayfinding universal symbols.
- Arrow Standards - includes HAS arrow standards, sizes, applications/meanings, rotation angles and placement.
- Color Standards - includes all universal color standards as applicable to the overall HAS wayfinding system.
- Sign Family Overview - includes a brief organized index of sign types.

### 2.0 Design Intent

General design intent of new IAH Parking C Garage wayfinding signage, including design intent, general mounting and intended sign usage.

### 3.0 Design Intent - Signage Details

Additional design intent details for IAH Parking C Garage wayfinding signage.

### 4.0 through 10.0 Location Plans & Message Schedules

Sign location plans and message schedules showing intended typical locations and messages of updated IAH Parking C Garage wayfinding signage.

#### Wayfinding Updates

Issue Date: 08-23-2024

Issue for Bid

REV.   
REV.   
REV. 

#### WARNING:

This record contains Sensitive Security Information that is controlled under 49 CFR parts 15 and 1520. No part of this record may be disclosed to persons with a "need to know," as defined in 49 CFR parts 15 and 1520, except with the written permission of the Administrator of the Transportation Security Administration or the Secretary of Transportation. Unauthorized release may result in civil penalty or other action. For U.S. government agencies, public disclosure is governed by 5 U.S.C. 552 and 49 CFR parts 15 and 1520.



THESE SHEETS ARE ISSUED FOR  
GRAPHICAL INFORMATION ONLY

08-23-2024

## GOVERNING BODIES, CODES & REGULATIONS

Governing bodies, codes, city ordinances and standards affecting the HAS wayfinding sign system are outlined in this section. The accompanying lists have been compiled from various entities and codes affecting HAS properties, however, it is not to be considered a complete or final list of requirements. These lists have been initially established by HAS, and changes will be coordinated with and approved by HAS as required on an individual case-by-case basis. If there is a conflict between a requirement listed here and another authoritative code or standard, the more stringent one shall be applied.

*NOTE: This section is for general reference only. It is the responsibility of the designer/fabricator/installer to always design/fabricate/engineer/install all signage to meet or exceed all current applicable local, state and national codes and regulations.*

### General Requirements

- An eggshell or satin finish (11 to 19 degree gloss on 60 degree gloss meter) on sign faces and elements is to be used in order to eliminate distracting levels of sheen.
- Letters and numbers on signs shall have a width-to-height ratio between 3:5 and 1:1 and a stroke-width-to-height ratio between 1:5 and 1:10.
- Characters and numbers on signs shall be sized according to the viewing distance from which they are to be read unless otherwise noted. The minimum height is measured using a capital letter height, and is shown as an "X" for the basis of measurement reference.
- For all tactile signs, the physical sign surface, background finish, contrast, materials, mounting heights/locations, letters/numbers and Braille shall be sized, spaced and applied to meet the most recent Federal ADA standards for Accessible Design, Texas Accessibility Standards and/or other local requirements.
- Elements and spaces of accessible facilities which shall be identified by the "International Symbol of Accessibility" are:
  - Parking spaces designated as reserved for individuals with disabilities
  - Accessible passenger loading zones
  - Accessible entrances when not all are accessible (inaccessible entrances shall have directional signs indicating the route to the nearest accessible entrance)
  - When older facilities contain non-accessible elevators and/or restrooms, the accessible elevators and restrooms must be identified as such
  - All other requirements as dictated by local, state and national standards/building codes and regulations

## Governing Bodies & Authoritative Organizations

The following list includes (but may not be limited to) the governing bodies and authoritative organizations as applicable to design and engineering at HAS properties:

- AAEE: American Association of Airport Executives
- AASHTO: American Association of State Highway & Transportation Officials
- ACC: Airport Consultants Council
- ACRP: Airport Cooperative Research Program: Report 52
- AIGA: American Institute of Graphic Arts
- ANSI: American National Standards Institute
- ASTM: American Society for Testing and Materials
- ATA: Air Transport Association of America
- AWI: Architectural Woodwork Institute
- CAA: Civil Aeronautics Administration
- CAB: Civil Aeronautics Board
- CABO: Council of American Building Officials
- CSI: Construction Specification Institute
- FAA: Federal Aviation Administration
- FHA: Federal Highway Administration
- IATA: International Air Transport Association
- NEMA: National Electric Manufacturers Association
- NFPA: National Fire Protection Association
- TXDOT: Texas Department of Transportation
- Other governing bodies and authoritative organizations as deemed necessary by HAS

### Codes & Regulations

The following list includes (but may not be limited to) the governing bodies and authoritative organizations as applicable to design and engineering at HAS properties:

- ADA: Americans with Disabilities Act
- ANSI: American National Standards Institute
- IBC: International Building Code
- LSC: Life Safety Code (written by the NFPA)
- NEC: No Exposure Certification
- SPC: Standard Plumbing Code (written by the NFPA)
- SBCCI: Standard Building Code
- TDLR: Texas Department of Licensing and Regulation
- UBC: Uniform Building Code
- Other codes and regulations as deemed necessary by HAS



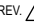
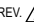
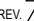

## DESIGN INTENT: DEFINITION & LIMITATIONS OF THIS DOCUMENT

Labozan Associates, Inc. (LAI) creates design intent documentation/specifications for the purposes of illustrating new wayfinding signage system design intent only, as it relates to the applicable wayfinding project and its predefined area of scope. LAI is not responsible or liable in any regard for final engineering, material selection, fabrication, installation or performance specification of any kind. The included design intent documentation and specifications are based on the most recent information and drawings as provided to LAI by HAS and the Project Team at the time of publication. Any included drawings, specifications or information within LAI's design intent documentation is to only be used as a general guideline. No information contained within LAI's design intent documentation or specifications should be construed as engineered elements or used for the purposes of final sign fabrication, specification or installation. The Fabricator/Contractor/Installer is responsible for all final design, engineering, fabrication and material specifications with regard to all structural, electrical, mechanical, foundation, installation and material selection/processes, and must be approved by HAS prior to final fabrication/install. In addition:

- All final design, engineering and amount/sizing of structural sign support elements, material types/thicknesses, dimensions, welds and attachment methods shall be performed and approved by an engineer licensed in the State of Texas to meet or exceed all applicable local, state and national codes, standards and regulations. Where a conflict occurs between LAI's design intent documentation/specifications, the more stringent requirements per all codes apply.
- Final engineering, dimensions, materials and fabrication are the responsibility of the Contractor/Fabricator/Installer, and the Contractor/Fabricator/Installer must ensure the highest quality fit and finish for all components of the completed product. All final detailing and specifications are to be provided by the Contractor/Fabricator/Installer within their final fabrication-ready shop drawings and must be approved by HAS prior to final fabrication and installation.
- Wherever dissimilar metals or possibly corrosive installation surfaces are in contact, always separate contact surfaces prior to assembly or installation with the necessary protective coatings/gaskets/washers to prevent galvanic, moisture related and all other types of corrosion.
- Final fabrication methods, materials, quality and fit/finish to be reviewed and approved by HAS through prototype reviews and testing prior to final fabrication production run/installation processes.
- Colors shown are for reference only, and are subject to the limitations of the printing process and/or variance of electronic screen displays. Refer to color system swatches and/or final finish samples for accurate reference.
- All messages shown in this document must be reviewed by the Contractor/Fabricator/Installer prior to final fabrication and installation (see message schedules for actual messaging by individual location and sign type). Any discrepancies will be identified, documented, corrected and coordinated with HAS during the C.A. process and prior to final fabrication and installation.
- Sign locations/orientations and plans shown are approximations based on the most current plan drawings as provided to LAI at the time of the document's completion. Sign locations are for general design intent and wayfinding planning purposes only. They should not be construed or deemed as absolute or final locations. Field verification, marking and documentation of every final location is to be performed by the Contractor/Fabricator/Installer and coordinated with HAS for final approval.
- All final install locations must be marked and verified in the field for proper structural integrity, adequate line of sight, utilities/property-line/other existing or future interferences, and must be in complete compliance with all local, state and national codes prior to fabrication or installation.
- Adjustments to sign locations shown must be documented by the Contractor/Fabricator/Installer and provided to HAS for final approval.
- Demolition plans of existing wayfinding signage is not in scope nor included; survey, removal and/or relocation of existing signage is to be coordinated by the Contractor/Fabricator/Installer with HAS.

HAS TIP # 24 -103 - IAH

BSG PRJCT# BSG-2024-111-IAH

 <p><b>GEORGE BUSH INTERCONTINENTAL AIRPORT</b> Wayfinding Signage Design Intent Documents <b>C Garage</b></p>	 <p>Louville, Colorado P: 303.494.7849 www.labozan.com</p>	<p><small>These documents are intended to illustrate design intent, and should only be used as a general guideline. No information contained here should be construed as engineered elements. The fabricator/contractor shall be responsible for all engineering and specifications with regard to structural, electrical, mechanical, foundation and installation. Information and illustrations contained here are part of an original unpublished design by Labozan Associates, Inc. Detailing and information contained on these pages shall not be reproduced, copied or utilized in any way except for the specific project for which they were created without previous written authorization from Labozan Associates, Inc.</small></p> <p><small>© 2024 by Labozan Associates, Inc.</small></p>	<p><b>Wayfinding Updates</b> Issue Date: 08-23-2024 Issue for Bid</p> <p>REV.  REV.  REV. </p>	<p><b>WARNING:</b> <small>This record contains Sensitive Security Information that is controlled under 49 CFR parts 15 and 1520. No part of this record may be disclosed to persons with a "need to know," as defined in 49 CFR parts 15 and 1520, except with the written permission of the Administrator of the Transportation Security Administration or the Secretary of Transportation. Unauthorized release may result in civil penalty or other action. For U.S. government agencies, public disclosure is governed by 5 U.S.C. 552 and 49 CFR parts 15 and 1520.</small></p>	 <p>08-23-2024</p>	<p>THESE SHEETS ARE ISSUED FOR GRAPHICAL INFORMATION ONLY</p>	<p><b>1.1 INTRODUCTION</b> (2 of 2) BSG PRJCT# BSG-2024-111-IAH HAS TIP # 24 -103 - IAH Sheet: 1-2</p>
--	---	---	---	--	---	---	--

## MESSAGE FUNCTIONS

This section defines the four basic functions of a “message” as it pertains to the HAS wayfinding system. It is to be utilized by anyone designing or specifying new or updated wayfinding signage to be implemented at HAS airport properties.

### Directional Messages

Directional messages are the main source of information enabling wayfinding traffic to choose the proper route to a specific destination point. This process involves selecting the correct destination point, and then determining at which point a change of direction will be required. Properly placed directional signage at decision points in adequate quantities is necessary for rapid movement of passengers, employees and vehicles.

### Identification Messages

Identification messages mark specific locations/destinations within a defined area or environment. In addition to these locations, identification messages provide proper public exposure to leased tenant spaces and other spaces as governed by Airport Management.

### Informational Messages

Informational messages typically provide specific, detailed and supplementary wayfinding information to assist in orientation within an unfamiliar and/or complex environment. In addition, informational messaging that is graphic in nature (i.e. directory maps) help with providing precise locations for the user in context to the overall facility and its destinations/amenities/etc..

### Regulatory / Safety Messages

Regulatory/Safety messages relate to DPS, FAA, TSA and CBP requirements, as well as other federal, state, and local city codes/regulations. In general, these messages provide travelers with important regulatory information, such as travel advice, warnings and restrictions.

### Temporary Messages

Temporary messages generally fall into a separate category of messages, and are typically established during the course of fluctuating interim wayfinding conditions due to construction related processes. Temporary signs shall only be used on an interim basis while permanent signs are in the process of fabrication, repair and/or maintenance. Temporary signs are also an excellent way to test new wayfinding elements and locations prior to final fabrication. Note that all temporary messages shall be reviewed and approved by HAS and Airport Management prior to implementation.

## MESSAGE HIERARCHY

This section defines standards for a complete and uniform hierarchy of HAS wayfinding system messages and terminology. These standards shall be utilized for all new and updated wayfinding signage implemented at HAS properties.

The need for visual continuity among all messages and information of the same hierarchy will help eliminate elements which may interrupt the functional wayfinding process or add confusion. Clear and concise information presented by Primary and Secondary signs/messaging systems ensure efficient passenger circulation. Tertiary signs/messaging must always be coordinated with primary and secondary signs/messaging, as well as interior design features and elements. This tertiary category of signs should also always be visually distinguished from other wayfinding signs.

Messages will always be organized and maintained within three distinct and functionally tiered categories: Primary, Secondary and Tertiary (see Figure 1.2.1 for a full message hierarchy list).

### Primary Messages

This information shall be the largest and the most visible information on each sign. Primary information includes, but may not be limited to:

- Exterior direction to and identification of Terminal(s).
- Exterior direction to major vehicular arteries (i.e. nearby access roads).
- IAH example: interior direction to and identification of multiple Terminals if applicable (i.e. A, B, C, D, E) and inter-terminal transit (i.e. Skyway and Subway trains)
- Interior direction to and identification of Gates.
- Interior direction to and identification of Baggage Claim and Check-In.

### Secondary Messages

This information supplements and reinforces information already conveyed by the primary messages and signs listed above. It usually indicates the auxiliary services and support functions of the facility. Secondary information includes, but may not be limited to:

- Exterior direction to and identification of Ticketing/Check-In, Baggage Claim, and specific Parking Facilities/Areas
- Exterior identification of Rental Car Return, Airport Exit, etc..
- Interior direction to and identification of Elevators and Restrooms.
- Interior direction to Parking and Ground Transportation.

### Tertiary Messages

Tertiary sign information supplements both the primary and secondary messages, and typically informs visitors of regulations and warnings. All regulatory/safety signs are generally considered to be tertiary within the HAS wayfinding system. Tertiary information includes, but may not limited to:

- Exterior and Interior TSA related notification messages.
- Interior CBP related notification messages.
- Exterior “No Parking” messages.
- FAA required warnings, notifications and information.
- Other messages required by code.

## MESSAGE TERMINOLOGY

### Basic Requirements

Terminology, or nomenclature as it applies to airport signage and wayfinding systems, is a standardized set of words, syntax, grammar, spelling, and symbols used to communicate information to the user of the airport. Terminology systems ensure that information is presented in a consistent way, and that the content of this information is always clear and concise. When a term is shown with a corresponding symbol, that term will always appear with its symbol as indicated in Figure 1.4.1, unless otherwise noted.

### Change Procedures for Terminology

Consistent use of terminology for established messaging within the HAS wayfinding system is always required. All changes to or additions of new terminology shall require coordination, review and approval by HAS.

## FOREIGN LANGUAGE: APPLICATION & USE

### Universal Symbols

Using universal symbols will assist international and non-English speaking travelers with locating airport destinations in a universal manner, while also eliminating the possibility of unintended bias for individual groups and languages. See Section 1.4 Graphic Standards - Symbols.

### Informational Wayfinding Signage and Supplemental Materials

Accommodating multiple languages on informational wayfinding signage (i.e. directories and information centers), as well as supplemental materials (such as hand-outs and maps) is the recommended and preferred method of providing detailed wayfinding information to the most diverse groups of non-English speaking airport users. Standards and guidelines for this type of information is not covered within this document and is to be coordinated with HAS as applicable and required.

### Foreign Language Translations

Foreign language translations, if shown within this document, are placeholders only. All foreign language translations that are used within the HAS wayfinding system are to be provided by professional translators and will be coordinated with HAS staff for final approval prior to final fabrication and installation. All foreign language translations will use the most common and universal dialect for each individual foreign language as deemed appropriate by professional translators, and is to be coordinated with HAS staff for final approval prior to final fabrication and installation.

#### Wayfinding Updates

Issue Date: 08-23-2024

Issue for Bid

REV. 

REV. 

REV. 

#### WARNING:

This record contains Sensitive Security Information that is controlled under 49 CFR parts 15 and 1520. No part of this record may be disclosed to persons with a "need to know," as defined in 49 CFR parts 15 and 1520, except with the written permission of the Administrator of the Transportation Security Administration or the Secretary of Transportation. Unauthorized release may result in civil penalty or other action. For U.S. government agencies, public disclosure is governed by 5 U.S.C. 552 and 49 CFR parts 15 and 1520.



THESE SHEETS ARE ISSUED FOR GRAPHICAL INFORMATION ONLY

08-23-2024

**MESSAGE HIERARCHY - HAS Parking**

PRIMARY	SECONDARY	TERTIARY	REGULATORY/STATUTORY
<p><b>Vehicular Directional</b></p> <ul style="list-style-type: none"> <li>- Parking</li> <li>- Exit</li> <li>- Parking X (used only at IAH: "X" = terminal letter):                             <ul style="list-style-type: none"> <li>- Parking AB; Parking C; Parking DE</li> </ul> </li> <li>- Parking C WEST; Parking C CENTRAL; Parking DE</li> <li>- Additional Parking</li> <li>- Return to Parking</li> <li>- Level X; Levels X-X ("X" = garage level numbers)</li> <li>- Exit: Credit Cards</li> <li>- Exit: Cashier</li> </ul>	<p><b>Vehicular Directional</b></p> <ul style="list-style-type: none"> <li>- Terminal X (used only at IAH: "X" = terminal letter)</li> <li>- X Arrivals (used only at IAH: "X" = terminal letter)</li> <li>- ecopark</li> <li>- Return to Parking</li> <li>- High Vehicles</li> <li>- Upper Levels</li> <li>- KEEP RIGHT (or LEFT)</li> <li>- RAMP DOWN (or UP)</li> </ul>	<p><b>Vehicular Directional</b></p> <ul style="list-style-type: none"> <li>- Employees Only</li> </ul>	<p>Notifications:</p> <ul style="list-style-type: none"> <li>- AUTHORIZED PERSONNEL ONLY</li> <li>- DO NOT ENTER</li> <li>- Warning: Restricted Area, Do Not Enter</li> <li>- Warning: Emergency Exit Only, Door Monitored by Alarm</li> <li>- CAUTION: WATCH FOR CROSSING VEHICLES</li> <li>- CLEARANCE: X'-X" ("X" = feet and inches of lowest clearance)</li> <li>- Etc...</li> </ul> <p>Other / General:</p> <ul style="list-style-type: none"> <li>- No Smoking</li> <li>- All life safety/egress</li> <li>- Elevator escape route maps/notifications (with ADA code compliance)</li> </ul>
<p><b>Vehicular Identification</b></p> <ul style="list-style-type: none"> <li>- Parking X (used only at IAH: "X" = terminal letter)</li> <li>- Level X ("X" = garage level number)</li> </ul>	<p><b>Vehicular Identification</b></p> <ul style="list-style-type: none"> <li>- Parking X (used only at IAH: "X" = terminal letter):                             <ul style="list-style-type: none"> <li>- Parking AB; Parking C; Parking DE</li> </ul> </li> <li>- Parking C WEST; Parking C CENTRAL; Parking DE</li> <li>- Welcome to:...</li> <li>- Level X ("X" = level number)</li> <li>- Exit</li> <li>- Exit: Cashier</li> <li>- Exit: Credit Cards</li> </ul>	<p><b>Vehicular Identification</b></p> <ul style="list-style-type: none"> <li>- CAUTION: Crossing Traffic</li> <li>- CAUTION: PEDESTRIAN CROSSING</li> <li>- CAUTION: Clearance X'-X" ("X" = height number)</li> <li>- Employees Only</li> <li>- Restricted Areas</li> <li>- Reserved Parking</li> </ul>	
<p><b>Pedestrian Directional</b></p> <ul style="list-style-type: none"> <li>- Terminal(s) X (used only at IAH: "X" = terminal letter)</li> <li>- Section X ("X" = section number)</li> <li>- Departures</li> <li>- Arrivals</li> </ul>	<p><b>Pedestrian Directional</b></p> <ul style="list-style-type: none"> <li>- Elevator</li> <li>- Stairs</li> <li>- Use: Elevator X (used only at IAH: "X" = elevator ID):                             <ul style="list-style-type: none"> <li>- C Elevator X ("X" = WEST, CENTRAL, WEST-2)</li> <li>- DE Elevator X ("X" = EAST, EAST-2)</li> </ul> </li> </ul>	<p><b>Pedestrian Directional</b></p> <ul style="list-style-type: none"> <li>- Use Elevators/Stairs to Level X ("X" = garage level number)</li> <li>- Use Crosswalk to Garage</li> <li>- Use Elevator to Level 3 Bridge</li> <li>- Exit and use Crosswalk to Garage</li> <li>- Walk around Elevator &amp; continue on Bridge Walkway to Garage</li> <li>- Walkway behind Elevators</li> <li>- Bridge to.... (used only at IAH)</li> </ul>	
<p><b>Pedestrian Identification</b></p> <ul style="list-style-type: none"> <li>- Terminal(s) X (used only at IAH: "X" = terminal letter)</li> <li>- A (B, C, D, E) Column ID Bands ((used only at IAH)</li> <li>- Parking X (used only at IAH: "X" = terminal letter)</li> <li>- Section X ("X" = section number)</li> <li>- C Elevator X ("X" = WEST, CENTRAL, WEST-2)</li> <li>- DE Elevator X ("X" = EAST, EAST-2)</li> </ul>	<p><b>Pedestrian Identification</b></p> <ul style="list-style-type: none"> <li>- Elevator</li> <li>- Stairs</li> </ul>		
<p><b>Vehicular Informational</b></p> <ul style="list-style-type: none"> <li>- SPACES THIS GARAGE (counts by entire garage area)</li> <li>- ADDITIONAL PARKING: Use Levels 4-6 to: X (used only at IAH: "X" = Garage area):                             <ul style="list-style-type: none"> <li>- Parking C WEST; Parking C CENTRAL; Parking DE</li> </ul> </li> <li>- Available Spaces</li> <li>- Parking Rate Information (per Airport and Garage/Lot as req'd)</li> </ul>	<p><b>Pedestrian Informational</b></p> <ul style="list-style-type: none"> <li>- Information</li> <li>- Level Directory</li> </ul>		

NOTE: This message/terminology list is the most recent at the time of this document's publication; messages/terminology may be expanded and/or change depending on the unique needs, design conditions & requirements of individual HAS wayfinding modernization programs during design development processes; Always verify and obtain the most recent HAS messaging and terminology list prior to any final design or message specification

Figure 1.2.1

HAS Wayfinding Message Hierarchy List: **Parking/Garage Areas**



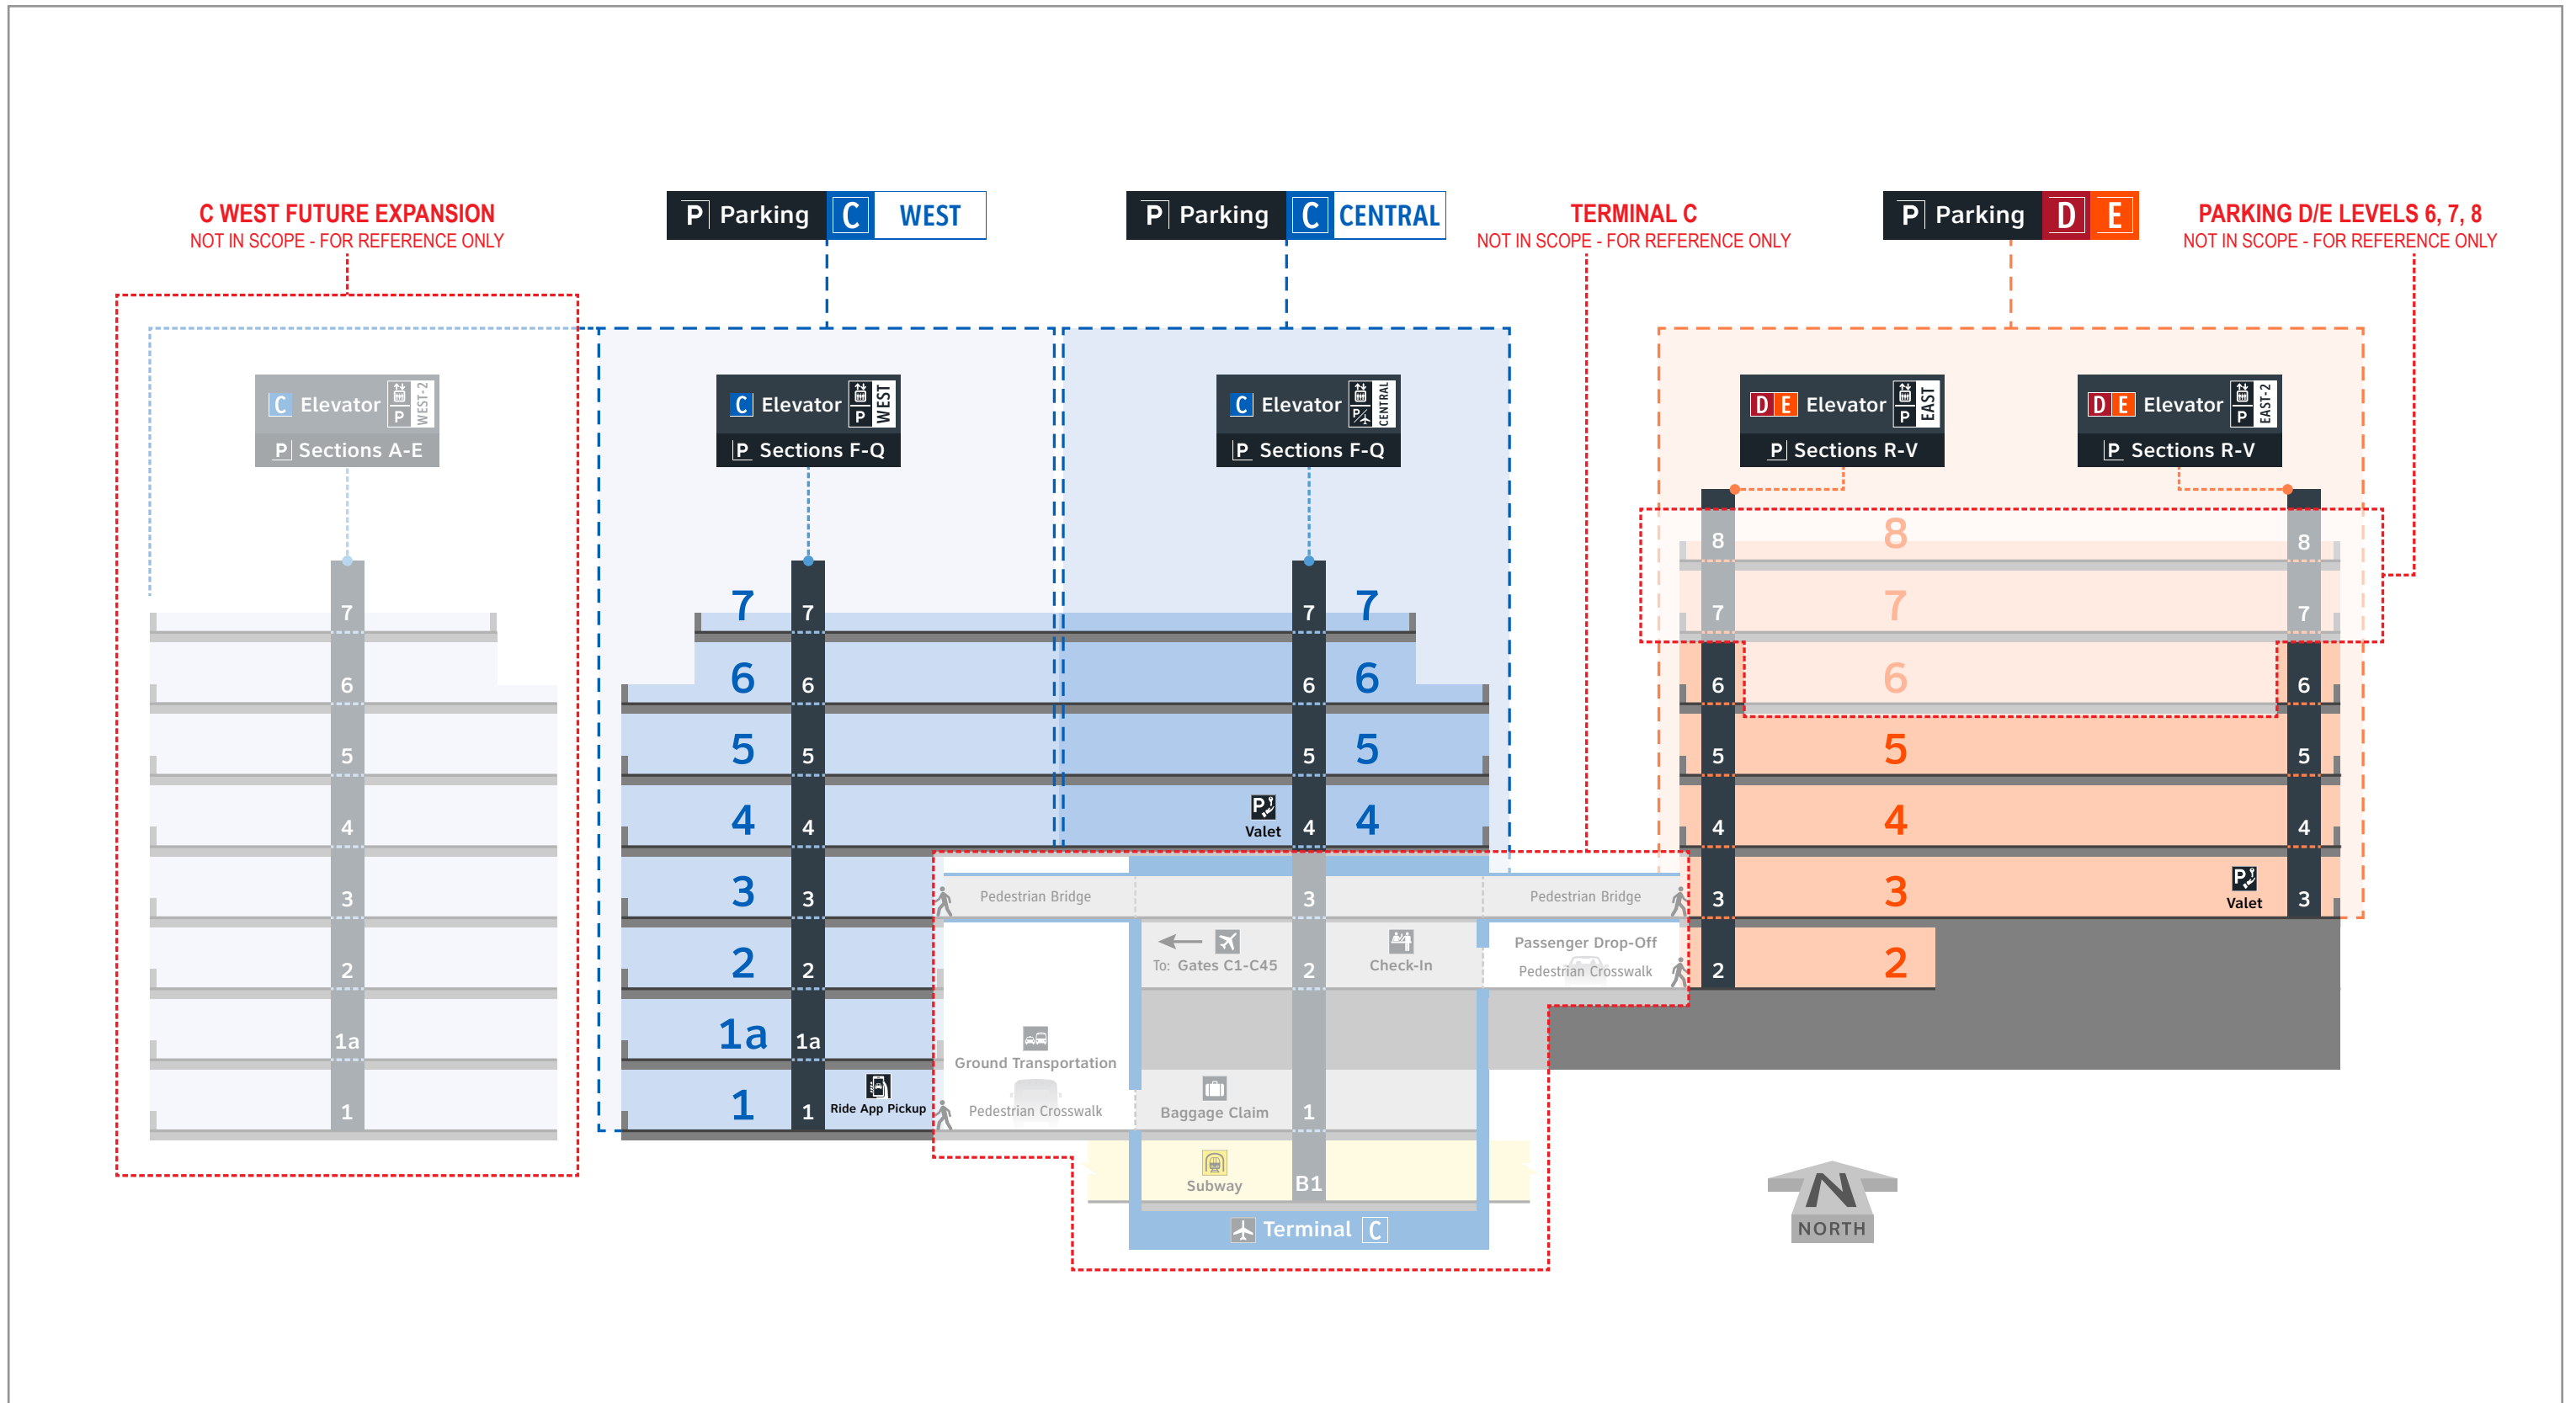


Figure 1.2.3a

Parking C & D/E: **New Terminology** Vertical Section-cut View

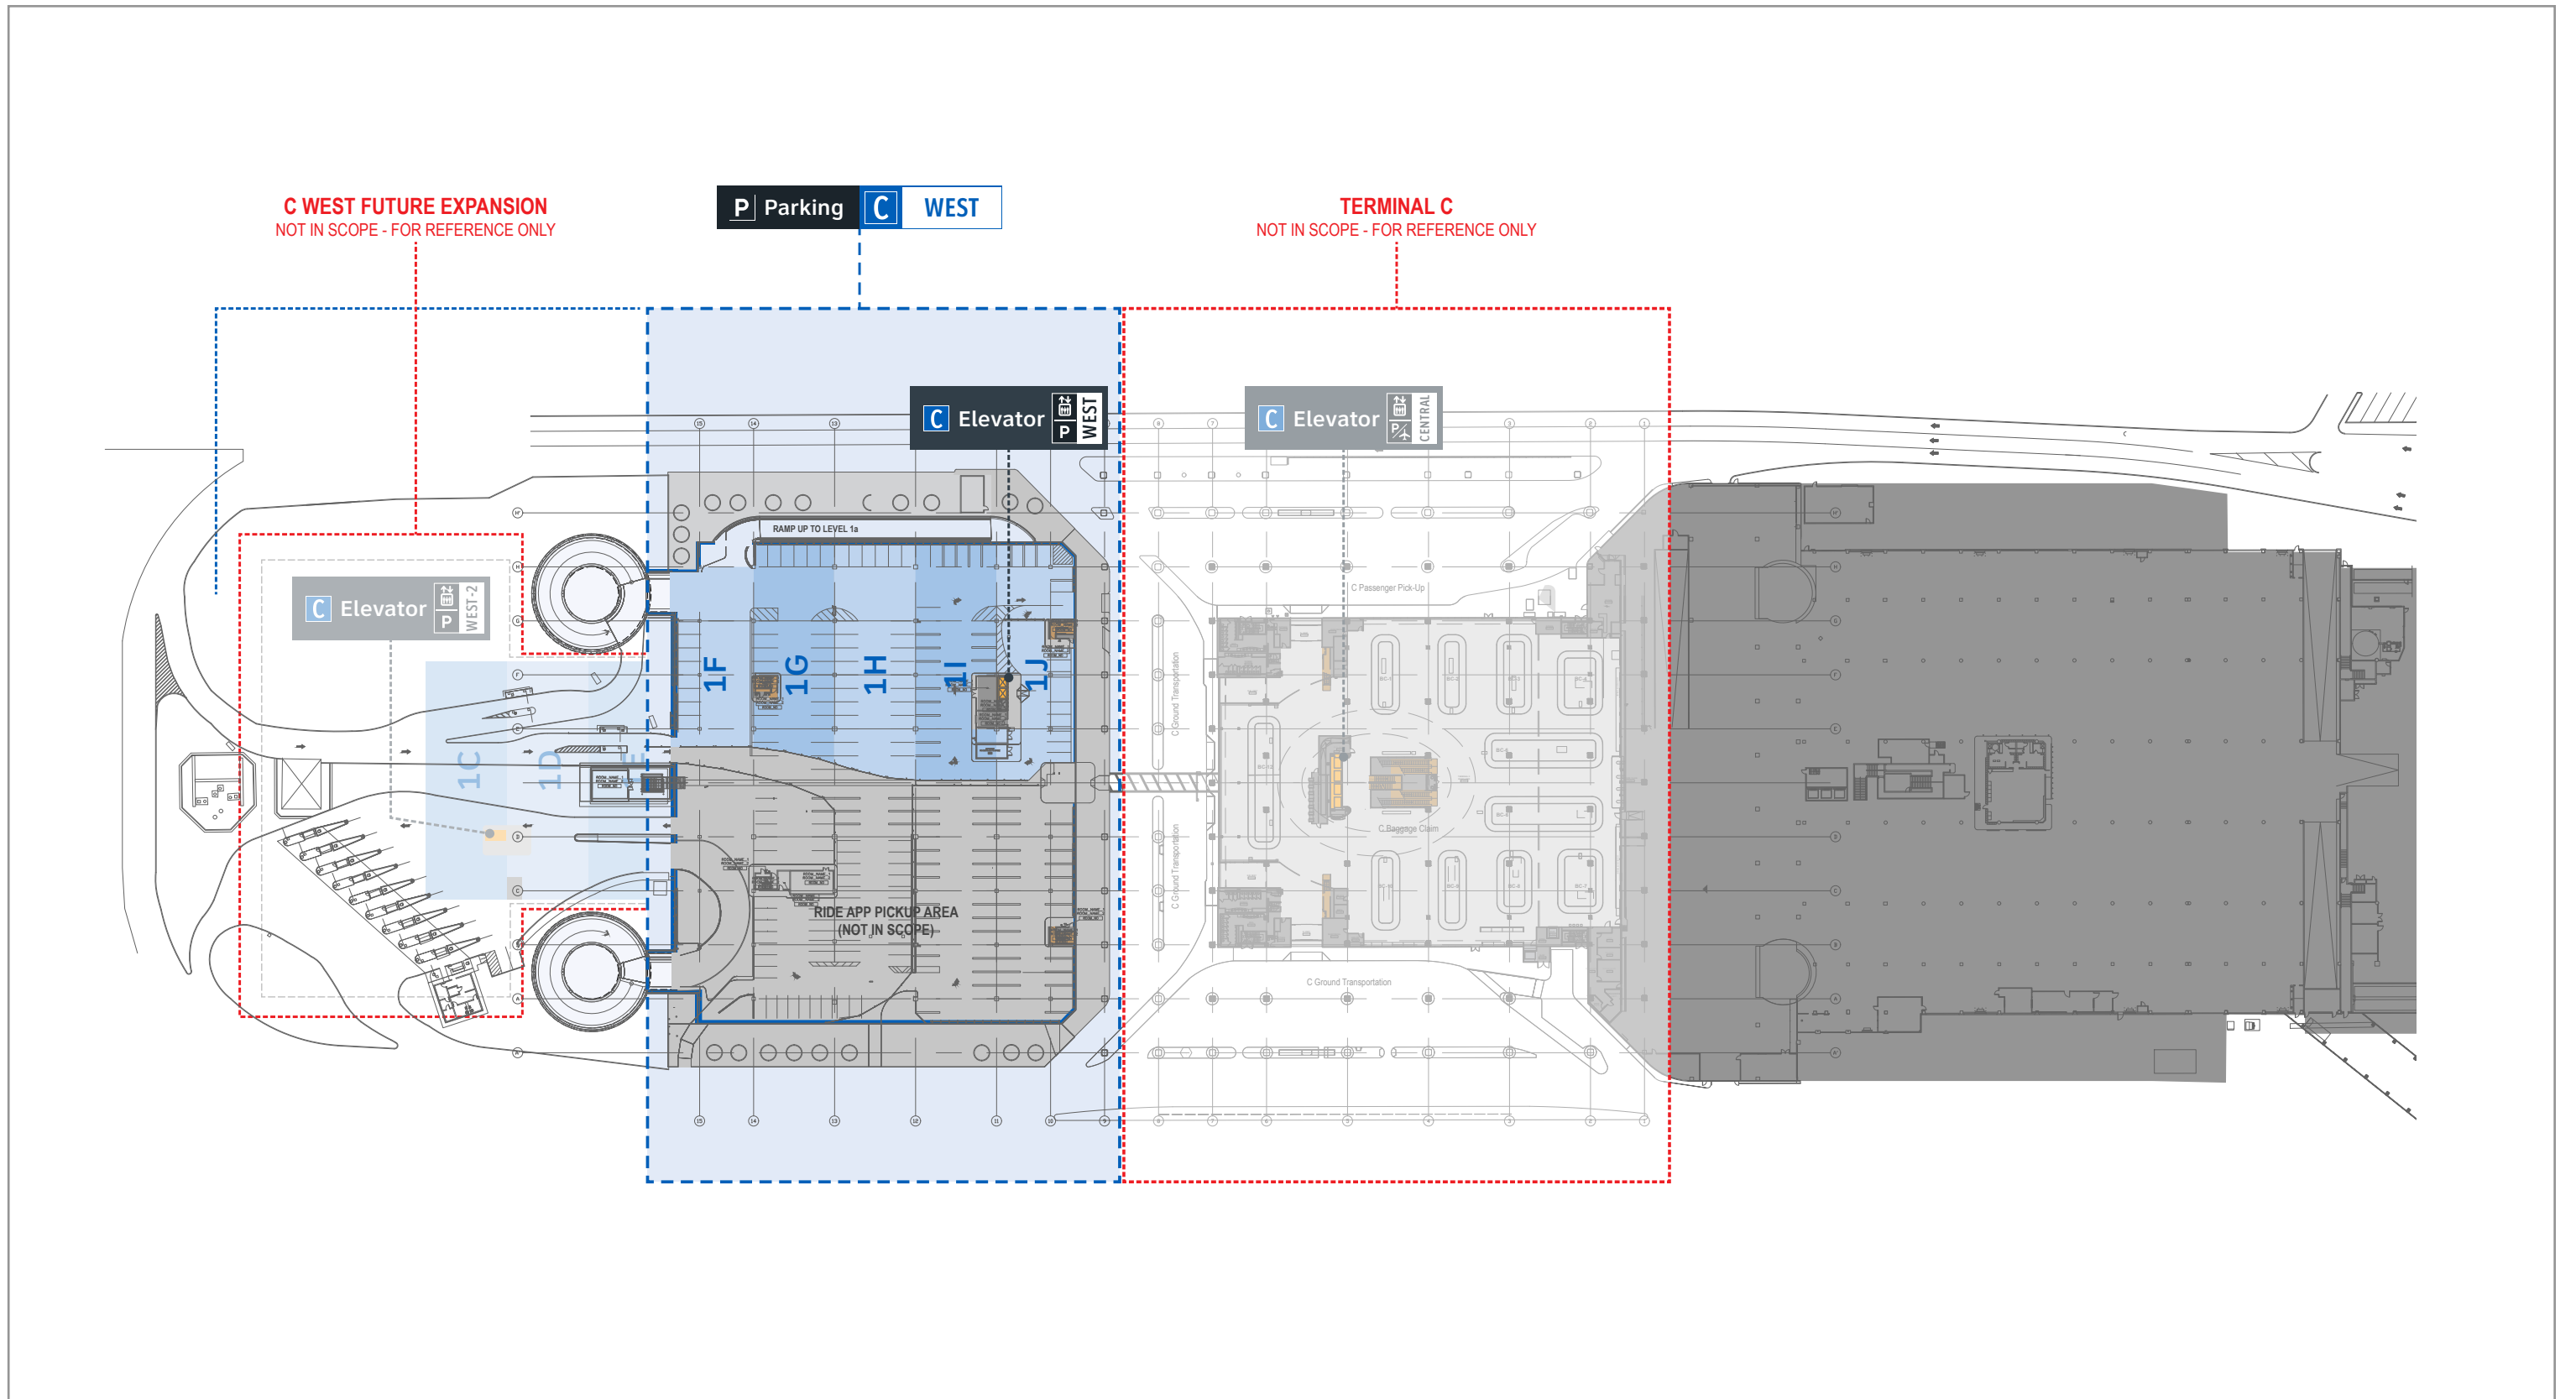


Figure 1.2.4b Parking C & D/E: **New Terminology Plan - Level 1**

**C WEST FUTURE EXPANSION**  
NOT IN SCOPE - FOR REFERENCE ONLY

**P** Parking **C** WEST

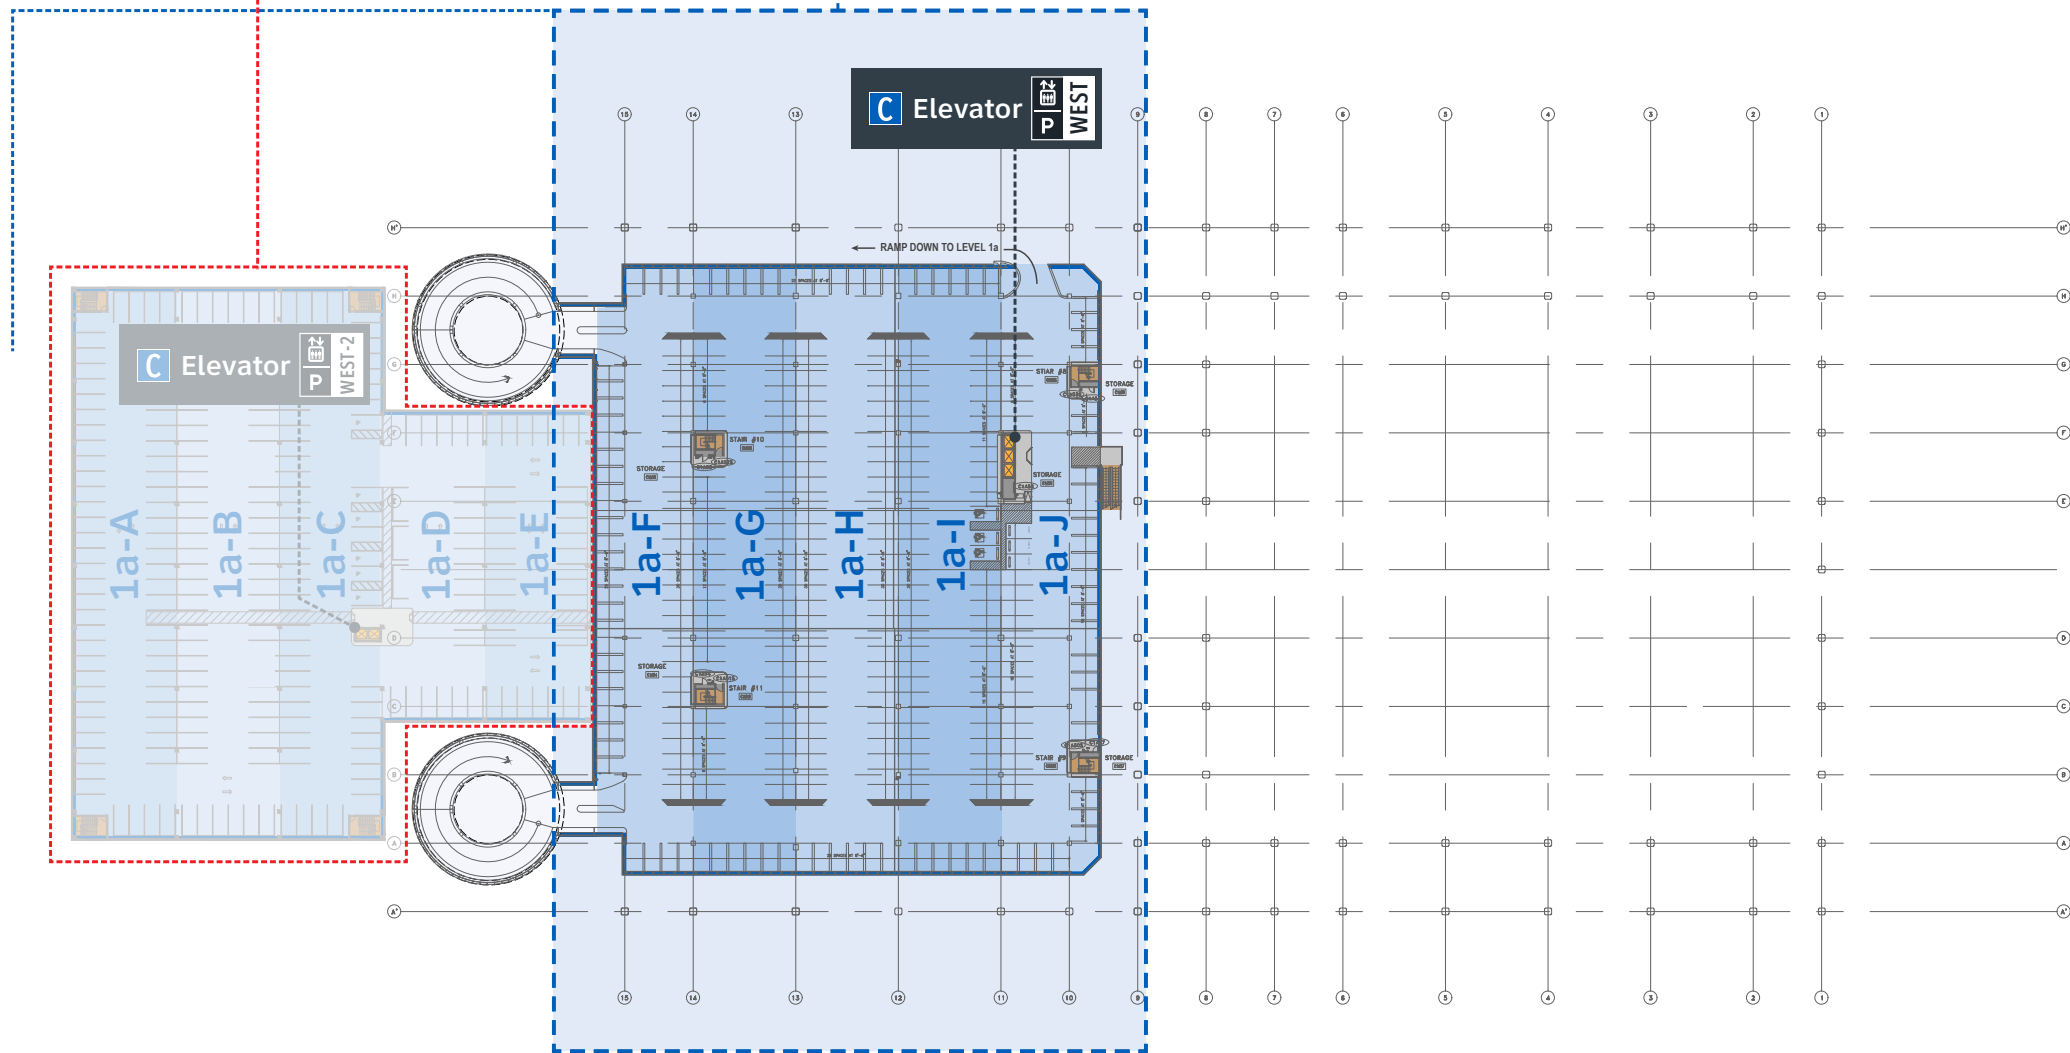


Figure 1.2.4c

Parking C & D/E: **New Terminology Plan - Level 1a**



**GEORGE BUSH INTERCONTINENTAL AIRPORT**  
Wayfinding Signage Design Intent Documents  
**C Garage**



Louisville, Colorado  
P: 303.494.7849  
www.labozan.com

These documents are intended to illustrate design intent, and should only be used as a general guideline. No information contained here should be construed as engineered elements. The fabricator/contractor shall be responsible for all engineering and specifications with regard to structural, electrical, mechanical, foundation and installation. Information and illustrations contained here are part of an original unpublished design by Labozan Associates, Inc. Detailing and information contained on these pages shall not be reproduced, copied or utilized in any way except for the specific project for which they were created without previous written authorization from Labozan Associates, Inc.  
© 2024 by Labozan Associates, Inc.

**Wayfinding Updates**

Issue Date: 08-23-2024  
Issue for Bid

REV.   
REV.   
REV.

**WARNING:**

This record contains Sensitive Security Information that is controlled under 49 CFR parts 15 and 1520. No part of this record may be disclosed to persons with a "need to know," as defined in 49 CFR parts 15 and 1520, except with the written permission of the Administrator of the Transportation Security Administration or the Secretary of Transportation. Unauthorized release may result in civil penalty or other action. For U.S. government agencies, public disclosure is governed by 5 U.S.C. 552 and 49 CFR parts 15 and 1520.



THESE SHEETS ARE ISSUED FOR GRAPHICAL INFORMATION ONLY

08-23-2024

**1.2 GRAPHIC STANDARDS - MESSAGES & TERMINOLOGY**

BSG PRJCT# BSG-2024-111-IAH  
HAS TIP # 24 -103 - IAH

(5 of 11)

Sheet: 1-7

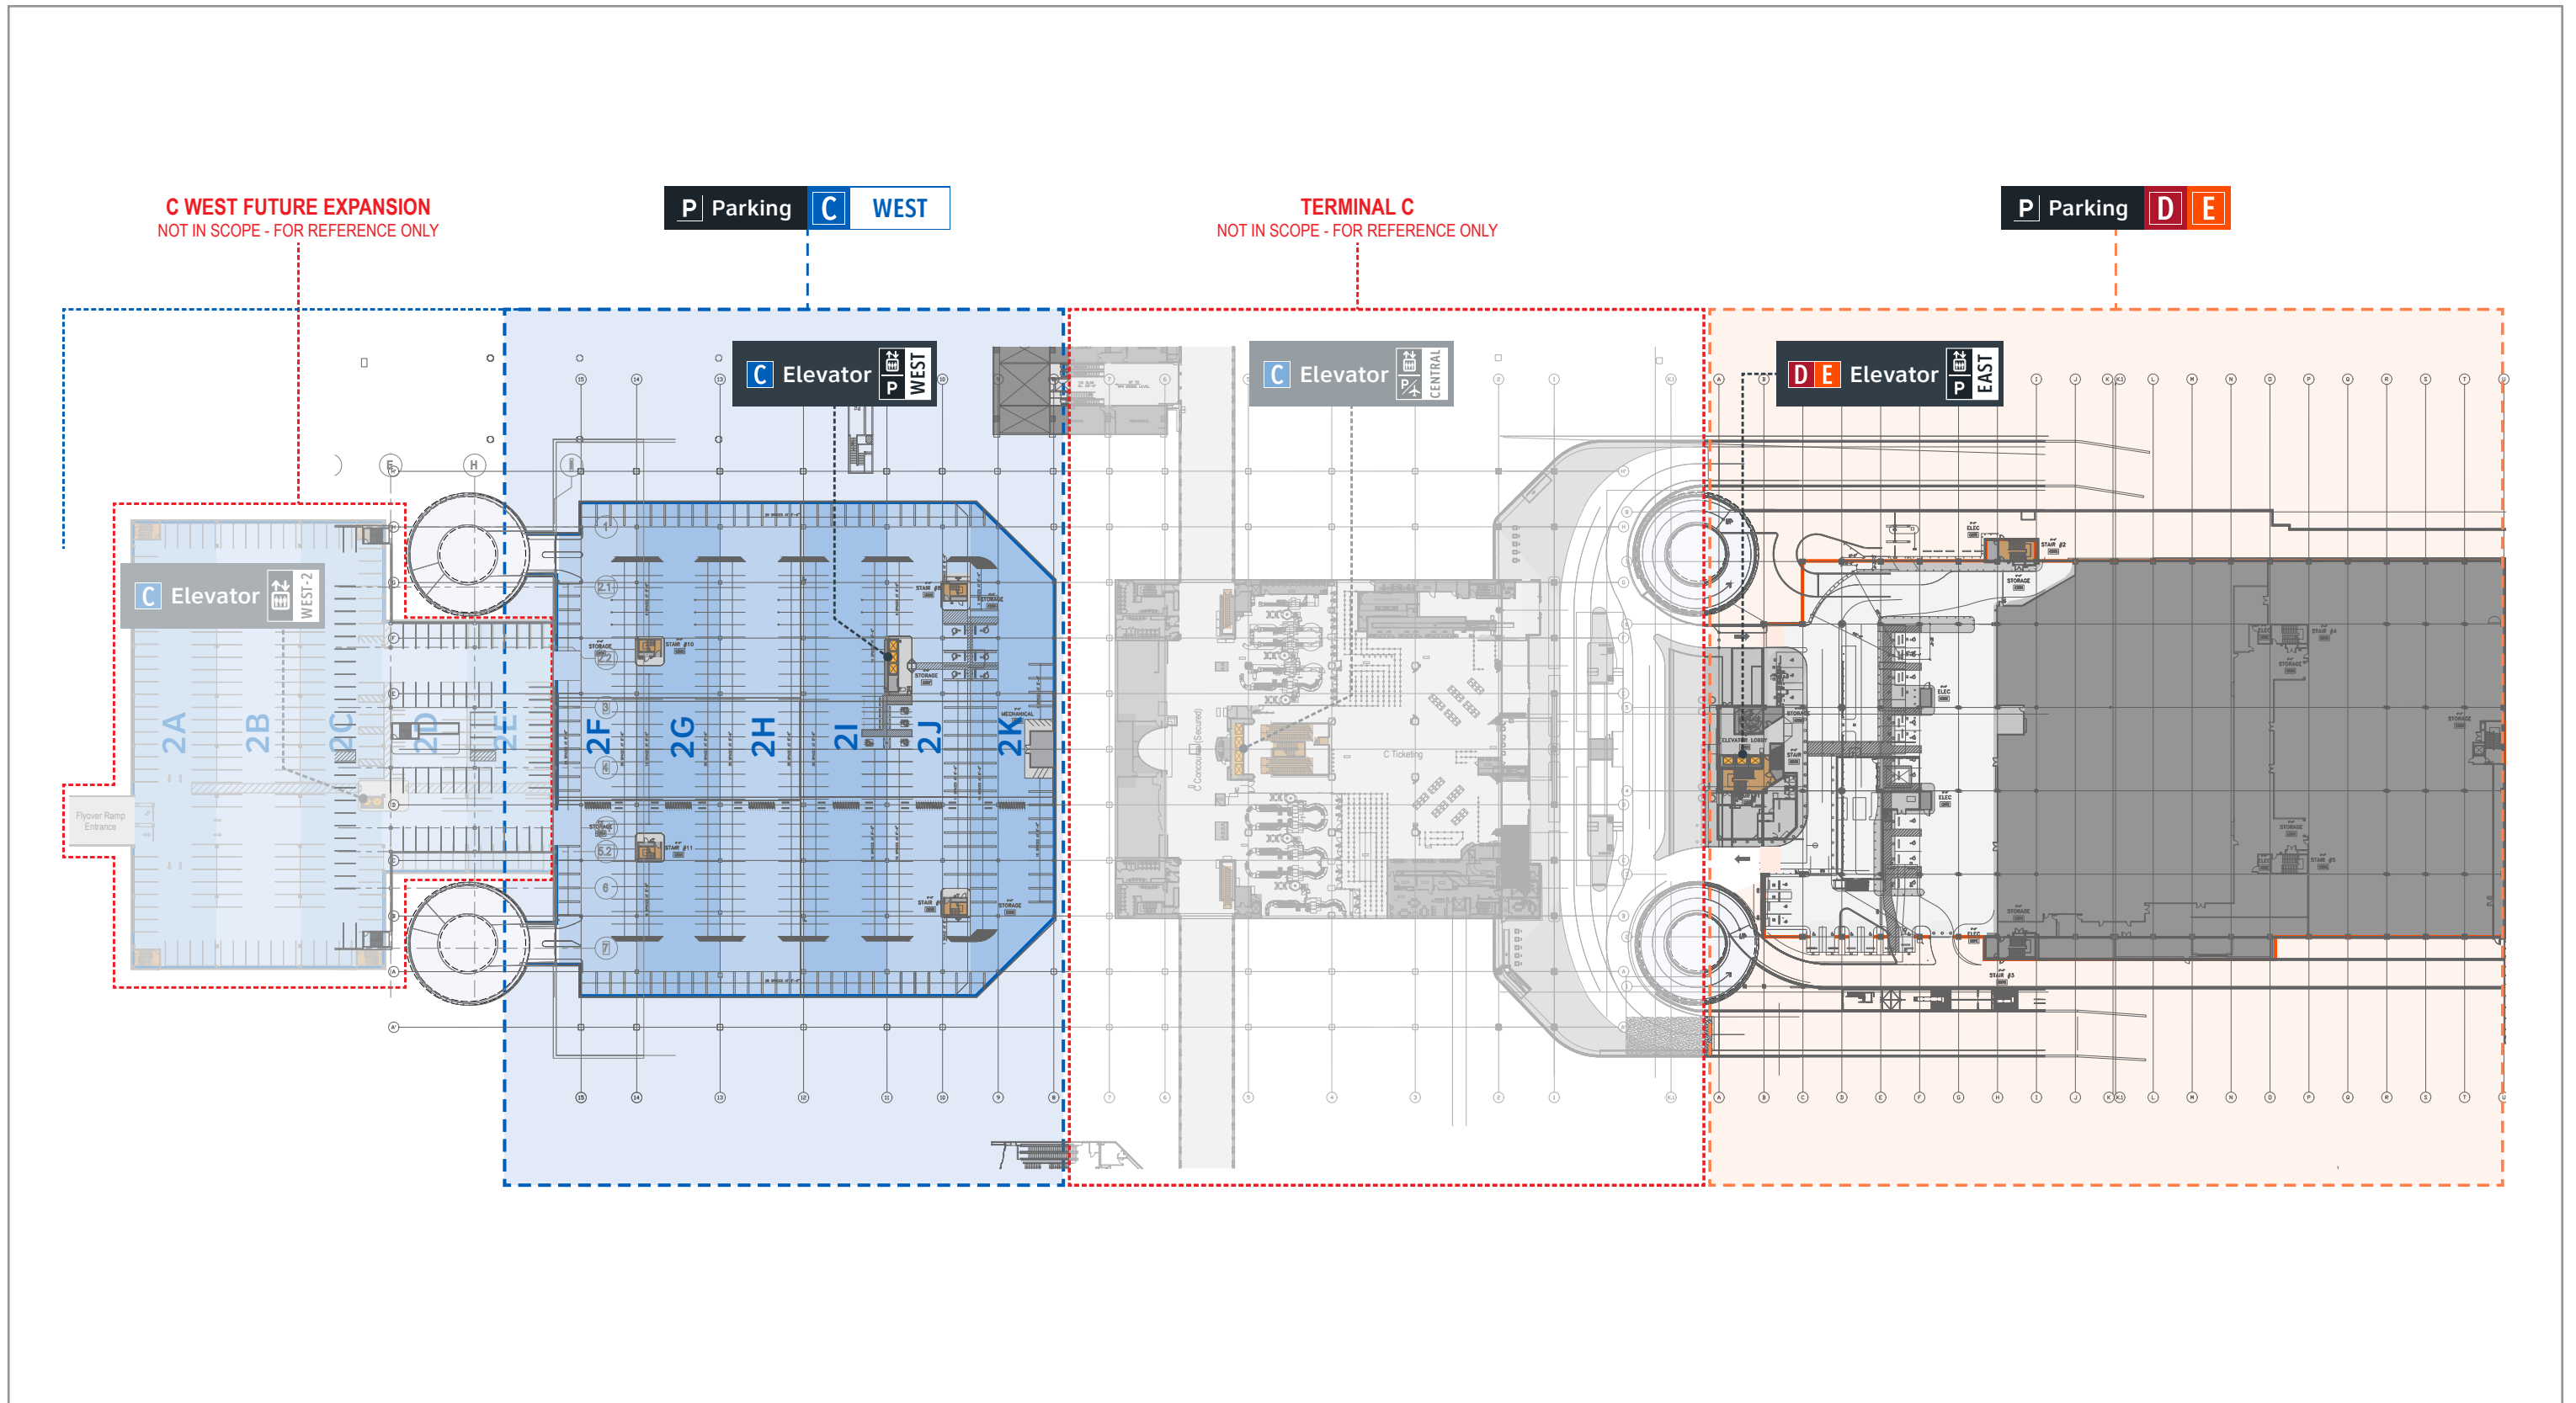


Figure 1.2.4d

Parking C & D/E: **New Terminology Plan - Level 2**



GEORGE BUSH INTERCONTINENTAL AIRPORT  
Wayfinding Signage Design Intent Documents  
**C Garage**



Louisville, Colorado  
P: 303.494.7849  
www.labozan.com

These documents are intended to illustrate design intent, and should only be used as a general guideline. No information contained here should be construed as engineered elements. The fabricator/contractor shall be responsible for all engineering and specifications with regard to structural, electrical, mechanical, foundation and installation. Information and illustrations contained here are part of an original unpublished design by Labozan Associates, Inc. Detailing and information contained on these pages shall not be reproduced, copied or utilized in any way except for the specific project for which they were created without previous written authorization from Labozan Associates, Inc.  
© 2024 by Labozan Associates, Inc.

**Wayfinding Updates**

Issue Date: 08-23-2024  
Issue for Bid

REV.   
REV.   
REV.

**WARNING:**

This record contains Sensitive Security Information that is controlled under 49 CFR parts 15 and 1520. No part of this record may be disclosed to persons with a "need to know," as defined in 49 CFR parts 15 and 1520, except with the written permission of the Administrator of the Transportation Security Administration or the Secretary of Transportation. Unauthorized release may result in civil penalty or other action. For U.S. government agencies, public disclosure is governed by 5 U.S.C. 552 and 49 CFR parts 15 and 1520.



08-23-2024

THESE SHEETS ARE ISSUED FOR GRAPHICAL INFORMATION ONLY

**1.2 GRAPHIC STANDARDS - MESSAGES & TERMINOLOGY**

BSG PRJCT# BSG-2024-111-IAH  
HAS TIP # 24 -103 - IAH

(6 of 11)

Sheet: 1-8

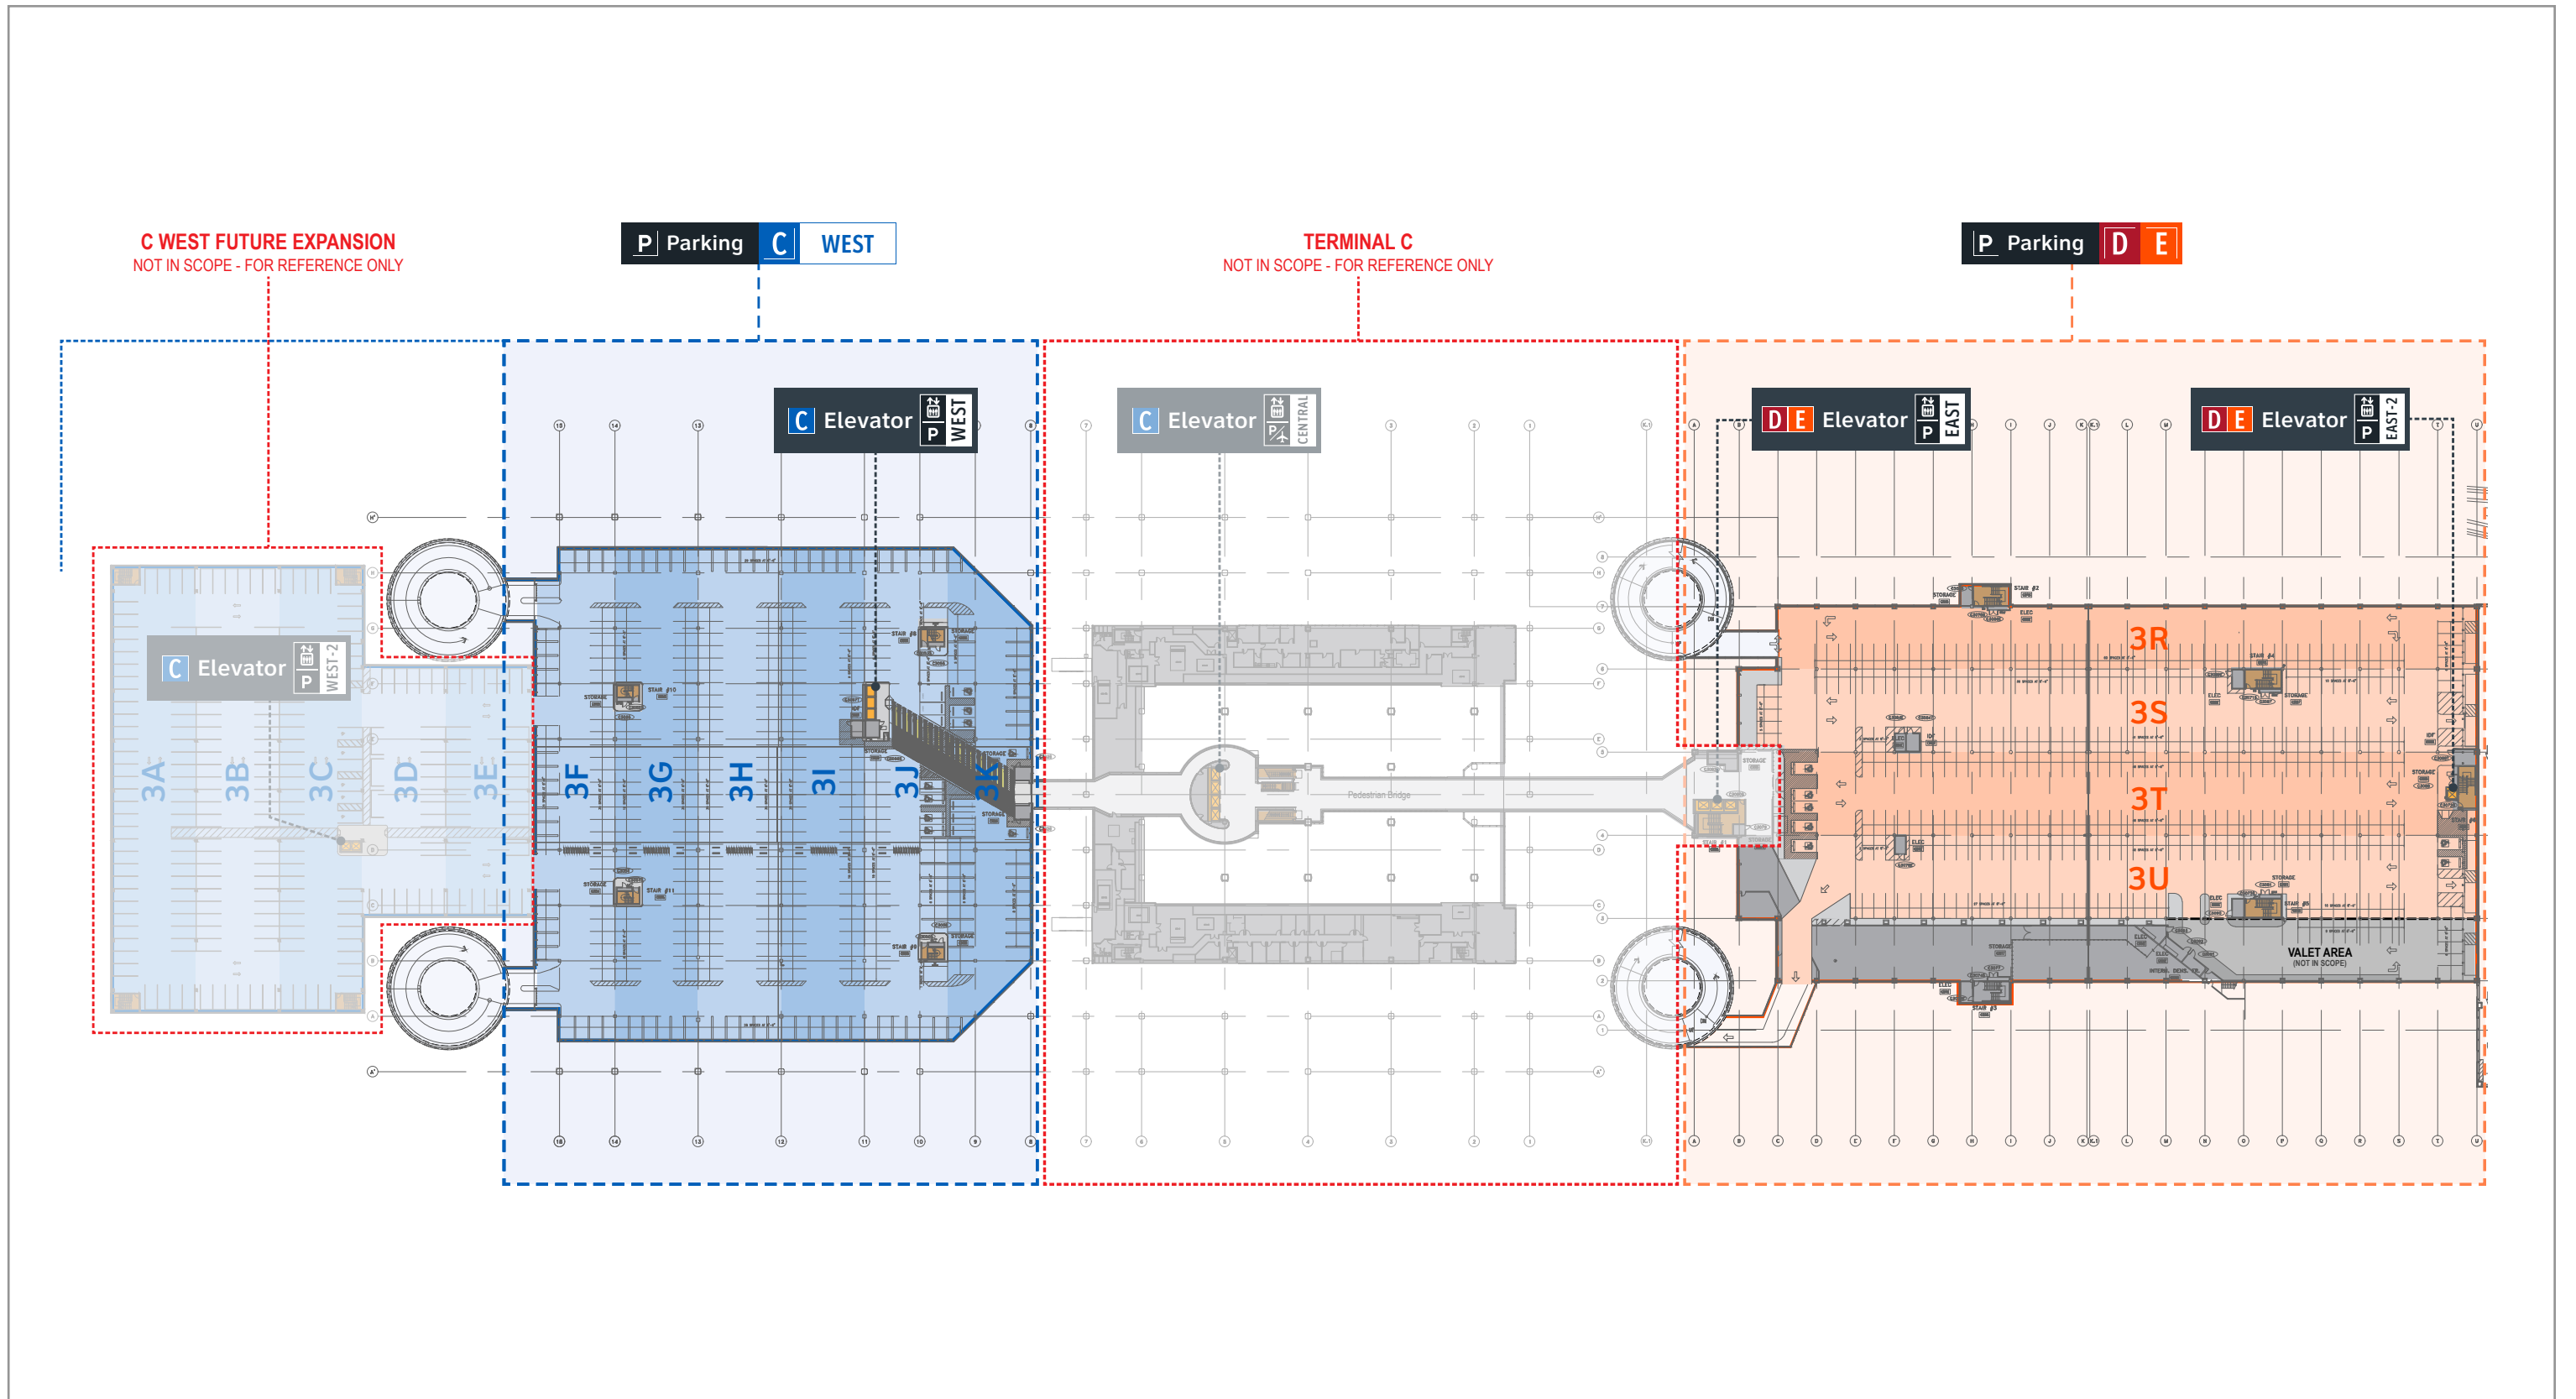


Figure 1.2.4e

Parking C & D/E: **New Terminology Plan - Level 3**



GEORGE BUSH INTERCONTINENTAL AIRPORT  
Wayfinding Signage Design Intent Documents  
**C Garage**



Louisville, Colorado  
P: 303.494.7849  
www.labozan.com

These documents are intended to illustrate design intent, and should only be used as a general guideline. No information contained here should be construed as engineered elements. The fabricator/contractor shall be responsible for all engineering and specifications with regard to structural, electrical, mechanical, foundation and installation. Information and illustrations contained here are part of an original unpublished design by Labozan Associates, Inc. Detailing and information contained on these pages shall not be reproduced, copied or utilized in any way except for the specific project for which they were created without previous written authorization from Labozan Associates, Inc.  
© 2024 by Labozan Associates, Inc.

**Wayfinding Updates**

Issue Date: 08-23-2024  
Issue for Bid

REV. ▲  
REV. ▲  
REV. ▲

**WARNING:**

This record contains Sensitive Security Information that is controlled under 49 CFR parts 15 and 1520. No part of this record may be disclosed to persons with a "need to know," as defined in 49 CFR parts 15 and 1520, except with the written permission of the Administrator of the Transportation Security Administration or the Secretary of Transportation. Unauthorized release may result in civil penalty or other action. For U.S. government agencies, public disclosure is governed by 5 U.S.C. 552 and 49 CFR parts 15 and 1520.



08-23-2024

THESE SHEETS ARE ISSUED FOR GRAPHICAL INFORMATION ONLY

**1.2 GRAPHIC STANDARDS - MESSAGES & TERMINOLOGY**

BSG PRJCT# BSG-2024-111-IAH  
HAS TIP # 24 -103 - IAH

(7 of 11)

Sheet: 1-9

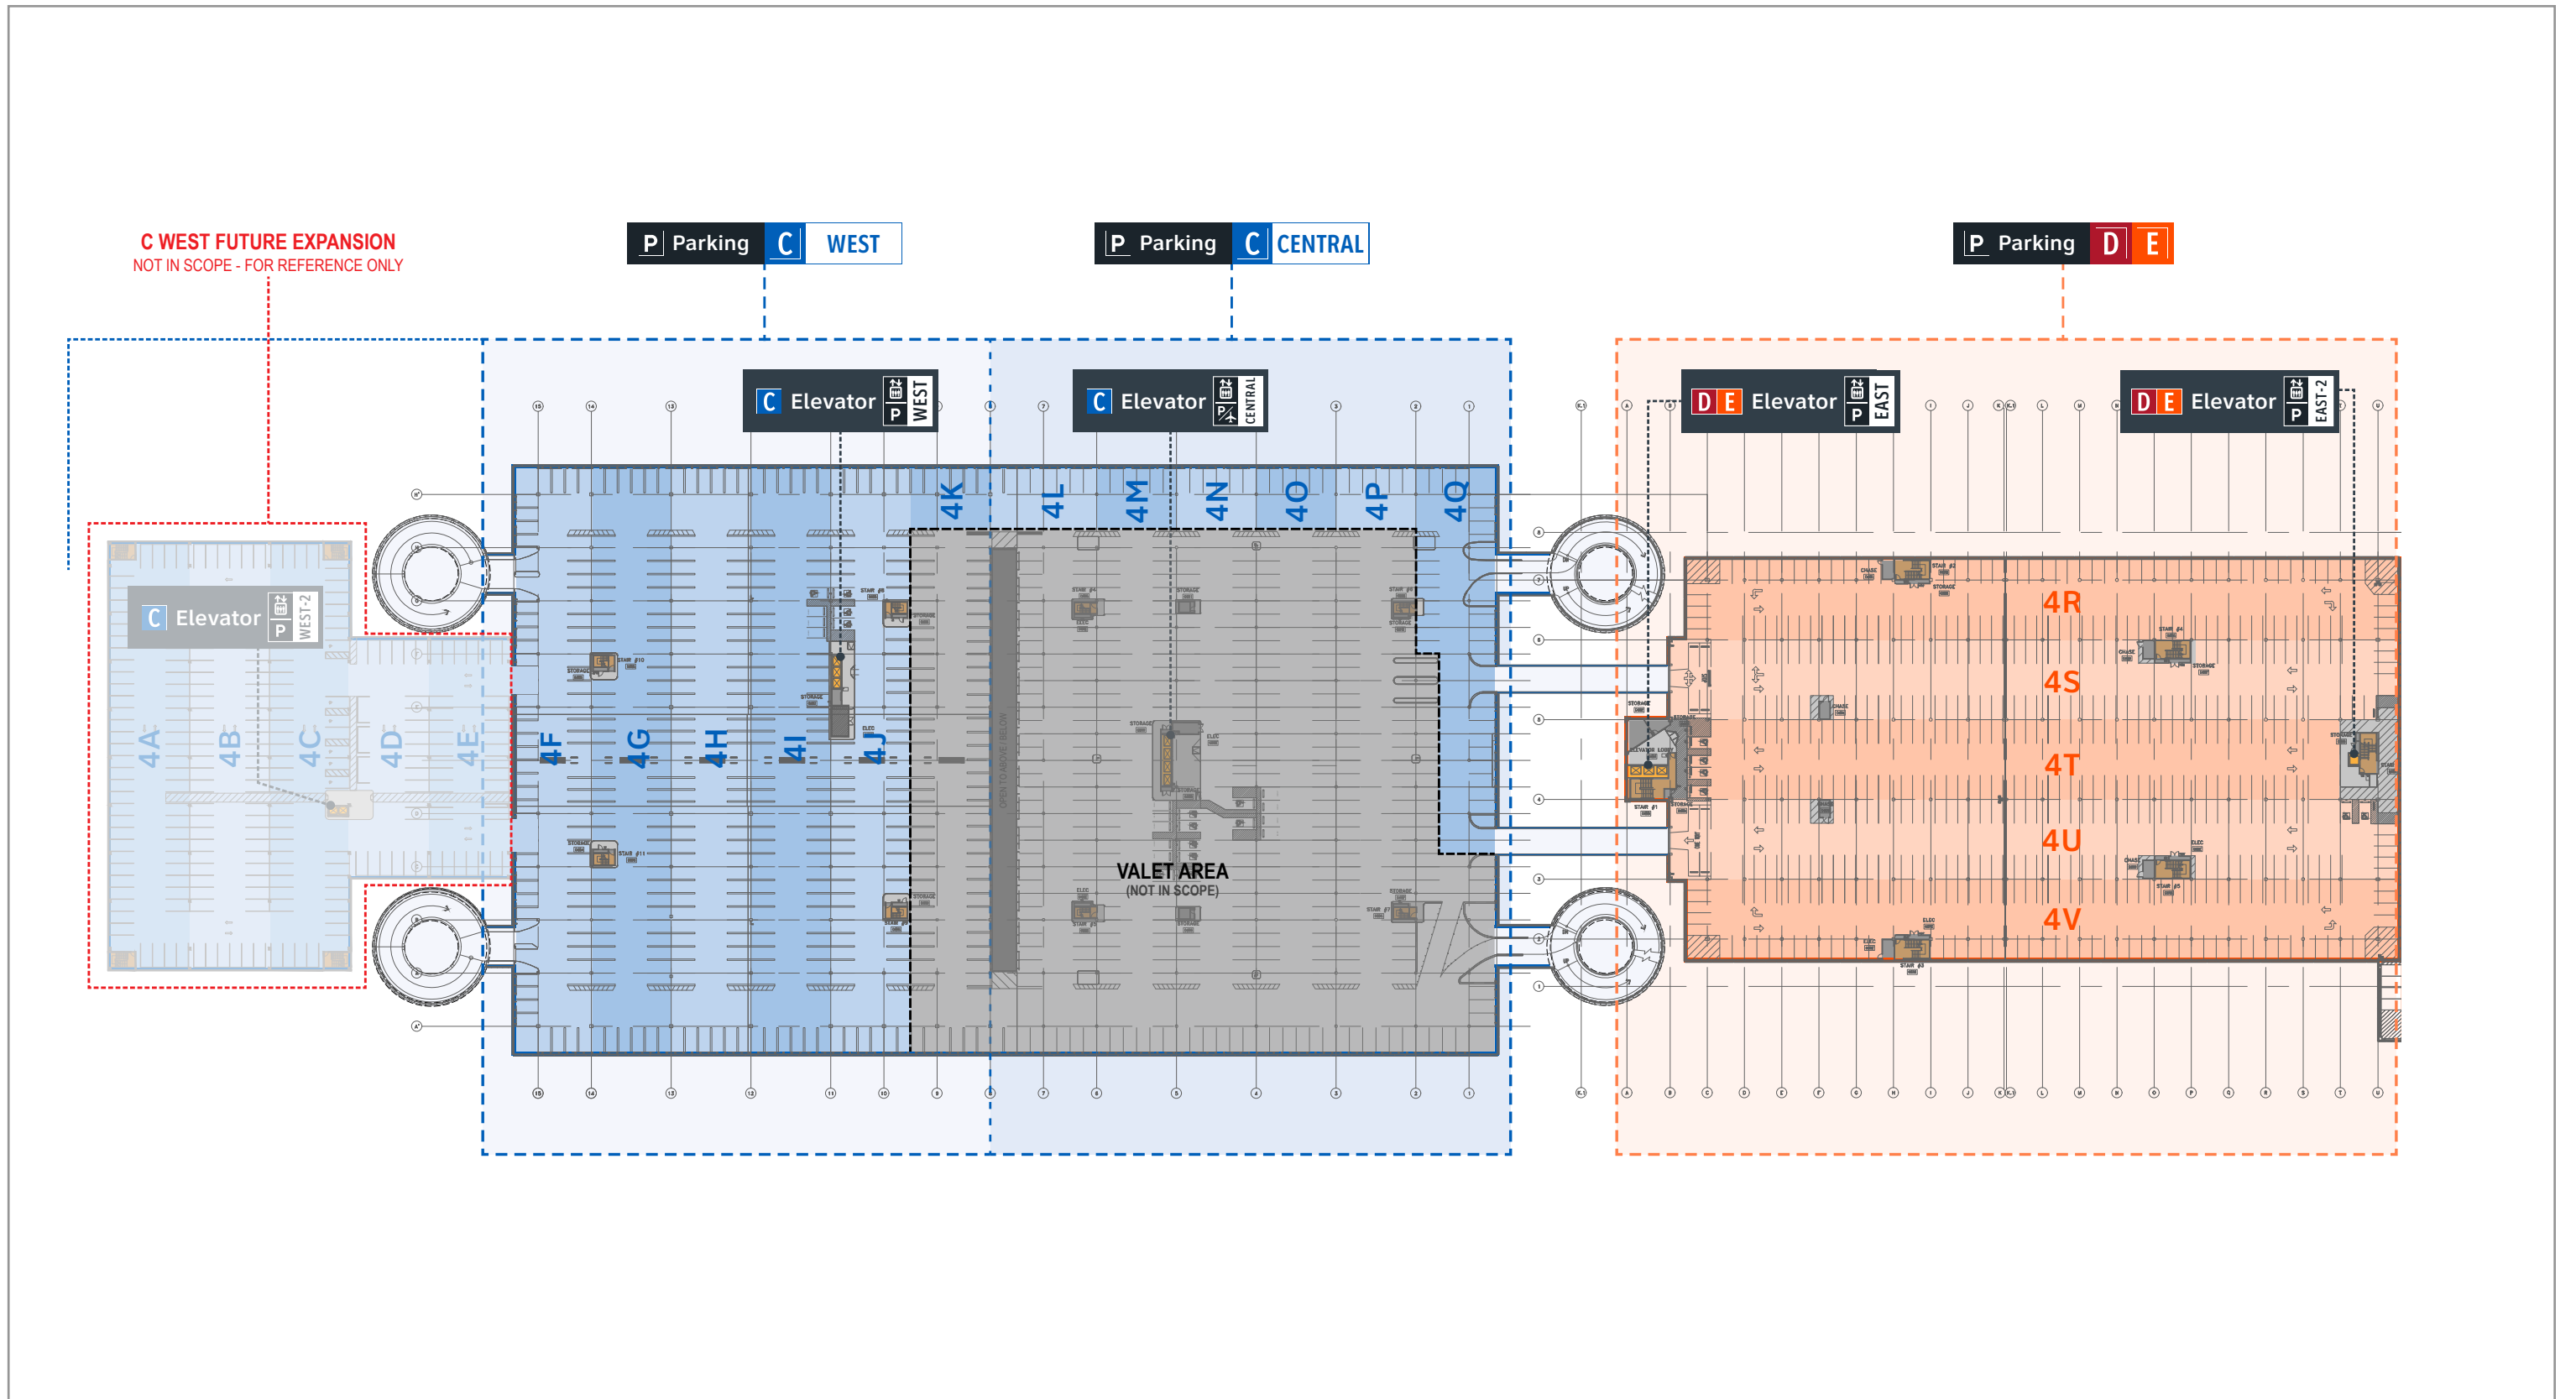


Figure 1.2.4f

Parking C & D/E: New Terminology Plan - Level 4



Wayfinding Updates

Issue Date: 08-23-2024  
Issue for Bid

REV.   
REV.   
REV.

WARNING:

This record contains Sensitive Security Information that is controlled under 49 CFR parts 15 and 1520. No part of this record may be disclosed to persons with a "need to know," as defined in 49 CFR parts 15 and 1520, except with the written permission of the Administrator of the Transportation Security Administration or the Secretary of Transportation. Unauthorized release may result in civil penalty or other action. For U.S. government agencies, public disclosure is governed by 5 U.S.C. 552 and 49 CFR parts 15 and 1520.



08-23-2024

THESE SHEETS ARE ISSUED FOR GRAPHICAL INFORMATION ONLY

1.2 GRAPHIC STANDARDS - MESSAGES & TERMINOLOGY

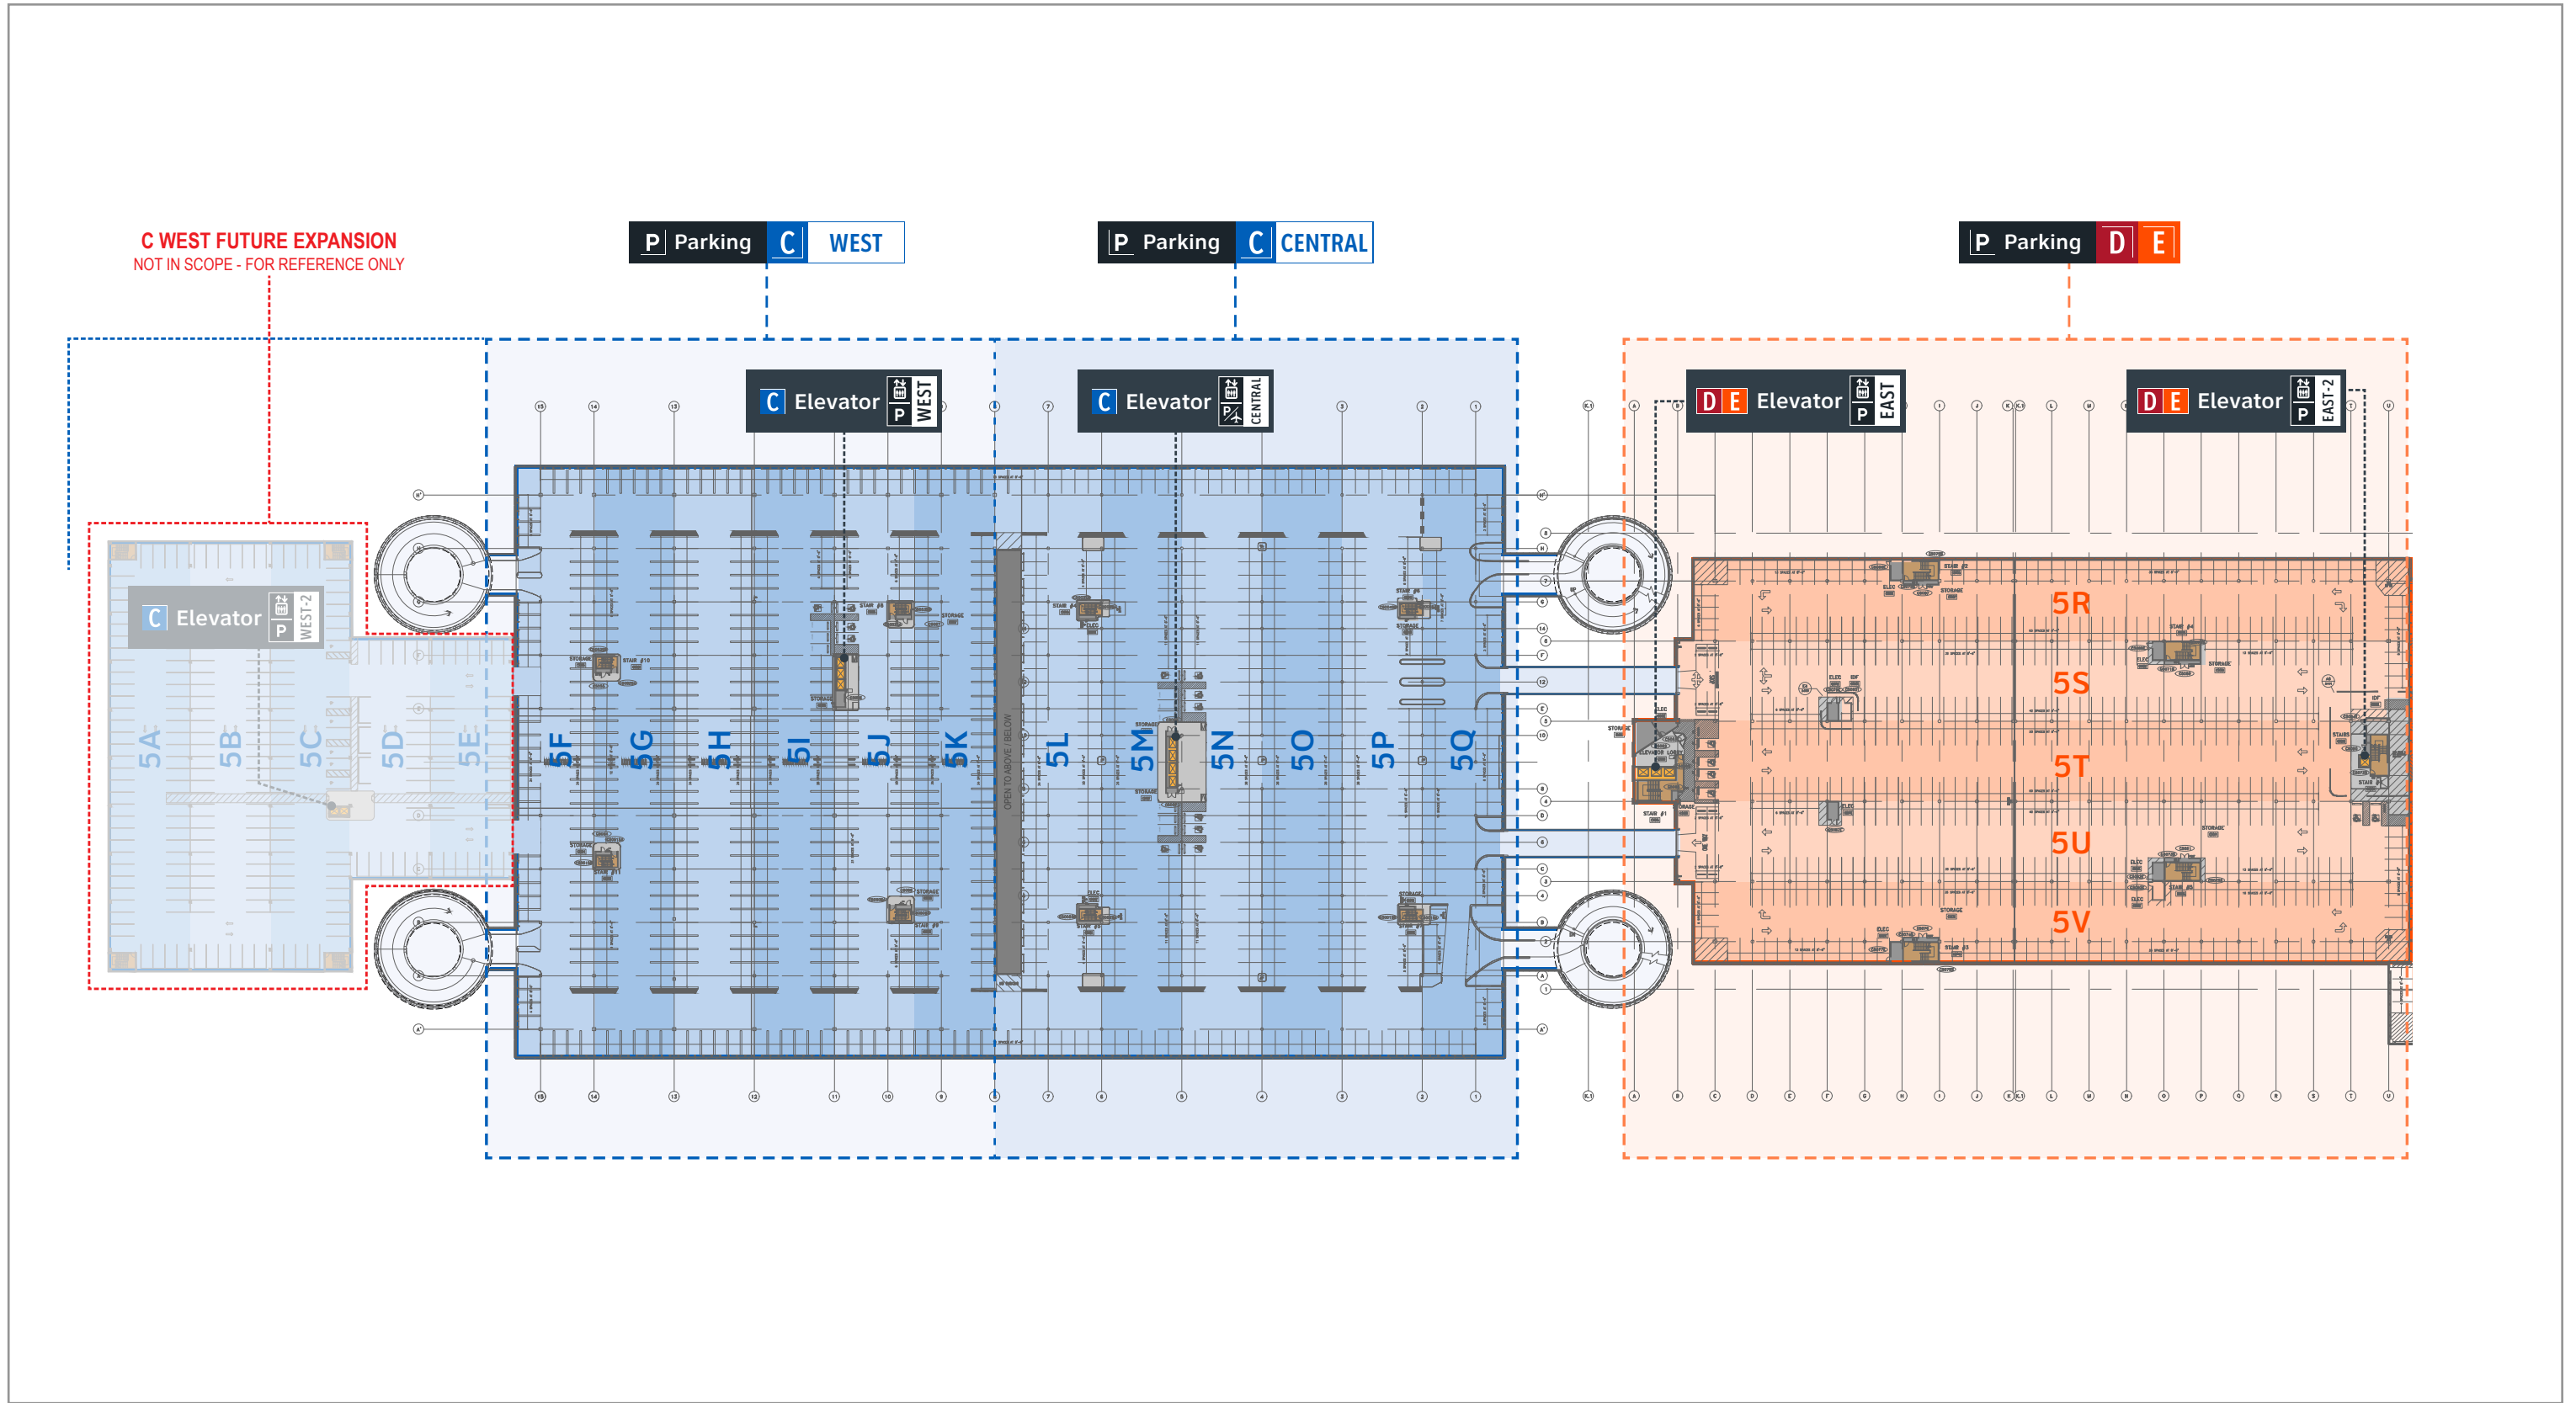


Figure 1.2.4g

Parking C & D/E: **New Terminology Plan - Level 5**



**Wayfinding Updates**

Issue Date: 08-23-2024

Issue for Bid

- REV. ▲
- REV. ▲
- REV. ▲

**WARNING:**

This record contains Sensitive Security Information that is controlled under 49 CFR parts 15 and 1520. No part of this record may be disclosed to persons with a "need to know," as defined in 49 CFR parts 15 and 1520, except with the written permission of the Administrator of the Transportation Security Administration or the Secretary of Transportation. Unauthorized release may result in civil penalty or other action. For U.S. government agencies, public disclosure is governed by 5 U.S.C. 552 and 49 CFR parts 15 and 1520.



08-23-2024

THESE SHEETS ARE ISSUED FOR GRAPHICAL INFORMATION ONLY

**1.2 GRAPHIC STANDARDS - MESSAGES & TERMINOLOGY**

BSG PRJCT# BSG-2024-111-IAH  
HAS TIP # 24 -103 - IAH

(9 of 11)

Sheet: 1-11

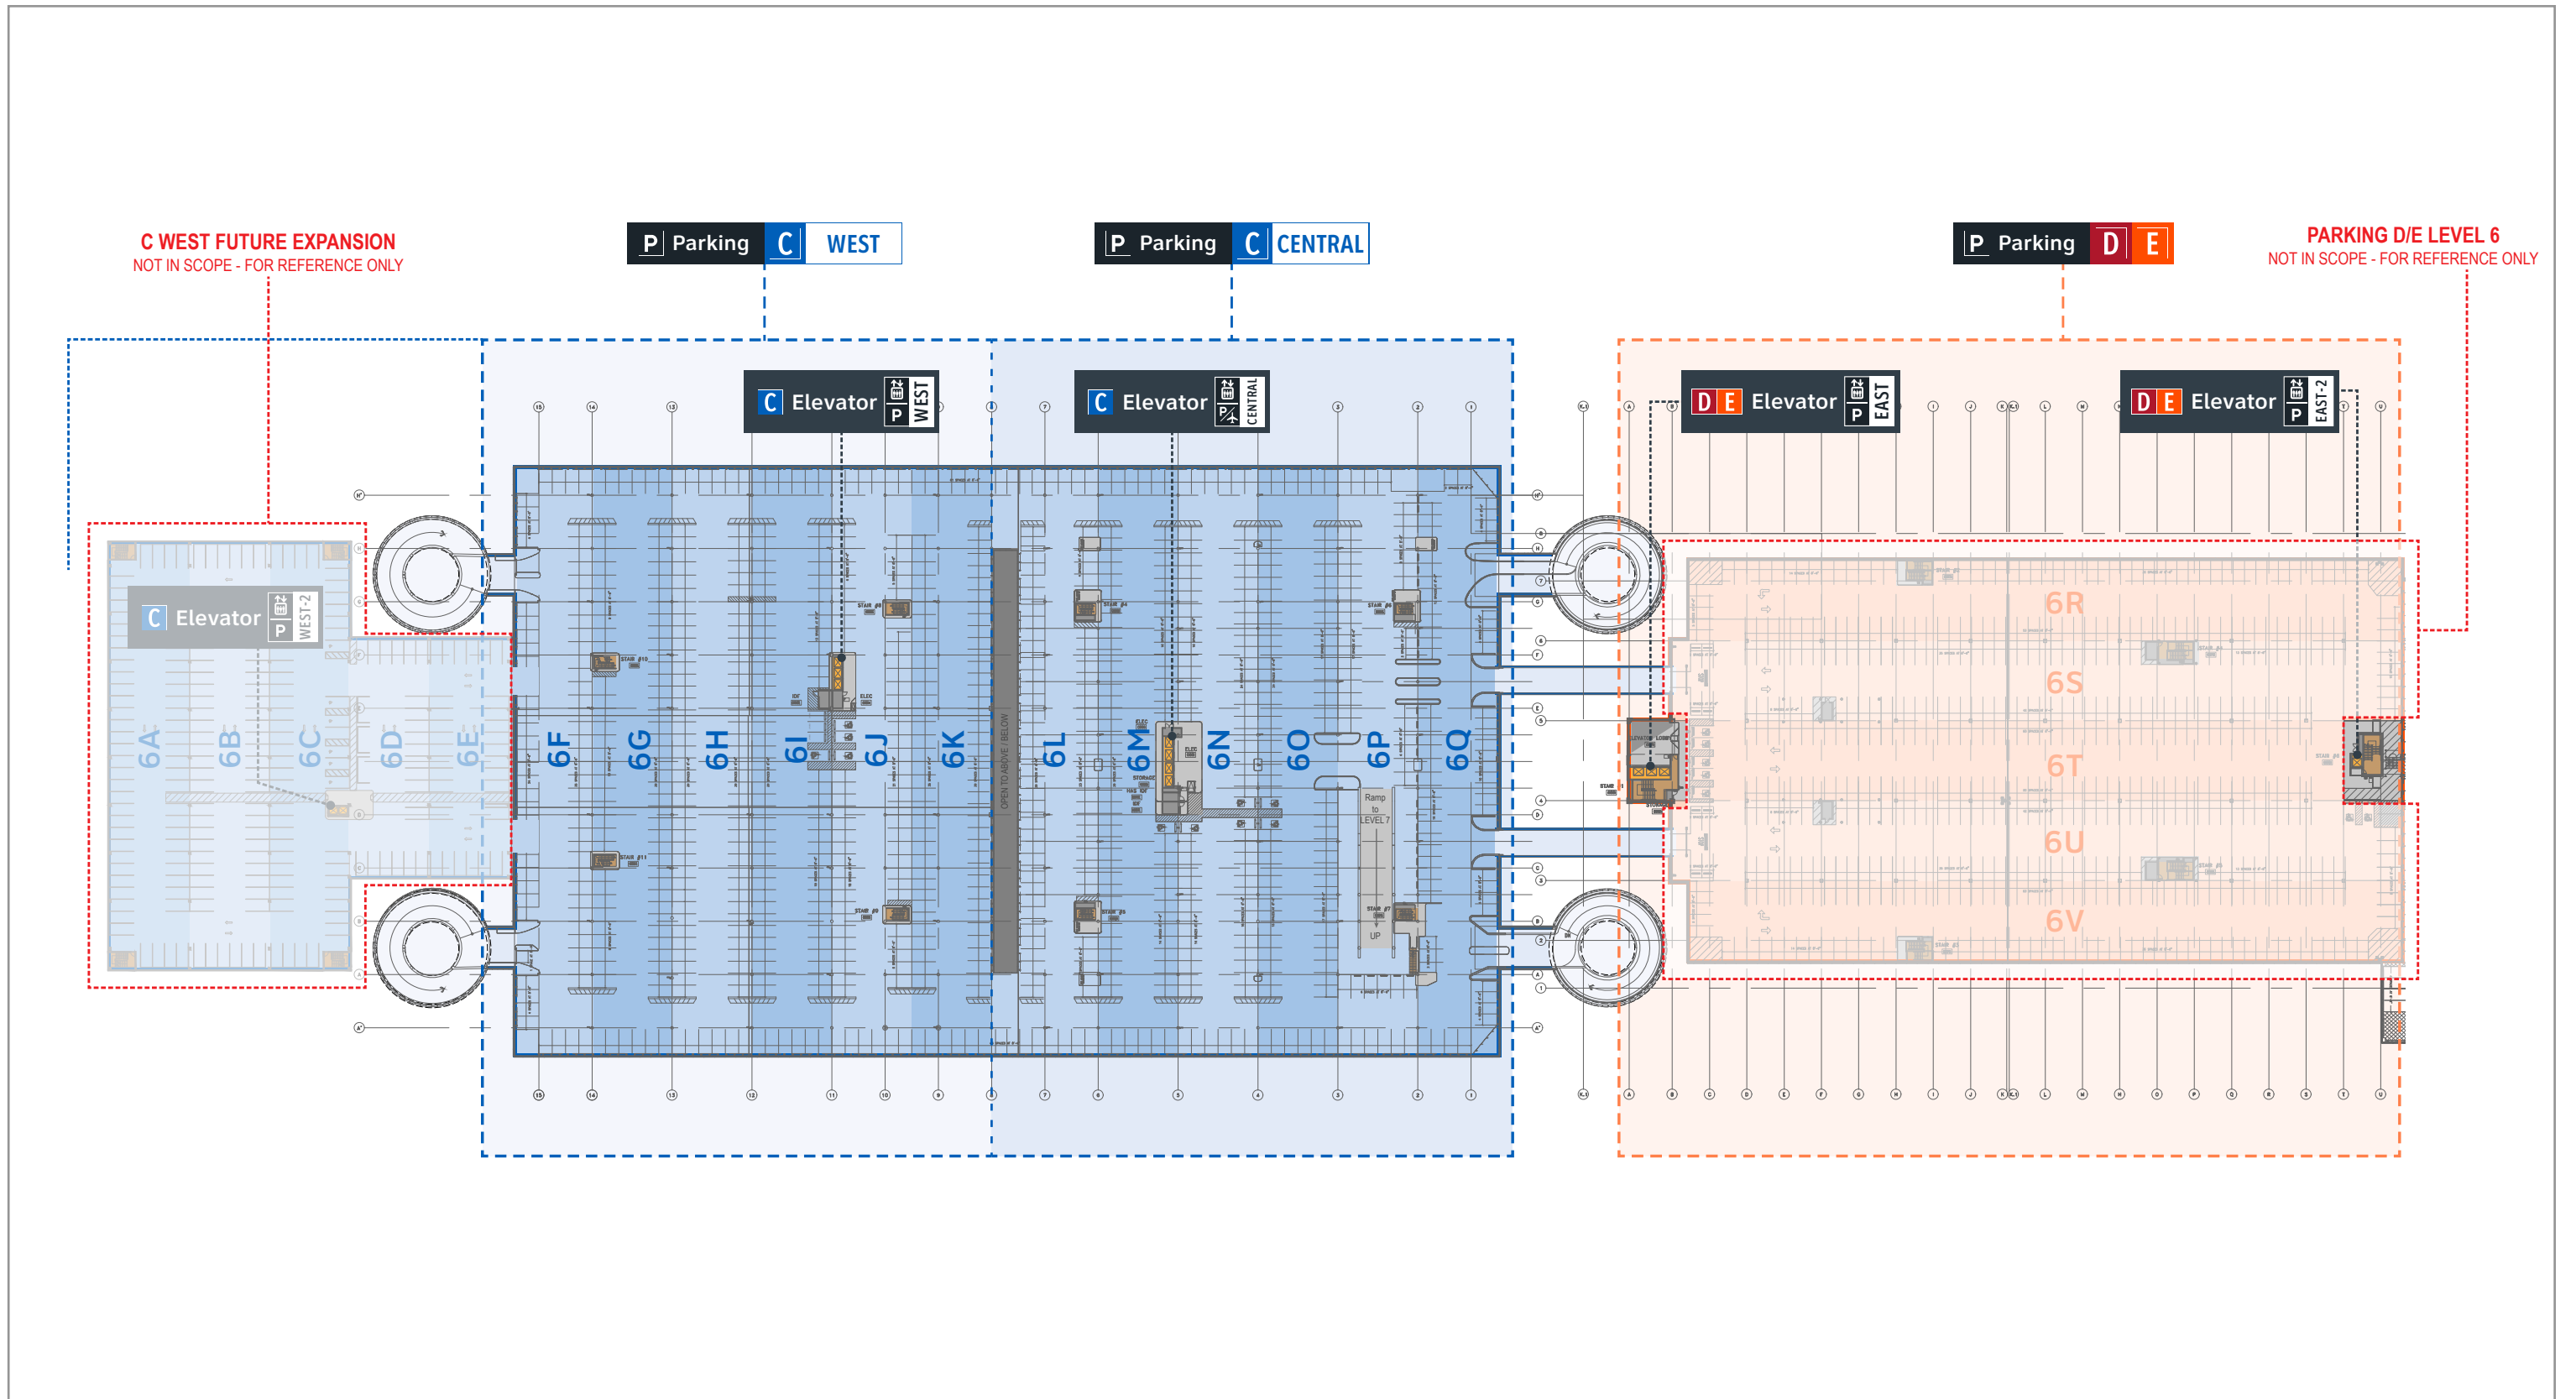


Figure 1.2.4h

Parking C & D/E: New Terminology Plan - Level 6



Wayfinding Updates

Issue Date: 08-23-2024  
Issue for Bid

- REV.
- REV.
- REV.

WARNING:

This record contains Sensitive Security Information that is controlled under 49 CFR parts 15 and 1520. No part of this record may be disclosed to persons with a "need to know," as defined in 49 CFR parts 15 and 1520, except with the written permission of the Administrator of the Transportation Security Administration or the Secretary of Transportation. Unauthorized release may result in civil penalty or other action. For U.S. government agencies, public disclosure is governed by 5 U.S.C. 552 and 49 CFR parts 15 and 1520.

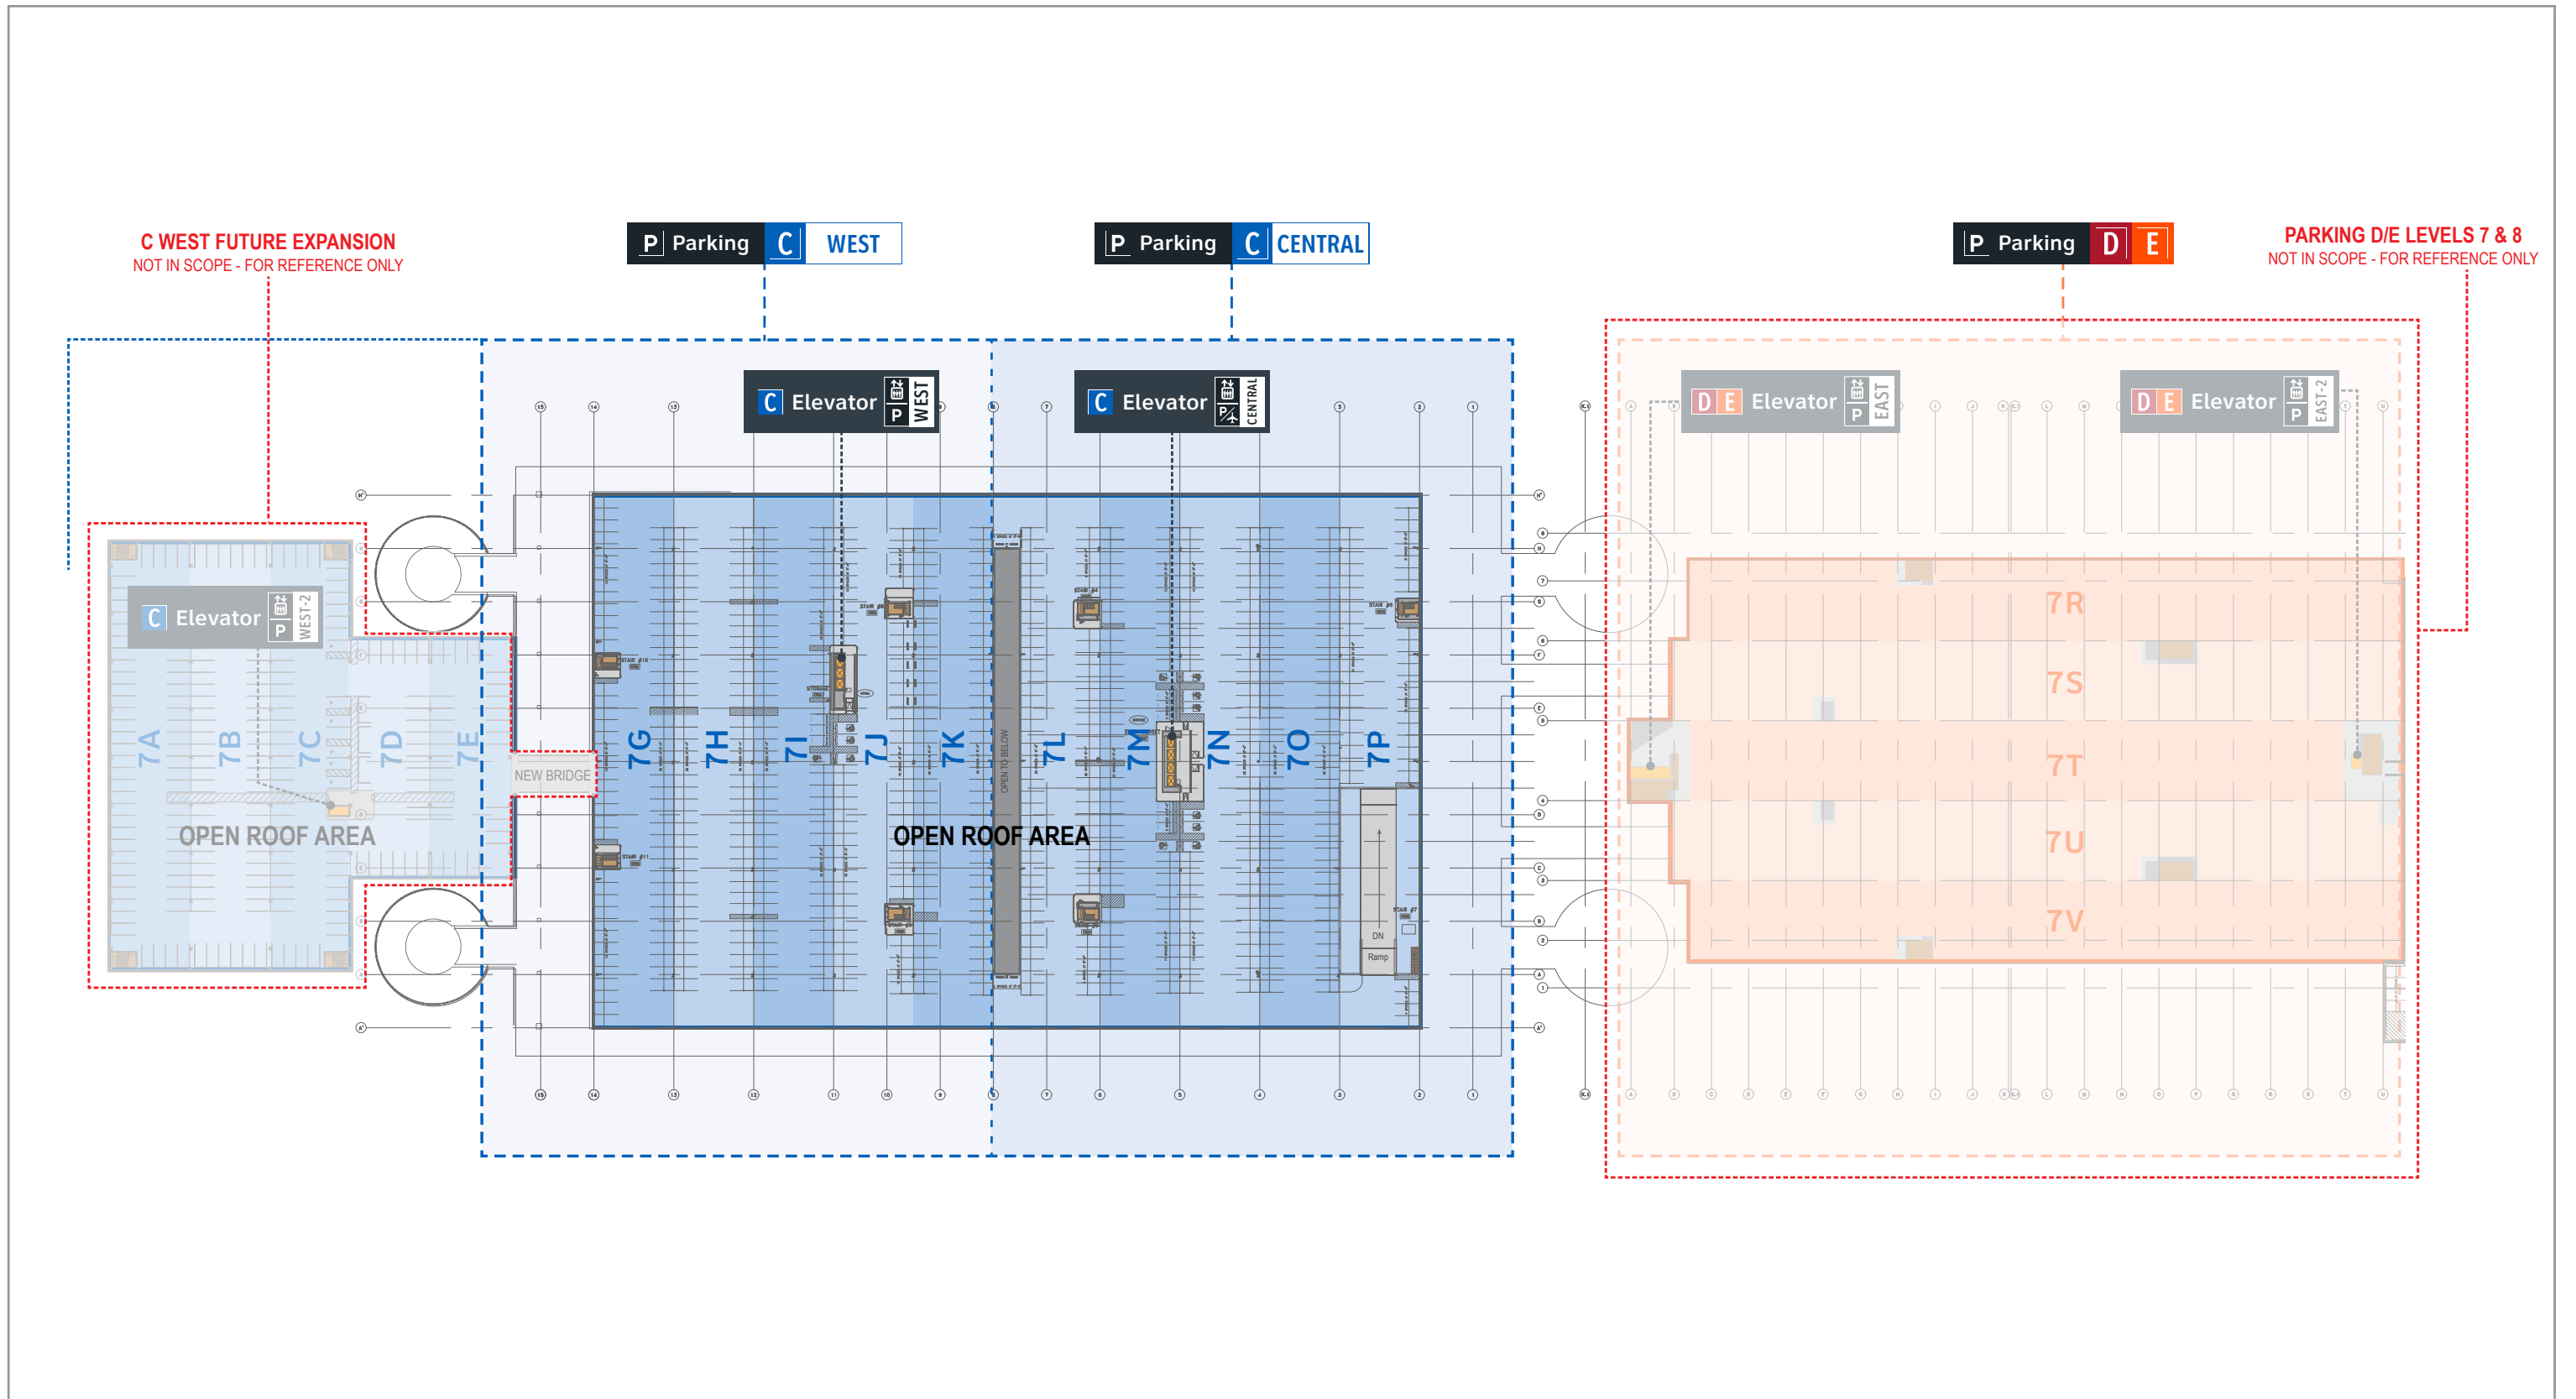


08-23-2024

THESE SHEETS ARE ISSUED FOR GRAPHICAL INFORMATION ONLY

1.2 GRAPHIC STANDARDS - MESSAGES & TERMINOLOGY





**C WEST FUTURE EXPANSION**  
NOT IN SCOPE - FOR REFERENCE ONLY

**P Parking C WEST**

**P Parking C CENTRAL**

**P Parking D E**

**PARKING D/E LEVELS 7 & 8**  
NOT IN SCOPE - FOR REFERENCE ONLY

Figure 1.2.4i

Parking C & D/E: **New Terminology Plan - Level 7**



**GEORGE BUSH INTERCONTINENTAL AIRPORT**  
Wayfinding Signage Design Intent Documents  
**C Garage**



Louisville, Colorado  
P: 303.494.7849  
www.labozan.com

These documents are intended to illustrate design intent, and should only be used as a general guideline. No information contained here should be construed as engineered elements. The fabricator/contractor shall be responsible for all engineering and specifications with regard to structural, electrical, mechanical, foundation and installation. Information and illustrations contained here are part of an original unpublished design by Labozan Associates, Inc. Detailing and information contained on these pages shall not be reproduced, copied or utilized in any way except for the specific project for which they were created without previous written authorization from Labozan Associates, Inc.  
© 2024 by Labozan Associates, Inc.

**Wayfinding Updates**

Issue Date: 08-23-2024  
Issue for Bid

- REV.
- REV.
- REV.

**WARNING:**

This record contains Sensitive Security Information that is controlled under 49 CFR parts 15 and 1520. No part of this record may be disclosed to persons with a "need to know," as defined in 49 CFR parts 15 and 1520, except with the written permission of the Administrator of the Transportation Security Administration or the Secretary of Transportation. Unauthorized release may result in civil penalty or other action. For U.S. government agencies, public disclosure is governed by 5 U.S.C. 552 and 49 CFR parts 15 and 1520.



THESE SHEETS ARE ISSUED FOR GRAPHICAL INFORMATION ONLY

08-23-2024

**1.2 GRAPHIC STANDARDS - MESSAGES & TERMINOLOGY**

BSG PRJCT# BSG-2024-111-IAH  
HAS TIP # 24 -103 - IAH

(11 of 11)

Sheet: 1-13

**HAS WAYFINDING: TYPE STYLES**

**Acceptable Type Styles**

The Clearview font family has been chosen as the standard HAS wayfinding typeface due to its wayfinding efficiency and industry-wide adoption as a typeface that is suitable for use in wayfinding programs. Note that specific Clearview type styles are uniquely associated with Pedestrian and Vehicular related wayfinding audiences. As such, only the following applicable type styles may be used:

- Pedestrian Wayfinding: all text on Pedestrian HAS wayfinding signage shall be set in the following *ClearviewText* and *ClearviewOne* font families, unless otherwise specified (see Figure 1.3.1a):
  - ClearviewText Medium = all standard wayfinding word messages
  - ClearviewOne Book Condensed = supplemental wayfinding word messages (i.e. “via,” “to:” and CBP notification text)
- Vehicular Wayfinding: all text on Vehicular HAS wayfinding signage shall be set in the following *Clearview Highway* font family, unless otherwise specified (see Figure 1.3.1b):
  - Clearview Highway 2-W = all standard wayfinding word messages (“W” = white text on dark background)
  - Clearview Highway 1-W = supplemental wayfinding ID word messages (“W” = white text on dark background)
  - Clearview Highway 2-B = all standard wayfinding word messages (“B” = black text on light background)
  - Clearview Highway 1-B = supplemental wayfinding ID word messages (“B” = black text on light background)

**Capitalization**

Aside from special decorative uses where all-caps is desirable and/or used on specific regulatory related messaging, all word messages shall be in “Title Case.” Title Case is defined as the initial “alpha” letter shown in upper case followed by lower case letters for each individual word in a given message.

Examples of exceptions include (but are not limited to):

- EXIT; EXIT ONLY
- DO NOT ENTER
- ATM
- KEEP LEFT; KEEP RIGHT
- NEXT LEFT; NEXT RIGHT

Other notables regarding message capitalization:

- As required by the Americans with Disabilities Act, all tactile messages shall be in all upper case.
- All vehicular wayfinding signage must meet all requirements as established within MUTCD and TXDOT signage design standards.
- Upper case letters shall have an upper case “X” height as determined by using a capital letter “I” when determining a layout’s text height dimension.
- Lower case letters should have a lower case “x” height that is approximately two-thirds the height of the upper case letters.

ClearviewText Medium:

ABCDEFGHIJKLMNOPQRSTUVWXYZ  
 abcdefghijklmnopqrstuvwxyz  
 1234567890 !@#\$%^&\*()-+=\*/:

ClearviewOne Book Condensed:

ABCDEFGHIJKLMNOPQRSTUVWXYZ  
 abcdefghijklmnopqrstuvwxyz  
 1234567890 !@#\$%^&\*()-+=\*/:

Figure 1.3.1a

Type Style: Pedestrian Wayfinding Text Example

Clearview Highway 2-W (“W” = white text on dark background):

ABCDEFGHIJKLMNOPQRSTUVWXYZ  
 abcdefghijklmnopqrstuvwxyz  
 1234567890 !@#\$%^&\*()-+=\*/:

Clearview Highway 1-W (“W” = white text on dark background):

ABCDEFGHIJKLMNOPQRSTUVWXYZ  
 abcdefghijklmnopqrstuvwxyz  
 1234567890 !@#\$%^&\*()-+=\*/:

Clearview Highway 2-B (“B” = black text on light background):

ABCDEFGHIJKLMNOPQRSTUVWXYZ  
 abcdefghijklmnopqrstuvwxyz  
 1234567890 !@#\$%^&\*()-+=\*/:

Clearview Highway 1-B (“B” = black text on light background):

ABCDEFGHIJKLMNOPQRSTUVWXYZ  
 abcdefghijklmnopqrstuvwxyz  
 1234567890 !@#\$%^&\*()-+=\*/:

Figure 1.3.1b

Type Style: Vehicular Wayfinding Text

- Each word in a message shall be capitalized, with the exception of articles, prepositions and conjunctions (i.e. to, from, via, etc.).
- A consistent capital letter height shall always be maintained when wayfinding signs are used in sequence unless otherwise noted.

- Modification of letter shapes is prohibited unless otherwise specified and approved by HAS.
- Condensed, extended, skewed, stretched, outlined or otherwise distorted type shall not be used.

**Typographic Restrictions**

Typefaces or weights not described here shall not be used at HAS airport properties, unless otherwise noted and approved by HAS.

Language to this effect will always be included in the specifications for all related HAS wayfinding signage projects, and variances must be reviewed and approved by HAS.

The following additional typographic restrictions shall always apply and be strictly adhered to when designing or specifying signage for HAS airport properties:

Type styles specialized for a particular sign face or graphic layout shall be used exactly as specified in wayfinding signage design documents. Deviations from the sign type’s application provided in layouts are strictly prohibited. Refer to individual sign types for exact specifications and text sizing/layout details.

- Use only the type styles as specified for a specific traffic type as shown in this document (i.e. Pedestrian vs. Vehicular):
  - Use only Pedestrian type styles on Pedestrian wayfinding signage.
  - Use only Vehicular type styles on Vehicular wayfinding signage.

## HAS WAYFINDING: TYPE SPACING

### Letter Spacing (Kerning and Tracking)

Kerning is typically defined as the process of adjusting the spacing between characters in a proportional font, usually to achieve a visually pleasing result within a set of readable text. Also note that while kerning adjusts the individual spacing between individual letter forms, tracking instead adjusts the spacing uniformly over an overall set/range of characters in a word or set of words. Tracking adjustments are not usually as ideal for readability on wayfinding signage as they tend to make individual words and groups of words more difficult to read, whereas kerning helps to maintain the visual harmony of words.

Unless otherwise indicated, all sign messages shall use the Clearview font family's default letter spacing with regards to kerning and tracking. Messages set according to the typeface maker's letter spacing standards will not normally require adjustment (see Figures 1.3.2a and 1.3.2b). In some circumstances, modification of the spacing between individual letters or letter-sets may improve the appearance and legibility of a sign message. Examples of typical needs for kerning adjustments include (but may not be limited to) improved visibility at increased viewing distances, as well as the elimination of unacceptable levels of "halation" (aka visual blurring together of letter strokes/graphic elements) due to internal or external illumination of the sign face.

Designers are required to review sample messages for all sign projects, and shall recommend spacing modifications where they can be shown to be advantageous or necessary. In these instances, hand-kerning will be required to adjust spacing and shall be noted as such within the sign's specific layout using a +/- pica unit of measurement as used within professional graphic design software. Other letter spacing restrictions include: reducing normal letter or word spacing (i.e. to fit a lengthy message within a restrictive size layout area) is not acceptable and shall always be avoided; punctuation marks, which relate to two letters, should be spaced equally from both letters.

### Word Spacing

Unless otherwise indicated, spacing between words in a message is typically  $\frac{3}{4}$  (.75) times the capital letter height (adjust by appropriate percentage if hand-kerning). For example, a message using 4" cap letters will have approximately 3" between words (see Figures 1.3.2a and 1.3.2b).

### Line Spacing (Leading)

Leading is typically defined as the distance between the baselines of successive lines of type. Typically the \*spacing between *related* lines of message text (i.e. a message in a layout that must continue to the next line down due to not enough available width on the first line) will typically be approximately  $\frac{1}{2}$  (.50) times the capital letter height (unless otherwise noted). And typically the \*spacing between *unrelated* message text lines (i.e. two completely separate ideas/destinations/messages) will typically be approximately 1 times the capital letter height (unless otherwise noted).

*\*NOTE: Always refer to actual HAS wayfinding signage face layouts for all final definitive line spacing requirements per each individual sign type as shown in current HAS wayfinding signage design intent/construction documents.*

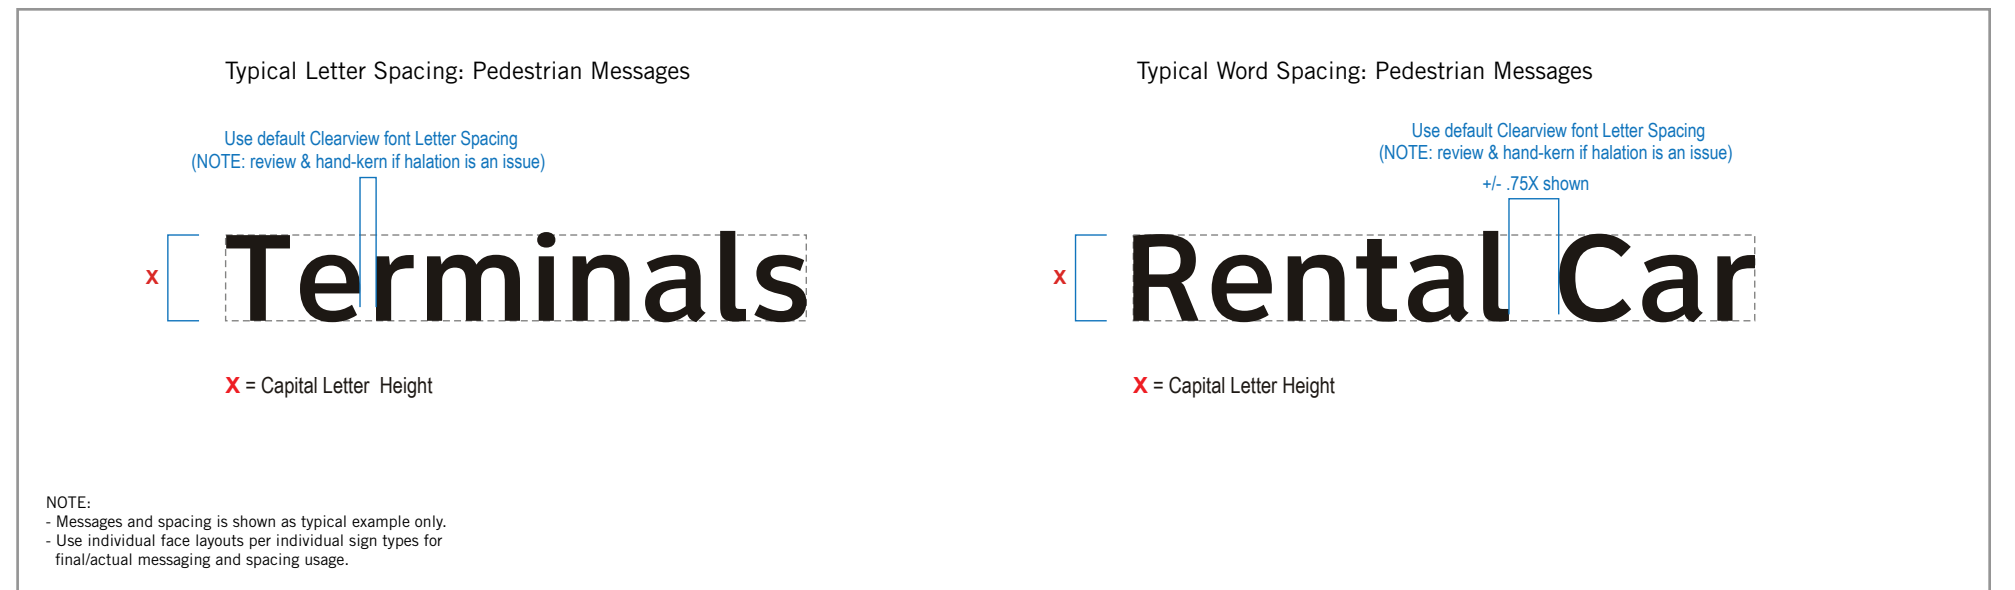


Figure 1.3.2a

Pedestrian Messages: Typical Type Spacing


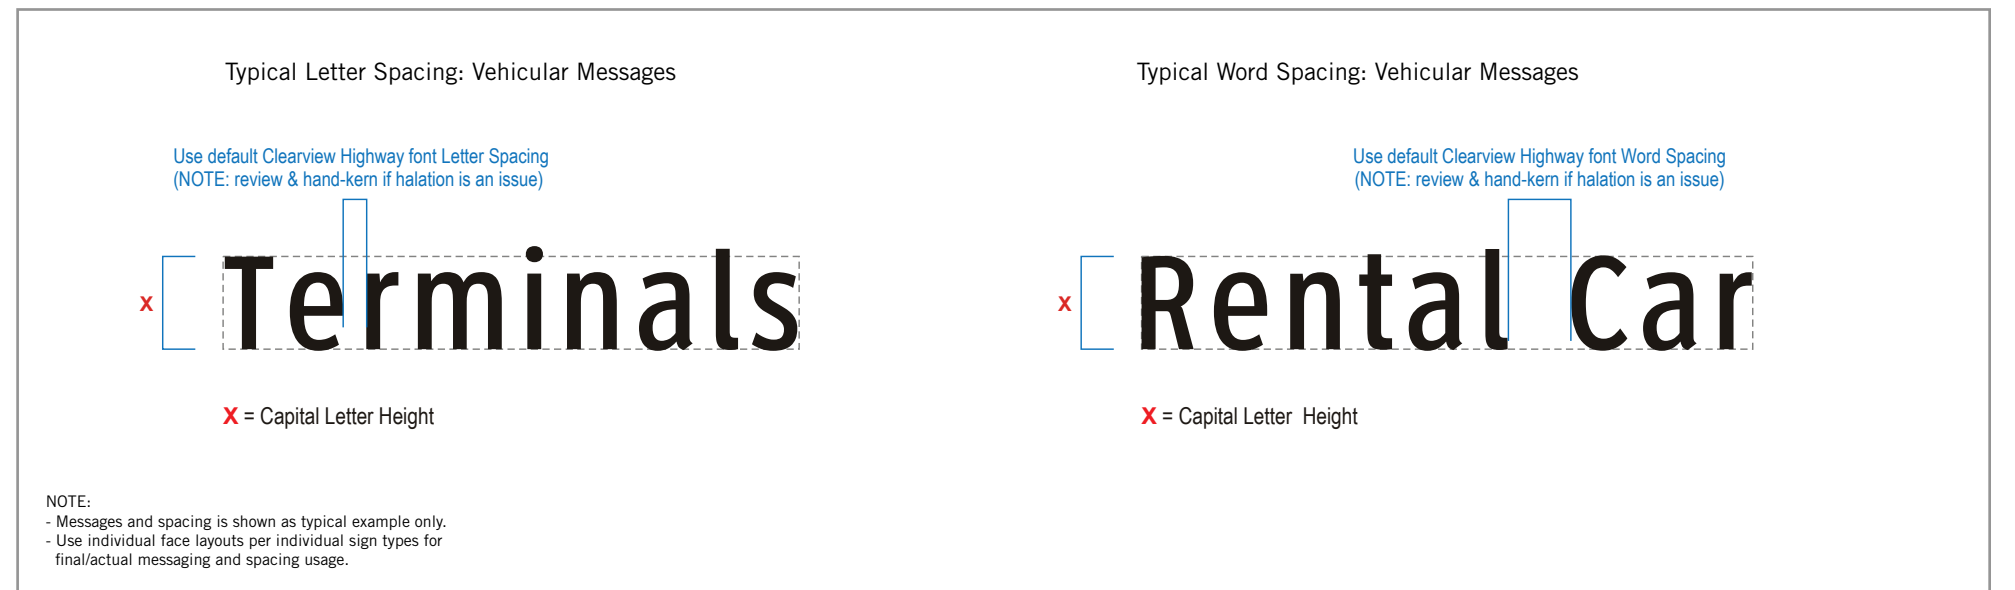



Figure 1.3.2b

Vehicular Messages: Typical Type Spacing

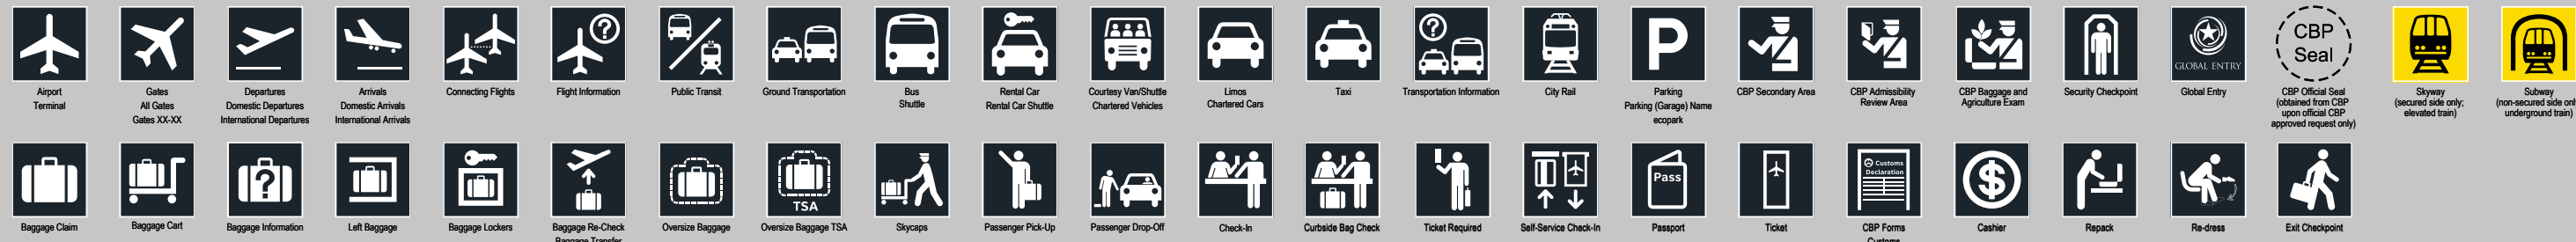TRAVEL SYMBOLS



PUBLIC SERVICE SYMBOLS

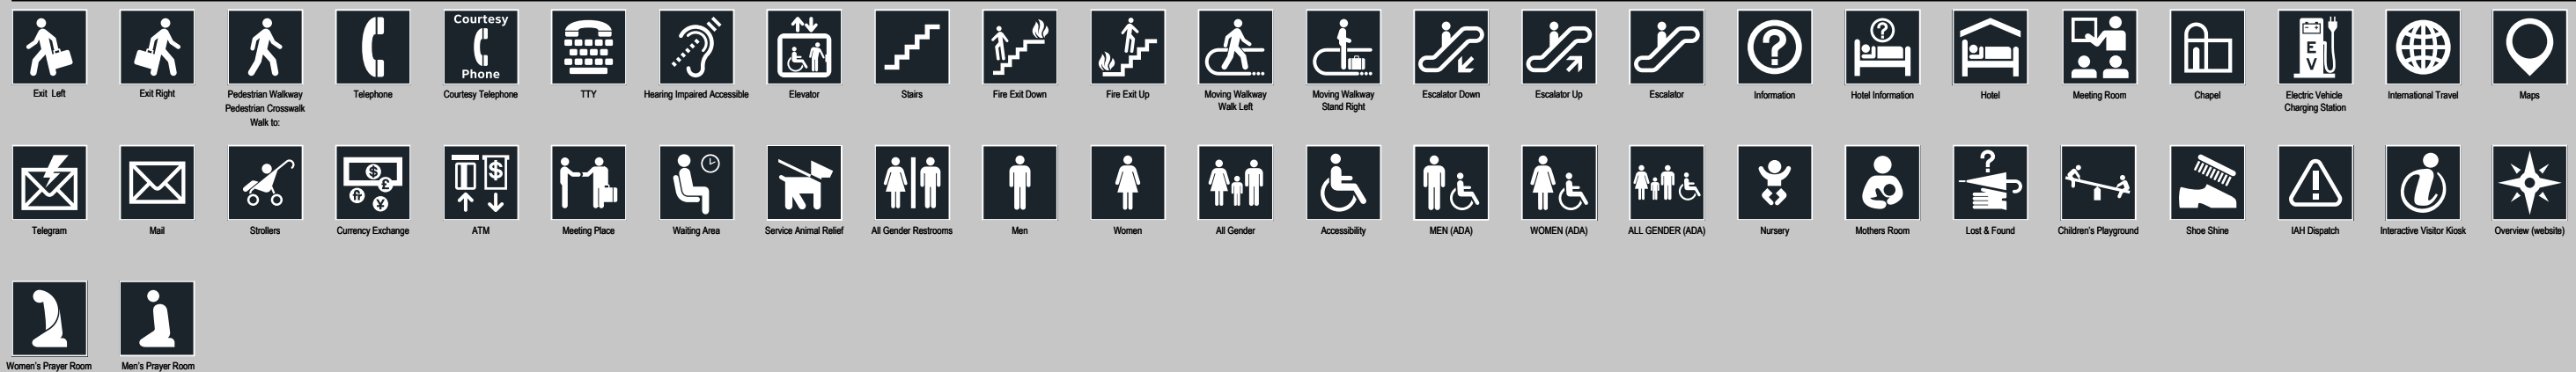

AMENITIES & CONCESSIONS



GROUND TRANSPORTATION



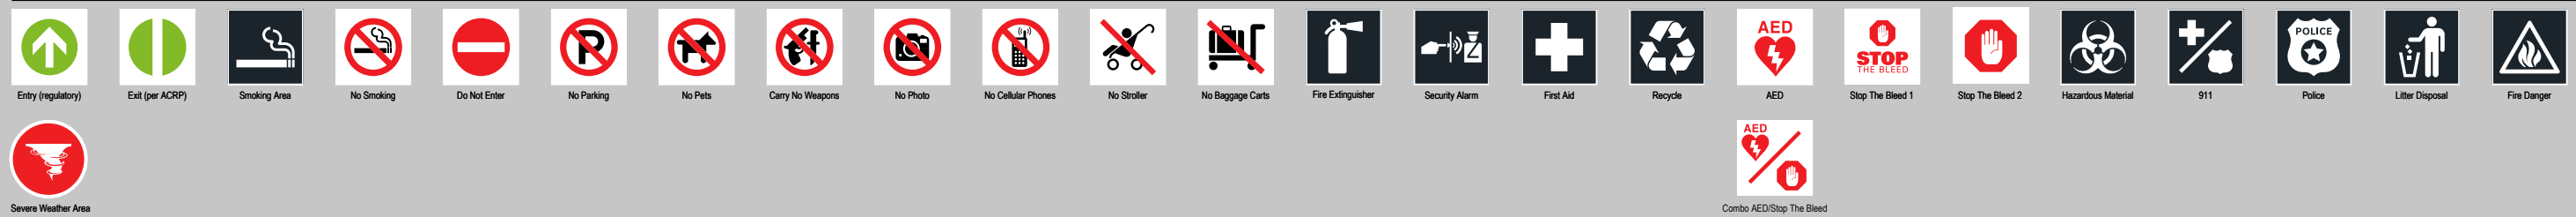
TERMINAL IDENTIFICATION: IAH Only



TXDOT HIGHWAY SHIELDS



REGULATORY



NOTE: Use only HAS wayfinding universal symbol artwork as shown; re-proportioning and/or manipulating is not allowed

UPDATED: 09-22-2023

Figure 1.4.1

HAS Wayfinding Universal Symbols - Master List

## HAS WAYFINDING: ARROWS

Arrows, when used as directional elements, are more flexible and require less sign layout space than messages. This section defines the standards for HAS wayfinding arrows and their rotation angles, sizes, proportions, applications and general placement.

### Arrow Proportions

The standard HAS directional arrow (as shown in Figure 1.5.1) must always be proportionally consistent (width-to-height ratio) throughout the entire sign system, regardless of the sign type or layout that it is being applied to. It should never be disproportioned, squashed or stretched in any dimension in order to make it fit on a sign face with limited size, or for any other circumstance. Typical proportioning between arrow and message sizes for the HAS wayfinding sign system will be determined as follows:

- Pedestrian wayfinding signage:
  - By individual sign face layout sizes, sign locations, visibility distances/angles, mounting heights and per ADA requirements.
- Vehicular wayfinding signage:
  - By individual sign layout sizes, sign locations, visibility distances/angles, mounting heights, posted speeds and per MUTCD/TXDOT standards.

### Arrow Size Scaling

When scaling an arrow, it must always be locked at its default proportions as shown in Figure 1.5.1. This will eliminate the possibility of skewing the arrow's proportions when scaling it for use on differently sized \*sign face layouts.

*\*NOTE: Always refer to actual HAS wayfinding signage face layouts for all final definitive arrow sizing per each individual sign type as shown in current HAS wayfinding signage design intent/construction documents.*

### Arrow Placement and Text Alignment

The placement of arrows on sign faces and in relation to message text will conform to the standard guidelines provided for each specific sign type and their corresponding traffic type (i.e. Pedestrian or Vehicular), as well as all applicable ADA and MUTCD/TXDOT requirements. Arrows and their related message text may not be positioned in any other location on the sign face unless otherwise indicated. When new and/or customized sign types or layouts are necessary, the following general guidelines and restrictions apply to arrows and their corresponding message text alignment:

#### Pedestrian: General Arrow Placement

- Arrows should NEVER point into text.
- Left-facing arrows should be located toward the left side of signs
- Right-facing arrows should be located toward the right side of signs
- Forward-facing and/or downward-facing arrows are typically located closest to the flow of traffic

#### Pedestrian: General Text Alignment with Arrows

- Left-facing arrows require left justified message text/symbols
- Right-facing arrows require right justified message text/symbols

- Forward-facing and/or downward-facing arrows require text/symbols to be justified closest to the flow of traffic (i.e. if forward traffic is hugging the right side of a corridor, the arrow should be on the right side of the face with the text justified right, and vice versa)

#### Vehicular: General Arrow Placement

- Roadside left-facing arrows should be located toward the left side of signs
- Roadside right-facing arrows should be located toward the right side of signs
- Forward-facing and/or Downward-facing arrows on overhead signs are typically centered over their corresponding traffic lanes
- Forward-facing and/or Downward-facing arrows on roadside signs are typically located closest to the flow of traffic or centered (depending on the sign type's use and layout)

#### Vehicular: General Text Alignment with Arrows

- Left-facing arrows require left justified message text/symbols, unless otherwise noted or required by MUTCD/TXDOT
- Right-facing arrows require right justified message text/symbols, unless otherwise noted or required by MUTCD/TXDOT
- Forward-facing arrows on roadside signs typically use text justified toward traffic flow, while overhead signs typically use centered text/arrows

### Arrow Rotation

A consistent rotation angle and the directional information that an arrow conveys is as important as the accompanying message text. The rotation angle that conveys "straight ahead" is particularly notable. For example, either an "up" arrow (12 o'clock) or a "down" arrow (6 o'clock) can be used to convey forward movement, and is typically interpreted differently based on a sign's given location, relative pathway conditions and/or the type of wayfinding traffic that is viewing it.

Note that arrow rotation angle selection must always be done so consistently throughout the entire HAS wayfinding system and in accordance with these established arrow rotation standards. The following are general guidelines for the selection and use of arrow rotation:

- The standard wayfinding arrow can be rendered in eight (8) different pre-determined rotation angles (see Figures 1.5.2a and 1.5.2b). No alternate rotation angles are acceptable, unless approved by HAS.
- Arrow rotation angles should follow the guidelines provided in this section. Straight-ahead pedestrian movement will always be indicated at HAS properties by upward-facing arrows (12 o'clock), unless a downward-facing arrow can be shown to be clearly advantageous in a specific circumstance (i.e. "use this lane"). Note that straight downward-facing arrows (6 o'clock) are typically reserved to indicate movement to a lower level (i.e. at the top of a down stairway or escalator).
- Vehicular wayfinding arrow rotation will always follow MUTCD/TXDOT reqs.
- For a full list of acceptable arrow applications, rotation angles and their designated message interpretations for HAS wayfinding, see Figures 1.5.2a and 1.5.2b.

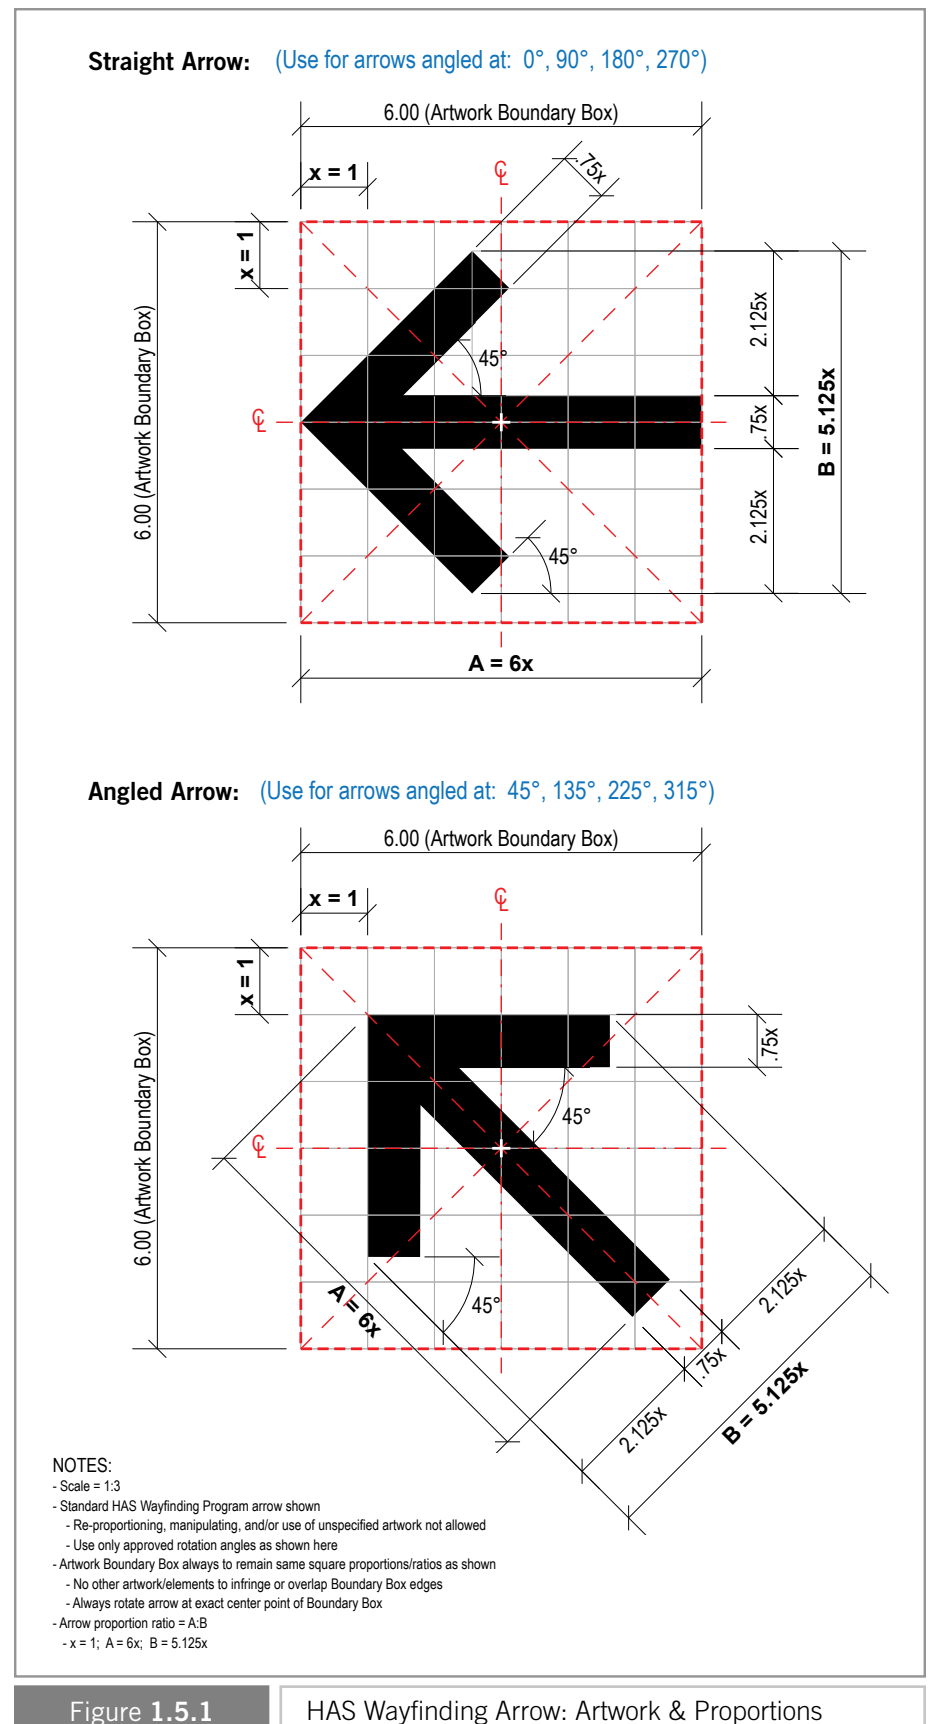

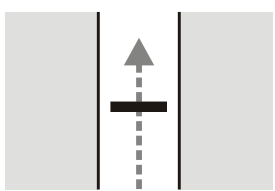

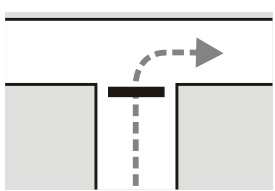

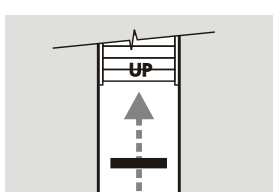

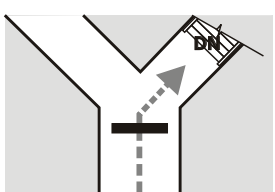

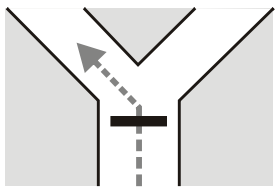

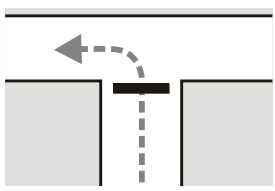

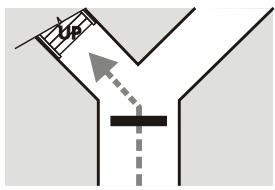

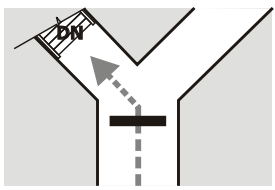

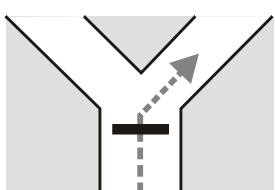

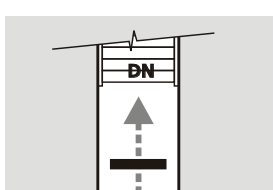

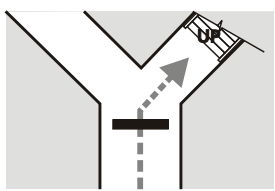

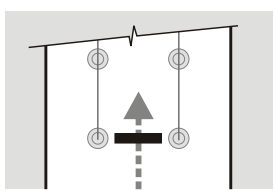


Figure 1.5.1

HAS Wayfinding Arrow: Artwork & Proportions

ARROW ROTATION	LOCATION PLAN EXAMPLE	MESSAGE CONVEYED	ARROW ROTATION	LOCATION PLAN EXAMPLE	MESSAGE CONVEYED
 90° (12 o'clock)		Straight Ahead	 0° (3 o'clock)		Right
 90° (12 o'clock)		Up	 315° (4:30)		Down on the Right
 135° (10:30)		Ahead on the Left	 180° (9 o'clock)		Left
 135° (10:30)		Up on the Left	 225° (7:30)		Down on the Left
 45° (1:30)		Ahead on the Right	 270° (6 o'clock)		Down
 45° (1:30)		Up on the Right	 270° (6 o'clock)		Use this lane / row / aisle / line

NOTES:  
 - Source: Guidelines for Airport Signage & Graphics - Latest Ed.  
 - Schematic representations only; drawings not to scale

Figure 1.5.2a

Wayfinding Arrows: Applications - Pedestrian

OVERHEAD Directionals		
ARROW ROTATION	LOCATION PLAN EXAMPLE	MESSAGE CONVEYED
 90° (12 o'clock)		Straight Ahead (Arrow Justified Center)
 270° (6 o'clock)		Straight Ahead: Use This Lane (Arrow Justified Center)
 315° (4:30)		Down on the Right (Arrow Justified Center)
 225° (7:30)		Down on the Left (Arrow Justified Center)
 45° (1:30)		Exit/Ahead on the Right (Arrow Justified Center)
 135° (10:30)		Exit/Ahead on the Left (Arrow Justified Center)

CANTILEVER Directionals		
ARROW ROTATION	LOCATION PLAN EXAMPLE	MESSAGE CONVEYED
 90° (12 o'clock)		Straight Ahead (Arrow Justified Center)
 90° (12 o'clock)		Straight Ahead (Arrow Justified Center)
 270° (6 o'clock)		Straight Ahead: Use This Lane (Arrow Justified Center)
 270° (6 o'clock)		Straight Ahead: Use This Lane (Arrow Justified Center)
 135° (10:30)		Exit/Ahead on the Left (Arrow Justified Center)
 45° (1:30)		Exit/Up on the Right (Arrow Justified Center)

ROADSIDE Directionals		
ARROW ROTATION	LOCATION PLAN EXAMPLE	MESSAGE CONVEYED
 90° (12 o'clock)		Straight Ahead (Arrow Justified Left)
 90° (12 o'clock)		Straight Ahead (Arrow Justified Right)
 45° (1:30)		Exit/Ahead on the Right (Arrow Justified Right)
 0° (3:00)		To the Right (Arrow Justified Right)
 135° (10:30)		Exit/Ahead on the Left (Arrow Justified Left)
 180° (9 o'clock)		To the Left (Arrow Justified Left)

NOTES:  
 - Arrow applications shown are for general reference only  
 - Arrow type and application may vary based on condition  
 - Reference MUTCD for additional standards and guidelines

Figure 1.5.2b Wayfinding Arrows: Applications - Vehicular

# HAS WAYFINDING: COLOR SYSTEM

In order to maintain a visually and graphically holistic system of wayfinding signage, the presentation of color must always be consistent and maintained on all elements of HAS wayfinding signage. These colors and their manufacturing equivalents (as shown in Figure 1.6.1) shall always be used when designing or specifying HAS wayfinding signage, unless otherwise noted and approved by HAS.

UNIVERSAL COLORS: All HAS Airport Properties												
Hardware/HOU Accent:	Gateways - Dark Silver:	Gateways - Dark Bronze:	White Graphics:	Sign Face Backgrounds:	Divider-Line Graphics:	Neutral Watermark:	ID Header Background:	Black Graphics:	Safety Red:	Warning Yellow:	DOT Legend Green:	
<b>PMS1</b> (Pantone Matching System Ref.) N/A: Not Used	<b>PMS2</b> (Pantone Matching System Ref.) N/A: Not Used	<b>PMS3</b> (Pantone Matching System Ref.) N/A: Not Used	<b>PMS4</b> (Pantone Matching System Ref.) N/A: Not Used	<b>PMS5</b> (Pantone Matching System Ref.) PMS 433C (Solid Coated)	<b>PMS6</b> (Pantone Matching System Ref.) PMS 432C (Solid Coated)	<b>PMS7</b> (Pantone Matching System Ref.) PMS 430C (Solid Coated)	<b>PMS8</b> (Pantone Matching System Ref.) PMS 427C (Solid Coated)	<b>PMS9</b> (Pantone Matching System Ref.) PMS Black C (Solid Coated)	<b>PMS10</b> (Pantone Matching System Ref.) PMS 186C (Solid Coated)	<b>PMS11</b> (Pantone Matching System Ref.) PMS 116C (Solid Coated)	<b>PMS12</b> (Pantone Ref.) PMS 342C (Solid Coated)	<b>PMS12.2</b> (Pantone Ref.) N/A: Note Used
<b>D1</b> (Digital Print Equivalent) N/A: Not Used	<b>D2</b> (Digital Print Equivalent) N/A: Not Used	<b>D3</b> (Digital Print Equivalent) N/A: Not Used	<b>D4</b> (Digital Print Equivalent) White = C:0 M:0 Y:0 K:0; Roadway signs = 3M 4090 DG3 White (showing thru)	<b>D5</b> (Digital Print Equivalent) Match PMS 433C; Roadway signs = Picasso print on DG3 C:0 M:0 Y:0 K:90 (cool gray row)	<b>D6</b> (Digital Print Equivalent) Match PMS 432C	<b>D7</b> (Digital Print Equivalent) Match PMS 430C	<b>D8</b> (Digital Print Equivalent) Match PMS 427C; Roadway signs = Picasso print on DG3 C:0 M:0 Y:0 K:100 (cool gray row)	<b>D9</b> (Digital Print Equivalent) C:50 M:40 Y:40 K:100; Roadway signs = Picasso print on DG3 C:0 M:0 Y:0 K:100 (cool gray row)	<b>D10</b> (Digital Print Equivalent) Match PMS 186C	<b>D11</b> (Digital Print Equivalent) Match PMS 116C	<b>D12</b> (Digital Print Eq.) Match PMS 342C	<b>D12.2</b> (Digital Print Eq.) Match "Waller Green" custom color
<b>P1</b> (Gateway Paint Eq.) Matthews Acrylic Polyurethane (MAP) #41342SP Brushed Aluminum, satin finish	<b>P2</b> (Paint Equivalent) Matthews Acrylic Polyurethane (MAP) #MP32195 Staid Gray Metallic, satin finish	<b>P3</b> (Paint Equivalent) Matthews Acrylic Polyurethane (MAP) #41313SP Dark Bronze, satin finish	<b>P4</b> (Paint Equivalent) Matthews Acrylic Polyurethane (MAP) MP N202 White, satin finish	<b>P5</b> (Paint Equivalent) Matthews Acrylic Polyurethane (MAP) to match PMS 433C, satin finish	<b>P6</b> (Paint Equivalent) Matthews Acrylic Polyurethane (MAP) to match PMS 432C, satin finish	<b>P7</b> (Paint Equivalent) Matthews Acrylic Polyurethane (MAP) to match PMS 430C, satin finish	<b>P8</b> (Paint Equivalent) Matthews Acrylic Polyurethane (MAP) to match PMS 427C, satin finish	<b>P9</b> (Paint Equivalent) Matthews Acrylic Polyurethane (MAP) to match TBD, satin finish	<b>P10</b> (Paint Equivalent) Matthews Acrylic Polyurethane (MAP) to match PMS 186C, satin finish	<b>P11</b> (Paint Equivalent) Matthews Acrylic Polyurethane (MAP) to match PMS 116C, satin finish	<b>P12</b> (Paint Eq.) MAP to match PMS 342C, satin fin.	<b>P12.2</b> (Paint Eq.) MAP to match "Waller Green," satin fin.
<b>P1.2</b> (HOU/EFD Accent Paint) Matthews Acrylic Polyurethane (MAP) #MP33172 Silver Surfer Metallic, satin fin.	<b>V2</b> (Vinyl Film Equivalent) N/A: Not Used	<b>V3</b> (Vinyl Film Equivalent) N/A: Not Used	<b>V4.x</b> (NOTE: "x" = see below) (Vinyl Film Equivalent) V4.1 = Opaque: 3M 7725-20 White V4.2 = Reflective: 3M 4090 DG3 White T4.3 = Tactile: White to match V4.1 V4.4 = Translucent: White plex to match V4.1	<b>V5</b> (Vinyl Film Equivalent) Use Digital Print Equivalent on White film	<b>V6</b> (Vinyl Film Equivalent) Use Digital Print Equivalent on White film	<b>V7</b> (Vinyl Film Equivalent) Use Digital Print Equivalent on White film	<b>V8</b> (Vinyl Film Equivalent) Use Digital Print Equivalent on White film	<b>V9</b> (Vinyl Film Equivalent) Opaque: 3M 7725-22 Black	<b>V10</b> (Vinyl Film Equivalent) Reflective: 3M 4092 DG3 Red	<b>V11</b> (Vinyl Film Equivalent) Reflective: 3M 4091 DG3 Yellow	<b>V12</b> (Vinyl Film Eq.) Reflective: 3M 4097 DG3 Green	<b>V12.2</b> (Vinyl Film Eq.) Ref.: Use Digital Print Eq. on White film
<b>NOTE: Also used only on HOU roadway signs</b>												
TERMINAL BRANDED ID COLORS: IAH Only												
<b>PMS13</b> (Pantone Matching System Ref.) PMS 349C (Solid Coated)	<b>PMS14</b> (Pantone Matching System Ref.) PMS 3435C (Solid Coated)	<b>PMS15</b> (Pantone Matching System Ref.) PMS 2597C (Solid Coated)	<b>PMS16</b> (Pantone Matching System Ref.) PMS 2695C (Solid Coated)	<b>PMS17</b> (Pantone Matching System Ref.) PMS 300C (Solid Coated)	<b>PMS18</b> (Pantone Matching System Ref.) PMS 294C (Solid Coated)	<b>PMS19</b> (Pantone Matching System Ref.) PMS 187C (Solid Coated)	<b>PMS20</b> (Pantone Matching System Ref.) PMS 188C (Solid Coated)	<b>PMS21</b> (Pantone Matching System Ref.) PMS 1655C (Solid Coated)	<b>PMS22</b> (Pantone Matching System Ref.) PMS 180C (Solid Coated)	<b>PMS23</b> (Pantone Matching System Ref.) PMS 3965C (Solid Coated)	<b>PMS24</b> (Pantone Matching System Ref.) PMS 3975C (Solid Coated)	
<b>D13</b> (Digital Print Equivalent) Match PMS 349C; Roadway signs = Picasso print on DG3 C:90 M:50 Y:90 K:0	<b>D14</b> (Digital Print Equivalent) Match PMS 3435C	<b>D15</b> (Digital Print Equivalent) Match PMS 2597C; Roadway signs = Picasso print on DG3 C:70 M:100 Y:0 K:0	<b>D16</b> (Digital Print Equivalent) Match PMS 2695C	<b>D17</b> (Digital Print Equivalent) Match PMS 300C; Roadway signs = Picasso print on DG3 C:100 M:50 Y:0 K:0	<b>D18</b> (Digital Print Equivalent) Match PMS 294C	<b>D19</b> (Digital Print Equivalent) Match PMS 187C; Roadway signs = Picasso print on DG3 C:30 M:100 Y:80 K:0	<b>D20</b> (Digital Print Equivalent) Match PMS 188C	<b>D21</b> (Digital Print Equivalent) Match PMS 1655C; Roadway signs = Picasso print on DG3 C:0 M:70 Y:100 K:0	<b>D22</b> (Digital Print Equivalent) Match PMS 180C	<b>D23</b> (Digital Print Equivalent) Match PMS 3965C	<b>D24</b> (Digital Print Equivalent) Match PMS 3975C	
<b>P13</b> (Paint Equivalent) Matthews Acrylic Polyurethane (MAP) to match PMS 349C, satin finish	<b>P14</b> (Paint Equivalent) Matthews Acrylic Polyurethane (MAP) to match PMS 3435C, satin finish	<b>P15</b> (Paint Equivalent) Matthews Acrylic Polyurethane (MAP) to match PMS 2597C, satin finish	<b>P16</b> (Paint Equivalent) Matthews Acrylic Polyurethane (MAP) to match PMS 2695C, satin finish	<b>P17</b> (Paint Equivalent) Matthews Acrylic Polyurethane (MAP) to match PMS 300C, satin finish	<b>P18</b> (Paint Equivalent) Matthews Acrylic Polyurethane (MAP) to match PMS 294C, satin finish	<b>P19</b> (Paint Equivalent) Matthews Acrylic Polyurethane (MAP) to match PMS 187C, satin finish	<b>P20</b> (Paint Equivalent) Matthews Acrylic Polyurethane (MAP) to match PMS 188C, satin finish	<b>P21</b> (Paint Equivalent) Matthews Acrylic Polyurethane (MAP) to match PMS 1655C, satin finish	<b>P22</b> (Paint Equivalent) Matthews Acrylic Polyurethane (MAP) to match PMS 180C, satin finish	<b>P23</b> (Paint Equivalent) Matthews Acrylic Polyurethane (MAP) to match PMS 3965C, satin finish	<b>P24</b> (Paint Equivalent) Matthews Acrylic Polyurethane (MAP) to match PMS 3975C, satin finish	
<b>V13</b> (Vinyl Film Equivalent) Use Digital Print Equivalent on White film	<b>V14</b> (Vinyl Film Equivalent) Use Digital Print Equivalent on White film	<b>V15</b> (Vinyl Film Equivalent) Use Digital Print Equivalent on White film	<b>V16</b> (Vinyl Film Equivalent) Use Digital Print Equivalent on White film	<b>V17</b> (Vinyl Film Equivalent) Use Digital Print Equivalent on White film	<b>V18</b> (Vinyl Film Equivalent) Use Digital Print Equivalent on White film	<b>V19</b> (Vinyl Film Equivalent) Use Digital Print Equivalent on White film	<b>V20</b> (Vinyl Film Equivalent) Use Digital Print Equivalent on White film	<b>V21</b> (Vinyl Film Equivalent) Use Digital Print Equivalent on White film	<b>V22</b> (Vinyl Film Equivalent) Use Digital Print Equivalent on White film	<b>V23</b> (Vinyl Film Equivalent) Use Digital Print Equivalent on White film	<b>V24</b> (Vinyl Film Equivalent) Use Digital Print Equivalent on White film	
<b>NOTE: Also used as HOU - Ecopark (Parking Lot) ID</b>				<b>NOTE: Also used as HOU - Blue (aka "New") Garage ID</b>				<b>NOTE: Also used as HOU - Red (aka "Existing") Garage ID</b>				


Figure 1.6.1

HAS Wayfinding Color System



5-DR.01 to 5-DR.19 = Vehicular Directionals: **CEILING** Mount - **Suspended**

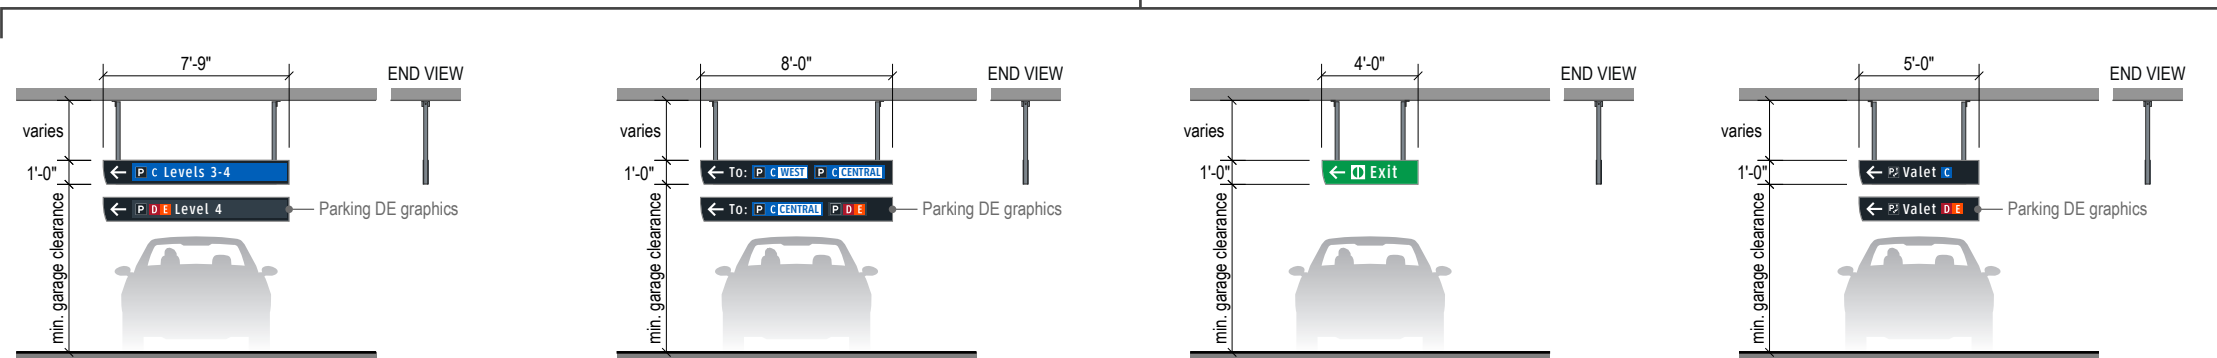Signage with **STATIC** Panels Only




**5-DR.01a** Ceiling Susp. Level/Garage Trailblazer - Static  
 - Vehicular  
 - Arrow = 8"; Symbols = 5.5"  
 - Text = 5"  
 Qty. = 24

**5-DR.02a** Ceiling Susp. Multi-Garage Trailblazer - Static  
 - Vehicular  
 - Arrow = 8"; Symbols = 5.5"  
 - Text = 5"  
 Qty. = 20

**5-DR.03b** Ceiling Susp. Exit Trailblazer - Static  
 - Vehicular  
 - Arrow = 8"; Symbol = 7"  
 - Text = 6"  
 Qty. = 198

**5-DR.04** Ceiling Susp. Valet Trailblazer - Static  
 - Vehicular  
 - Arrow = 8"; Symbols = 5.5"  
 - Text = 5"  
 Qty. = 7

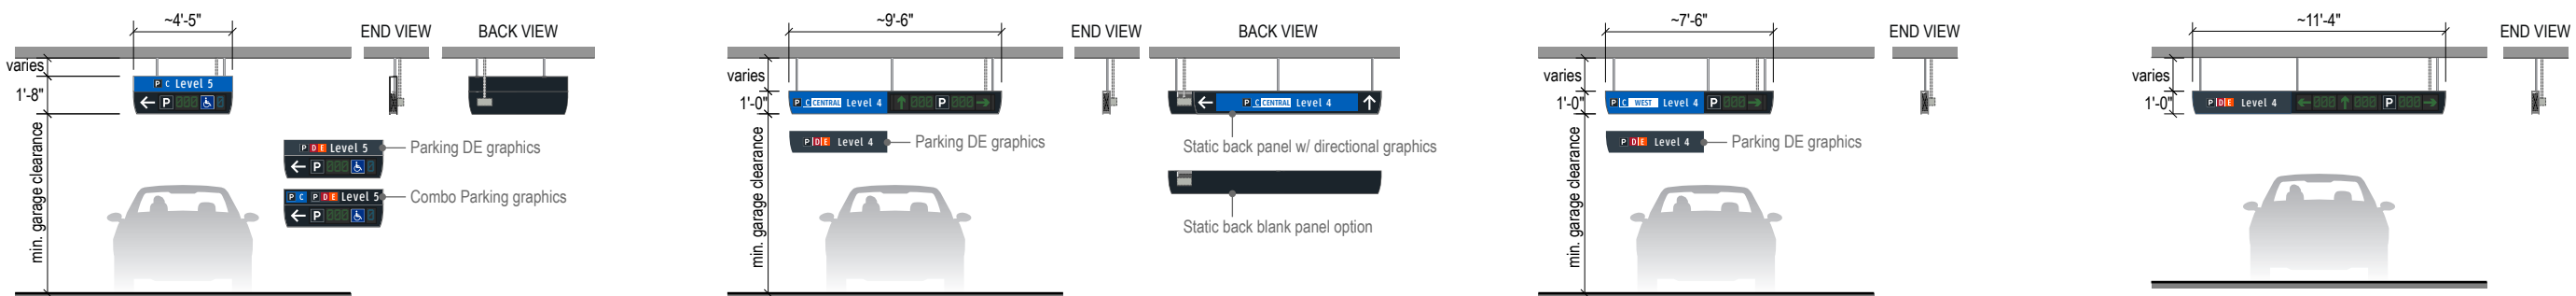Cover Panels over Signage with **DIGITAL** Areas



**5-DR.08** **Digital Single-sided (front = digital area):**  
 1-way Ceiling Susp. Directional Cover Panels w/ ID Header  
 - Vehicular  
 - ID Header Panel = Static (4.5" text & symbol)  
 - "P" symbol = Static (7")  
 - Space count no.'s = Digital (~5")  
 - Arrow = Static (8")  
 Qty. = 19

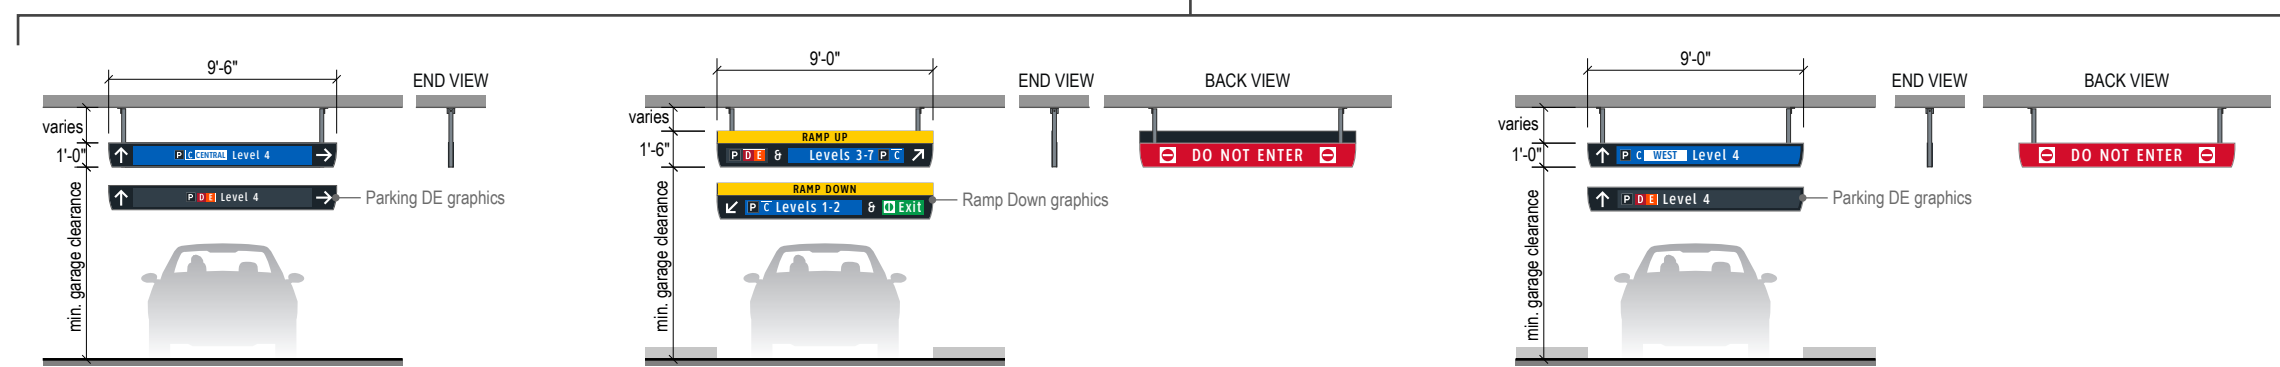
**5-DR.09** **Digital Single-sided (front = digital area; back = static):**  
 2-way Ceiling Susp. Space Count Directional Cover Panels  
 - Vehicular  
 - Level ID graphics = Static (4.5")  
 - "P" symbol = Static (7")  
 - Space count no.'s = Digital (~5")  
 - Arrows: Digital (~8"); Static (8")  
 Qty. = 52

**5-DR.09b** **Digital Single-sided (front = digital; back = static):**  
 1-way Ceiling Susp. Space Count Directional Cover Panels  
 - Vehicular  
 - Level ID graphics = Static (4.5")  
 - "P" symbol = Static (7")  
 - Space count no.'s = Digital (~5")  
 - Arrows: Digital (~8"); Static (8")  
 Qty. = 17

**5-DR.09c** **Digital Single-sided (front = digital; back = static):**  
 3-way Ceiling Susp. Space Count Directional Cover Panels  
 - Vehicular  
 - Level ID graphics = Static (4.5")  
 - "P" symbol = Static (7")  
 - Space count no.'s = Digital (~5")  
 - Arrows: Digital (~8"); Static (8")  
 Qty. = 2

5-DR.01 to 5-DR.19 = Vehicular Directionals: **CEILING** Mount - **Suspended** (cont.)

Signage with **STATIC** Panels Only




**5-DR.09a** 2-way Ceiling Susp. Parking Row Directional - Static  
 - Vehicular  
 - Level ID graphics = Static (4.5")  
 - Arrows = Static (8")  
**Qty. = 57**

**5-DR.12** Ceiling Susp. Ramp Entry Directional - Static  
 - Vehicular  
 - ID Header Panel (6" H panel; 4" text)  
 - Arrow = 8"  
 - Symbols/Badges = 5.5"  
 - Text = 5"  
 - Do Not Enter (8" symbol; 6" text)  
**Qty. = 11**

**5-DR.13a** Ceiling Susp. Level/Bridge Entry Directional - Static  
 - Vehicular  
 - Arrow = 8"  
 - Symbols/Badges = 5.5"  
 - Text = 5"  
 - Do Not Enter (8" symbol; 6" text)  
**Qty. = 15**


5-DR.50 to 5-DR.59 = Vehicular Directionals: **POST** Mount

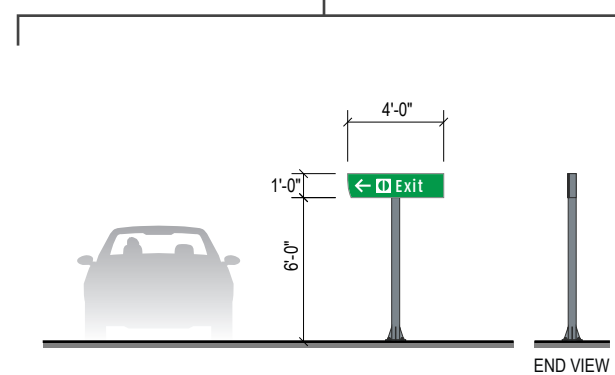Signage with **STATIC** Panels Only



**5-DR.53b** Post Mount Exit Trailblazer - Static  
 - Vehicular  
 - Arrow = 8"; Symbol = 7"  
 - Text = 6"  
**Qty. = 25**

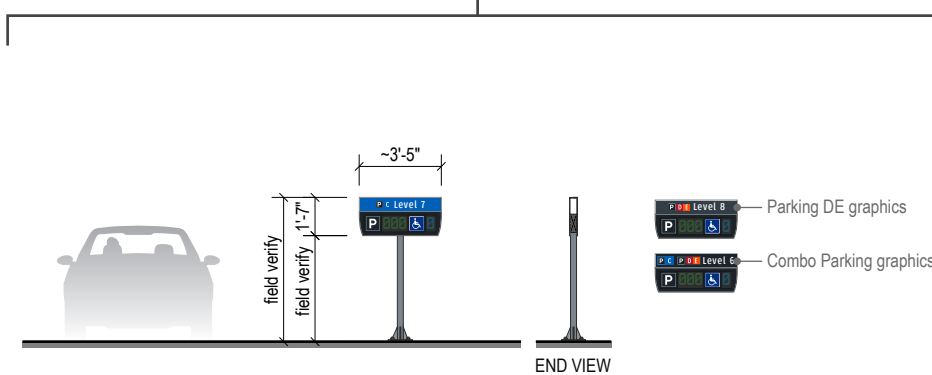
Cover Panels over Signage with **DIGITAL** Areas



**5-DR.58** **Digital Single-sided (front = digital area):**  
 Post Mount Level ID/Space Count Digital Unit Cover Panels w/ ID Header  
 - Vehicular  
 - ID Header Panel = Static (3.5" text & 4" symbol)  
 - "P" symbol = Static (7")  
 - Space count no.'s = Digital (~5")  
 - Arrow = Static (8")  
**Qty. = 7**


5-ID.01 to 5-ID.10 = Vehicular Identification: **CEILING** Mount - **Suspended**

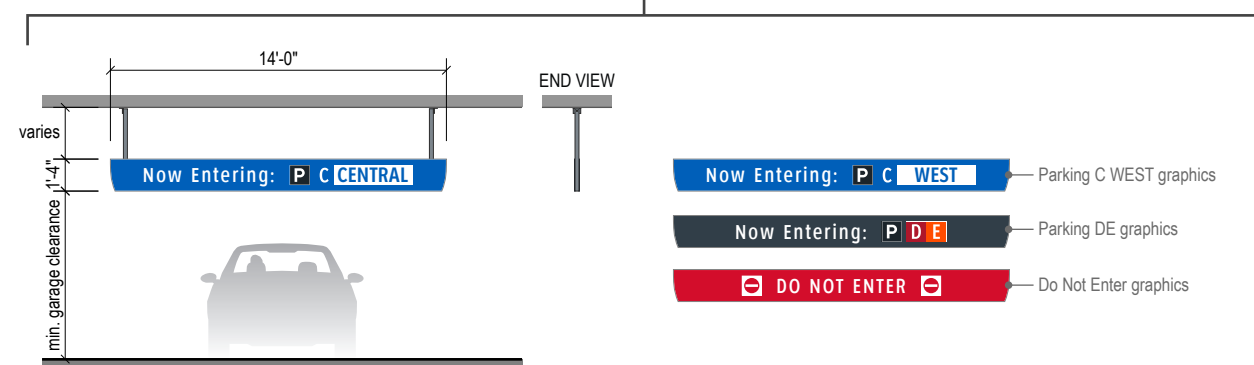Signage with **STATIC** Panels Only



**5-ID.01** Ceiling Susp. Garage Area Boundary ID - Static  
 - Vehicular  
 - Symbols/Badges = 10"  
 - Text = 7"  
 Qty. = 9

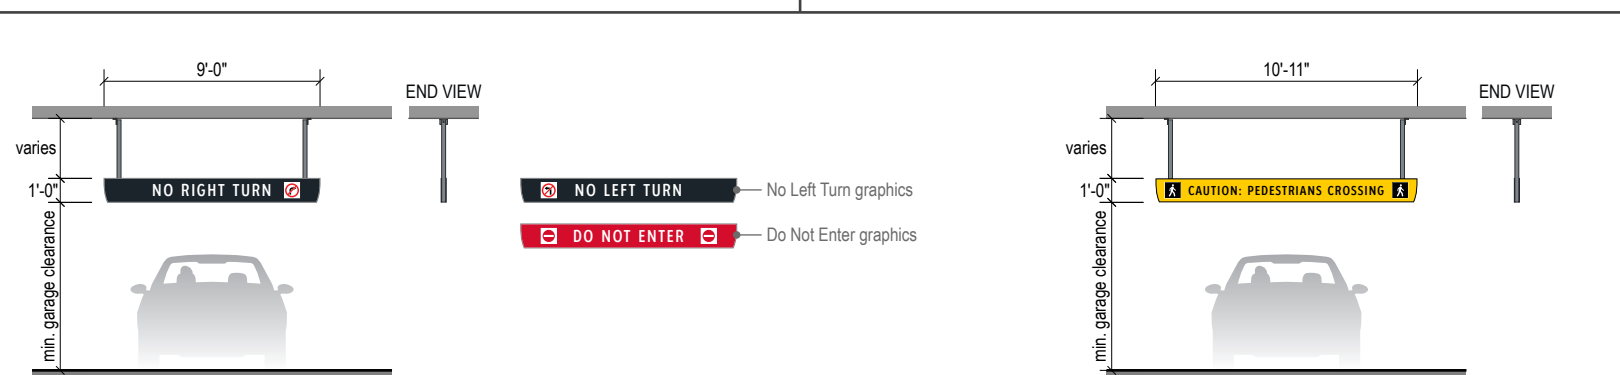Signage with **STATIC** Panels Only




**5-ID.06** Ceiling Susp. Ramp No Turn/Do Not Enter ID - Static  
 - Vehicular  
 - Symbol = 8"  
 - Text = 6"  
 Qty. = 7


**5-ID.07** Ceiling Susp. Pedestrian Crossing Caution ID - Static  
 - Vehicular  
 - Symbol = 8"  
 - Text = 4.5"  
 Qty. = 17

Parking Garage - Pedestrian (Scale: 1/8" = 1'-0")

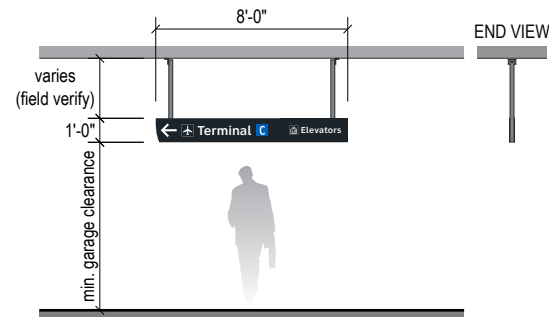
5-DR.30 to 5-DR.39 = Pedestrian Directionals: CEILING Mount - Suspended



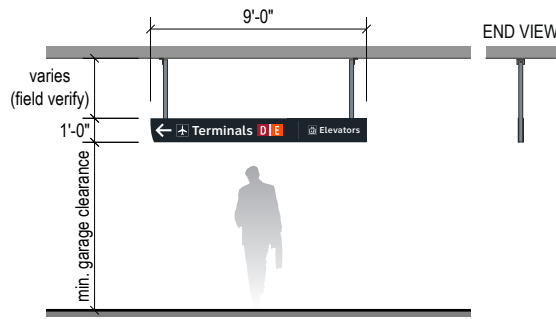**5-DR.31** Ceiling Susp. C Terminal/Elevator Trailblazer  
 - Pedestrian  
 - Arrow = 8"  
 - Terminal ID: symbol = 7.5"; text = 4.5"  
 - Elevators ID: symbol = 4.5"; text = 3"  
 Qty. = 218



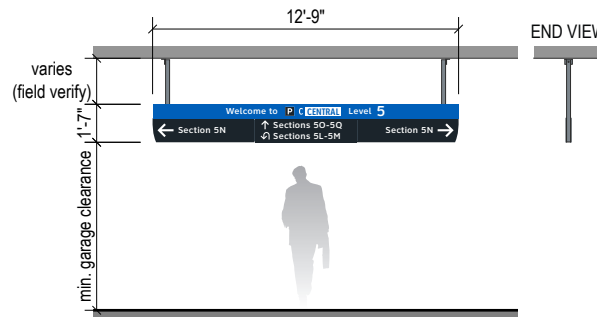
**5-DR.31b** Ceiling Susp. DE Terminal/Elevator Trailblazer  
 - Pedestrian  
 - Arrow = 8"  
 - Terminal ID: symbol = 7.5"; text = 4.5"  
 - Elevators ID: symbol = 4.5"; text = 3"  
 Qty. = 66




**5-DR.34** Ceiling Susp. Garage ID/Sections Multi-way Directional  
 - Pedestrian  
 - ID Header (4.5" badge; 3"-5" text)  
 - Arrow = 8"; Symbol = 5"; Text = 3"  
 Qty. = 17



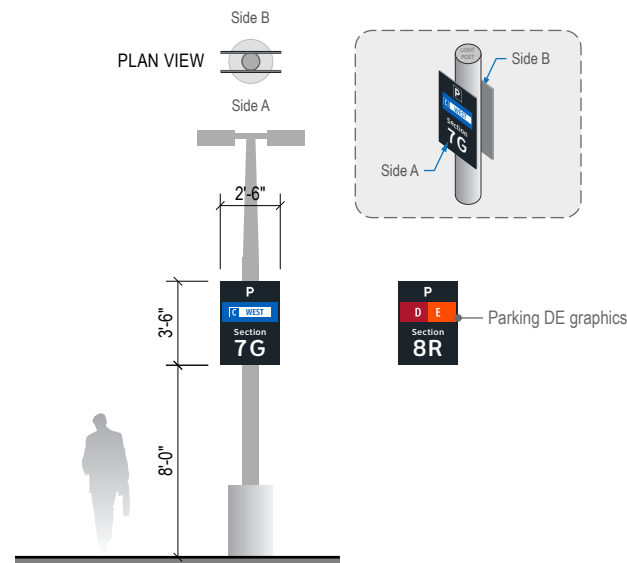5-ID.40 to 5-ID.49 = Pedestrian Identification: POST Mount




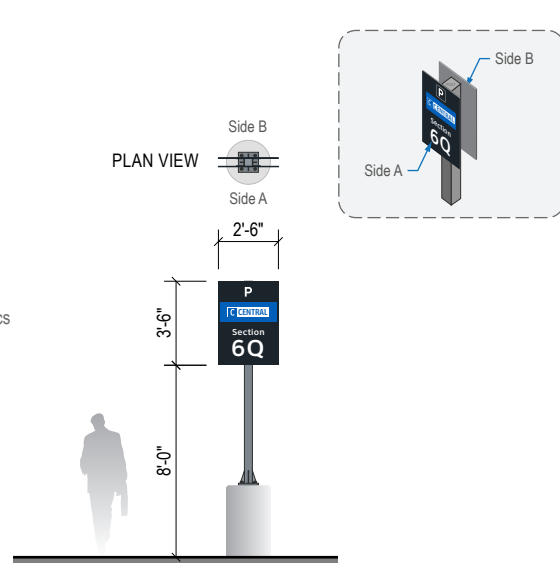**5-ID.41b** Light Post Mount Parking Section/Garage ID  
 - Pedestrian  
 - Symbols: "P" = 7"; Garage ID badge = 4.5"  
 - Text: Section = 3"; No. = 8"  
 Qty. = 14




**5-ID.43** Post/Bollard Mount Parking Section/Garage ID  
 - Pedestrian  
 - Symbols: "P" = 7"; Garage ID badge = 4.5"  
 - Text: Section = 3"; No. = 8"  
 Qty. = 88

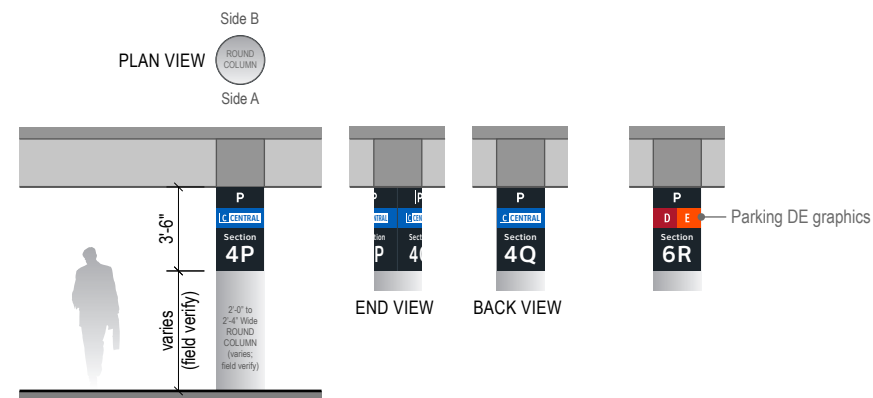5-ID.50 to 5-ID.54 = Pedestrian Identification: COLUMN Mount



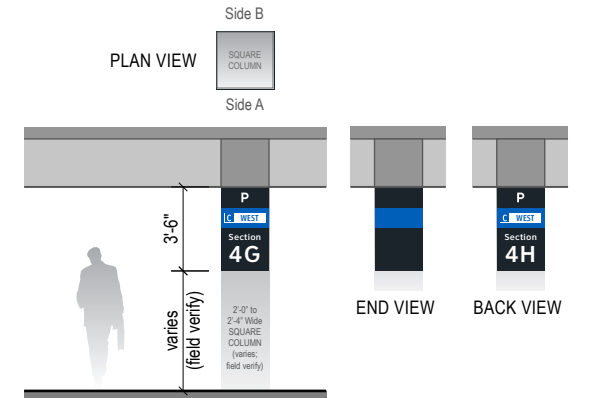
**5-ID.52** Round Single Column-Wrap Parking Section/Garage ID  
 - Pedestrian  
 - "P" symbol = 7"  
 - Garage ID badge: C = 4.5"; DE = 6"  
 - Section ID text = 3"  
 - Section no. text = 8"  
 Qty. = 245




**5-ID.53** Square Single Column-Wrap Parking Section/Garage ID  
 - Pedestrian  
 - "P" symbol = 7"  
 - Garage ID badge = 4"  
 - Section ID text = 3"  
 - Section no. text = 8" (Level 1a = 6.5")  
 Qty. = 353

Parking Garage - Pedestrian (Scale: 1/8" = 1'-0")

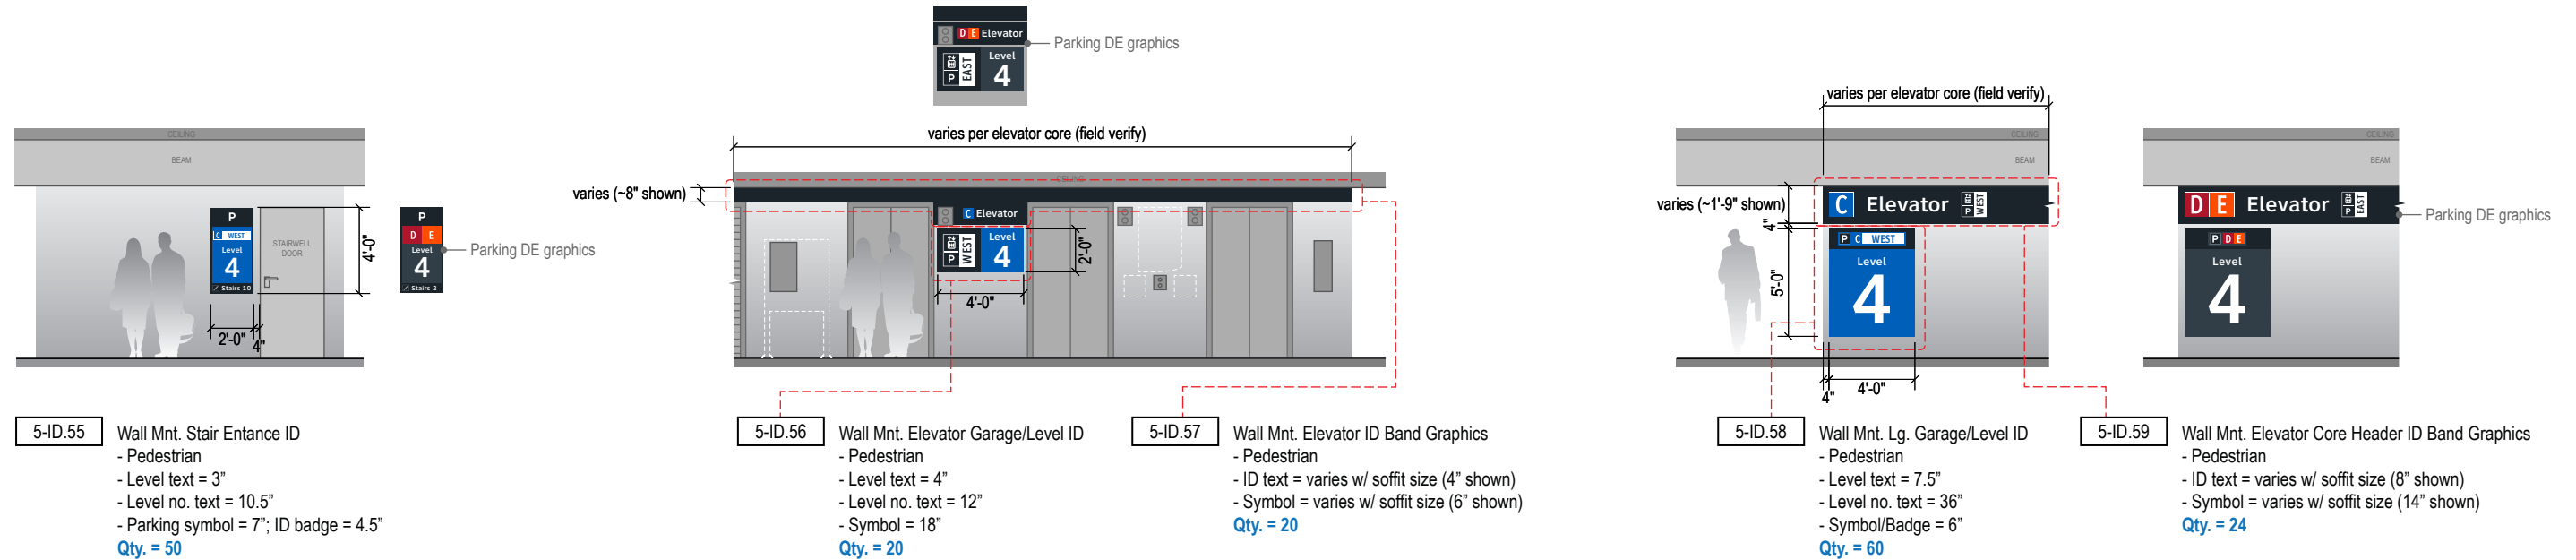
5-ID.55 to 5-ID.59 = Pedestrian Identification: Elevator/Stair Areas - WALL Mount



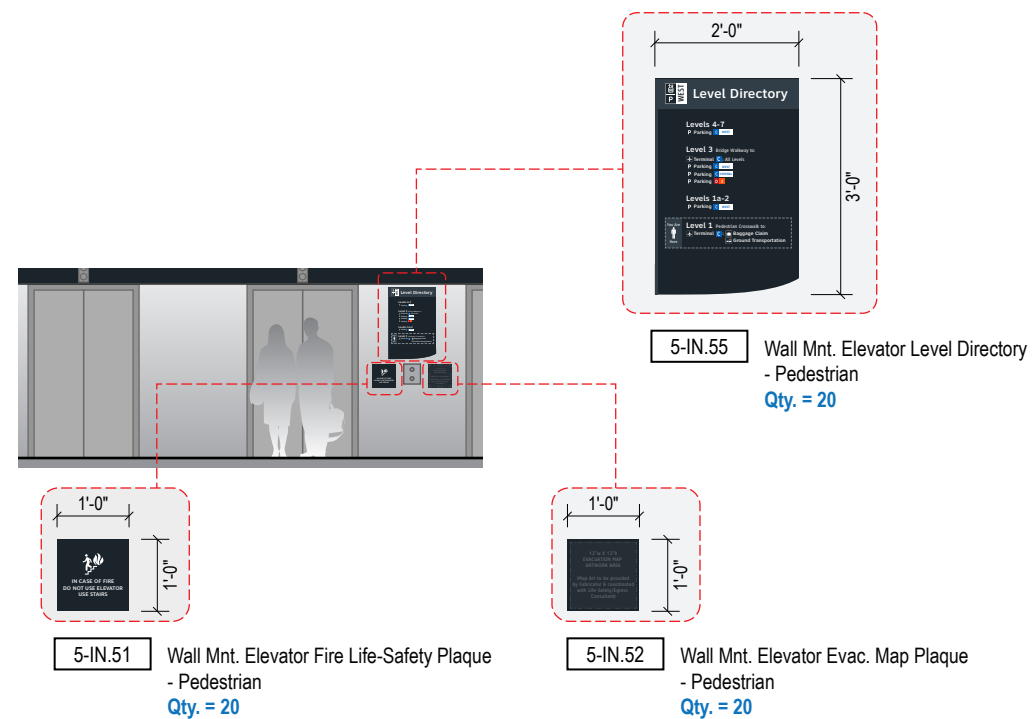5-IN.50 to 5-IN.59 = Pedestrian Informational: Elevator Areas - WALL Mount



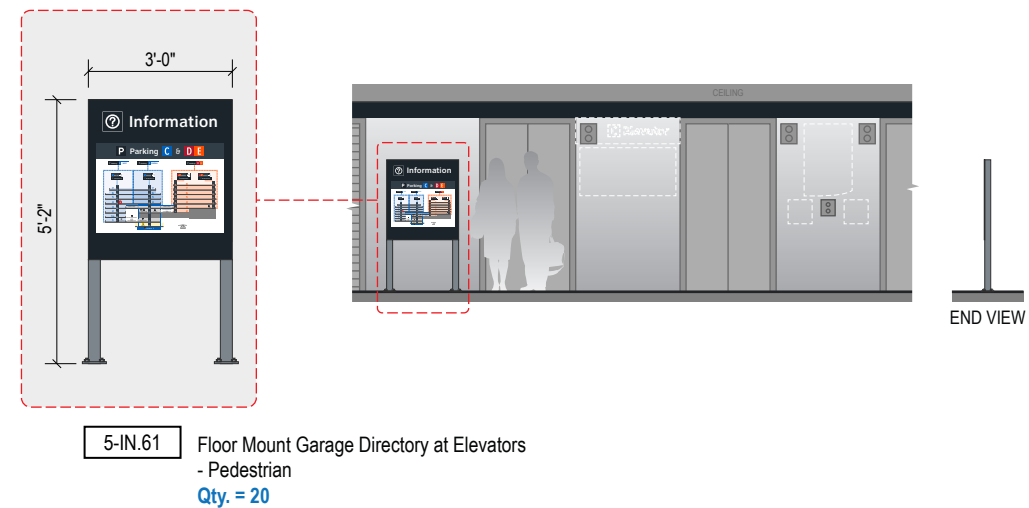5-IN.60 to 5-IN.69 = Pedestrian Informational: Elevator Areas - FLOOR Mount



Miscellaneous Other Areas - **Pedestrian** (Scale: 1/8" = 1'-0")

1-ID.30 to 1-ID.39 = Pedestrian Identification: **WALL Mount - Plaques & Restroom ID**



1-ID.30 Wall Mount Tactile Room ID  
- Pedestrian

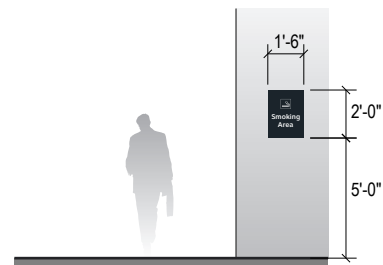


1-ID.31 Wall Mount Tactile Restroom ID  
- Pedestrian

3t-ID.20 to 3t-ID.29 = Transitional Identification: **SOFFIT / WALL Mount**




3t-ID.33 Terminal Symbol ID  
- Pedestrian



3t-ID.34 Smoking Area ID  
- Pedestrian

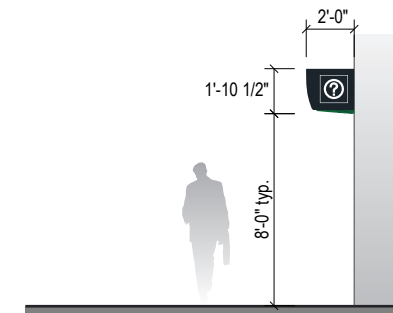3t-ID.40 to 3t-ID.49 = Transitional Identification: **FLAG Mount**



3t-ID.43 Trans. Flag Mount ID  
- Pedestrian

Miscellaneous Terminal / Curbside **Regulatory** (Scale: 3/4" = 1'-0")

**1t-RG.20 to 1t-ID.29** = Wall Mount Regulatory Signage

1t-RG.24  
Restricted Area

**3t-RG.20 to 3-RG.29** = Regulatory: WALL Mount

3t-RG.23  
No Smoking

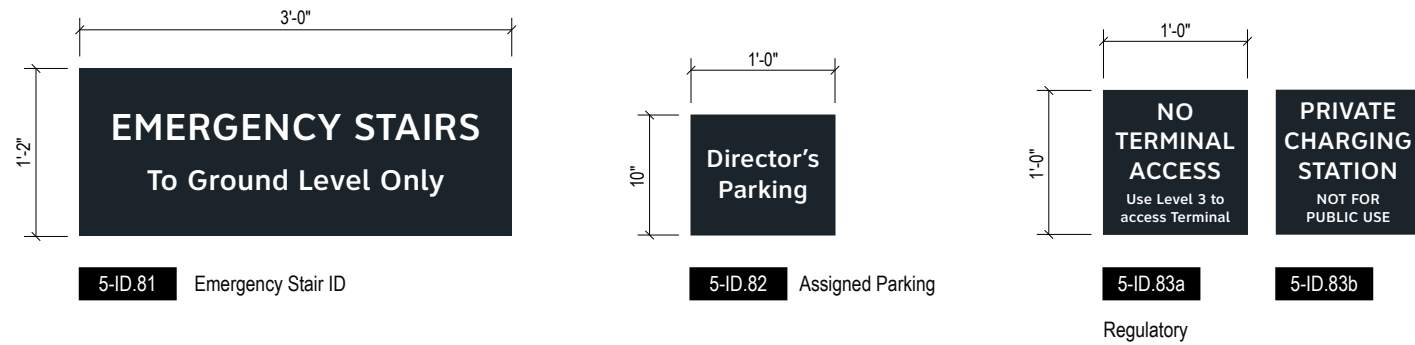
3t-RG.24  
Firearms Regulatory

**3t-DR.20 to 3-DR.29** = Directionals: SOFFIT / WALL Mount

3t-DR.29  
Smoking Area Directional

Parking Garage **Regulatory** (Scale: 3/4" = 1'-0")


5-ID.80 to 5-ID.89 = Miscellaneous Wall Mount ID Signage



5-LE.20 to 5-LE.29 = Wall Mount Safety / Egress Signage



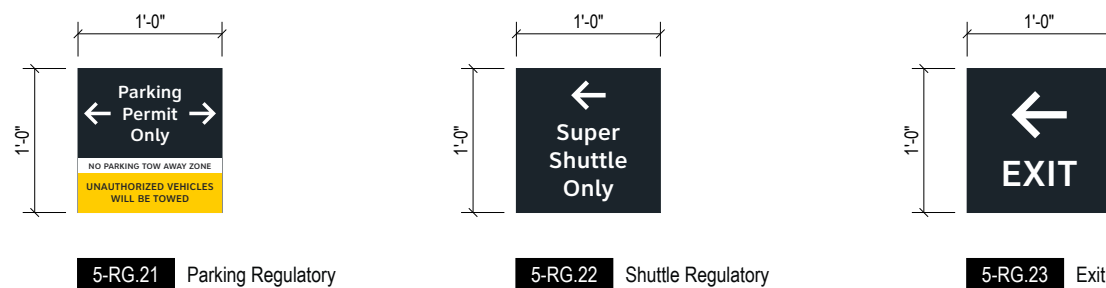5-RG.20 to 5-RG.29 = Wall Mount Regulatory Signage





# 2.0

## **2.0 DESIGN INTENT**

- 2.1 Design Intent - Parking Garage: Vehicular Signs
- 2.2 Design Intent - Parking Garage: Pedestrian Signs
- 2.3 Design Intent - Regulatory Signs

ILLUMINATION REFLECTIVE	SIGN TYPE 5-DR.01a	SIGN FUNCTION DIRECTIONAL	MOUNTING METHOD CEILING SUSPENDED	GENERAL DESCRIPTION & USE VEHICULAR - Ceiling Susp. Level/Garage Trailblazer - Static
----------------------------	-----------------------	------------------------------	--------------------------------------	--

GENERAL NOTES

- All final design, engineering & amount/sizing of structural sign support elements, material types/thicknesses, dimensions and attachment methods shall be performed and approved by a licensed engineer to meet or exceed all applicable local and national codes.
- Final engineering, dimensions, materials and fabrication are the responsibility of the Contractor/Fabricator/Installer to ensure the highest quality fit and finish for all components of the completed product. All final detailing and specifications to be provided by the Contractor/Fabricator/Installer within their final approved fabrication-ready shop drawings.
- Wherever dissimilar metals are in contact, always separate contact surfaces prior to assembly or installation with the necessary protective coatings/gaskets/washers to prevent galvanic corrosion.
- Final fabrication methods, quality and fit/finish to be reviewed & approved by HAS and the Wayfinding Design Consultants thru prototype reviews prior to final production run/installation processes.
- Colors shown are for reference only, and are subject to the limitations of the printing process and/or variance of electronic RGB screen displays. Refer to color system swatches and approved finish samples for accurate reference.
- Messages shown here are typical placeholders only. See message schedules for specific messaging by location & sign type.

FABRICATION NOTES (GENERAL DESIGN INTENT)

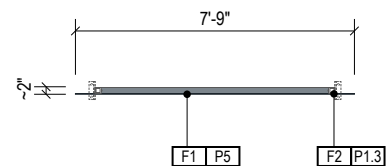
- F1** SIGN FACE PANELS: 1/8" thk. alum. face panel w/ 1st surface full-bleed digitally printed color graphics on reflective 3M DG3 4090 white film; face panel mech. fastened to support frame w/ stainless steel screws, paint heads to match face; paint all exposed surfaces with satin MAP paint to match P5
- F2** SUPPORT FRAME/SUSPENSION: fabricated 2" square alum. support tube frame & vertical suspension tube structure; all exposed support frame tube ends to be capped with alum.; all welds on frame/caps to be filled & ground smooth for uniform appearance; suspension tubes mechanically attached to ceiling attachment hinge plates above; ceiling attachment plates to be mechanically fastened to garage's structural ceiling elements as req. w/ mech. fasteners (fabricator to field verify); support frame, suspension tubes & hinge plates to be painted all exposed surfaces with satin MAP paint to match P1.3

LETTERING (TYPEFACES) / SYMBOLS / ARROWS:


- L1** Vehicular Wayfinding Typeface: Clearview Highway 2-W
- L2** Vehicular Wayfinding Typeface: Clearview Highway 2-B
- L4** Vehicular Dynamic Numbers: Indect digital numbers
- L6** Supplemental Typeface: Clearview One Book Condensed
- S1** Arrow(s): use only official HAS wayfinding arrow art
- S2** Int'l Symbols: use only official HAS wayfinding symbol art
- B1** Sign Face Reflective White Border - 1/2" full-bleed border
- B2** Dynamic Unit White Border - border to match symbol field
- B3** Black Border - 1/2" full-bleed border

COLORS:


- NOTES: "D" = digitally printed colors as generated by 3M Picasso printer (or equal) on 3M Reflective DG3 4090 White unless otherwise noted; "P" = Matthews Acrylic Polyurethane (MAP) paint (or equal), satin finish; "V" = 3M vinyl films (or equal)
- D4** White: match C:0 M:0 Y:0 K:0
  - D5** Dark Gray: match PMS 433C **D6**: match PMS 432C
  - D8** Light Gray: match PMS 427C
  - D9** Black: match C:50 M:40 Y:40 K:100
  - D11** Warning Yellow: match 3M Reflective DG3 4091 Yellow
  - D17** Blue: match PMS 300C **D18** Dk. Blue: match PMS 294C
  - D19** Red: match PMS 187C **D10** Safety Red: match PMS186C
  - D21** Orange: match PMS 1655C
  - D25** Exit Green: match C:90 M:15 Y:100 K:0
  - P1.3** Silver: MAP paint no. N951SP Med. Silver
  - P5** Dark Gray: MAP paint matched to PMS 433C
  - P17** Blue: MAP paint matched to PMS 300C
  - P19** Red: MAP paint matched to PMS 187C




1 PLAN VIEW  
Scale: 3/16" = 1'-0"

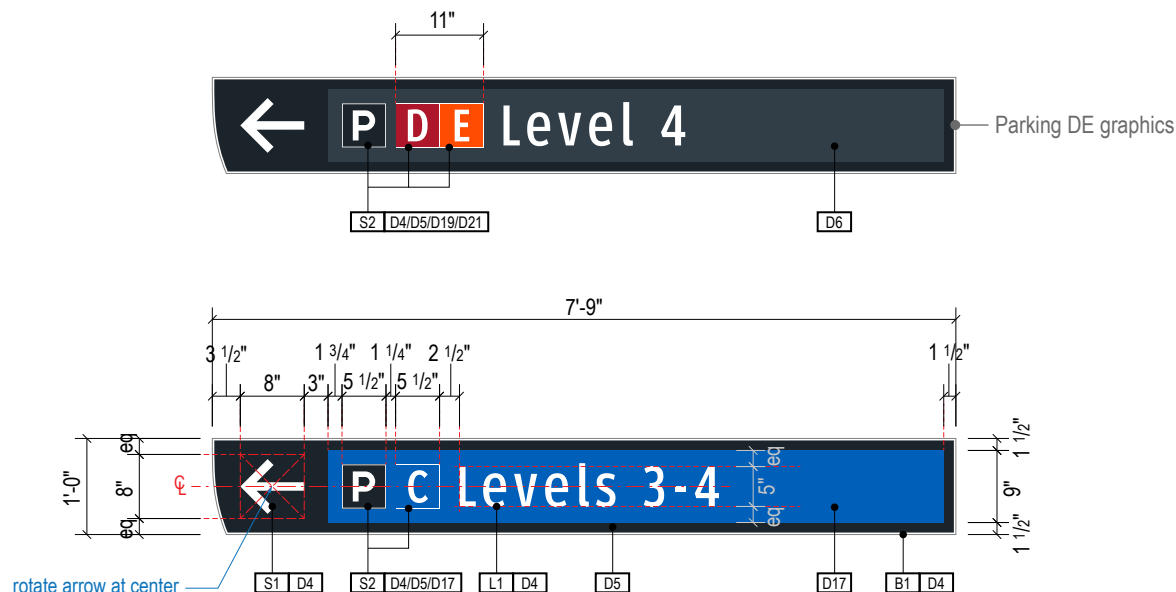


A FACE LAYOUT  
Scale: 1/2" = 1'-0"

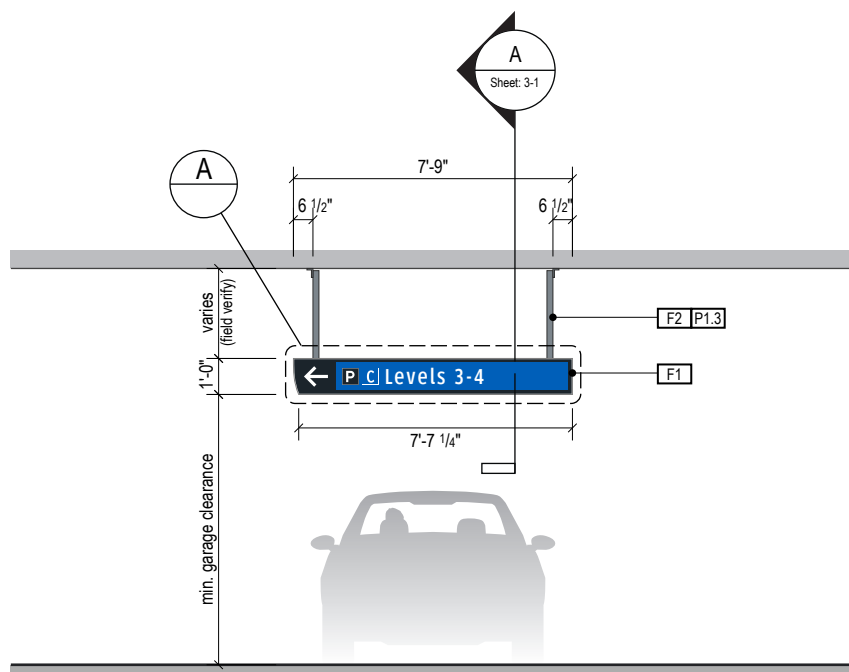

2 ELEVATION  
Scale: 3/16" = 1'-0"

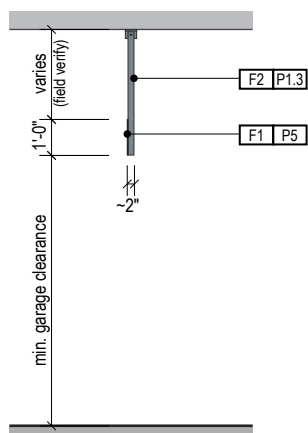

3 END VIEW  
Scale: 3/16" = 1'-0"

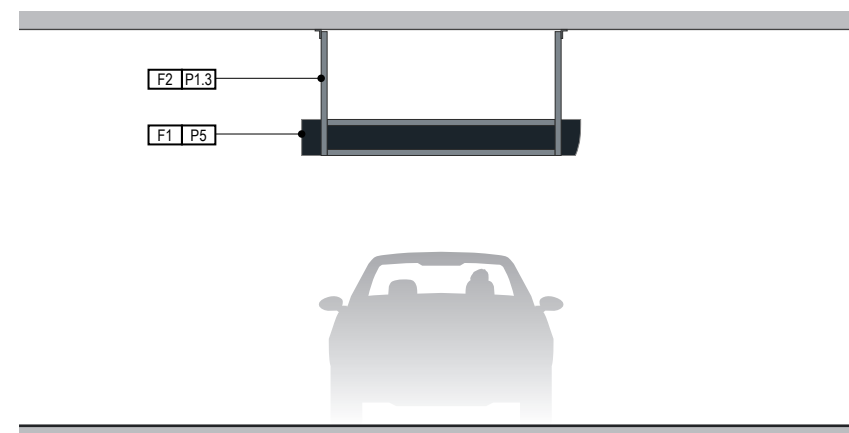

4 ELEVATION (OPPOSITE SIDE)  
Scale: 3/16" = 1'-0"

ILLUMINATION REFLECTIVE	SIGN TYPE 5-DR.02a	SIGN FUNCTION DIRECTIONAL	MOUNTING METHOD CEILING SUSPENDED	GENERAL DESCRIPTION & USE VEHICULAR - Ceiling Susp. Multi-Garage Trailblazer - Static
----------------------------	-----------------------	------------------------------	--------------------------------------	--

GENERAL NOTES

- All final design, engineering & amount/sizing of structural sign support elements, material types/thicknesses, dimensions and attachment methods shall be performed and approved by a licensed engineer to meet or exceed all applicable local and national codes.
- Final engineering, dimensions, materials and fabrication are the responsibility of the Contractor/Fabricator/Installer to ensure the highest quality fit and finish for all components of the completed product. All final detailing and specifications to be provided by the Contractor/Fabricator/Installer within their final approved fabrication-ready shop drawings.
- Wherever dissimilar metals are in contact, always separate contact surfaces prior to assembly or installation with the necessary protective coatings/gaskets/washers to prevent galvanic corrosion.
- Final fabrication methods, quality and fit/finish to be reviewed & approved by HAS and the Wayfinding Design Consultants thru prototype reviews prior to final production run/installation processes.
- Colors shown are for reference only, and are subject to the limitations of the printing process and/or variance of electronic RGB screen displays. Refer to color system swatches and approved finish samples for accurate reference.
- Messages shown here are typical placeholders only. See message schedules for specific messaging by location and sign type.

FABRICATION NOTES (GENERAL DESIGN INTENT)

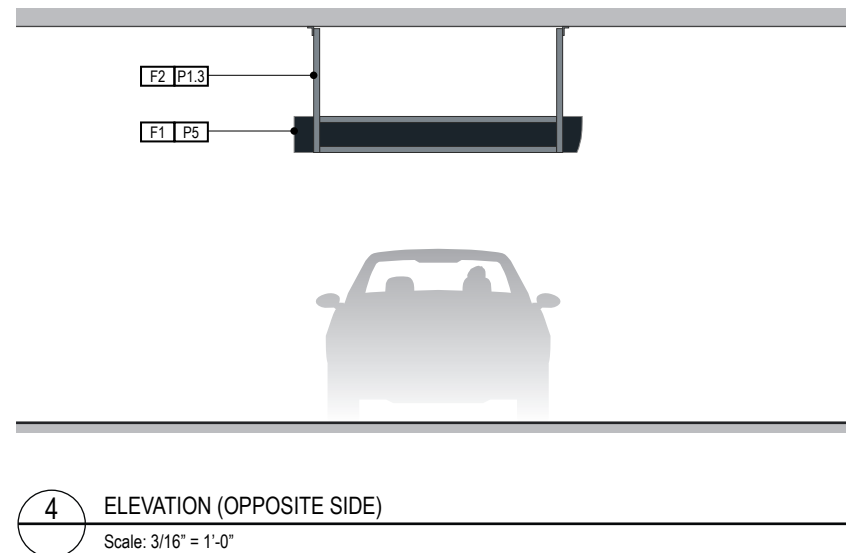
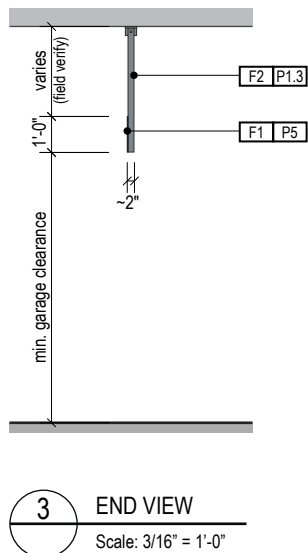
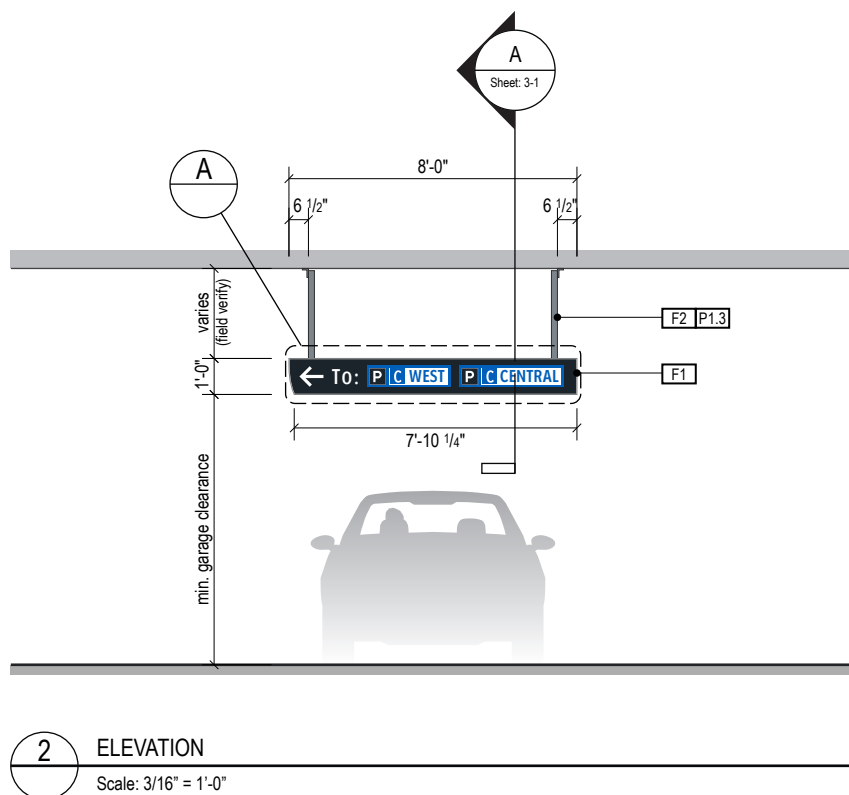
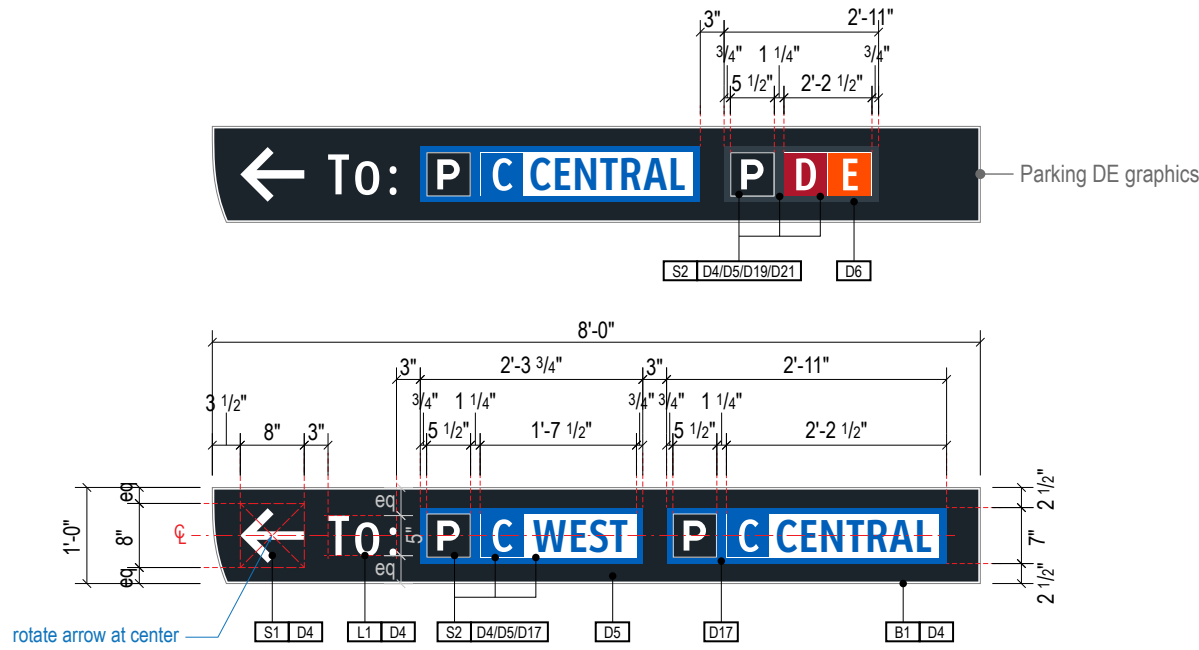
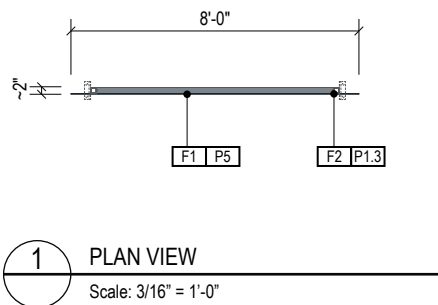
- F1** SIGN FACE PANELS: 1/8" thk. alum. face panel w/ 1st surface full-bleed digitally printed color graphics on reflective 3M DG3 4090 white film; face panel mech. fastened to support frame w/ stainless steel screws, paint heads to match face; paint all exposed surfaces with satin MAP paint to match P5
- F2** SUPPORT FRAME/SUSPENSION: fabricated 2" square alum. support tube frame & vertical suspension tube structure; all exposed support frame tube ends to be capped with alum.; all welds on frame/caps to be filled & ground smooth for uniform appearance; suspension tubes mechanically attached to ceiling attachment hinge plates above; ceiling attachment plates to be mechanically fastened to garage's structural ceiling elements as req. w/ mech. fasteners (fabricator to field verify); support frame, suspension tubes & hinge plates to be painted all exposed surfaces with satin MAP paint to match P1.3

LETTERING (TYPEFACES) / SYMBOLS / ARROWS:

- L1** Vehicular Wayfinding Typeface: Clearview Highway 2-W
- L2** Vehicular Wayfinding Typeface: Clearview Highway 2-B
- L4** Vehicular Dynamic Numbers: Indect digital numbers
- L6** Supplemental Typeface: Clearview One Book Condensed
- S1** Arrow(s): use only official HAS wayfinding arrow art
- S2** Int'l Symbols: use only official HAS wayfinding symbol art
- B1** Sign Face Reflective White Border - 1/2" full-bleed border
- B2** Dynamic Unit White Border - border to match symbol field
- B3** Black Border - 1/2" full-bleed border

COLORS:

- NOTES: "D" = digitally printed colors as generated by 3M Picasso printer (or equal) on 3M Reflective DG3 4090 White unless otherwise noted; "P" = Matthews Acrylic Polyurethane (MAP) paint (or equal), satin finish; "V" = 3M vinyl films (or equal)
- D4** White: match C:0 M:0 Y:0 K:0
  - D5** Dark Gray: match PMS 433C **D6**: match PMS 432C
  - D8** Light Gray: match PMS 427C
  - D9** Black: match C:50 M:40 Y:40 K:100
  - D11** Warning Yellow: match 3M Reflective DG3 4091 Yellow
  - D17** Blue: match PMS 300C **D18** Dk. Blue: match PMS 294C
  - D19** Red: match PMS 187C **D10** Safety Red: match PMS186C
  - D25** Exit Green: match C:90 M:15 Y:100 K:0
  - P1.3** Silver: MAP paint no. N951SP Med. Silver
  - P5** Dark Gray: MAP paint matched to PMS 433C
  - P17** Blue: MAP paint matched to PMS 300C
  - P19** Red: MAP paint matched to PMS 187C



ILLUMINATION	SIGN TYPE	SIGN FUNCTION	MOUNTING METHOD	GENERAL DESCRIPTION & USE
REFLECTIVE	5-DR.03b	DIRECTIONAL	CEILING SUSPENDED	VEHICULAR - Ceiling Susp. Exit Trailblazer - Static

**GENERAL NOTES**

- All final design, engineering & amount/sizing of structural sign support elements, material types/thicknesses, dimensions and attachment methods shall be performed and approved by a licensed engineer to meet or exceed all applicable local and national codes.
- Final engineering, dimensions, materials and fabrication are the responsibility of the Contractor/Fabricator/Installer to ensure the highest quality fit and finish for all components of the completed product. All final detailing and specifications to be provided by the Contractor/Fabricator/Installer within their final approved fabrication-ready shop drawings.
- Wherever dissimilar metals are in contact, always separate contact surfaces prior to assembly or installation with the necessary protective coatings/gaskets/washers to prevent galvanic corrosion.
- Final fabrication methods, quality and fit/finish to be reviewed & approved by HAS and the Wayfinding Design Consultants thru prototype reviews prior to final production run/installation processes.
- Colors shown are for reference only, and are subject to the limitations of the printing process and/or variance of electronic RGB screen displays. Refer to color system swatches and approved finish samples for accurate reference.
- Messages shown here are typical placeholders only. See message schedules for specific messaging by location & sign type.

**FABRICATION NOTES (GENERAL DESIGN INTENT)**

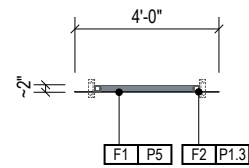
- F1** SIGN FACE PANELS: 1/8" thk. alum. face panel w/ 1st surface full-bleed digitally printed color graphics on reflective 3M DG3 4090 white film; face panel mech. fastened to support frame w/ stainless steel screws, paint heads to match face; paint all exposed surfaces with satin MAP paint to match P5
- F2** SUPPORT FRAME/SUSPENSION: fabricated 2" square alum. support tube frame & vertical suspension tube structure; all exposed support frame tube ends to be capped with alum.; all welds on frame/caps to be filled & ground smooth for uniform appearance; suspension tubes mechanically attached to ceiling attachment hinge plates above; ceiling attachment plates to be mechanically fastened to garage's structural ceiling elements as req. w/ mech. fasteners (fabricator to field verify); support frame, suspension tubes & hinge plates to be painted all exposed surfaces with satin MAP paint to match P1.3

**LETTERING (TYPEFACES) / SYMBOLS / ARROWS:**


- L1** Vehicular Wayfinding Typeface: Clearview Highway 2-W
- L2** Vehicular Wayfinding Typeface: Clearview Highway 2-B
- L4** Vehicular Dynamic Numbers: Indect digital numbers
- L6** Supplemental Typeface: Clearview One Book Condensed
- S1** Arrow(s): use only official HAS wayfinding arrow art
- S2** Int'l Symbols: use only official HAS wayfinding symbol art
- B1** Sign Face Reflective White Border - 1/2" full-bleed border
- B2** Dynamic Unit White Border - border to match symbol field
- B3** Black Border - 1/2" full-bleed border

**COLORS:**


- NOTES: "D" = digitally printed colors as generated by 3M Picasso printer (or equal) on 3M Reflective DG3 4090 White unless otherwise noted; "P" = Matthews Acrylic Polyurethane (MAP) paint (or equal), satin finish; "V" = 3M vinyl films (or equal)
- D4** White: match C:0 M:0 Y:0 K:0
  - D5** Dark Gray: match PMS 433C **D6**: match PMS 432C
  - D8** Light Gray: match PMS 427C
  - D9** Black: match C:50 M:40 Y:40 K:100
  - D11** Warning Yellow: match 3M Reflective DG3 4091 Yellow
  - D17** Blue: match PMS 300C **D18** Dk. Blue: match PMS 294C
  - D19** Red: match PMS 187C **D10** Safety Red: match PMS186C
  - D21** Orange: match PMS 1655C
  - D25** Exit Green: match C:90 M:15 Y:100 K:0
  - P1.3** Silver: MAP paint no. N951SP Med. Silver
  - P5** Dark Gray: MAP paint matched to PMS 433C
  - P17** Blue: MAP paint matched to PMS 300C
  - P19** Red: MAP paint matched to PMS 187C




**1 PLAN VIEW**  
Scale: 3/16" = 1'-0"

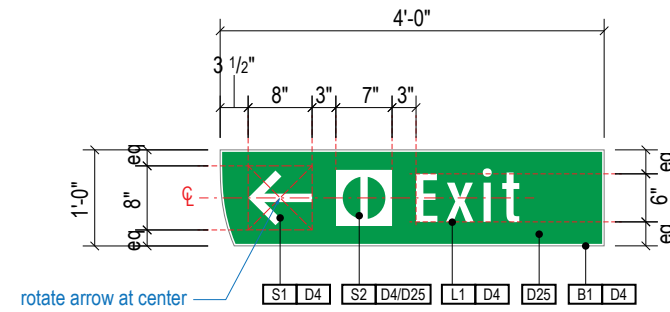


**A FACE LAYOUT**  
Scale: 1/2" = 1'-0"

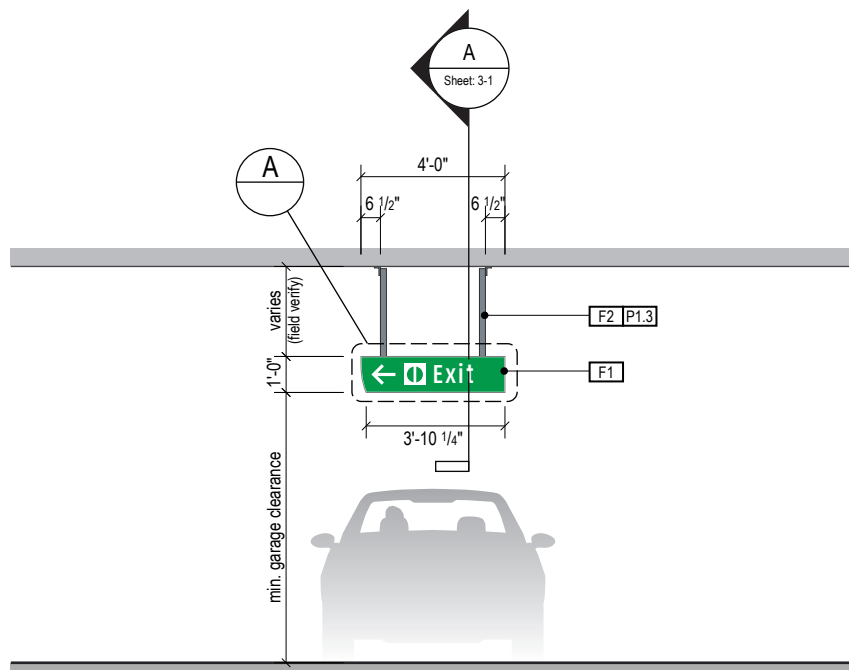

**2 ELEVATION**  
Scale: 3/16" = 1'-0"

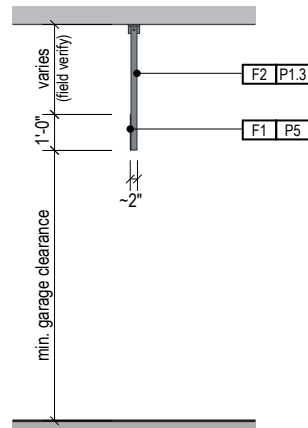

**3 END VIEW**  
Scale: 3/16" = 1'-0"

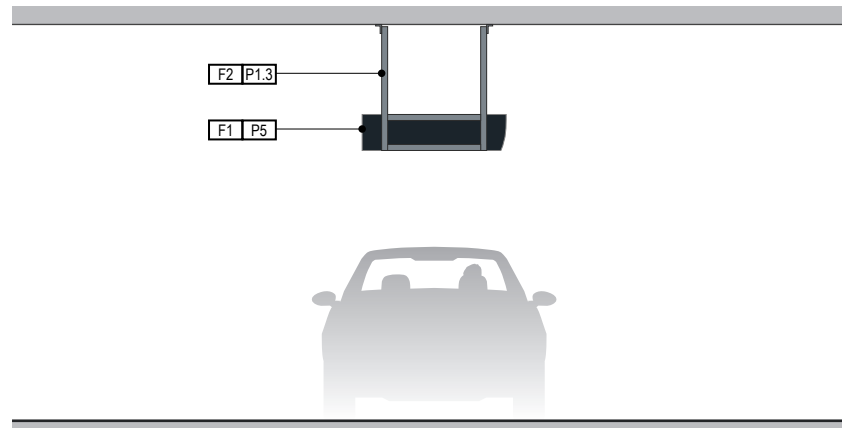

**4 ELEVATION (OPPOSITE SIDE)**  
Scale: 3/16" = 1'-0"

ILLUMINATION REFLECTIVE	SIGN TYPE 5-DR.04	SIGN FUNCTION DIRECTIONAL	MOUNTING METHOD CEILING SUSPENDED	GENERAL DESCRIPTION & USE VEHICULAR - Ceiling Susp. Valet Trailblazer - Static
----------------------------	----------------------	------------------------------	--------------------------------------	---

GENERAL NOTES

- All final design, engineering & amount/sizing of structural sign support elements, material types/thicknesses, dimensions and attachment methods shall be performed and approved by a licensed engineer to meet or exceed all applicable local and national codes.
- Final engineering, dimensions, materials and fabrication are the responsibility of the Contractor/Fabricator/Installer to ensure the highest quality fit and finish for all components of the completed product. All final detailing and specifications to be provided by the Contractor/Fabricator/Installer within their final approved fabrication-ready shop drawings.
- Wherever dissimilar metals are in contact, always separate contact surfaces prior to assembly or installation with the necessary protective coatings/gaskets/washers to prevent galvanic corrosion.
- Final fabrication methods, quality and fit/finish to be reviewed & approved by HAS and the Wayfinding Design Consultants thru prototype reviews prior to final production run/installation processes.
- Colors shown are for reference only, and are subject to the limitations of the printing process and/or variance of electronic RGB screen displays. Refer to color system swatches and approved finish samples for accurate reference.
- Messages shown here are typical placeholders only. See message schedules for specific messaging by location and sign type.

FABRICATION NOTES (GENERAL DESIGN INTENT)

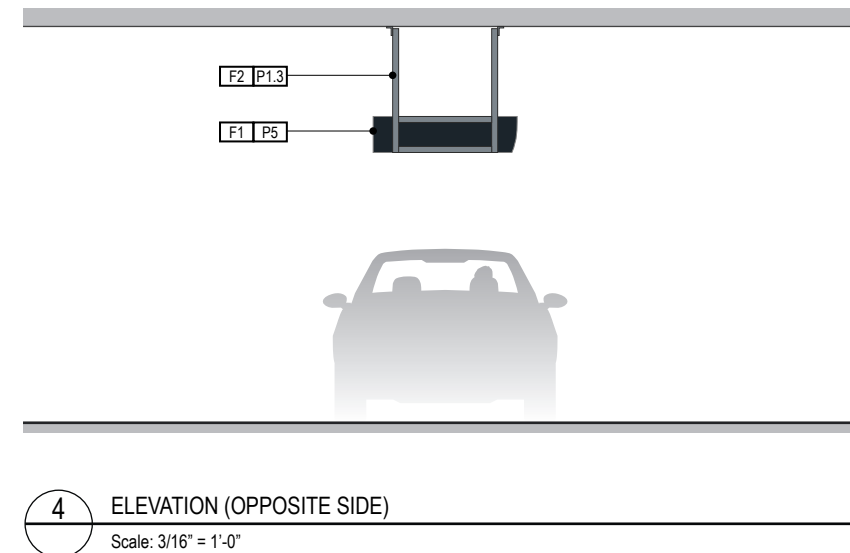
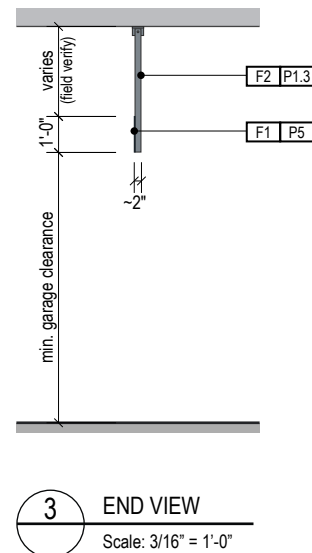
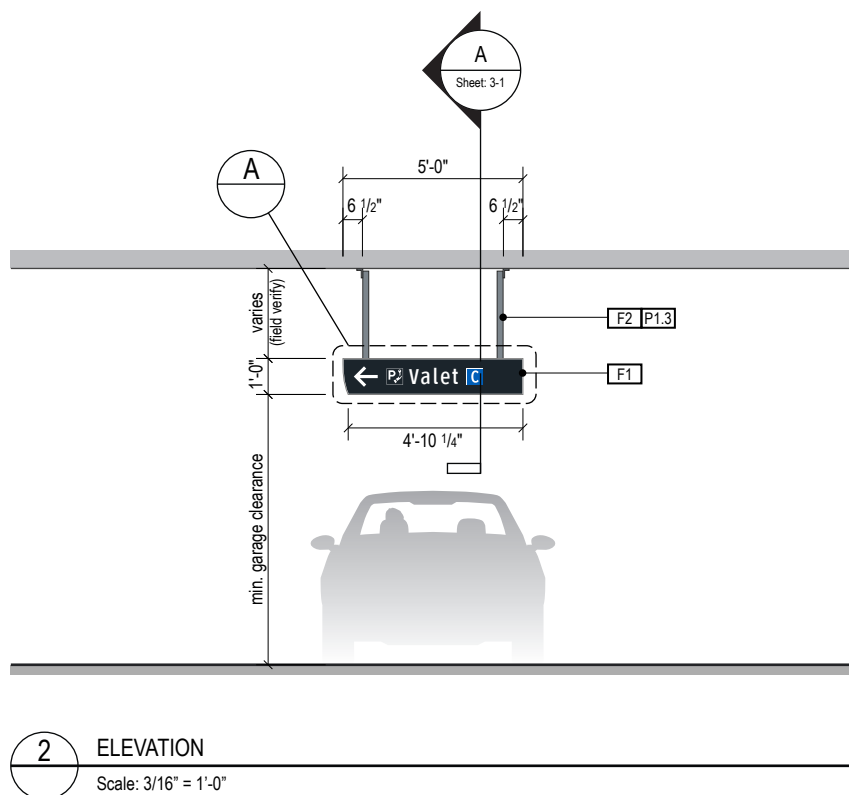
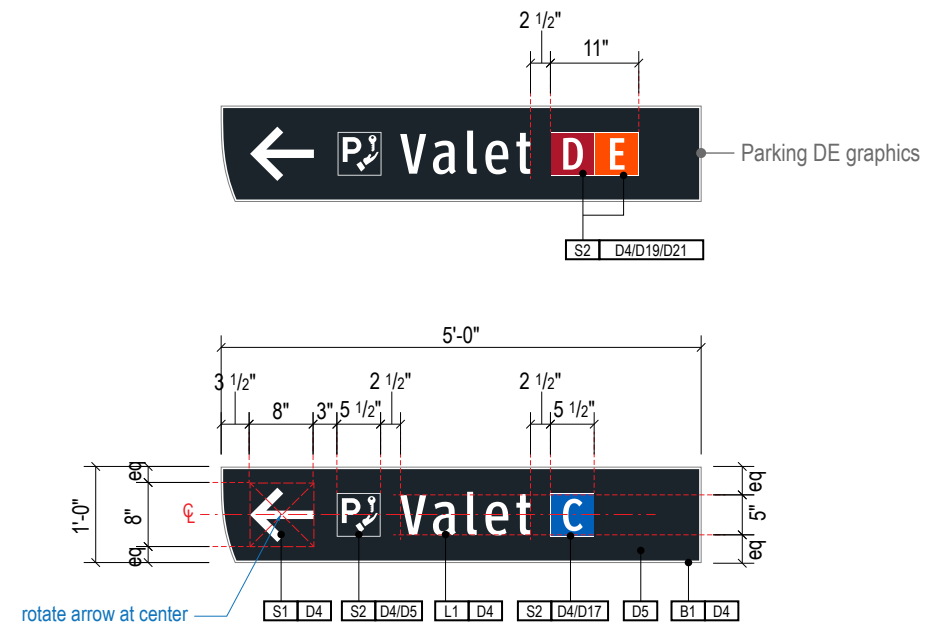
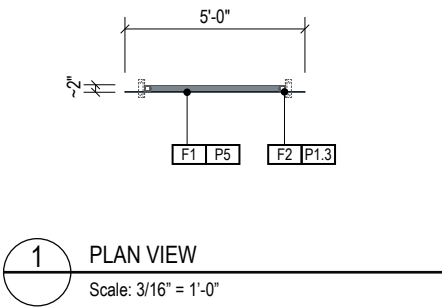
- F1** SIGN FACE PANELS: 1/8" thk. alum. face panel w/ 1st surface full-bleed digitally printed color graphics on reflective 3M DG3 4090 white film; face panel mech. fastened to support frame w/ stainless steel screws, paint heads to match face; paint all exposed surfaces with satin MAP paint to match P5
- F2** SUPPORT FRAME/SUSPENSION: fabricated 2" square alum. support tube frame & vertical suspension tube structure; all exposed support frame tube ends to be capped with alum.; all welds on frame/caps to be filled & ground smooth for uniform appearance; suspension tubes mechanically attached to ceiling attachment hinge plates above; ceiling attachment plates to be mechanically fastened to garage's structural ceiling elements as req. w/ mech. fasteners (fabricator to field verify); support frame, suspension tubes & hinge plates to be painted all exposed surfaces with satin MAP paint to match P1.3

LETTERING (TYPEFACES) / SYMBOLS / ARROWS:






- L1** Vehicular Wayfinding Typeface: Clearview Highway 2-W
- L2** Vehicular Wayfinding Typeface: Clearview Highway 2-B
- L4** Vehicular Dynamic Numbers: Indect digital numbers
- L6** Supplemental Typeface: Clearview One Book Condensed
- S1** Arrow(s): use only official HAS wayfinding arrow art
- S2** Int'l Symbols: use only official HAS wayfinding symbol art
- B1** Sign Face Reflective White Border - 1/2" full-bleed border
- B2** Dynamic Unit White Border - border to match symbol field
- B3** Black Border - 1/2" full-bleed border

COLORS:

- NOTES: "D" = digitally printed colors as generated by 3M Picasso printer (or equal) on 3M Reflective DG3 4090 White unless otherwise noted; "P" = Matthews Acrylic Polyurethane (MAP) paint (or equal), satin finish; "V" = 3M vinyl films (or equal)
- D4** White: match C:0 M:0 Y:0 K:0
  - D5** Dark Gray: match PMS 433C **D6**: match PMS 432C
  - D8** Light Gray: match PMS 427C
  - D9** Black: match C:50 M:40 Y:40 K:100
  - D11** Warning Yellow: match 3M Reflective DG3 4091 Yellow
  - D17** Blue: match PMS 300C **D18** Dk. Blue: match PMS 294C
  - D19** Red: match PMS 187C **D10** Safety Red: match PMS186C
  - D21** Orange: match PMS 1655C
  - D25** Exit Green: match C:90 M:15 Y:100 K:0
  - P1.3** Silver: MAP paint no. N951SP Med. Silver
  - P5** Dark Gray: MAP paint matched to PMS 433C
  - P17** Blue: MAP paint matched to PMS 300C
  - P19** Red: MAP paint matched to PMS 187C



ILLUMINATION	SIGN TYPE	SIGN FUNCTION	MOUNTING METHOD	GENERAL DESCRIPTION & USE
REFLECTIVE / DIGITAL	5-DR.08	DIRECTIONAL	CEILING SUSPENDED	VEHICULAR - 1-way Ceiling Susp. Space Count Directional Cover Panels w/ ID Header - Static

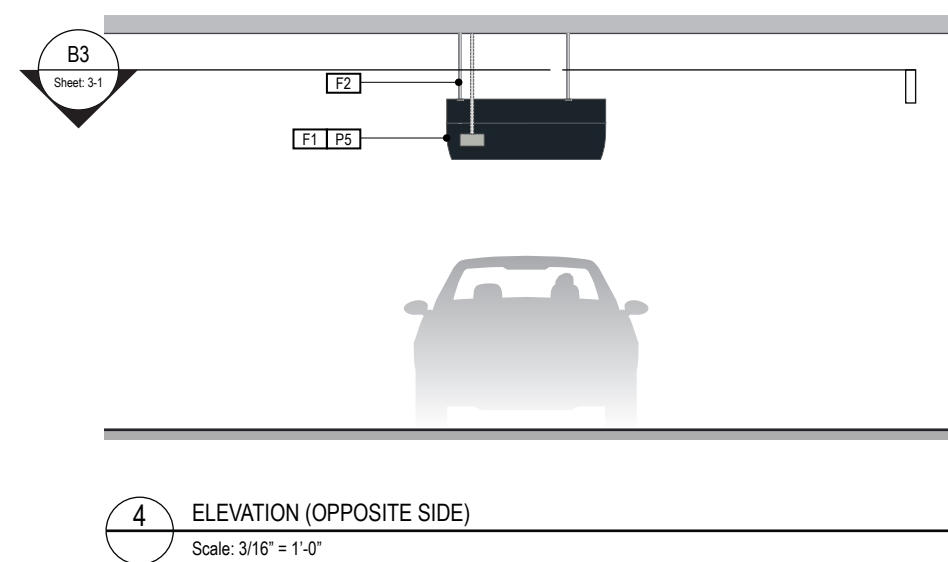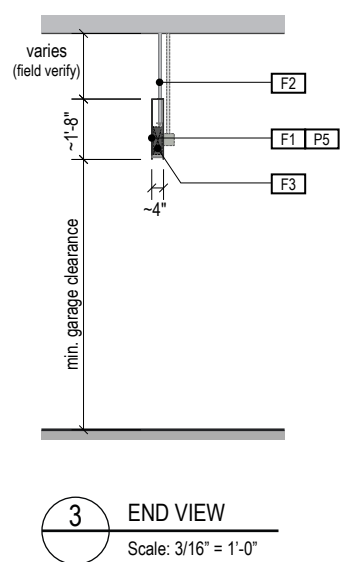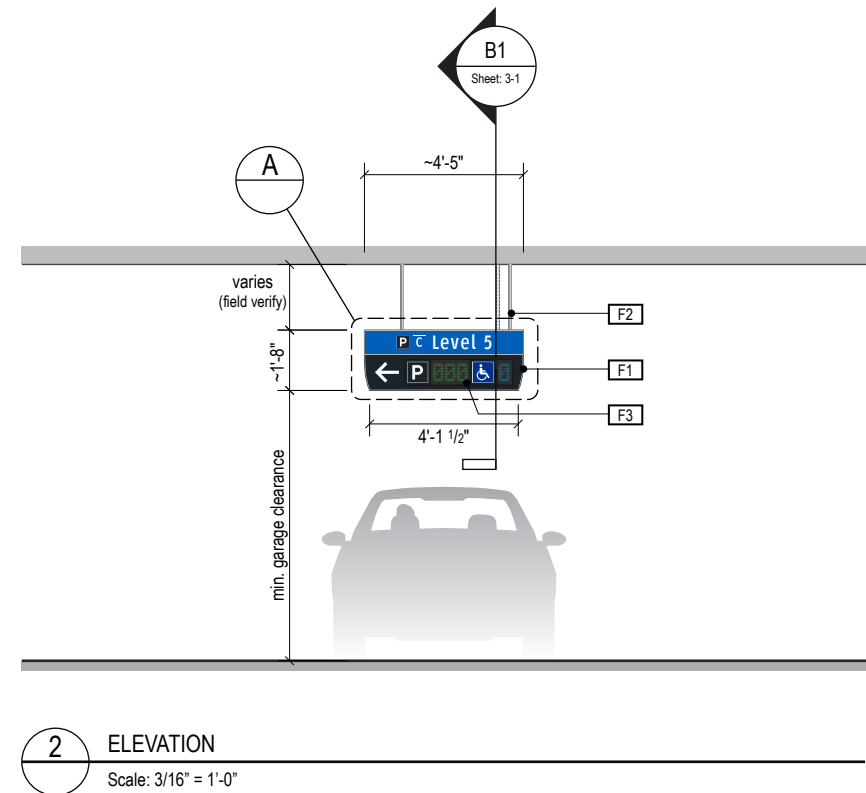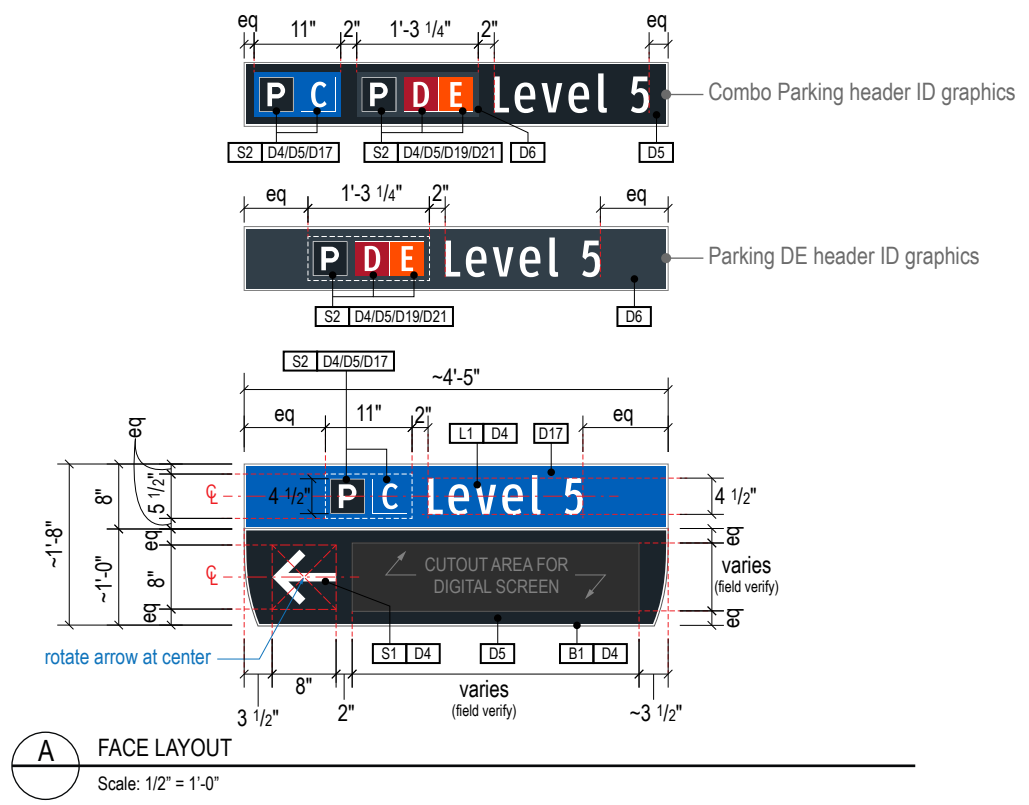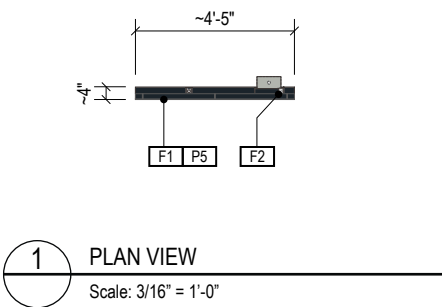

**GENERAL NOTES**

- All final design, engineering & amount/sizing of structural sign support elements, material types/thicknesses, dimensions and attachment methods shall be performed and approved by a licensed engineer to meet or exceed all applicable local and national codes.
- Final engineering, dimensions, materials and fabrication are the responsibility of the Contractor/Fabricator/Installer to ensure the highest quality fit and finish for all components of the completed product. All final detailing and specifications to be provided by the Contractor/Fabricator/Installer within their final approved fabrication-ready shop drawings.
- Wherever dissimilar metals are in contact, always separate contact surfaces prior to assembly or installation with the necessary protective coatings/gaskets/washers to prevent galvanic corrosion.
- Final fabrication methods, quality and fit/finish to be reviewed & approved by HAS and the Wayfinding Design Consultants thru prototype reviews prior to final production run/installation processes.
- Colors shown are for reference only, and are subject to the limitations of the printing process and/or variance of electronic RGB screen displays. Refer to color system swatches and approved finish samples for accurate reference.
- Messages shown here are typical placeholders only. See message schedules for specific messaging by location & sign type.

**FABRICATION NOTES (GENERAL DESIGN INTENT)**

**F1** COVER PANELS: brake-formed alum. cover panels on front (w/ 1st surface full-bleed digitally printed color graphics on reflective 3M DG3 4090 white film) & back (painted with satin MAP paint all exposed surfaces), create cutout(s) to accommodate full-bleed view of digital unit screen area(s) as req'd (field verify) & slotted as req'd to fit around existing mounting hardware/power/data/conduit & mech. fastened to existing Inlect unit(s) as req'd (field verify) w/ stainless fasteners (fabricator to field verify all sizes and installation conditions); paint all exposed surfaces with satin MAP paint to match P5

**F2** SUSPENSION/MOUNTING HARDWARE: existing suspension/mounting hardware to be reinforced/sized by engineer to accommodate additional wind loads & weight of new cover panels (fabricator and engineer to field verify prior to final fabrication and installation of new cover panels)

**F3** DIGITAL UNITS: existing self-contained Inlect brand digital units (config./qty. of units varies per sign type as shown) w/ digital number space counts/arrows/red X's & static rear-lit symbols as shown

**LETTERING (TYPEFACES) / SYMBOLS / ARROWS:**

**L1** Vehicular Wayfinding Typeface: Clearview Highway 2-W  
**L2** Vehicular Wayfinding Typeface: Clearview Highway 2-B  
**L4** Vehicular Dynamic Numbers: Inlect digital numbers  
**L6** Supplemental Typeface: Clearview One Book Condensed  
**S1** Arrow(s): use only official HAS wayfinding arrow art  
**S2** Int'l Symbols: use only official HAS wayfinding symbol art  
**B1** Sign Face Reflective White Border - 1/2" full-bleed border  
**B2** Dynamic Unit White Border - border to match symbol field  
**B3** Black Border - 1/2" full-bleed border

**COLORS:**

NOTES: "D" = digitally printed colors as generated by 3M Picasso printer (or equal) on 3M Reflective DG3 4090 White unless otherwise noted; "P" = Matthews Acrylic Polyurethane (MAP) paint (or equal), satin finish; "V" = 3M vinyl films (or equal)

**D4** White: match C:0 M:0 Y:0 K:0  
**D5** Dark Gray: match PMS 433C **D6** : match PMS 432C  
**D8** Light Gray: match PMS 427C  
**D9** Black: match C:50 M:40 Y:40 K:100  
**D11** Warning Yellow: match 3M Reflective DG3 4091 Yellow  
**D17** Blue: match PMS 300C **D18** Dk. Blue: match PMS 294C  
**D19** Red: match PMS 187C **D10** Safety Red: match PMS186C  
**D21** Orange: match PMS 1655C  
**D25** Exit Green: match C:90 M:15 Y:100 K:0  
**P1.3** Silver: MAP paint no. N951SP Med. Silver  
**P5** Dark Gray: MAP paint matched to PMS 433C  
**P17** Blue: MAP paint matched to PMS 300C  
**P19** Red: MAP paint matched to PMS 187C

ILLUMINATION REFLECTIVE / DIGITAL	SIGN TYPE 5-DR.09	SIGN FUNCTION DIRECTIONAL	MOUNTING METHOD CEILING SUSPENDED	GENERAL DESCRIPTION & USE VEHICULAR - 2-way Ceiling Susp. Space Count Directional Cover Panels
--------------------------------------	----------------------	------------------------------	--------------------------------------	---

GENERAL NOTES

- All final design, engineering & amount/sizing of structural sign support elements, material types/thicknesses, dimensions and attachment methods shall be performed and approved by a licensed engineer to meet or exceed all applicable local and national codes.
- Final engineering, dimensions, materials and fabrication are the responsibility of the Contractor/Fabricator/Installer to ensure the highest quality fit and finish for all components of the completed product. All final detailing and specifications to be provided by the Contractor/Fabricator/Installer within their final approved fabrication-ready shop drawings.
- Wherever dissimilar metals are in contact, always separate contact surfaces prior to assembly or installation with the necessary protective coatings/gaskets/washers to prevent galvanic corrosion.
- Final fabrication methods, quality and fit/finish to be reviewed & approved by HAS and the Wayfinding Design Consultants thru prototype reviews prior to final production run/installation processes.
- Colors shown are for reference only, and are subject to the limitations of the printing process and/or variance of electronic RGB screen displays. Refer to color system swatches and approved finish samples for accurate reference.
- Messages shown here are typical placeholders only. See message schedules for specific messaging by location & sign type.

FABRICATION NOTES (GENERAL DESIGN INTENT)

- F1** COVER PANELS: brake-formed alum. cover panels on front (w/ 1st surface full-bleed digitally printed color graphics on reflective 3M DG3 4090 white film) & back (painted with satin MAP paint all exposed surfaces), create cutout(s) to accommodate full-bleed view of digital unit screen area(s) as req'd (field verify) & slotted as req'd to fit around existing mounting hardware/power/data/conduit & mech. fastened to existing Indect unit(s) as req'd (field verify) w/ stainless fasteners (fabricator to field verify all sizes and installation conditions); paint all exposed surfaces with satin MAP paint to match P5
- F2** SUSPENSION/MOUNTING HARDWARE: existing suspension/mounting hardware to be reinforced/sized by engineer to accommodate additional wind loads & weight of new cover panels (fabricator and engineer to field verify prior to final fabrication and installation of new cover panels)
- F3** DIGITAL UNITS: existing self-contained Indect brand digital units (config./qty. of units varies per sign type as shown) w/ digital number space counts/arrows/red X's & static rear-lit symbols as shown

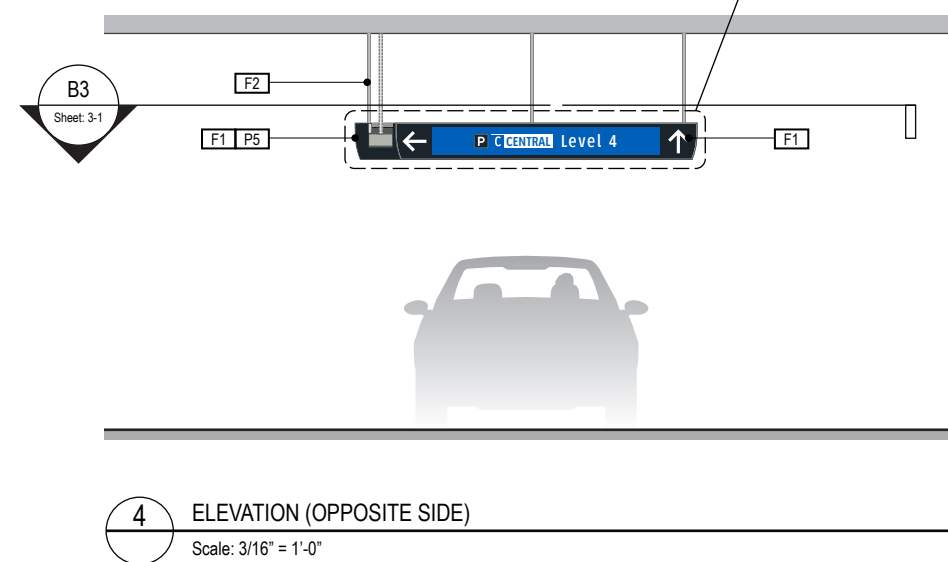
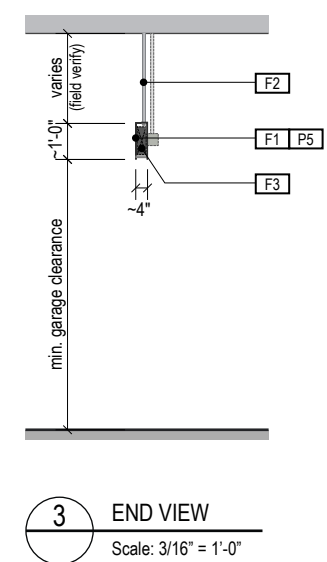
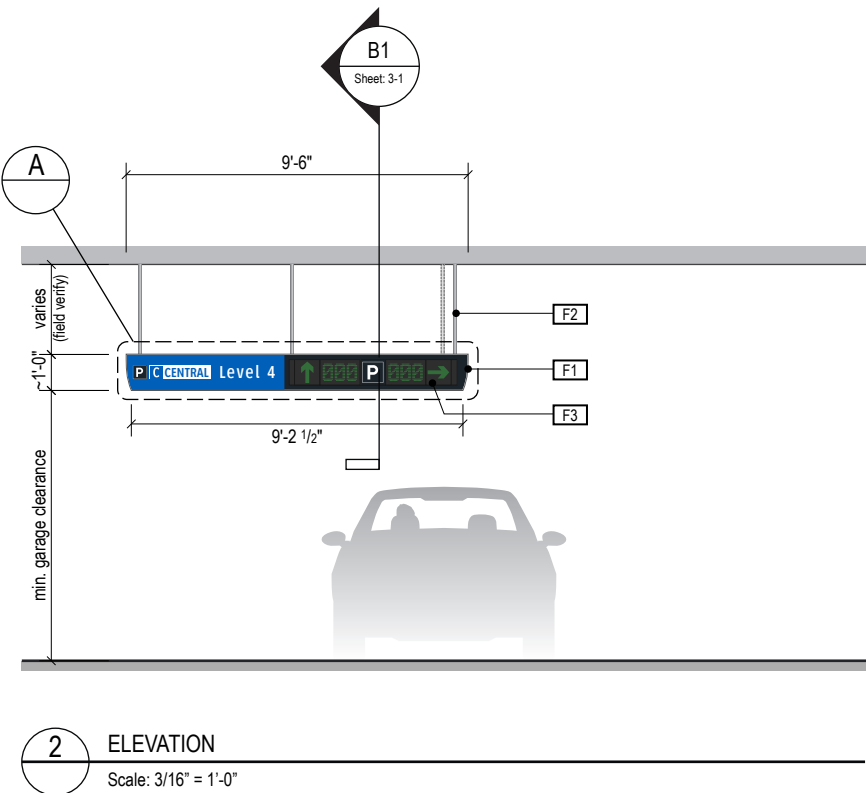
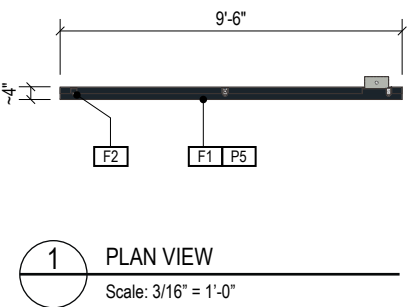
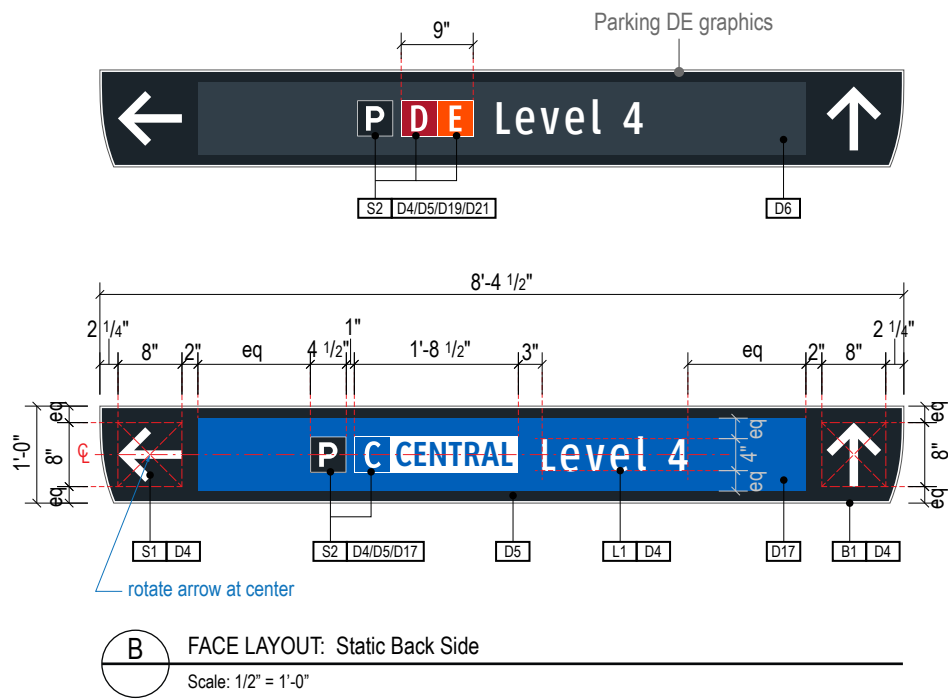
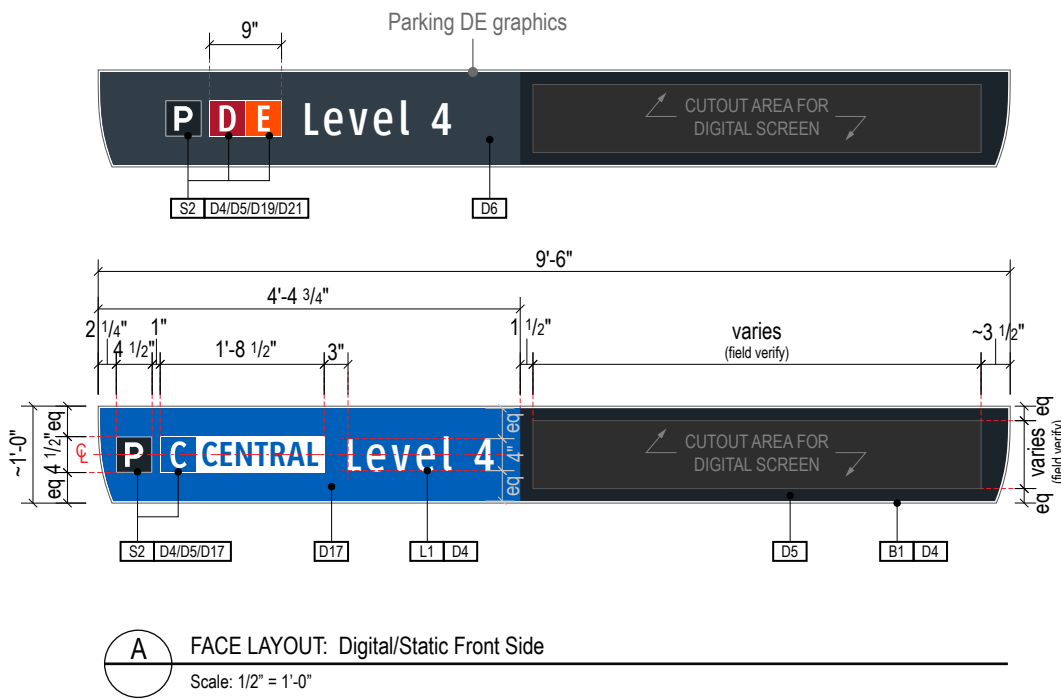
LETTERING (TYPEFACES) / SYMBOLS / ARROWS:

- L1** Vehicular Wayfinding Typeface: Clearview Highway 2-W
- L2** Vehicular Wayfinding Typeface: Clearview Highway 2-B
- L4** Vehicular Dynamic Numbers: Indect digital numbers
- L6** Supplemental Typeface: Clearview One Book Condensed
- S1** Arrow(s): use only official HAS wayfinding arrow art
- S2** Int'l Symbols: use only official HAS wayfinding symbol art
- B1** Sign Face Reflective White Border - 1/2" full-bleed border
- B2** Dynamic Unit White Border - border to match symbol field
- B3** Black Border - 1/2" full-bleed border

COLORS:

NOTES: "D" = digitally printed colors as generated by 3M Picasso printer (or equal) on 3M Reflective DG3 4090 White unless otherwise noted; "P" = Matthews Acrylic Polyurethane (MAP) paint (or equal), satin finish; "V" = 3M vinyl films (or equal)

- D4** White: match C:0 M:0 Y:0 K:0
- D5** Dark Gray: match PMS 433C **D6**: match PMS 432C
- D8** Light Gray: match PMS 427C
- D9** Black: match C:50 M:40 Y:40 K:100
- D11** Warning Yellow: match 3M Reflective DG3 4091 Yellow
- D17** Blue: match PMS 300C **D18** Dk. Blue: match PMS 294C
- D19** Red: match PMS 187C **D10** Safety Red: match PMS186C
- D21** Orange: match PMS 1655C
- D25** Exit Green: match C:90 M:15 Y:100 K:0
- P1.3** Silver: MAP paint no. N951SP Med. Silver
- P5** Dark Gray: MAP paint matched to PMS 433C
- P17** Blue: MAP paint matched to PMS 300C
- P19** Red: MAP paint matched to PMS 187C



ILLUMINATION REFLECTIVE	SIGN TYPE 5-DR.09a	SIGN FUNCTION DIRECTIONAL	MOUNTING METHOD CEILING SUSPENDED	GENERAL DESCRIPTION & USE VEHICULAR - 2-way Ceiling Susp. Parking Row Directional - Static
----------------------------	-----------------------	------------------------------	--------------------------------------	---

GENERAL NOTES

- All final design, engineering & amount/sizing of structural sign support elements, material types/thicknesses, dimensions and attachment methods shall be performed and approved by a licensed engineer to meet or exceed all applicable local and national codes.
- Final engineering, dimensions, materials and fabrication are the responsibility of the Contractor/Fabricator/Installer to ensure the highest quality fit and finish for all components of the completed product. All final detailing and specifications to be provided by the Contractor/Fabricator/Installer within their final approved fabrication-ready shop drawings.
- Wherever dissimilar metals are in contact, always separate contact surfaces prior to assembly or installation with the necessary protective coatings/gaskets/washers to prevent galvanic corrosion.
- Final fabrication methods, quality and fit/finish to be reviewed & approved by HAS and the Wayfinding Design Consultants thru prototype reviews prior to final production run/installation processes.
- Colors shown are for reference only, and are subject to the limitations of the printing process and/or variance of electronic RGB screen displays. Refer to color system swatches and approved finish samples for accurate reference.
- Messages shown here are typical placeholders only. See message schedules for specific messaging by location and sign type.

FABRICATION NOTES (GENERAL DESIGN INTENT)

- F1** SIGN FACE PANELS: 1/8" thk. alum. face panel w/ 1st surface full-bleed digitally printed color graphics on reflective 3M DG3 4090 white film; face panel mech. fastened to support frame w/ stainless steel screws, paint heads to match face; paint all exposed surfaces with satin MAP paint to match P5
- F2** SUPPORT FRAME/SUSPENSION: fabricated 2" square alum. support tube frame & vertical suspension tube structure; all exposed support frame tube ends to be capped with alum.; all welds on frame/caps to be filled & ground smooth for uniform appearance; suspension tubes mechanically attached to ceiling attachment hinge plates above; ceiling attachment plates to be mechanically fastened to garage's structural ceiling elements as req. w/ mech. fasteners (fabricator to field verify); support frame, suspension tubes & hinge plates to be painted all exposed surfaces with satin MAP paint to match P1.3

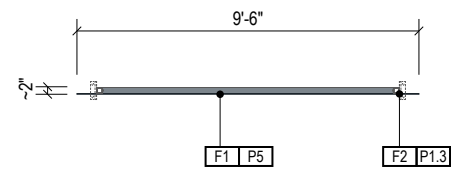
LETTERING (TYPEFACES) / SYMBOLS / ARROWS:

- L1** Vehicular Wayfinding Typeface: Clearview Highway 2-W
- L2** Vehicular Wayfinding Typeface: Clearview Highway 2-B
- L4** Vehicular Dynamic Numbers: Indect digital numbers
- L6** Supplemental Typeface: Clearview One Book Condensed
- S1** Arrow(s): use only official HAS wayfinding arrow art
- S2** Int'l Symbols: use only official HAS wayfinding symbol art
- B1** Sign Face Reflective White Border - 1/2" full-bleed border
- B2** Dynamic Unit White Border - border to match symbol field
- B3** Black Border - 1/2" full-bleed border


COLORS:

NOTES: "D" = digitally printed colors as generated by 3M Picasso printer (or equal) on 3M Reflective DG3 4090 White unless otherwise noted; "P" = Matthews Acrylic Polyurethane (MAP) paint (or equal), satin finish; "V" = 3M vinyl films (or equal)


- D4** White: match C:0 M:0 Y:0 K:0
- D5** Dark Gray: match PMS 433C **D6**: match PMS 432C
- D8** Light Gray: match PMS 427C
- D9** Black: match C:50 M:40 Y:40 K:100
- D11** Warning Yellow: match 3M Reflective DG3 4091 Yellow
- D17** Blue: match PMS 300C **D18** Dk. Blue: match PMS 294C
- D19** Red: match PMS 187C **D10** Safety Red: match PMS186C
- D21** Orange: match PMS 1655C
- D25** Exit Green: match C:90 M:15 Y:100 K:0
- P1.3** Silver: MAP paint no. N951SP Med. Silver
- P5** Dark Gray: MAP paint matched to PMS 433C
- P17** Blue: MAP paint matched to PMS 300C
- P19** Red: MAP paint matched to PMS 187C




**1** PLAN VIEW  
Scale: 3/16" = 1'-0"

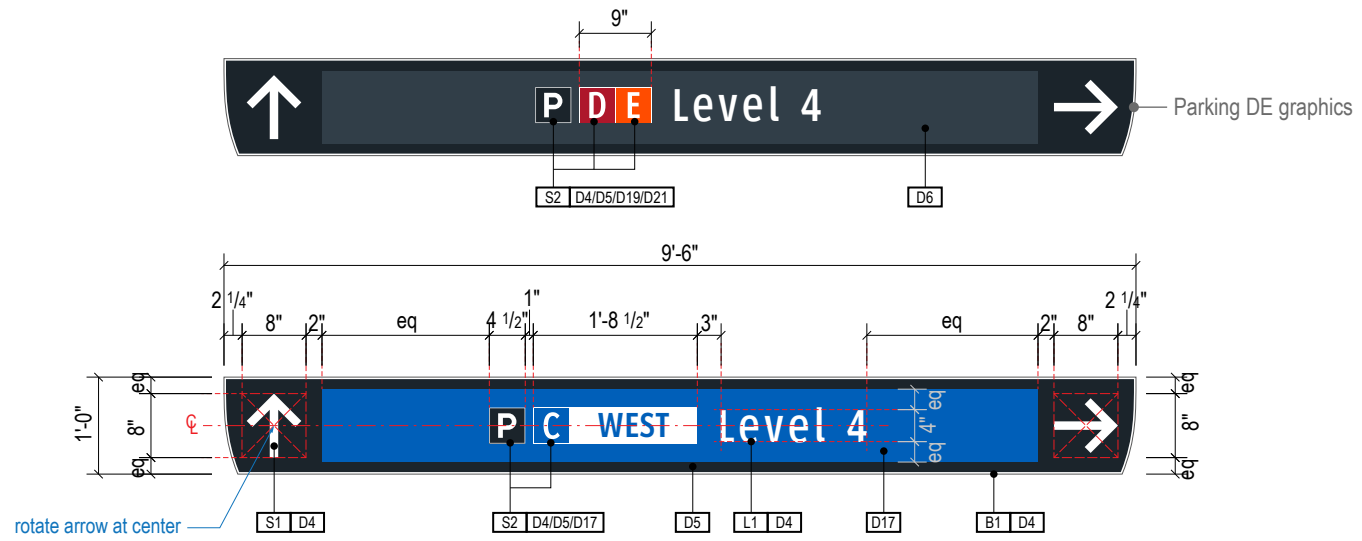


**A** FACE LAYOUT  
Scale: 1/2" = 1'-0"

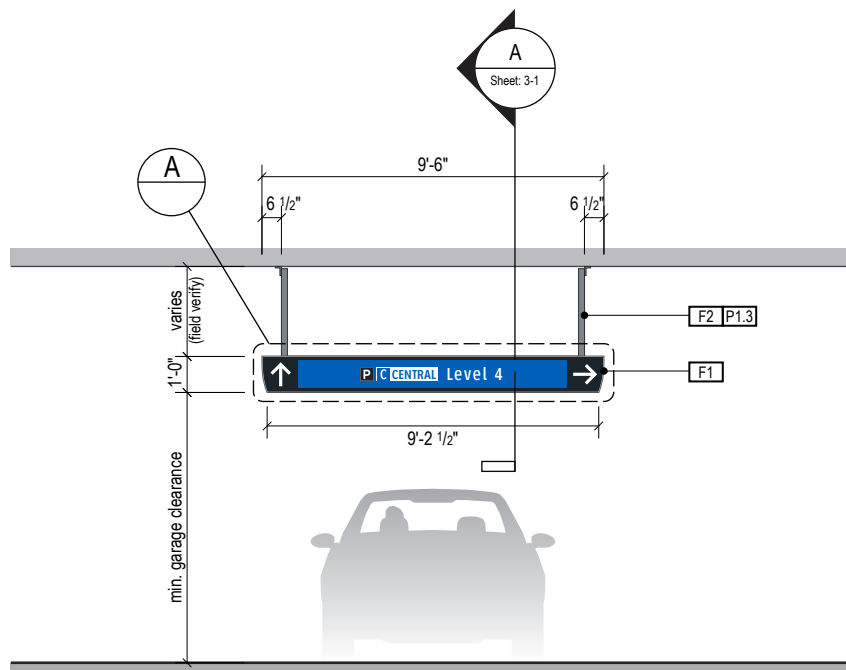

**2** ELEVATION  
Scale: 3/16" = 1'-0"

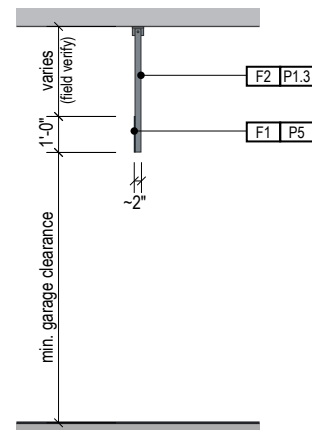

**3** END VIEW  
Scale: 3/16" = 1'-0"

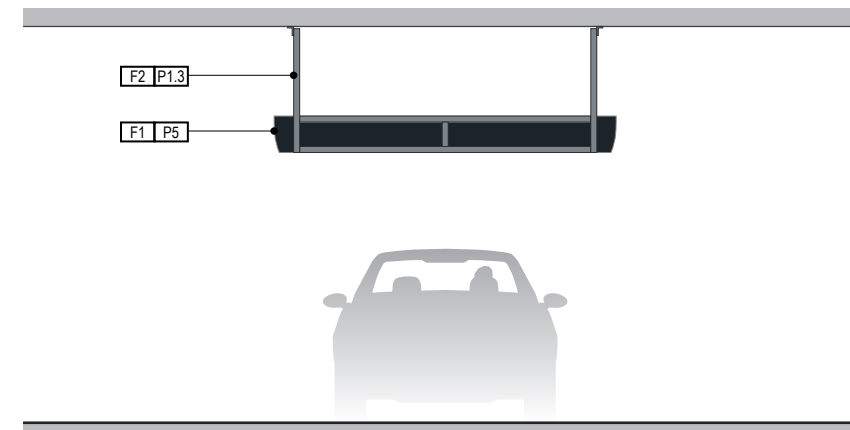

**4** ELEVATION (OPPOSITE SIDE)  
Scale: 3/16" = 1'-0"



ILLUMINATION REFLECTIVE / DIGITAL	SIGN TYPE 5-DR.09b	SIGN FUNCTION DIRECTIONAL	MOUNTING METHOD CEILING SUSPENDED	GENERAL DESCRIPTION & USE VEHICULAR - 1-way Ceiling Susp. Space Count Directional Cover Panels
--------------------------------------	-----------------------	------------------------------	--------------------------------------	---

GENERAL NOTES

- All final design, engineering & amount/sizing of structural sign support elements, material types/thicknesses, dimensions and attachment methods shall be performed and approved by a licensed engineer to meet or exceed all applicable local and national codes.
- Final engineering, dimensions, materials and fabrication are the responsibility of the Contractor/Fabricator/Installer to ensure the highest quality fit and finish for all components of the completed product. All final detailing and specifications to be provided by the Contractor/Fabricator/Installer within their final approved fabrication-ready shop drawings.
- Wherever dissimilar metals are in contact, always separate contact surfaces prior to assembly or installation with the necessary protective coatings/gaskets/washers to prevent galvanic corrosion.
- Final fabrication methods, quality and fit/finish to be reviewed & approved by HAS and the Wayfinding Design Consultants thru prototype reviews prior to final production run/installation processes.
- Colors shown are for reference only, and are subject to the limitations of the printing process and/or variance of electronic RGB screen displays. Refer to color system swatches and approved finish samples for accurate reference.
- Messages shown here are typical placeholders only. See message schedules for specific messaging by location & sign type.

FABRICATION NOTES (GENERAL DESIGN INTENT)

- F1** COVER PANELS: brake-formed alum. cover panels on front (w/ 1st surface full-bleed digitally printed color graphics on reflective 3M DG3 4090 white film) & back (painted with satin MAP paint all exposed surfaces), create cutout(s) to accommodate full-bleed view of digital unit screen area(s) as req'd (field verify) & slotted as req'd to fit around existing mounting hardware/power/data/conduit & mech. fastened to existing Indect unit(s) as req'd (field verify) w/ stainless fasteners (fabricator to field verify all sizes and installation conditions); paint all exposed surfaces with satin MAP paint to match P5
- F2** SUSPENSION/MOUNTING HARDWARE: existing suspension/mounting hardware to be reinforced/sized by engineer to accommodate additional wind loads & weight of new cover panels (fabricator and engineer to field verify prior to final fabrication and installation of new cover panels)
- F3** DIGITAL UNITS: existing self-contained Indect brand digital units (config./qty. of units varies per sign type as shown) w/ digital number space counts/arrows/red X's & static rear-lit symbols as shown

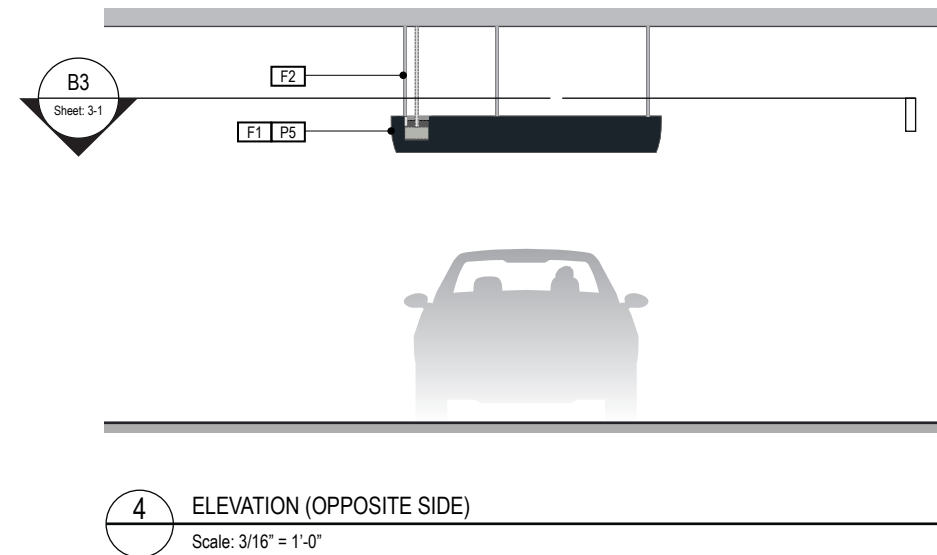
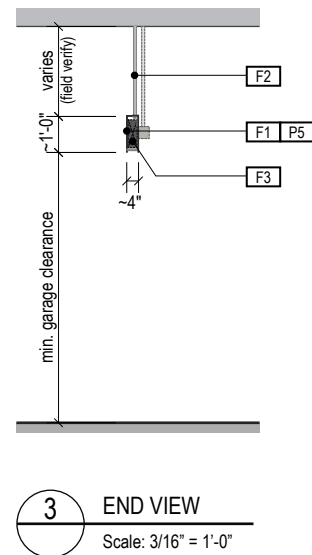
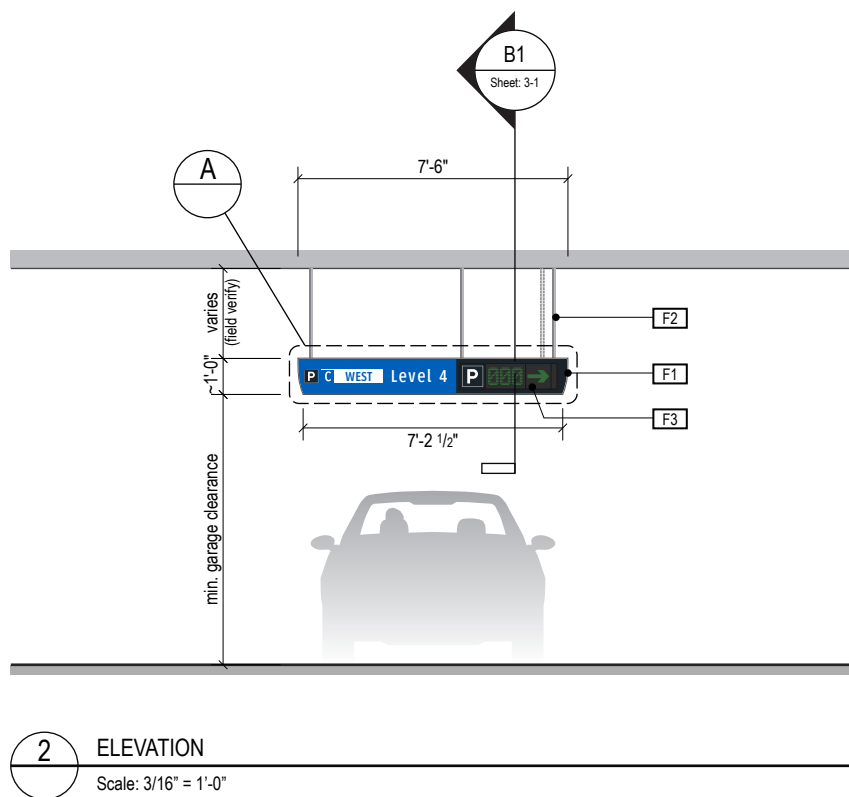
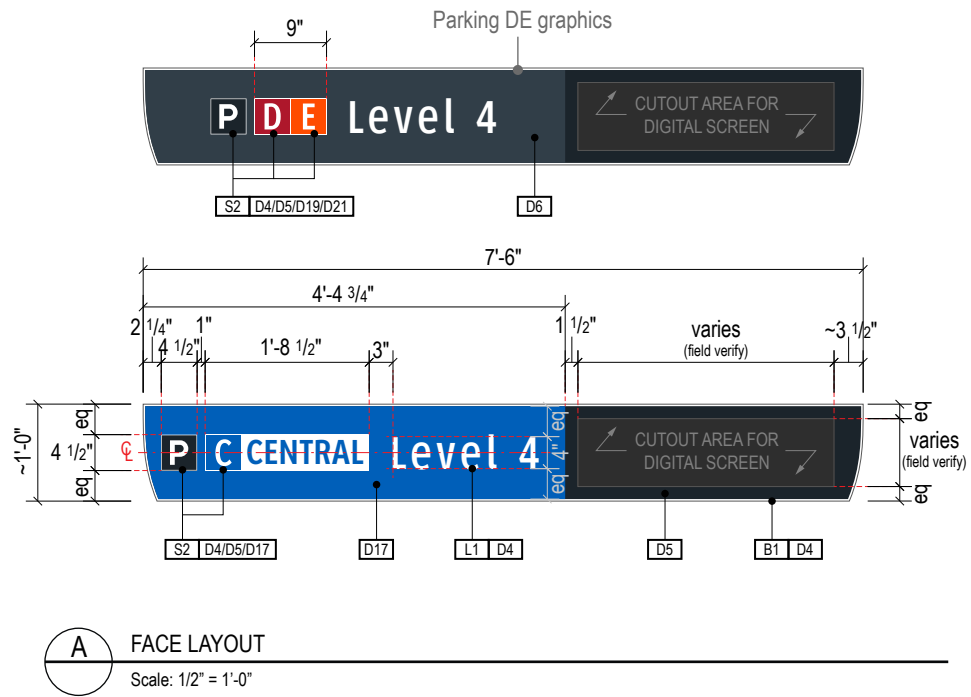
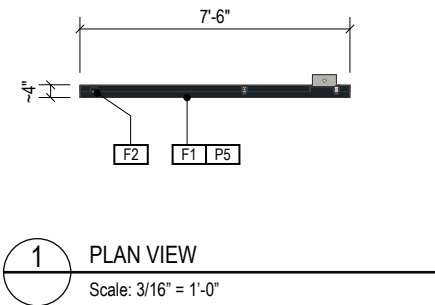
LETTERING (TYPEFACES) / SYMBOLS / ARROWS:

- L1** Vehicular Wayfinding Typeface: Clearview Highway 2-W
- L2** Vehicular Wayfinding Typeface: Clearview Highway 2-B
- L4** Vehicular Dynamic Numbers: Indect digital numbers
- L6** Supplemental Typeface: Clearview One Book Condensed
- S1** Arrow(s): use only official HAS wayfinding arrow art
- S2** Int'l Symbols: use only official HAS wayfinding symbol art
- B1** Sign Face Reflective White Border - 1/2" full-bleed border
- B2** Dynamic Unit White Border - border to match symbol field
- B3** Black Border - 1/2" full-bleed border

COLORS:

NOTES: "D" = digitally printed colors as generated by 3M Picasso printer (or equal) on 3M Reflective DG3 4090 White unless otherwise noted; "P" = Matthews Acrylic Polyurethane (MAP) paint (or equal), satin finish; "V" = 3M vinyl films (or equal)

- D4** White: match C:0 M:0 Y:0 K:0
- D5** Dark Gray: match PMS 433C **D6** : match PMS 432C
- D8** Light Gray: match PMS 427C
- D9** Black: match C:50 M:40 Y:40 K:100
- D11** Warning Yellow: match 3M Reflective DG3 4091 Yellow
- D17** Blue: match PMS 300C **D18** Dk. Blue: match PMS 294C
- D19** Red: match PMS 187C **D10** Safety Red: match PMS186C
- D25** Exit Green: match C:90 M:15 Y:100 K:0
- P1.3** Silver: MAP paint no. N951SP Med. Silver
- P5** Dark Gray: MAP paint matched to PMS 433C
- P17** Blue: MAP paint matched to PMS 300C
- P19** Red: MAP paint matched to PMS 187C



ILLUMINATION	SIGN TYPE	SIGN FUNCTION	MOUNTING METHOD	GENERAL DESCRIPTION & USE
REFLECTIVE / DIGITAL	5-DR_09c	DIRECTIONAL	CEILING SUSPENDED	VEHICULAR - 3-way Ceiling Susp. Space Count Directional Cover Panels

**GENERAL NOTES**

- All final design, engineering & amount/size of structural sign support elements, material types/thicknesses, dimensions and attachment methods shall be performed and approved by a licensed engineer to meet or exceed all applicable local and national codes.
- Final engineering, dimensions, materials and fabrication are the responsibility of the Contractor/Fabricator/Installer to ensure the highest quality fit and finish for all components of the completed product. All final detailing and specifications to be provided by the Contractor/Fabricator/Installer within their final approved fabrication-ready shop drawings.
- Wherever dissimilar metals are in contact, always separate contact surfaces prior to assembly or installation with the necessary protective coatings/gaskets/washers to prevent galvanic corrosion.
- Final fabrication methods, quality and fit/finish to be reviewed & approved by HAS and the Wayfinding Design Consultants thru prototype reviews prior to final production run/installation processes.
- Colors shown are for reference only, and are subject to the limitations of the printing process and/or variance of electronic RGB screen displays. Refer to color system swatches and approved finish samples for accurate reference.
- Messages shown here are typical placeholders only. See message schedules for specific messaging by location & sign type.

**FABRICATION NOTES (GENERAL DESIGN INTENT)**

- F1** COVER PANELS: brake-formed alum. cover panels on front (w/ 1st surface full-bleed digitally printed color graphics on reflective 3M DG3 4090 white film) & back (painted with satin MAP paint all exposed surfaces), create cutout(s) to accommodate full-bleed view of digital unit screen area(s) as req'd (field verify) & slotted as req'd to fit around existing mounting hardware/power/data/conduit & mech. fasteners to existing Indect unit(s) as req'd (field verify) w/ stainless fasteners (fabricator to field verify all sizes and installation conditions); paint all exposed surfaces with satin MAP paint to match P5
- F2** SUSPENSION/MOUNTING HARDWARE: existing suspension/mounting hardware to be reinforced/sized by engineer to accommodate additional wind loads & weight of new cover panels (fabricator and engineer to field verify prior to final fabrication and installation of new cover panels)
- F3** DIGITAL UNITS: existing self-contained Indect brand digital units (config./qty. of units varies per sign type as shown) w/ digital number space counts/arrows/red X's & static rear-lit symbols as shown

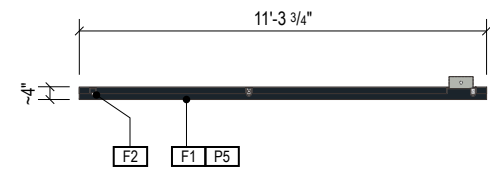
**LETTERING (TYPEFACES) / SYMBOLS / ARROWS:**

- L1** Vehicular Wayfinding Typeface: Clearview Highway 2-W
- L2** Vehicular Wayfinding Typeface: Clearview Highway 2-B
- L4** Vehicular Dynamic Numbers: Indect digital numbers
- L6** Supplemental Typeface: Clearview One Book Condensed
- S1** Arrow(s): use only official HAS wayfinding arrow art
- S2** Int'l Symbols: use only official HAS wayfinding symbol art
- B1** Sign Face Reflective White Border - 1/2" full-bleed border
- B2** Dynamic Unit White Border - border to match symbol field
- B3** Black Border - 1/2" full-bleed border


**COLORS:**

NOTES: "D" = digitally printed colors as generated by 3M Picasso printer (or equal) on 3M Reflective DG3 4090 White unless otherwise noted; "P" = Matthews Acrylic Polyurethane (MAP) paint (or equal), satin finish; "V" = 3M vinyl films (or equal)


- D4** White: match C:0 M:0 Y:0 K:0
- D5** Dark Gray: match PMS 433C **D6**: match PMS 432C
- D8** Light Gray: match PMS 427C
- D9** Black: match C:50 M:40 Y:40 K:100
- D11** Warning Yellow: match 3M Reflective DG3 4091 Yellow
- D17** Blue: match PMS 300C **D18** Dk. Blue: match PMS 294C
- D19** Red: match PMS 187C **D10** Safety Red: match PMS186C
- D21** Orange: match PMS 1655C
- D25** Exit Green: match C:90 M:15 Y:100 K:0
- P1.3** Silver: MAP paint no. N951SP Med. Silver
- P5** Dark Gray: MAP paint matched to PMS 433C
- P17** Blue: MAP paint matched to PMS 300C
- P19** Red: MAP paint matched to PMS 187C




**1 PLAN VIEW**  
Scale: 3/16" = 1'-0"

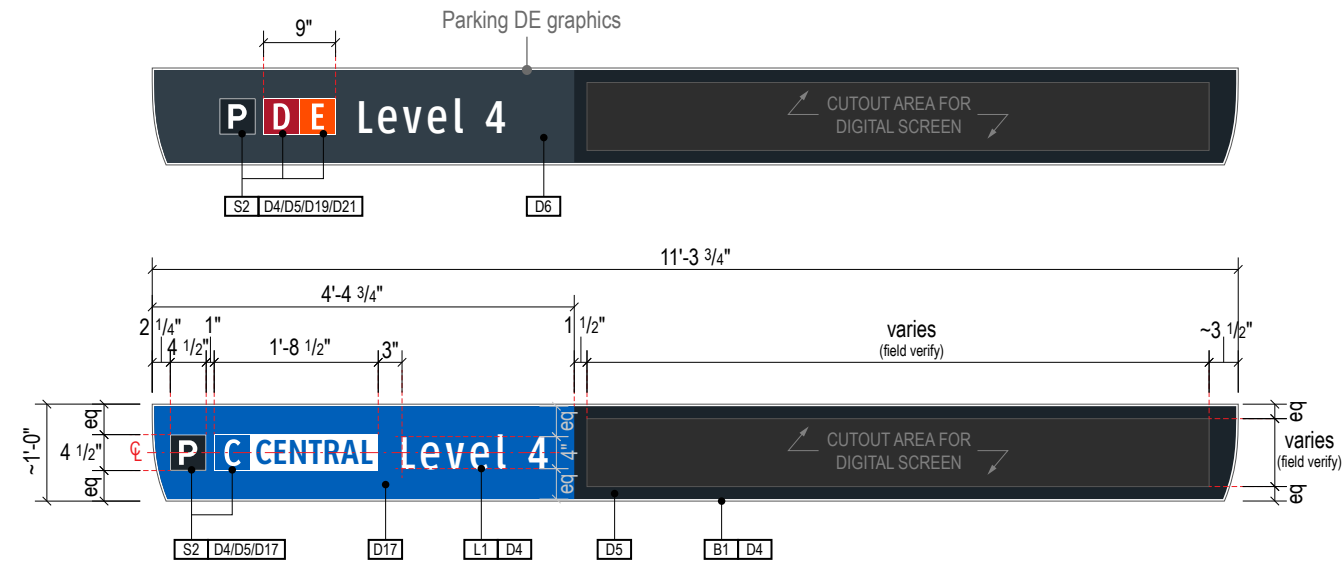


**A FACE LAYOUT**  
Scale: 1/2" = 1'-0"

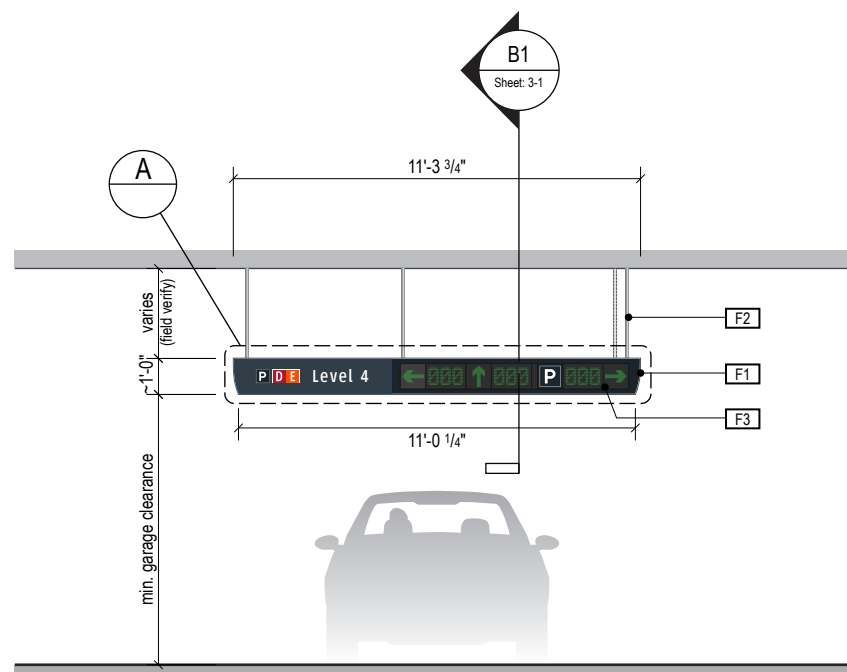

**2 ELEVATION**  
Scale: 3/16" = 1'-0"

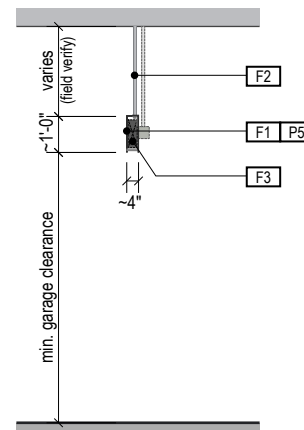

**3 END VIEW**  
Scale: 3/16" = 1'-0"

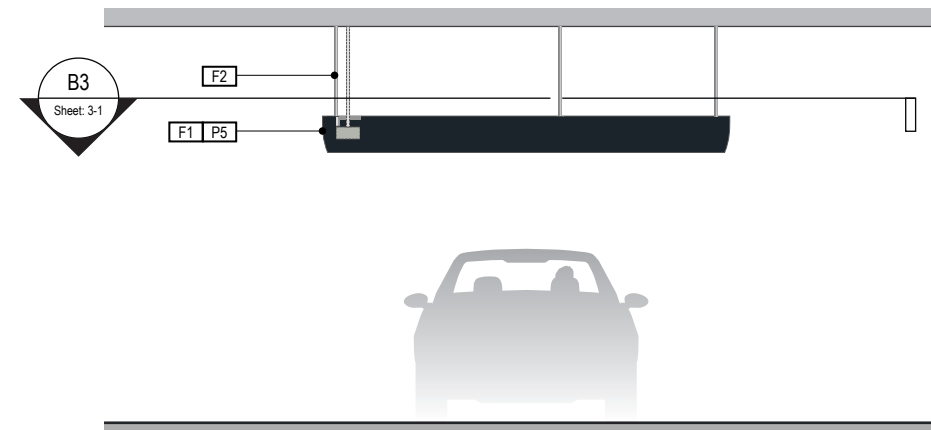

**4 ELEVATION (OPPOSITE SIDE)**  
Scale: 3/16" = 1'-0"

ILLUMINATION	SIGN TYPE	SIGN FUNCTION	MOUNTING METHOD	GENERAL DESCRIPTION & USE
REFLECTIVE	5-DR.12	DIRECTIONAL	CEILING SUSPENDED	VEHICULAR - Ceiling Susp. Ramp Entry Directional - Static

**GENERAL NOTES**

- All final design, engineering & amount/sizing of structural sign support elements, material types/thicknesses, dimensions and attachment methods shall be performed and approved by a licensed engineer to meet or exceed all applicable local and national codes.
- Final engineering, dimensions, materials and fabrication are the responsibility of the Contractor/Fabricator/Installer to ensure the highest quality fit and finish for all components of the completed product. All final detailing and specifications to be provided by the Contractor/Fabricator/Installer within their final approved fabrication-ready shop drawings.
- Wherever dissimilar metals are in contact, always separate contact surfaces prior to assembly or installation with the necessary protective coatings/gaskets/washers to prevent galvanic corrosion.
- Final fabrication methods, quality and fit/finish to be reviewed & approved by HAS and the Wayfinding Design Consultants thru prototype reviews prior to final production run/installation processes.
- Colors shown are for reference only, and are subject to the limitations of the printing process and/or variance of electronic RGB screen displays. Refer to color system swatches and approved finish samples for accurate reference.
- Messages shown here are typical placeholders only. See message schedules for specific messaging by location & sign type.

**FABRICATION NOTES (GENERAL DESIGN INTENT)**

- F1** SIGN FACE PANELS: 1/8" thk. alum. face panel w/ 1st surface full-bleed digitally printed color graphics on reflective 3M DG3 4090 white film; face panel mech. fastened to support frame w/ stainless steel screws, paint heads to match face; paint all exposed surfaces with satin MAP paint to match P5
- F2** SUPPORT FRAME/SUSPENSION: fabricated 2" square alum. support tube frame & vertical suspension tube structure; all exposed support frame tube ends to be capped with alum.; all welds on frame/caps to be filled & ground smooth for uniform appearance; suspension tubes mechanically attached to ceiling attachment hinge plates above; ceiling attachment plates to be mechanically fastened to garage's structural ceiling elements as req. w/ mech. fasteners (fabricator to field verify); support frame, suspension tubes & hinge plates to be painted all exposed surfaces with satin MAP paint to match P1.3

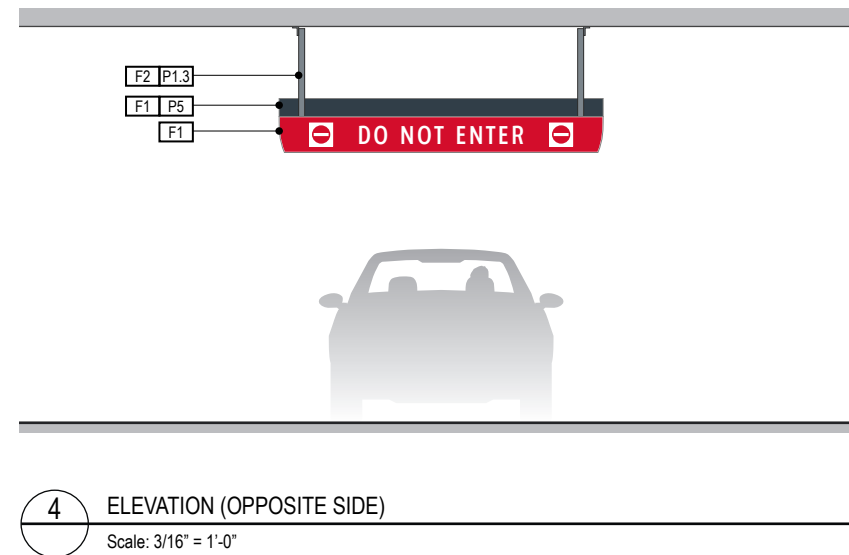
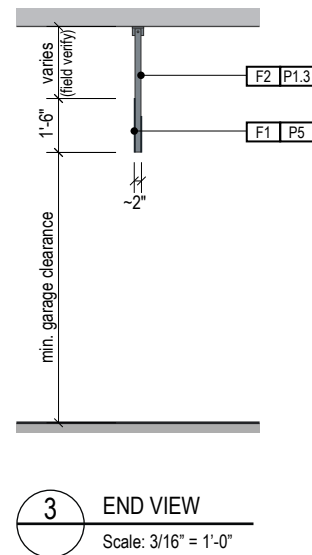
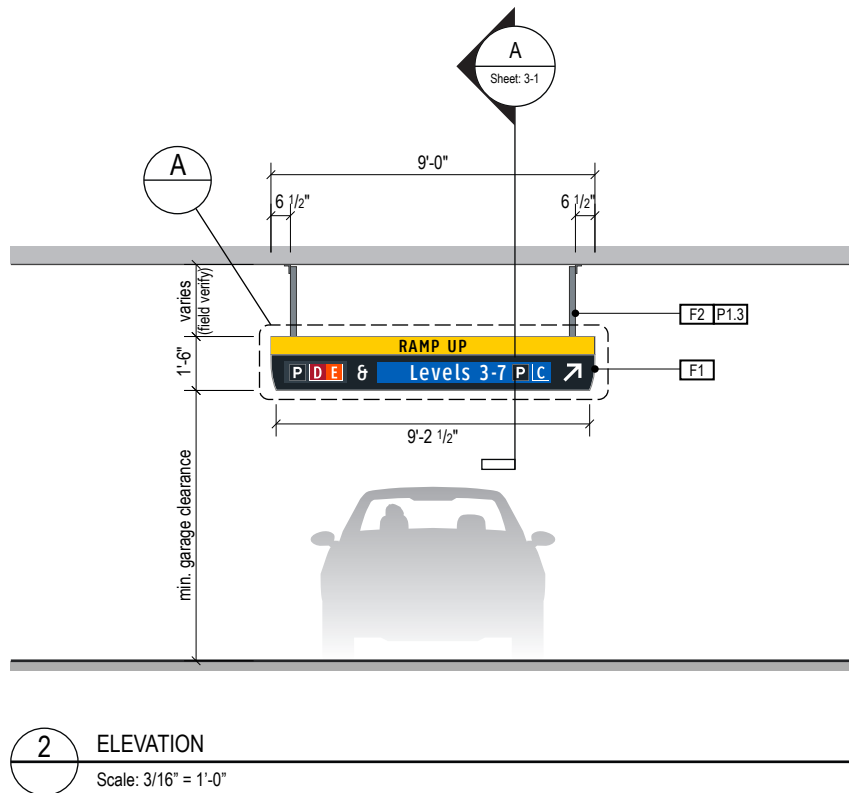
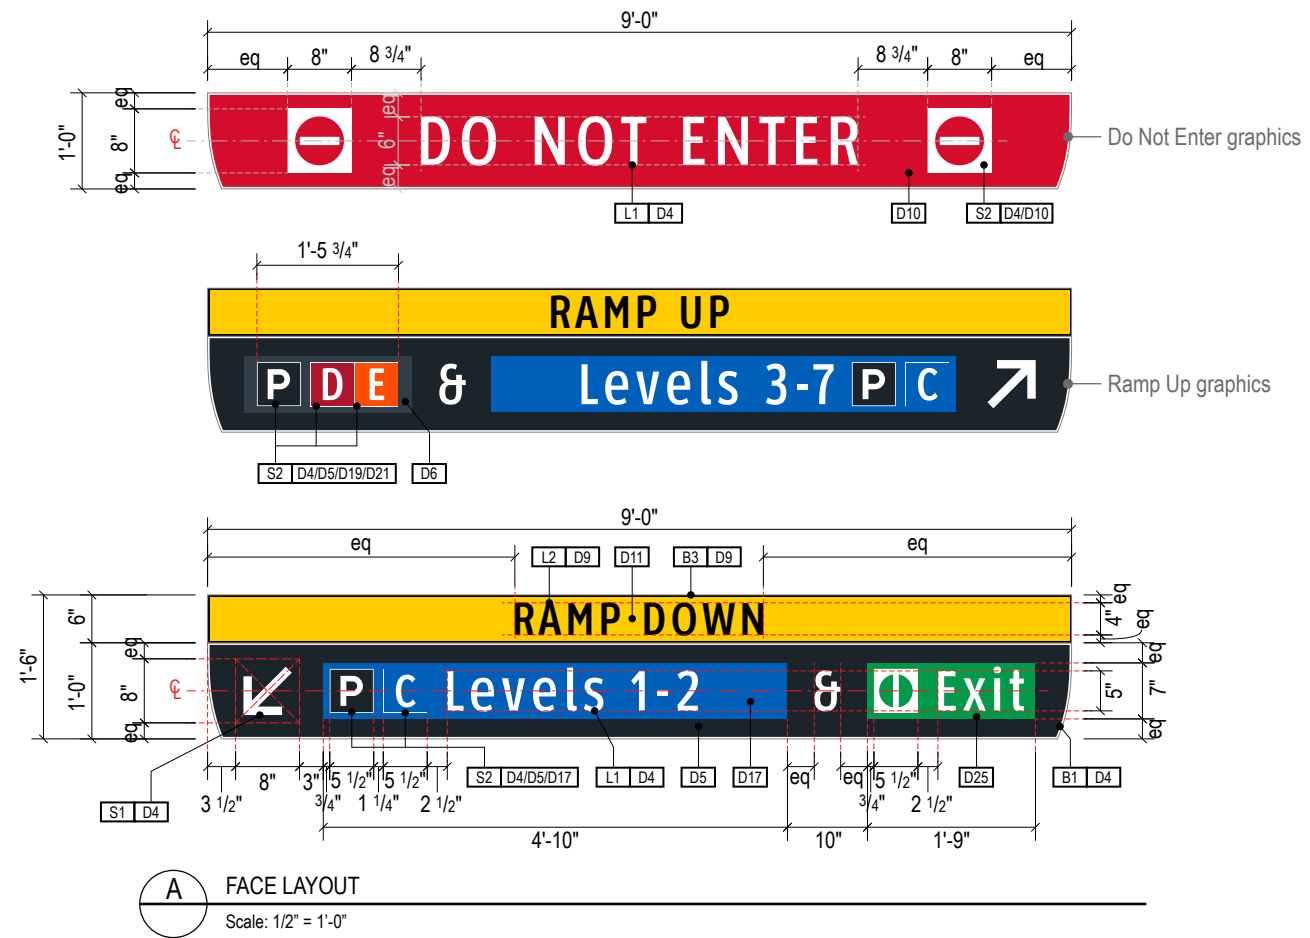
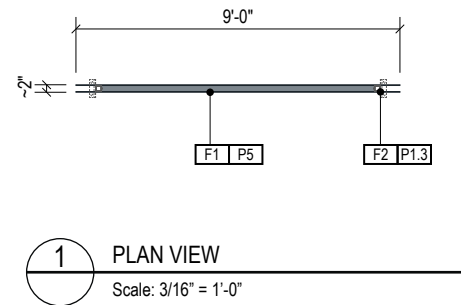
**LETTERING (TYPEFACES) / SYMBOLS / ARROWS:**

- L1** Vehicular Wayfinding Typeface: Clearview Highway 2-W
- L2** Vehicular Wayfinding Typeface: Clearview Highway 2-B
- L4** Vehicular Dynamic Numbers: Indect digital numbers
- L6** Supplemental Typeface: Clearview One Book Condensed
- S1** Arrow(s): use only official HAS wayfinding arrow art
- S2** Int'l Symbols: use only official HAS wayfinding symbol art
- B1** Sign Face Reflective White Border - 1/2" full-bleed border
- B2** Dynamic Unit White Border - border to match symbol field
- B3** Black Border - 1/2" full-bleed border






**COLORS:**

NOTES: "D" = digitally printed colors as generated by 3M Picasso printer (or equal) on 3M Reflective DG3 4090 White unless otherwise noted; "P" = Matthews Acrylic Polyurethane (MAP) paint (or equal), satin finish; "V" = 3M vinyl films (or equal)

- D4** White: match C:0 M:0 Y:0 K:0
- D5** Dark Gray: match PMS 300C **D6**: match PMS 432C
- D8** Light Gray: match PMS 427C
- D9** Black: match C:50 M:40 Y:40 K:100
- D11** Warning Yellow: match 3M Reflective DG3 4091 Yellow
- D17** Blue: match PMS 300C **D18** Dk. Blue: match PMS 294C
- D19** Red: match PMS 187C **D10** Safety Red: match PMS186C
- D21** Orange: match PMS 1655C
- D25** Exit Green: match C:90 M:15 Y:100 K:0
- P1.3** Silver: MAP paint no. N951SP Med. Silver
- P5** Dark Gray: MAP paint matched to PMS 433C
- P17** Blue: MAP paint matched to PMS 300C
- P19** Red: MAP paint matched to PMS 187C



ILLUMINATION	SIGN TYPE	SIGN FUNCTION	MOUNTING METHOD	GENERAL DESCRIPTION & USE
REFLECTIVE	5-DR.13a	DIRECTIONAL	CEILING SUSPENDED	VEHICULAR - Ceiling Susp. Level/Bridge Entry Directional - Static

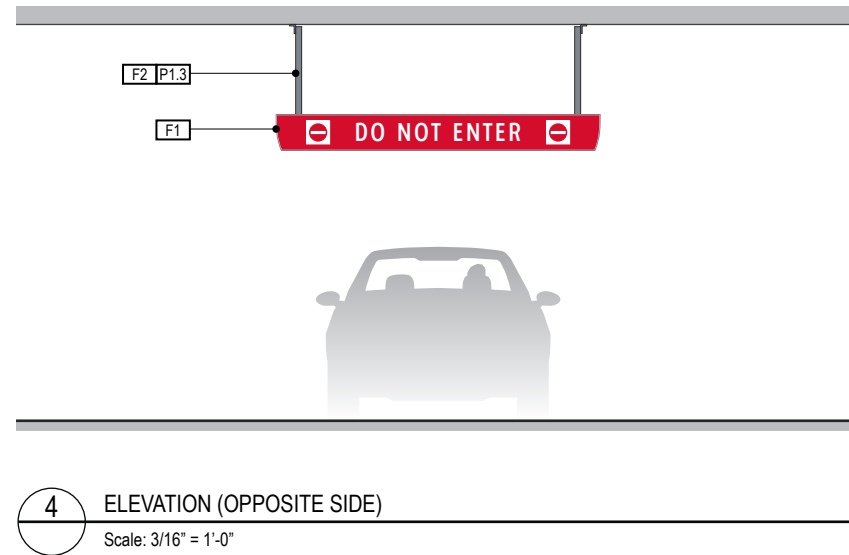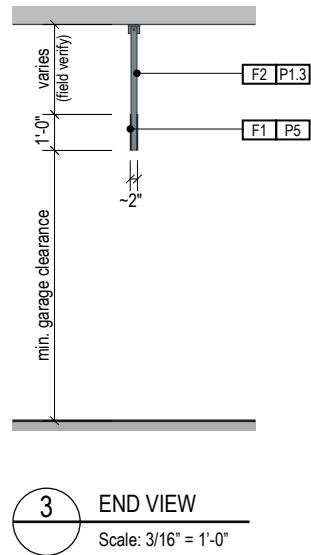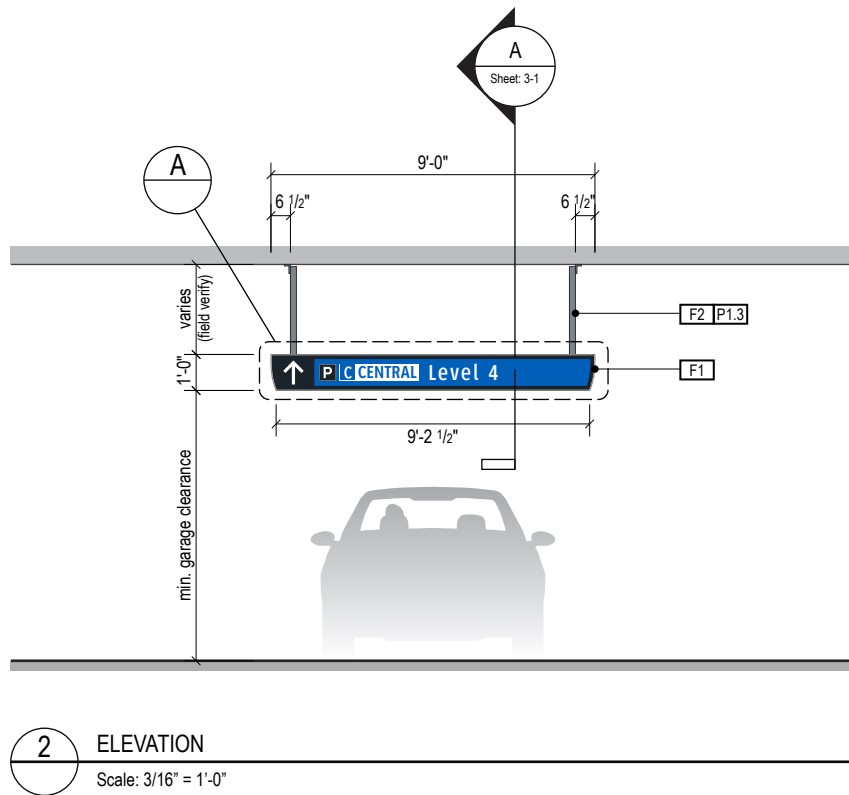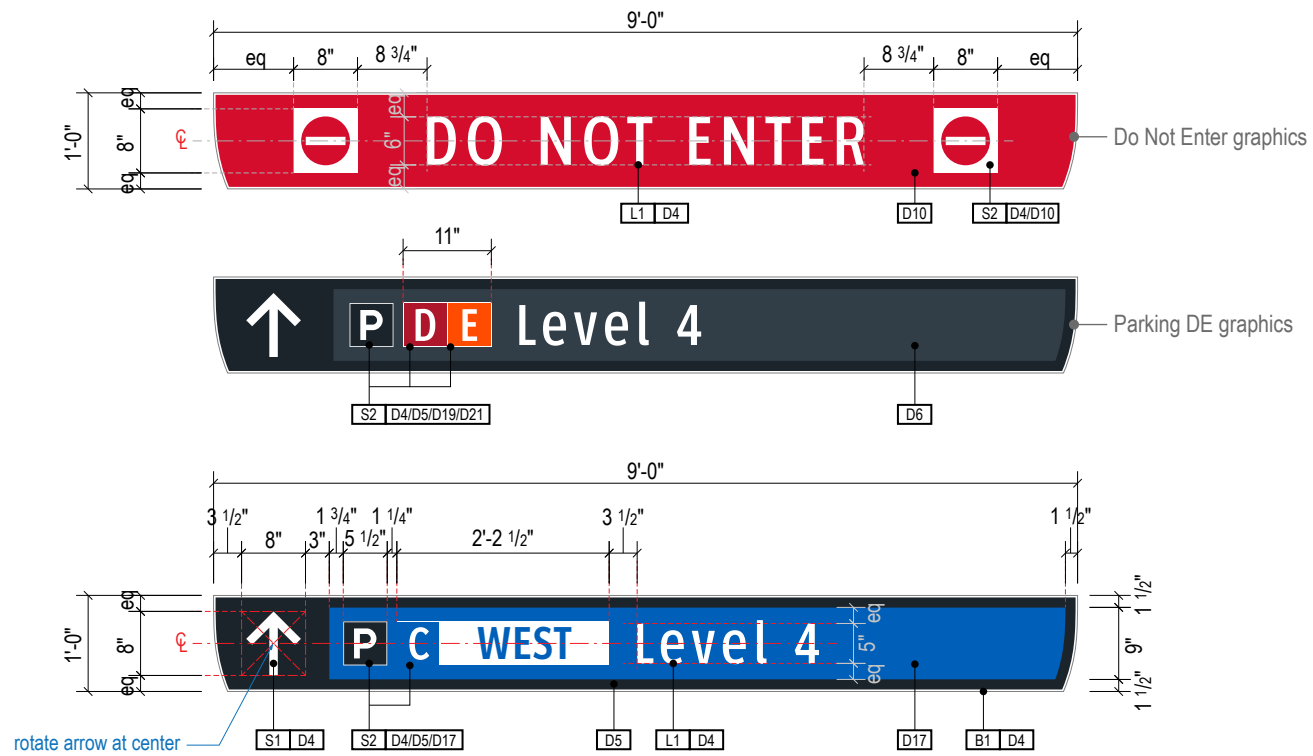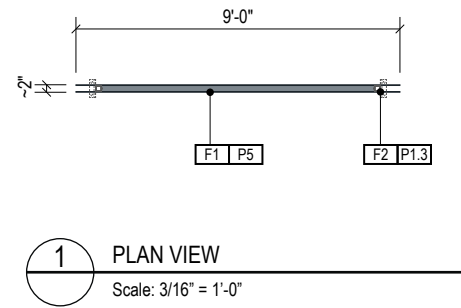

GENERAL NOTES

- All final design, engineering & amount/sizing of structural sign support elements, material types/thicknesses, dimensions and attachment methods shall be performed and approved by a licensed engineer to meet or exceed all applicable local and national codes.
- Final engineering, dimensions, materials and fabrication are the responsibility of the Contractor/Fabricator/Installer to ensure the highest quality fit and finish for all components of the completed product. All final detailing and specifications to be provided by the Contractor/Fabricator/Installer within their final approved fabrication-ready shop drawings.
- Wherever dissimilar metals are in contact, always separate contact surfaces prior to assembly or installation with the necessary protective coatings/gaskets/washers to prevent galvanic corrosion.
- Final fabrication methods, quality and fit/finish to be reviewed & approved by HAS and the Wayfinding Design Consultants thru prototype reviews prior to final production run/installation processes.
- Colors shown are for reference only, and are subject to the limitations of the printing process and/or variance of electronic RGB screen displays. Refer to color system swatches and approved finish samples for accurate reference.
- Messages shown here are typical placeholders only. See message schedules for specific messaging by location and sign type.

FABRICATION NOTES (GENERAL DESIGN INTENT)

- F1** SIGN FACE PANELS: 1/8" thk. alum. face panel w/ 1st surface full-bleed digitally printed color graphics on reflective 3M DG3 4090 white film; face panel mech. fastened to support frame w/ stainless steel screws, paint heads to match face; paint all exposed surfaces with satin MAP paint to match P5
- F2** SUPPORT FRAME/SUSPENSION: fabricated 2" square alum. support tube frame & vertical suspension tube structure; all exposed support frame tube ends to be capped with alum.; all welds on frame/caps to be filled & ground smooth for uniform appearance; suspension tubes mechanically attached to ceiling attachment hinge plates above; ceiling attachment plates to be mechanically fastened to garage's structural ceiling elements as req. w/ mech. fasteners (fabricator to field verify); support frame, suspension tubes & hinge plates to be painted all exposed surfaces with satin MAP paint to match P1.3

LETTERING (TYPEFACES) / SYMBOLS / ARROWS:

- L1** Vehicular Wayfinding Typeface: Clearview Highway 2-W
- L2** Vehicular Wayfinding Typeface: Clearview Highway 2-B
- L4** Vehicular Dynamic Numbers: Indect digital numbers
- L6** Supplemental Typeface: Clearview One Book Condensed
- S1** Arrow(s): use only official HAS wayfinding arrow art
- S2** Int'l Symbols: use only official HAS wayfinding symbol art
- B1** Sign Face Reflective White Border - 1/2" full-bleed border
- B2** Dynamic Unit White Border - border to match symbol field
- B3** Black Border - 1/2" full-bleed border

COLORS:

- NOTES: "D" = digitally printed colors as generated by 3M Picasso printer (or equal) on 3M Reflective DG3 4090 White unless otherwise noted; "P" = Matthews Acrylic Polyurethane (MAP) paint (or equal), satin finish; "V" = 3M vinyl films (or equal)
- D4** White: match C:0 M:0 Y:0 K:0
  - D5** Dark Gray: match PMS 433C **D6**: match PMS 432C
  - D8** Light Gray: match PMS 427C
  - D9** Black: match C:50 M:40 Y:40 K:100
  - D11** Warning Yellow: match 3M Reflective DG3 4091 Yellow
  - D17** Blue: match PMS 300C **D18** Dk. Blue: match PMS 294C
  - D19** Red: match PMS 187C **D10** Safety Red: match PMS186C
  - D21** Orange: match PMS 1655C
  - D25** Exit Green: match C:90 M:15 Y:100 K:0
  - P1.3** Silver: MAP paint no. N951SP Med. Silver
  - P5** Dark Gray: MAP paint matched to PMS 433C
  - P17** Blue: MAP paint matched to PMS 300C
  - P19** Red: MAP paint matched to PMS 187C

Wayfinding Updates

Issue Date: 08-23-2024

Issue for Bid

- REV.
- REV.
- REV.

WARNING:

This record contains Sensitive Security Information that is controlled under 49 CFR parts 15 and 1520. No part of this record may be disclosed to persons with a "need to know," as defined in 49 CFR parts 15 and 1520, except with the written permission of the Administrator of the Transportation Security Administration or the Secretary of Transportation. Unauthorized release may result in civil penalty or other action. For U.S. government agencies, public disclosure is governed by 5 U.S.C. 552 and 49 CFR parts 15 and 1520.



THESE SHEETS ARE ISSUED FOR GRAPHICAL INFORMATION ONLY

08-23-2024

2.1 DESIGN INTENT - PARKING GARAGE: VEHICULAR SIGNS

BSG PRJCT# BSG-2024-111-IAH  
HAS TIP # 24 -103 - IAH

Sheet: 2-11

ILLUMINATION	SIGN TYPE	SIGN FUNCTION	MOUNTING METHOD	GENERAL DESCRIPTION & USE
REFLECTIVE	5-DR.53b	DIRECTIONAL	POST MOUNT	VEHICULAR - Post Mount Exit Trailblazer - Static

**GENERAL NOTES**

- All final design, engineering & amount/sizing of structural sign support elements, material types/thicknesses, dimensions and attachment methods shall be performed and approved by a licensed engineer to meet or exceed all applicable local and national codes.
- Final engineering, dimensions, materials and fabrication are the responsibility of the Contractor/Fabricator/Installer to ensure the highest quality fit and finish for all components of the completed product. All final detailing and specifications to be provided by the Contractor/Fabricator/Installer within their final approved fabrication-ready shop drawings.
- Wherever dissimilar metals are in contact, always separate contact surfaces prior to assembly or installation with the necessary protective coatings/gaskets/washers to prevent galvanic corrosion.
- Final fabrication methods, quality and fit/finish to be reviewed & approved by HAS and the Wayfinding Design Consultants thru prototype reviews prior to final production run/installation processes.
- Colors shown are for reference only, and are subject to the limitations of the printing process and/or variance of electronic RGB screen displays. Refer to color system swatches and approved finish samples for accurate reference.
- Messages shown here are typical placeholders only. See message schedules for specific messaging by location and sign type.

**FABRICATION NOTES (GENERAL DESIGN INTENT)**

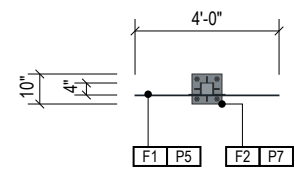
- F1** SIGN FACE PANELS: 1/4" thk. alum. face panel w/ 1st surface full-bleed digitally printed color graphics on reflective 3M DG3 4090 white film; face panel mech. fastened to support frame w/ stainless steel screws, paint heads to match face; paint all exposed surfaces with satin MAP paint to match P5
- F2** SUPPORT POST: fabricated square alum. support tube frame & vertical post structure; all support frame tube ends to be capped with alum.; all welds to be filled & ground smooth for uniform appearance; support post base plate mechanically attached to ground/decking as req'd (fabricator to field verify & get engineering support/buy-off prior to fabrication/installation); use break-away base connection if/as code requires; support frame/post/base plate to be painted all exposed surfaces with satin MAP paint to match P7

**LETTERING (TYPEFACES) / SYMBOLS / ARROWS:**


- L1** Vehicular Wayfinding Typeface: Clearview Highway 2-W
- L2** Vehicular Wayfinding Typeface: Clearview Highway 2-B
- L4** Vehicular Dynamic Numbers: Indect digital numbers
- L6** Supplemental Typeface: Clearview One Book Condensed
- S1** Arrow(s): use only official HAS wayfinding arrow art
- S2** Int'l Symbols: use only official HAS wayfinding symbol art
- B1** Sign Face Reflective White Border - 1/2" full-bleed border
- B2** Dynamic Unit White Border - border to match symbol field
- B3** Black Border - 1/2" full-bleed border

**COLORS:**


- NOTES: "D" = digitally printed colors as generated by 3M Picasso printer (or equal) on 3M Reflective DG3 4090 White unless otherwise noted; "P" = Matthews Acrylic Polyurethane (MAP) paint (or equal), satin finish; "V" = 3M vinyl films (or equal)
- D4** White: match C:0 M:0 Y:0 K:0
  - D5** Dark Gray: match PMS 433C **D6** : match PMS 432C
  - D8** Light Gray: match PMS 427C
  - D9** Black: match C:50 M:40 Y:40 K:100
  - D11** Warning Yellow: match 3M Reflective DG3 4091 Yellow
  - D17** Blue: match PMS 300C **D18** Dk. Blue: match PMS 294C
  - D19** Red: match PMS 187C **D10** Safety Red: match PMS186C
  - D21** Orange: match PMS 1655C
  - D25** Exit Green: match C:90 M:15 Y:100 K:0
  - P1.3** Silver: MAP paint no. N951SP Med. Silver
  - P5** Dark Gray: MAP paint matched to PMS 433C
  - P17** Blue: MAP paint matched to PMS 300C
  - P19** Red: MAP paint matched to PMS 187C




**1 PLAN VIEW**  
Scale: 3/16" = 1'-0"

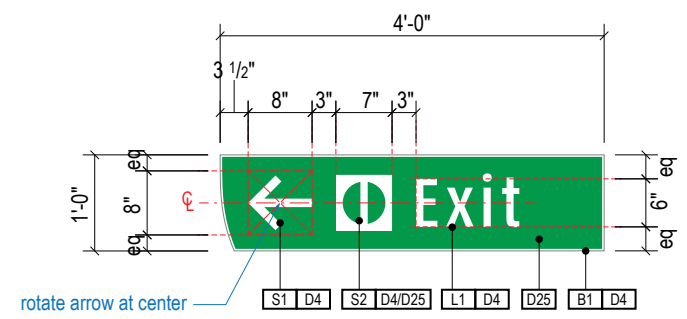


**A FACE LAYOUT**  
Scale: 1/2" = 1'-0"

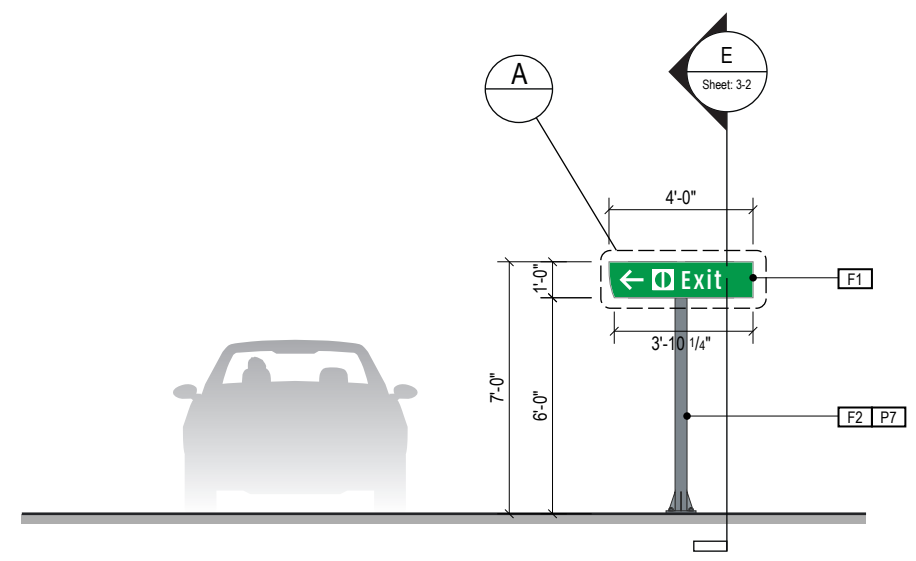

**2 ELEVATION**  
Scale: 3/16" = 1'-0"

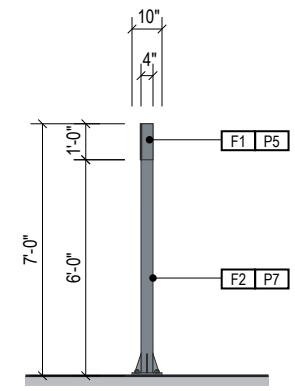

**3 END VIEW**  
Scale: 3/16" = 1'-0"

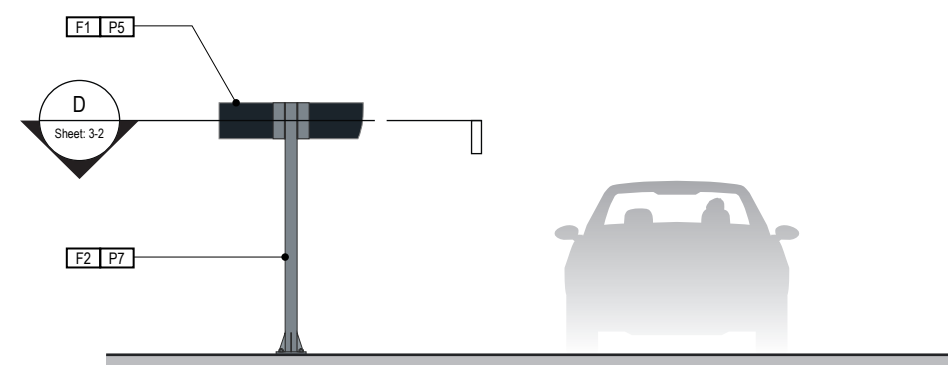

**4 ELEVATION (OPPOSITE SIDE)**  
Scale: 3/16" = 1'-0"

ILLUMINATION	SIGN TYPE	SIGN FUNCTION	MOUNTING METHOD	GENERAL DESCRIPTION & USE
REFLECTIVE / DIGITAL	5-DR.58	DIRECTIONAL	POST MOUNT	VEHICULAR - Post Mount Level ID/Space Count Digital Unit Cover Panels w/ ID Header

**GENERAL NOTES**

- All final design, engineering & amount/size of structural sign support elements, material types/thicknesses, dimensions and attachment methods shall be performed and approved by a licensed engineer to meet or exceed all applicable local and national codes.
- Final engineering, dimensions, materials and fabrication are the responsibility of the Contractor/Fabricator/Installer to ensure the highest quality fit and finish for all components of the completed product. All final detailing and specifications to be provided by the Contractor/Fabricator/Installer within their final approved fabrication-ready shop drawings.
- Wherever dissimilar metals are in contact, always separate contact surfaces prior to assembly or installation with the necessary protective coatings/gaskets/washers to prevent galvanic corrosion.
- Final fabrication methods, quality and fit/finish to be reviewed & approved by HAS and the Wayfinding Design Consultants thru prototype reviews prior to final production run/installation processes.
- Colors shown are for reference only, and are subject to the limitations of the printing process and/or variance of electronic RGB screen displays. Refer to color system swatches and approved finish samples for accurate reference.
- Messages shown here are typical placeholders only. See message schedules for specific messaging by location and sign type.

**FABRICATION NOTES (GENERAL DESIGN INTENT)**

- F1** COVER PANELS: brake-formed alum. cover panels on front (w/ 1st surface full-bleed digitally printed color graphics on reflective 3M DG3 4090 white film) & back (painted with satin MAP paint all exposed surfaces), create cutout(s) to accommodate full-bleed view of digital unit screen area(s) as req'd (field verify) & slotted as req'd to fit around existing mounting hardware/power/data/conduit & mech. fastened to existing Indect unit(s) as req'd (field verify) w/ stainless fasteners (fabricator to field verify all sizes and installation conditions); paint all exposed surfaces with satin MAP paint to match P5
- F2** POST/MOUNTING HARDWARE: existing post/mounting hardware to be reinforced/sized by engineer to accommodate additional wind loads & weight of new cover panels (fabricator and engineer to field verify prior to final fabrication and installation of new cover panels)
- F3** DIGITAL UNITS: existing self-contained Indect brand digital units (config./qty. of units varies per sign type as shown) w/ digital number space counts/arrows/red X's & static rear-lit symbols as shown

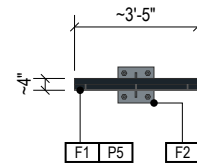
**LETTERING (TYPEFACES) / SYMBOLS / ARROWS:**

- L1** Vehicular Wayfinding Typeface: Clearview Highway 2-W
- L2** Vehicular Wayfinding Typeface: Clearview Highway 2-B
- L4** Vehicular Dynamic Numbers: Indect digital numbers
- L6** Supplemental Typeface: Clearview One Book Condensed
- S1** Arrow(s): use only official HAS wayfinding arrow art
- S2** Int'l Symbols: use only official HAS wayfinding symbol art
- B1** Sign Face Reflective White Border - 1/2" full-bleed border
- B2** Dynamic Unit White Border - border to match symbol field
- B3** Black Border - 1/2" full-bleed border


**COLORS:**

NOTES: "D" = digitally printed colors as generated by 3M Picasso printer (or equal) on 3M Reflective DG3 4090 White unless otherwise noted; "P" = Matthews Acrylic Polyurethane (MAP) paint (or equal), satin finish; "V" = 3M vinyl films (or equal)


- D4** White: match C:0 M:0 Y:0 K:0
- D5** Dark Gray: match PMS 433C **D6** match PMS 432C
- D8** Light Gray: match PMS 427C
- D9** Black: match C:50 M:40 Y:40 K:100
- D11** Warning Yellow: match 3M Reflective DG3 4091 Yellow
- D17** Blue: match PMS 300C **D18** Dk. Blue: match PMS 294C
- D19** Red: match PMS 187C **D10** Safety Red: match PMS186C
- D21** Orange: match PMS 1655C
- D25** Exit Green: match C:90 M:15 Y:100 K:0
- P1.3** Silver: MAP paint no. N951SP Med. Silver
- P5** Dark Gray: MAP paint matched to PMS 433C
- P17** Blue: MAP paint matched to PMS 300C
- P19** Red: MAP paint matched to PMS 187C




**1 PLAN VIEW**  
Scale: 3/16" = 1'-0"

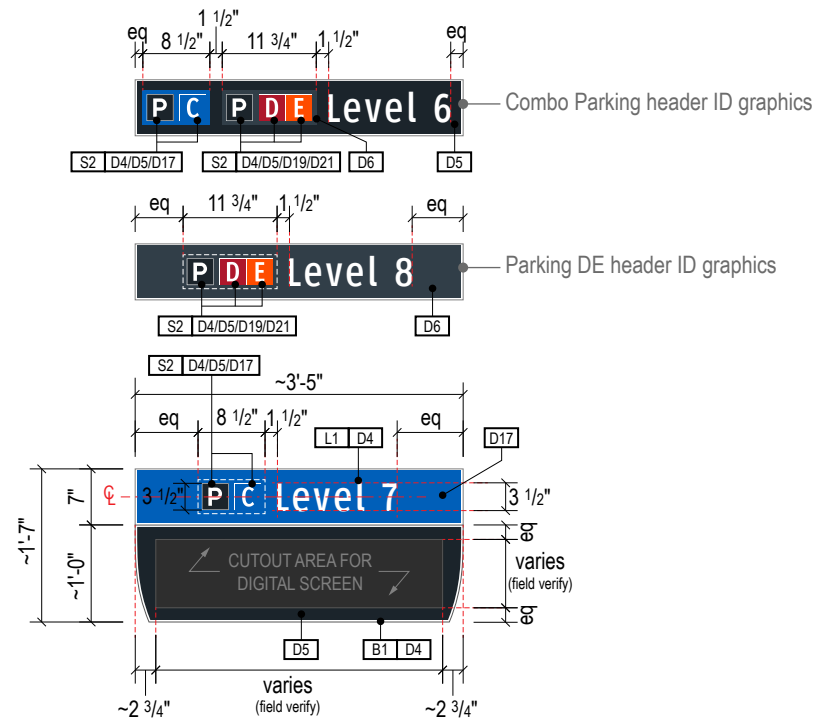


**A FACE LAYOUT**  
Scale: 1/2" = 1'-0"

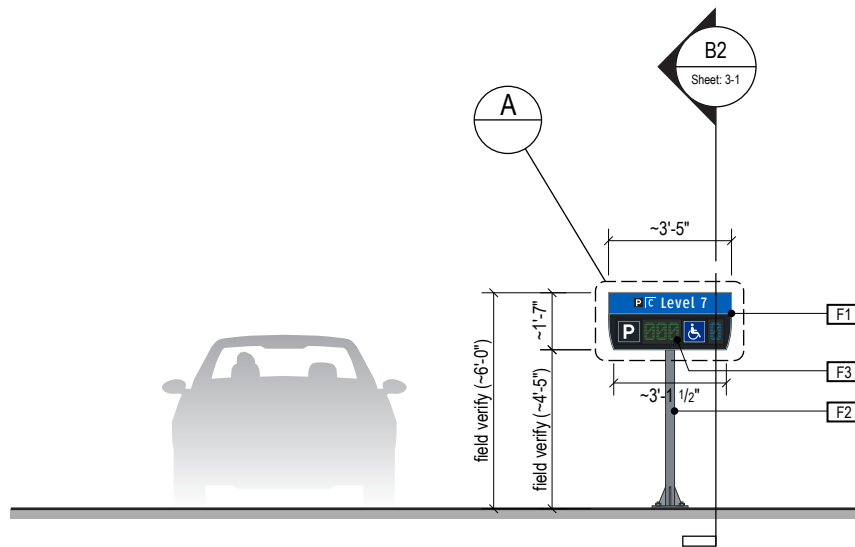

**2 ELEVATION**  
Scale: 3/16" = 1'-0"





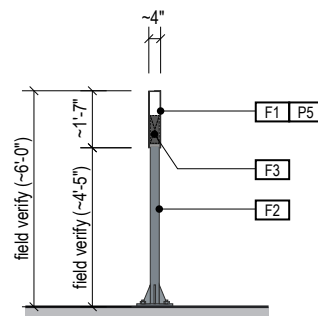


**3 END VIEW**  
Scale: 3/16" = 1'-0"

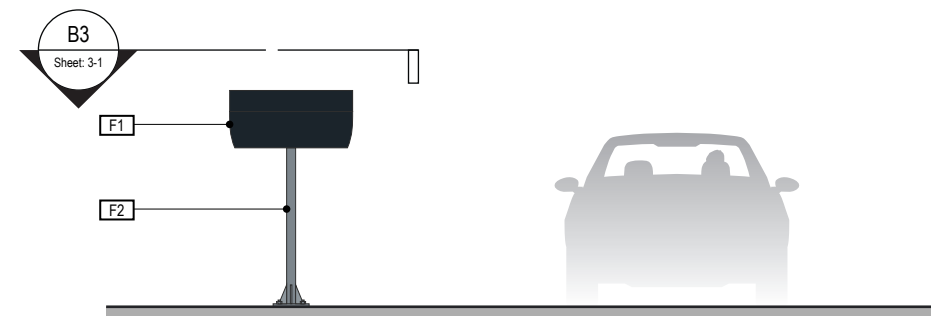

**4 ELEVATION (OPPOSITE SIDE)**  
Scale: 3/16" = 1'-0"

ILLUMINATION	SIGN TYPE	SIGN FUNCTION	MOUNTING METHOD	GENERAL DESCRIPTION & USE
REFLECTIVE	5-ID.01	IDENTIFICATION	CEILING SUSPENDED	VEHICULAR - Ceiling Susp. Garage Area Boundary ID - Static

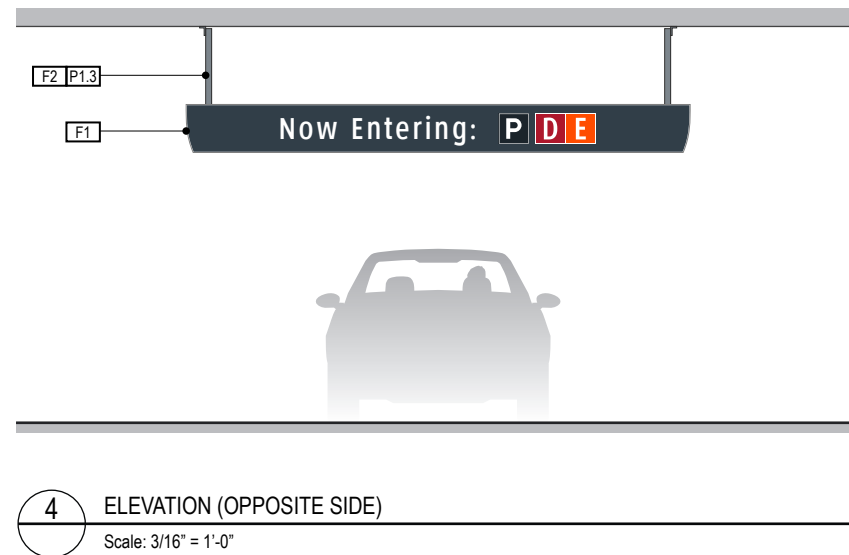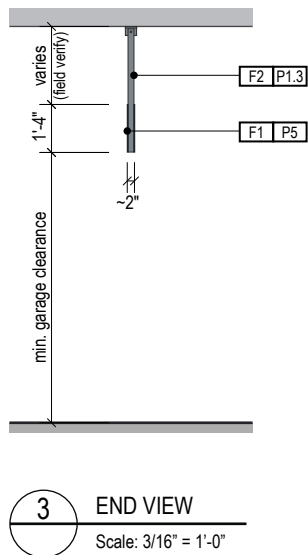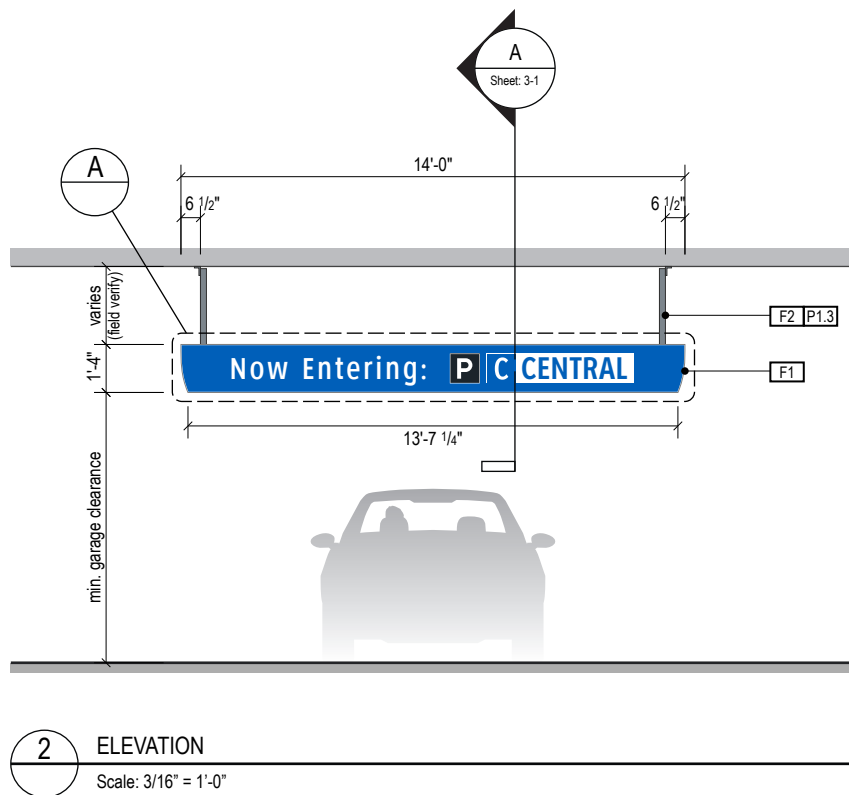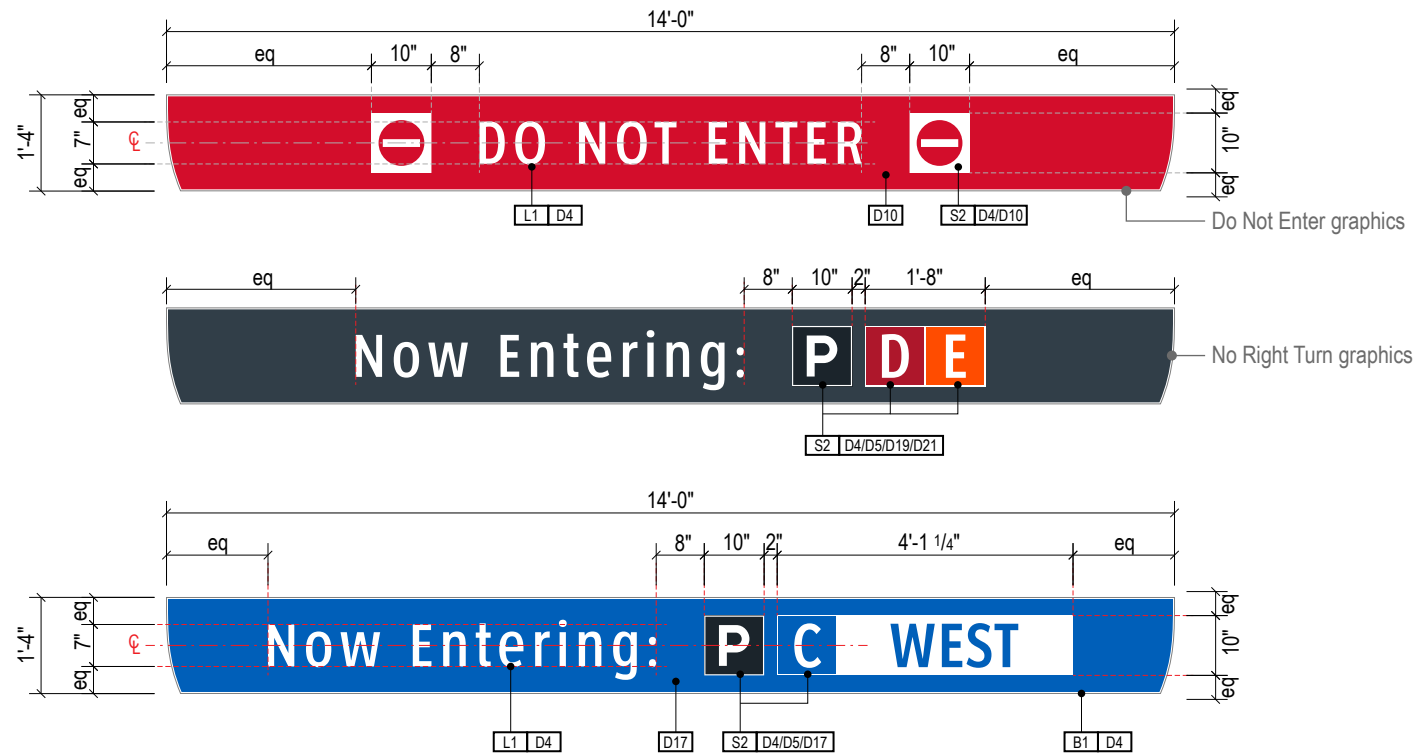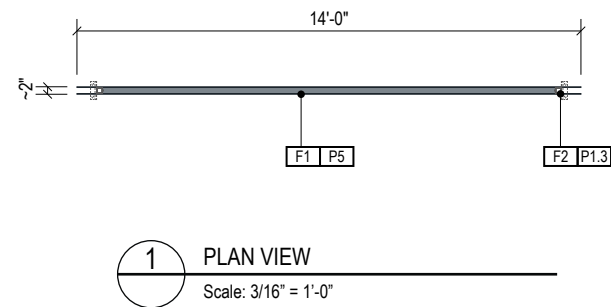

GENERAL NOTES

- All final design, engineering & amount/sizing of structural sign support elements, material types/thicknesses, dimensions and attachment methods shall be performed and approved by a licensed engineer to meet or exceed all applicable local and national codes.
- Final engineering, dimensions, materials and fabrication are the responsibility of the Contractor/Fabricator/Installer to ensure the highest quality fit and finish for all components of the completed product. All final detailing and specifications to be provided by the Contractor/Fabricator/Installer within their final approved fabrication-ready shop drawings.
- Wherever dissimilar metals are in contact, always separate contact surfaces prior to assembly or installation with the necessary protective coatings/gaskets/washers to prevent galvanic corrosion.
- Final fabrication methods, quality and fit/finish to be reviewed & approved by HAS and the Wayfinding Design Consultants thru prototype reviews prior to final production run/installation processes.
- Colors shown are for reference only, and are subject to the limitations of the printing process and/or variance of electronic RGB screen displays. Refer to color system swatches and approved finish samples for accurate reference.
- Messages shown here are typical placeholders only. See message schedules for specific messaging by location & sign type.

FABRICATION NOTES (GENERAL DESIGN INTENT)

- F1** SIGN FACE PANELS: 1/8" thk. alum. face panel w/ 1st surface full-bleed digitally printed color graphics on reflective 3M DG3 4090 white film; face panel mech. fastened to support frame w/ stainless steel screws, paint heads to match face; paint all exposed surfaces with satin MAP paint to match P5
- F2** SUPPORT FRAME/SUSPENSION: fabricated 2" square alum. support tube frame & vertical suspension tube structure; all exposed support frame tube ends to be capped with alum.; all welds on frame/caps to be filled & ground smooth for uniform appearance; suspension tubes mechanically attached to ceiling attachment hinge plates above; ceiling attachment plates to be mechanically fastened to garage's structural ceiling elements as req. w/ mech. fasteners (fabricator to field verify); support frame, suspension tubes & hinge plates to be painted all exposed surfaces with satin MAP paint to match P1.3

LETTERING (TYPEFACES) / SYMBOLS / ARROWS:

- L1** Vehicular Wayfinding Typeface: Clearview Highway 2-W
- L2** Vehicular Wayfinding Typeface: Clearview Highway 2-B
- L4** Vehicular Dynamic Numbers: Indect digital numbers
- L6** Supplemental Typeface: Clearview One Book Condensed
- S1** Arrow(s): use only official HAS wayfinding arrow art
- S2** Int'l Symbols: use only official HAS wayfinding symbol art
- B1** Sign Face Reflective White Border - 1/2" full-bleed border
- B2** Dynamic Unit White Border - border to match symbol field
- B3** Black Border - 1/2" full-bleed border

COLORS:

- NOTES: "D" = digitally printed colors as generated by 3M Picasso printer (or equal) on 3M Reflective DG3 4090 White unless otherwise noted; "P" = Matthews Acrylic Polyurethane (MAP) paint (or equal), satin finish; "V" = 3M vinyl films (or equal)
- D4** White: match C:0 M:0 Y:0 K:0
  - D5** Dark Gray: match PMS 433C **D6** Dk. Blue: match PMS 432C
  - D8** Light Gray: match PMS 427C
  - D9** Black: match C:50 M:40 Y:40 K:100
  - D11** Warning Yellow: match 3M Reflective DG3 4091 Yellow
  - D17** Blue: match PMS 300C **D18** Dk. Blue: match PMS 294C
  - D19** Red: match PMS 187C **D10** Safety Red: match PMS186C
  - D21** Orange: match PMS 1655C
  - D25** Exit Green: match C:90 M:15 Y:100 K:0
  - P1.3** Silver: MAP paint no. N951SP Med. Silver
  - P5** Dark Gray: MAP paint matched to PMS 433C
  - P17** Blue: MAP paint matched to PMS 300C
  - P19** Red: MAP paint matched to PMS 187C

Wayfinding Updates

Issue Date: 08-23-2024

Issue for Bid

- REV.
- REV.
- REV.

WARNING:

This record contains Sensitive Security Information that is controlled under 49 CFR parts 15 and 1520. No part of this record may be disclosed to persons with a "need to know," as defined in 49 CFR parts 15 and 1520, except with the written permission of the Administrator of the Transportation Security Administration or the Secretary of Transportation. Unauthorized release may result in civil penalty or other action. For U.S. government agencies, public disclosure is governed by 5 U.S.C. 552 and 49 CFR parts 15 and 1520.



THESE SHEETS ARE ISSUED FOR GRAPHICAL INFORMATION ONLY


08-23-2024

2.1 DESIGN INTENT - PARKING GARAGE: VEHICULAR SIGNS



BSG PRJCT# BSG-2024-111-IAH  
HAS TIP # 24 -103 - IAH

Sheet: 2-14


ILLUMINATION REFLECTIVE	SIGN TYPE 5-ID.06	SIGN FUNCTION IDENTIFICATION	MOUNTING METHOD CEILING SUSPENDED	GENERAL DESCRIPTION & USE VEHICULAR - Ceiling Susp. Ramp No Turn/Do Not Enter ID - Static
----------------------------	----------------------	---------------------------------	--------------------------------------	--

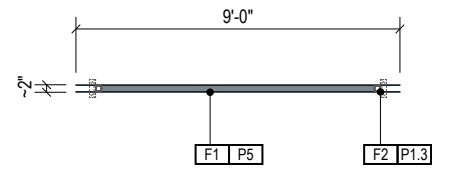


**1 PLAN VIEW**  
Scale: 3/16" = 1'-0"

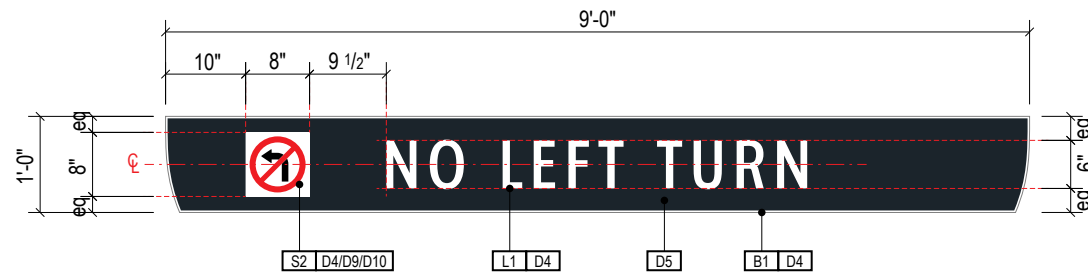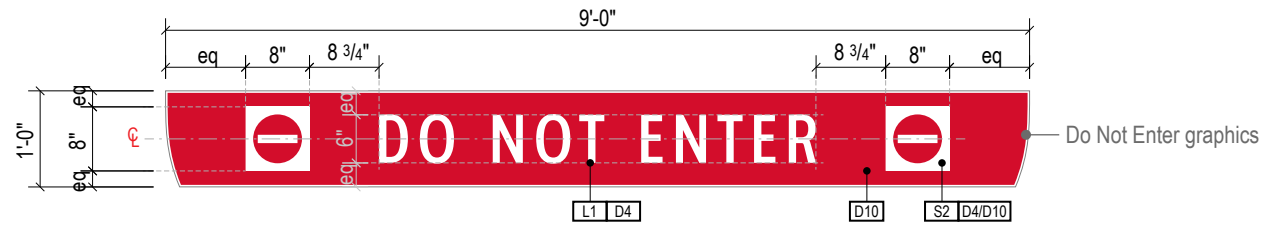


**A FACE LAYOUT**  
Scale: 1/2" = 1'-0"

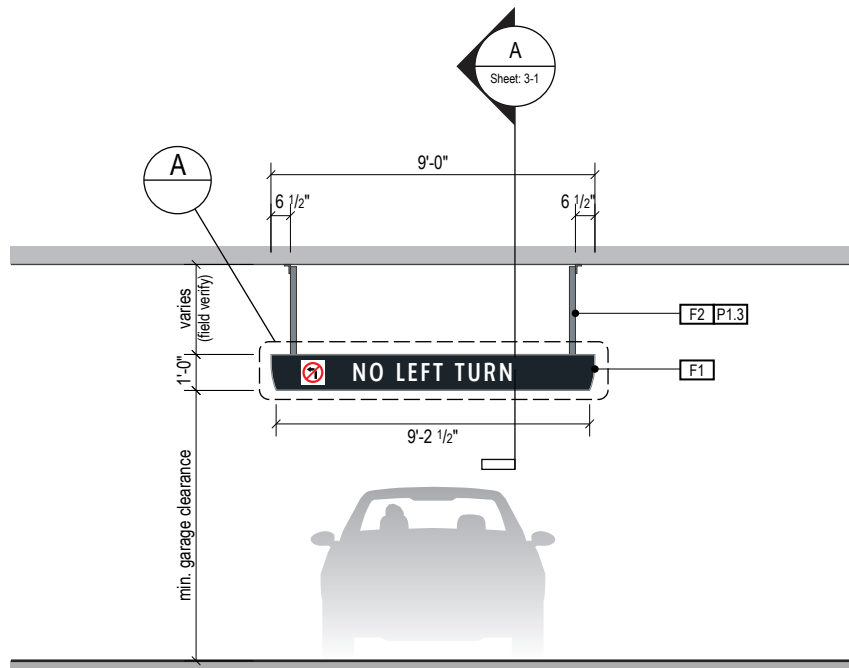

**2 ELEVATION**  
Scale: 3/16" = 1'-0"

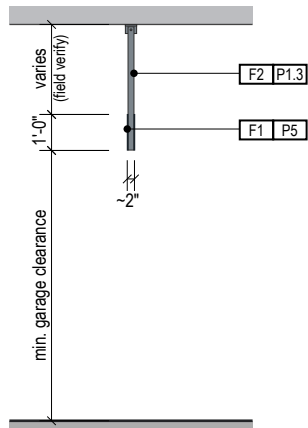

**3 END VIEW**  
Scale: 3/16" = 1'-0"

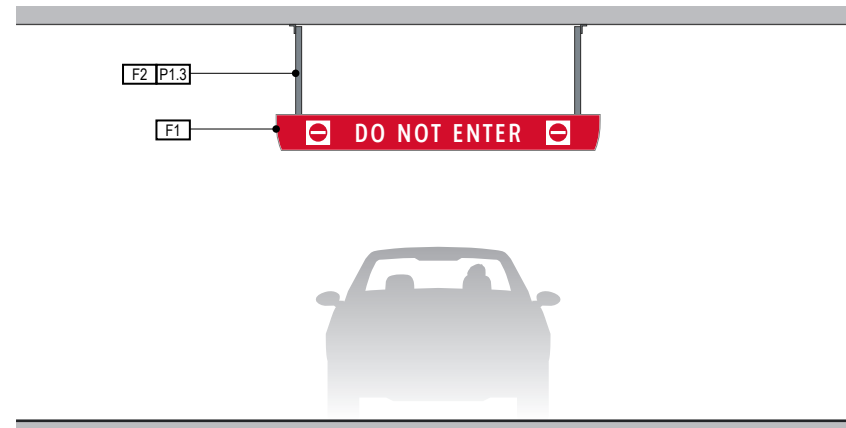

**4 ELEVATION (OPPOSITE SIDE)**  
Scale: 3/16" = 1'-0"

**GENERAL NOTES**

- All final design, engineering & amount/size of structural sign support elements, material types/thicknesses, dimensions and attachment methods shall be performed and approved by a licensed engineer to meet or exceed all applicable local and national codes.
- Final engineering, dimensions, materials and fabrication are the responsibility of the Contractor/Fabricator/Installer to ensure the highest quality fit and finish for all components of the completed product. All final detailing and specifications to be provided by the Contractor/Fabricator/Installer within their final approved fabrication-ready shop drawings.
- Wherever dissimilar metals are in contact, always separate contact surfaces prior to assembly or installation with the necessary protective coatings/gaskets/washers to prevent galvanic corrosion.
- Final fabrication methods, quality and fit/finish to be reviewed & approved by HAS and the Wayfinding Design Consultants thru prototype reviews prior to final production run/installation processes.
- Colors shown are for reference only, and are subject to the limitations of the printing process and/or variance of electronic RGB screen displays. Refer to color system swatches and approved finish samples for accurate reference.
- Messages shown here are typical placeholders only. See message schedules for specific messaging by location and sign type.

**FABRICATION NOTES (GENERAL DESIGN INTENT)**

- F1** SIGN FACE PANELS: 1/8" thk. alum. face panel w/ 1st surface full-bleed digitally printed color graphics on reflective 3M DG3 4090 white film; face panel mech. fastened to support frame w/ stainless steel screws, paint heads to match face; paint all exposed surfaces with satin MAP paint to match P5
- F2** SUPPORT FRAME/SUSPENSION: fabricated 2" square alum. support tube frame & vertical suspension tube structure; all exposed support frame tube ends to be capped with alum.; all welds on frame/caps to be filled & ground smooth for uniform appearance; suspension tubes mechanically attached to ceiling attachment hinge plates above; ceiling attachment plates to be mechanically fastened to garage's structural ceiling elements as req. w/ mech. fasteners (fabricator to field verify); support frame, suspension tubes & hinge plates to be painted all exposed surfaces with satin MAP paint to match P1.3

**LETTERING (TYPEFACES) / SYMBOLS / ARROWS:**

- L1** Vehicular Wayfinding Typeface: Clearview Highway 2-W
- L2** Vehicular Wayfinding Typeface: Clearview Highway 2-B
- L4** Vehicular Dynamic Numbers: Indect digital numbers
- L6** Supplemental Typeface: Clearview One Book Condensed
- S1** Arrow(s): use only official HAS wayfinding arrow art
- S2** Int'l Symbols: use only official HAS wayfinding symbol art
- B1** Sign Face Reflective White Border - 1/2" full-bleed border
- B2** Dynamic Unit White Border - border to match symbol field
- B3** Black Border - 1/2" full-bleed border

**COLORS:**

- NOTES: "D" = digitally printed colors as generated by 3M Picasso printer (or equal) on 3M Reflective DG3 4090 White unless otherwise noted; "P" = Matthews Acrylic Polyurethane (MAP) paint (or equal), satin finish; "V" = 3M vinyl films (or equal)
- D4** White: match C:0 M:0 Y:0 K:0
  - D5** Dark Gray: match PMS 433C **D6**: match PMS 432C
  - D8** Light Gray: match PMS 427C
  - D9** Black: match C:50 M:40 Y:40 K:100
  - D11** Warning Yellow: match 3M Reflective DG3 4091 Yellow
  - D17** Blue: match PMS 300C **D18** Dk. Blue: match PMS 294C
  - D19** Red: match PMS 187C **D10** Safety Red: match PMS186C
  - D21** Orange: match PMS 1655C
  - D25** Exit Green: match C:90 M:15 Y:100 K:0
  - P1.3** Silver: MAP paint no. N951SP Med. Silver
  - P5** Dark Gray: MAP paint matched to PMS 433C
  - P17** Blue: MAP paint matched to PMS 300C
  - P19** Red: MAP paint matched to PMS 187C

**Wayfinding Updates**

Issue Date: 08-23-2024

**Issue for Bid**

- REV.
- REV.
- REV.

**WARNING:**

This record contains Sensitive Security Information that is controlled under 49 CFR parts 15 and 1520. No part of this record may be disclosed to persons with a "need to know," as defined in 49 CFR parts 15 and 1520, except with the written permission of the Administrator of the Transportation Security Administration or the Secretary of Transportation. Unauthorized release may result in civil penalty or other action. For U.S. government agencies, public disclosure is governed by 5 U.S.C. 552 and 49 CFR parts 15 and 1520.



THESE SHEETS ARE ISSUED FOR GRAPHICAL INFORMATION ONLY

08-23-2024

**2.1 DESIGN INTENT - PARKING GARAGE: VEHICULAR SIGNS**

BSG PRJCT# BSG-2024-111-IAH  
HAS TIP # 24 -103 - IAH

Sheet: 2-15



ILLUMINATION	SIGN TYPE	SIGN FUNCTION	MOUNTING METHOD	GENERAL DESCRIPTION & USE
REFLECTIVE	5-ID.07	IDENTIFICATION	CEILING SUSPENDED	VEHICULAR - Ceiling Susp. Pedestrian Crossing Caution ID - Static

**GENERAL NOTES**

- All final design, engineering & amount/sizing of structural sign support elements, material types/thicknesses, dimensions and attachment methods shall be performed and approved by a licensed engineer to meet or exceed all applicable local and national codes.
- Final engineering, dimensions, materials and fabrication are the responsibility of the Contractor/Fabricator/Installer to ensure the highest quality fit and finish for all components of the completed product. All final detailing and specifications to be provided by the Contractor/Fabricator/Installer within their final approved fabrication-ready shop drawings.
- Wherever dissimilar metals are in contact, always separate contact surfaces prior to assembly or installation with the necessary protective coatings/gaskets/washers to prevent galvanic corrosion.
- Final fabrication methods, quality and fit/finish to be reviewed & approved by HAS and the Wayfinding Design Consultants thru prototype reviews prior to final production run/installation processes.
- Colors shown are for reference only, and are subject to the limitations of the printing process and/or variance of electronic RGB screen displays. Refer to color system swatches and approved finish samples for accurate reference.
- Messages shown here are typical placeholders only. See message schedules for specific messaging by location and sign type.

**FABRICATION NOTES (GENERAL DESIGN INTENT)**

- F1** SIGN FACE PANELS: 1/8" thk. alum. face panel w/ 1st surface full-bleed digitally printed color graphics on reflective 3M DG3 4090 white film; face panel mech. fastened to support frame w/ stainless steel screws, paint heads to match face; paint all exposed surfaces with satin MAP paint to match P5
- F2** SUPPORT FRAME/SUSPENSION: fabricated 2" square alum. support tube frame & vertical suspension tube structure; all exposed support frame tube ends to be capped with alum.; all welds on frame/caps to be filled & ground smooth for uniform appearance; suspension tubes mechanically attached to ceiling attachment hinge plates above; ceiling attachment plates to be mechanically fastened to garage's structural ceiling elements as req. w/ mech. fasteners (fabricator to field verify); support frame, suspension tubes & hinge plates to be painted all exposed surfaces with satin MAP paint to match P1.3

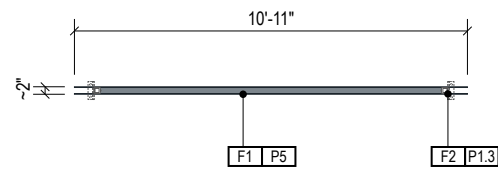
**LETTERING (TYPEFACES) / SYMBOLS / ARROWS:**

- L1** Vehicular Wayfinding Typeface: Clearview Highway 2-W
- L2** Vehicular Wayfinding Typeface: Clearview Highway 2-B
- L4** Vehicular Dynamic Numbers: Indect digital numbers
- L6** Supplemental Typeface: Clearview One Book Condensed
- S1** Arrow(s): use only official HAS wayfinding arrow art
- S2** Int'l Symbols: use only official HAS wayfinding symbol art
- B1** Sign Face Reflective White Border - 1/2" full-bleed border
- B2** Dynamic Unit White Border - border to match symbol field
- B3** Black Border - 1/2" full-bleed border


**COLORS:**

NOTES: "D" = digitally printed colors as generated by 3M Picasso printer (or equal) on 3M Reflective DG3 4090 White unless otherwise noted; "P" = Matthews Acrylic Polyurethane (MAP) paint (or equal), satin finish; "V" = 3M vinyl films (or equal)


- D4** White: match C:0 M:0 Y:0 K:0
- D5** Dark Gray: match PMS 433C **D6** : match PMS 432C
- D8** Light Gray: match PMS 427C
- D9** Black: match C:50 M:40 Y:40 K:100
- D11** Warning Yellow: match 3M Reflective DG3 4091 Yellow
- D17** Blue: match PMS 300C **D18** Dk. Blue: match PMS 294C
- D19** Red: match PMS 187C **D10** Safety Red: match PMS186C
- D21** Orange: match PMS 1655C
- D25** Exit Green: match C:90 M:15 Y:100 K:0
- P1.3** Silver: MAP paint no. N951SP Med. Silver
- P5** Dark Gray: MAP paint matched to PMS 433C
- P17** Blue: MAP paint matched to PMS 300C
- P19** Red: MAP paint matched to PMS 187C




**1 PLAN VIEW**  
Scale: 3/16" = 1'-0"

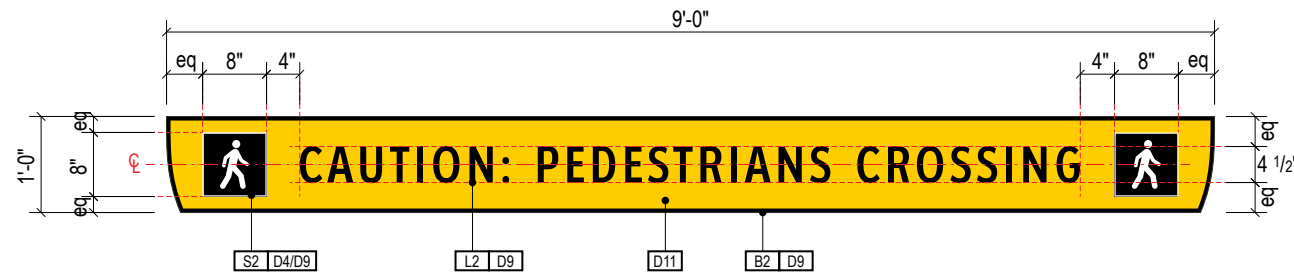


**A FACE LAYOUT**  
Scale: 1/2" = 1'-0"

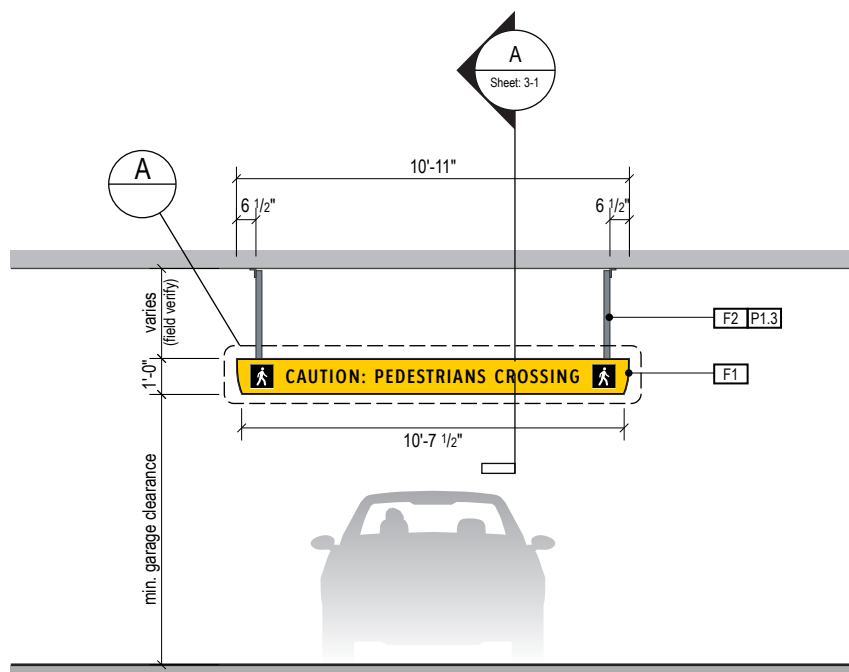

**2 ELEVATION**  
Scale: 3/16" = 1'-0"

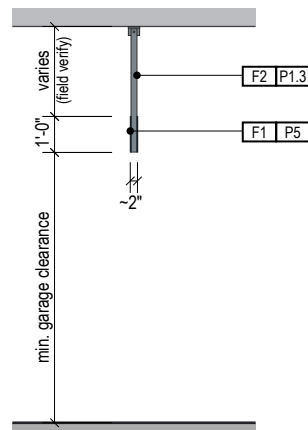

**3 END VIEW**  
Scale: 3/16" = 1'-0"

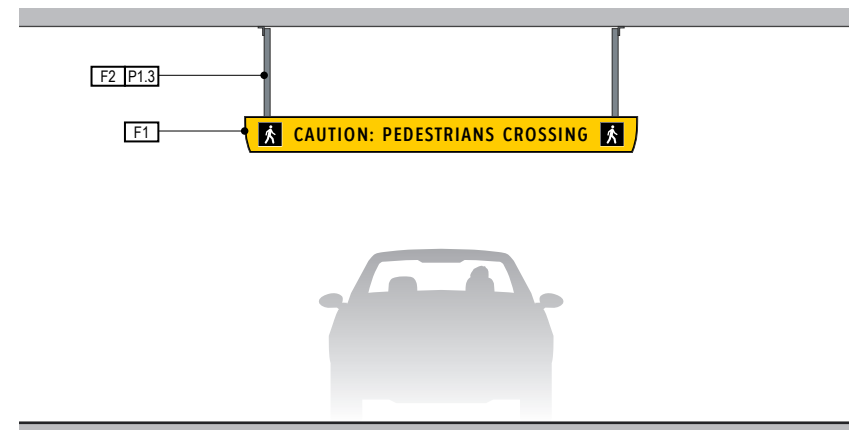

**4 ELEVATION (OPPOSITE SIDE)**  
Scale: 3/16" = 1'-0"

ILLUMINATION	SIGN TYPE	SIGN FUNCTION	MOUNTING METHOD	GENERAL DESCRIPTION & USE
NON-ILLUMINATED	5-DR.31	DIRECTIONAL	CEILING SUSPENDED	PEDESTRIAN - Ceiling Susp. C Terminal/Elevator Trailblazer - Static

**GENERAL NOTES**

- All final design, engineering & amount/sizing of structural sign support elements, material types/thicknesses, dimensions and attachment methods shall be performed and approved by a licensed engineer to meet or exceed all applicable local and national codes.
- Final engineering, dimensions, materials and fabrication are the responsibility of the Contractor/Fabricator/Installer to ensure the highest quality fit and finish for all components of the completed product. All final detailing and specifications to be provided by the Contractor/Fabricator/Installer within their final approved fabrication-ready shop drawings.
- Wherever dissimilar metals are in contact, always separate contact surfaces prior to assembly or installation with the necessary protective coatings/gaskets/washers to prevent galvanic corrosion.
- Final fabrication methods, quality and fit/finish to be reviewed & approved by HAS and the Wayfinding Design Consultants thru prototype reviews prior to final production run/installation processes.
- Colors shown are for reference only, and are subject to the limitations of the printing process and/or variance of electronic RGB screen displays. Refer to color system swatches and approved finish samples for accurate reference.
- Messages shown here are typical placeholders only. See message schedules for specific messaging by location & sign type.

**FABRICATION NOTES (GENERAL DESIGN INTENT)**

- F1** SIGN FACE PANELS: 1/8" thk. alum. face panel w/ 1st surface full-bleed digitally printed color graphics on matte 3M white film; face panel mech. fastened to support frame w/ stainless steel screws, paint heads to match face; paint all exposed surfaces with satin MAP paint to match P5
- F2** SUPPORT FRAME/SUSPENSION: fabricated 2" square alum. support tube frame & vertical suspension tube structure; all exposed support frame tube ends to be capped with alum.; all welds on frame/caps to be filled & ground smooth for uniform appearance; suspension tubes mechanically attached to ceiling attachment hinge plates above; ceiling attachment plates to be mechanically fastened to garage's structural ceiling elements as req. w/ mech. fasteners (fabricator to field verify); support frame, suspension tubes & hinge plates to be painted all exposed surfaces with satin MAP paint to match P1.3

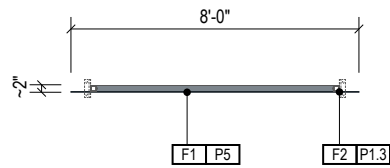
**LETTERING (TYPEFACES) / SYMBOLS / ARROWS:**

- L1** Vehicular Wayfinding Typeface: Clearview Highway 2-W
- L2** Vehicular Wayfinding Typeface: Clearview Highway 2-B
- L4** Vehicular Dynamic Numbers: Indect digital numbers
- L6** Supplemental Typeface: Clearview One Book Condensed
- S1** Arrow(s): use only official HAS wayfinding arrow art
- S2** Int'l Symbols: use only official HAS wayfinding symbol art
- B1** Sign Face Reflective White Border - 1/2" full-bleed border
- B2** Dynamic Unit White Border - border to match symbol field
- B3** Black Border - 1/2" full-bleed border


**COLORS:**

NOTES: "D" = digitally printed colors as generated by 3M Picasso printer (or equal) on 3M Reflective DG3 4090 White unless otherwise noted; "P" = Matthews Acrylic Polyurethane (MAP) paint (or equal), satin finish; "V" = 3M vinyl films (or equal)


- D4** White: match C:0 M:0 Y:0 K:0
- D5** Dark Gray: match PMS 433C **D6**: match PMS 432C
- D8** Light Gray: match PMS 427C
- D9** Black: match C:50 M:40 Y:40 K:100
- D11** Warning Yellow: match 3M Reflective DG3 4091 Yellow
- D17** Blue: match PMS 300C **D18** Dk. Blue: match PMS 294C
- D19** Red: match PMS 187C **D10** Safety Red: match PMS186C
- D21** Orange: match PMS 1655C
- D25** Exit Green: match C:90 M:15 Y:100 K:0
- P1.3** Silver: MAP paint no. N951SP Med. Silver
- P5** Dark Gray: MAP paint matched to PMS 433C
- P17** Blue: MAP paint matched to PMS 300C
- P19** Red: MAP paint matched to PMS 187C




**1 PLAN VIEW**  
Scale: 3/16" = 1'-0"

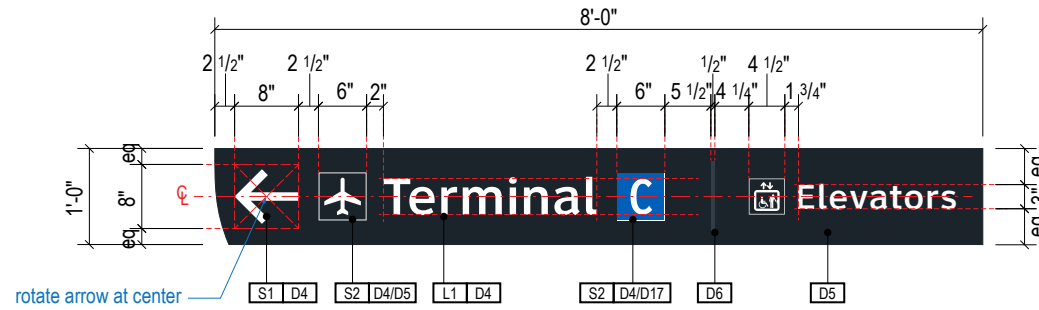


**A FACE LAYOUT**  
Scale: 1/2" = 1'-0"

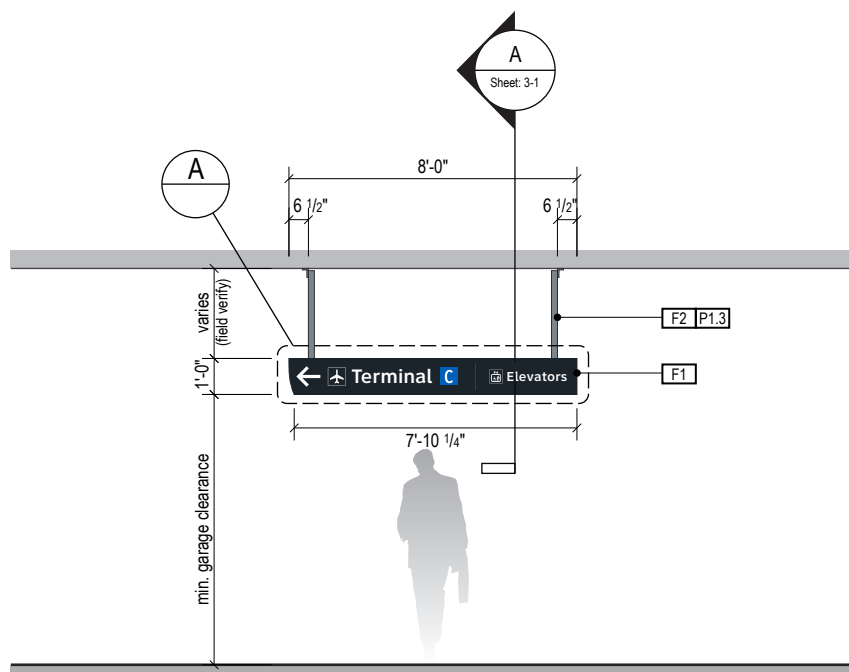

**2 ELEVATION**  
Scale: 3/16" = 1'-0"

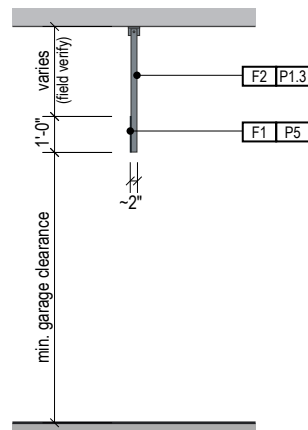

**3 END VIEW**  
Scale: 3/16" = 1'-0"

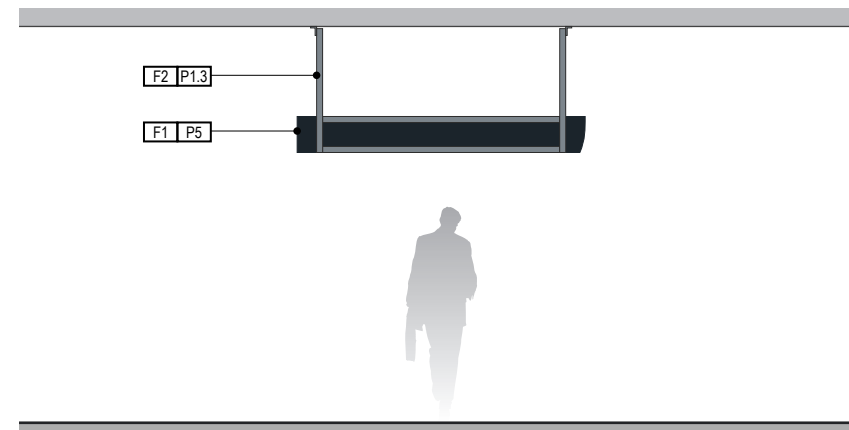

**4 ELEVATION (OPPOSITE SIDE)**  
Scale: 3/16" = 1'-0"

**Wayfinding Updates**

Issue Date: 08-23-2024

**Issue for Bid**

- REV.
- REV.
- REV.

**WARNING:**

This record contains Sensitive Security Information that is controlled under 49 CFR parts 15 and 1520. No part of this record may be disclosed to persons with a "need to know," as defined in 49 CFR parts 15 and 1520, except with the written permission of the Administrator of the Transportation Security Administration or the Secretary of Transportation. Unauthorized release may result in civil penalty or other action. For U.S. government agencies, public disclosure is governed by 5 U.S.C. 552 and 49 CFR parts 15 and 1520.



THESE SHEETS ARE ISSUED FOR GRAPHICAL INFORMATION ONLY

08-23-2024

**2.2 DESIGN INTENT - PARKING GARAGE: PEDESTRIAN SIGNS**

BSG PRJCT# BSG-2024-111-IAH  
HAS TIP # 24 -103 - IAH

Sheet: 2-17

ILLUMINATION	SIGN TYPE	SIGN FUNCTION	MOUNTING METHOD	GENERAL DESCRIPTION & USE
NON-ILLUMINATED	5-DR.31b	DIRECTIONAL	CEILING SUSPENDED	PEDESTRIAN - Ceiling Susp. DE Terminal/Elevator Trailblazer - Static

**GENERAL NOTES**

- All final design, engineering & amount/sizing of structural sign support elements, material types/thicknesses, dimensions and attachment methods shall be performed and approved by a licensed engineer to meet or exceed all applicable local and national codes.
- Final engineering, dimensions, materials and fabrication are the responsibility of the Contractor/Fabricator/Installer to ensure the highest quality fit and finish for all components of the completed product. All final detailing and specifications to be provided by the Contractor/Fabricator/Installer within their final approved fabrication-ready shop drawings.
- Wherever dissimilar metals are in contact, always separate contact surfaces prior to assembly or installation with the necessary protective coatings/gaskets/washers to prevent galvanic corrosion.
- Final fabrication methods, quality and fit/finish to be reviewed & approved by HAS and the Wayfinding Design Consultants thru prototype reviews prior to final production run/installation processes.
- Colors shown are for reference only, and are subject to the limitations of the printing process and/or variance of electronic RGB screen displays. Refer to color system swatches and approved finish samples for accurate reference.
- Messages shown here are typical placeholders only. See message schedules for specific messaging by location and sign type.

**FABRICATION NOTES (GENERAL DESIGN INTENT)**

- F1** SIGN FACE PANELS: 1/8" thk. alum. face panel w/ 1st surface full-bleed digitally printed color graphics on matte 3M white film; face panel mech. fastened to support frame w/ stainless steel screws, paint heads to match face; paint all exposed surfaces with satin MAP paint to match P5
- F2** SUPPORT FRAME/SUSPENSION: fabricated 2" square alum. support tube frame & vertical suspension tube structure; all exposed support frame tube ends to be capped with alum.; all welds on frame/caps to be filled & ground smooth for uniform appearance; suspension tubes mechanically attached to ceiling attachment hinge plates above; ceiling attachment plates to be mechanically fastened to garage's structural ceiling elements as req. w/ mech. fasteners (fabricator to field verify); support frame, suspension tubes & hinge plates to be painted all exposed surfaces with satin MAP paint to match P1.3

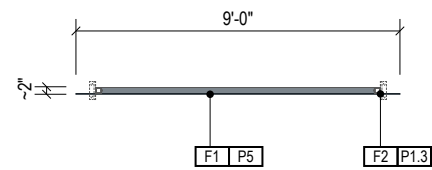
**LETTERING (TYPEFACES) / SYMBOLS / ARROWS:**

- L1** Vehicular Wayfinding Typeface: Clearview Highway 2-W
- L2** Vehicular Wayfinding Typeface: Clearview Highway 2-B
- L4** Vehicular Dynamic Numbers: Indect digital numbers
- L6** Supplemental Typeface: Clearview One Book Condensed
- S1** Arrow(s): use only official HAS wayfinding arrow art
- S2** Int'l Symbols: use only official HAS wayfinding symbol art
- B1** Sign Face Reflective White Border - 1/2" full-bleed border
- B2** Dynamic Unit White Border - border to match symbol field
- B3** Black Border - 1/2" full-bleed border


**COLORS:**

NOTES: "D" = digitally printed colors as generated by 3M Picasso printer (or equal) on 3M Reflective DG3 4090 White unless otherwise noted; "P" = Matthews Acrylic Polyurethane (MAP) paint (or equal), satin finish; "V" = 3M vinyl films (or equal)


- D4** White: match C:0 M:0 Y:0 K:0
- D5** Dark Gray: match PMS 433C **D6**: match PMS 432C
- D8** Light Gray: match PMS 427C
- D9** Black: match C:50 M:40 Y:40 K:100
- D11** Warning Yellow: match 3M Reflective DG3 4091 Yellow
- D17** Blue: match PMS 300C **D18** Dk. Blue: match PMS 294C
- D19** Red: match PMS 187C **D10** Safety Red: match PMS186C
- D21** Orange: match PMS 1655C
- D25** Exit Green: match C:90 M:15 Y:100 K:0
- P1.3** Silver: MAP paint no. N951SP Med. Silver
- P5** Dark Gray: MAP paint matched to PMS 433C
- P17** Blue: MAP paint matched to PMS 300C
- P19** Red: MAP paint matched to PMS 187C




**1 PLAN VIEW**  
Scale: 3/16" = 1'-0"

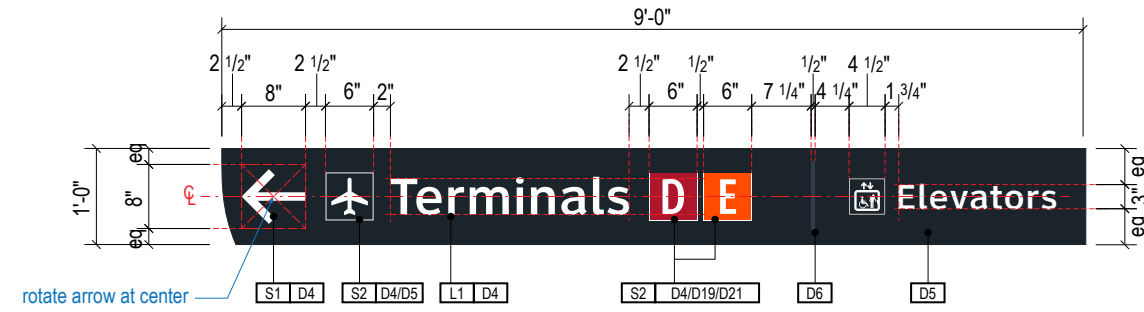


**A FACE LAYOUT**  
Scale: 1/2" = 1'-0"

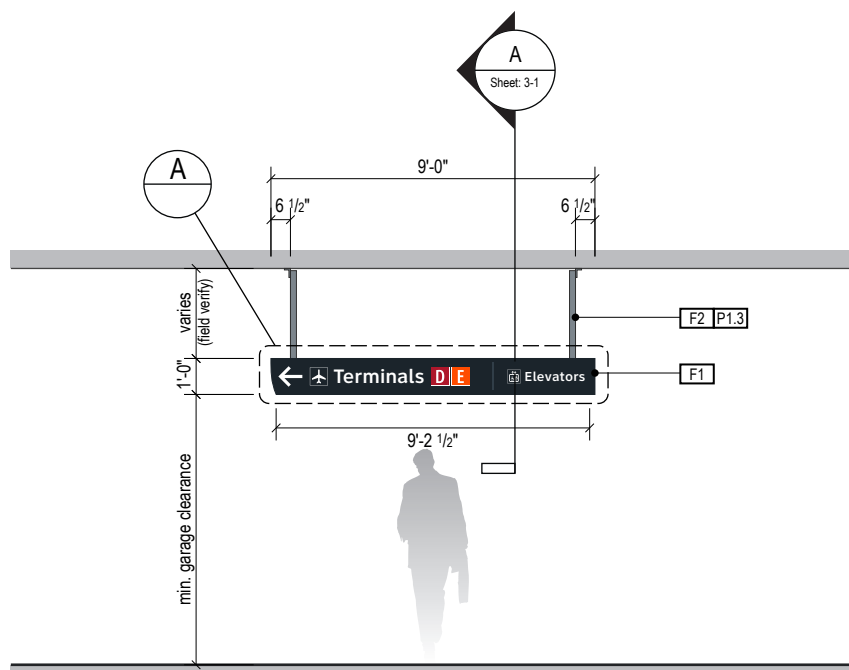

**2 ELEVATION**  
Scale: 3/16" = 1'-0"

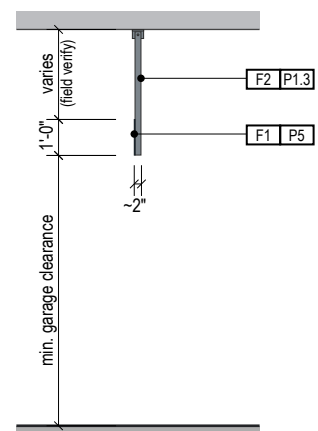

**3 END VIEW**  
Scale: 3/16" = 1'-0"

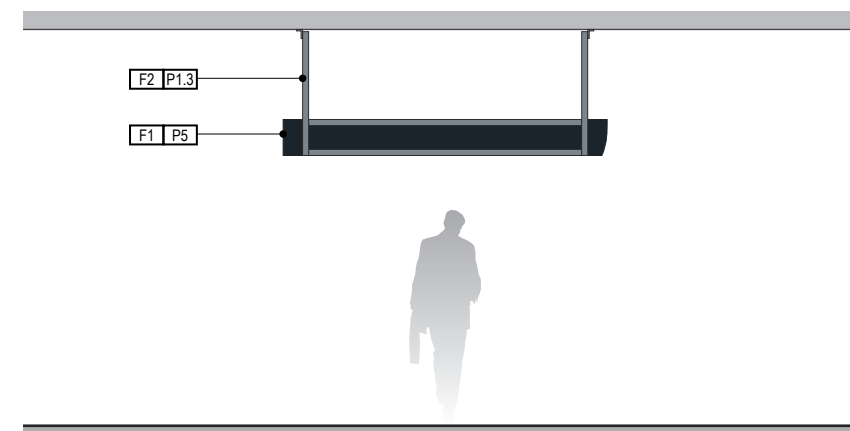

**4 ELEVATION (OPPOSITE SIDE)**  
Scale: 3/16" = 1'-0"

ILLUMINATION	SIGN TYPE	SIGN FUNCTION	MOUNTING METHOD	GENERAL DESCRIPTION & USE
NON-ILLUMINATED	5-DR.34	DIRECTIONAL	CEILING SUSPENDED	PEDESTRIAN - Ceiling Susp. Garage ID/Section Multi-way Directional - Static

**GENERAL NOTES**

- All final design, engineering & amount/sizing of structural sign support elements, material types/thicknesses, dimensions and attachment methods shall be performed and approved by a licensed engineer to meet or exceed all applicable local and national codes.
- Final engineering, dimensions, materials and fabrication are the responsibility of the Contractor/Fabricator/Installer to ensure the highest quality fit and finish for all components of the completed product. All final detailing and specifications to be provided by the Contractor/Fabricator/Installer within their final approved fabrication-ready shop drawings.
- Wherever dissimilar metals are in contact, always separate contact surfaces prior to assembly or installation with the necessary protective coatings/gaskets/washers to prevent galvanic corrosion.
- Final fabrication methods, quality and fit/finish to be reviewed & approved by HAS and the Wayfinding Design Consultants thru prototype reviews prior to final production run/installation processes.
- Colors shown are for reference only, and are subject to the limitations of the printing process and/or variance of electronic RGB screen displays. Refer to color system swatches and approved finish samples for accurate reference.
- Messages shown here are typical placeholders only. See message schedules for specific messaging by location & sign type.

**FABRICATION NOTES (GENERAL DESIGN INTENT)**

- F1** SIGN FACE PANELS: 1/8" thk. alum. face panel w/ 1st surface full-bleed digitally printed color graphics on matte 3M white film; face panel mech. fastened to support frame w/ stainless steel screws, paint heads to match face; paint all exposed surfaces with satin MAP paint to match P5
- F2** SUPPORT FRAME/SUSPENSION: fabricated 2" square alum. support tube frame & vertical suspension tube structure; all exposed support frame tube ends to be capped with alum.; all welds on frame/caps to be filled & ground smooth for uniform appearance; suspension tubes mechanically attached to ceiling attachment hinge plates above; ceiling attachment plates to be mechanically fastened to garage's structural ceiling elements as req. w/ mech. fasteners (fabricator to field verify); support frame, suspension tubes & hinge plates to be painted all exposed surfaces with satin MAP paint to match P1.3

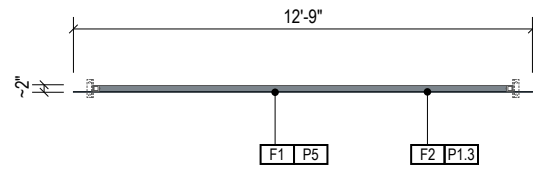
**LETTERING (TYPEFACES) / SYMBOLS / ARROWS:**

- L1** Vehicular Wayfinding Typeface: Clearview Highway 2-W
- L2** Vehicular Wayfinding Typeface: Clearview Highway 2-B
- L4** Vehicular Dynamic Numbers: Indect digital numbers
- L6** Supplemental Typeface: Clearview One Book Condensed
- S1** Arrow(s): use only official HAS wayfinding arrow art
- S2** Int'l Symbols: use only official HAS wayfinding symbol art
- B1** Sign Face Reflective White Border - 1/2" full-bleed border
- B2** Dynamic Unit White Border - border to match symbol field
- B3** Black Border - 1/2" full-bleed border


**COLORS:**

NOTES: "D" = digitally printed colors as generated by 3M Picasso printer (or equal) on 3M Reflective DG3 4090 White unless otherwise noted; "P" = Matthews Acrylic Polyurethane (MAP) paint (or equal), satin finish; "V" = 3M vinyl films (or equal)


- D4** White: match C:0 M:0 Y:0 K:0
- D5** Dark Gray: match PMS 433C **D6** Dk. Blue: match PMS 432C
- D8** Light Gray: match PMS 427C
- D9** Black: match C:50 M:40 Y:40 K:100
- D11** Warning Yellow: match 3M Reflective DG3 4091 Yellow
- D17** Blue: match PMS 300C **D18** Dk. Blue: match PMS 294C
- D19** Red: match PMS 187C **D10** Safety Red: match PMS186C
- D25** Orange: match PMS 1655C
- D25** Exit Green: match C:90 M:15 Y:100 K:0
- P1.3** Silver: MAP paint no. N951SP Med. Silver
- P5** Dark Gray: MAP paint matched to PMS 433C
- P17** Blue: MAP paint matched to PMS 300C
- P19** Red: MAP paint matched to PMS 187C




**1 PLAN VIEW**  
Scale: 3/16" = 1'-0"

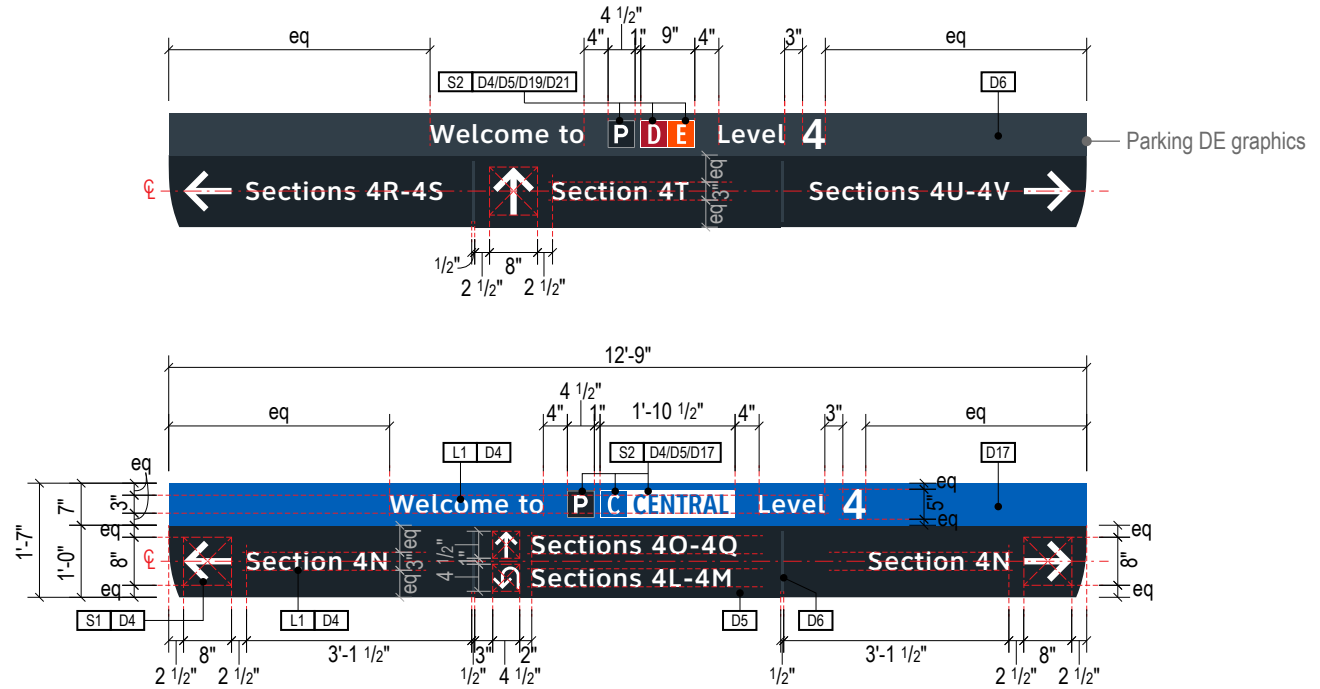


**A FACE LAYOUT**  
Scale: 1/2" = 1'-0"

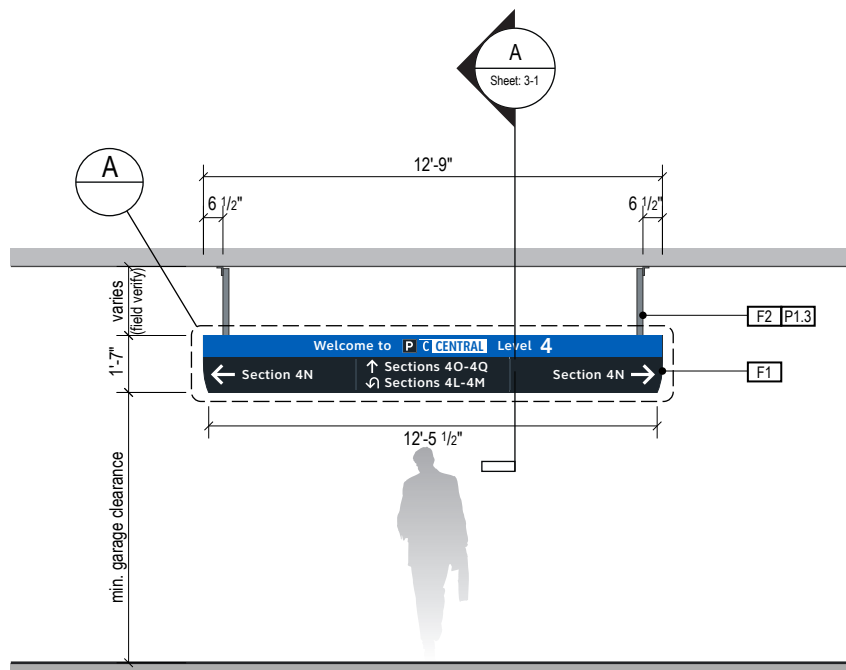

**2 ELEVATION**  
Scale: 3/16" = 1'-0"

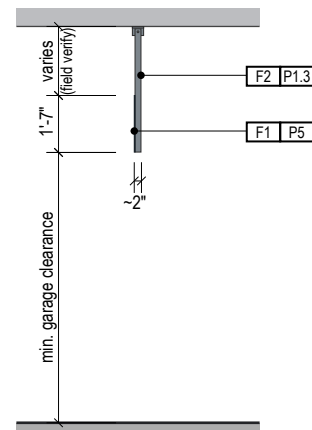

**3 END VIEW**  
Scale: 3/16" = 1'-0"

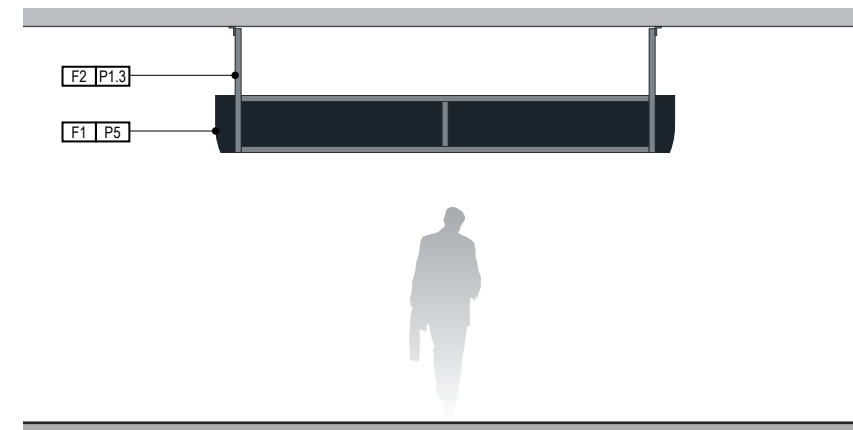

**4 ELEVATION (OPPOSITE SIDE)**  
Scale: 3/16" = 1'-0"

ILLUMINATION REFLECTIVE	SIGN TYPE 5-DR.41b	SIGN FUNCTION IDENTIFICATION	MOUNTING METHOD LIGHT POST MOUNT	GENERAL DESCRIPTION & USE PEDESTRIAN - Light Post Mount Parking Section/Garage ID
----------------------------	-----------------------	---------------------------------	-------------------------------------	--

GENERAL NOTES

- All final design, engineering & amount/sizing of structural sign support elements, material types/thicknesses, dimensions and attachment methods shall be performed and approved by a licensed engineer to meet or exceed all applicable local and national codes.
- Final engineering, dimensions, materials and fabrication are the responsibility of the Contractor/Fabricator/Installer to ensure the highest quality fit and finish for all components of the completed product. All final detailing and specifications to be provided by the Contractor/Fabricator/Installer within their final approved fabrication-ready shop drawings.
- Wherever dissimilar metals are in contact, always separate contact surfaces prior to assembly or installation with the necessary protective coatings/gaskets/washers to prevent galvanic corrosion.
- Final fabrication methods, quality and fit/finish to be reviewed & approved by HAS and the Wayfinding Design Consultants thru prototype reviews prior to final production run/installation processes.
- Colors shown are for reference only, and are subject to the limitations of the printing process and/or variance of electronic RGB screen displays. Refer to color system swatches and approved finish samples for accurate reference.
- Messages shown here are typical placeholders only. See message schedules for specific messaging by location & sign type.

FABRICATION NOTES (GENERAL DESIGN INTENT)

- F1** SIGN FACE PANELS: 1/8" thk. alum. face panel w/ full-bleed digitally printed color graphics on 3M 3290 Engineer Grade white reflective, mech. fastened to support frame; fabricated 1" square alum. tube support frame/post(s) painted all exposed surfaces with satin MAP paint to match P7
- F2** MOUNTING: mech. fastened/strapped onto existing light post as req'd existing suspension/mounting hardware to be specified/sized by engineer to accommodate additional wind loads & weight of new sign panels/support frames (fabricator and engineer to field verify existing conditions prior to final fabrication and installation of new sign panels)
- F3** EXISTING LIGHT POST: existing light post, fabricator and engineer to field verify existing light post conditions at all installation locations

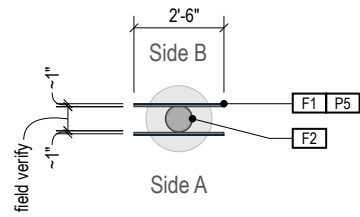
LETTERING (TYPEFACES) / SYMBOLS / ARROWS:

- L1** Vehicular Wayfinding Typeface: Clearview Highway 2-W
- L2** Vehicular Wayfinding Typeface: Clearview Highway 2-B
- L4** Vehicular Dynamic Numbers: Indect digital numbers
- L6** Supplemental Typeface: Clearview One Book Condensed
- S1** Arrow(s): use only official HAS wayfinding arrow art
- S2** Int'l Symbols: use only official HAS wayfinding symbol art
- B1** Sign Face Reflective White Border - 1/2" full-bleed border
- B2** Dynamic Unit White Border - border to match symbol field
- B3** Black Border - 1/2" full-bleed border


COLORS:

NOTES: "D" = digitally printed colors as generated by 3M Picasso printer (or equal) on 3M Reflective DG3 4090 White unless otherwise noted; "P" = Matthews Acrylic Polyurethane (MAP) paint (or equal), satin finish; "V" = 3M vinyl films (or equal)


- D4** White: match C:0 M:0 Y:0 K:0
- D5** Dark Gray: match PMS 433C **D6** : match PMS 432C
- D8** Light Gray: match PMS 427C
- D9** Black: match C:50 M:40 Y:40 K:100
- D11** Warning Yellow: match 3M Reflective DG3 4091 Yellow
- D17** Blue: match PMS 300C **D18** Dk. Blue: match PMS 294C
- D19** Red: match PMS 187C **D10** Safety Red: match PMS186C
- D21** Orange: match PMS 1655C
- D25** Exit Green: match C:90 M:15 Y:100 K:0
- P1.3** Silver: MAP paint no. N951SP Med. Silver
- P5** Dark Gray: MAP paint matched to PMS 433C
- P17** Blue: MAP paint matched to PMS 300C
- P19** Red: MAP paint matched to PMS 187C




**1** PLAN VIEW  
Scale: 3/16" = 1'-0"

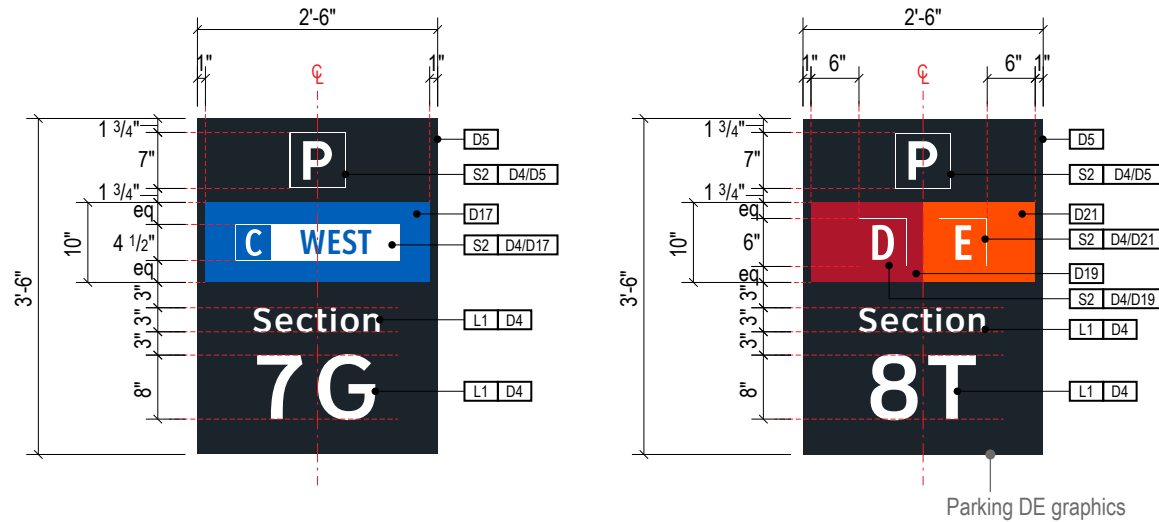


**A** FACE LAYOUT  
Scale: 1/2" = 1'-0"

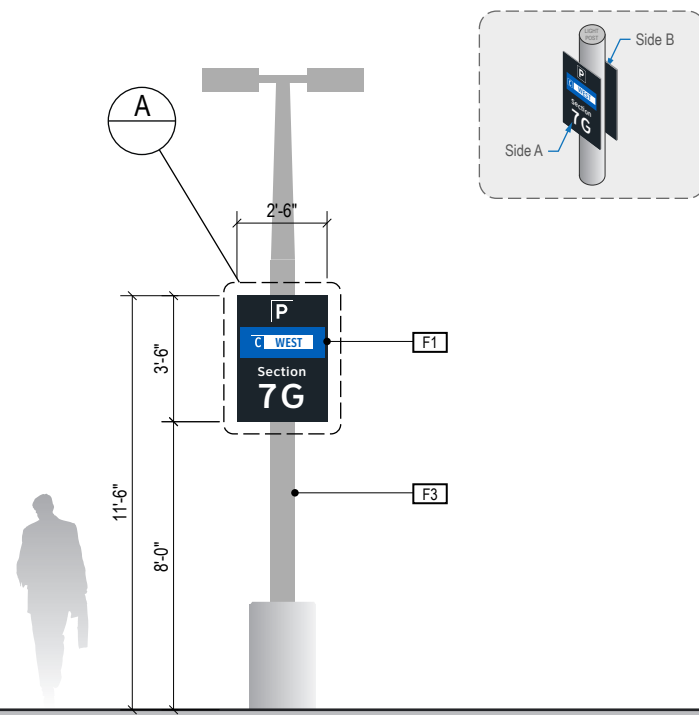

**2** ELEVATION  
Scale: 3/16" = 1'-0"

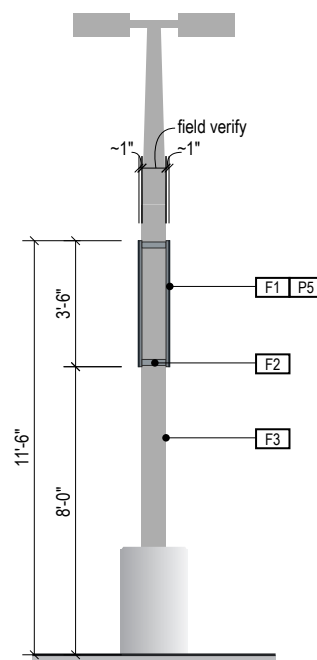

**3** END VIEW  
Scale: 3/16" = 1'-0"

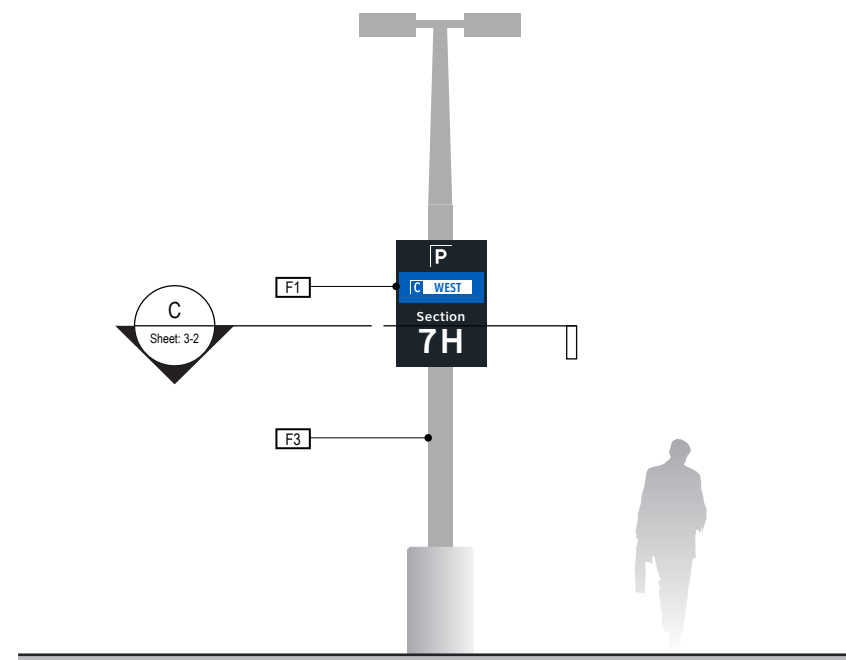

**4** ELEVATION (OPPOSITE SIDE)  
Scale: 3/16" = 1'-0"

ILLUMINATION	SIGN TYPE	SIGN FUNCTION	MOUNTING METHOD	GENERAL DESCRIPTION & USE
REFLECTIVE	5-DR.43	IDENTIFICATION	POST/BOLLARD MOUNT	PEDESTRIAN - Post/Bollard Mount Parking Section/Garage ID

**GENERAL NOTES**

- All final design, engineering & amount/size of structural sign support elements, material types/thicknesses, dimensions and attachment methods shall be performed and approved by a licensed engineer to meet or exceed all applicable local and national codes.
- Final engineering, dimensions, materials and fabrication are the responsibility of the Contractor/Fabricator/Installer to ensure the highest quality fit and finish for all components of the completed product. All final detailing and specifications to be provided by the Contractor/Fabricator/Installer within their final approved fabrication-ready shop drawings.
- Wherever dissimilar metals are in contact, always separate contact surfaces prior to assembly or installation with the necessary protective coatings/gaskets/washers to prevent galvanic corrosion.
- Final fabrication methods, quality and fit/finish to be reviewed & approved by HAS and the Wayfinding Design Consultants thru prototype reviews prior to final production run/installation processes.
- Colors shown are for reference only, and are subject to the limitations of the printing process and/or variance of electronic RGB screen displays. Refer to color system swatches and approved finish samples for accurate reference.
- Messages shown here are typical placeholders only. See message schedules for specific messaging by location & sign type.

**FABRICATION NOTES (GENERAL DESIGN INTENT)**

- F1** SIGN FACE PANELS: 1/8" thk. alum. face panel w/ full-bleed digitally printed color graphics on 3M 3290 Engineer Grade white reflective, mech. fastened to support post; painted all exposed surfaces with satin MAP paint to match P5
- F2** SUPPORT BRACKET: face panel(s) mech. fastened onto support bracket & post as req'd, mounting fasteners/hardware to be specified/sized by engineer to accommodate wind loads & weight of sign panels
- F3** SUPPORT POST: fabricated square alum. vertical support post structure; all support post ends to be capped with alum.; all welds on to be filled & ground smooth for uniform appearance; support post base plate mechanically attached to bollard/ground/decking as req'd (fabricator to field verify & get engineering support/buy-off prior to fabrication/installation); use break-away base connection if/as code requires; support bracket/post/base to be painted all exposed surfaces with satin MAP paint to match P7
- F4** BOLLARD: concrete bollard for protection of sign post(s) as and where req'd; fabricator and engineer to field verify installation location conditions and provide design and buy-off for each location prior to final fabrication and installation

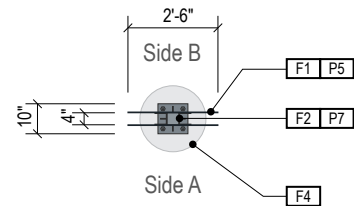
**LETTERING (TYPEFACES) / SYMBOLS / ARROWS:**

- L1** Vehicular Wayfinding Typeface: Clearview Highway 2-W
- L2** Vehicular Wayfinding Typeface: Clearview Highway 2-B
- L4** Vehicular Dynamic Numbers: Indect digital numbers
- L6** Supplemental Typeface: Clearview One Book Condensed
- S1** Arrow(s): use only official HAS wayfinding arrow art
- S2** Int'l Symbols: use only official HAS wayfinding symbol art
- B1** Sign Face Reflective White Border - 1/2" full-bleed border
- B2** Dynamic Unit White Border - border to match symbol field
- B3** Black Border - 1/2" full-bleed border


**COLORS:**

NOTES: "D" = digitally printed colors as generated by 3M Picasso printer (or equal) on 3M Reflective DG3 4090 White unless otherwise noted; "P" = Matthews Acrylic Polyurethane (MAP) paint (or equal), satin finish; "V" = 3M vinyl films (or equal)


- D4** White: match C:0 M:0 Y:0 K:0
- D5** Dark Gray: match PMS 433C **D6** : match PMS 432C
- D8** Light Gray: match PMS 427C
- D9** Black: match C:50 M:40 Y:40 K:100
- D11** Warning Yellow: match 3M Reflective DG3 4091 Yellow
- D17** Blue: match PMS 300C **D18** Dk. Blue: match PMS 294C
- D19** Red: match PMS 187C **D10** Safety Red: match PMS186C
- D25** Exit Green: match C:90 M:15 Y:100 K:0
- P1.3** Silver: MAP paint no. N951SP Med. Silver
- P5** Dark Gray: MAP paint matched to PMS 433C
- P17** Blue: MAP paint matched to PMS 300C
- P19** Red: MAP paint matched to PMS 187C




**1 PLAN VIEW**  
Scale: 3/16" = 1'-0"

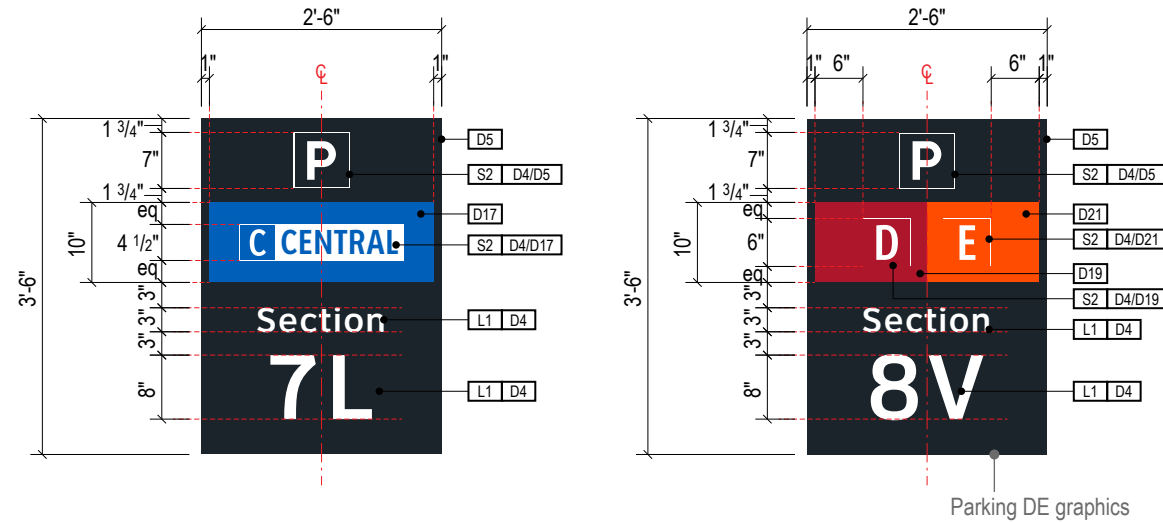


**A FACE LAYOUT**  
Scale: 1/2" = 1'-0"

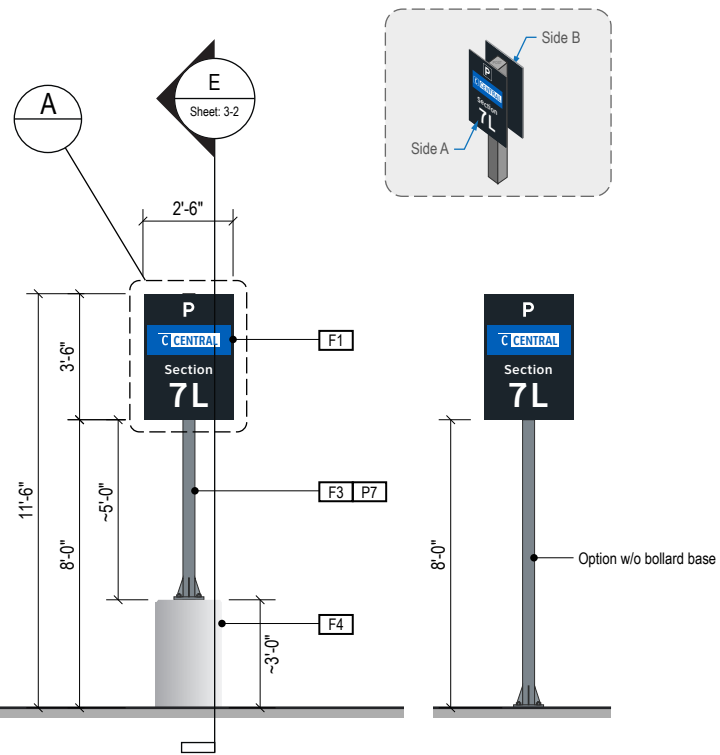

**2 ELEVATION**  
Scale: 3/16" = 1'-0"

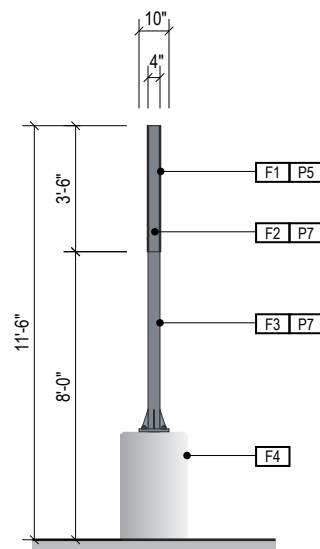

**3 END VIEW**  
Scale: 3/16" = 1'-0"

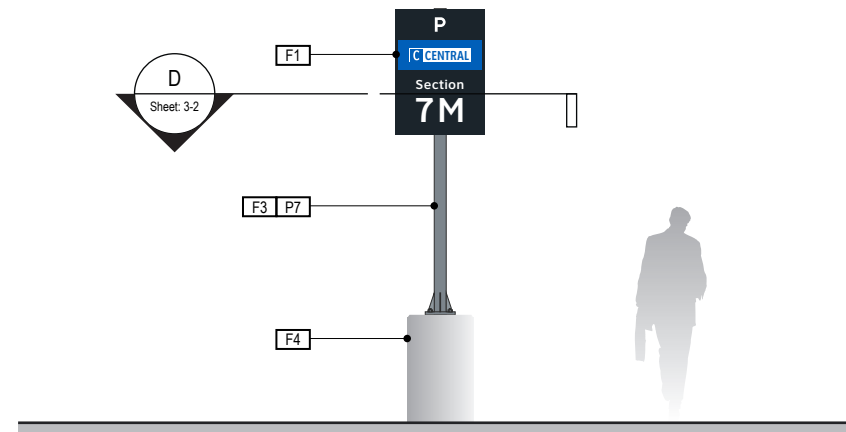

**4 ELEVATION (OPPOSITE SIDE)**  
Scale: 3/16" = 1'-0"

**Wayfinding Updates**

Issue Date: 08-23-2024  
Issue for Bid

- REV.
- REV.
- REV.

**WARNING:**

This record contains Sensitive Security Information that is controlled under 49 CFR parts 15 and 1520. No part of this record may be disclosed to persons with a "need to know," as defined in 49 CFR parts 15 and 1520, except with the written permission of the Administrator of the Transportation Security Administration or the Secretary of Transportation. Unauthorized release may result in civil penalty or other action. For U.S. government agencies, public disclosure is governed by 5 U.S.C. 552 and 49 CFR parts 15 and 1520.



THESE SHEETS ARE ISSUED FOR GRAPHICAL INFORMATION ONLY

08-23-2024

**2.2 DESIGN INTENT - PARKING GARAGE: PEDESTRIAN SIGNS**

BSG PRJCT# BSG-2024-111-IAH  
HAS TIP # 24 -103 - IAH

Sheet: 2-21

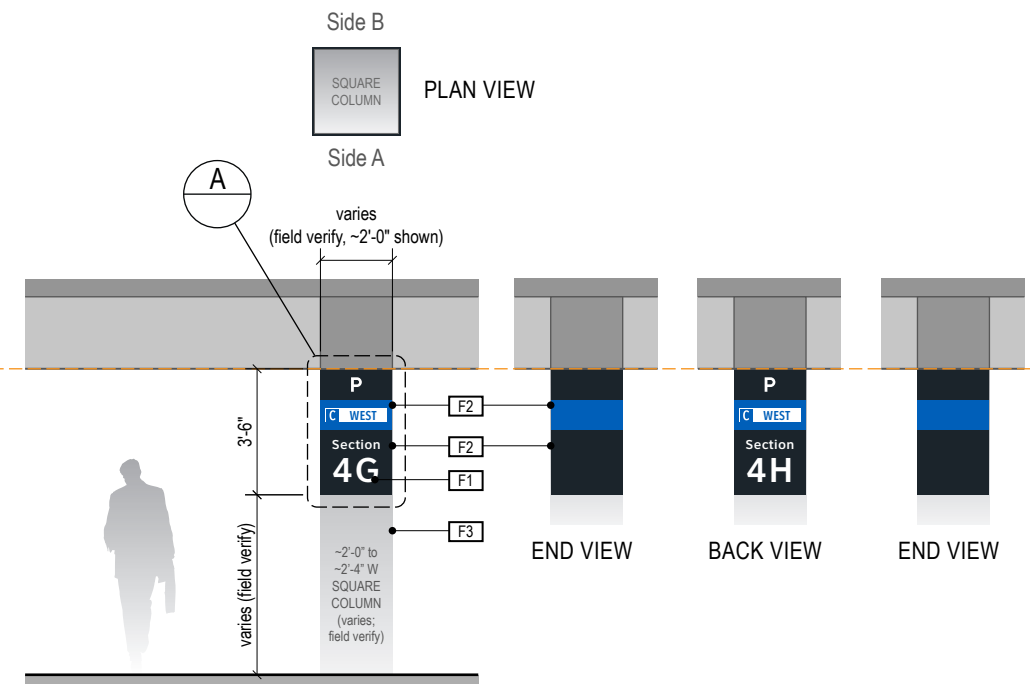
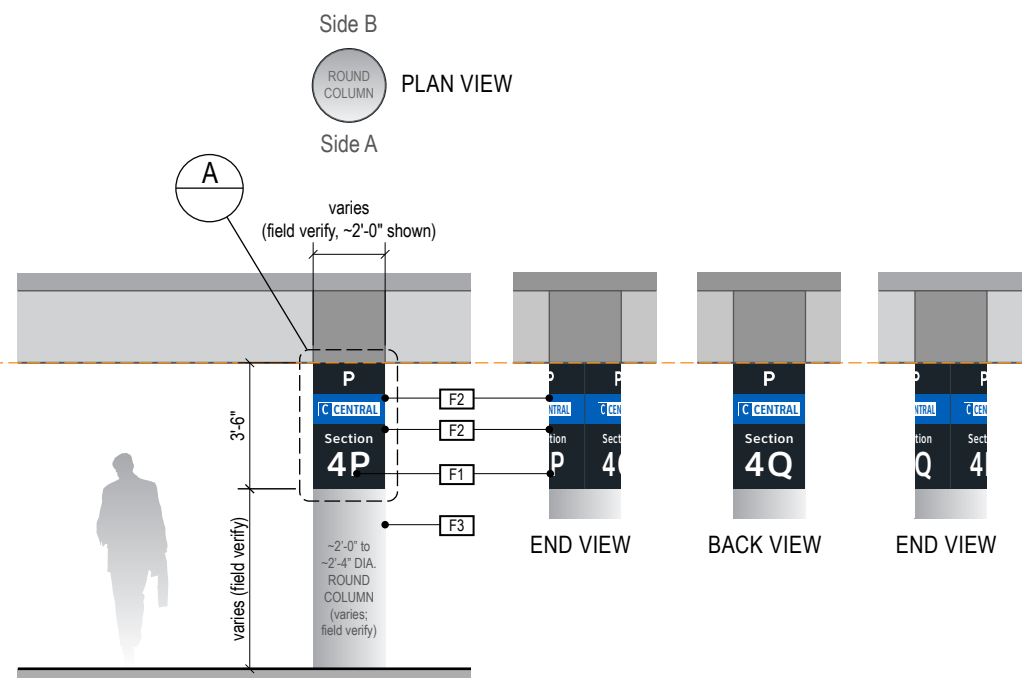
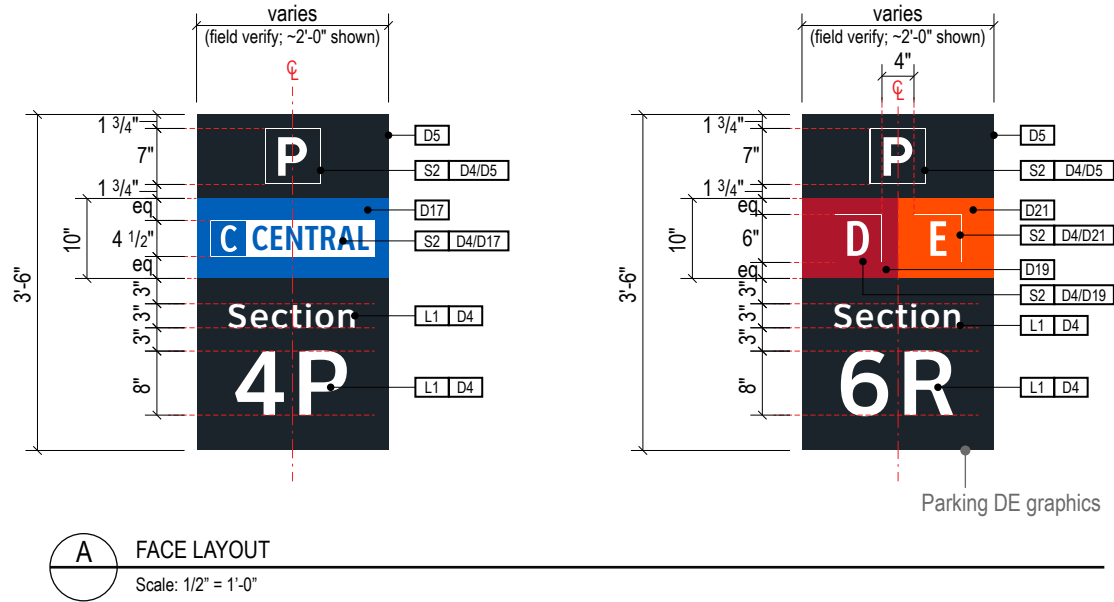
ILLUMINATION	SIGN TYPE	SIGN FUNCTION	MOUNTING METHOD	GENERAL DESCRIPTION & USE
REFLECTIVE	5-ID.52 & 5-ID.53	IDENTIFICATION	COLUMN-WRAP	PEDESTRIAN - Single Column-Wrap Parking Section/Garage ID

**GENERAL NOTES**

- All final design, engineering & amount/size of structural sign support elements, material types/thicknesses, dimensions and attachment methods shall be performed and approved by a licensed engineer to meet or exceed all applicable local and national codes.
- Final engineering, dimensions, materials and fabrication are the responsibility of the Contractor/Fabricator/Installer to ensure the highest quality fit and finish for all components of the completed product. All final detailing and specifications to be provided by the Contractor/Fabricator/Installer within their final approved fabrication-ready shop drawings.
- Wherever dissimilar metals are in contact, always separate contact surfaces prior to assembly or installation with the necessary protective coatings/gaskets/washers to prevent galvanic corrosion.
- Final fabrication methods, quality and fit/finish to be reviewed & approved by HAS and the Wayfinding Design Consultants thru prototype reviews prior to final production run/installation processes.
- Colors shown are for reference only, and are subject to the limitations of the printing process and/or variance of electronic RGB screen displays. Refer to color system swatches and approved finish samples for accurate reference.
- Messages shown here are typical placeholders only. See message schedules for specific messaging by location & sign type.

**FABRICATION NOTES (GENERAL DESIGN INTENT)**

- F1** GRAPHICS: letter/numbers to be 3M 3290 Engineer Grade white reflective cut vinyl applied directly to painted column surface
- F2** BACKGROUND COLOR-WRAP AREAS: background color-wrap areas to be satin paint directly on existing garage column; fabricator to field verify all installation locations and touch-up/primer/seal column surfaces as req'd prior to painting; NOTE: all existing/old/previous column painted areas and locations to be removed by fabricator
- F3** EXISTING COLUMNS: existing concrete columns vary in size and shape per garage area and location; fabricator to field verify all installation locations prior to final fabrication and installation



**LETTERING (TYPEFACES) / SYMBOLS / ARROWS:**

- L1** Vehicular Wayfinding Typeface: Clearview Highway 2-W
- L2** Vehicular Wayfinding Typeface: Clearview Highway 2-B
- L4** Vehicular Dynamic Numbers: Indect digital numbers
- L6** Supplemental Typeface: Clearview One Book Condensed
- S1** Arrow(s): use only official HAS wayfinding arrow art
- S2** Int'l Symbols: use only official HAS wayfinding symbol art
- B1** Sign Face Reflective White Border - 1/2" full-bleed border
- B2** Dynamic Unit White Border - border to match symbol field
- B3** Black Border - 1/2" full-bleed border

**COLORS:**

- NOTES: "D" = digitally printed colors as generated by 3M Picasso printer (or equal) on 3M Reflective DG3 4090 White unless otherwise noted; "P" = Matthews Acrylic Polyurethane (MAP) paint (or equal), satin finish; "V" = 3M vinyl films (or equal)
- D4** White: match C:0 M:0 Y:0 K:0
  - D5** Dark Gray: match PMS 433C **D6** Dk. Blue: match PMS 432C
  - D8** Light Gray: match PMS 427C
  - D9** Black: match C:50 M:40 Y:40 K:100
  - D11** Warning Yellow: match 3M Reflective DG3 4091 Yellow
  - D17** Blue: match PMS 300C **D18** Dk. Blue: match PMS 294C
  - D19** Red: match PMS 187C **D10** Safety Red: match PMS186C
  - D25** Exit Green: match C:90 M:15 Y:100 K:0
  - P1.3** Silver: MAP paint no. N951SP Med. Silver
  - P5** Dark Gray: MAP paint matched to PMS 433C
  - P17** Blue: MAP paint matched to PMS 300C
  - P19** Red: MAP paint matched to PMS 187C

**Wayfinding Updates**

Issue Date: 08-23-2024  
Issue for Bid

- REV.
- REV.
- REV.

**WARNING:**

This record contains Sensitive Security Information that is controlled under 49 CFR parts 15 and 1520. No part of this record may be disclosed to persons with a "need to know," as defined in 49 CFR parts 15 and 1520, except with the written permission of the Administrator of the Transportation Security Administration or the Secretary of Transportation. Unauthorized release may result in civil penalty or other action. For U.S. government agencies, public disclosure is governed by 5 U.S.C. 552 and 49 CFR parts 15 and 1520.



THESE SHEETS ARE ISSUED FOR GRAPHICAL INFORMATION ONLY

08-23-2024

**2.2 DESIGN INTENT - PARKING GARAGE: PEDESTRIAN SIGNS**

BSG PRJCT# BSG-2024-111-IAH  
HAS TIP # 24 -103 - IAH

Sheet: 2-22

ILLUMINATION	SIGN TYPE	SIGN FUNCTION	MOUNTING METHOD	GENERAL DESCRIPTION & USE
NON-ILLUMINATED	5-ID.55	IDENTIFICATION	WALL MOUNT	PEDESTRIAN - Wall Mount Stair Entrance ID

GENERAL NOTES

- All final design, engineering & amount/sizing of structural sign support elements, material types/thicknesses, dimensions and attachment methods shall be performed and approved by a licensed engineer to meet or exceed all applicable local and national codes.
- Final engineering, dimensions, materials and fabrication are the responsibility of the Contractor/Fabricator/Installer to ensure the highest quality fit and finish for all components of the completed product. All final detailing and specifications to be provided by the Contractor/Fabricator/Installer within their final approved fabrication-ready shop drawings.
- Wherever dissimilar metals are in contact, always separate contact surfaces prior to assembly or installation with the necessary protective coatings/gaskets/washers to prevent galvanic corrosion.
- Final fabrication methods, quality and fit/finish to be reviewed & approved by HAS and the Wayfinding Design Consultants thru prototype reviews prior to final production run/installation processes.
- Colors shown are for reference only, and are subject to the limitations of the printing process and/or variance of electronic RGB screen displays. Refer to color system swatches and approved finish samples for accurate reference.
- Messages shown here are typical placeholders only. See message schedules for specific messaging by location & sign type.

FABRICATION NOTES (GENERAL DESIGN INTENT)

- F1** SIGN FACE PANEL: 1/8" thk. alum. face panel w/ 1st surface full-bleed digitally printed color graphics on matte 3M white film; ease all sharp edges; face panel mech. fastened to wall as req'd

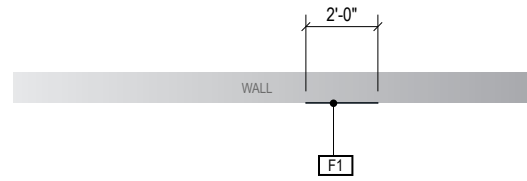
LETTERING (TYPEFACES) / SYMBOLS / ARROWS:

- L1** Vehicular Wayfinding Typeface: Clearview Highway 2-W
- L2** Vehicular Wayfinding Typeface: Clearview Highway 2-B
- L4** Vehicular Dynamic Numbers: Indect digital numbers
- L6** Supplemental Typeface: Clearview One Book Condensed
- S1** Arrow(s): use only official HAS wayfinding arrow art
- S2** Int'l Symbols: use only official HAS wayfinding symbol art
- B1** Sign Face Reflective White Border - 1/2" full-bleed border
- B2** Dynamic Unit White Border - border to match symbol field
- B3** Black Border - 1/2" full-bleed border


COLORS:

NOTES: "D" = digitally printed colors as generated by 3M Picasso printer (or equal) on 3M Reflective DG3 4090 White unless otherwise noted; "P" = Matthews Acrylic Polyurethane (MAP) paint (or equal), satin finish; "V" = 3M vinyl films (or equal)


- D4** White: match C:0 M:0 Y:0 K:0
- D5** Dark Gray: match PMS 433C **D6** Dk. Blue: match PMS 432C
- D8** Light Gray: match PMS 427C
- D9** Black: match C:50 M:40 Y:40 K:100
- D11** Warning Yellow: match 3M Reflective DG3 4091 Yellow
- D17** Blue: match PMS 300C **D18** Dk. Blue: match PMS 294C
- D19** Red: match PMS 187C **D10** Safety Red: match PMS186C
- D21** Orange: match PMS 1655C
- D25** Exit Green: match C:90 M:15 Y:100 K:0
- P1.3** Silver: MAP paint no. N951SP Med. Silver
- P5** Dark Gray: MAP paint matched to PMS 433C
- P17** Blue: MAP paint matched to PMS 300C
- P19** Red: MAP paint matched to PMS 187C




**1** PLAN VIEW  
Scale: 3/16" = 1'-0"

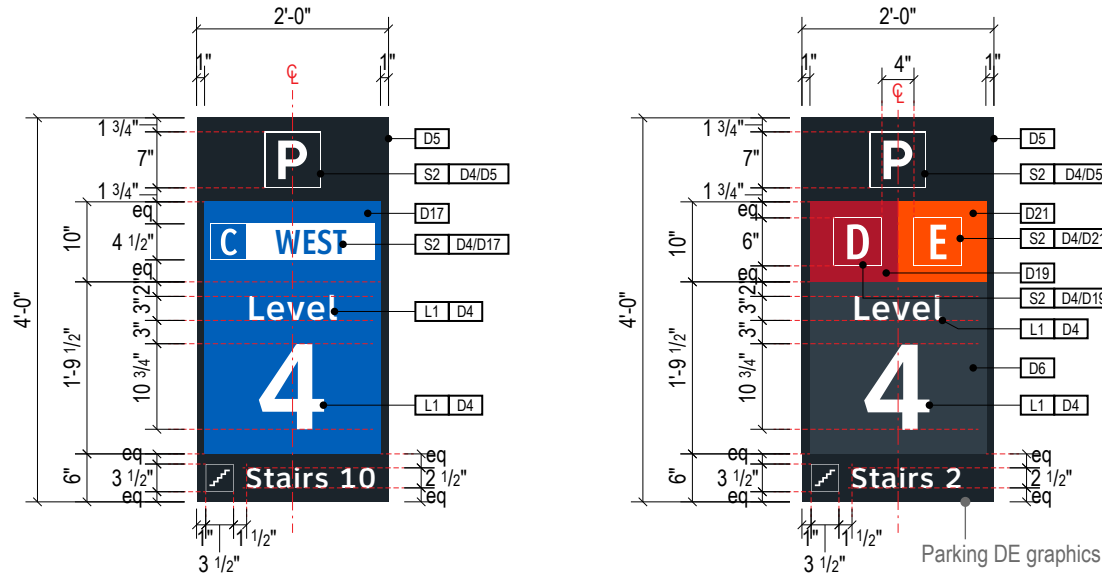

**A** FACE LAYOUT  
Scale: 1/2" = 1'-0"

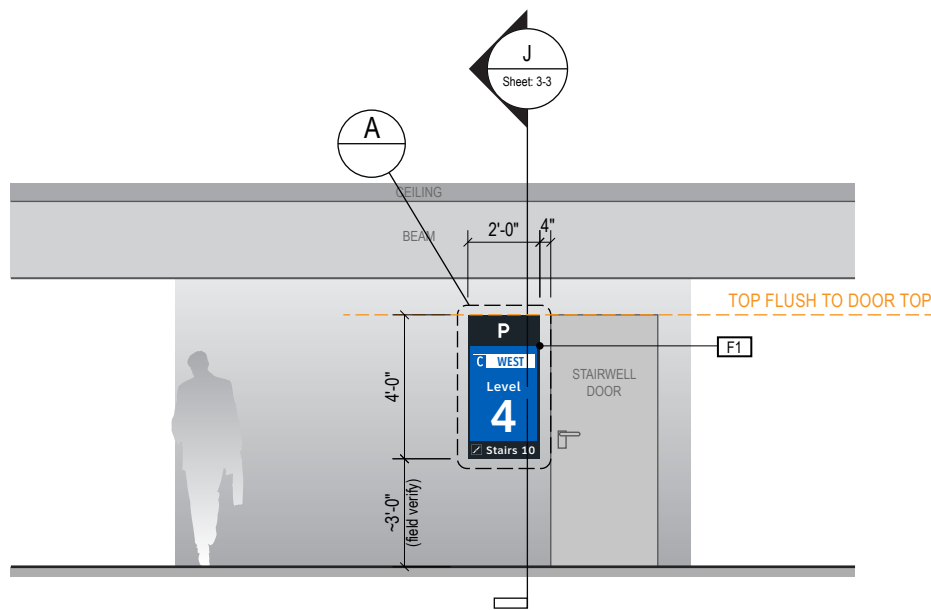

**2** ELEVATION  
Scale: 3/16" = 1'-0"

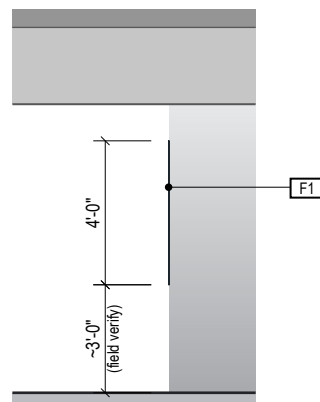

**3** END VIEW  
Scale: 3/16" = 1'-0"

Wayfinding Updates

Issue Date: 08-23-2024  
Issue for Bid

- REV.
- REV.
- REV.

WARNING:

This record contains Sensitive Security Information that is controlled under 49 CFR parts 15 and 1520. No part of this record may be disclosed to persons with a "need to know," as defined in 49 CFR parts 15 and 1520, except with the written permission of the Administrator of the Transportation Security Administration or the Secretary of Transportation. Unauthorized release may result in civil penalty or other action. For U.S. government agencies, public disclosure is governed by 5 U.S.C. 552 and 49 CFR parts 15 and 1520.



THESE SHEETS ARE ISSUED FOR GRAPHICAL INFORMATION ONLY

08-23-2024

2.2 DESIGN INTENT - PARKING GARAGE: PEDESTRIAN SIGNS

BSG PRJCT# BSG-2024-111-IAH  
HAS TIP # 24 -103 - IAH

Sheet: 2-23



ILLUMINATION NON-ILLUMINATED	SIGN TYPE 5-ID.56 & 5-ID.57	SIGN FUNCTION IDENTIFICATION	MOUNTING METHOD WALL MOUNT	GENERAL DESCRIPTION & USE PEDESTRIAN - Wall Mount Elevator Garage/Level ID & ID Band Graphics
---------------------------------	--------------------------------	---------------------------------	-------------------------------	--

GENERAL NOTES

- All final design, engineering & amount/sizing of structural sign support elements, material types/thicknesses, dimensions and attachment methods shall be performed and approved by a licensed engineer to meet or exceed all applicable local and national codes.
- Final engineering, dimensions, materials and fabrication are the responsibility of the Contractor/Fabricator/Installer to ensure the highest quality fit and finish for all components of the completed product. All final detailing and specifications to be provided by the Contractor/Fabricator/Installer within their final approved fabrication-ready shop drawings.
- Wherever dissimilar metals are in contact, always separate contact surfaces prior to assembly or installation with the necessary protective coatings/gaskets/washers to prevent galvanic corrosion.
- Final fabrication methods, quality and fit/finish to be reviewed & approved by HAS and the Wayfinding Design Consultants thru prototype reviews prior to final production run/installation processes.
- Colors shown are for reference only, and are subject to the limitations of the printing process and/or variance of electronic RGB screen displays. Refer to color system swatches and approved finish samples for accurate reference.
- Messages shown here are typical placeholders only. See message schedules for specific messaging by location and sign type.

FABRICATION NOTES (GENERAL DESIGN INTENT)

- F1** SIGN FACE PANEL: 1/8" thk. alum. face panel w/ 1st surface full-bleed digitally printed color graphics on matte 3M white film; ease all sharp edges; face panel mech. fastened to wall as req'd
- F2** HEADER ID GRAPHICS: Satin paint on existing wall, touch-up/fill/primer/seal wall surfaces as req'd prior to painting; graphics to be full-bleed digitally printed color graphics on 3M 3290 Engineer Grade white reflective cut vinyl applied directly to wall surface (or alum. panel painted w/ MAP satin paint to match P5) as req'd per install location conditions

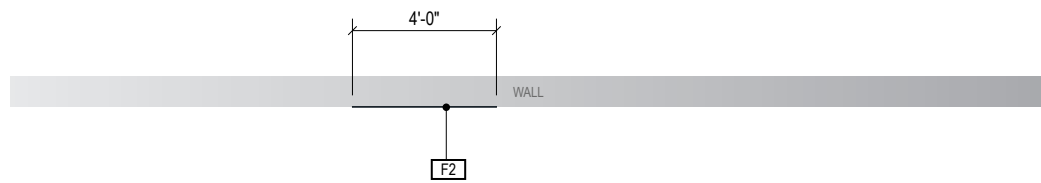
LETTERING (TYPEFACES) / SYMBOLS / ARROWS:

- L1** Vehicular Wayfinding Typeface: Clearview Highway 2-W
- L2** Vehicular Wayfinding Typeface: Clearview Highway 2-B
- L4** Vehicular Dynamic Numbers: Indect digital numbers
- L6** Supplemental Typeface: Clearview One Book Condensed
- S1** Arrow(s): use only official HAS wayfinding arrow art
- S2** Int'l Symbols: use only official HAS wayfinding symbol art
- B1** Sign Face Reflective White Border - 1/2" full-bleed border
- B2** Dynamic Unit White Border - border to match symbol field
- B3** Black Border - 1/2" full-bleed border


COLORS:

NOTES: "D" = digitally printed colors as generated by 3M Picasso printer (or equal) on 3M Reflective DG3 4090 White unless otherwise noted; "P" = Matthews Acrylic Polyurethane (MAP) paint (or equal), satin finish; "V" = 3M vinyl films (or equal)


- D4** White: match C:0 M:0 Y:0 K:0
- D5** Dark Gray: match PMS 433C **D6**: match PMS 432C
- D8** Light Gray: match PMS 427C
- D9** Black: match C:50 M:40 Y:40 K:100
- D11** Warning Yellow: match 3M Reflective DG3 4091 Yellow
- D17** Blue: match PMS 300C **D18** Dk. Blue: match PMS 294C
- D19** Red: match PMS 187C **D10** Safety Red: match PMS186C
- D25** Exit Green: match C:90 M:15 Y:100 K:0
- P1.3** Silver: MAP paint no. N951SP Med. Silver
- P5** Dark Gray: MAP paint matched to PMS 433C
- P17** Blue: MAP paint matched to PMS 300C
- P19** Red: MAP paint matched to PMS 187C




**1** PLAN VIEW  
Scale: 3/16" = 1'-0"

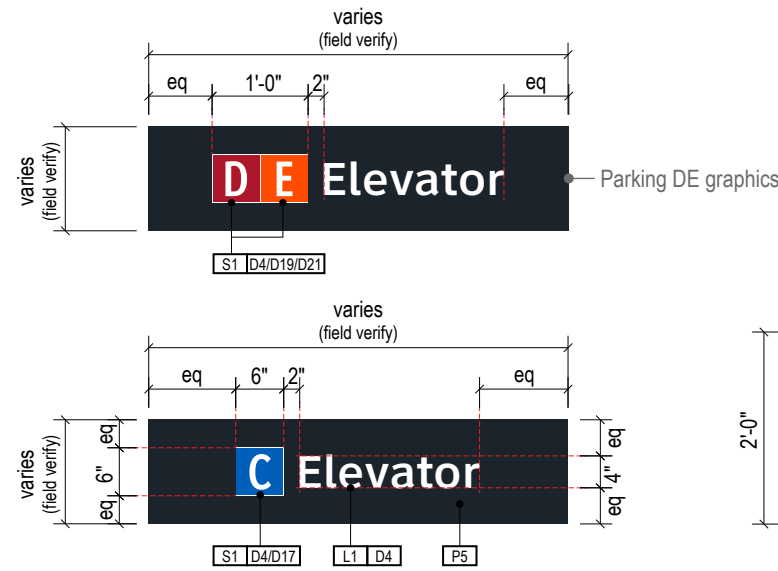

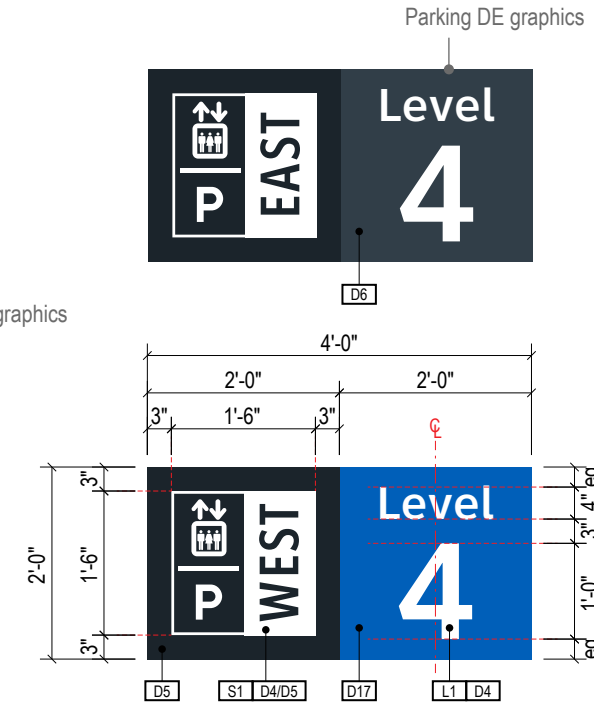
**A** FACE LAYOUT: Sign Type 5-ID.57  
Scale: 1/2" = 1'-0"



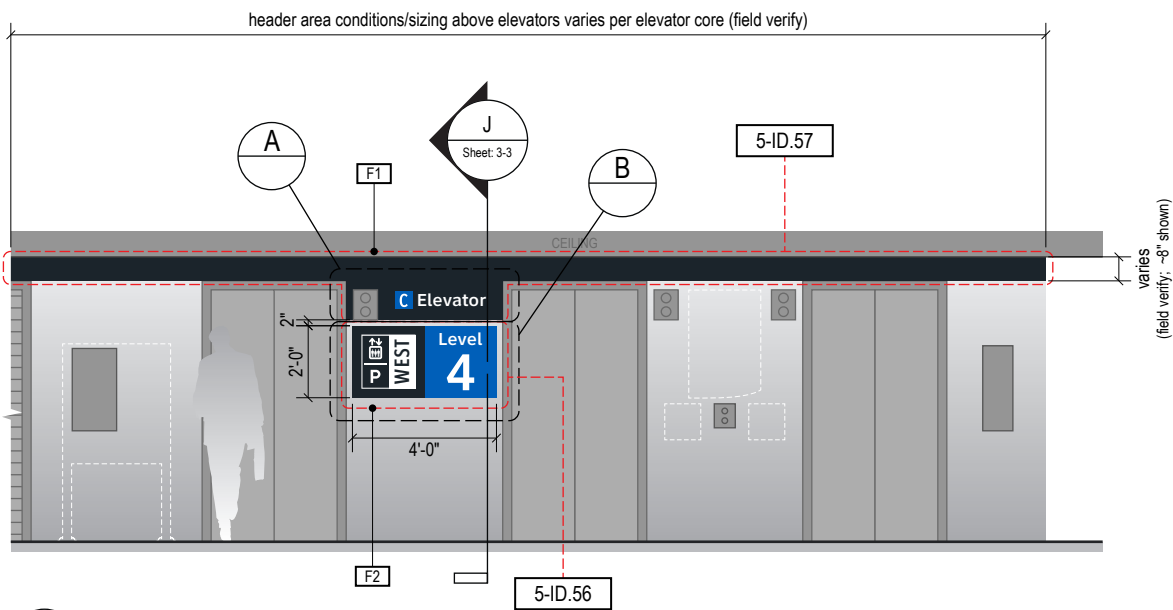**B** FACE LAYOUT: Sign Type 5-ID.56  
Scale: 1/2" = 1'-0"



**2** ELEVATION  
Scale: 3/16" = 1'-0"

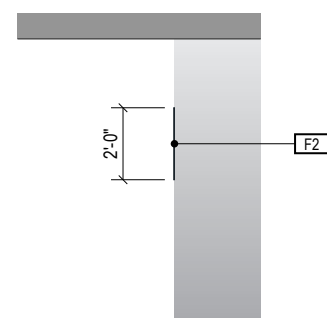

**3** END VIEW  
Scale: 3/16" = 1'-0"

ILLUMINATION	SIGN TYPE	SIGN FUNCTION	MOUNTING METHOD	GENERAL DESCRIPTION & USE
NON-ILLUMINATED	5-ID.58 & 5-ID.59	IDENTIFICATION	WALL MOUNT	PEDESTRIAN - Wall Mount Large Elevator Garage/Level ID & Header ID Band Graphics

**GENERAL NOTES**

- All final design, engineering & amount/sizing of structural sign support elements, material types/thicknesses, dimensions and attachment methods shall be performed and approved by a licensed engineer to meet or exceed all applicable local and national codes.
- Final engineering, dimensions, materials and fabrication are the responsibility of the Contractor/Fabricator/Installer to ensure the highest quality fit and finish for all components of the completed product. All final detailing and specifications to be provided by the Contractor/Fabricator/Installer within their final approved fabrication-ready shop drawings.
- Wherever dissimilar metals are in contact, always separate contact surfaces prior to assembly or installation with the necessary protective coatings/gaskets/washers to prevent galvanic corrosion.
- Final fabrication methods, quality and fit/finish to be reviewed & approved by HAS and the Wayfinding Design Consultants thru prototype reviews prior to final production run/installation processes.
- Colors shown are for reference only, and are subject to the limitations of the printing process and/or variance of electronic RGB screen displays. Refer to color system swatches and approved finish samples for accurate reference.
- Messages shown here are typical placeholders only. See message schedules for specific messaging by location & sign type.

**FABRICATION NOTES (GENERAL DESIGN INTENT)**

- F1** SIGN FACE PANEL: Fabricated alum. 1" deep pan-face, painted all exposed surfaces/returns with satin MAP paint; full-bleed digitally printed color graphics on 3M 3290 Engineer Grade white reflective film; removable faces, use internal hidden alum. mounting bracket mech. fastened to wall as req'd
- F2** HEADER ID GRAPHICS: Satin paint on existing wall, touch-up/fill/primer/seal wall surfaces as req'd prior to painting; graphics to be full-bleed digitally printed color graphics on 3M 3290 Engineer Grade white reflective cut vinyl applied directly to wall surface (or alum. panel painted w/ MAP satin paint to match P5) as req'd per install location conditions

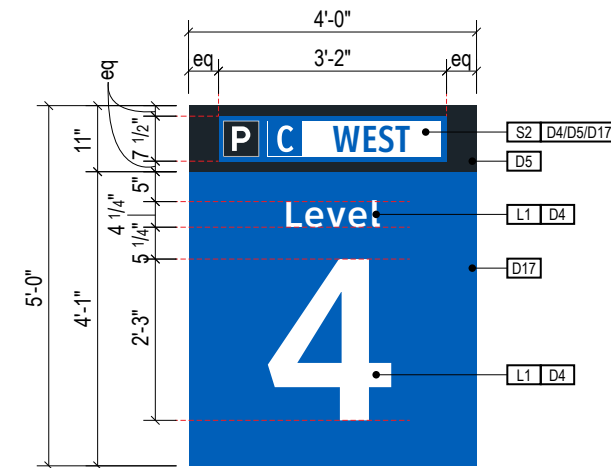
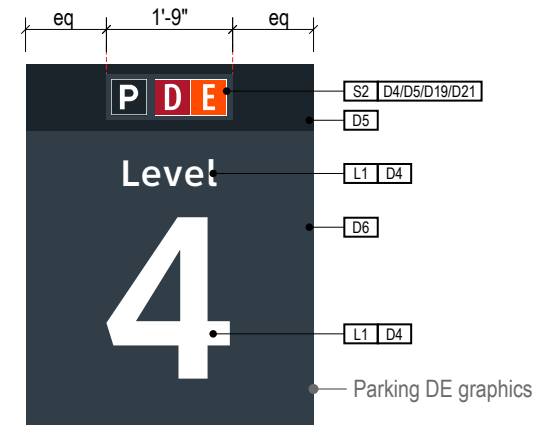
**LETTERING (TYPEFACES) / SYMBOLS / ARROWS:**

- L1** Vehicular Wayfinding Typeface: Clearview Highway 2-W
- L2** Vehicular Wayfinding Typeface: Clearview Highway 2-B
- L4** Vehicular Dynamic Numbers: Indect digital numbers
- L6** Supplemental Typeface: Clearview One Book Condensed
- S1** Arrow(s): use only official HAS wayfinding arrow art
- S2** Int'l Symbols: use only official HAS wayfinding symbol art
- B1** Sign Face Reflective White Border - 1/2" full-bleed border
- B2** Dynamic Unit White Border - border to match symbol field
- B3** Black Border - 1/2" full-bleed border


**COLORS:**

NOTES: "D" = digitally printed colors as generated by 3M Picasso printer (or equal) on 3M Reflective DG3 4090 White unless otherwise noted; "P" = Matthews Acrylic Polyurethane (MAP) paint (or equal), satin finish; "V" = 3M vinyl films (or equal)


- D4** White: match C:0 M:0 Y:0 K:0
- D5** Dark Gray: match PMS 433C **D6**: match PMS 432C
- D8** Light Gray: match PMS 427C
- D9** Black: match C:50 M:40 Y:40 K:100
- D11** Warning Yellow: match 3M Reflective DG3 4091 Yellow
- D17** Blue: match PMS 300C **D18** Dk. Blue: match PMS 294C
- D19** Red: match PMS 187C **D10** Safety Red: match PMS186C
- D25** Exit Green: match C:90 M:15 Y:100 K:0
- P1.3** Silver: MAP paint no. N951SP Med. Silver
- P5** Dark Gray: MAP paint matched to PMS 433C
- P17** Blue: MAP paint matched to PMS 300C
- P19** Red: MAP paint matched to PMS 187C



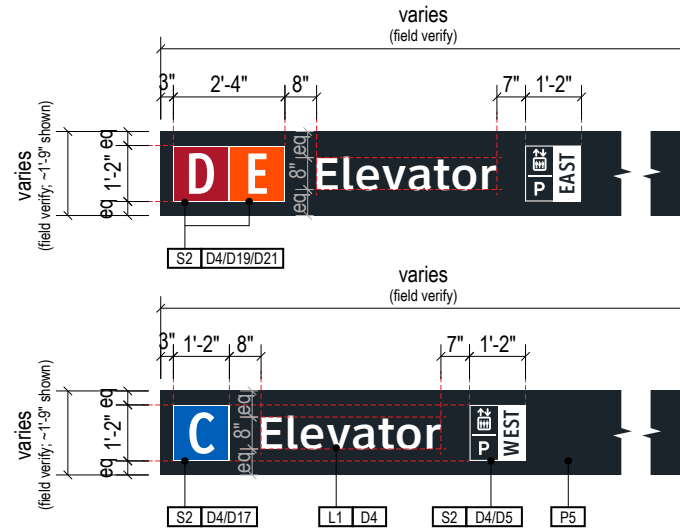
**B** FACE LAYOUT: Sign Type 5-ID.58  
Scale: 3/8" = 1'-0"



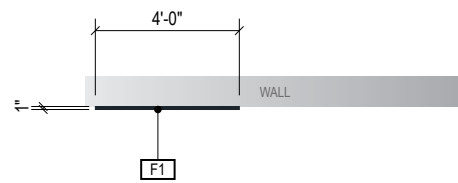
**A** FACE LAYOUT: Sign Type 5-ID.59  
Scale: 1/4" = 1'-0"



**1** PLAN VIEW  
Scale: 3/16" = 1'-0"

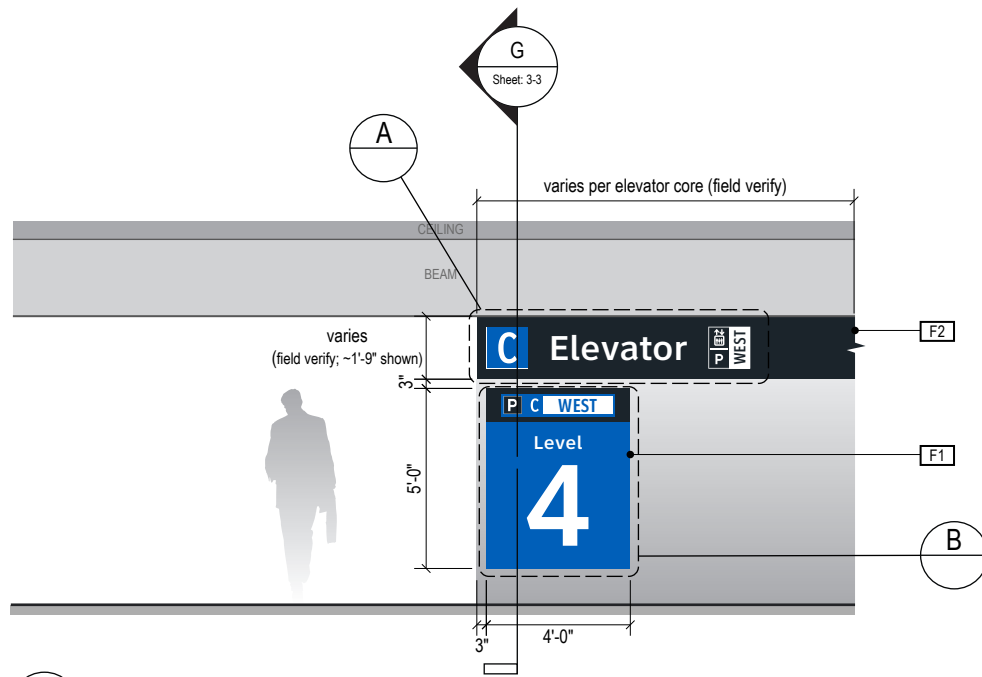

**2** ELEVATION  
Scale: 3/16" = 1'-0"

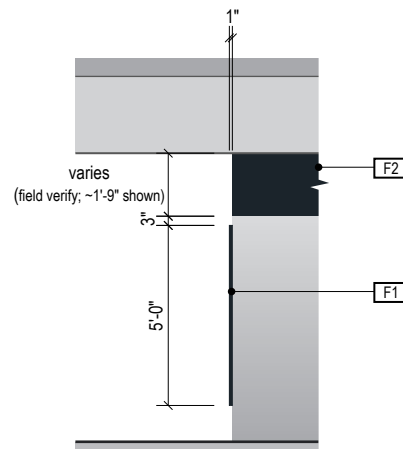

**3** END VIEW  
Scale: 3/16" = 1'-0"


ILLUMINATION	SIGN TYPE	SIGN FUNCTION	MOUNTING METHOD	GENERAL DESCRIPTION & USE
NON-ILLUMINATED	5-IN.51 & 5-IN.52	IDENTIFICATION	WALL MOUNT	PEDESTRIAN - Wall Mount Elevator Plaques

**GENERAL NOTES**

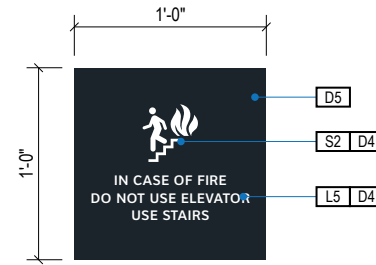
- All final design, engineering & amount/size of structural sign support elements, material types/thicknesses, dimensions and attachment methods shall be performed and approved by a licensed engineer to meet or exceed all applicable local and national codes.
- Final engineering, dimensions, materials and fabrication are the responsibility of the Contractor/Fabricator/Installer to ensure the highest quality fit and finish for all components of the completed product. All final detailing and specifications to be provided by the Contractor/Fabricator/Installer within their final approved fabrication-ready shop drawings.
- Wherever dissimilar metals are in contact, always separate contact surfaces prior to assembly or installation with the necessary protective coatings/gaskets/washers to prevent galvanic corrosion.
- Final fabrication methods, quality and fit/finish to be reviewed & approved by HAS and the Wayfinding Design Consultants thru prototype reviews prior to final production run/installation processes.
- Colors shown are for reference only, and are subject to the limitations of the printing process and/or variance of electronic RGB screen displays. Refer to color system swatches and approved finish samples for accurate reference.
- Messages shown here are typical placeholders only. See message schedules for specific messaging by location & sign type.

**FABRICATION NOTES (GENERAL DESIGN INTENT)**


- F1** SIGN FACE PANEL: 1/4" thick acrylic, edges sanded smooth & eased; painted all exposed surfaces with Matthews acrylic polyurethane (MAP), satin finish (non-glare); 1st surface screen printed graphics
- F2** MOUNTING: mount 2nd surface to wall 1st surface with high-bond strength sign grade VHB tape (or approved equal)



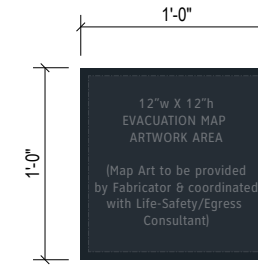
**A** FACE LAYOUT: Sign Type 5-IN.51  
Scale: 1" = 1'-0"



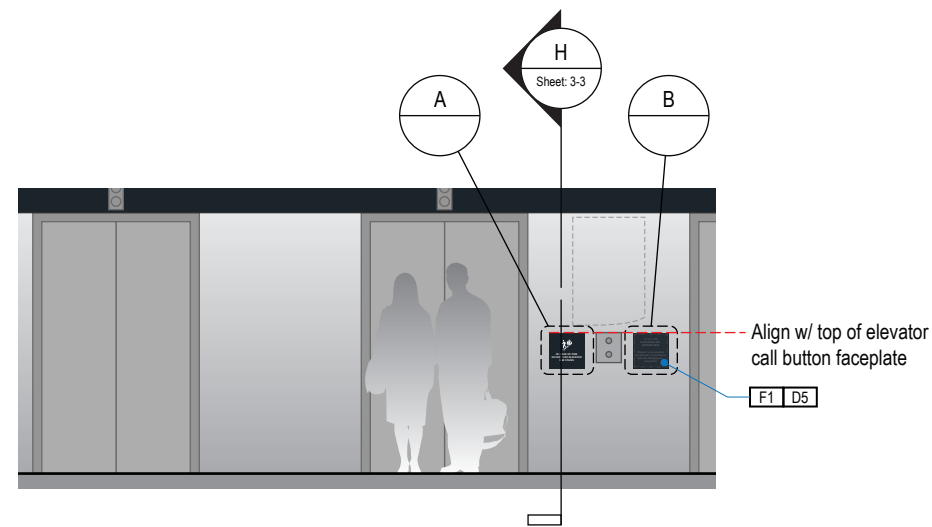**B** FACE LAYOUT: Sign Type 5-IN.52  
Scale: 1" = 1'-0"



**1** ELEVATION  
Scale: 3/16" = 1'-0"

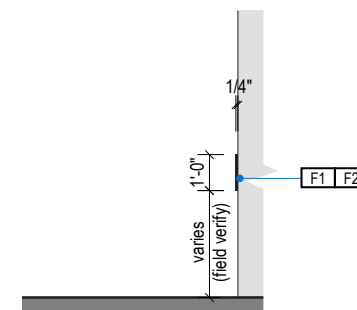

**2** END VIEW  
Scale: 3/16" = 1'-0"

**LETTERING (TYPEFACES) / SYMBOLS / ARROWS:**

- L1** Vehicular Wayfinding Typeface: Clearview Highway 2-W
- L2** Vehicular Wayfinding Typeface: Clearview Highway 2-B
- L4** Vehicular Dynamic Numbers: Indect digital numbers
- L6** Supplemental Typeface: Clearview One Book Condensed
- S1** Arrow(s): use only official HAS wayfinding arrow art
- S2** Int'l Symbols: use only official HAS wayfinding symbol art
- B1** Sign Face Reflective White Border - 1/2" full-bleed border
- B2** Dynamic Unit White Border - border to match symbol field
- B3** Black Border - 1/2" full-bleed border

**COLORS:**

NOTES: "D" = digitally printed colors as generated by 3M Picasso printer (or equal) on 3M Reflective DG3 4090 White unless otherwise noted; "P" = Matthews Acrylic Polyurethane (MAP) paint (or equal), satin finish; "V" = 3M vinyl films (or equal)

- D4** White: match C:0 M:0 Y:0 K:0
- D5** Dark Gray: match PMS 433C **D6**: match PMS 432C
- D8** Light Gray: match PMS 427C
- D9** Black: match C:50 M:40 Y:40 K:100
- D11** Warning Yellow: match 3M Reflective DG3 4091 Yellow
- D17** Blue: match PMS 300C **D18** Dk. Blue: match PMS 294C
- D19** Red: match PMS 187C **D10** Safety Red: match PMS186C
- D21** Orange: match PMS 1655C
- D25** Exit Green: match C:90 M:15 Y:100 K:0
- P1.3** Silver: MAP paint no. N951SP Med. Silver
- P5** Dark Gray: MAP paint matched to PMS 433C
- P17** Blue: MAP paint matched to PMS 300C
- P19** Red: MAP paint matched to PMS 187C

ILLUMINATION	SIGN TYPE	SIGN FUNCTION	MOUNTING METHOD	GENERAL DESCRIPTION & USE
NON-ILLUMINATED	5-IN.55	INFORMATIONAL	WALL MOUNT	PEDESTRIAN - Wall Mount Elevator Level Directory

GENERAL NOTES

- All final design, engineering & amount/size of structural sign support elements, material types/thicknesses, dimensions and attachment methods shall be performed and approved by a licensed engineer to meet or exceed all applicable local and national codes.
- Final engineering, dimensions, materials and fabrication are the responsibility of the Contractor/Fabricator/Installer to ensure the highest quality fit and finish for all components of the completed product. All final detailing and specifications to be provided by the Contractor/Fabricator/Installer within their final approved fabrication-ready shop drawings.
- Wherever dissimilar metals are in contact, always separate contact surfaces prior to assembly or installation with the necessary protective coatings/gaskets/washers to prevent galvanic corrosion.
- Final fabrication methods, quality and fit/finish to be reviewed & approved by HAS and the Wayfinding Design Consultants thru prototype reviews prior to final production run/installation processes.
- Colors shown are for reference only, and are subject to the limitations of the printing process and/or variance of electronic RGB screen displays. Refer to color system swatches and approved finish samples for accurate reference.
- Messages shown here are typical placeholders only. See message schedules for specific messaging by location & sign type.

FABRICATION NOTES (GENERAL DESIGN INTENT)

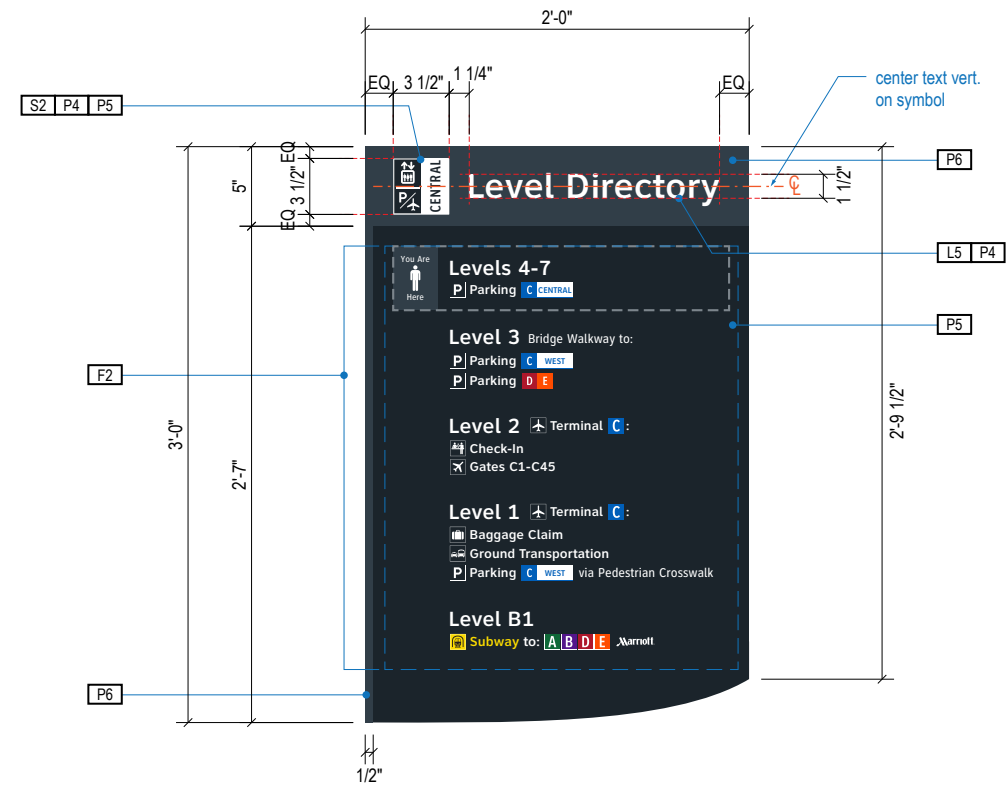
- F1** SIGN FACE PANEL: 1/2" thk. high pressure laminate with all colors/graphics to match as shown; mount plumb/level to wall with 2nd surface studs & high-bond strength sign grade VHB tape as req'd
- F2** LEVEL DIRECTORY GRAPHICS: NOTE: each level directory informational graphics are unique per each level directory location, fabricator to use level directory informational artwork as provided by designer from message schedule per each unique location

LETTERING (TYPEFACES) / SYMBOLS / ARROWS:


- L1** Vehicular Wayfinding Typeface: Clearview Highway 2-W
- L2** Vehicular Wayfinding Typeface: Clearview Highway 2-B
- L4** Vehicular Dynamic Numbers: Indect digital numbers
- L6** Supplemental Typeface: Clearview One Book Condensed
- S1** Arrow(s): use only official HAS wayfinding arrow art
- S2** Int'l Symbols: use only official HAS wayfinding symbol art
- B1** Sign Face Reflective White Border - 1/2" full-bleed border
- B2** Dynamic Unit White Border - border to match symbol field
- B3** Black Border - 1/2" full-bleed border

COLORS:


- NOTES: "D" = digitally printed colors as generated by 3M Picasso printer (or equal) on 3M Reflective DG3 4090 White unless otherwise noted; "P" = Matthews Acrylic Polyurethane (MAP) paint (or equal), satin finish; "V" = 3M vinyl films (or equal)
- D4** White: match C:0 M:0 Y:0 K:0
  - D5** Dark Gray: match PMS 433C **D6**: match PMS 432C
  - D8** Light Gray: match PMS 427C
  - D9** Black: match C:50 M:40 Y:40 K:100
  - D11** Warning Yellow: match 3M Reflective DG3 4091 Yellow
  - D17** Blue: match PMS 300C **D18** Dk. Blue: match PMS 294C
  - D19** Red: match PMS 187C **D10** Safety Red: match PMS186C
  - D25** Exit Green: match C:90 M:15 Y:100 K:0
  - P1.3** Silver: MAP paint no. N951SP Med. Silver
  - P5** Dark Gray: MAP paint matched to PMS 433C
  - P17** Blue: MAP paint matched to PMS 300C
  - P19** Red: MAP paint matched to PMS 187C



**A** FACE LAYOUT  
Scale: 1" = 1'-0"

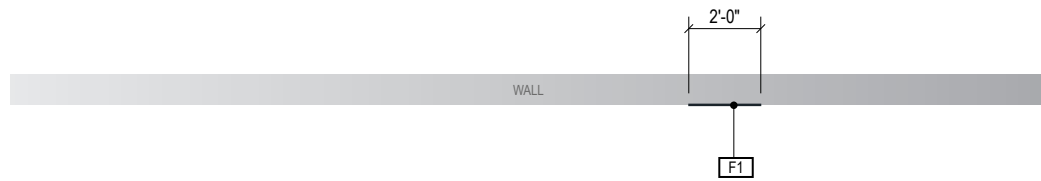

**1** PLAN VIEW  
Scale: 3/16" = 1'-0"

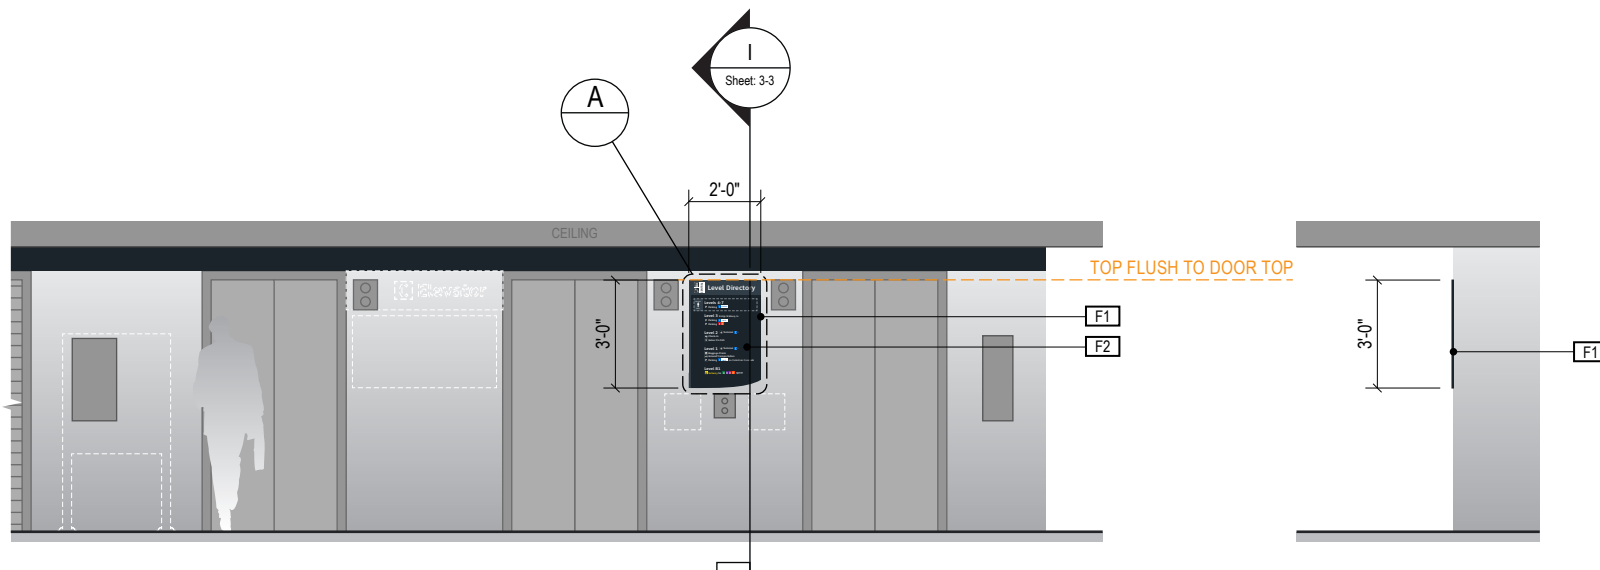

**2** ELEVATION  
Scale: 3/16" = 1'-0"

**3** END VIEW  
Scale: 3/16" = 1'-0"

ILLUMINATION	SIGN TYPE	SIGN FUNCTION	MOUNTING METHOD	GENERAL DESCRIPTION & USE
NON-ILLUMINATED	5-IN.61	INFORMATIONAL	FLOOR MOUNT	PEDESTRIAN - Floor Mount Garage Directory at Elevators

**GENERAL NOTES**

- All final design, engineering & amount/size of structural sign support elements, material types/thicknesses, dimensions and attachment methods shall be performed and approved by a licensed engineer to meet or exceed all applicable local and national codes.
- Final engineering, dimensions, materials and fabrication are the responsibility of the Contractor/Fabricator/Installer to ensure the highest quality fit and finish for all components of the completed product. All final detailing and specifications to be provided by the Contractor/Fabricator/Installer within their final approved fabrication-ready shop drawings.
- Wherever dissimilar metals are in contact, always separate contact surfaces prior to assembly or installation with the necessary protective coatings/gaskets/washers to prevent galvanic corrosion.
- Final fabrication methods, quality and fit/finish to be reviewed & approved by HAS and the Wayfinding Design Consultants thru prototype reviews prior to final production run/installation processes.
- Colors shown are for reference only, and are subject to the limitations of the printing process and/or variance of electronic RGB screen displays. Refer to color system swatches and approved finish samples for accurate reference.
- Messages shown here are typical placeholders only. See message schedules for specific messaging by location & sign type.

**FABRICATION NOTES (GENERAL DESIGN INTENT)**

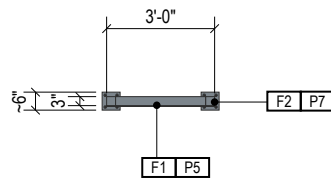
- F1** SIGN FACE PANEL: 1/8" thk. alum. face panel w/ 1st surface full-bleed digitally printed color graphics on matte 3M white film; ease all sharp edges; face panel mech. fastened to support frame w/ stainless steel screws, paint heads to match face; paint all exposed surfaces with satin MAP paint to match P5
- F2** SUPPORT FRAME/POSTS: fabricated square alum. support tube frame & vertical post structure; all support frame tube ends to be capped with alum.; all welds to be filled & ground smooth for uniform appearance; support post base plate mechanically attached to ground/decking as req'd (fabricator to field verify & get engineering support/buy-off prior to fabrication/installation); use break-away base connection if/as code requires; support frame/post/base plate to be painted all exposed surfaces with satin MAP paint to match P7
- F3** DIRECTORY MAP GRAPHICS: NOTE: each "YOU ARE HERE" graphic dot is in a unique location per each directory location, fabricator to use map artwork as provided by designer from message schedule per each unique location

**LETTERING (TYPEFACES) / SYMBOLS / ARROWS:**


- L1** Vehicular Wayfinding Typeface: Clearview Highway 2-W
- L2** Vehicular Wayfinding Typeface: Clearview Highway 2-B
- L4** Vehicular Dynamic Numbers: Indect digital numbers
- L6** Supplemental Typeface: Clearview One Book Condensed
- S1** Arrow(s): use only official HAS wayfinding arrow art
- S2** Int'l Symbols: use only official HAS wayfinding symbol art
- B1** Sign Face Reflective White Border - 1/2" full-bleed border
- B2** Dynamic Unit White Border - border to match symbol field
- B3** Black Border - 1/2" full-bleed border

**COLORS:**


- NOTES: "D" = digitally printed colors as generated by 3M Picasso printer (or equal) on 3M Reflective DG3 4090 White unless otherwise noted; "P" = Matthews Acrylic Polyurethane (MAP) paint (or equal), satin finish; "V" = 3M vinyl films (or equal)
- D4** White: match C:0 M:0 Y:0 K:0
  - D5** Dark Gray: match PMS 433C **D6**: match PMS 432C
  - D8** Light Gray: match PMS 427C
  - D9** Black: match C:50 M:40 Y:40 K:100
  - D11** Warning Yellow: match 3M Reflective DG3 4091 Yellow
  - D17** Blue: match PMS 300C **D18** Dk. Blue: match PMS 294C
  - D19** Red: match PMS 187C **D10** Safety Red: match PMS186C
  - D21** Orange: match PMS 1655C
  - D25** Exit Green: match C:90 M:15 Y:100 K:0
  - P1.3** Silver: MAP paint no. N951SP Med. Silver
  - P5** Dark Gray: MAP paint matched to PMS 433C
  - P17** Blue: MAP paint matched to PMS 300C
  - P19** Red: MAP paint matched to PMS 187C




**1 PLAN VIEW**  
Scale: 3/16" = 1'-0"

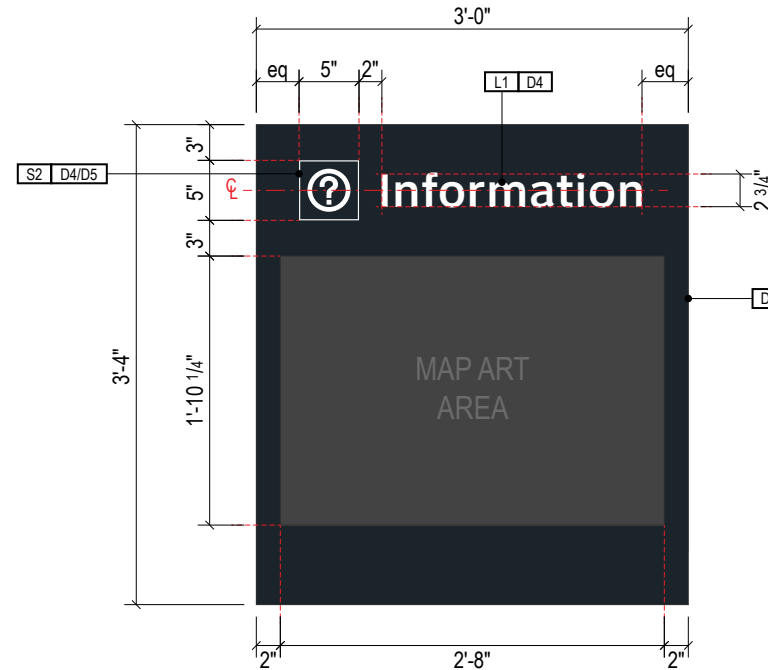


**A FACE LAYOUT**  
Scale: 3/4" = 1'-0"

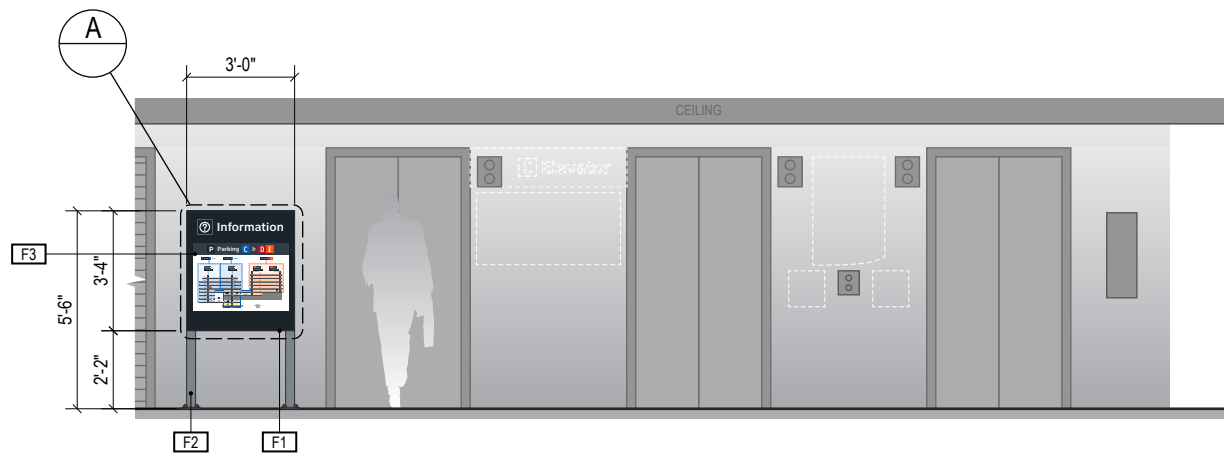

**2 ELEVATION**  
Scale: 3/16" = 1'-0"

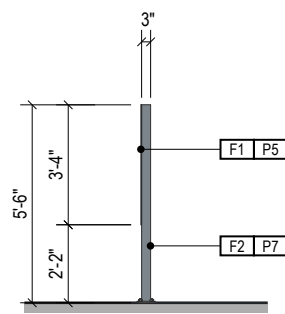


**3 END VIEW**  
Scale: 3/16" = 1'-0"

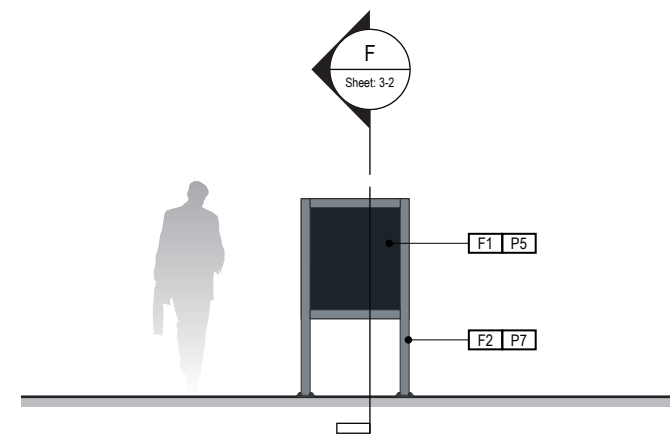


**4 END VIEW**  
Scale: 3/16" = 1'-0"

ILLUMINATION	SIGN TYPE	SIGN FUNCTION	MOUNTING METHOD	GENERAL DESCRIPTION & USE
NON-ILLUMINATED	1-ID.30	IDENTIFICATION	WALL	Wall Mount ADA Tactile Room ID

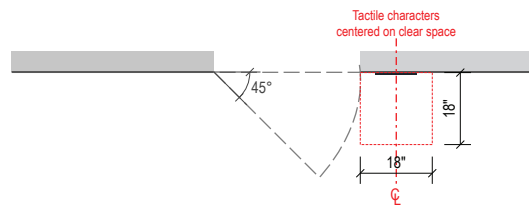

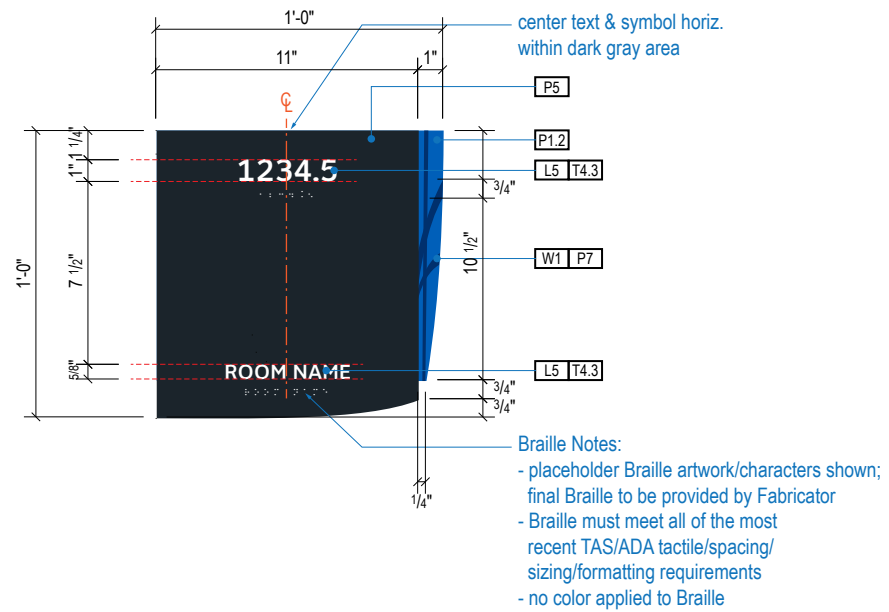NOTE: Sign must be located so that a clear floor space of 18" minimum by 18" minimum, centered on the tactile characters, is provided beyond the arc of any door swing between the closed position and 45 degree open position.



**Braille Notes:**  
 - placeholder Braille artwork/characters shown; final Braille to be provided by Fabricator  
 - Braille must meet all of the most recent TAS/ADA tactile/spacing/sizing/formatting requirements  
 - no color applied to Braille

#### GENERAL NOTES

- All final design, engineering & amount/sizing of structural sign support elements, material types/thicknesses, dimensions and attachment methods shall be performed and approved by a licensed engineer to meet or exceed all applicable local and national codes.
- Final engineering, dimensions, materials and fabrication are the responsibility of the Contractor/Fabricator/Installer to ensure the highest quality fit and finish for all components of the completed product. All final detailing and specifications to be provided by the Contractor/Fabricator/Installer within their final approved fabrication-ready shop drawings.
- Wherever dissimilar metals are in contact, always separate contact surfaces prior to assembly or installation with the necessary protective coatings/gaskets/washers to prevent galvanic corrosion.
- Final fabrication methods, quality and fit / finish to be reviewed & approved by HAS and the Wayfinding Design Consultants thru prototype reviews prior to final production run / installation processes.
- Colors shown are for reference only, and are subject to the limitations of the printing process and / or variance of electronic RGB screen displays. Refer to color system swatches and/or final finish samples for accurate reference.
- Messages shown here are typical placeholders only. See message schedules for specific messaging by location & sign type.

#### DESIGN INTENT NOTES

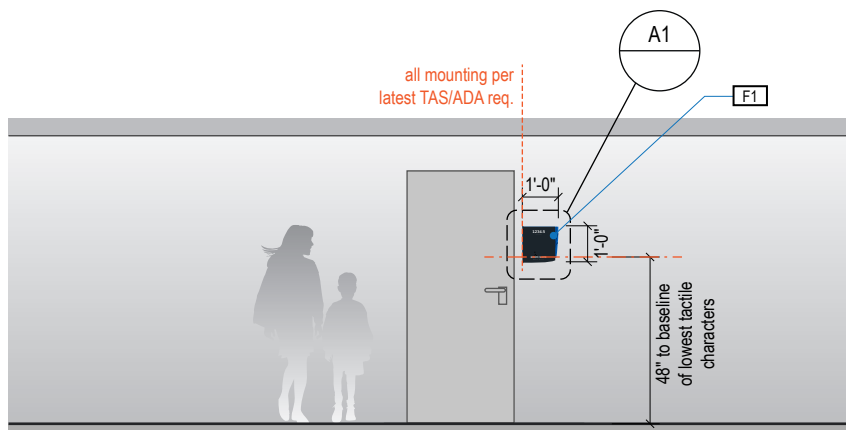
- F1** SIGN PANEL: 1/4" thick thermoformed acrylic panel, edges sanded smooth & eased, paint 2nd surface to match MAP paint P5, satin finish; screen paint watermark graphic 2nd surface to match P1.2 & P7, satin finish; 1st surface 1/32" raised tactile letters/graphics painted to match MAP paint P4, satin finish; 1st surface tactile Braille, no color applied (NOTE: Braille must meet all of the most recent TAS/ADA tactile/spacing/sizing/formatting requirements)
- F4** MOUNTING: mounting height and location/proximity to doors, strike plates & finished entry openings per most recent TAS/ADA requirements; mount plumb & level with adhesive/high-bond strength sign grade VHB tape (or approved equal) as install cond. req. (field verify)

#### 1 PLAN VIEW

Scale: 3/16" = 1'-0"


#### A1 FACE LAYOUT: Typical

Scale: 1 1/2" = 1'-0"



#### 2 ELEVATION

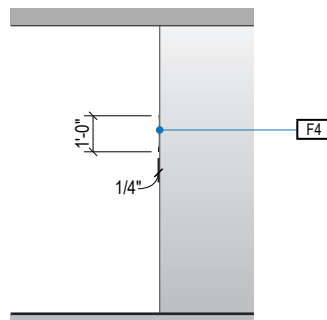Scale: 3/16" = 1'-0"



#### 3 END VIEW

Scale: 3/16" = 1'-0"

#### LETTERING (TYPEFACES) / SYMBOLS / ARROWS:

- L5** Pedestrian Wayfinding Typeface: ClearviewText Medium
- L6** Supplemental Typeface: Clearview One Book Condensed
- S1** Arrow(s): use only official HAS wayfinding arrows
- S2** Universal Symbols: use only official HAS wayfinding symbols
- W1** Watermark Graphic: use only official HAS "globe" vector art (art can be extracted from digital version of this drawing)

#### COLORS:

NOTES: "D" = digitally printed colors on 3M 7725-20 White unless otherwise noted; "P" = Matthews Acrylic Polyurethane (MAP) paint (or equal), satin finish; "V" = 3M vinyl films (or equal); "T" = tactile

- T4.3** Tactile: White to match P4
- P4** White: MAP paint MPN202
- P5** Dark Gray: match PMS 433C
- P17** C Blue: PMS 300C; **P18** C Watermark: PMS 294C

#### Wayfinding Updates

Issue Date: 08-23-2024  
Issue for Bid

REV.   
REV.   
REV.

#### WARNING:

This record contains Sensitive Security Information that is controlled under 49 CFR parts 15 and 1520. No part of this record may be disclosed to persons with a "need to know," as defined in 49 CFR parts 15 and 1520, except with the written permission of the Administrator of the Transportation Security Administration or the Secretary of Transportation. Unauthorized release may result in civil penalty or other action. For U.S. government agencies, public disclosure is governed by 5 U.S.C. 552 and 49 CFR parts 15 and 1520.



THESE SHEETS ARE ISSUED FOR GRAPHICAL INFORMATION ONLY

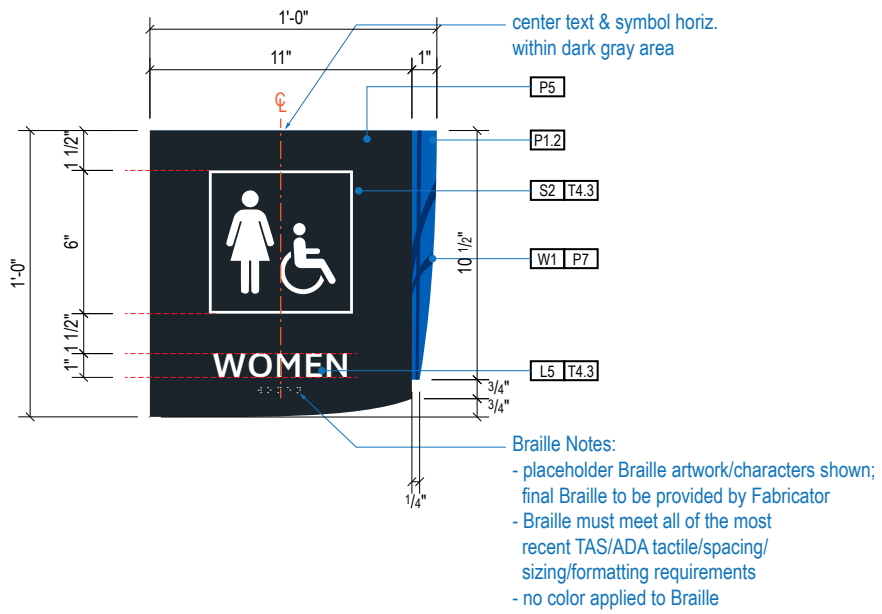
08-23-2024

#### 2.3 DESIGN INTENT - MISC. OTHER AREAS: PEDESTRIAN SIGNS


BSG PRJCT# BSG-2024-111-IAH  
HAS TIP # 24 -103 - IAH

Sheet: 2-29


ILLUMINATION	SIGN TYPE	SIGN FUNCTION	MOUNTING METHOD	GENERAL DESCRIPTION & USE
NON-ILLUMINATED	1-ID.31	IDENTIFICATION	WALL	Wall Mount ADA Tactile Restroom Entrance ID



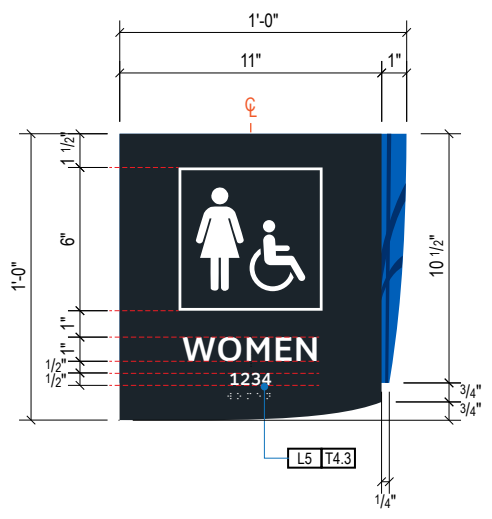
**A1** FACE LAYOUT: Typical  
 Scale: 1 1/2" = 1'-0"



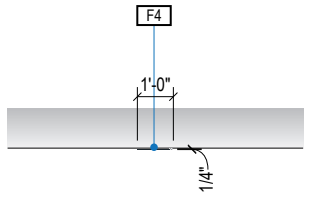
**A2** FACE LAYOUT W/ ROOM NUMBER  
 Scale: 1 1/2" = 1'-0"



**1** PLAN VIEW  
 Scale: 3/16" = 1'-0"

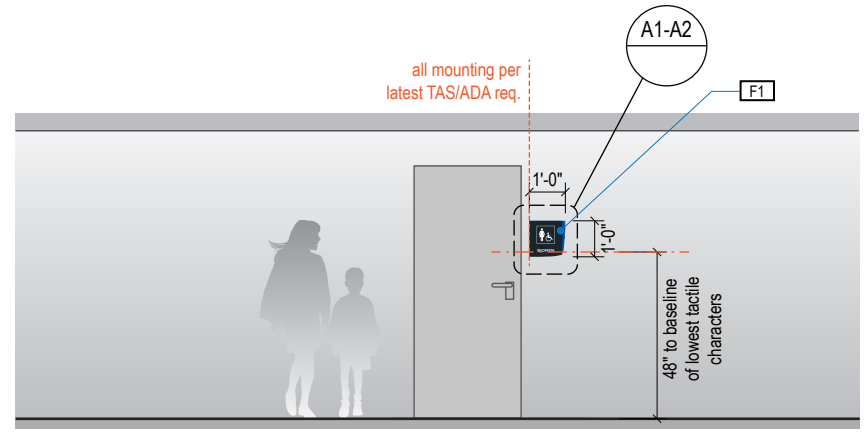

**2** ELEVATION  
 Scale: 3/16" = 1'-0"

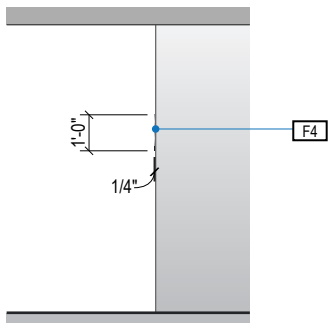

**3** END VIEW  
 Scale: 3/16" = 1'-0"

**GENERAL NOTES**

- All final design, engineering & amount/sizing of structural sign support elements, material types/thicknesses, dimensions and attachment methods shall be performed and approved by a licensed engineer to meet or exceed all applicable local and national codes.
- Final engineering, dimensions, materials and fabrication are the responsibility of the Contractor/Fabricator/Installer to ensure the highest quality fit and finish for all components of the completed product. All final detailing and specifications to be provided by the Contractor/Fabricator/Installer within their final approved fabrication-ready shop drawings.
- Wherever dissimilar metals are in contact, always separate contact surfaces prior to assembly or installation with the necessary protective coatings/gaskets/washers to prevent galvanic corrosion.
- Final fabrication methods, quality and fit / finish to be reviewed & approved by HAS and the Wayfinding Design Consultants thru prototype reviews prior to final production run / installation processes.
- Colors shown are for reference only, and are subject to the limitations of the printing process and / or variance of electronic RGB screen displays. Refer to color system swatches and/or final finish samples for accurate reference.
- Messages shown here are typical placeholders only. See message schedules for specific messaging by location & sign type.

**DESIGN INTENT NOTES**

- F1** SIGN PANEL: 1/4" thick thermoformed acrylic panel, edges sanded smooth & eased, paint 2nd surface to match MAP paint P5, satin finish; screen paint watermark graphic 2nd surface to match P1.2 & P7, satin finish; 1st surface 1/32" raised tactile letters/graphics painted to match MAP paint P4, satin finish; 1st surface tactile Braille, no color applied (NOTE: Braille must meet all of the most recent TAS/ADA tactile/spacing/sizing/formatting requirements)
- F4** MOUNTING: mounting height and location/proximity to doors, strike plates & finished entry openings per most recent TAS/ADA requirements; mount plumb & level with adhesive/high-bond strength sign grade VHB tape (or approved equal) as install cond. req. (field verify)

- LETTERING (TYPEFACES) / SYMBOLS / ARROWS:**
- L5** Pedestrian Wayfinding Typeface: ClearviewText Medium
  - L6** Supplemental Typeface: Clearview One Book Condensed
  - S1** Arrow(s): use only official HAS wayfinding arrows
  - S2** Universal Symbols: use only official HAS wayfinding symbols
  - W1** Watermark Graphic: use only official HAS "globe" vector art (art can be extracted from digital version of this drawing)

**COLORS:**  
 NOTES: "D" = digitally printed colors on 3M 7725-20 White unless otherwise noted; "P" = Matthews Acrylic Polyurethane (MAP) paint (or equal), satin finish; "V" = 3M vinyl films (or equal); "T" = tactile

- T4.3** Tactile: White to match P4
- P4** White: MAP paint MPN202
- P5** Dark Gray: match PMS 433C
- P17** C Blue: PMS 300C; **P18** C Watermark: PMS 294C

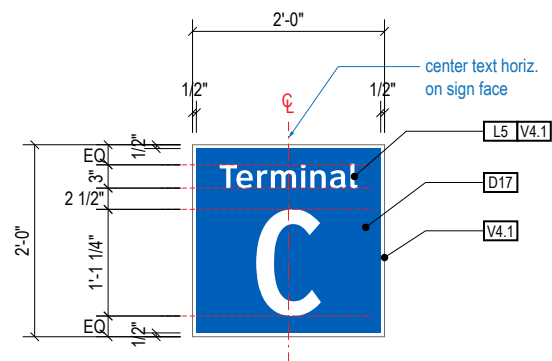
ILLUMINATION	SIGN TYPE	SIGN FUNCTION	MOUNTING METHOD	GENERAL DESCRIPTION & USE
NON-ILLUMINATED	3t-ID.33 & 3t-ID.34	IDENTIFICATION	WALL	Miscellaneous ID Signage

**GENERAL NOTES**


- All final design, engineering & amount/sizing of structural sign support elements, material types/thicknesses, dimensions and attachment methods shall be performed and approved by a licensed engineer to meet or exceed all applicable local and national codes.
- Final engineering, dimensions, materials and fabrication are the responsibility of the Contractor/Fabricator/Installer to ensure the highest quality fit and finish for all components of the completed product. All final detailing and specifications to be provided by the Contractor/Fabricator/Installer within their final approved fabrication-ready shop drawings.
- Wherever dissimilar metals are in contact, always separate contact surfaces prior to assembly or installation with the necessary protective coatings/gaskets/washers to prevent galvanic corrosion.
- Final fabrication methods, quality and fit / finish to be reviewed & approved by HAS and the Wayfinding Design Consultants thru prototype reviews prior to final production run / installation processes.
- Colors shown are for reference only, and are subject to the limitations of the printing process and / or variance of electronic RGB screen displays. Refer to color system swatches and/or final finish samples for accurate reference.
- Messages shown here are typical placeholders only. See message schedules for specific messaging by location & sign type.

**DESIGN INTENT NOTES**

- F1** SIGN FACE UNIT(S): 1/8" thick aluminum sign panel; graphics to be full-bleed digital print on 3M vinyl film & applied to faces
- F2** MOUNTING: mechanically fasten sign panels to wall/beam/soffit with stainless steel tamper-proof mechanical fasteners as install conditions require (Fabricator to field verify), paint heads to match sign face; NOTE: Fabricator to use proper connection gaskets/seals/etc to eliminate corrosion from mounting surface and weather conditions as install location conditions require (Fabricator to field verify)



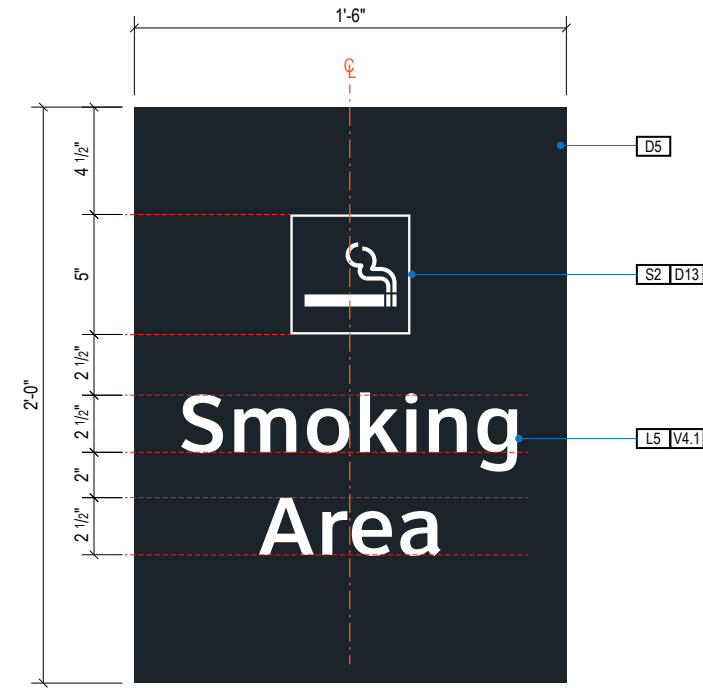**1** FACE LAYOUT: 3t-ID.33  
Scale: 1/2" = 1'-0"



**2** FACE LAYOUT: 3t-ID.34  
Scale: 1 1/2" = 1'-0"

LETTERING (TYPEFACES) / SYMBOLS / ARROWS:  
**L5** Pedestrian Wayfinding Typeface: ClearviewText Medium  
**S2** Universal Symbols: use only official HAS wayfinding symbols

COLORS:  
 NOTES: "D" = digitally printed colors on 3M 7725-20 White unless otherwise noted; "P" = Matthews Acrylic Polyurethane (MAP) paint (or equal), satin finish; "V" = 3M vinyl films (or equal); "T" = tactile  
**V4.1** White: 3M 7725-20 White Opaque  
**D5** Dark Gray: match PMS 433C  
**D17** C Blue: PMS 300C



ILLUMINATION	SIGN TYPE	SIGN FUNCTION	MOUNTING METHOD	GENERAL DESCRIPTION & USE
NON-ILLUMINATED	3-I.D.43	IDENTIFICATION	FLAG	Transitional Flag Mount ID

**GENERAL NOTES**

- All final design, engineering & amount/size of structural sign support elements, material types/thicknesses, dimensions and attachment methods shall be performed and approved by a licensed engineer to meet or exceed all applicable local and national codes.
- Final engineering, dimensions, materials and fabrication are the responsibility of the Contractor/Fabricator/Installer to ensure the highest quality fit and finish for all components of the completed product. All final detailing and specifications to be provided by the Contractor/Fabricator/Installer within their final approved fabrication-ready shop drawings.
- Wherever dissimilar metals are in contact, always separate contact surfaces prior to assembly or installation with the necessary protective coatings/gaskets/washers to prevent galvanic corrosion.
- Final fabrication methods, quality and fit/finish to be reviewed & approved by HAS and the Wayfinding Design Consultants thru prototype reviews prior to final production run/installation processes.
- Colors shown are for reference only, and are subject to the limitations of the printing process and/or variance of electronic RGB screen displays. Refer to color system swatches and approved finish samples for accurate reference.
- Messages shown here are typical placeholders only. See message schedules for specific messaging by location & sign type.

**FABRICATION NOTES (GENERAL DESIGN INTENT)**

- F1** SIGN FACE PANEL: 1/4" thk. alum. face panel w/ brake-formed vertical mounting flange edge; 1st surface full-bleed digitally printed color graphics on matte 3M white film; ease all sharp edges; paint all exposed surfaces/mounting flange with satin MAP paint to match P5
- F2** MOUNTING: mount plumb/level to vertical mounting surface with mech. fasteners as install location conditions require

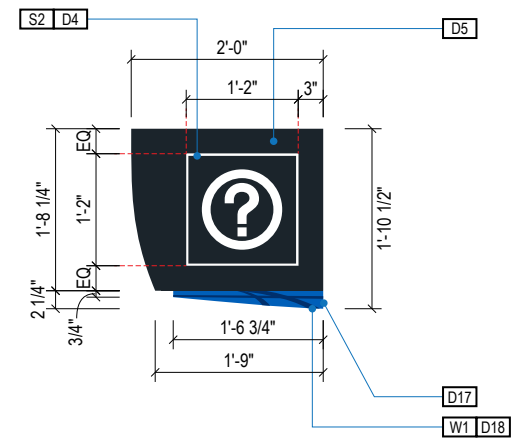
**LETTERING (TYPEFACES) / SYMBOLS / ARROWS:**

- L1** Vehicular Wayfinding Typeface: Clearview Highway 2-W
- L2** Vehicular Wayfinding Typeface: Clearview Highway 2-B
- L4** Vehicular Dynamic Numbers: Indect digital numbers
- L6** Supplemental Typeface: Clearview One Book Condensed
- S1** Arrow(s): use only official HAS wayfinding arrow art
- S2** Int'l Symbols: use only official HAS wayfinding symbol art
- B1** Sign Face Reflective White Border - 1/2" full-bleed border
- B2** Dynamic Unit White Border - border to match symbol field
- B3** Black Border - 1/2" full-bleed border


**COLORS:**

NOTES: "D" = digitally printed colors as generated by 3M Picasso printer (or equal) on 3M Reflective DG3 4090 White unless otherwise noted; "P" = Matthews Acrylic Polyurethane (MAP) paint (or equal), satin finish; "V" = 3M vinyl films (or equal)


- D4** White: match C:0 M:0 Y:0 K:0
- D5** Dark Gray: match PMS 433C **D6**: match PMS 432C
- D8** Light Gray: match PMS 427C
- D9** Black: match C:50 M:40 Y:40 K:100
- D11** Warning Yellow: match 3M Reflective DG3 4091 Yellow
- D17** Blue: match PMS 300C **D18** Dk. Blue: match PMS 294C
- D19** Red: match PMS 187C **D10** Safety Red: match PMS186C
- D21** Orange: match PMS 1655C
- D25** Exit Green: match C:90 M:15 Y:100 K:0
- P1.3** Silver: MAP paint no. N951SP Med. Silver
- P5** Dark Gray: MAP paint matched to PMS 433C
- P17** Blue: MAP paint matched to PMS 300C
- P19** Red: MAP paint matched to PMS 187C



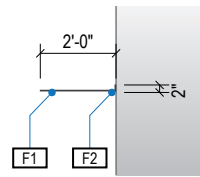
**A** FACE LAYOUT: Typical  
Scale: 1/2" = 1'-0"




**1** PLAN VIEW  
Scale: 3/16" = 1'-0"

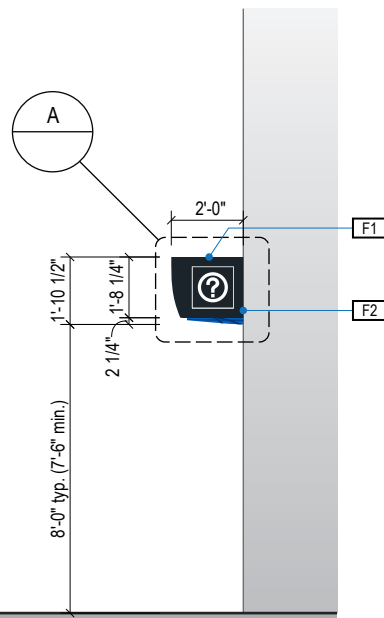

**2** ELEVATION  
Scale: 3/16" = 1'-0"

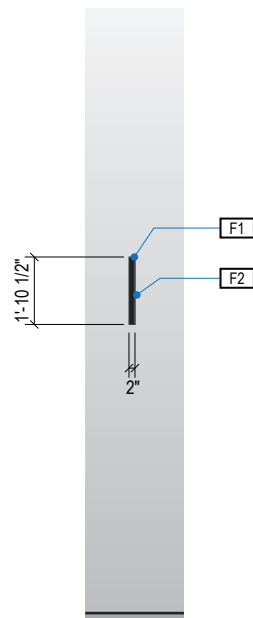

**3** END VIEW  
Scale: 3/16" = 1'-0"

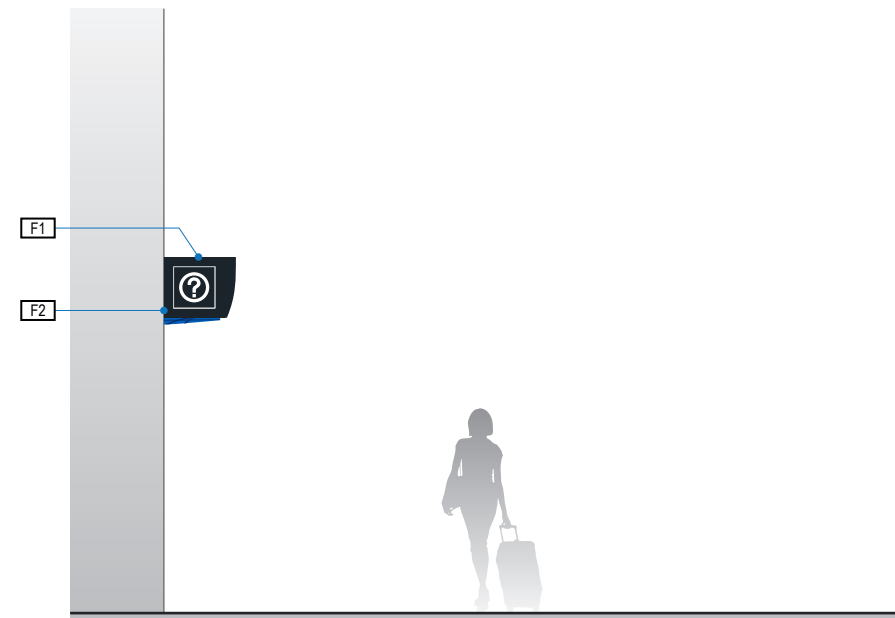

**4** ELEVATION (OPPOSITE SIDE)  
Scale: 3/16" = 1'-0"


ILLUMINATION	SIGN TYPE	SIGN FUNCTION	MOUNTING METHOD	GENERAL DESCRIPTION & USE
NON-ILLUMINATED	1t-RG.24	REGULATORY	WALL	Terminal Regulatory Signage

**GENERAL NOTES**

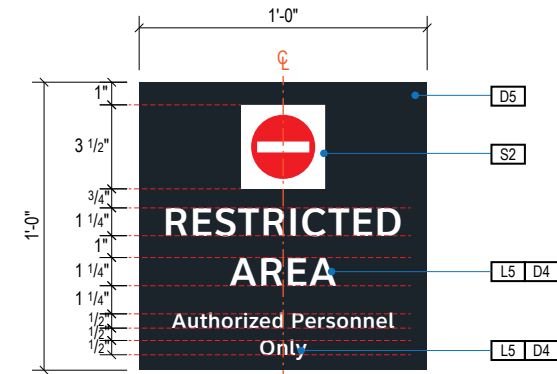- All final design, engineering & amount/sizing of structural sign support elements, material types/thicknesses, dimensions and attachment methods shall be performed and approved by a licensed engineer to meet or exceed all applicable local and national codes.
- Final engineering, dimensions, materials and fabrication are the responsibility of the Contractor/Fabricator/Installer to ensure the highest quality fit and finish for all components of the completed product. All final detailing and specifications to be provided by the Contractor/Fabricator/Installer within their final approved fabrication-ready shop drawings.
- Wherever dissimilar metals are in contact, always separate contact surfaces prior to assembly or installation with the necessary protective coatings/gaskets/washers to prevent galvanic corrosion.
- Final fabrication methods, quality and fit / finish to be reviewed & approved by HAS and the Wayfinding Design Consultants thru prototype reviews prior to final production run / installation processes.
- Colors shown are for reference only, and are subject to the limitations of the printing process and / or variance of electronic RGB screen displays. Refer to color system swatches and/or final finish samples for accurate reference.
- Messages shown here are typical placeholders only. See message schedules for specific messaging by location & sign type.

**DESIGN INTENT NOTES**

- F1** SIGN PANEL: 1/8" thick aluminum sign panel; graphics to be full bleed-digital print on 3M vinyl film & applied to faces
- F2** MOUNTING: mount to surface with high-bond strength sign grade VHB tape (or approved equal)



**1** FACE LAYOUT: 1t-RG.24  
Scale: 1 1/2" = 1'-0"

- LETTERING (TYPEFACES) / SYMBOLS / ARROWS:**
- L5** Pedestrian Wayfinding Typeface: ClearviewText Medium
  - S1** Arrow(s): use only official HAS wayfinding arrows
  - S2** Universal Symbols: use only official HAS wayfinding symbols

- COLORS:**
- NOTES: "D" = digitally printed colors on 3M 7725-20 White unless otherwise noted; "P" = Matthews Acrylic Polyurethane (MAP) paint (or equal), satin finish; "V" = 3M vinyl films (or equal); "T" = tactile
- D4** White: C:0 M:0 Y:0 K:0
  - D5** Dark Gray: match PMS 433C
  - D9** Black: C:50 M:40 Y:40 K:100
  - D11** Warning Yellow: match PMS116C
  - D17** C Blue: match PMS 300C


ILLUMINATION	SIGN TYPE	SIGN FUNCTION	MOUNTING METHOD	GENERAL DESCRIPTION & USE
NON-ILLUMINATED	3t-RG.23, 3t-RG.24	REGULATORY	WALL	Curbside Regulatory Signage

**GENERAL NOTES**

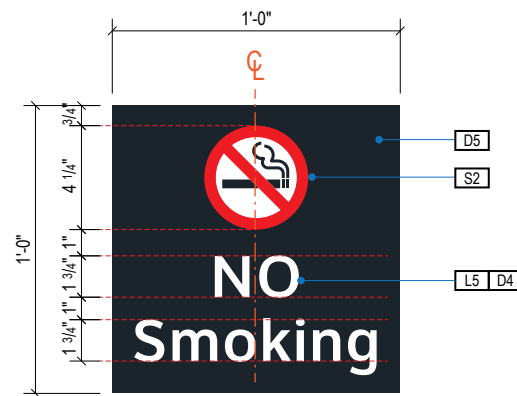
- All final design, engineering & amount/sizing of structural sign support elements, material types/thicknesses, dimensions and attachment methods shall be performed and approved by a licensed engineer to meet or exceed all applicable local and national codes.
- Final engineering, dimensions, materials and fabrication are the responsibility of the Contractor/Fabricator/Installer to ensure the highest quality fit and finish for all components of the completed product. All final detailing and specifications to be provided by the Contractor/Fabricator/Installer within their final approved fabrication-ready shop drawings.
- Wherever dissimilar metals are in contact, always separate contact surfaces prior to assembly or installation with the necessary protective coatings/gaskets/washers to prevent galvanic corrosion.
- Final fabrication methods, quality and fit / finish to be reviewed & approved by HAS and the Wayfinding Design Consultants thru prototype reviews prior to final production run / installation processes.
- Colors shown are for reference only, and are subject to the limitations of the printing process and / or variance of electronic RGB screen displays. Refer to color system swatches and/or final finish samples for accurate reference.
- Messages shown here are typical placeholders only. See message schedules for specific messaging by location & sign type.

**DESIGN INTENT NOTES**

- F1** SIGN PANEL: 1/8" thick aluminum sign panel; graphics to be full bleed-digital print on 3M vinyl film & applied to faces
- F2** MOUNTING: mechanically fasten sign panels to surface with stainless steel tamper-proof mechanical fasteners as install conditions require (fabricator to field verify); paint heads to match sign face. NOTE: Fabricator to use proper connection gaskets/seals/etc. to eliminate corrosion from mounting surface and weather conditions as install locations require.



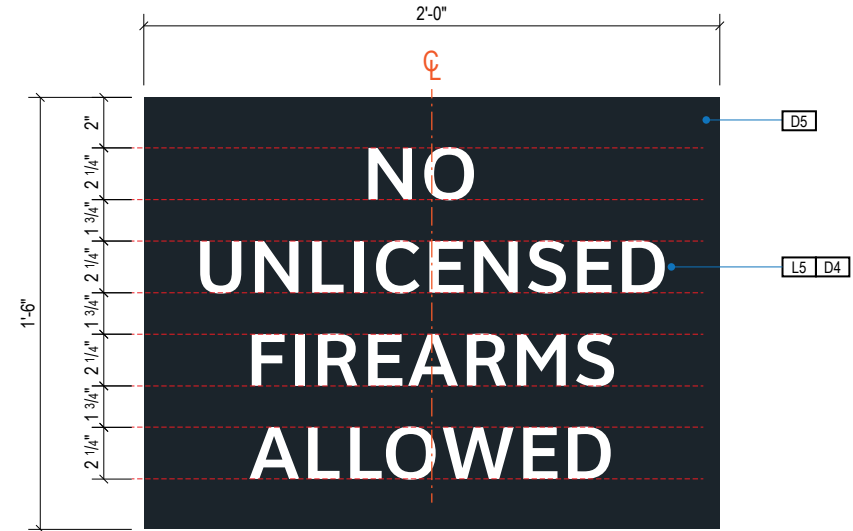**1** FACE LAYOUT: 3t-RG.23  
Scale: 1 1/2" = 1'-0"



**2** FACE LAYOUT: 3t-RG.24  
Scale: 1 1/2" = 1'-0"

**LETTERING (TYPEFACES) / SYMBOLS / ARROWS:**

- L5** Pedestrian Wayfinding Typeface: ClearviewText Medium
- S1** Arrow(s): use only official HAS wayfinding arrows
- S2** Universal Symbols: use only official HAS wayfinding symbols

**COLORS:**

- NOTES: "D" = digitally printed colors on 3M 7725-20 White unless otherwise noted; "P" = Matthews Acrylic Polyurethane (MAP) paint (or equal), satin finish; "V" = 3M vinyl films (or equal); "T" = tactile
- D4** White: C:0 M:0 Y:0 K:0
  - D5** Dark Gray: match PMS 433C
  - D9** Black: C:50 M:40 Y:40 K:100
  - D10** Safety Red: match PMS 186C
  - D11** Warning Yellow: match PMS 116C
  - D17** C Blue: match PMS 300C

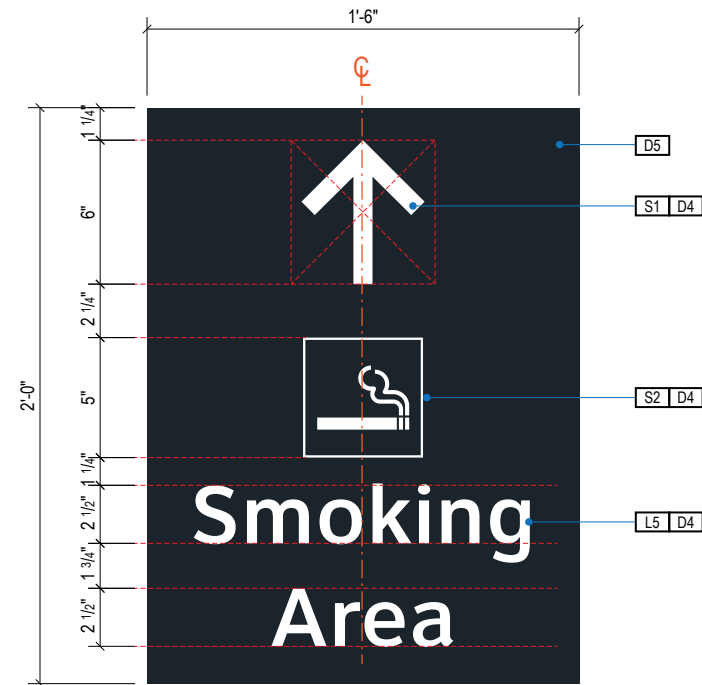
ILLUMINATION	SIGN TYPE	SIGN FUNCTION	MOUNTING METHOD	GENERAL DESCRIPTION & USE
NON-ILLUMINATED	3t-DR.29	DIRECTIONAL	WALL	Curbside Directional Signage

**GENERAL NOTES**

- All final design, engineering & amount/sizing of structural sign support elements, material types/thicknesses, dimensions and attachment methods shall be performed and approved by a licensed engineer to meet or exceed all applicable local and national codes.
- Final engineering, dimensions, materials and fabrication are the responsibility of the Contractor/Fabricator/Installer to ensure the highest quality fit and finish for all components of the completed product. All final detailing and specifications to be provided by the Contractor/Fabricator/Installer within their final approved fabrication-ready shop drawings.
- Wherever dissimilar metals are in contact, always separate contact surfaces prior to assembly or installation with the necessary protective coatings/gaskets/washers to prevent galvanic corrosion.
- Final fabrication methods, quality and fit / finish to be reviewed & approved by HAS and the Wayfinding Design Consultants thru prototype reviews prior to final production run / installation processes.
- Colors shown are for reference only, and are subject to the limitations of the printing process and / or variance of electronic RGB screen displays. Refer to color system swatches and/or final finish samples for accurate reference.
- Messages shown here are typical placeholders only. See message schedules for specific messaging by location & sign type.

**DESIGN INTENT NOTES**

- F1** SIGN PANEL: 1/8" thick aluminum sign panel; graphics to be full bleed-digital print on 3M vinyl film & applied to faces
- F2** MOUNTING: mechanically fasten sign panels to surface with stainless steel tamper-proof mechanical fasteners as install conditions require (fabricator to field verify); paint heads to match sign face. NOTE: Fabricator to use proper connection gaskets/seals/etc. to eliminate corrosion from mounting surface and weather conditions as install locations require.



**1** FACE LAYOUT: 3t-DR.29  
Scale: 1 1/2" = 1'-0"

- LETTERING (TYPEFACES) / SYMBOLS / ARROWS:**
- L5** Pedestrian Wayfinding Typeface: ClearviewText Medium
  - S1** Arrow(s): use only official HAS wayfinding arrows
  - S2** Universal Symbols: use only official HAS wayfinding symbols

- COLORS:**
- NOTES: "D" = digitally printed colors on 3M 7725-20 White unless otherwise noted; "P" = Matthews Acrylic Polyurethane (MAP) paint (or equal), satin finish; "V" = 3M vinyl films (or equal); "T" = tactile
- D4** White: C:0 M:0 Y:0 K:0
  - D5** Dark Gray: match PMS 433C
  - D17** C Blue: PMS 300C




ILLUMINATION	SIGN TYPE	SIGN FUNCTION	MOUNTING METHOD	GENERAL DESCRIPTION & USE
NON-ILLUMINATED	5-ID.81, 5-ID.82, 5-ID.83	IDENTIFICATION	WALL	Miscellaneous Wall Mount ID Signage

**GENERAL NOTES**

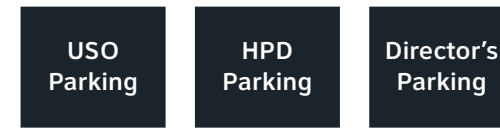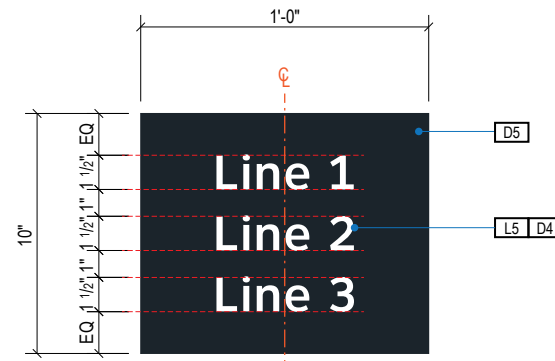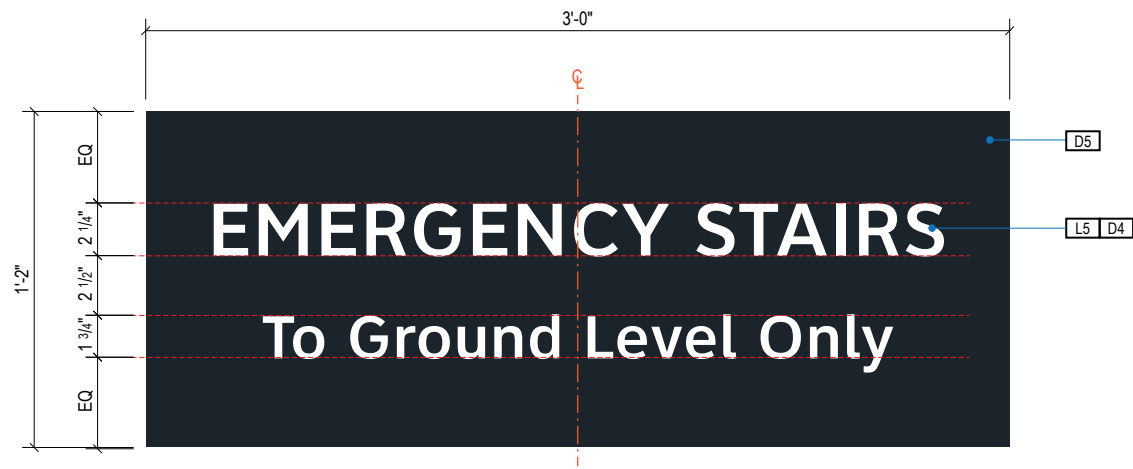
- All final design, engineering & amount/size of structural sign support elements, material types/thicknesses, dimensions and attachment methods shall be performed and approved by a licensed engineer to meet or exceed all applicable local and national codes.
- Final engineering, dimensions, materials and fabrication are the responsibility of the Contractor/Fabricator/Installer to ensure the highest quality fit and finish for all components of the completed product. All final detailing and specifications to be provided by the Contractor/Fabricator/Installer within their final approved fabrication-ready shop drawings.
- Wherever dissimilar metals are in contact, always separate contact surfaces prior to assembly or installation with the necessary protective coatings/gaskets/washers to prevent galvanic corrosion.
- Final fabrication methods, quality and fit / finish to be reviewed & approved by HAS and the Wayfinding Design Consultants thru prototype reviews prior to final production run / installation processes.
- Colors shown are for reference only, and are subject to the limitations of the printing process and / or variance of electronic RGB screen displays. Refer to color system swatches and/or final finish samples for accurate reference.
- Messages shown here are typical placeholders only. See message schedules for specific messaging by location & sign type.

**DESIGN INTENT NOTES**

- [F1] SIGN PANEL:** 1/8" thick aluminum sign panel; graphics to be full bleed-digital print on 3M vinyl film & applied to faces
- [F2] MOUNTING:** mechanically fasten sign panels to surface with stainless steel tamper-proof mechanical fasteners as install conditions require (fabricator to field verify); paint heads to match sign face. NOTE: Fabricator to use proper connection gaskets/seals/etc. to eliminate corrosion from mounting surface and weather conditions as install locations require.



Typical 2-Line Layouts

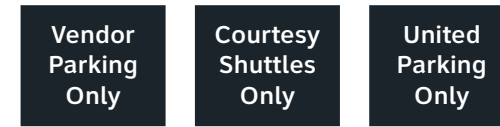


Typical 3-Line Layouts

**1** FACE LAYOUT: 5-ID.81 (Emergency Stair ID)

Scale: 1 1/2" = 1'-0"

**2** FACE LAYOUT: 5-ID.82 (Assigned Parking)

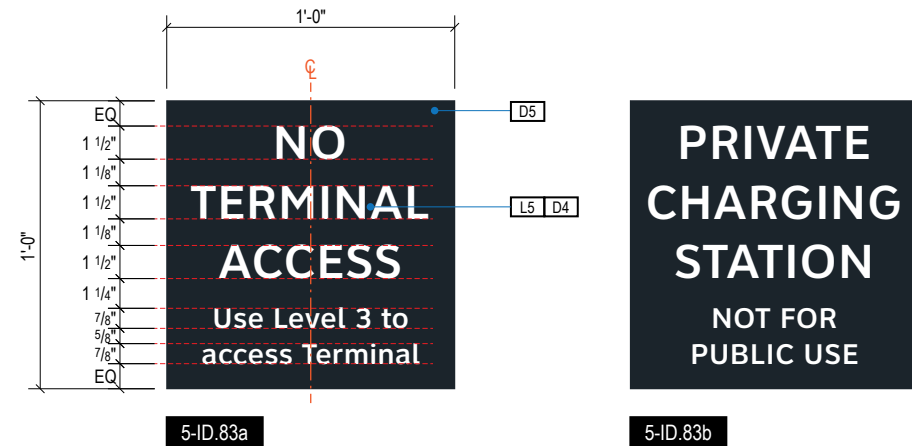Scale: 1 1/2" = 1'-0"



**3** FACE LAYOUT: 5-ID.83 (Regulatory)

Scale: 1 1/2" = 1'-0"

**LETTERING (TYPEFACES) / SYMBOLS / ARROWS:**

- [L5]** Pedestrian Wayfinding Typeface: ClearviewText Medium
- [S1]** Arrow(s): use only official HAS wayfinding arrows
- [S2]** Universal Symbols: use only official HAS wayfinding symbols

**COLORS:**

- NOTES: "D" = digitally printed colors on 3M 7725-20 White unless otherwise noted; "P" = Matthews Acrylic Polyurethane (MAP) paint (or equal), satin finish; "V" = 3M vinyl films (or equal); "T" = tactile
- [D4]** White: C:0 M:0 Y:0 K:0
  - [D5]** Dark Gray: match PMS 433C
  - [D9]** Black: C:50 M:40 Y:40 K:100
  - [D11]** Warning Yellow: match PMS116C
  - [D17]** C Blue: match PMS 300C

**Wayfinding Updates**

Issue Date: 08-23-2024

Issue for Bid

- REV.
- REV.
- REV.

**WARNING:**

This record contains Sensitive Security Information that is controlled under 49 CFR parts 15 and 1520. No part of this record may be disclosed to persons with a "need to know," as defined in 49 CFR parts 15 and 1520, except with the written permission of the Administrator of the Transportation Security Administration or the Secretary of Transportation. Unauthorized release may result in civil penalty or other action. For U.S. government agencies, public disclosure is governed by 5 U.S.C. 552 and 49 CFR parts 15 and 1520.



08-23-2024

THESE SHEETS ARE ISSUED FOR GRAPHICAL INFORMATION ONLY

**2.4 DESIGN INTENT - REGULATORY SIGNS**

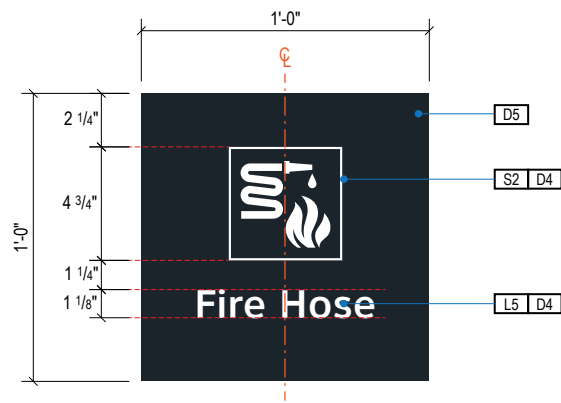
ILLUMINATION	SIGN TYPE	SIGN FUNCTION	MOUNTING METHOD	GENERAL DESCRIPTION & USE
NON-ILLUMINATED	5-LE.21	IDENTIFICATION	WALL	Fire Device ID

**GENERAL NOTES**


- All final design, engineering & amount/sizing of structural sign support elements, material types/thicknesses, dimensions and attachment methods shall be performed and approved by a licensed engineer to meet or exceed all applicable local and national codes.
- Final engineering, dimensions, materials and fabrication are the responsibility of the Contractor/Fabricator/Installer to ensure the highest quality fit and finish for all components of the completed product. All final detailing and specifications to be provided by the Contractor/Fabricator/Installer within their final approved fabrication-ready shop drawings.
- Wherever dissimilar metals are in contact, always separate contact surfaces prior to assembly or installation with the necessary protective coatings/gaskets/washers to prevent galvanic corrosion.
- Final fabrication methods, quality and fit / finish to be reviewed & approved by HAS and the Wayfinding Design Consultants thru prototype reviews prior to final production run / installation processes.
- Colors shown are for reference only, and are subject to the limitations of the printing process and / or variance of electronic RGB screen displays. Refer to color system swatches and/or final finish samples for accurate reference.
- Messages shown here are typical placeholders only. See message schedules for specific messaging by location & sign type.

**DESIGN INTENT NOTES**


- F1** SIGN PANEL: 1/8" thick aluminum sign panel; graphics to be full bleed-digital print on 3M vinyl film & applied to faces
- F2** MOUNTING: mechanically fasten sign panels to surface with stainless steel tamper-proof mechanical fasteners as install conditions require (fabricator to field verify); paint heads to match sign face. NOTE: Fabricator to use proper connection gaskets/seals/etc. to eliminate corrosion from mounting surface and weather conditions as install locations require.



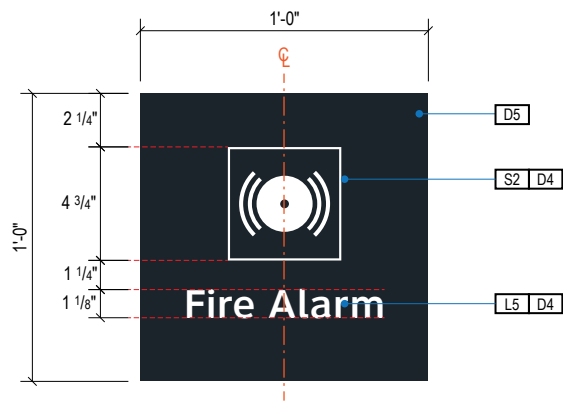**1** FACE LAYOUT: 5-LE.21a  
Scale: 1 1/2" = 1'-0"



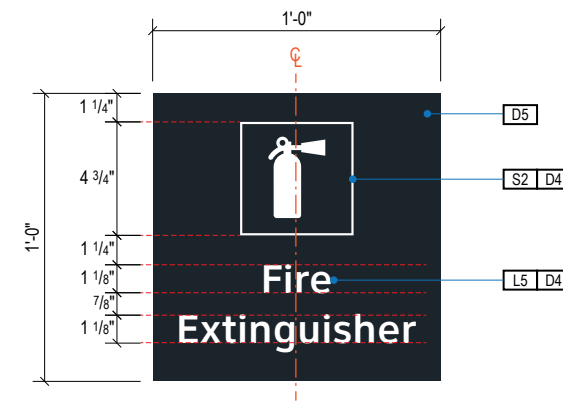**2** FACE LAYOUT: 5-LE.21b  
Scale: 1 1/2" = 1'-0"



**3** FACE LAYOUT: 5-LE.21c  
Scale: 1 1/2" = 1'-0"

- LETTERING (TYPEFACES) / SYMBOLS / ARROWS:**
- L5** Pedestrian Wayfinding Typeface: ClearviewText Medium
  - S1** Arrow(s): use only official HAS wayfinding arrows
  - S2** Universal Symbols: use only official HAS wayfinding symbols

- COLORS:**
- NOTES: "D" = digitally printed colors on 3M 7725-20 White unless otherwise noted; "P" = Matthews Acrylic Polyurethane (MAP) paint (or equal), satin finish; "V" = 3M vinyl films (or equal); "T" = tactile
- D4** White: C:0 M:0 Y:0 K:0
  - D5** Dark Gray: match PMS 433C
  - D9** Black: C:50 M:40 Y:40 K:100
  - D11** Warning Yellow: match PMS116C
  - D17** C Blue: match PMS 300C


ILLUMINATION	SIGN TYPE	SIGN FUNCTION	MOUNTING METHOD	GENERAL DESCRIPTION & USE
NON-ILLUMINATED	5-RG.21, 5-RG.22, 5-RG.23	REGULATORY	WALL	Parking Regulatory Signage

**GENERAL NOTES**

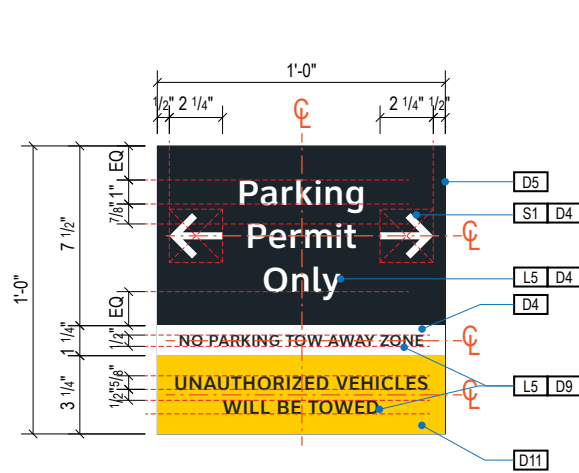
- All final design, engineering & amount/size of structural sign support elements, material types/thicknesses, dimensions and attachment methods shall be performed and approved by a licensed engineer to meet or exceed all applicable local and national codes.
- Final engineering, dimensions, materials and fabrication are the responsibility of the Contractor/Fabricator/Installer to ensure the highest quality fit and finish for all components of the completed product. All final detailing and specifications to be provided by the Contractor/Fabricator/Installer within their final approved fabrication-ready shop drawings.
- Wherever dissimilar metals are in contact, always separate contact surfaces prior to assembly or installation with the necessary protective coatings/gaskets/washers to prevent galvanic corrosion.
- Final fabrication methods, quality and fit / finish to be reviewed & approved by HAS and the Wayfinding Design Consultants thru prototype reviews prior to final production run / installation processes.
- Colors shown are for reference only, and are subject to the limitations of the printing process and / or variance of electronic RGB screen displays. Refer to color system swatches and/or final finish samples for accurate reference.
- Messages shown here are typical placeholders only. See message schedules for specific messaging by location & sign type.

**DESIGN INTENT NOTES**


- F1** SIGN PANEL: 1/8" thick aluminum sign panel; graphics to be full bleed-digital print on 3M vinyl film & applied to faces
- F2** MOUNTING: mechanically fasten sign panels to surface with stainless steel tamper-proof mechanical fasteners as install conditions require (fabricator to field verify); paint heads to match sign face. NOTE: Fabricator to use proper connection gaskets/seals/etc. to eliminate corrosion from mounting surface and weather conditions as install locations require.



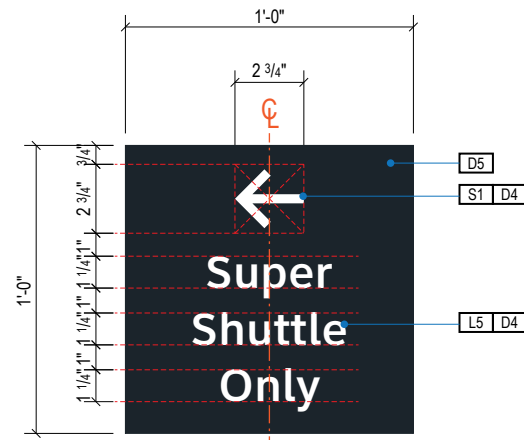**1** FACE LAYOUT: 5-RG.21 (Parking Regulatory)  
Scale: 1 1/2" = 1'-0"



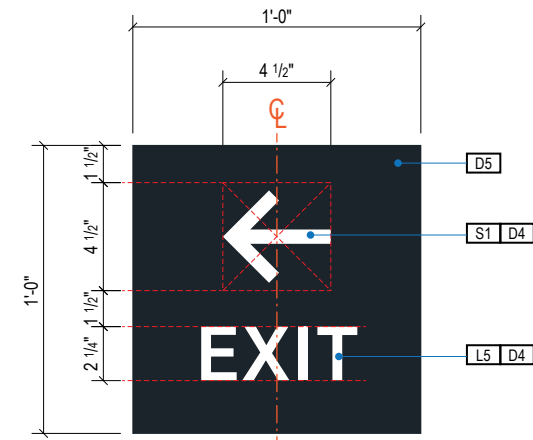**2** FACE LAYOUT: 5-RG.22 (Shuttle Regulatory)  
Scale: 1 1/2" = 1'-0"



**3** FACE LAYOUT: 5-RG.23 (Exit)  
Scale: 1 1/2" = 1'-0"

- LETTERING (TYPEFACES) / SYMBOLS / ARROWS:**
- L5** Pedestrian Wayfinding Typeface: ClearviewText Medium
  - S1** Arrow(s): use only official HAS wayfinding arrows
  - S2** Universal Symbols: use only official HAS wayfinding symbols


- COLORS:**
- NOTES: "D" = digitally printed colors on 3M 7725-20 White unless otherwise noted; "P" = Matthews Acrylic Polyurethane (MAP) paint (or equal), satin finish; "V" = 3M vinyl films (or equal); "T" = tactile
- D4** White: C:0 M:0 Y:0 K:0
  - D5** Dark Gray: match PMS 433C
  - D9** Black: C:50 M:40 Y:40 K:100
  - D11** Warning Yellow: match PMS116C
  - D17** C Blue: match PMS 300C

# 3.0

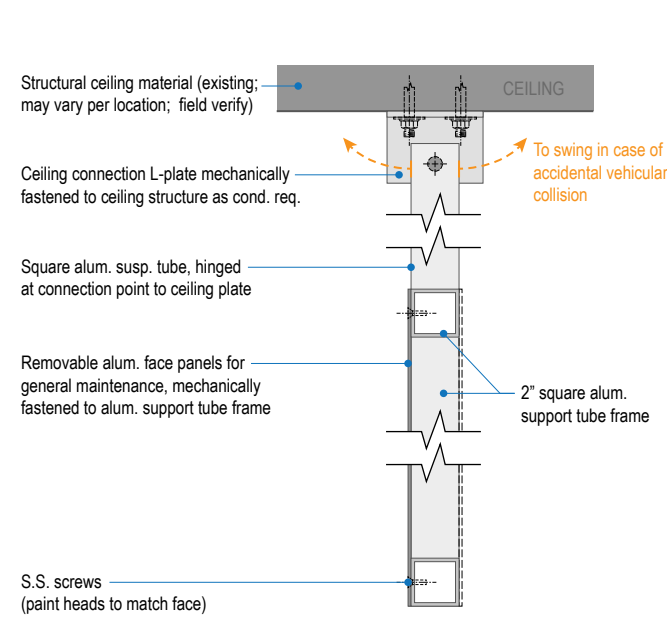
## **3.0 DESIGN INTENT - SIGNAGE DETAILS**

- 3.1 Details - Parking Garage Signs






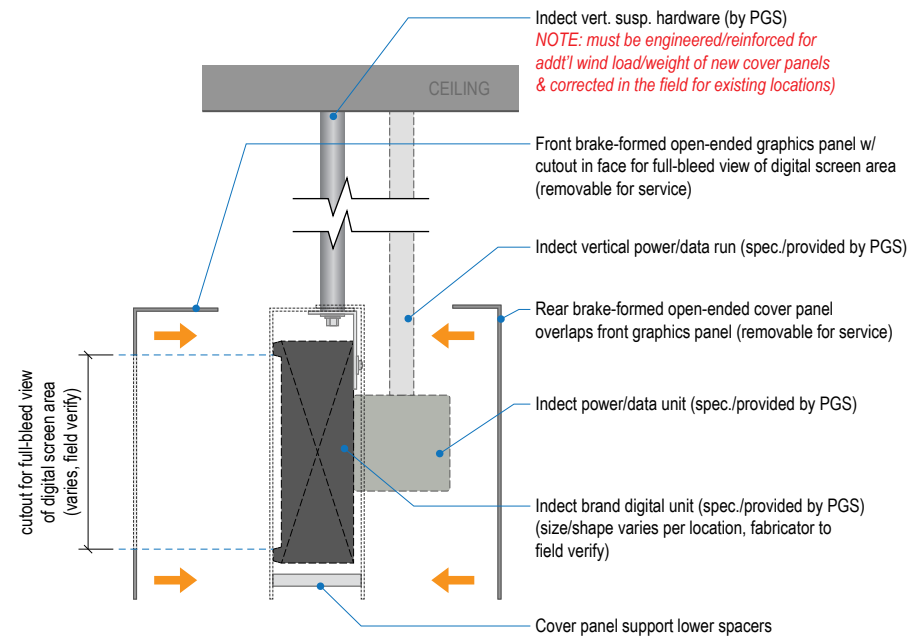
**A** SECTION CUT DETAIL: Ceiling Susp. w/ Static Face Panels  
Scale: 1 1/2" = 1'-0"



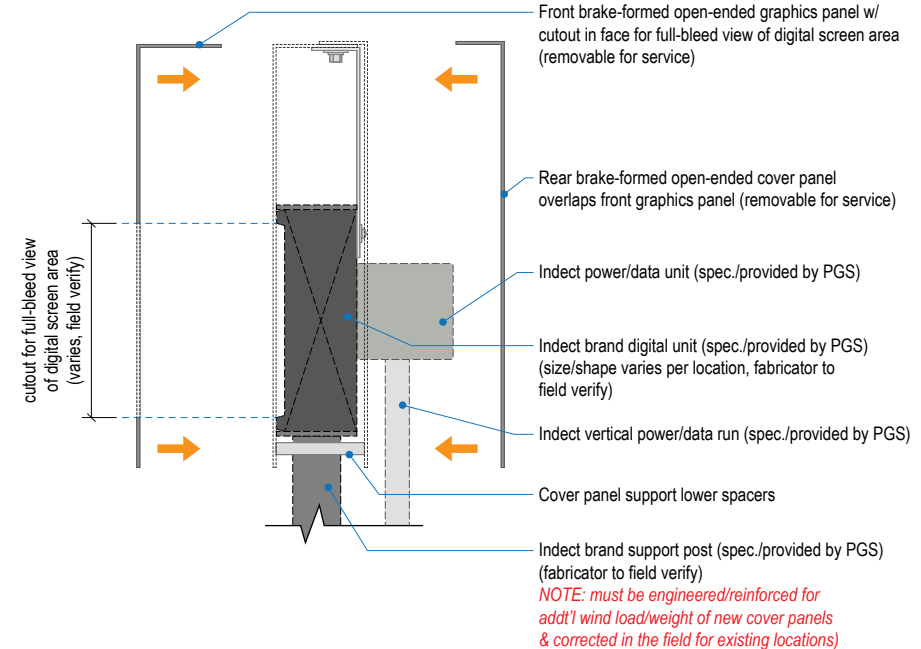**B1** END VIEW DETAIL: Cover Panels on Ceiling Susp. APGS Indect Digital Units  
Scale: 1 1/2" = 1'-0"



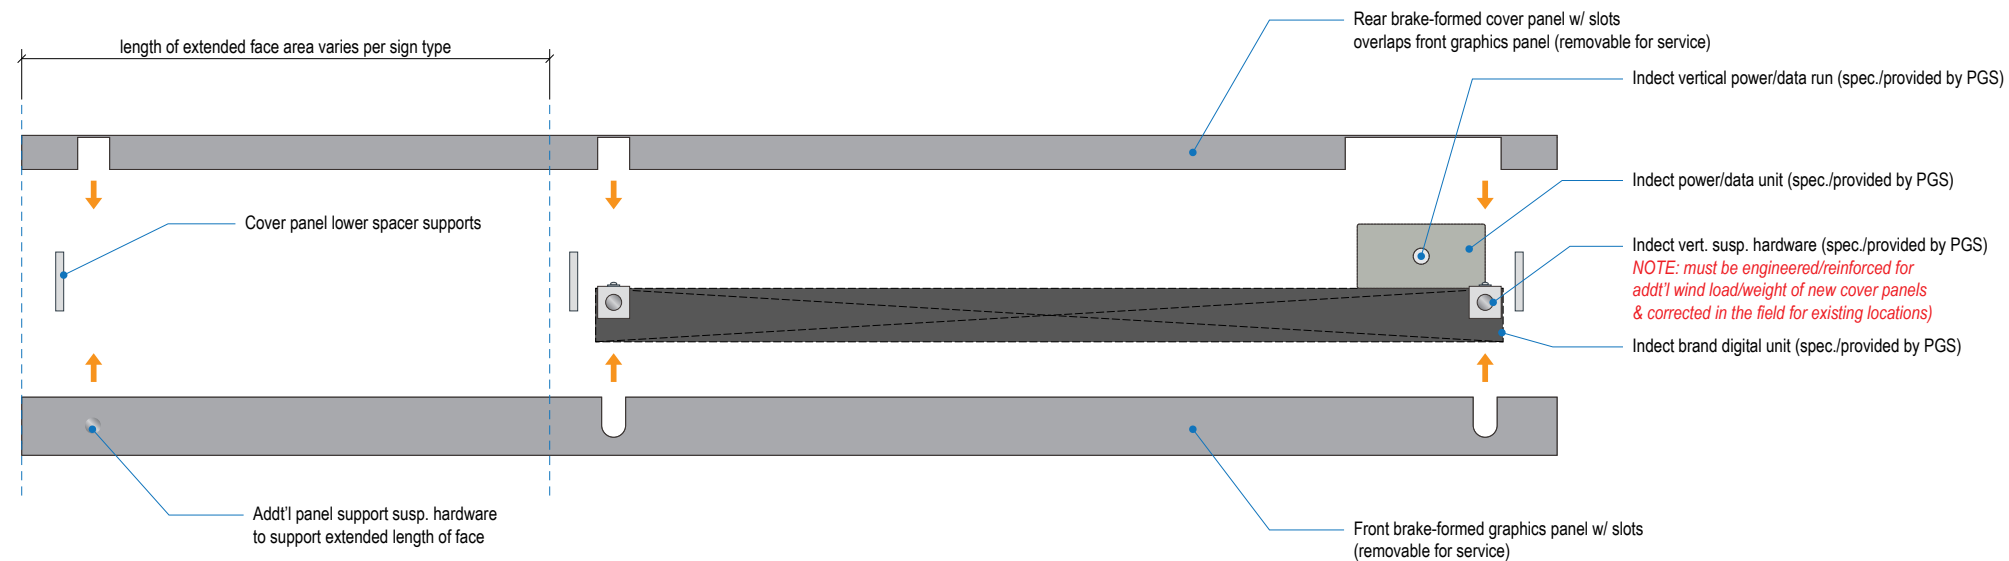
**B2** END VIEW DETAIL: Cover Panels on Post Mt. APGS Indect Digital Units  
Scale: 1 1/2" = 1'-0"




**B3** PLAN VIEW DETAIL: Cover Panels on APGS Indect Digital Units  
Scale: 1" = 1'-0"

GENERAL NOTES

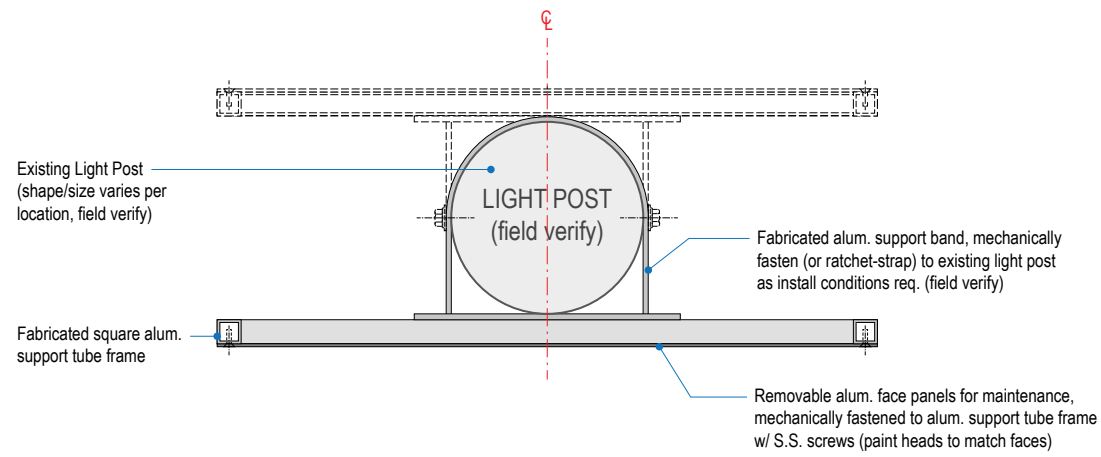
- All final design, engineering & amount/sizing of structural sign support elements, material types/thicknesses, dimensions and attachment methods shall be performed and approved by a licensed engineer to meet or exceed all applicable local and national codes.
- Final engineering, dimensions, materials and fabrication are the responsibility of the Contractor/Fabricator/Installer to ensure the highest quality fit and finish for all components of the completed product. All final detailing and specifications to be provided by the Contractor/Fabricator/Installer within their final approved fabrication-ready shop drawings.
- Wherever dissimilar metals are in contact, always separate contact surfaces prior to assembly or installation with the necessary protective coatings/gaskets/washers to prevent galvanic corrosion.
- Final fabrication methods, quality and fit/finish to be reviewed & approved by HAS and the Wayfinding Design Consultants thru prototype reviews prior to final production run/installation processes.
- Colors shown are for reference only, and are subject to the limitations of the printing process and/or variance of electronic RGB screen displays. Refer to color system swatches and approved finish samples for accurate reference.
- Messages shown here are typical placeholders only. See message schedules for specific messaging by location & sign type.



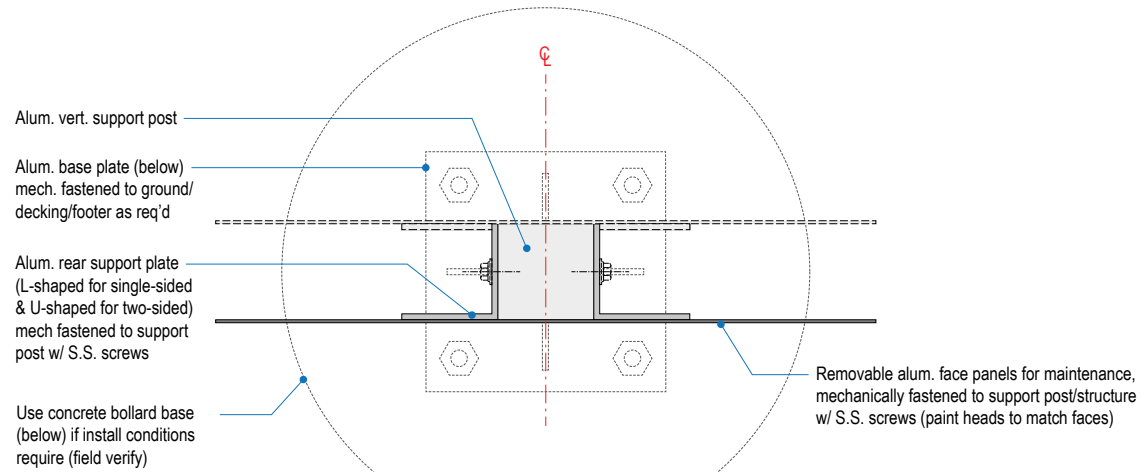
**C** SECTION CUT DETAIL: Light Post Mount ID Panels  
Scale: 1 1/2" = 1'-0"



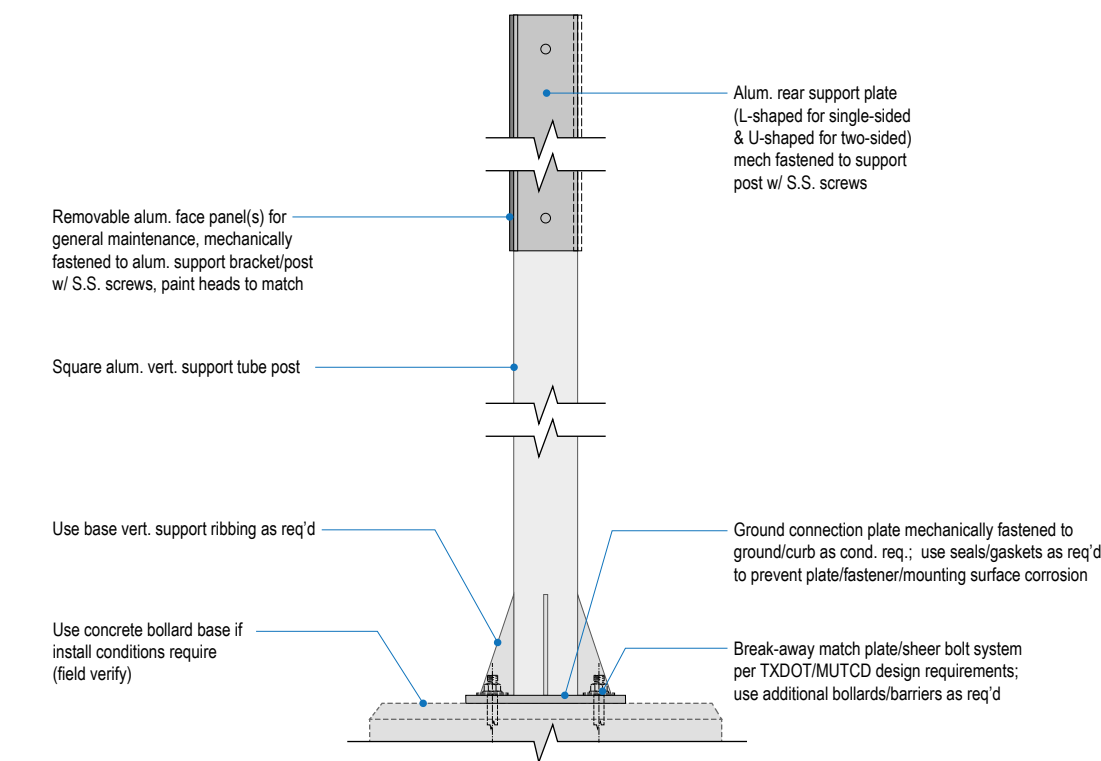**D** SECTION CUT DETAIL: Post Mount ID Panels  
Scale: 1 1/2" = 1'-0"



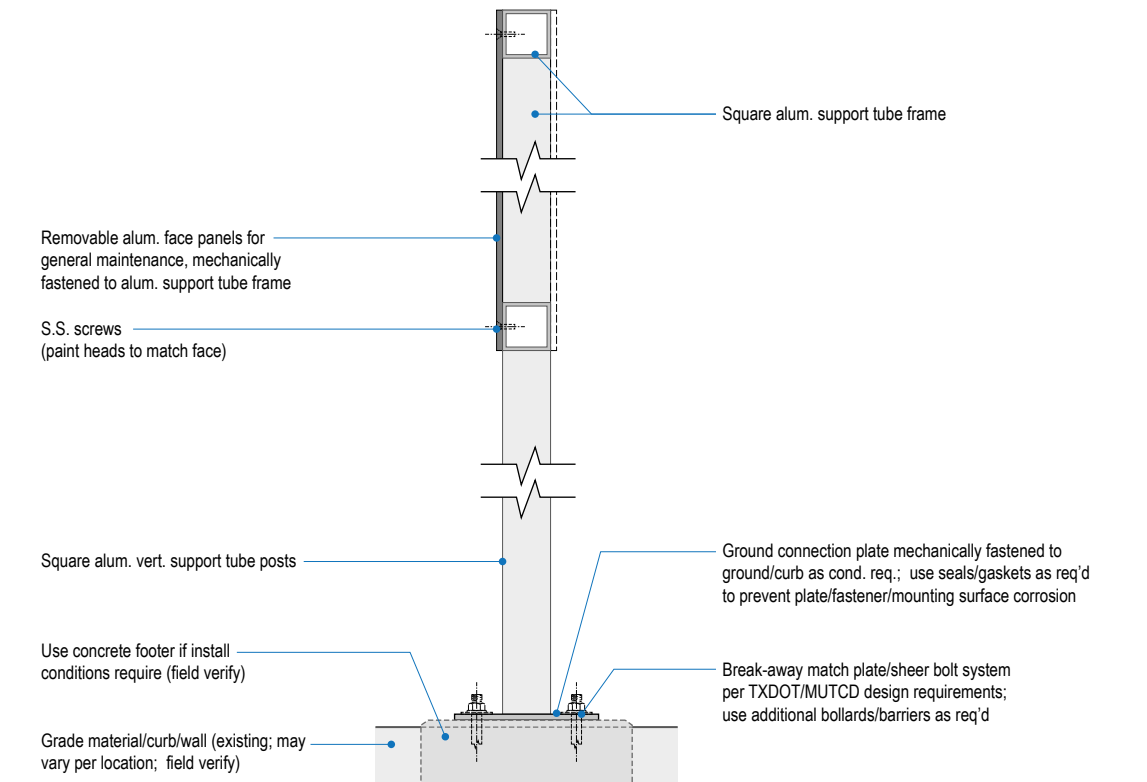**E** SECTION CUT DETAIL: Post Mount Section ID w/ Static Panel(s)  
Scale: 1" = 1'-0"



**F** SECTION CUT DETAIL: Post Mount w/ Static Panels  
Scale: 1 1/2" = 1'-0"

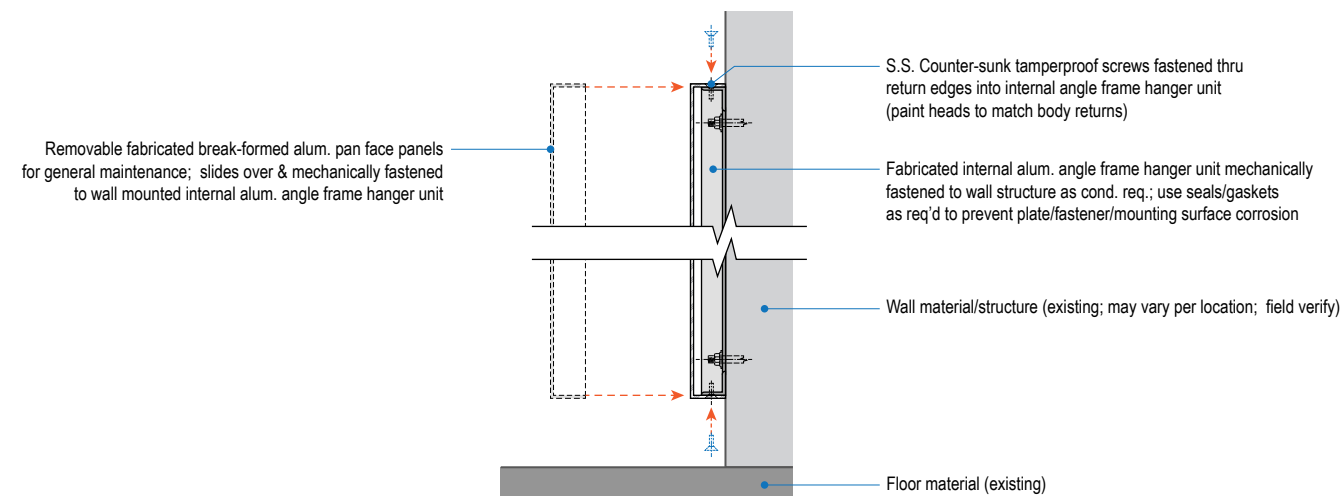
GENERAL NOTES

- All final design, engineering & amount/sizing of structural sign support elements, material types/thicknesses, dimensions and attachment methods shall be performed and approved by a licensed engineer to meet or exceed all applicable local and national codes.
- Final engineering, dimensions, materials and fabrication are the responsibility of the Contractor/Fabricator/Installer to ensure the highest quality fit and finish for all components of the completed product. All final detailing and specifications to be provided by the Contractor/Fabricator/Installer within their final approved fabrication-ready shop drawings.
- Wherever dissimilar metals are in contact, always separate contact surfaces prior to assembly or installation with the necessary protective coatings/gaskets/washers to prevent galvanic corrosion.
- Final fabrication methods, quality and fit/finish to be reviewed & approved by HAS and the Wayfinding Design Consultants thru prototype reviews prior to final production run/installation processes.
- Colors shown are for reference only, and are subject to the limitations of the printing process and/or variance of electronic RGB screen displays. Refer to color system swatches and approved finish samples for accurate reference.
- Messages shown here are typical placeholders only. See message schedules for specific messaging by location & sign type.


**NOTE:**  
Fabricator/Contractor/Installer and licensed Engineer to verify & provide buy-off that existing light posts within C and D/E Garage's roof level areas are capable of supporting the additional weight and wind-loads of new wayfinding signage applied to them.

GENERAL NOTES


- All final design, engineering & amount/sizing of structural sign support elements, material types/thicknesses, dimensions and attachment methods shall be performed and approved by a licensed engineer to meet or exceed all applicable local and national codes.
- Final engineering, dimensions, materials and fabrication are the responsibility of the Contractor/Fabricator/Installer to ensure the highest quality fit and finish for all components of the completed product. All final detailing and specifications to be provided by the Contractor/Fabricator/Installer within their final approved fabrication-ready shop drawings.
- Wherever dissimilar metals are in contact, always separate contact surfaces prior to assembly or installation with the necessary protective coatings/gaskets/washers to prevent galvanic corrosion.
- Final fabrication methods, quality and fit/finish to be reviewed & approved by HAS and the Wayfinding Design Consultants thru prototype reviews prior to final production run/installation processes.
- Colors shown are for reference only, and are subject to the limitations of the printing process and/or variance of electronic RGB screen displays. Refer to color system swatches and approved finish samples for accurate reference.
- Messages shown here are typical placeholders only. See message schedules for specific messaging by location & sign type.



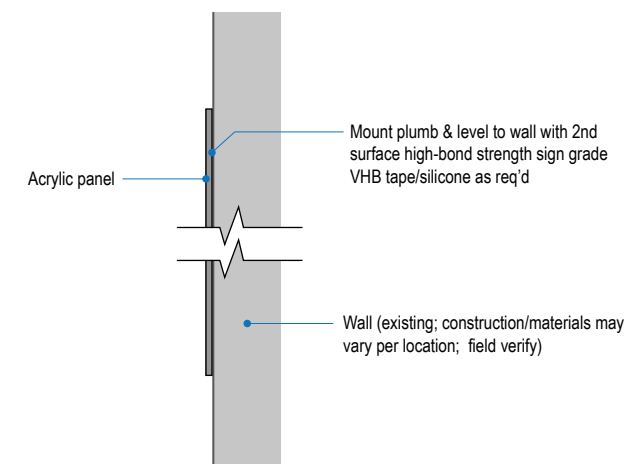
**G** SECTION CUT DETAIL: Wall Mount Large Level IDs  
Scale: 1 1/2" = 1'-0"



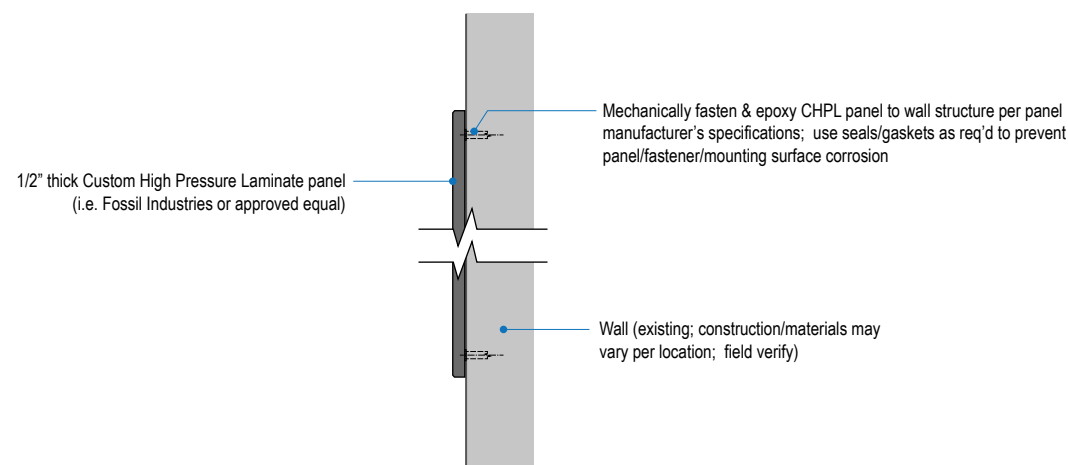**H** SECTION CUT DETAIL: Wall Mount IDs  
Scale: 1 1/2" = 1'-0"



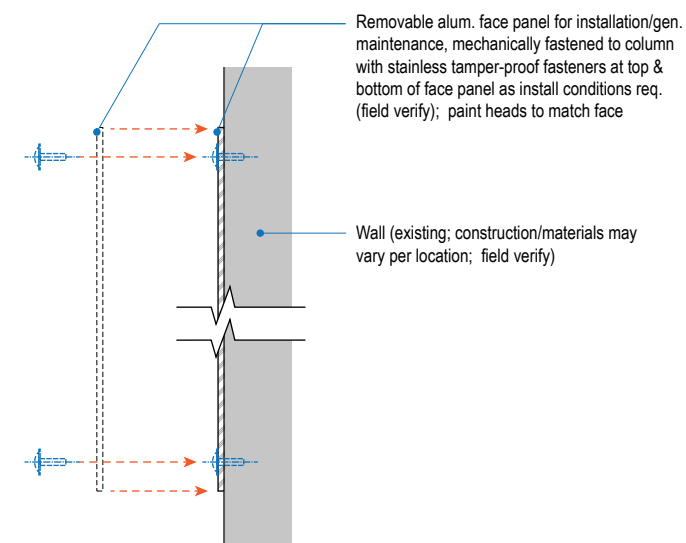
**I** SECTION CUT DETAIL: Wall Mount - CHPL Panels  
Scale: 1 1/2" = 1'-0"



**J** SECTION CUT DETAIL: Wall Mount IDs  
Scale: 1 1/2" = 1'-0"

# 4.0
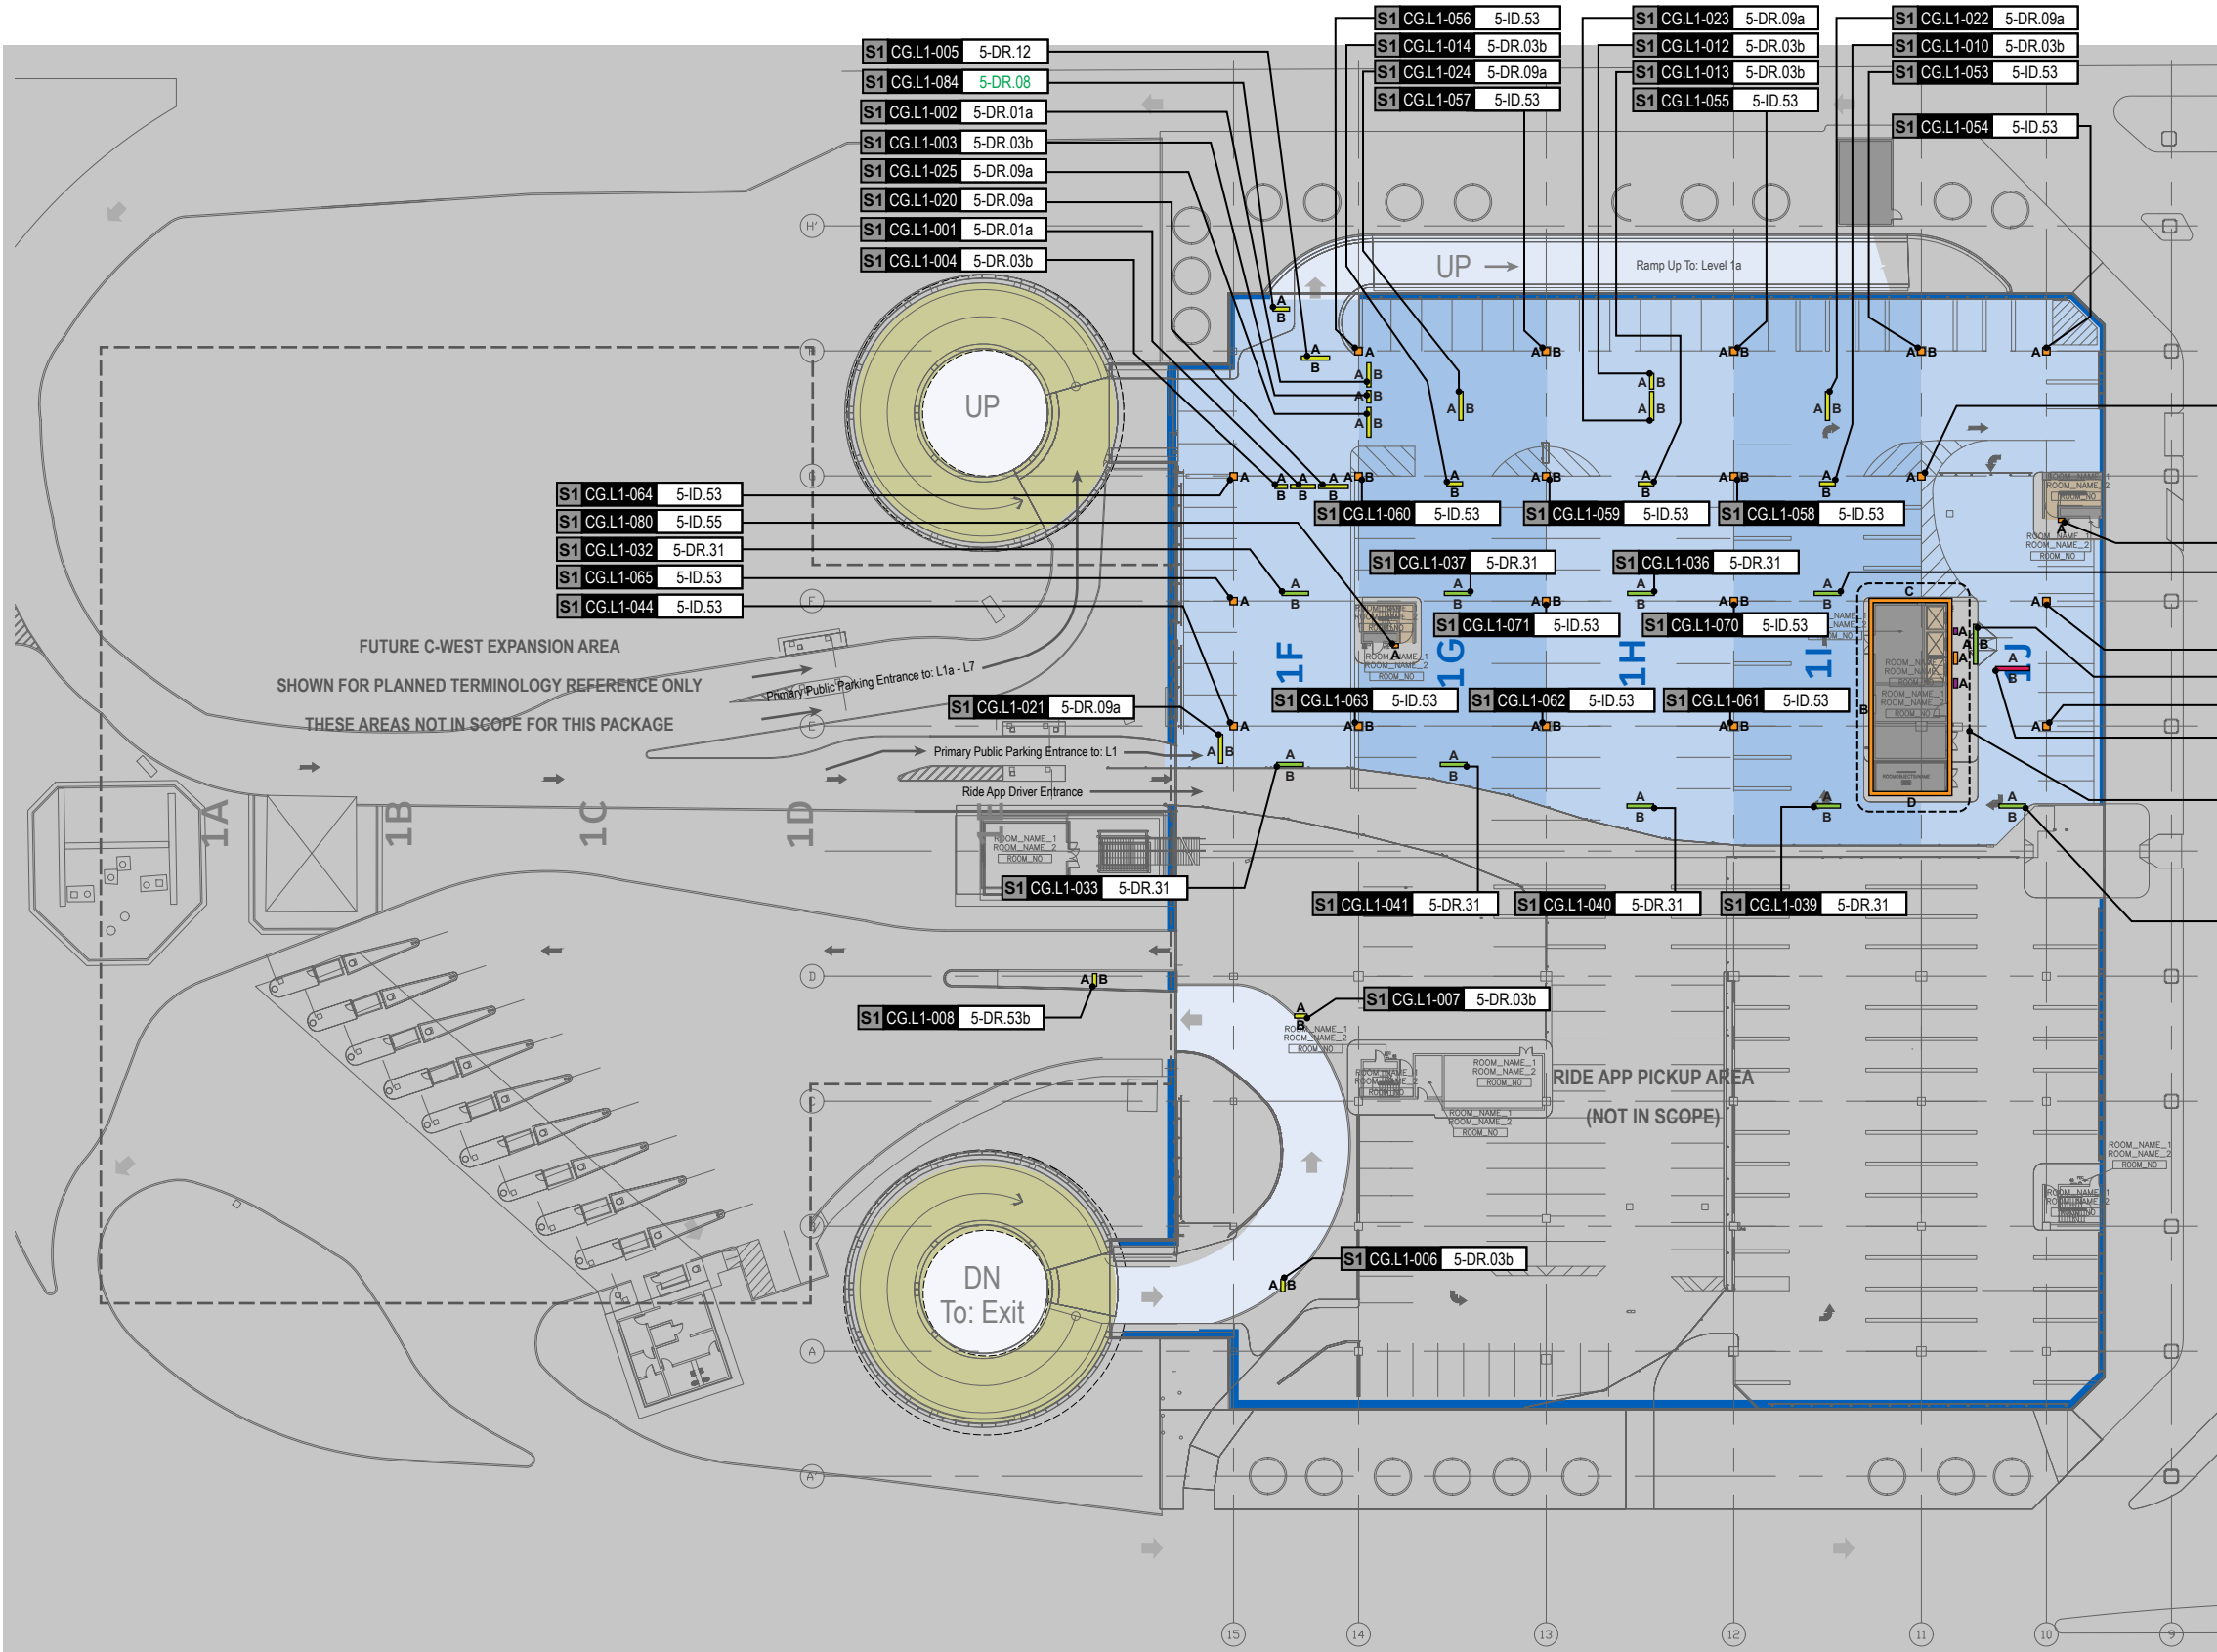
## **4.0 LOCATION PLANS & MESSAGE SCHEDULES: LEVELS 1 AND 1A**




**GENERAL NOTES**

- Sign locations & orientations shown here are approximations based on the most current plan drawings as provided to the designer by the architect at the time of this document's completion. These sign locations are for general design intent & wayfinding planning purposes only. They should not be construed or deemed as absolute or final locations. Field verification, marking & documentation of each final location is to be performed by the Fabricator/Installer & coordinated with project staff & Wayfinding Design Consultants for final approval.
- All final install locations must be marked and verified in the field for proper structural integrity, adequate line of sight, utilities / property-line / other existing signage interferences & must be in complete compliance with all local, state and national codes prior to fabrication or installation.
- Adjustments to the sign locations shown in these drawings must be documented by the Fabricator/Installer, and provided to project staff & Wayfinding Design Consultants for final approval.

**NOTE:** Only priority wayfinding signage & locations as shown in this wayfinding plan package are in scope. All other signage not shown (including traffic control) are **NOT IN SCOPE** for this project/contract.

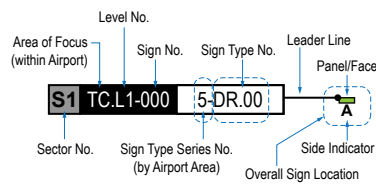**SIGN LOCATION ANNOTATION LEGEND**




- LOCATION CODE DEFINITIONS:**
- AREA OF FOCUS:** (location within Airport)  
 TA = Terminal A  
 TB = Terminal B  
 TC = Terminal C  
 TD = Terminal D  
 TE = Terminal E  
 AB = AB Garage  
 CG = C Garage  
 DE = DE Garage
- SIGN TYPE SERIES NO.:** (by Airport Area)  
 1- = Terminals/Concourses  
 1t- = Terminals/Concourses: Temporary  
 2- = CBP Areas  
 3- = Curbside/Ground Trans.  
 4- = Roadways  
 5- = Parking
- WAYFINDING SIGN TYPE:**  
 DR.xx = Directional  
 ID.xx = Identification  
 IN.xx = Informational

- WAYFINDING SIGN LOCATIONS - Parking:**
- PEDESTRIAN Signs:**  
 A = Directional (DR)  
 B = Identification (ID)  
 A/B = Informational (IN)
- VEHICULAR Signs:**  
 A = Directional (DR)  
 B = Identification (ID)  
 A/B = Informational (IN)


- CIRCULATION:**
- Public Use PEDESTRIAN Vertical Circulation (i.e. Elevators/Escalators/Stairs)
  - Public Use VEHICULAR Vertical Circulation (i.e. Ramps)
  - Alpha-Numeric Parking Section Naming Areas (Blues = C Garages; Oranges = D/E Garage)
  - Areas Not In Scope for this Package

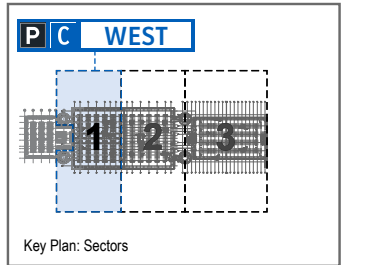LOCATION PLAN SCALE: 1" = 60'




**4.1 SIGN LOCATION PLAN - GARAGE C: LEVEL 1 - SECTOR 1 (C WEST)**

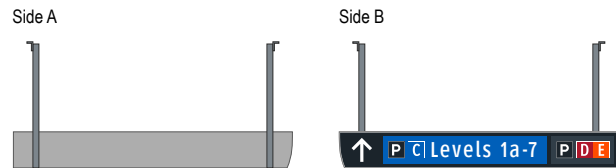
S1 CG.L1-001 5-DR.01a Notes: N/A




S1 CG.L1-005 5-DR.12 Notes: N/A

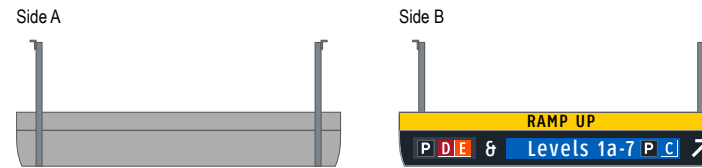


S1 CG.L1-002 5-DR.01a Notes: N/A

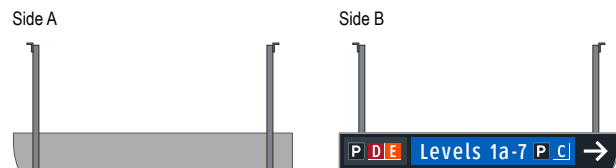


S1 CG.L1-006 5-DR.03b Notes: N/A

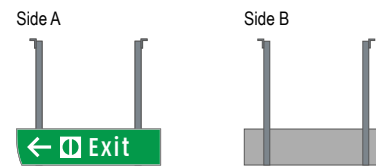


S1 CG.L1-003 5-DR.03b Notes: N/A

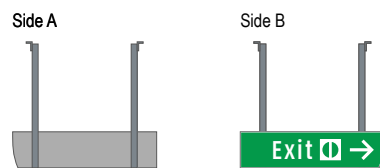


S1 CG.L1-007 5-DR.03b Notes: N/A

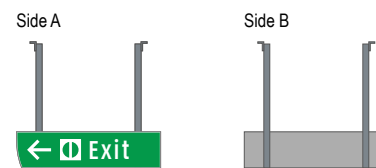

S1 CG.L1-004 5-DR.03b Notes: N/A

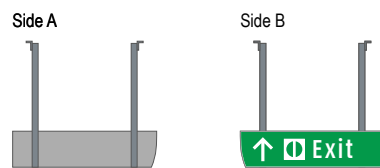


S1 CG.L1-008 5-DR.53b Notes: N/A

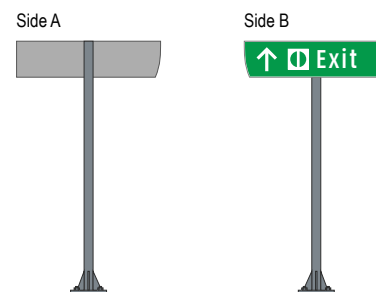


S1 CGL1-009 N/A Notes: N/A

NOT USED

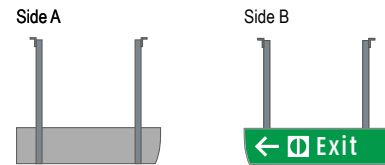
S1 CGL1-013 5-DR.03b Notes: N/A



S1 CGL1-010 5-DR.03b Notes: N/A

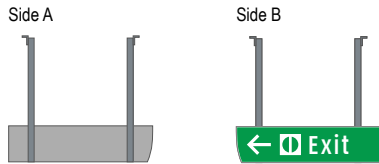

S1 CGL1-014 5-DR.03b Notes: N/A

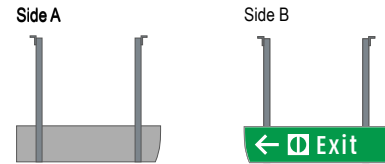


S1 CGL1-011 N/A Notes: N/A

NOT USED

S1 CGL1-015 N/A Notes: N/A

NOT USED

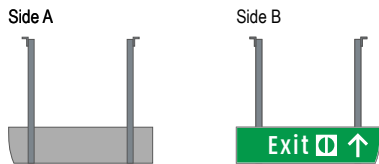S1 CGL1-012 5-DR.03b Notes: N/A



S1 CGL1-016 N/A Notes: N/A

NOT USED

S1 CGL1-017 N/A Notes: N/A

NOT USED

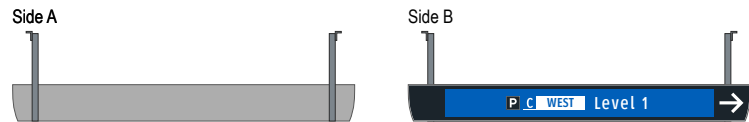
S1 CGL1-018 N/A Notes: N/A

NOT USED


S1 CGL1-019 N/A Notes: N/A

NOT USED


S1 CGL1-020 5-DR.09a Notes: N/A




S1 CGL1-021 5-DR.09a Notes: N/A

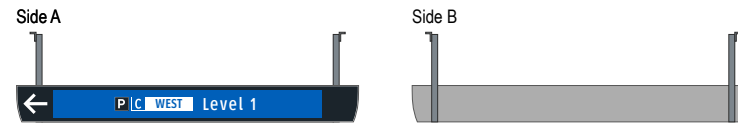


S1 CGL1-022 5-DR.09a Notes: N/A

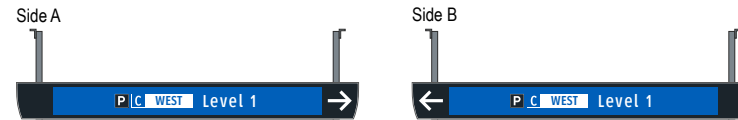

S1 CGL1-023 5-DR.09a Notes: N/A

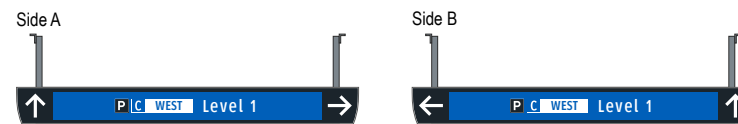

S1 CGL1-024 5-DR.09a Notes: N/A

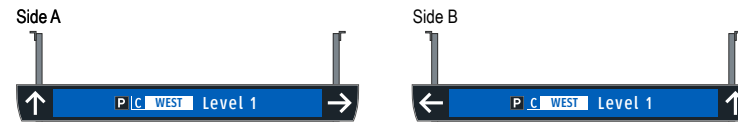

**Wayfinding Updates**

Issue Date: 08-23-2024

**Issue for Bid**

- REV. 
- REV. 
- REV. 

**WARNING:**

This record contains Sensitive Security Information that is controlled under 49 CFR parts 15 and 1520. No part of this record may be disclosed to persons with a "need to know," as defined in 49 CFR parts 15 and 1520, except with the written permission of the Administrator of the Transportation Security Administration or the Secretary of Transportation. Unauthorized release may result in civil penalty or other action. For U.S. government agencies, public disclosure is governed by 5 U.S.C. 552 and 49 CFR parts 15 and 1520.



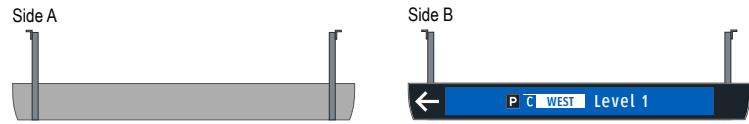
THESE SHEETS ARE ISSUED FOR GRAPHICAL INFORMATION ONLY

**4.2 MESSAGE SCHEDULE - GARAGE C: LEVEL 1 - SECTOR 1 (C WEST)**

BSG PRJCT# BSG-2024-111-IAH  
 HAS TIP # 24 -103 - IAH



S1 CG.L1-025 5-DR.09a Notes: N/A



S1 CG.L1-029 N/A Notes: N/A

NOT USED

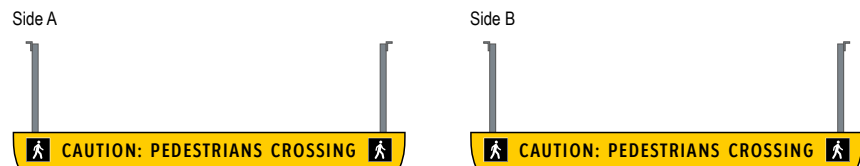
S1 CG.L1-026 N/A Notes: N/A

NOT USED

S1 CG.L1-030 N/A Notes: N/A

NOT USED

S1 CG.L1-027 5-ID.07 Notes: N/A




S1 CG.L1-031 N/A Notes: N/A

NOT USED

S1 CG.L1-028 N/A Notes: N/A

NOT USED

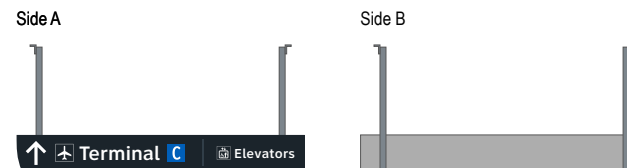S1 CG.L1-032 5-DR.31 Notes: N/A



**Wayfinding Updates**

Issue Date: 08-23-2024  
Issue for Bid

- REV. 
- REV. 
- REV. 

**WARNING:**

This record contains Sensitive Security Information that is controlled under 49 CFR parts 15 and 1520. No part of this record may be disclosed to persons with a "need to know," as defined in 49 CFR parts 15 and 1520, except with the written permission of the Administrator of the Transportation Security Administration or the Secretary of Transportation. Unauthorized release may result in civil penalty or other action. For U.S. government agencies, public disclosure is governed by 5 U.S.C. 552 and 49 CFR parts 15 and 1520.

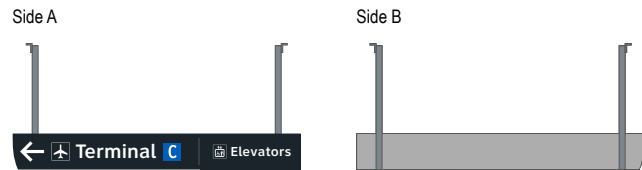


THESE SHEETS ARE ISSUED FOR GRAPHICAL INFORMATION ONLY


**4.2 MESSAGE SCHEDULE - GARAGE C: LEVEL 1 - SECTOR 1 (C WEST)**

BSG PRJCT# BSG-2024-111-IAH  
HAS TIP # 24 -103 - IAH


S1 CGL1-033 5-DR.31 Notes: N/A




S1 CGL1-037 5-DR.31 Notes: N/A

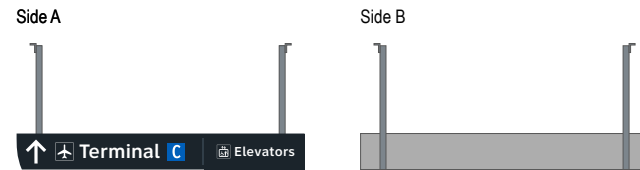

S1 CGL1-034 5-DR.31 Notes: N/A

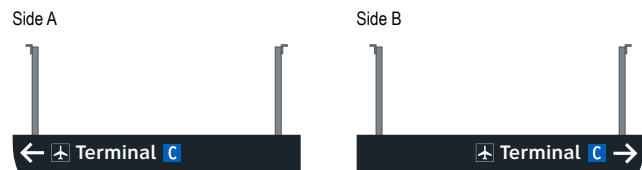


S1 CGL1-038 5-DR.31 Notes: N/A

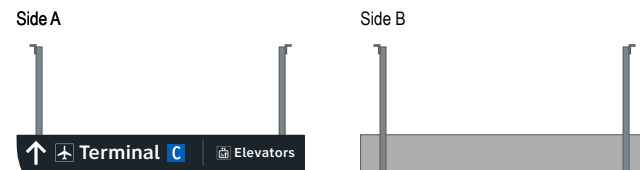


S1 CGL1-035 N/A Notes: N/A

NOT USED

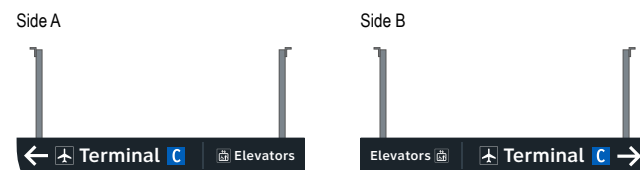
S1 CGL1-039 5-DR.31 Notes: N/A



S1 CGL1-036 5-DR.31 Notes: N/A

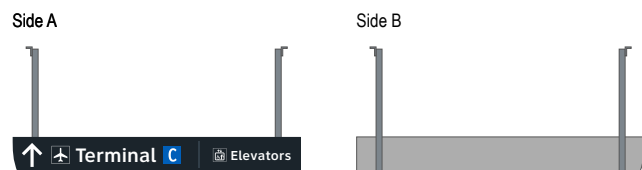

S1 CGL1-040 5-DR.31 Notes: N/A

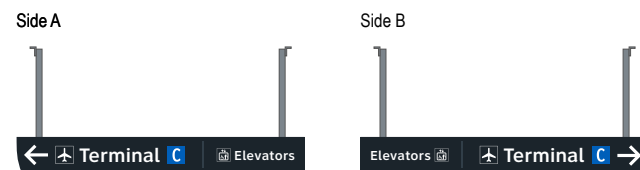

**Wayfinding Updates**

Issue Date: 08-23-2024

**Issue for Bid**

- REV. 
- REV. 
- REV. 

**WARNING:**

This record contains Sensitive Security Information that is controlled under 49 CFR parts 15 and 1520. No part of this record may be disclosed to persons with a "need to know," as defined in 49 CFR parts 15 and 1520, except with the written permission of the Administrator of the Transportation Security Administration or the Secretary of Transportation. Unauthorized release may result in civil penalty or other action. For U.S. government agencies, public disclosure is governed by 5 U.S.C. 552 and 49 CFR parts 15 and 1520.



THESE SHEETS ARE ISSUED FOR GRAPHICAL INFORMATION ONLY

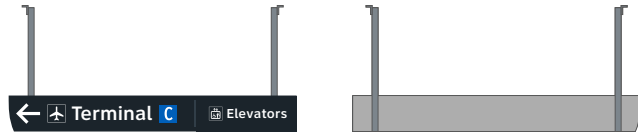
**4.2 MESSAGE SCHEDULE - GARAGE C: LEVEL 1 - SECTOR 1 (C WEST)**

BSG PRJCT# BSG-2024-111-IAH  
 HAS TIP # 24 -103 - IAH

S1 CG.L1-041 5-DR.31 Notes: N/A

Side A

Side B



S1 CG.L1-045 N/A Notes: N/A

NOT USED

S1 CG.L1-042 N/A Notes: N/A

NOT USED

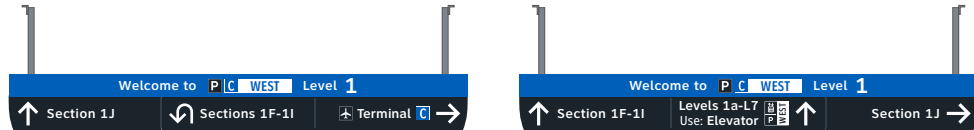
S1 CG.L1-046 N/A Notes: N/A

NOT USED

S1 CG.L1-043 5-DR.34 Notes: N/A

Side A

Side B




S1 CG.L1-047 N/A Notes: N/A

NOT USED

S1 CG.L1-044 5-ID.53 Notes: N/A

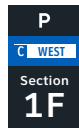Side A



S1 CG.L1-048 N/A Notes: N/A

NOT USED

**Wayfinding Updates**

Issue Date: 08-23-2024  
Issue for Bid

- REV. 
- REV. 
- REV. 

**WARNING:**

This record contains Sensitive Security Information that is controlled under 49 CFR parts 15 and 1520. No part of this record may be disclosed to persons with a "need to know," as defined in 49 CFR parts 15 and 1520, except with the written permission of the Administrator of the Transportation Security Administration or the Secretary of Transportation. Unauthorized release may result in civil penalty or other action. For U.S. government agencies, public disclosure is governed by 5 U.S.C. 552 and 49 CFR parts 15 and 1520.



THESE SHEETS ARE ISSUED FOR GRAPHICAL INFORMATION ONLY

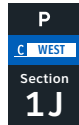
**4.2 MESSAGE SCHEDULE - GARAGE C: LEVEL 1 - SECTOR 1 (C WEST)**

BSG PRJCT# BSG-2024-111-IAH  
HAS TIP # 24 -103 - IAH


NOT USED

NOT USED


Side A




Side A

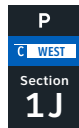


Side A

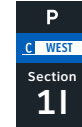


Side B

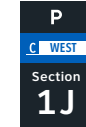


Side A

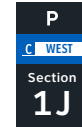


Side A

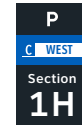

Side B

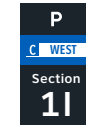

Side A

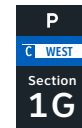

Wayfinding Updates

Issue Date: 08-23-2024

Issue for Bid

- REV. A
REV. A
REV. A

WARNING:

This record contains Sensitive Security Information that is controlled under 49 CFR parts 15 and 1520. No part of this record may be disclosed to persons with a "need to know," as defined in 49 CFR parts 15 and 1520, except with the written permission of the Administrator of the Transportation Security Administration or the Secretary of Transportation. Unauthorized release may result in civil penalty or other action. For U.S. government agencies, public disclosure is governed by 5 U.S.C. 552 and 49 CFR parts 15 and 1520.



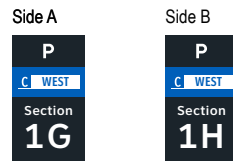
08-23-2024

THESE SHEETS ARE ISSUED FOR GRAPHICAL INFORMATION ONLY


4.2 MESSAGE SCHEDULE - GARAGE C: LEVEL 1 - SECTOR 1 (C WEST)

BSG PRJCT# BSG-2024-111-IAH
HAS TIP # 24 -103 - IAH


S1 CG.L1-057 5-ID.53 Notes: N/A




S1 CG.L1-061 5-ID.53 Notes: N/A

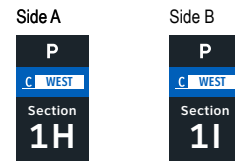


S1 CG.L1-058 5-ID.53 Notes: N/A

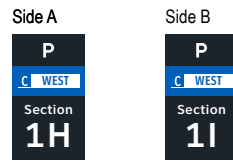


S1 CG.L1-062 5-ID.53 Notes: N/A

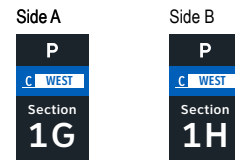


S1 CG.L1-059 5-ID.53 Notes: N/A

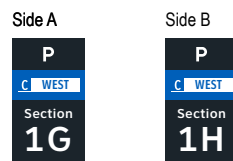


S1 CG.L1-063 5-ID.53 Notes: N/A

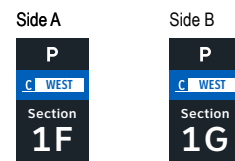

S1 CG.L1-060 5-ID.53 Notes: N/A

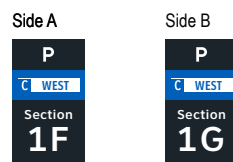


S1 CG.L1-064 5-ID.53 Notes: N/A

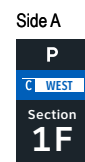


S1 CG.L1-065 5-ID.53 Notes: N/A

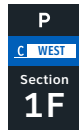Side A



S1 CG.L1-069 5-ID.53 Notes: N/A

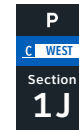Side A




S1 CG.L1-066 N/A Notes: N/A


NOT USED

S1 CG.L1-070 5-ID.53 Notes: N/A

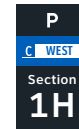Side A



Side B

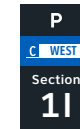


S1 CG.L1-067 N/A Notes: N/A

NOT USED

S1 CG.L1-071 5-ID.53 Notes: N/A

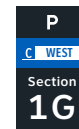Side A



Side B



S1 CG.L1-068 N/A Notes: N/A

NOT USED

S1 CG.L1-072 N/A Notes: N/A

NOT USED

S1 CGL1-073 N/A Notes: N/A

NOT USED

S1 CGL1-077 N/A Notes: N/A

NOT USED

S1 CGL1-074 N/A Notes: N/A

NOT USED

S1 CGL1-078 N/A Notes: N/A

NOT USED

S1 CGL1-075 N/A Notes: N/A

NOT USED

S1 CGL1-079 N/A Notes: N/A

NOT USED

S1 CGL1-076 N/A Notes: N/A

NOT USED

S1 CGL1-080 N/A

NOT USED

**Wayfinding Updates**

Issue Date: 08-23-2024  
Issue for Bid

- REV. 
- REV. 
- REV. 

**WARNING:**

This record contains Sensitive Security Information that is controlled under 49 CFR parts 15 and 1520. No part of this record may be disclosed to persons with a "need to know," as defined in 49 CFR parts 15 and 1520, except with the written permission of the Administrator of the Transportation Security Administration or the Secretary of Transportation. Unauthorized release may result in civil penalty or other action. For U.S. government agencies, public disclosure is governed by 5 U.S.C. 552 and 49 CFR parts 15 and 1520.



THESE SHEETS ARE ISSUED FOR GRAPHICAL INFORMATION ONLY

**4.2 MESSAGE SCHEDULE - GARAGE C: LEVEL 1 - SECTOR 1 (C WEST)**

BSG PRJCT# BSG-2024-111-IAH  
HAS TIP # 24 -103 - IAH

NOT USED

ELEVATOR CORE SIGNAGE CONTINUED ON NEXT SHEET

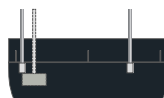
Side A



Side A



Side A



Side B



Wayfinding Updates

Issue Date: 08-23-2024

Issue for Bid

- REV.
- REV.
- REV.

WARNING:

This record contains Sensitive Security Information that is controlled under 49 CFR parts 15 and 1520. No part of this record may be disclosed to persons with a "need to know," as defined in 49 CFR parts 15 and 1520, except with the written permission of the Administrator of the Transportation Security Administration or the Secretary of Transportation. Unauthorized release may result in civil penalty or other action. For U.S. government agencies, public disclosure is governed by 5 U.S.C. 552 and 49 CFR parts 15 and 1520.



08-23-2024

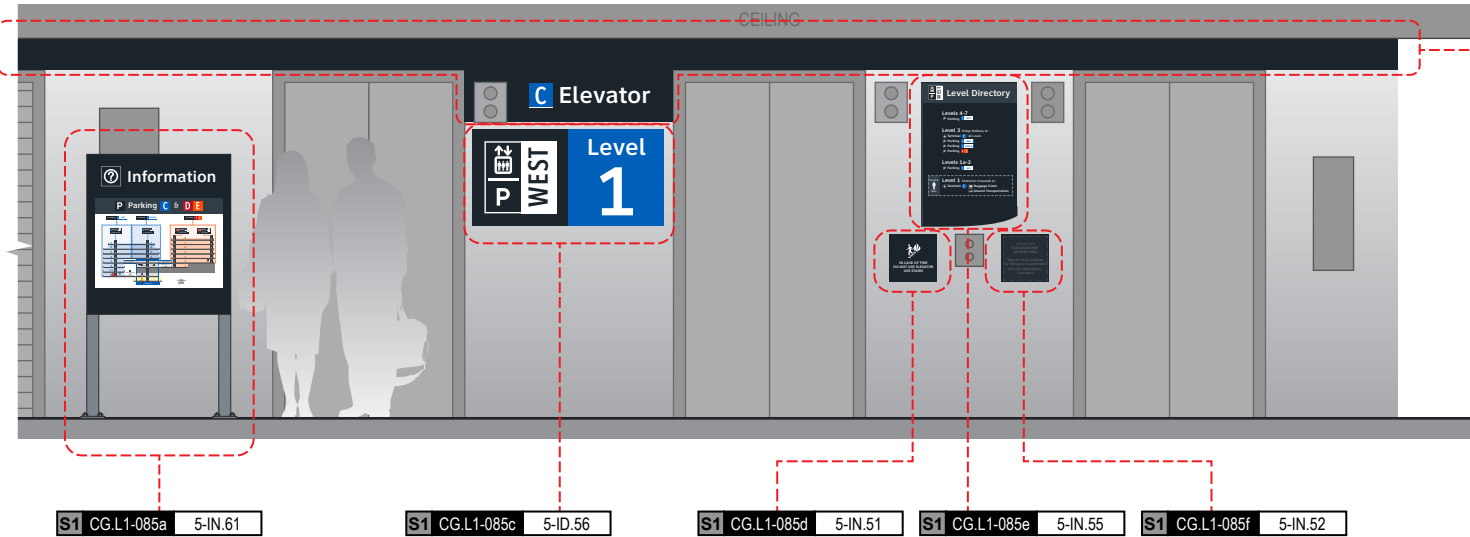
THESE SHEETS ARE ISSUED FOR GRAPHICAL INFORMATION ONLY

4.2 MESSAGE SCHEDULE - GARAGE C: LEVEL 1 - SECTOR 1 (C WEST)

BSG PRJCT# BSG-2024-111-IAH  
HAS TIP # 24 -103 - IAH



Side A



- S1 CG.L1-085a 5-IN.61
- S1 CG.L1-085c 5-ID.56
- S1 CG.L1-085d 5-IN.51
- S1 CG.L1-085e 5-IN.55
- S1 CG.L1-085f 5-IN.52

NOTES: Directory artwork includes a "You Are Here" button graphic and is in a unique location per elevator core/level location; artwork included here is representative of final map artwork design intent for this location

NOTES: Level directory plaque includes a "You Are Here" graphic and is in a unique location per elevator core/level location; artwork included here is representative of final artwork design intent for this location

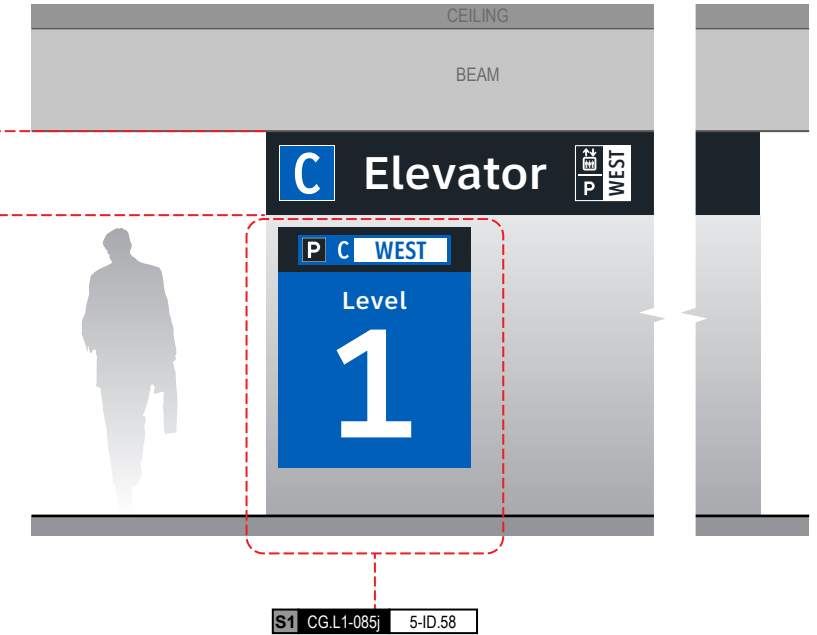
S1 CG.L1-085b 5-ID.57

NOTES: Wall paint and header graphics at front elevation only of elevator core included for this location number; wall elevation conditions shown are artistic representation based on rough site photo surveys; actual wall elevation conditions to be field verified by contractor/installer

S1 CG.L1-085g 5-ID.59


NOTES: Wall paint and header graphics on rear and two side elevations of elevator core included for this location number; wall elevation conditions shown are artistic representation based on rough site photo surveys; actual wall elevation conditions to be field verified by contractor/installer

Side C



S1 CG.L1-085j 5-ID.58

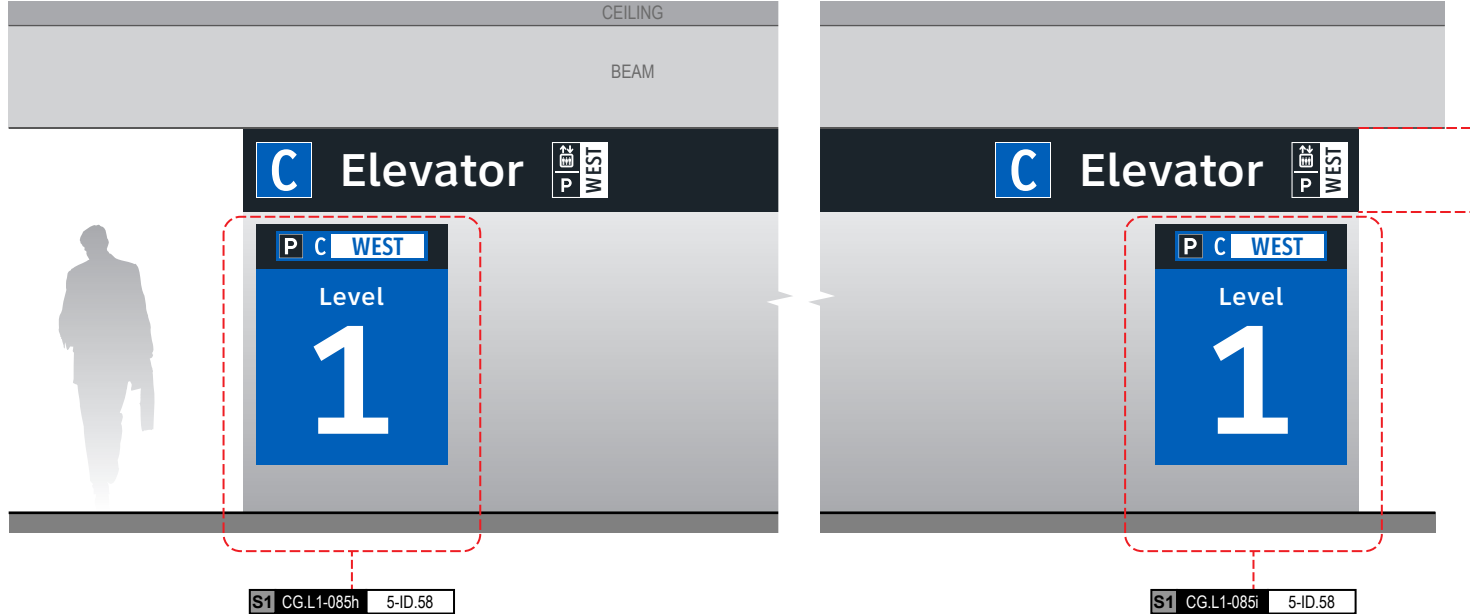
Side B



S1 CG.L1-085h 5-ID.58


S1 CG.L1-085i 5-ID.58

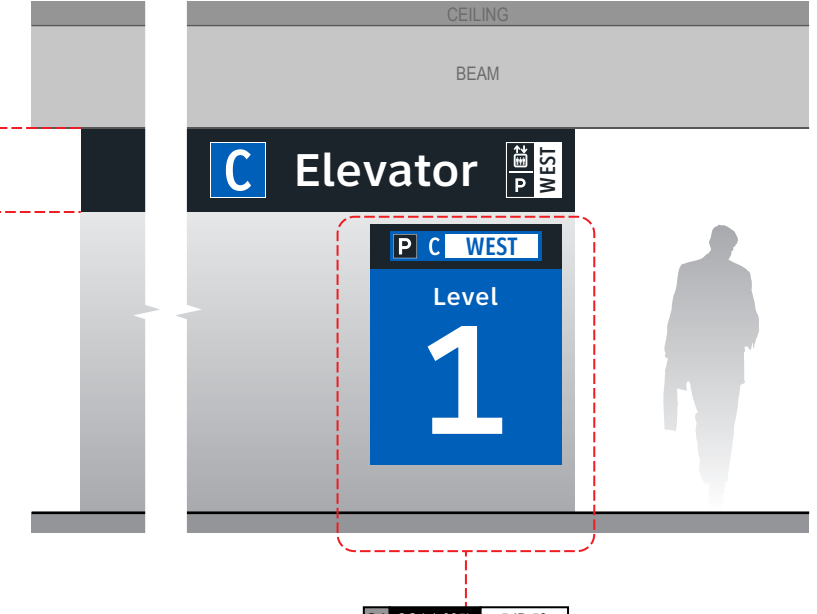Side D



S1 CG.L1-085k 5-ID.58


## END OF GARAGE C: LEVEL 1 - SECTOR 1 MESSAGES

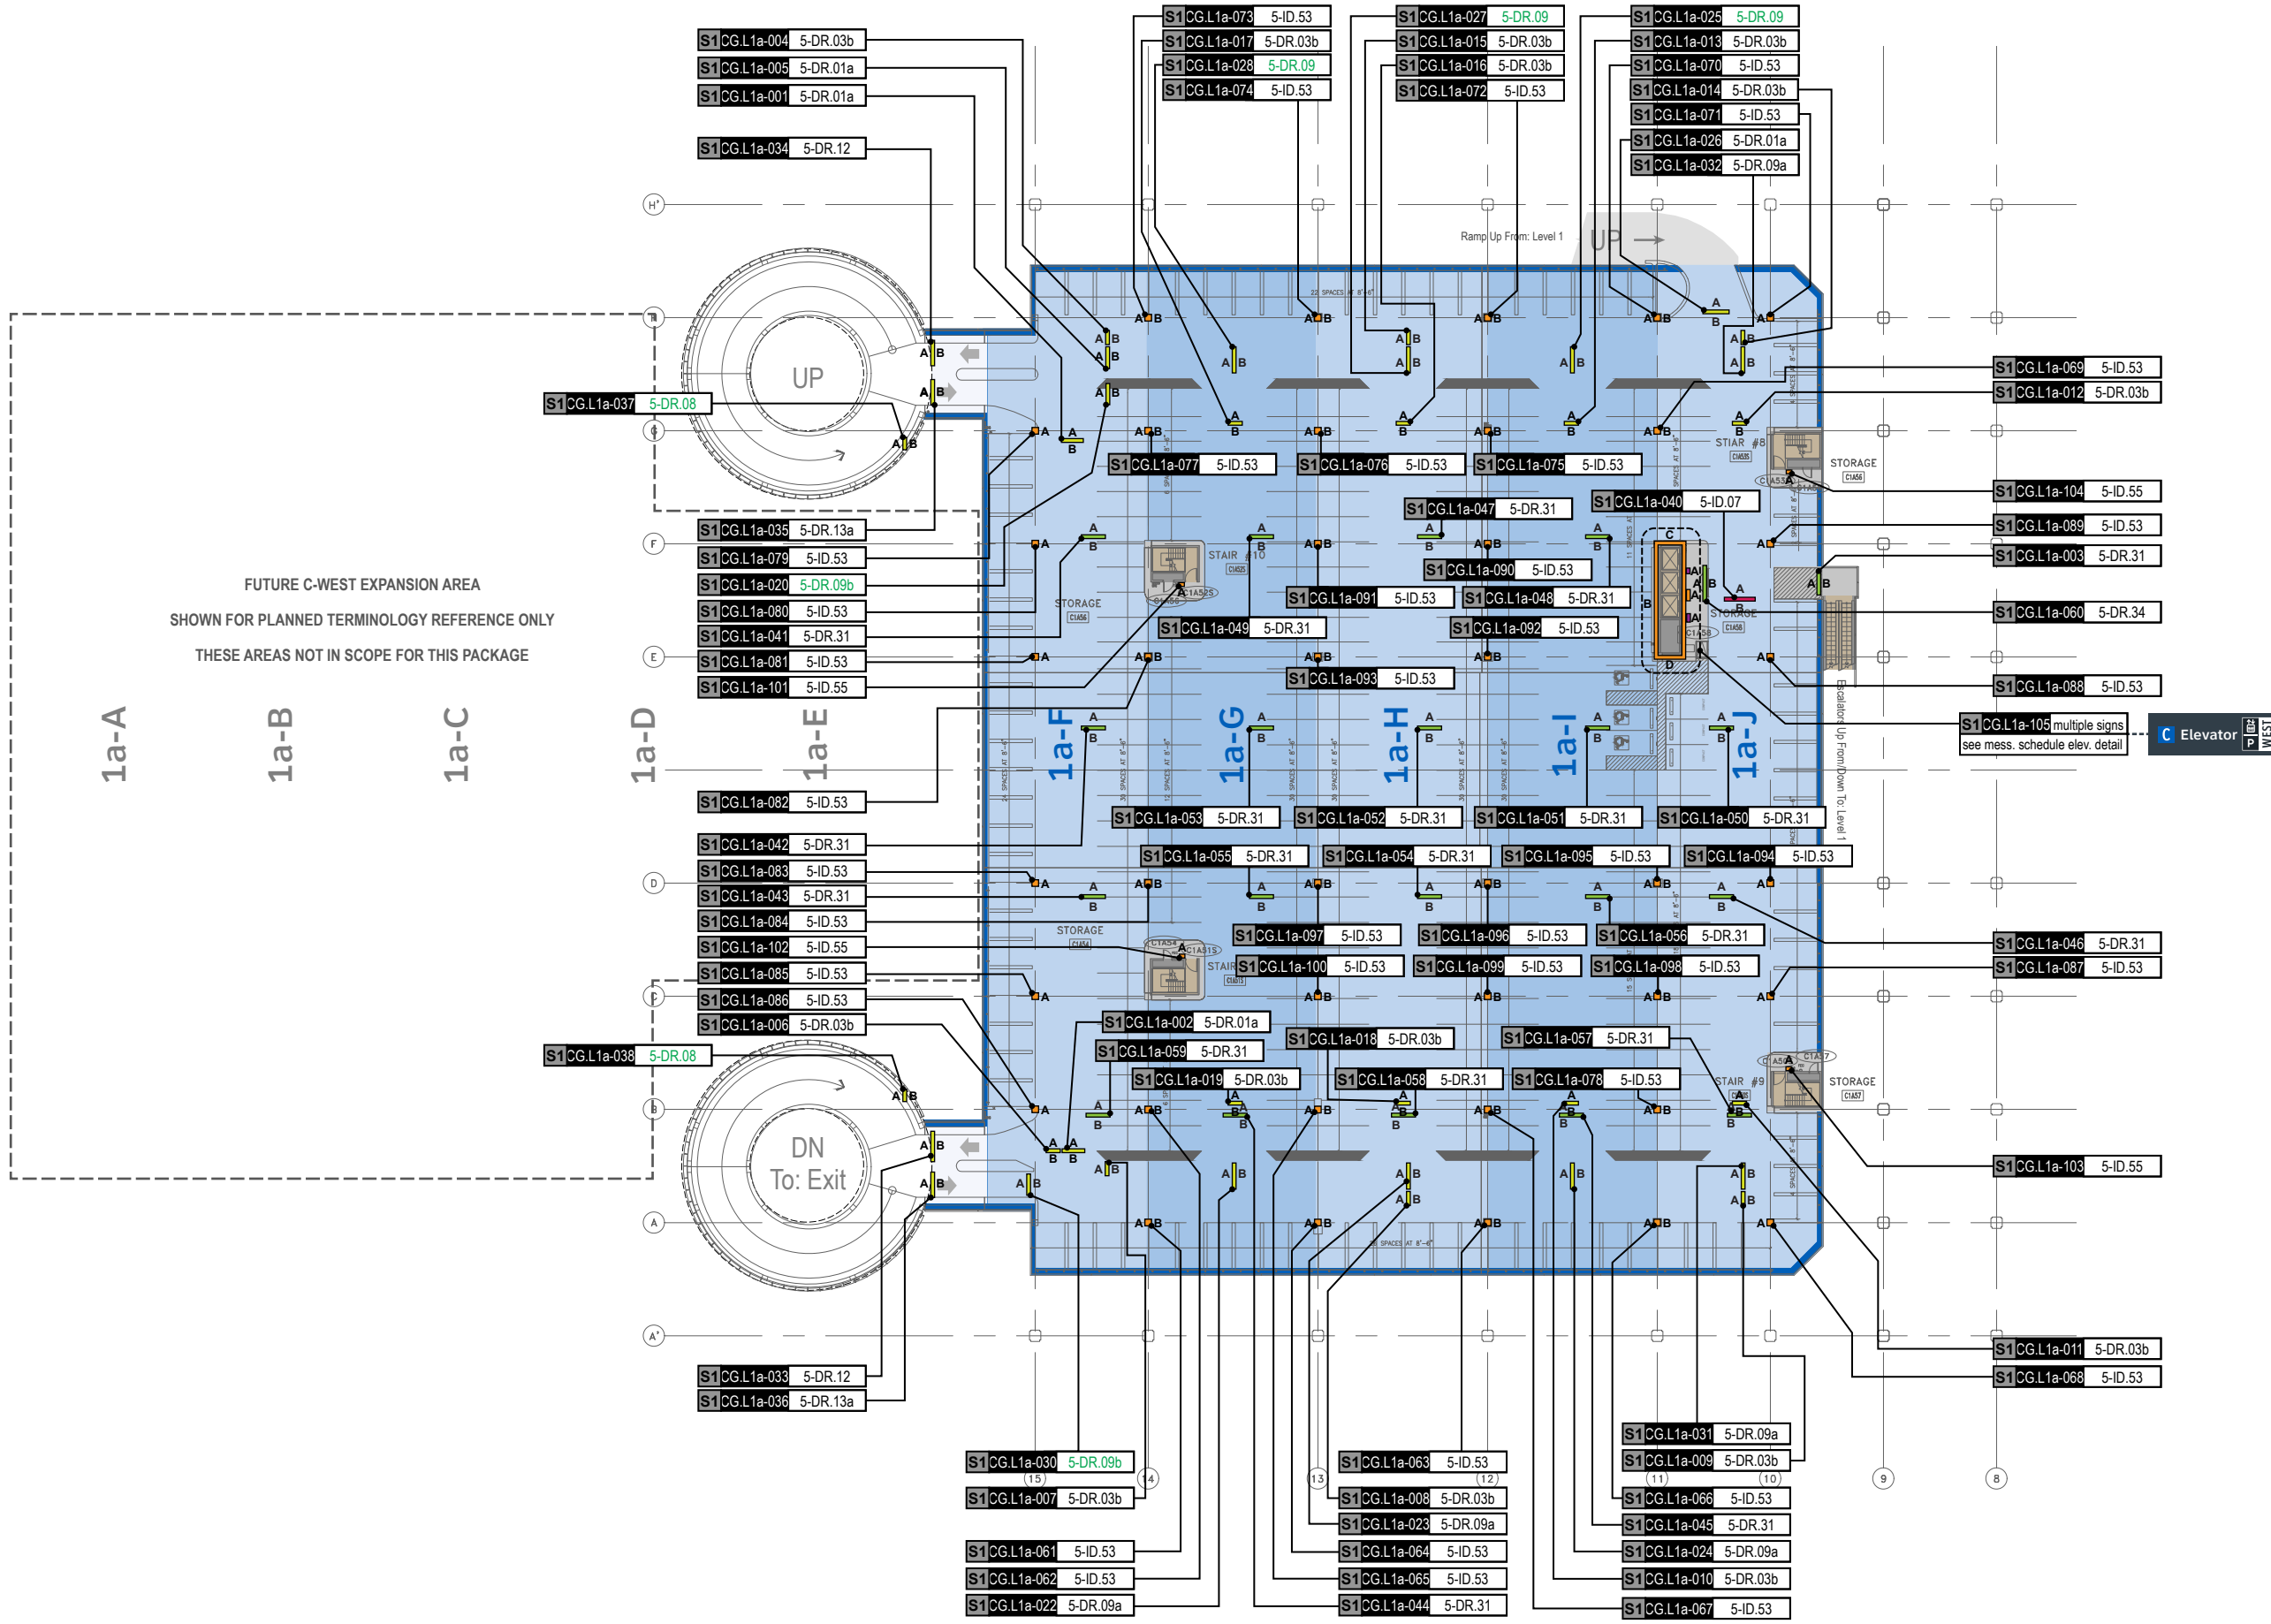

**GENERAL NOTES**

- Sign locations & orientations shown here are approximations based on the most current plan drawings as provided to the designer by the architect at the time of this document's completion. These sign locations are for general design intent & wayfinding planning purposes only. They should not be construed or deemed as absolute or final locations. Field verification, marking & documentation of each final location is to be performed by the Fabricator/Installer & coordinated with project staff & Wayfinding Design Consultants for final approval.
- All final install locations must be marked and verified in the field for proper structural integrity, adequate line of sight, utilities / property-line / other existing signage interferences & must be in complete compliance with all local, state and national codes prior to fabrication or installation.
- Adjustments to the sign locations shown in these drawings must be documented by the Fabricator/Installer, and provided to project staff & Wayfinding Design Consultants for final approval.

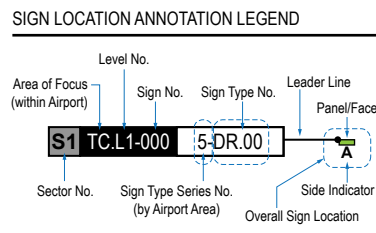**NOTE:** Only priority wayfinding signage & locations as shown in this wayfinding plan package are in scope. All other signage not shown (including traffic control) are NOT IN SCOPE for this project/contract.



**LOCATION CODE DEFINITIONS:**

**AREA OF FOCUS:** (location within Airport)

TA = Terminal A  
TB = Terminal B  
TC = Terminal C  
TD = Terminal D  
TE = Terminal E  
AB = AB Garage  
CG = C Garage  
DE = DE Garage

**SIGN TYPE SERIES NO.:** (by Airport Area)

1- = Terminals/Concourses  
1t- = Terminals/Concourses: Temporary  
2- = CBP Areas  
3- = Curbside/Ground Trans.  
4- = Roadways  
5- = Parking

**WAYFINDING SIGN TYPE:**

DR.xx = Directional  
ID.xx = Identification  
IN.xx = Informational

**WAYFINDING SIGN LOCATIONS - Parking:**

**PEDESTRIAN Signs:**

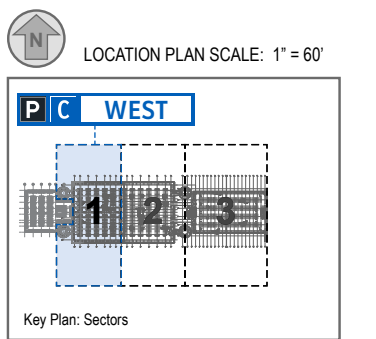
A/B = Directional (DR)  
A/B = Identification (ID)  
A/B = Informational (IN)

**VEHICULAR Signs:**


A/B = Directional (DR)  
A/B = Identification (ID)  
A/B = Informational (IN)

**CIRCULATION:**


■ = Public Use PEDESTRIAN Vertical Circulation (i.e. Elevators/Escalators/Stairs)  
■ = Public Use VEHICULAR Vertical Circulation (i.e. Ramps)  
■ = Alpha-Numeric Parking Section Naming Areas (Blues = C Garages; Oranges = D/E Garage)  
■ = Areas Not In Scope for this Package




S1CG.L1a-001 5-DR.01a Notes: N/A

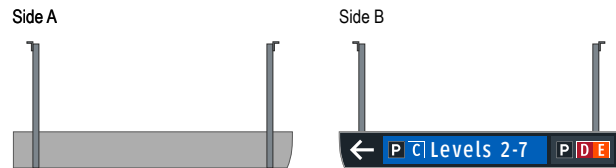


S1CG.L1a-005 5-DR.01a Notes: N/A

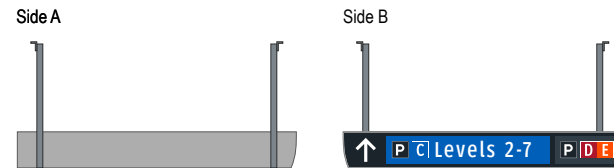


S1CG.L1a-002 5-DR.01a Notes: N/A

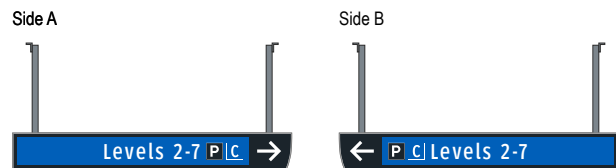


S1CG.L1a-006 5-DR.03b Notes: N/A

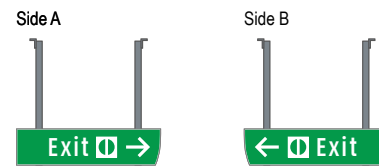


S1CG.L1a-003 5-DR.31 Notes: N/A

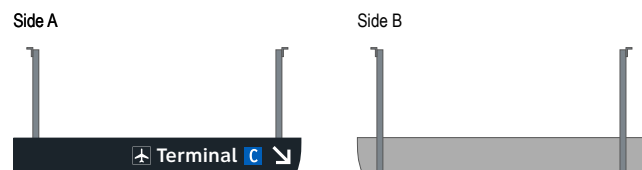


S1CG.L1a-007 5-DR.03b Notes: N/A

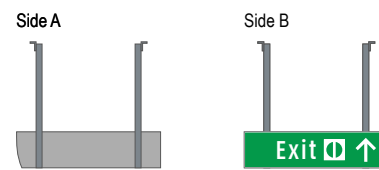


S1CG.L1a-004 5-DR.03b Notes: N/A

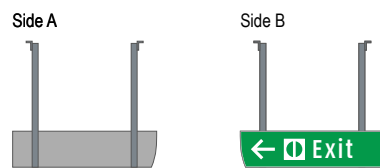


S1CG.L1a-008 5-DR.03b Notes: N/A

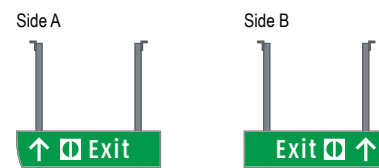


S1CG.L1a-009 5-DR.03b Notes: N/A

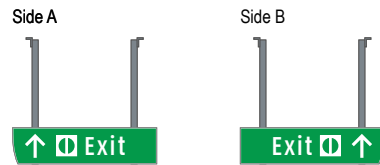


S1CG.L1a-013 5-DR.03b Notes: N/A

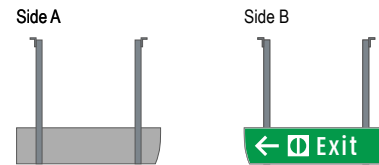


S1CG.L1a-010 5-DR.03b Notes: N/A

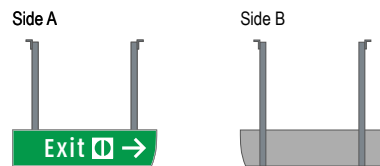


S1CG.L1a-014 5-DR.03b Notes: N/A

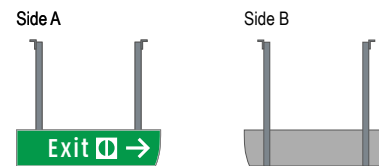


S1CG.L1a-011 5-DR.03b Notes: N/A

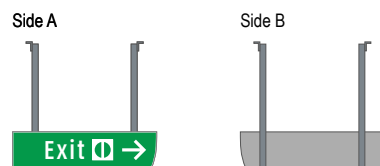


S1CG.L1a-015 5-DR.03b Notes: N/A

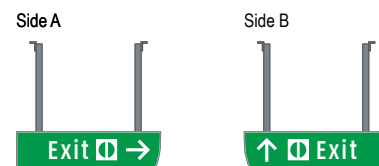


S1CG.L1a-012 5-DR.03b Notes: N/A

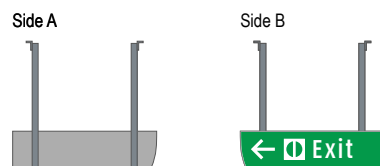

S1CG.L1a-016 5-DR.03b Notes: N/A

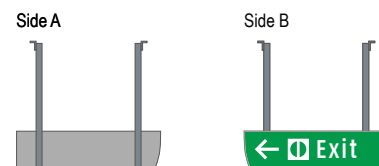


S1CG.L1a-017 5-DR.03b Notes: N/A

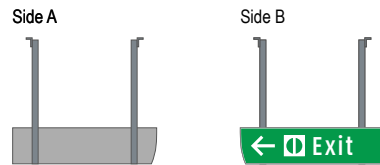


S1CG.L1a-021 N/A

NOT USED

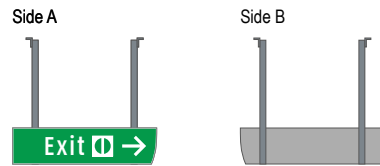
S1CG.L1a-018 5-DR.03b Notes: N/A




S1CG.L1a-022 5-DR.09a Notes: N/A

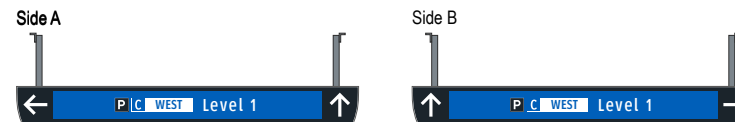


S1CG.L1a-019 5-DR.03b Notes: N/A

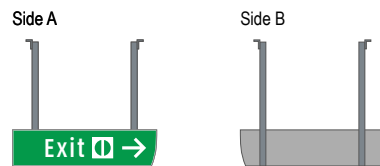


S1CG.L1a-023 5-DR.09a Notes: N/A

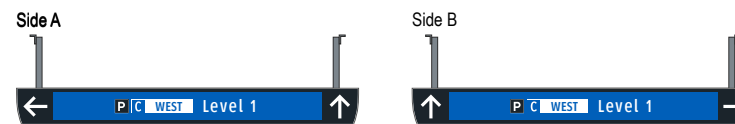


S1CG.L1a-020 5-DR.09b Notes: N/A

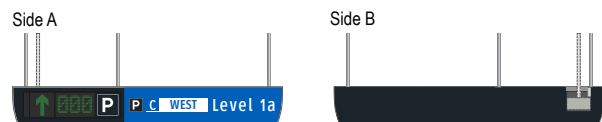

S1CG.L1a-024 5-DR.09a Notes: N/A

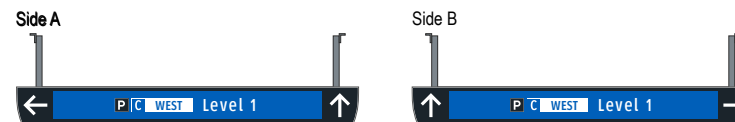


S1CG.L1a-025 5-DR.09 Notes: N/A

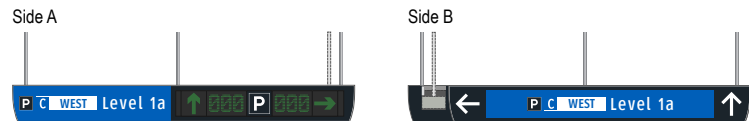


S1CG.L1a-029 N/A Notes: N/A

NOT USED

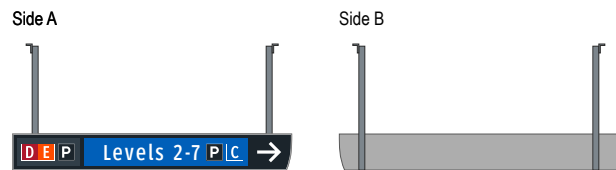
S1CG.L1a-026 5-DR.01a Notes: N/A




S1CG.L1a-030 5-DR.09b Notes: N/A

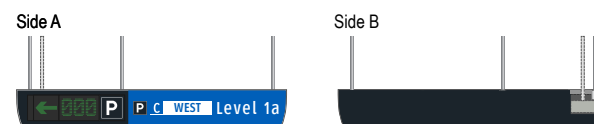


S1CG.L1a-027 5-DR.09 Notes: N/A

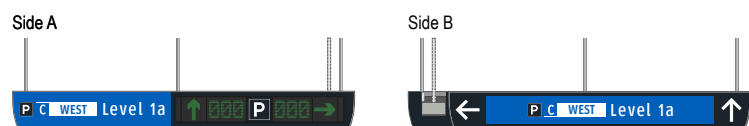


S1CG.L1a-031 5-DR.09a Notes: N/A

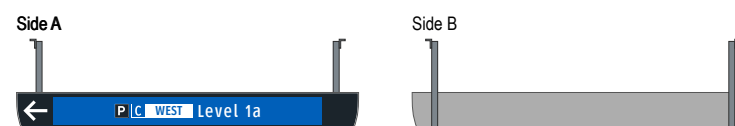

S1CG.L1a-028 5-DR.09 Notes: N/A

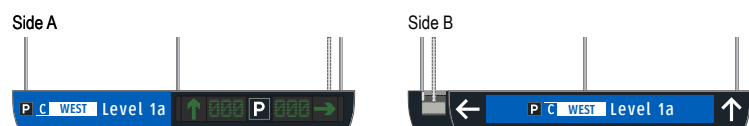

S1CG.L1a-032 5-DR.09a Notes: N/A

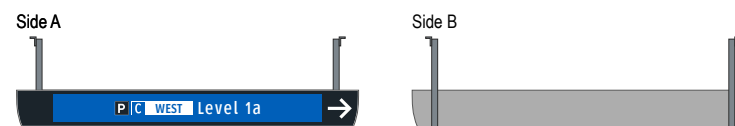


S1CG.L1a-033 5-DR.12 Notes: N/A

Side A



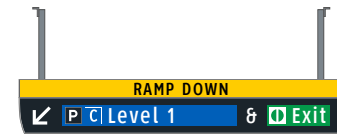Side B




S1CG.L1a-034 5-DR.12 Notes: N/A

Side A



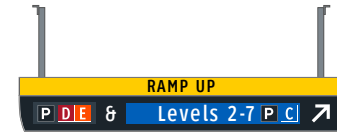Side B



S1CG.L1a-035 5-DR.13a Notes: N/A

Side A



Side B



S1CG.L1a-036 5-DR.13a Notes: N/A

Side A



Side B

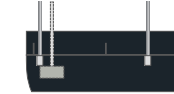


S1CG.L1a-037 5-DR.08 Notes: N/A

Side A



Side B



S1CG.L1a-038 5-DR.08 Notes: N/A

Side A



Side B



S1CG.L1a-039 N/A Notes: N/A

NOT USED

S1CG.L1a-040 5-ID.07 Notes: N/A

Side A



Side B



Wayfinding Updates

Issue Date: 08-23-2024

Issue for Bid

- REV. A
- REV. B
- REV. C

WARNING:

This record contains Sensitive Security Information that is controlled under 49 CFR parts 15 and 1520. No part of this record may be disclosed to persons with a "need to know," as defined in 49 CFR parts 15 and 1520, except with the written permission of the Administrator of the Transportation Security Administration or the Secretary of Transportation. Unauthorized release may result in civil penalty or other action. For U.S. government agencies, public disclosure is governed by 5 U.S.C. 552 and 49 CFR parts 15 and 1520.

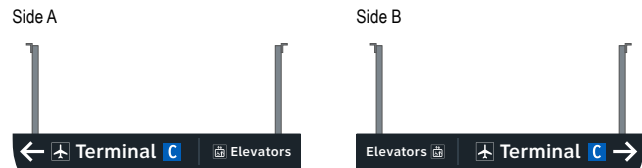


THESE SHEETS ARE ISSUED FOR GRAPHICAL INFORMATION ONLY


4.4 MESSAGE SCHEDULE - GARAGE C: LEVEL 1A - SECTOR 1 (C WEST)

BSG PRJCT# BSG-2024-111-IAH HAS TIP # 24 -103 - IAH


S1CG.L1a-041 5-DR.31 Notes: N/A




S1CG.L1a-045 5-DR.31 Notes: N/A

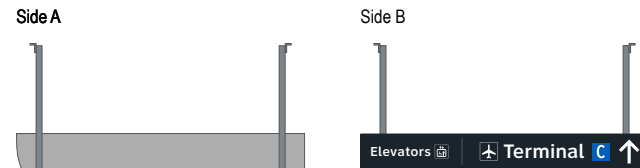


S1CG.L1a-042 5-DR.31 Notes: N/A

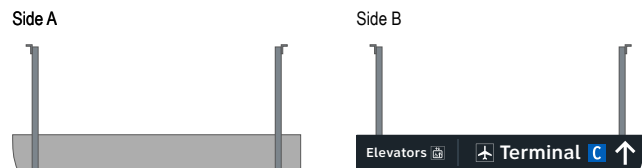


S1CG.L1a-046 5-DR.31 Notes: N/A

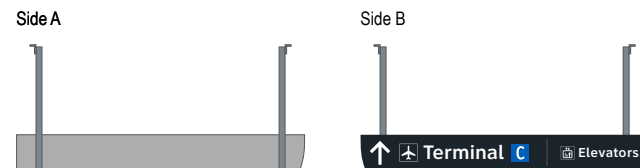


S1CG.L1a-043 5-DR.31 Notes: N/A

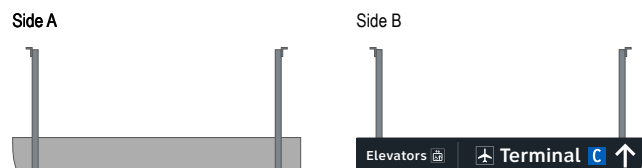


S1CG.L1a-047 5-DR.31 Notes: N/A

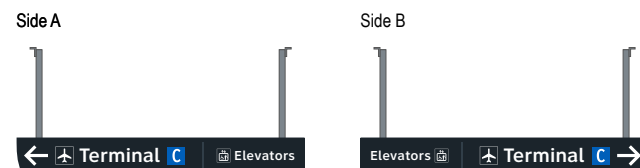

S1CG.L1a-044 5-DR.31 Notes: N/A

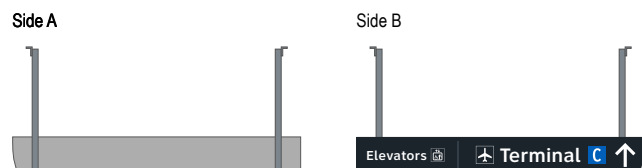

S1CG.L1a-048 5-DR.31 Notes: N/A

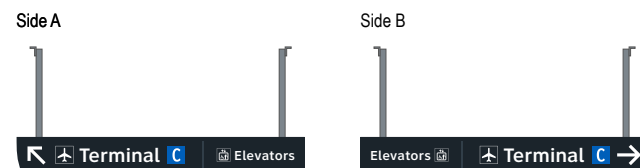

**Wayfinding Updates**

Issue Date: 08-23-2024  
Issue for Bid

- REV. 
- REV. 
- REV. 

**WARNING:**

This record contains Sensitive Security Information that is controlled under 49 CFR parts 15 and 1520. No part of this record may be disclosed to persons with a "need to know," as defined in 49 CFR parts 15 and 1520, except with the written permission of the Administrator of the Transportation Security Administration or the Secretary of Transportation. Unauthorized release may result in civil penalty or other action. For U.S. government agencies, public disclosure is governed by 5 U.S.C. 552 and 49 CFR parts 15 and 1520.



08-23-2024

THESE SHEETS ARE ISSUED FOR GRAPHICAL INFORMATION ONLY

**4.4 MESSAGE SCHEDULE - GARAGE C: LEVEL 1A - SECTOR 1 (C WEST)**

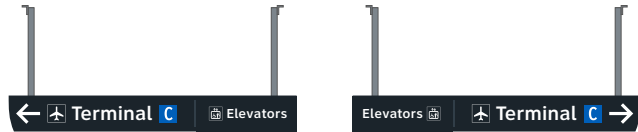
BSG PRJCT# BSG-2024-111-IAH  
HAS TIP # 24 -103 - IAH



S1CG.L1a-049 5-DR.31 Notes: N/A

Side A


Side B



S1CG.L1a-053 5-DR.31 Notes: N/A

Side A

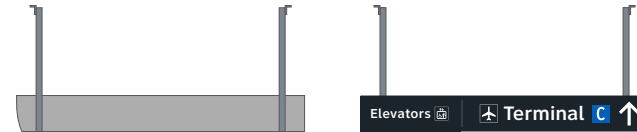
Side B



S1CG.L1a-050 5-DR.31 Notes: N/A

Side A

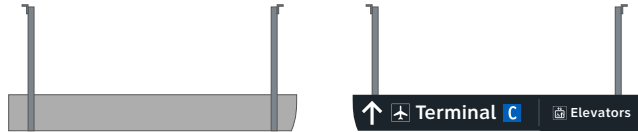
Side B



S1CG.L1a-054 5-DR.31 Notes: N/A

Side A

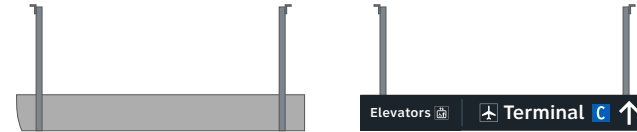
Side B



S1CG.L1a-051 5-DR.31 Notes: Notes: N/A

Side A

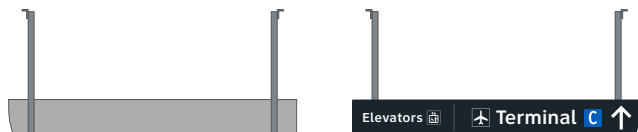
Side B



S1CG.L1a-055 5-DR.31 Notes: N/A

Side A

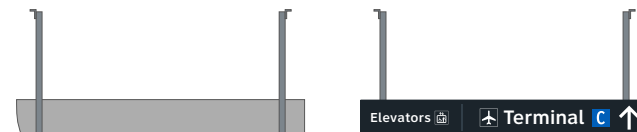
Side B



S1CG.L1a-052 5-DR.31 Notes: N/A

Side A

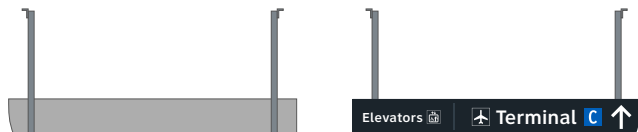
Side B



S1CG.L1a-056 5-DR.31 Notes: N/A

Side A

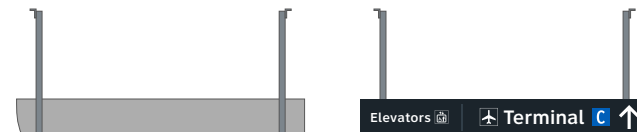Side B



**Wayfinding Updates**

Issue Date: 08-23-2024

**Issue for Bid**

- REV. 
- REV. 
- REV. 

**WARNING:**

This record contains Sensitive Security Information that is controlled under 49 CFR parts 15 and 1520. No part of this record may be disclosed to persons with a "need to know," as defined in 49 CFR parts 15 and 1520, except with the written permission of the Administrator of the Transportation Security Administration or the Secretary of Transportation. Unauthorized release may result in civil penalty or other action. For U.S. government agencies, public disclosure is governed by 5 U.S.C. 552 and 49 CFR parts 15 and 1520.

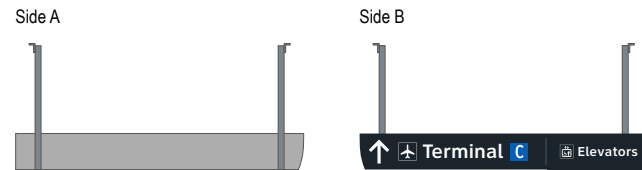


THESE SHEETS ARE ISSUED FOR  
 GRAPHICAL INFORMATION ONLY


**4.9 MESSAGE SCHEDULE - GARAGE C: LEVEL 1A - SECTOR 1 (C WEST)**

BSG PRJCT# BSG-2024-111-IAH  
 HAS TIP # 24 -103 - IAH


S1CG.L1a-057 5-DR.31 Notes: N/A




S1CG.L1a-061 5-ID.53 Notes: N/A

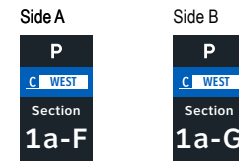


S1CG.L1a-058 5-DR.31 Notes: N/A

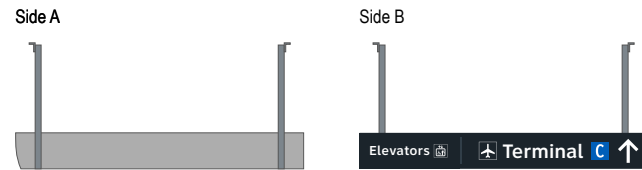


S1CG.L1a-062 5-ID.53 Notes: N/A

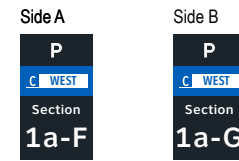


S1CG.L1a-059 5-DR.31 Notes: N/A

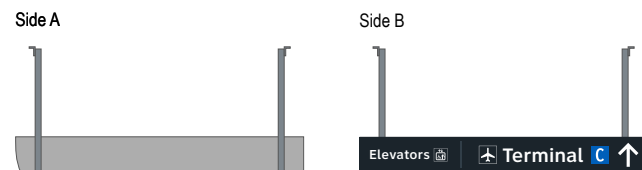


S1CG.L1a-063 5-ID.53 Notes: N/A

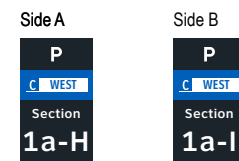

S1CG.L1a-060 5-DR.34 Notes: N/A

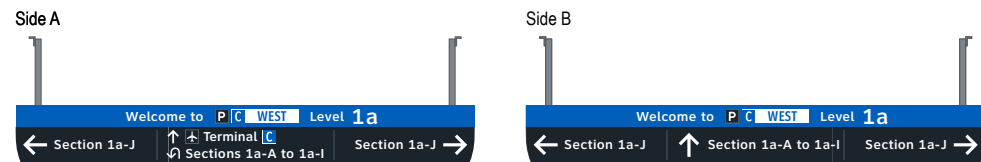

S1CG.L1a-064 5-ID.53 Notes: N/A

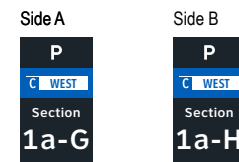

S1CG.L1a-065 5-ID.53 Notes: N/A

Side A	Side B
<b>P</b>	<b>P</b>
<b>C WEST</b>	<b>C WEST</b>
Section	Section
<b>1a-G</b>	<b>1a-H</b>

S1CG.L1a-069 5-ID.53 Notes: N/A

Side A	Side B
<b>P</b>	<b>P</b>
<b>C WEST</b>	<b>C WEST</b>
Section	Section
<b>1a-I</b>	<b>1a-J</b>

S1CG.L1a-066 5-ID.53 Notes: N/A

Side A	Side B
<b>P</b>	<b>P</b>
<b>C WEST</b>	<b>C WEST</b>
Section	Section
<b>1a-I</b>	<b>1a-J</b>

S1CG.L1a-070 5-ID.53 Notes: N/A

Side A	Side B
<b>P</b>	<b>P</b>
<b>C WEST</b>	<b>C WEST</b>
Section	Section
<b>1a-I</b>	<b>1a-J</b>

S1CG.L1a-067 5-ID.53 Notes: N/A

Side A	Side B
<b>P</b>	<b>P</b>
<b>C WEST</b>	<b>C WEST</b>
Section	Section
<b>1a-H</b>	<b>1a-I</b>

S1CG.L1a-071 5-ID.53 Notes: N/A

Side A
<b>P</b>
<b>C WEST</b>
Section
<b>1a-J</b>

S1CG.L1a-068 5-ID.53 Notes: N/A

Side A
<b>P</b>
<b>C WEST</b>
Section
<b>1a-J</b>

S1CG.L1a-072 5-ID.53 Notes: N/A

Side A	Side B
<b>P</b>	<b>P</b>
<b>C WEST</b>	<b>C WEST</b>
Section	Section
<b>1a-H</b>	<b>1a-I</b>



GEORGE BUSH INTERCONTINENTAL AIRPORT  
Wayfinding Signage Design Intent Documents  
**C Garage**



Louisville, Colorado  
P: 303.494.7849  
www.labozan.com

These documents are intended to illustrate design intent, and should only be used as a general guideline. No information contained here should be construed as engineered elements. The fabricator/contractor shall be responsible for all engineering and specifications with regard to structural, electrical, mechanical, foundation and installation. Information and illustrations contained here are part of an original unpublished design by Labozan Associates, Inc. Detailing and information contained on these pages shall not be reproduced, copied or utilized in any way except for the specific project for which they were created without previous written authorization from Labozan Associates, Inc.  
© 2024 by Labozan Associates, Inc.

**Wayfinding Updates**

Issue Date: 08-23-2024  
Issue for Bid

REV.   
REV.   
REV.

**WARNING:**

This record contains Sensitive Security Information that is controlled under 49 CFR parts 15 and 1520. No part of this record may be disclosed to persons with a "need to know," as defined in 49 CFR parts 15 and 1520, except with the written permission of the Administrator of the Transportation Security Administration or the Secretary of Transportation. Unauthorized release may result in civil penalty or other action. For U.S. government agencies, public disclosure is governed by 5 U.S.C. 552 and 49 CFR parts 15 and 1520.



08-23-2024

THESE SHEETS ARE ISSUED FOR GRAPHICAL INFORMATION ONLY

**4.4 MESSAGE SCHEDULE - GARAGE C: LEVEL 1A - SECTOR 1 (C WEST)**

BSG PRJCT# BSG-2024-111-IAH  
HAS TIP # 24 -103 - IAH

S1CG.L1a-073 5-ID.53 Notes: N/A

Side A	Side B
<b>P</b>	<b>P</b>
<b>C WEST</b>	<b>C WEST</b>
Section	Section
<b>1a-F</b>	<b>1a-G</b>

S1CG.L1a-077 5-ID.53 Notes: N/A

Side A	Side B
<b>P</b>	<b>P</b>
<b>C WEST</b>	<b>C WEST</b>
Section	Section
<b>1a-F</b>	<b>1a-G</b>

S1CG.L1a-074 5-ID.53 Notes: N/A

Side A	Side B
<b>P</b>	<b>P</b>
<b>C WEST</b>	<b>C WEST</b>
Section	Section
<b>1a-G</b>	<b>1a-H</b>

S1CG.L1a-078 5-ID.53 Notes: N/A

Side A	Side B
<b>P</b>	<b>P</b>
<b>C WEST</b>	<b>C WEST</b>
Section	Section
<b>1a-I</b>	<b>1a-J</b>

S1CG.L1a-075 5-ID.53 Notes: N/A

Side A	Side B
<b>P</b>	<b>P</b>
<b>C WEST</b>	<b>C WEST</b>
Section	Section
<b>1a-H</b>	<b>1a-I</b>

S1CG.L1a-079 5-ID.53 Notes: N/A

Side A
<b>P</b>
<b>C WEST</b>
Section
<b>1a-F</b>

S1CG.L1a-076 5-ID.53 Notes: N/A

Side A	Side B
<b>P</b>	<b>P</b>
<b>C WEST</b>	<b>C WEST</b>
Section	Section
<b>1a-G</b>	<b>1a-H</b>

S1CG.L1a-080 5-ID.53 Notes: N/A

Side A
<b>P</b>
<b>C WEST</b>
Section
<b>1a-F</b>

Side A

**P**  
**C WEST**  
 Section  
**1a-F**

Side A

**P**  
**C WEST**  
 Section  
**1a-F**

Side A

**P**  
**C WEST**  
 Section  
**1a-F**

Side B

**P**  
**C WEST**  
 Section  
**1a-G**

Side A

**P**  
**C WEST**  
 Section  
**1a-F**

Side A

**P**  
**C WEST**  
 Section  
**1a-F**

Side A

**P**  
**C WEST**  
 Section  
**1a-J**

Side A

**P**  
**C WEST**  
 Section  
**1a-F**

Side B

**P**  
**C WEST**  
 Section  
**1a-G**

Side A

**P**  
**C WEST**  
 Section  
**1a-J**



**Wayfinding Updates**

Issue Date: 08-23-2024  
Issue for Bid

- REV.
- REV.
- REV.

**WARNING:**

This record contains Sensitive Security Information that is controlled under 49 CFR parts 15 and 1520. No part of this record may be disclosed to persons with a "need to know," as defined in 49 CFR parts 15 and 1520, except with the written permission of the Administrator of the Transportation Security Administration or the Secretary of Transportation. Unauthorized release may result in civil penalty or other action. For U.S. government agencies, public disclosure is governed by 5 U.S.C. 552 and 49 CFR parts 15 and 1520.



08-23-2024

THESE SHEETS ARE ISSUED FOR GRAPHICAL INFORMATION ONLY

**4.4 MESSAGE SCHEDULE - GARAGE C: LEVEL 1A - SECTOR 1 (C WEST)**

BSG PRJCT# BSG-2024-111-IAH  
 HAS TIP # 24 -103 - IAH

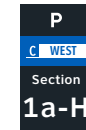
Side A




Side A




Side B




Side A

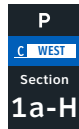


Side B

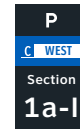


Side A

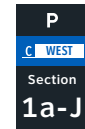


Side A

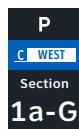


Side B

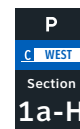


Side A

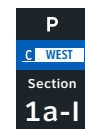


Side B

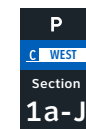


Side A

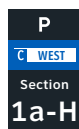


Side B

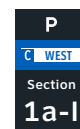

Side A

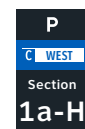

Side B

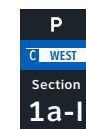

Wayfinding Updates

Issue Date: 08-23-2024  
Issue for Bid

- REV.
- REV.
- REV.

WARNING:

This record contains Sensitive Security Information that is controlled under 49 CFR parts 15 and 1520. No part of this record may be disclosed to persons with a "need to know," as defined in 49 CFR parts 15 and 1520, except with the written permission of the Administrator of the Transportation Security Administration or the Secretary of Transportation. Unauthorized release may result in civil penalty or other action. For U.S. government agencies, public disclosure is governed by 5 U.S.C. 552 and 49 CFR parts 15 and 1520.



08-23-2024

THESE SHEETS ARE ISSUED FOR GRAPHICAL INFORMATION ONLY

4.4 MESSAGE SCHEDULE - GARAGE C: LEVEL 1A - SECTOR 1 (C WEST)

BSG PRJCT# BSG-2024-111-IAH  
HAS TIP # 24 -103 - IAH

S1CG.L1a-097 5-ID.53 Notes: N/A

Side A      Side B

<b>P</b>	<b>P</b>
<b>C WEST</b>	<b>C WEST</b>
Section	Section
<b>1a-G</b>	<b>1a-H</b>

S1CG.L1a-101 5-ID.55 Notes: N/A

Side A

<b>P</b>
<b>C WEST</b>
Level
<b>1a</b>
Stairs 10

S1CG.L1a-098 5-ID.53 Notes: N/A

Side A      Side B

<b>P</b>	<b>P</b>
<b>C WEST</b>	<b>C WEST</b>
Section	Section
<b>1a-I</b>	<b>1a-J</b>

S1CG.L1a-102 5-ID.55 Notes: N/A

Side A

<b>P</b>
<b>C WEST</b>
Level
<b>1a</b>
Stairs 11

S1CG.L1a-099 5-ID.53 Notes: N/A

Side A      Side B

<b>P</b>	<b>P</b>
<b>C WEST</b>	<b>C WEST</b>
Section	Section
<b>1a-H</b>	<b>1a-I</b>

S1CG.L1a-103 5-ID.55 Notes: N/A

Side A

<b>P</b>
<b>C WEST</b>
Level
<b>1a</b>
Stairs 9

S1CG.L1a-100 5-ID.53 Notes: N/A

Side A      Side B


<b>P</b>	<b>P</b>
<b>C WEST</b>	<b>C WEST</b>
Section	Section
<b>1a-G</b>	<b>1a-H</b>

S1CG.L1a-104 5-ID.55 Notes: N/A

Side A

<b>P</b>
<b>C WEST</b>
Level
<b>1a</b>
Stairs 8

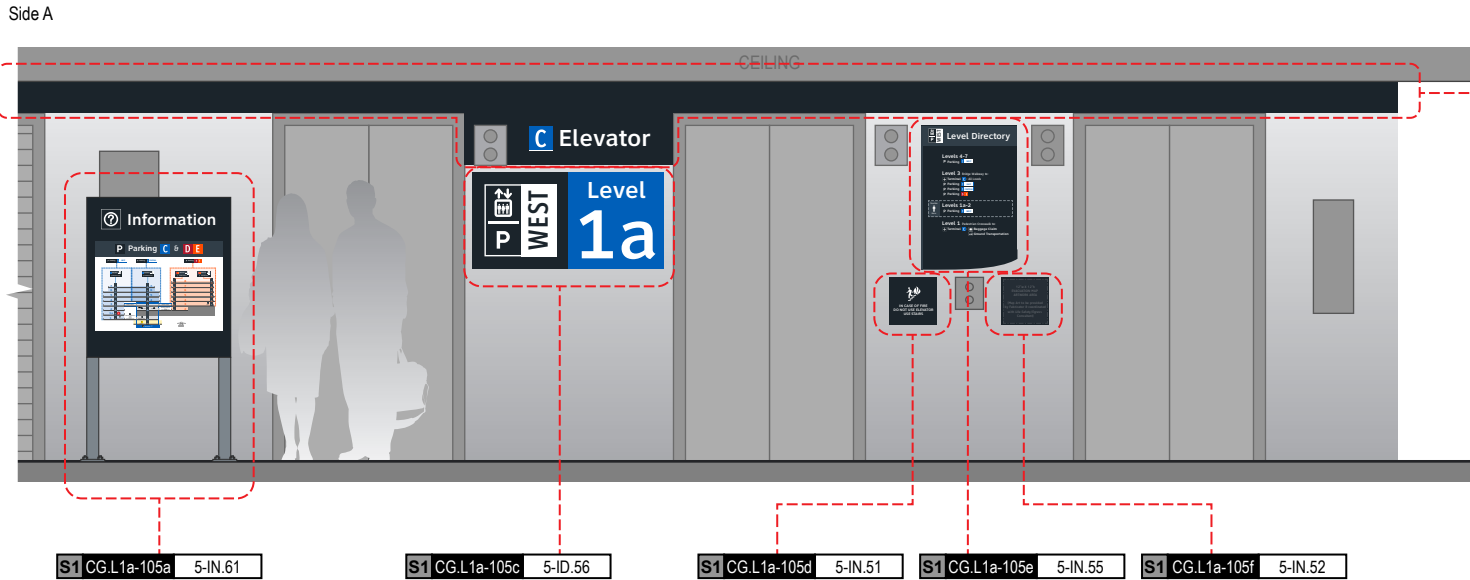ELEVATOR CORE SIGNAGE CONTINUED ON NEXT SHEET



NOTES: Directory artwork includes a "You Are Here" button graphic and is in a unique location per elevator core/level location; artwork included here is representative of final map artwork design intent for this location

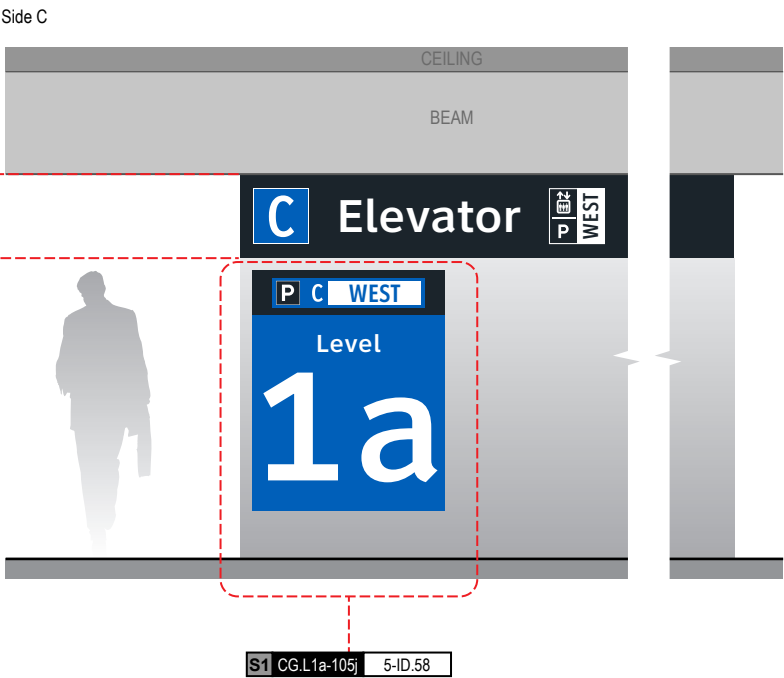
NOTES: Level directory plaque includes a "You Are Here" graphic and is in a unique location per elevator core/level location; artwork included here is representative of final artwork design intent for this location

S1 CG.L1a-105b 5-ID.57


NOTES: Wall paint and header graphics at front elevation only of elevator core included for this location number; wall elevation conditions shown are artistic representation based on rough site photo surveys; actual wall elevation conditions to be field verified by contractor/installer

S1 CG.L1a-105g 5-ID.59


NOTES: Wall paint and header graphics on rear and two side elevations of elevator core included for this location number; wall elevation conditions shown are artistic representation based on rough site photo surveys; actual wall elevation conditions to be field verified by contractor/installer




S1 CG.L1a-105j 5-ID.58

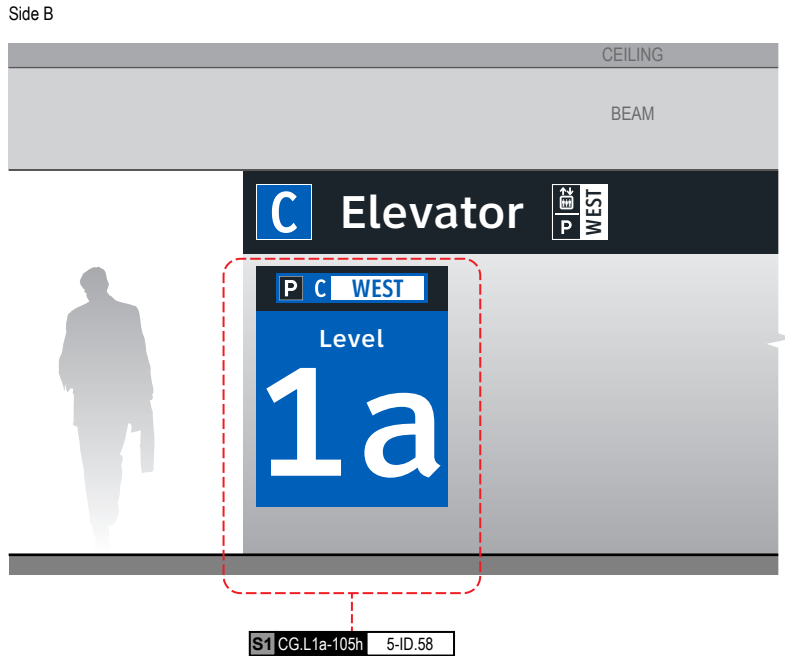

S1 CG.L1a-105h 5-ID.58

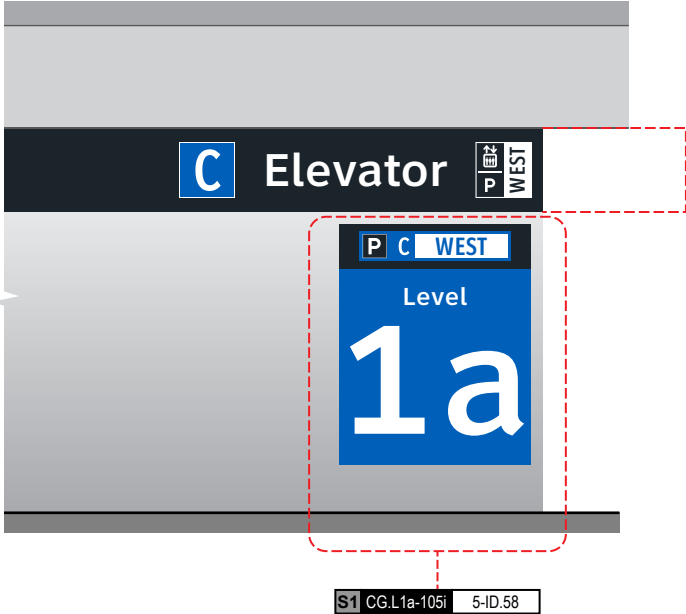

S1 CG.L1a-105i 5-ID.58

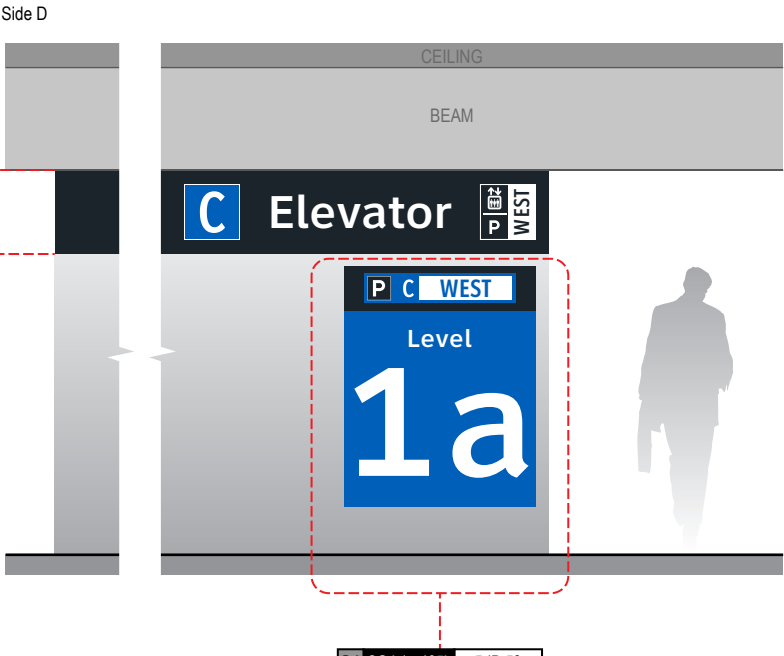


S1 CG.L1a-105k 5-ID.58

**END OF GARAGE C: LEVEL 1a - SECTOR 1 MESSAGES**


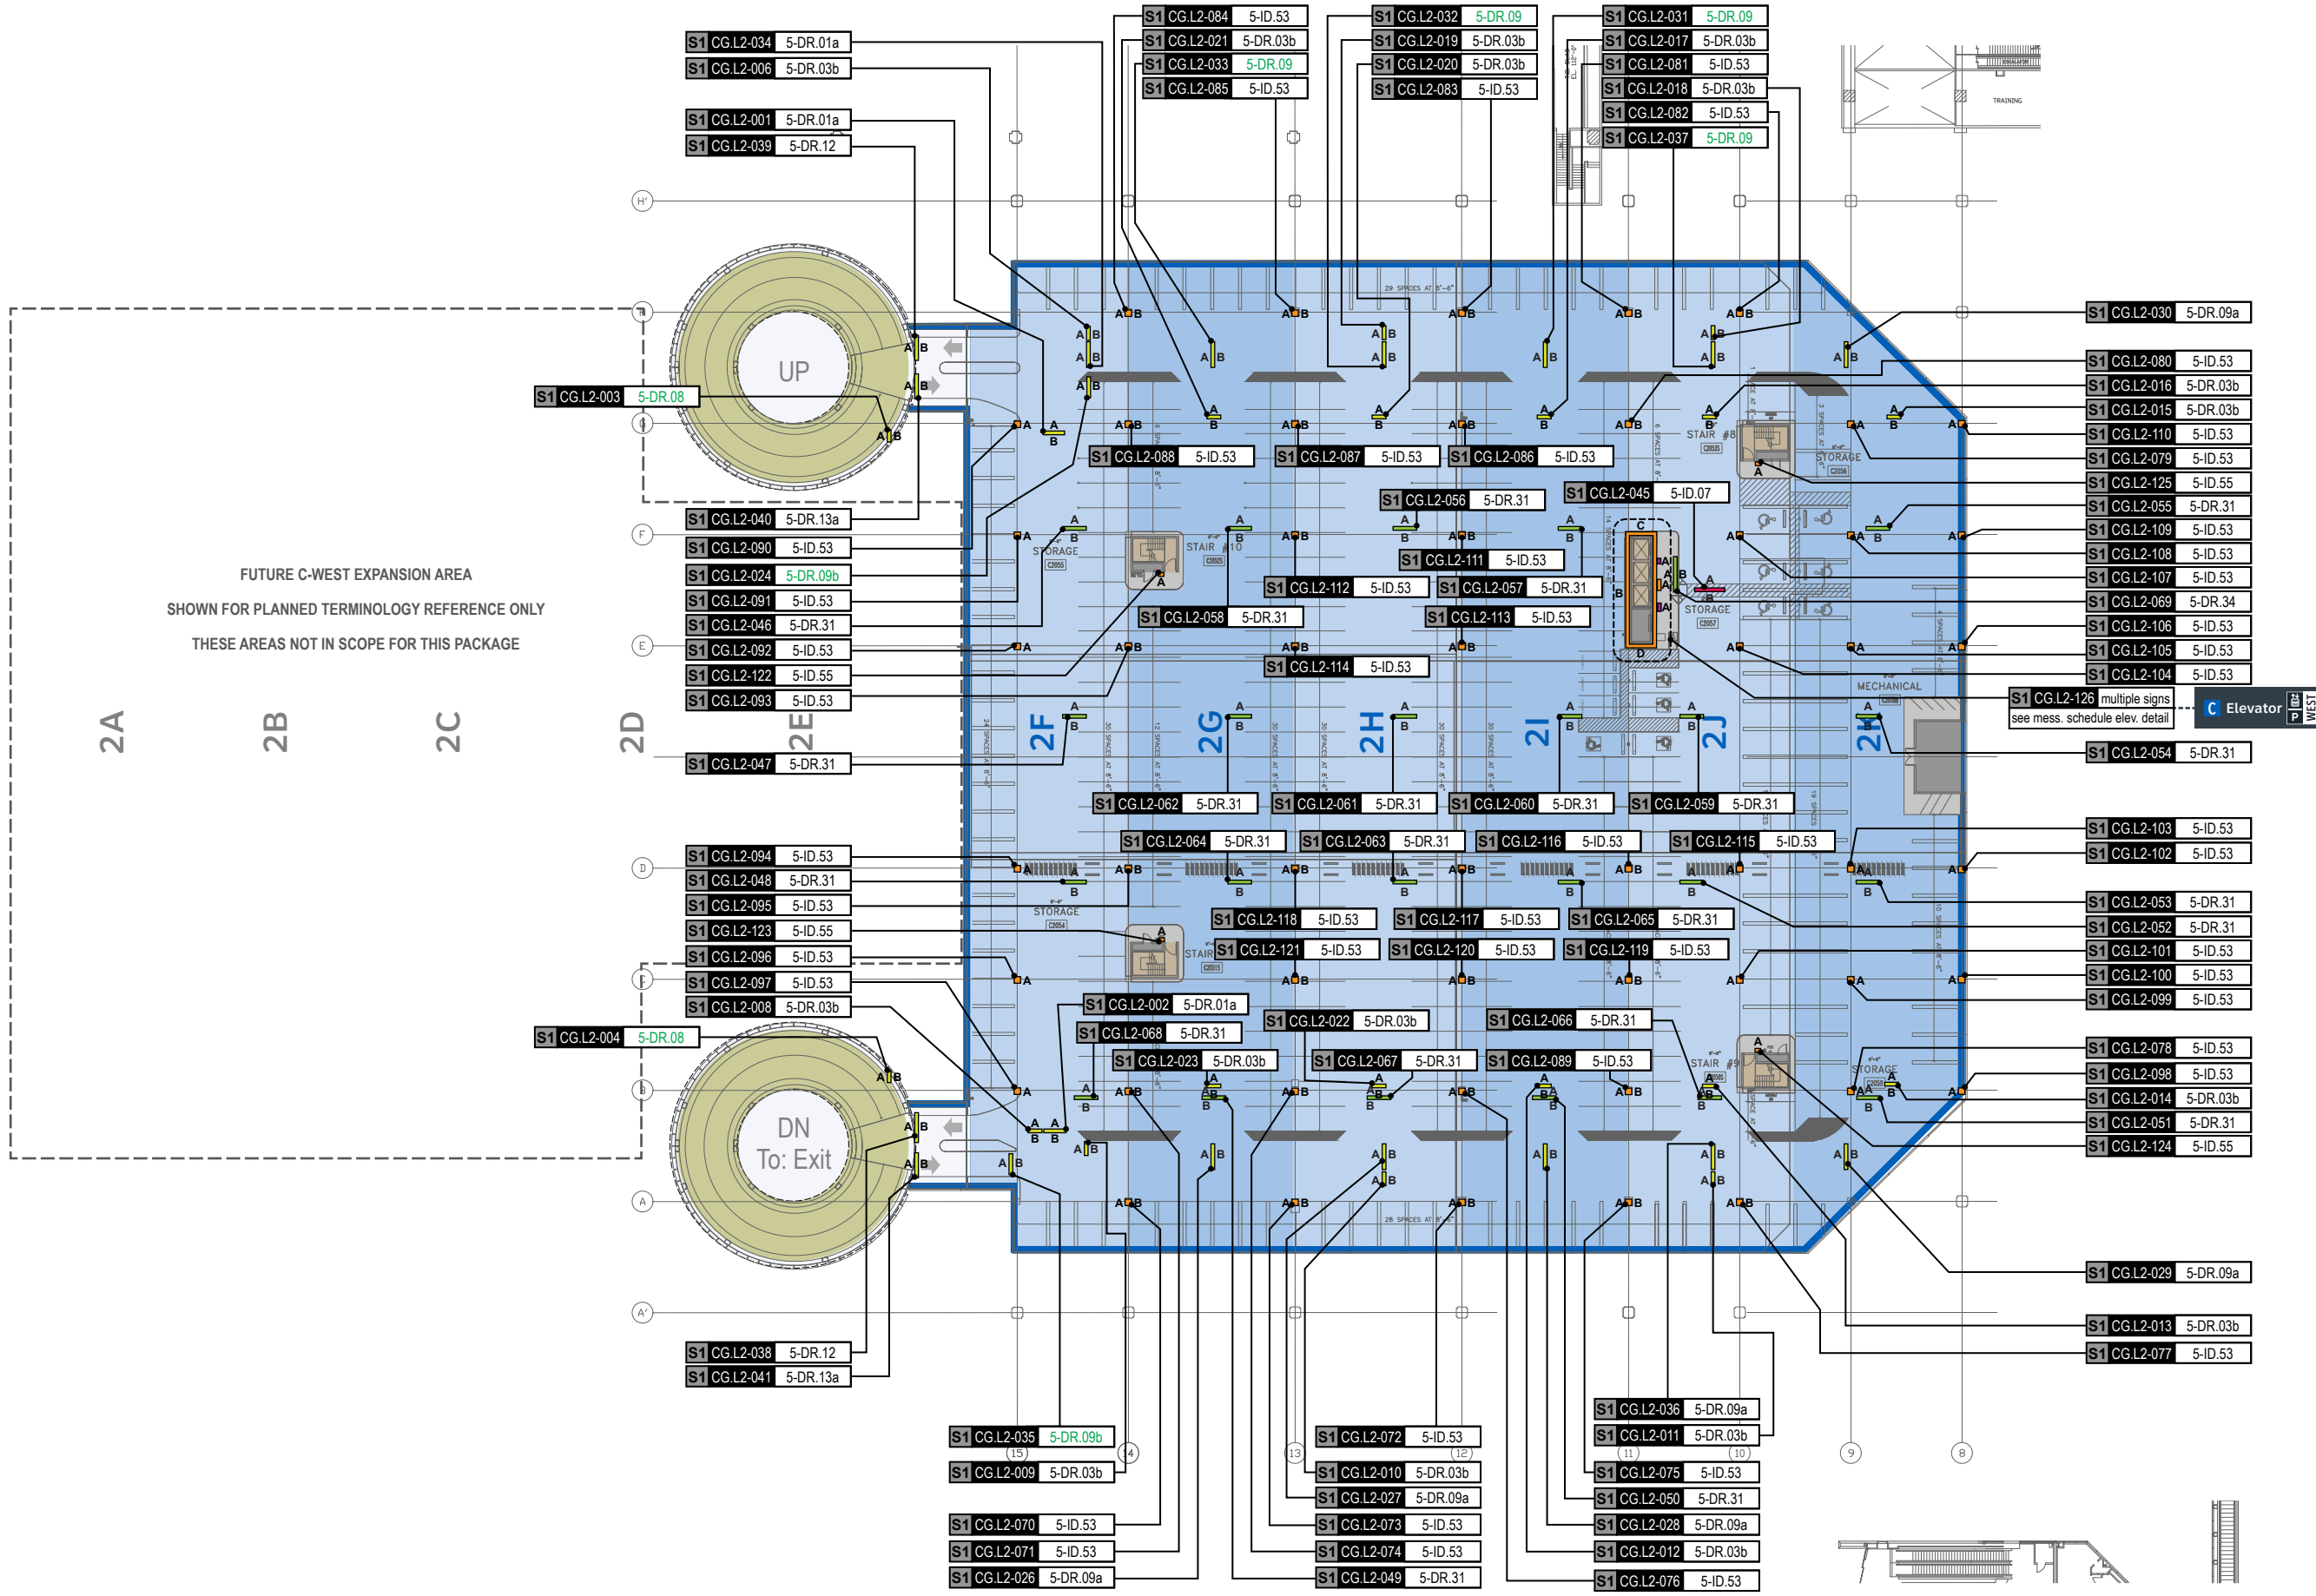
# 5.0

## **5.0 LOCATION PLANS & MESSAGE SCHEDULES: LEVEL 2**




FUTURE C-WEST EXPANSION AREA  
SHOWN FOR PLANNED TERMINOLOGY REFERENCE ONLY  
THESE AREAS NOT IN SCOPE FOR THIS PACKAGE

**GENERAL NOTES**

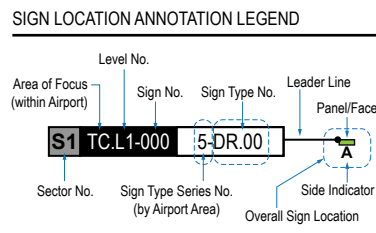- Sign locations & orientations shown here are approximations based on the most current plan drawings as provided to the designer by the architect at the time of this document's completion. These sign locations are for general design intent & wayfinding planning purposes only. They should not be construed or deemed as absolute or final locations. Field verification, marking & documentation of each final location is to be performed by the Fabricator/Installer & coordinated with project staff & Wayfinding Design Consultants for final approval.
- All final install locations must be marked and verified in the field for proper structural integrity, adequate line of sight, utilities / property-line / other existing signage interferences & must be in complete compliance with all local, state and national codes prior to fabrication or installation.
- Adjustments to the sign locations shown in these drawings must be documented by the Fabricator/Installer, and provided to project staff & Wayfinding Design Consultants for final approval.

**NOTE:** Only priority wayfinding signage & locations as shown in this wayfinding plan package are in scope. All other signage not shown (including traffic control) are NOT IN SCOPE for this project/contract.



**LOCATION CODE DEFINITIONS:**

**AREA OF FOCUS:** (location within Airport)  
 TA = Terminal A  
 TB = Terminal B  
 TC = Terminal C  
 TD = Terminal D  
 TE = Terminal E  
 AB = AB Garage  
 CG = C Garage  
 DE = DE Garage

**SIGN TYPE SERIES NO.:** (by Airport Area)  
 1- = Terminals/Concourses  
 1t- = Terminals/Concourses: Temporary  
 2- = CBP Areas  
 3- = Curbside/Ground Trans.  
 4- = Roadways  
 5- = Parking

**WAYFINDING SIGN TYPE:**  
 DR.xx = Directional  
 ID.xx = Identification  
 IN.xx = Informational

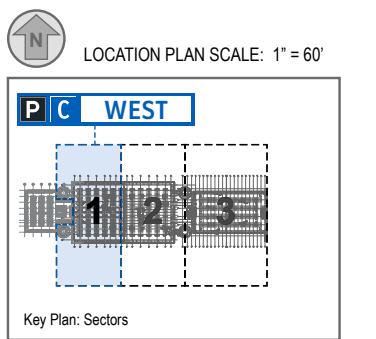
**WAYFINDING SIGN LOCATIONS - Parking:**

**PEDESTRIAN Signs:**  
 A/B = Directional (DR)  
 A/B = Identification (ID)  
 A/B = Informational (IN)


**VEHICULAR Signs:**  
 A/B = Directional (DR)  
 A/B = Identification (ID)  
 A/B = Informational (IN)

**CIRCULATION:**

- Public Use PEDESTRIAN Vertical Circulation (i.e. Elevators/Escalators/Stairs)
- Public Use VEHICULAR Vertical Circulation (i.e. Ramps)
- Alpha-Numeric Parking Section Naming Areas (Blues = C Garages; Oranges = D/E Garage)
- Areas Not In Scope for this Package




S1 CG.L2-001 5-DR.01a Notes: N/A

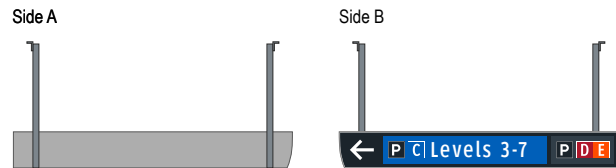


S1 CG.L2-005 N/A Notes: N/A

NOT USED

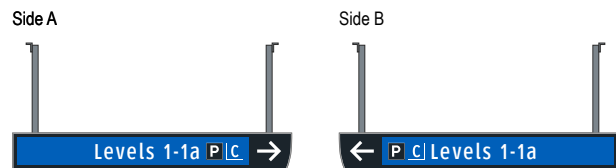
S1 CG.L2-002 5-DR.01a Notes: N/A



S1 CG.L2-006 5-DR.03b Notes: N/A

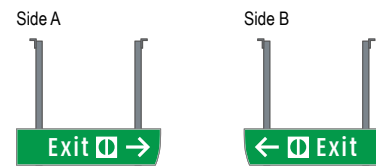


S1 CG.L2-003 5-DR.08 Notes: N/A

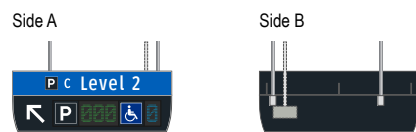


S1 CG.L2-007 N/A Notes: N/A

NOT USED

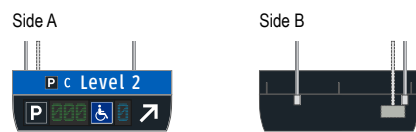S1 CG.L2-004 5-DR.08 Notes: N/A



S1 CG.L2-008 5-DR.03b Notes: N/A

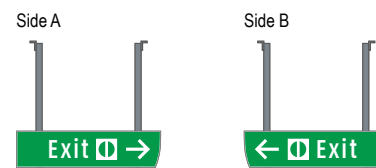

**Wayfinding Updates**

Issue Date: 08-23-2024

**Issue for Bid**

- REV. 
- REV. 
- REV. 

**WARNING:**

This record contains Sensitive Security Information that is controlled under 49 CFR parts 15 and 1520. No part of this record may be disclosed to persons with a "need to know," as defined in 49 CFR parts 15 and 1520, except with the written permission of the Administrator of the Transportation Security Administration or the Secretary of Transportation. Unauthorized release may result in civil penalty or other action. For U.S. government agencies, public disclosure is governed by 5 U.S.C. 552 and 49 CFR parts 15 and 1520.



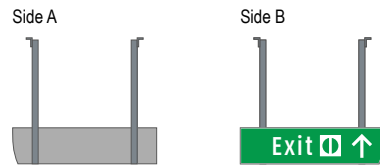
08-23-2024

THESE SHEETS ARE ISSUED FOR GRAPHICAL INFORMATION ONLY


**5.2 MESSAGE SCHEDULE - GARAGE C: LEVEL 2 - SECTOR 1 (C WEST)**

BSG PRJCT# BSG-2024-111-IAH  
 HAS TIP # 24 -103 - IAH


S1 CG.L2-009 5-DR.03b Notes: N/A




S1 CG.L2-013 5-DR.03b Notes: N/A

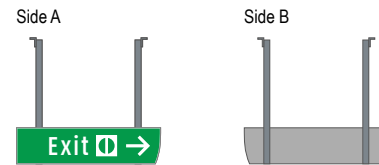


S1 CG.L2-010 5-DR.03b Notes: N/A

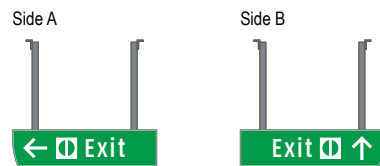


S1 CG.L2-014 5-DR.03b Notes: N/A

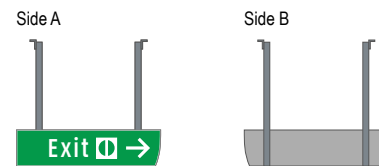


S1 CG.L2-011 5-DR.03b Notes: N/A

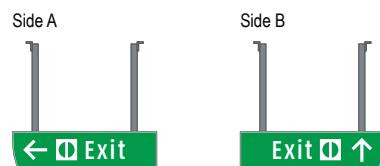


S1 CG.L2-015 5-DR.03b Notes: N/A

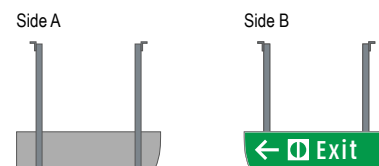


S1 CG.L2-012 5-DR.03b Notes: N/A

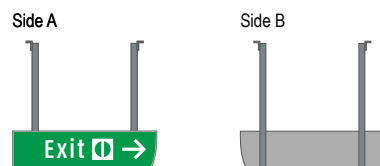


S1 CG.L2-016 5-DR.03b Notes: N/A

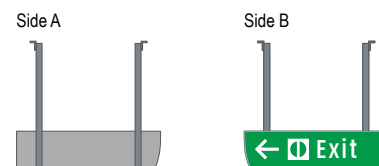


S1 CG.L2-017 5-DR.03b Notes: N/A

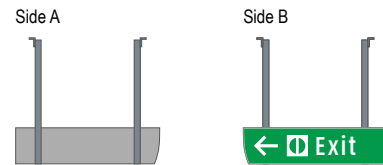


S1 CG.L2-021 5-DR.03b Notes: N/A

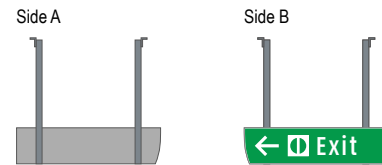


S1 CG.L2-018 5-DR.03b Notes: N/A

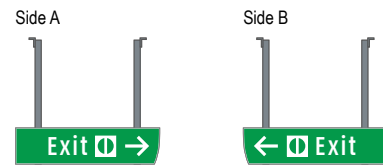


S1 CG.L2-022 5-DR.03b Notes: N/A

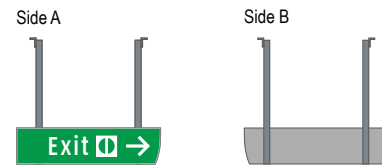


S1 CG.L2-019 5-DR.03b Notes: N/A

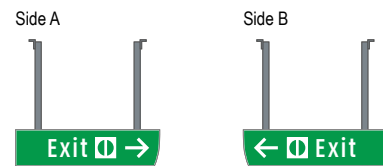


S1 CG.L2-023 5-DR.03b Notes: N/A

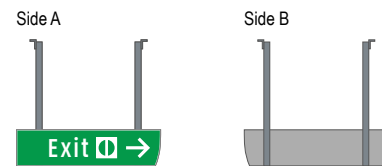

S1 CG.L2-020 5-DR.03b Notes: N/A

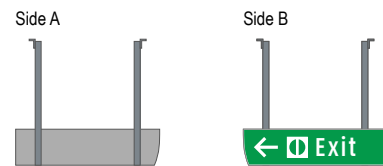

S1 CG.L2-024 5-DR.09b Notes: N/A

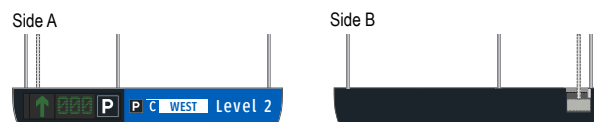

**Wayfinding Updates**

Issue Date: 08-23-2024

Issue for Bid

- REV. 
- REV. 
- REV. 

**WARNING:**

This record contains Sensitive Security Information that is controlled under 49 CFR parts 15 and 1520. No part of this record may be disclosed to persons with a "need to know," as defined in 49 CFR parts 15 and 1520, except with the written permission of the Administrator of the Transportation Security Administration or the Secretary of Transportation. Unauthorized release may result in civil penalty or other action. For U.S. government agencies, public disclosure is governed by 5 U.S.C. 552 and 49 CFR parts 15 and 1520.



08-23-2024

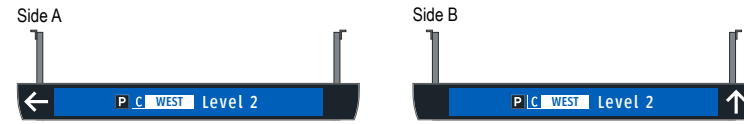
**5.2 MESSAGE SCHEDULE - GARAGE C: LEVEL 2 - SECTOR 1 (C WEST)**

THESE SHEETS ARE ISSUED FOR GRAPHICAL INFORMATION ONLY


S1 CG.L2-025 N/A Notes: N/A

NOT USED


S1 CG.L2-029 5-DR.09a Notes: N/A




S1 CG.L2-026 5-DR.09a Notes: N/A

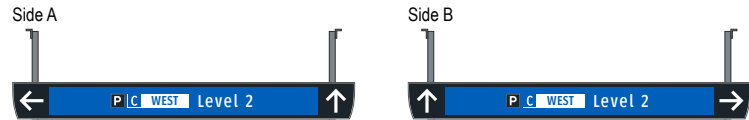


S1 CG.L2-030 5-DR.09a Notes: N/A

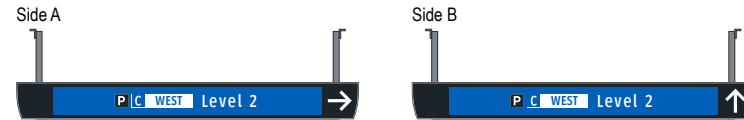


S1 CG.L2-027 5-DR.09a Notes: N/A

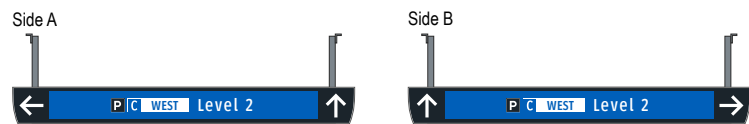


S1 CG.L2-031 5-DR.09 Notes: N/A

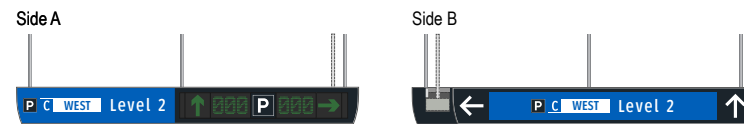


S1 CG.L2-028 5-DR.09a Notes: N/A

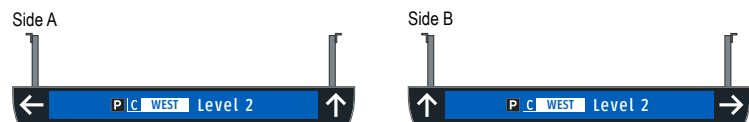


S1 CG.L2-032 5-DR.09 Notes: N/A

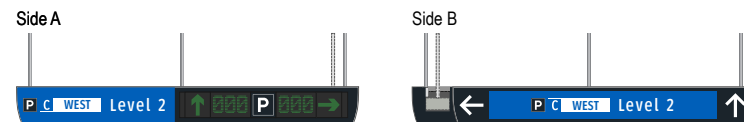


S1 CG.L2-033 5-DR.09 Notes: N/A

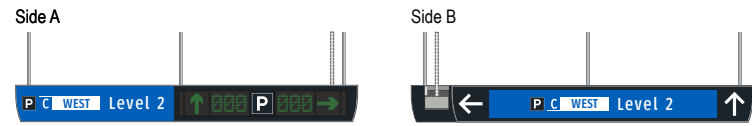


S1 CG.L2-037 5-DR.09 Notes: N/A

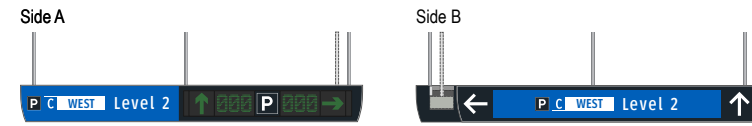


S1 CG.L2-034 5-DR.01a Notes: N/A

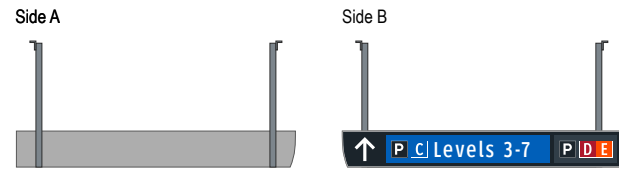


S1 CG.L2-038 5-DR.12 Notes: N/A

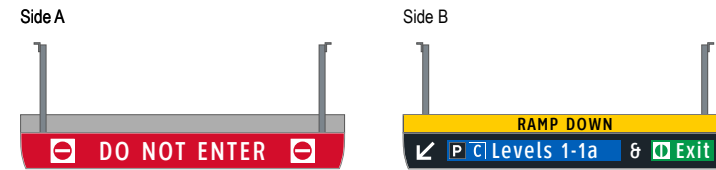


S1 CG.L2-035 5-DR.09b Notes: N/A

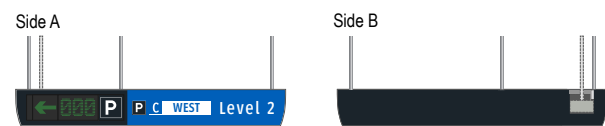


S1 CG.L2-039 5-DR.12 Notes: N/A

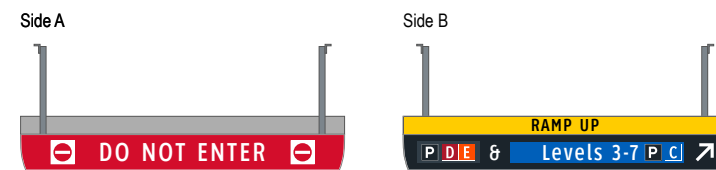


S1 CG.L2-036 5-DR.09a Notes: N/A

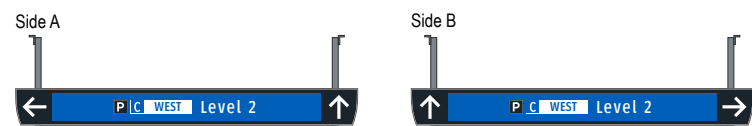


S1 CG.L2-040 5-DR.13a Notes: N/A

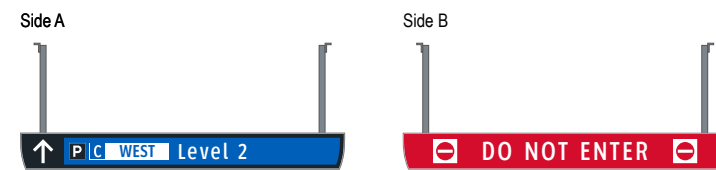

S1 CG.L2-041 5-DR.13a Notes: N/A

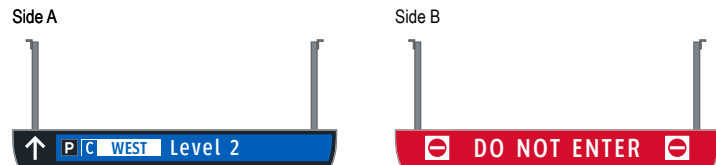


S1 CG.L2-045 5-ID.07 Notes: N/A

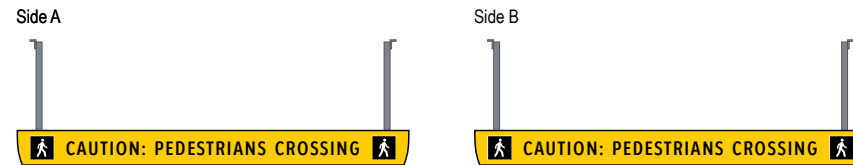

S1 CG.L2-042 N/A Notes: N/A

NOT USED

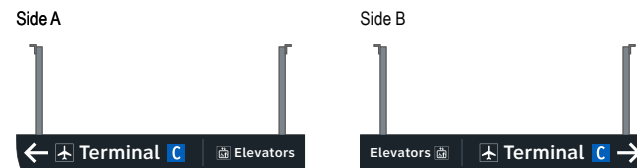
S1 CG.L2-046 5-DR.31 Notes: N/A



S1 CG.L2-043 N/A Notes: N/A

NOT USED

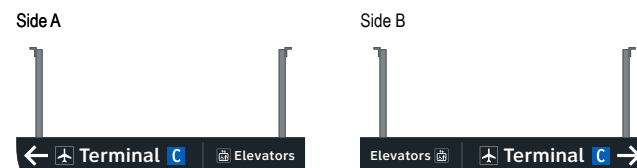
S1 CG.L2-047 5-DR.31 Notes: N/A



S1 CG.L2-044 N/A Notes: N/A


NOT USED

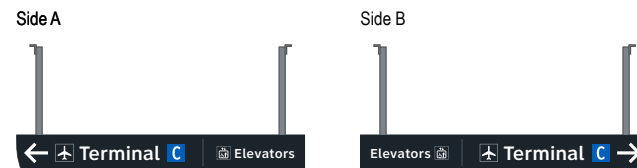S1 CG.L2-048 5-DR.31 Notes: N/A







S1 CG.L2-049 5-DR.31 Notes: N/A

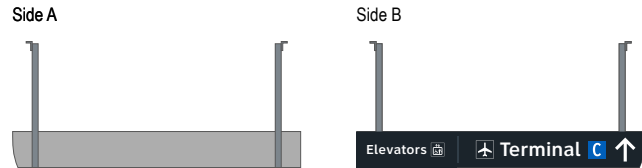


S1 CG.L2-053 5-DR.31 Notes: N/A

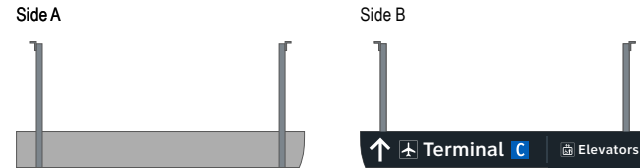


S1 CG.L2-050 5-DR.31 Notes: N/A

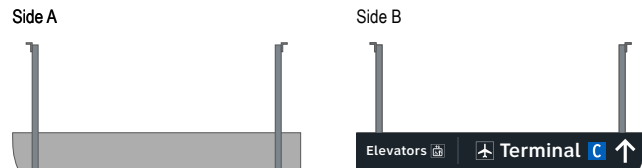


S1 CG.L2-054 5-DR.31 Notes: N/A

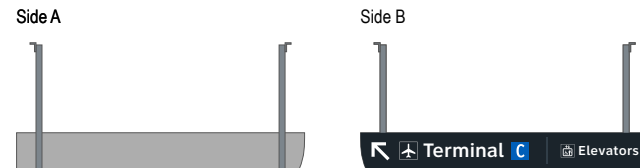


S1 CG.L2-051 5-DR.31 Notes: Notes: N/A

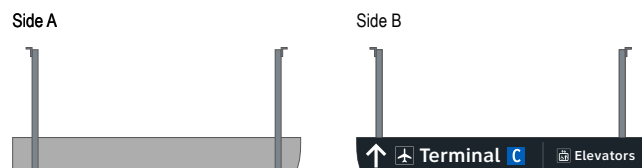


S1 CG.L2-055 5-DR.31 Notes: N/A

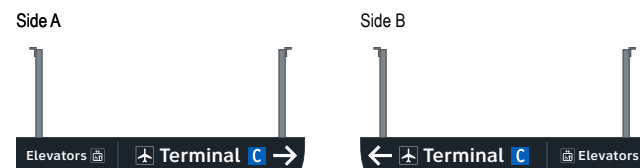

S1 CG.L2-052 5-DR.31 Notes: N/A

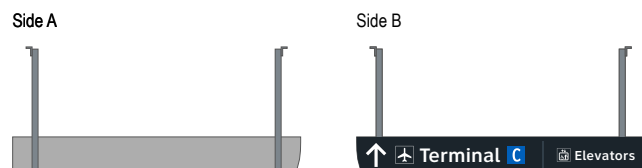

S1 CG.L2-056 5-DR.31 Notes: N/A

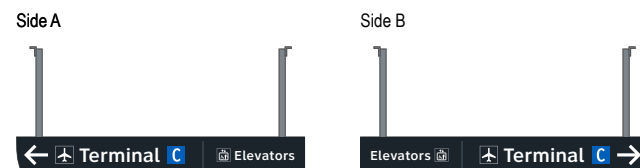

**Wayfinding Updates**

Issue Date: 08-23-2024

**Issue for Bid**

- REV. 
- REV. 
- REV. 

**WARNING:**

This record contains Sensitive Security Information that is controlled under 49 CFR parts 15 and 1520. No part of this record may be disclosed to persons with a "need to know," as defined in 49 CFR parts 15 and 1520, except with the written permission of the Administrator of the Transportation Security Administration or the Secretary of Transportation. Unauthorized release may result in civil penalty or other action. For U.S. government agencies, public disclosure is governed by 5 U.S.C. 552 and 49 CFR parts 15 and 1520.

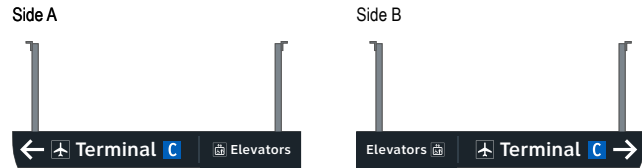


THESE SHEETS ARE ISSUED FOR GRAPHICAL INFORMATION ONLY


**5.2 MESSAGE SCHEDULE - GARAGE C: LEVEL 2 - SECTOR 1 (C WEST)**

BSG PRJCT# BSG-2024-111-IAH  
 HAS TIP # 24 -103 - IAH


S1 CG.L2-057 5-DR.31 Notes: N/A




S1 CG.L2-061 5-DR.31 Notes: N/A

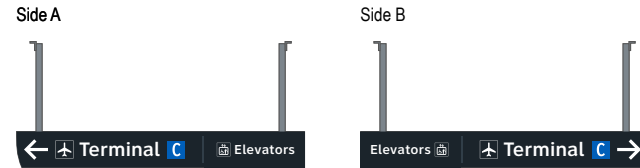


S1 CG.L2-058 5-DR.31 Notes: N/A

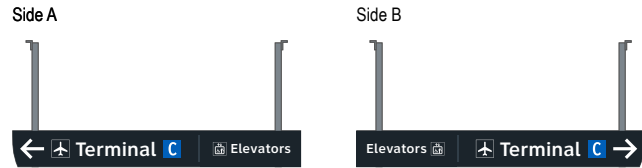


S1 CG.L2-062 5-DR.31 Notes: N/A

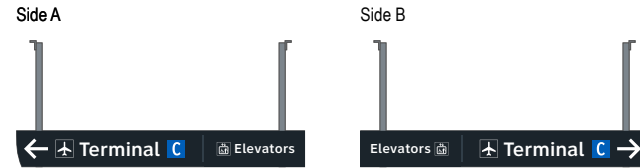


S1 CG.L2-059 5-DR.31 Notes: N/A

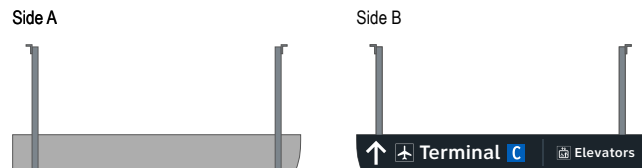


S1 CG.L2-063 5-DR.31 Notes: N/A

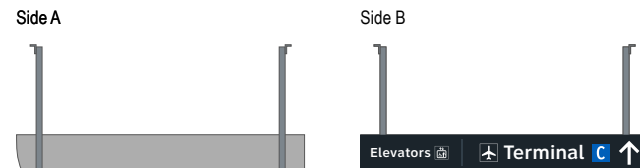

S1 CG.L2-060 5-DR.31 Notes: N/A

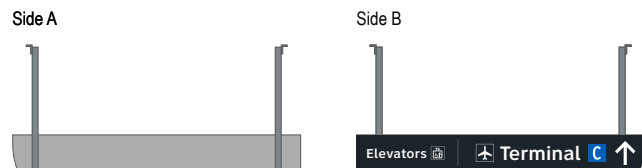

S1 CG.L2-064 5-DR.31 Notes: N/A

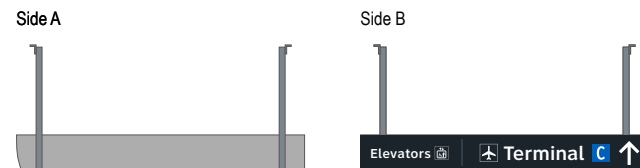

**Wayfinding Updates**

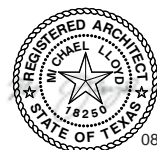
Issue Date: 08-23-2024

**Issue for Bid**

- REV. 
- REV. 
- REV. 

**WARNING:**

This record contains Sensitive Security Information that is controlled under 49 CFR parts 15 and 1520. No part of this record may be disclosed to persons with a "need to know," as defined in 49 CFR parts 15 and 1520, except with the written permission of the Administrator of the Transportation Security Administration or the Secretary of Transportation. Unauthorized release may result in civil penalty or other action. For U.S. government agencies, public disclosure is governed by 5 U.S.C. 552 and 49 CFR parts 15 and 1520.




08-23-2024

THESE SHEETS ARE ISSUED FOR GRAPHICAL INFORMATION ONLY


**5.2 MESSAGE SCHEDULE - GARAGE C: LEVEL 2 - SECTOR 1 (C WEST)**

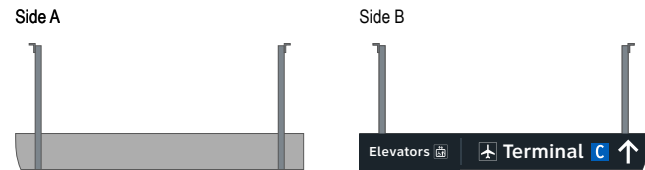BSG PRJCT# BSG-2024-111-IAH  
 HAS TIP # 24 -103 - IAH


S1 CG.L2-065 5-DR.31 Notes: N/A




S1 CG.L2-069 5-DR.34 Notes: N/A

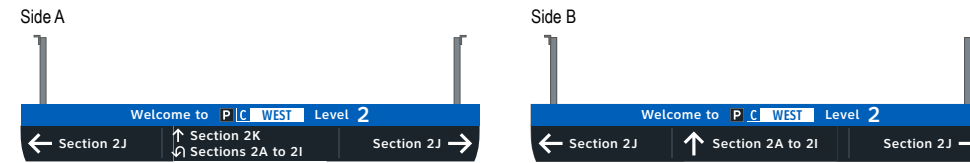


S1 CG.L2-066 5-DR.31 Notes: N/A

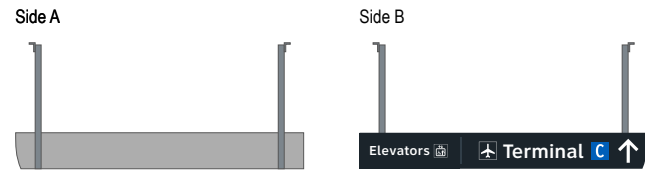


S1 CG.L2-070 5-ID.53 Notes: N/A

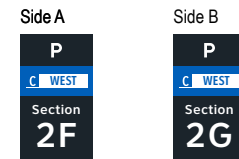


S1 CG.L2-067 5-DR.31 Notes: N/A

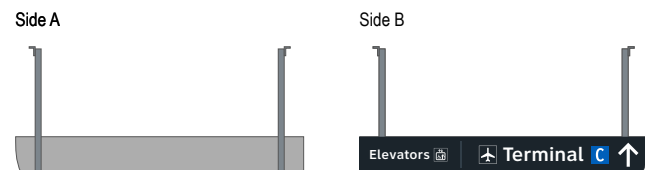


S1 CG.L2-071 5-ID.53 Notes: N/A

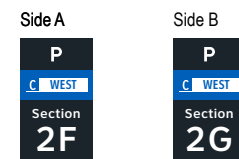

S1 CG.L2-068 5-DR.31 Notes: N/A

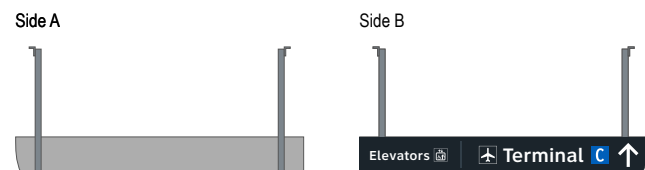

S1 CG.L2-072 5-ID.53 Notes: N/A

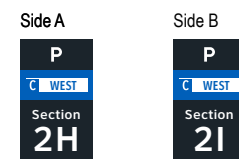

**Wayfinding Updates**

Issue Date: 08-23-2024  
Issue for Bid

- REV. 
- REV. 
- REV. 

**WARNING:**

This record contains Sensitive Security Information that is controlled under 49 CFR parts 15 and 1520. No part of this record may be disclosed to persons with a "need to know," as defined in 49 CFR parts 15 and 1520, except with the written permission of the Administrator of the Transportation Security Administration or the Secretary of Transportation. Unauthorized release may result in civil penalty or other action. For U.S. government agencies, public disclosure is governed by 5 U.S.C. 552 and 49 CFR parts 15 and 1520.

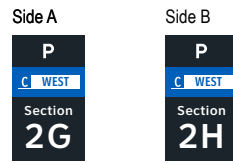


THESE SHEETS ARE ISSUED FOR GRAPHICAL INFORMATION ONLY


**5.2 MESSAGE SCHEDULE - GARAGE C: LEVEL 2 - SECTOR 1 (C WEST)**

BSG PRJCT# BSG-2024-111-IAH  
 HAS TIP # 24 -103 - IAH


S1 CG.L2-073 5-ID.53 Notes: N/A




S1 CG.L2-077 5-ID.53 Notes: N/A

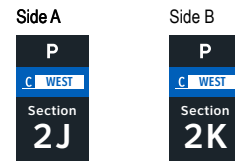


S1 CG.L2-074 5-ID.53 Notes: N/A

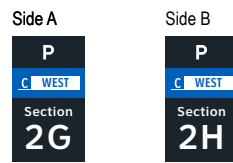


S1 CG.L2-078 5-ID.53 Notes: N/A

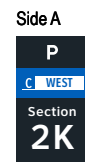


S1 CG.L2-075 5-ID.53 Notes: N/A

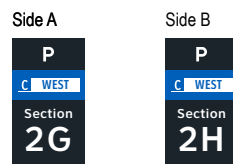


S1 CG.L2-079 5-ID.53 Notes: N/A

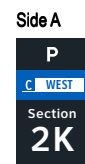


S1 CG.L2-076 5-ID.53 Notes: N/A

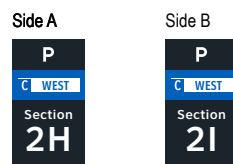


S1 CG.L2-080 5-ID.53 Notes: N/A

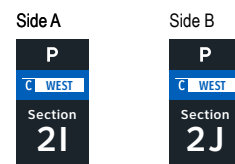


S1 CG.L2-081 5-ID.53 Notes: N/A

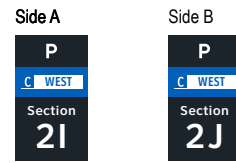


S1 CG.L2-085 5-ID.53 Notes: N/A

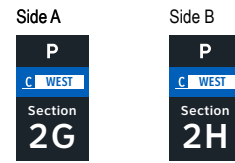


S1 CG.L2-082 5-ID.53 Notes: N/A

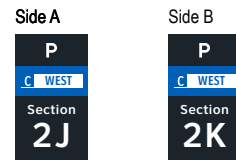


S1 CG.L2-086 5-ID.53 Notes: N/A

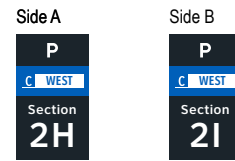


S1 CG.L2-083 5-ID.53 Notes: N/A

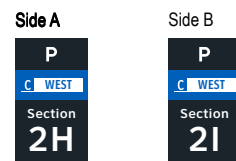


S1 CG.L2-087 5-ID.53 Notes: N/A

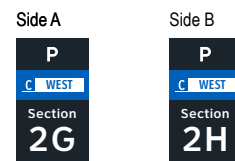

S1 CG.L2-084 5-ID.53 Notes: N/A

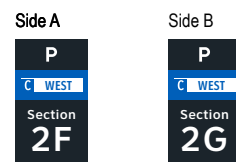

S1 CG.L2-088 5-ID.53 Notes: N/A

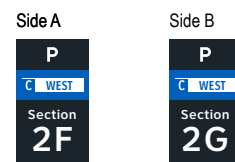

**Wayfinding Updates**

Issue Date: 08-23-2024

**Issue for Bid**

- REV. 
- REV. 
- REV. 

**WARNING:**

This record contains Sensitive Security Information that is controlled under 49 CFR parts 15 and 1520. No part of this record may be disclosed to persons with a "need to know," as defined in 49 CFR parts 15 and 1520, except with the written permission of the Administrator of the Transportation Security Administration or the Secretary of Transportation. Unauthorized release may result in civil penalty or other action. For U.S. government agencies, public disclosure is governed by 5 U.S.C. 552 and 49 CFR parts 15 and 1520.



THESE SHEETS ARE ISSUED FOR GRAPHICAL INFORMATION ONLY

**5.2 MESSAGE SCHEDULE - GARAGE C: LEVEL 2 - SECTOR 1 (C WEST)**

BSG PRJCT# BSG-2024-111-IAH  
HAS TIP # 24 -103 - IAH

S1 CG.L2-089 5-ID.53 Notes: N/A

Side A      Side B

P	P
C WEST	C WEST
Section	Section
2I	2J

S1 CG.L2-093 5-ID.53 Notes: N/A

Side A      Side B

P	P
C WEST	C WEST
Section	Section
2F	2G

S1 CG.L2-090 5-ID.53 Notes: N/A

Side A

P
C WEST
Section
2F

S1 CG.L2-094 5-ID.53 Notes: N/A

Side A

P
C WEST
Section
2F

S1 CG.L2-091 5-ID.53 Notes: N/A

Side A

P
C WEST
Section
2F

S1 CG.L2-095 5-ID.53 Notes: N/A

Side A      Side B

P	P
C WEST	C WEST
Section	Section
2F	2G

S1 CG.L2-092 5-ID.53 Notes: N/A

Side A

P
C WEST
Section
2F

S1 CG.L2-096 5-ID.53 Notes: N/A

Side A

P
C WEST
Section
2F

**Wayfinding Updates**

Issue Date: 08-23-2024

**Issue for Bid**

- REV. 
- REV. 
- REV. 

**WARNING:**

This record contains Sensitive Security Information that is controlled under 49 CFR parts 15 and 1520. No part of this record may be disclosed to persons with a "need to know," as defined in 49 CFR parts 15 and 1520, except with the written permission of the Administrator of the Transportation Security Administration or the Secretary of Transportation. Unauthorized release may result in civil penalty or other action. For U.S. government agencies, public disclosure is governed by 5 U.S.C. 552 and 49 CFR parts 15 and 1520.



THESE SHEETS ARE ISSUED FOR GRAPHICAL INFORMATION ONLY

**5.2 MESSAGE SCHEDULE - GARAGE C: LEVEL 2 - SECTOR 1 (C WEST)**

BSG PRJCT# BSG-2024-111-IAH  
HAS TIP # 24 -103 - IAH

S1 CG.L2-097 5-ID.53 Notes: N/A

Side A

P  
 C WEST  
 Section  
 2F

S1 CG.L2-098 5-ID.53 Notes: N/A

Side A

P  
 C WEST  
 Section  
 2K

S1 CG.L2-099 5-ID.53 Notes: N/A

Side A

P  
 C WEST  
 Section  
 2K

S1 CG.L2-100 5-ID.53 Notes: N/A

Side A

P  
 C WEST  
 Section  
 2K

S1 CG.L2-101 5-ID.53 Notes: N/A

Side A

P  
 C WEST  
 Section  
 2J

S1 CG.L2-102 5-ID.53 Notes: N/A

Side A

P  
 C WEST  
 Section  
 2K

S1 CG.L2-103 5-ID.53 Notes: N/A

Side A

P  
 C WEST  
 Section  
 2K

S1 CG.L2-104 5-ID.53 Notes: N/A

Side A

P  
 C WEST  
 Section  
 2J



GEORGE BUSH INTERCONTINENTAL AIRPORT  
Wayfinding Signage Design Intent Documents  
C Garage



Louisville, Colorado  
P: 303.494.7849  
www.labozan.com

These documents are intended to illustrate design intent, and should only be used as a general guideline. No information contained here should be construed as engineered elements. The fabricator/contractor shall be responsible for all engineering and specifications with regard to structural, electrical, mechanical, foundation and installation. Information and illustrations contained here are part of an original unpublished design by Labozan Associates, Inc. Detailing and information contained on these pages shall not be reproduced, copied or utilized in any way except for the specific project for which they were created without previous written authorization from Labozan Associates, Inc.  
© 2024 by Labozan Associates, Inc.

Wayfinding Updates

Issue Date: 08-23-2024  
Issue for Bid

- REV.
- REV.
- REV.

WARNING:

This record contains Sensitive Security Information that is controlled under 49 CFR parts 15 and 1520. No part of this record may be disclosed to persons with a "need to know," as defined in 49 CFR parts 15 and 1520, except with the written permission of the Administrator of the Transportation Security Administration or the Secretary of Transportation. Unauthorized release may result in civil penalty or other action. For U.S. government agencies, public disclosure is governed by 5 U.S.C. 552 and 49 CFR parts 15 and 1520.



08-23-2024

THESE SHEETS ARE ISSUED FOR GRAPHICAL INFORMATION ONLY

5.2 MESSAGE SCHEDULE - GARAGE C: LEVEL 2 - SECTOR 1 (C WEST)

BSG PRJCT# BSG-2024-111-IAH  
HAS TIP # 24 -103 - IAH

Side A

P  
 C WEST  
 Section  
**2K**

Side A

P  
 C WEST  
 Section  
**2K**

Side A

P  
 C WEST  
 Section  
**2J**

Side A

P  
 C WEST  
 Section  
**2K**

Side A

P  
 C WEST  
 Section  
**2K**

Side A

P  
 C WEST  
 Section  
**2K**

Side A

P  
 C WEST  
 Section  
**2H**

Side B

P  
 C WEST  
 Section  
**2I**

Side A

P  
 C WEST  
 Section  
**2G**

Side B

P  
 C WEST  
 Section  
**2H**



**Wayfinding Updates**

Issue Date: 08-23-2024  
Issue for Bid

- REV.
- REV.
- REV.

**WARNING:**

This record contains Sensitive Security Information that is controlled under 49 CFR parts 15 and 1520. No part of this record may be disclosed to persons with a "need to know," as defined in 49 CFR parts 15 and 1520, except with the written permission of the Administrator of the Transportation Security Administration or the Secretary of Transportation. Unauthorized release may result in civil penalty or other action. For U.S. government agencies, public disclosure is governed by 5 U.S.C. 552 and 49 CFR parts 15 and 1520.



08-23-2024

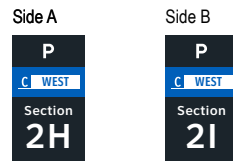
THESE SHEETS ARE ISSUED FOR GRAPHICAL INFORMATION ONLY

**5.2 MESSAGE SCHEDULE - GARAGE C: LEVEL 2 - SECTOR 1 (C WEST)**


BSG PRJCT# BSG-2024-111-IAH  
 HAS TIP # 24 -103 - IAH




S1 CG.L2-113 5-ID.53 Notes: N/A




S1 CG.L2-117 5-ID.53 Notes: N/A

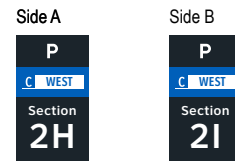


S1 CG.L2-114 5-ID.53 Notes: N/A

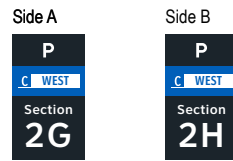


S1 CG.L2-118 5-ID.53 Notes: N/A

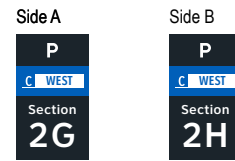


S1 CG.L2-115 5-ID.53 Notes: N/A

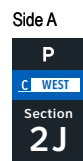


S1 CG.L2-119 5-ID.53 Notes: N/A

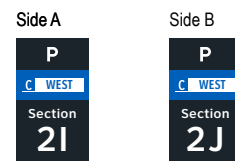

S1 CG.L2-116 5-ID.53 Notes: N/A

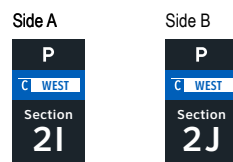

S1 CG.L2-120 5-ID.53 Notes: N/A

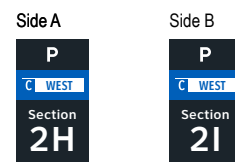

**Wayfinding Updates**

Issue Date: 08-23-2024

**Issue for Bid**

- REV. 
- REV. 
- REV. 

**WARNING:**

This record contains Sensitive Security Information that is controlled under 49 CFR parts 15 and 1520. No part of this record may be disclosed to persons with a "need to know," as defined in 49 CFR parts 15 and 1520, except with the written permission of the Administrator of the Transportation Security Administration or the Secretary of Transportation. Unauthorized release may result in civil penalty or other action. For U.S. government agencies, public disclosure is governed by 5 U.S.C. 552 and 49 CFR parts 15 and 1520.



THESE SHEETS ARE ISSUED FOR GRAPHICAL INFORMATION ONLY

**5.2 MESSAGE SCHEDULE - GARAGE C: LEVEL 2 - SECTOR 1 (C WEST)**

BSG PRJCT# BSG-2024-111-IAH  
HAS TIP # 24 -103 - IAH

S1 CG.L2-121 5-ID.53 Notes: N/A

Side A

P

C WEST

Section  
**2G**

Side B

P

C WEST

Section  
**2H**

S1 CG.L2-125 5-ID.55 Notes: N/A

Side A

P

C WEST

Level  
**2**

Stairs 8

S1 CG.L2-122 5-ID.55 Notes: N/A

Side A

P

C WEST

Level  
**2**

Stairs 10

S1 CG.L2-123 5-ID.55 Notes: N/A

Side A

P

C WEST

Level  
**2**

Stairs 11

S1 CG.L2-124 5-ID.55 Notes: N/A

Side A

P

C WEST

Level  
**2**

Stairs 9

ELEVATOR CORE SIGNAGE CONTINUED ON NEXT SHEET



GEORGE BUSH INTERCONTINENTAL AIRPORT  
Wayfinding Signage Design Intent Documents  
**C Garage**



Louisville, Colorado  
P: 303.494.7849  
www.labozan.com

These documents are intended to illustrate design intent, and should only be used as a general guideline. No information contained here should be construed as engineered elements. The fabricator/contractor shall be responsible for all engineering and specifications with regard to structural, electrical, mechanical, foundation and installation. Information and illustrations contained here are part of an original unpublished design by Labozan Associates, Inc. Detailing and information contained on these pages shall not be reproduced, copied or utilized in any way except for the specific project for which they were created without previous written authorization from Labozan Associates, Inc.

**Wayfinding Updates**

Issue Date: 08-23-2024  
Issue for Bid

- REV.
- REV.
- REV.

**WARNING:**

This record contains Sensitive Security Information that is controlled under 49 CFR parts 15 and 1520. No part of this record may be disclosed to persons with a "need to know," as defined in 49 CFR parts 15 and 1520, except with the written permission of the Administrator of the Transportation Security Administration or the Secretary of Transportation. Unauthorized release may result in civil penalty or other action. For U.S. government agencies, public disclosure is governed by 5 U.S.C. 552 and 49 CFR parts 15 and 1520.



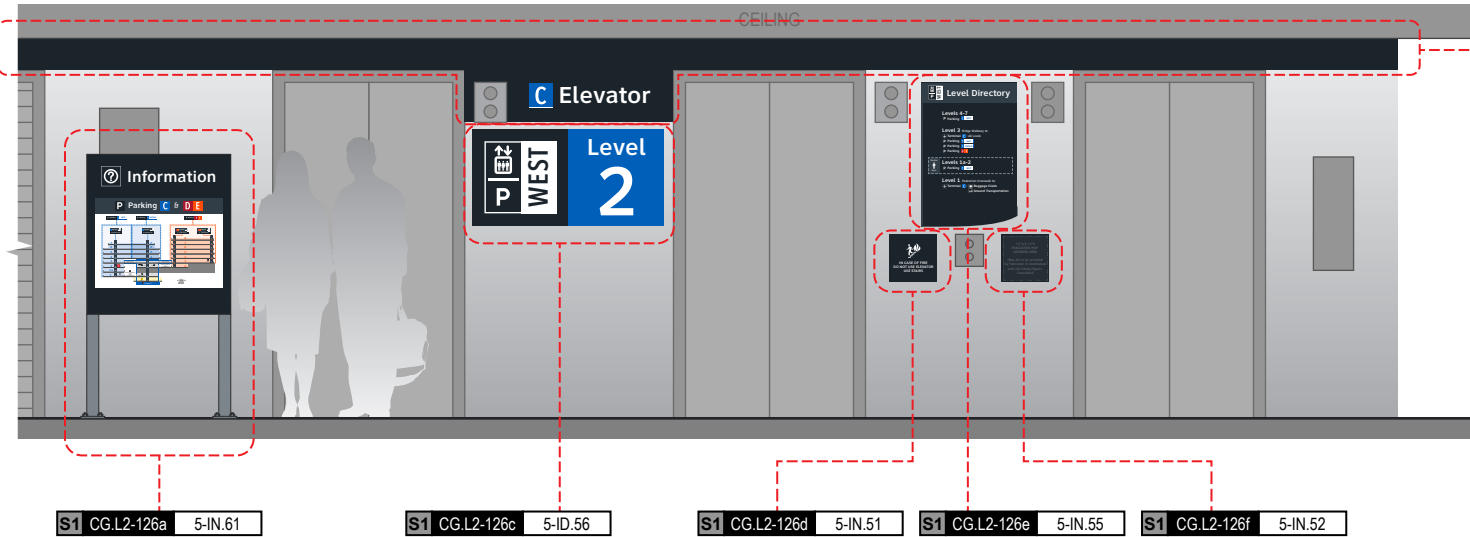
08-23-2024

THESE SHEETS ARE ISSUED FOR GRAPHICAL INFORMATION ONLY

**5.2 MESSAGE SCHEDULE - GARAGE C: LEVEL 2 - SECTOR 1 (C WEST)**

BSG PRJCT# BSG-2024-111-IAH  
HAS TIP # 24 -103 - IAH

Side A



- S1 CG.L2-126a 5-IN.61
- S1 CG.L2-126c 5-ID.56
- S1 CG.L2-126d 5-IN.51
- S1 CG.L2-126e 5-IN.55
- S1 CG.L2-126f 5-IN.52

NOTES: Directory artwork includes a "You Are Here" button graphic and is in a unique location per elevator core/level location; artwork included here is representative of final map artwork design intent for this location

NOTES: Level directory plaque includes a "You Are Here" graphic and is in a unique location per elevator core/level location; artwork included here is representative of final artwork design intent for this location

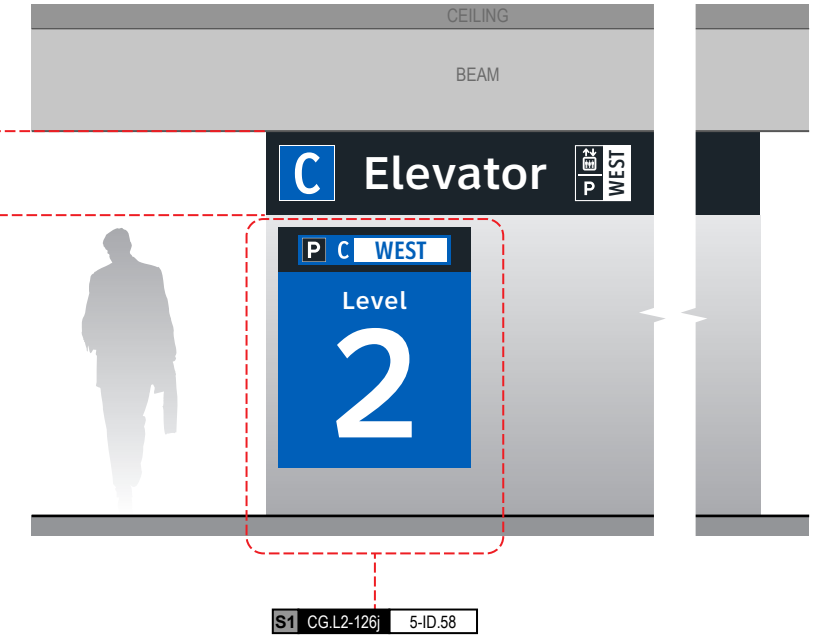
S1 CG.L2-126b 5-ID.57

NOTES: Wall paint and header graphics at front elevation only of elevator core included for this location number; wall elevation conditions shown are artistic representation based on rough site photo surveys; actual wall elevation conditions to be field verified by contractor/installer

S1 CG.L2-126g 5-ID.59


NOTES: Wall paint and header graphics on rear and two side elevations of elevator core included for this location number; wall elevation conditions shown are artistic representation based on rough site photo surveys; actual wall elevation conditions to be field verified by contractor/installer

Side C



S1 CG.L2-126j 5-ID.58

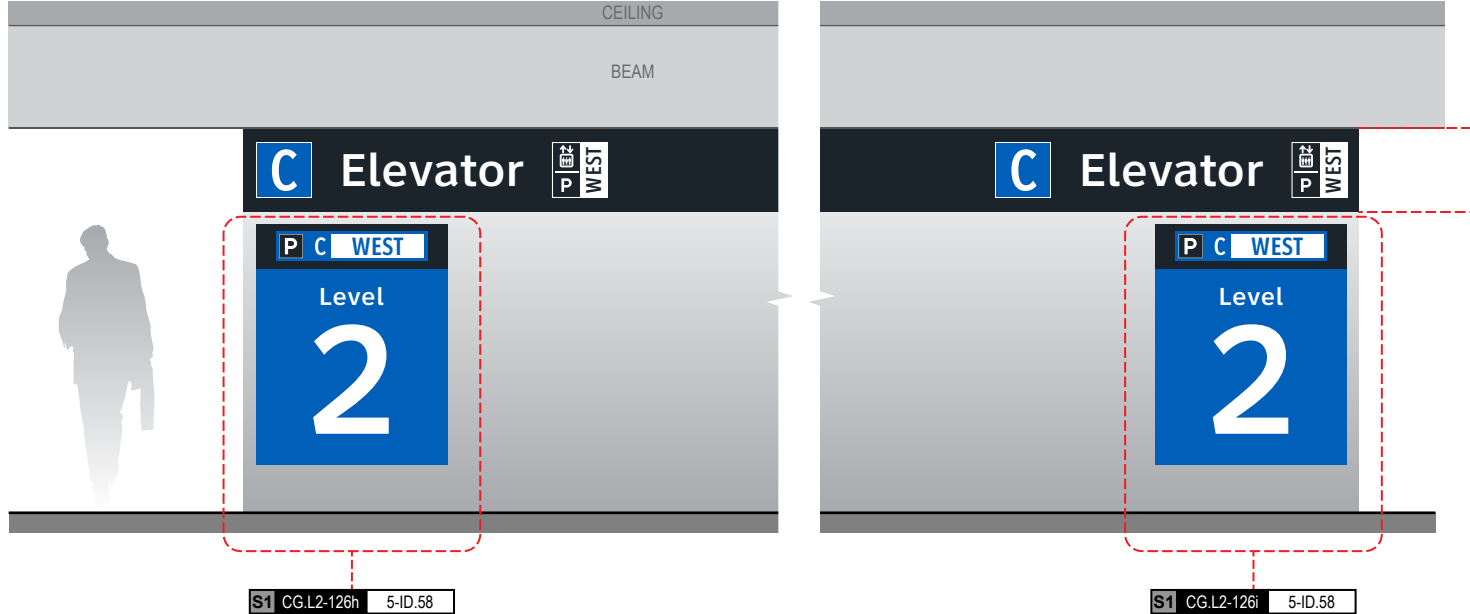
Side B



S1 CG.L2-126h 5-ID.58

S1 CG.L2-126i 5-ID.58

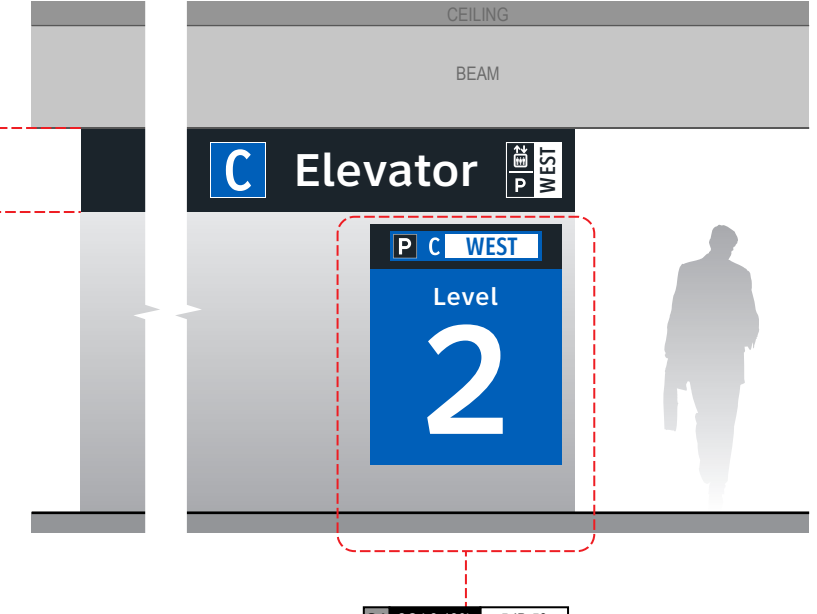Side D



S1 CG.L2-126k 5-ID.58


## END OF PARKING C: LEVEL 2 - SECTOR 1 MESSAGES

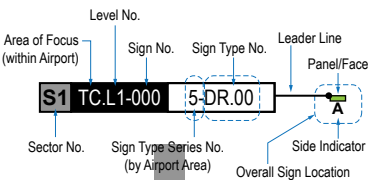**GENERAL NOTES**

- Sign locations & orientations shown here are approximations based on the most current plan drawings as provided to the designer by the architect at the time of this document's completion. These sign locations are for general design intent & wayfinding planning purposes only. They should not be construed or deemed as absolute or final locations. Field verification, marking & documentation of each final location is to be performed by the Fabricator/Installer & coordinated with project staff & Wayfinding Design Consultants for final approval.
- All final install locations must be marked and verified in the field for proper structural integrity, adequate line of sight, utilities / property-line / other existing signage interferences & must be in complete compliance with all local, state and national codes prior to fabrication or installation.
- Adjustments to the sign locations shown in these drawings must be documented by the Fabricator/Installer, and provided to project staff & Wayfinding Design Consultants for final approval.

**NOTE:** Only priority wayfinding signage & locations as shown in this wayfinding plan package are in scope. All other signage not shown (including traffic control) are **NOT IN SCOPE** for this project/contract.

**SIGN LOCATION ANNOTATION LEGEND**



**LOCATION CODE DEFINITIONS:**

- |  |   |
|--|---|
| <b>AREA OF FOCUS:</b><br>(location within Airport) | <b>SIGN TYPE SERIES NO.:</b><br>(by Airport Area) |
| TA = Terminal A                                    | 1- = Terminals/Concourses                         |
| TB = Terminal B                                    | 1t- = Terminals/Concourses: Temporary             |
| TC = Terminal C                                    | 2- = CBP Areas                                    |
| TD = Terminal D                                    | 3- = Curbside/Ground Trans.                       |
| TE = Terminal E                                    | 4- = Roadways                                     |
| AB = AB Garage                                     | 5- = Parking                                      |
| CG = C Garage                                      | <b>WAYFINDING SIGN TYPE:</b>                      |
| DE = DE Garage                                     | DR.xx = Directional                               |
|  | ID.xx = Identification                            |
|  | IN.xx = Informational                             |

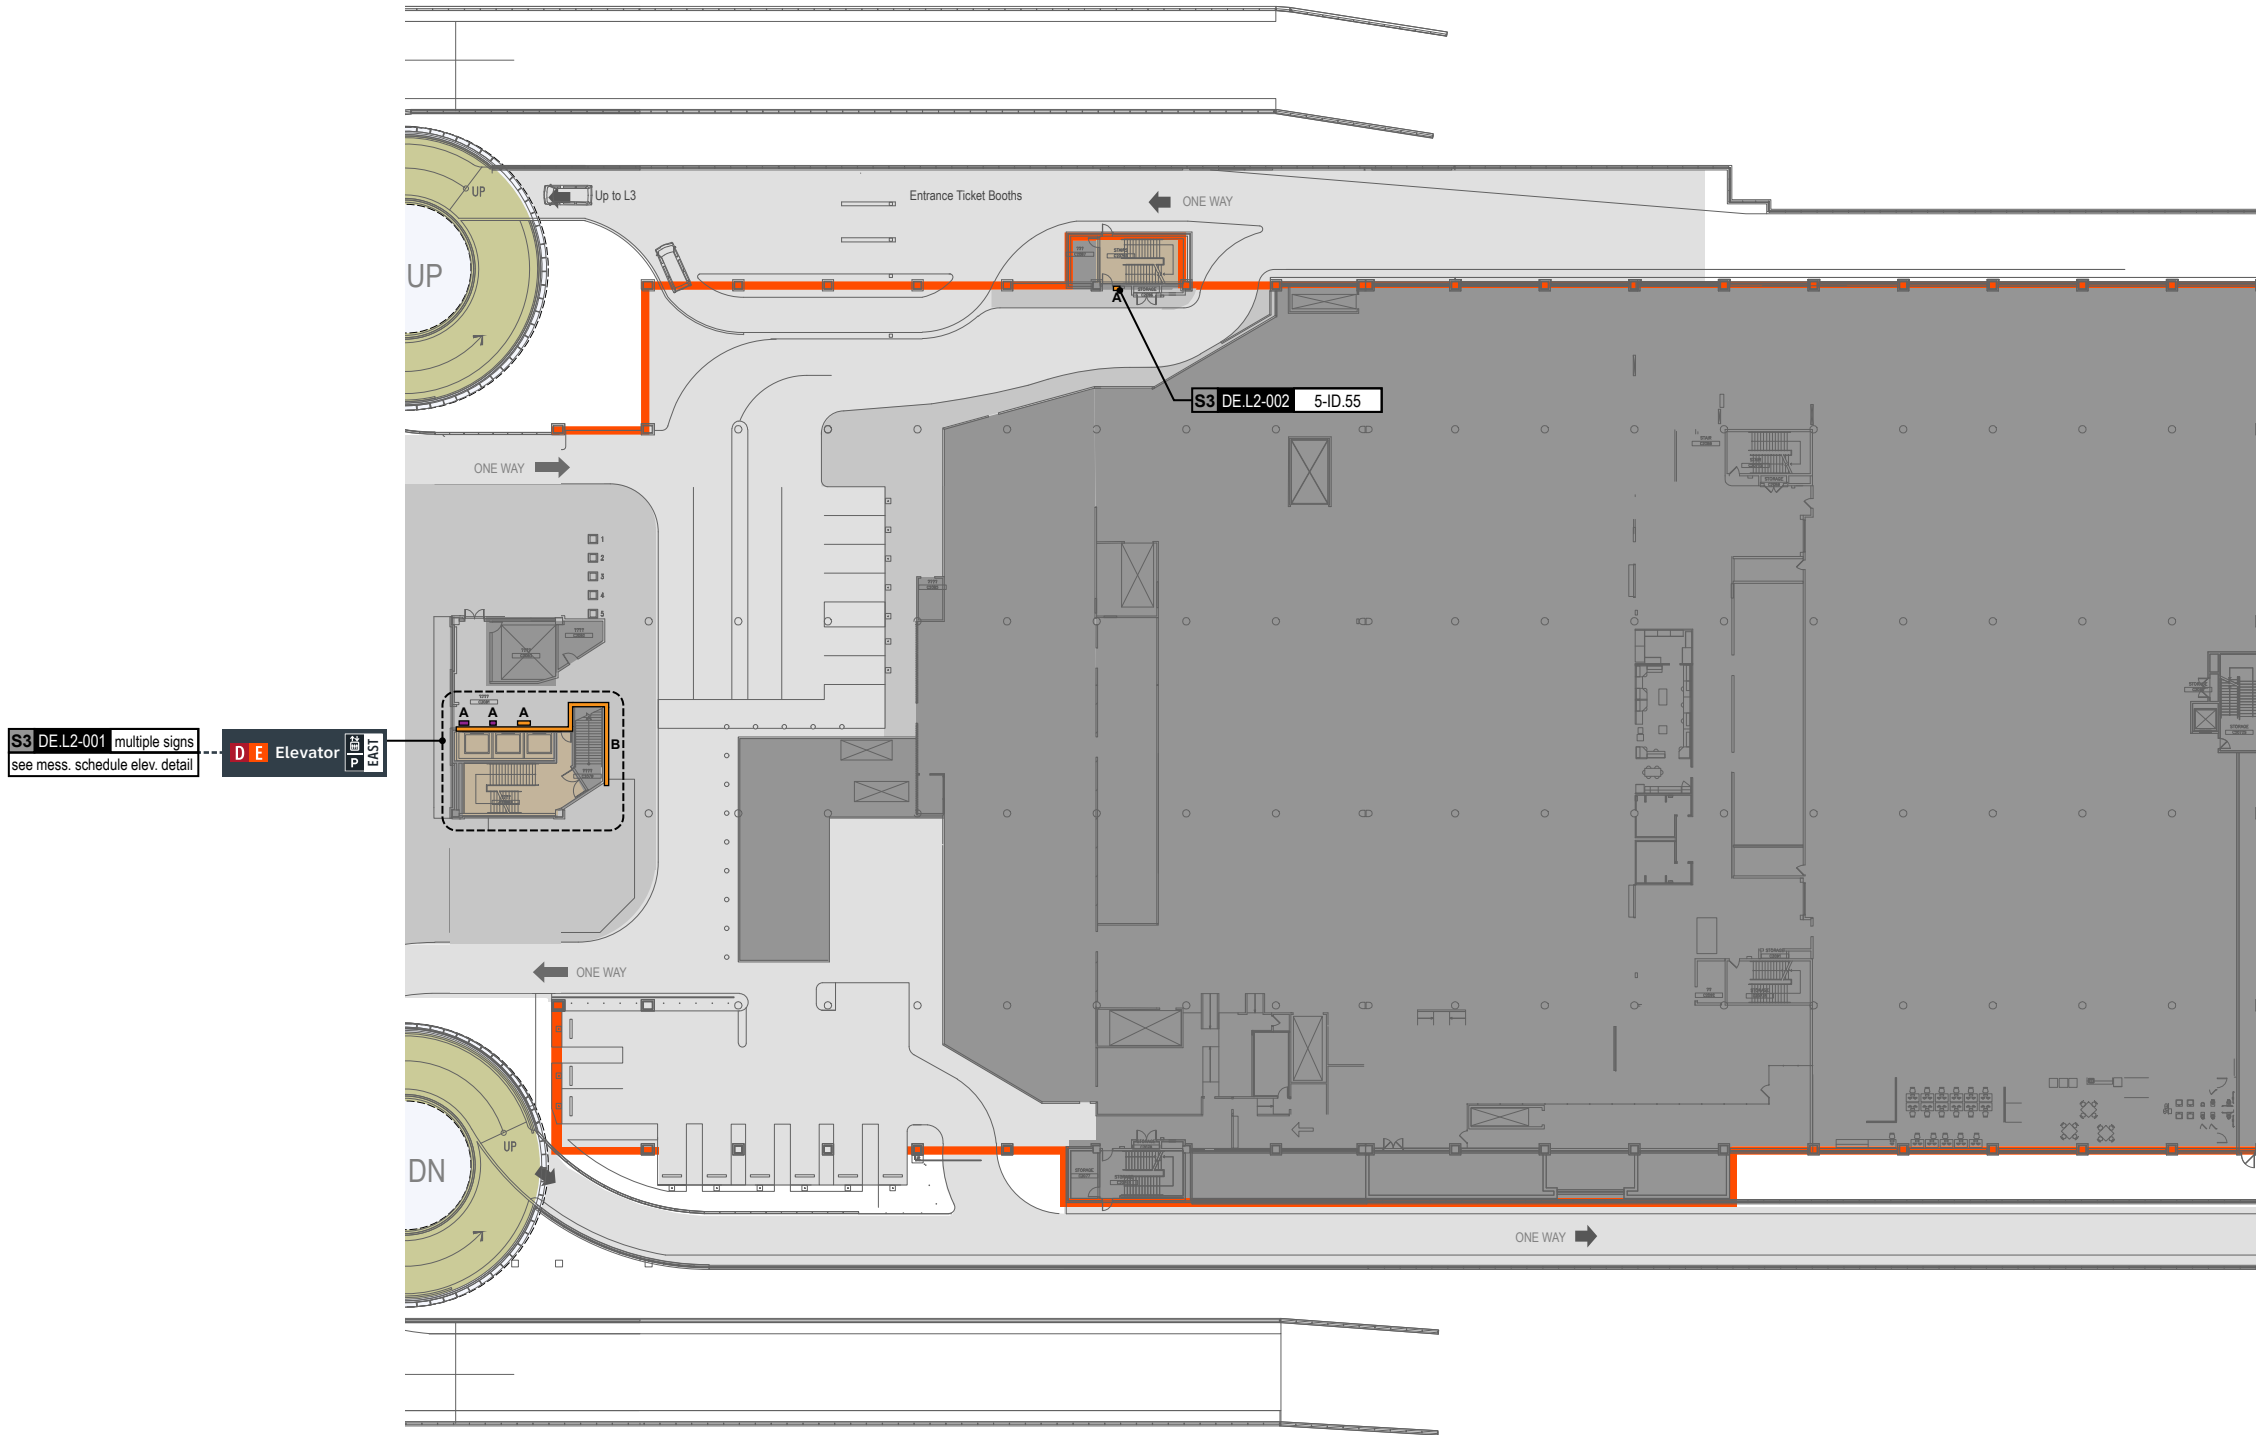
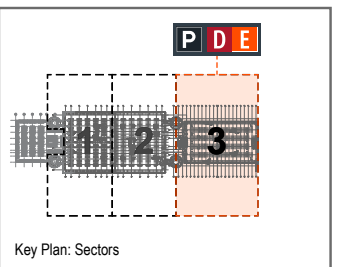
**WAYFINDING SIGN LOCATIONS - Parking:**

- |                          |                         |
|--------------------------|-------------------------|
| <b>PEDESTRIAN Signs:</b> | <b>VEHICULAR Signs:</b> |
| = Directional (DR)       | = Directional (DR)      |
| = Identification (ID)    | = Identification (ID)   |
| = Informational (IN)     | = Informational (IN)    |

**CIRCULATION:**

- = Public Use PEDESTRIAN Vertical Circulation (i.e. Elevators/Escalators/Stairs)
- = Public Use VEHICULAR Vertical Circulation (i.e. Ramps)
- = Alpha-Numeric Parking Section Naming Areas (Blues = C Garages; Oranges = D/E Garage)
- = Areas Not In Scope for this Package


LOCATION PLAN SCALE: 1" = 60'



Side A



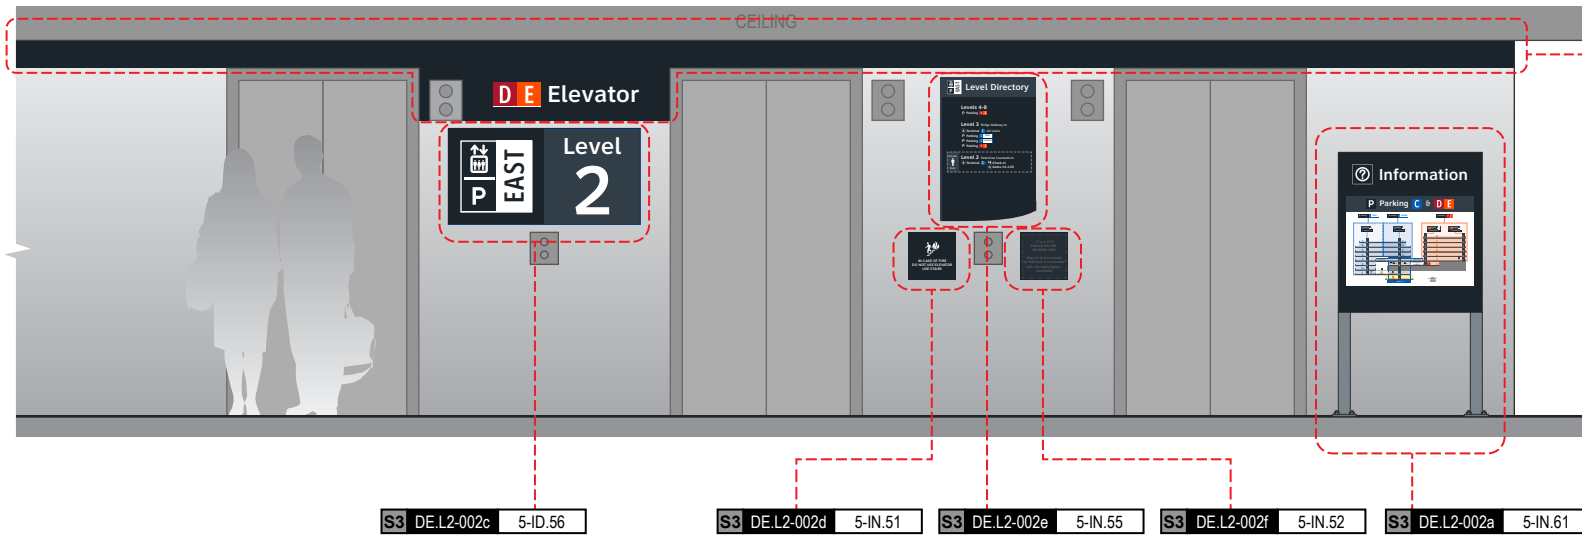Side A




NOTES: Wall paint and header graphics at front elevation only of elevator core included for this location number; wall elevation conditions shown are artistic representation based on rough site photo surveys; actual wall elevation conditions to be field verified by contractor/installer

NOTES: Level directory plaque includes a "You Are Here" graphic and is in a unique location per elevator core/level location; artwork included here is representative of final artwork design intent for this location

NOTES: Directory artwork includes a "You Are Here" button graphic and is in a unique location per elevator core/level location; artwork included here is representative of final map artwork design intent for this location

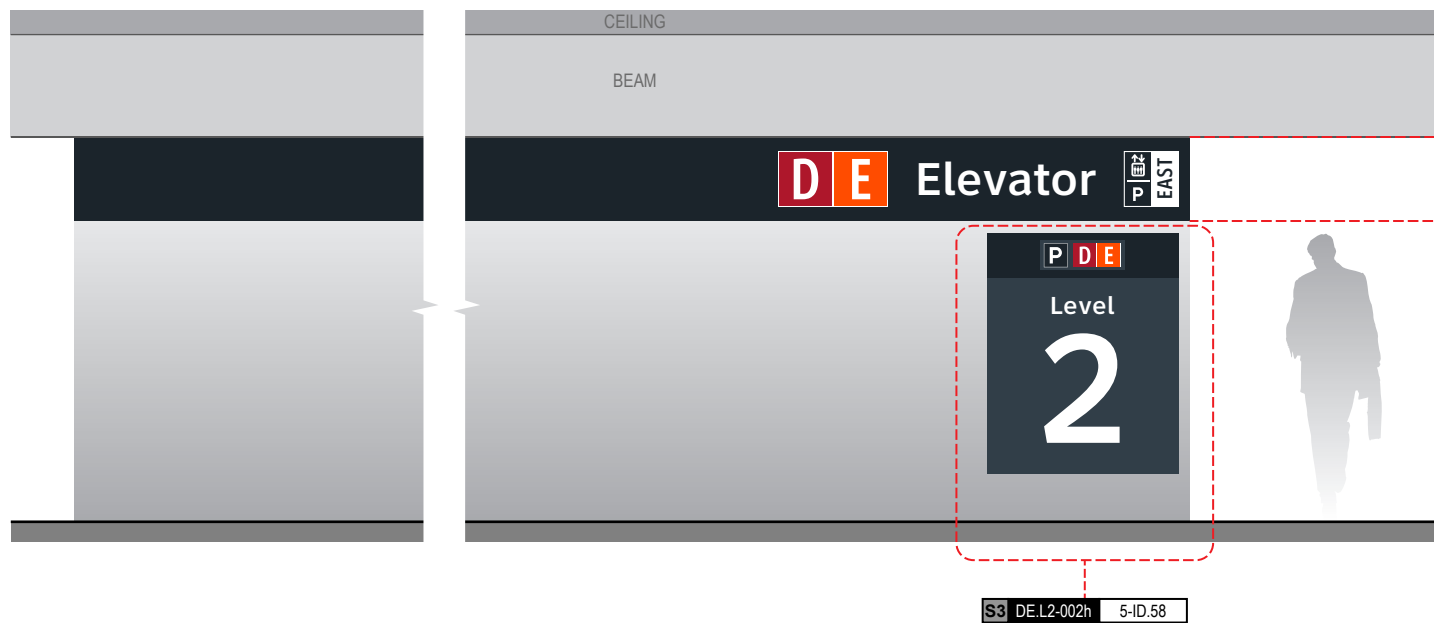Side B




NOTES: Wall paint and header graphics on garage-facing elevation of elevator core included for this location number; wall elevation conditions shown are artistic representation based on rough site photo surveys; actual wall elevation conditions to be field verified by contractor/installer

## END OF PARKING D/E: LEVEL 2 - SECTOR 3 MESSAGES
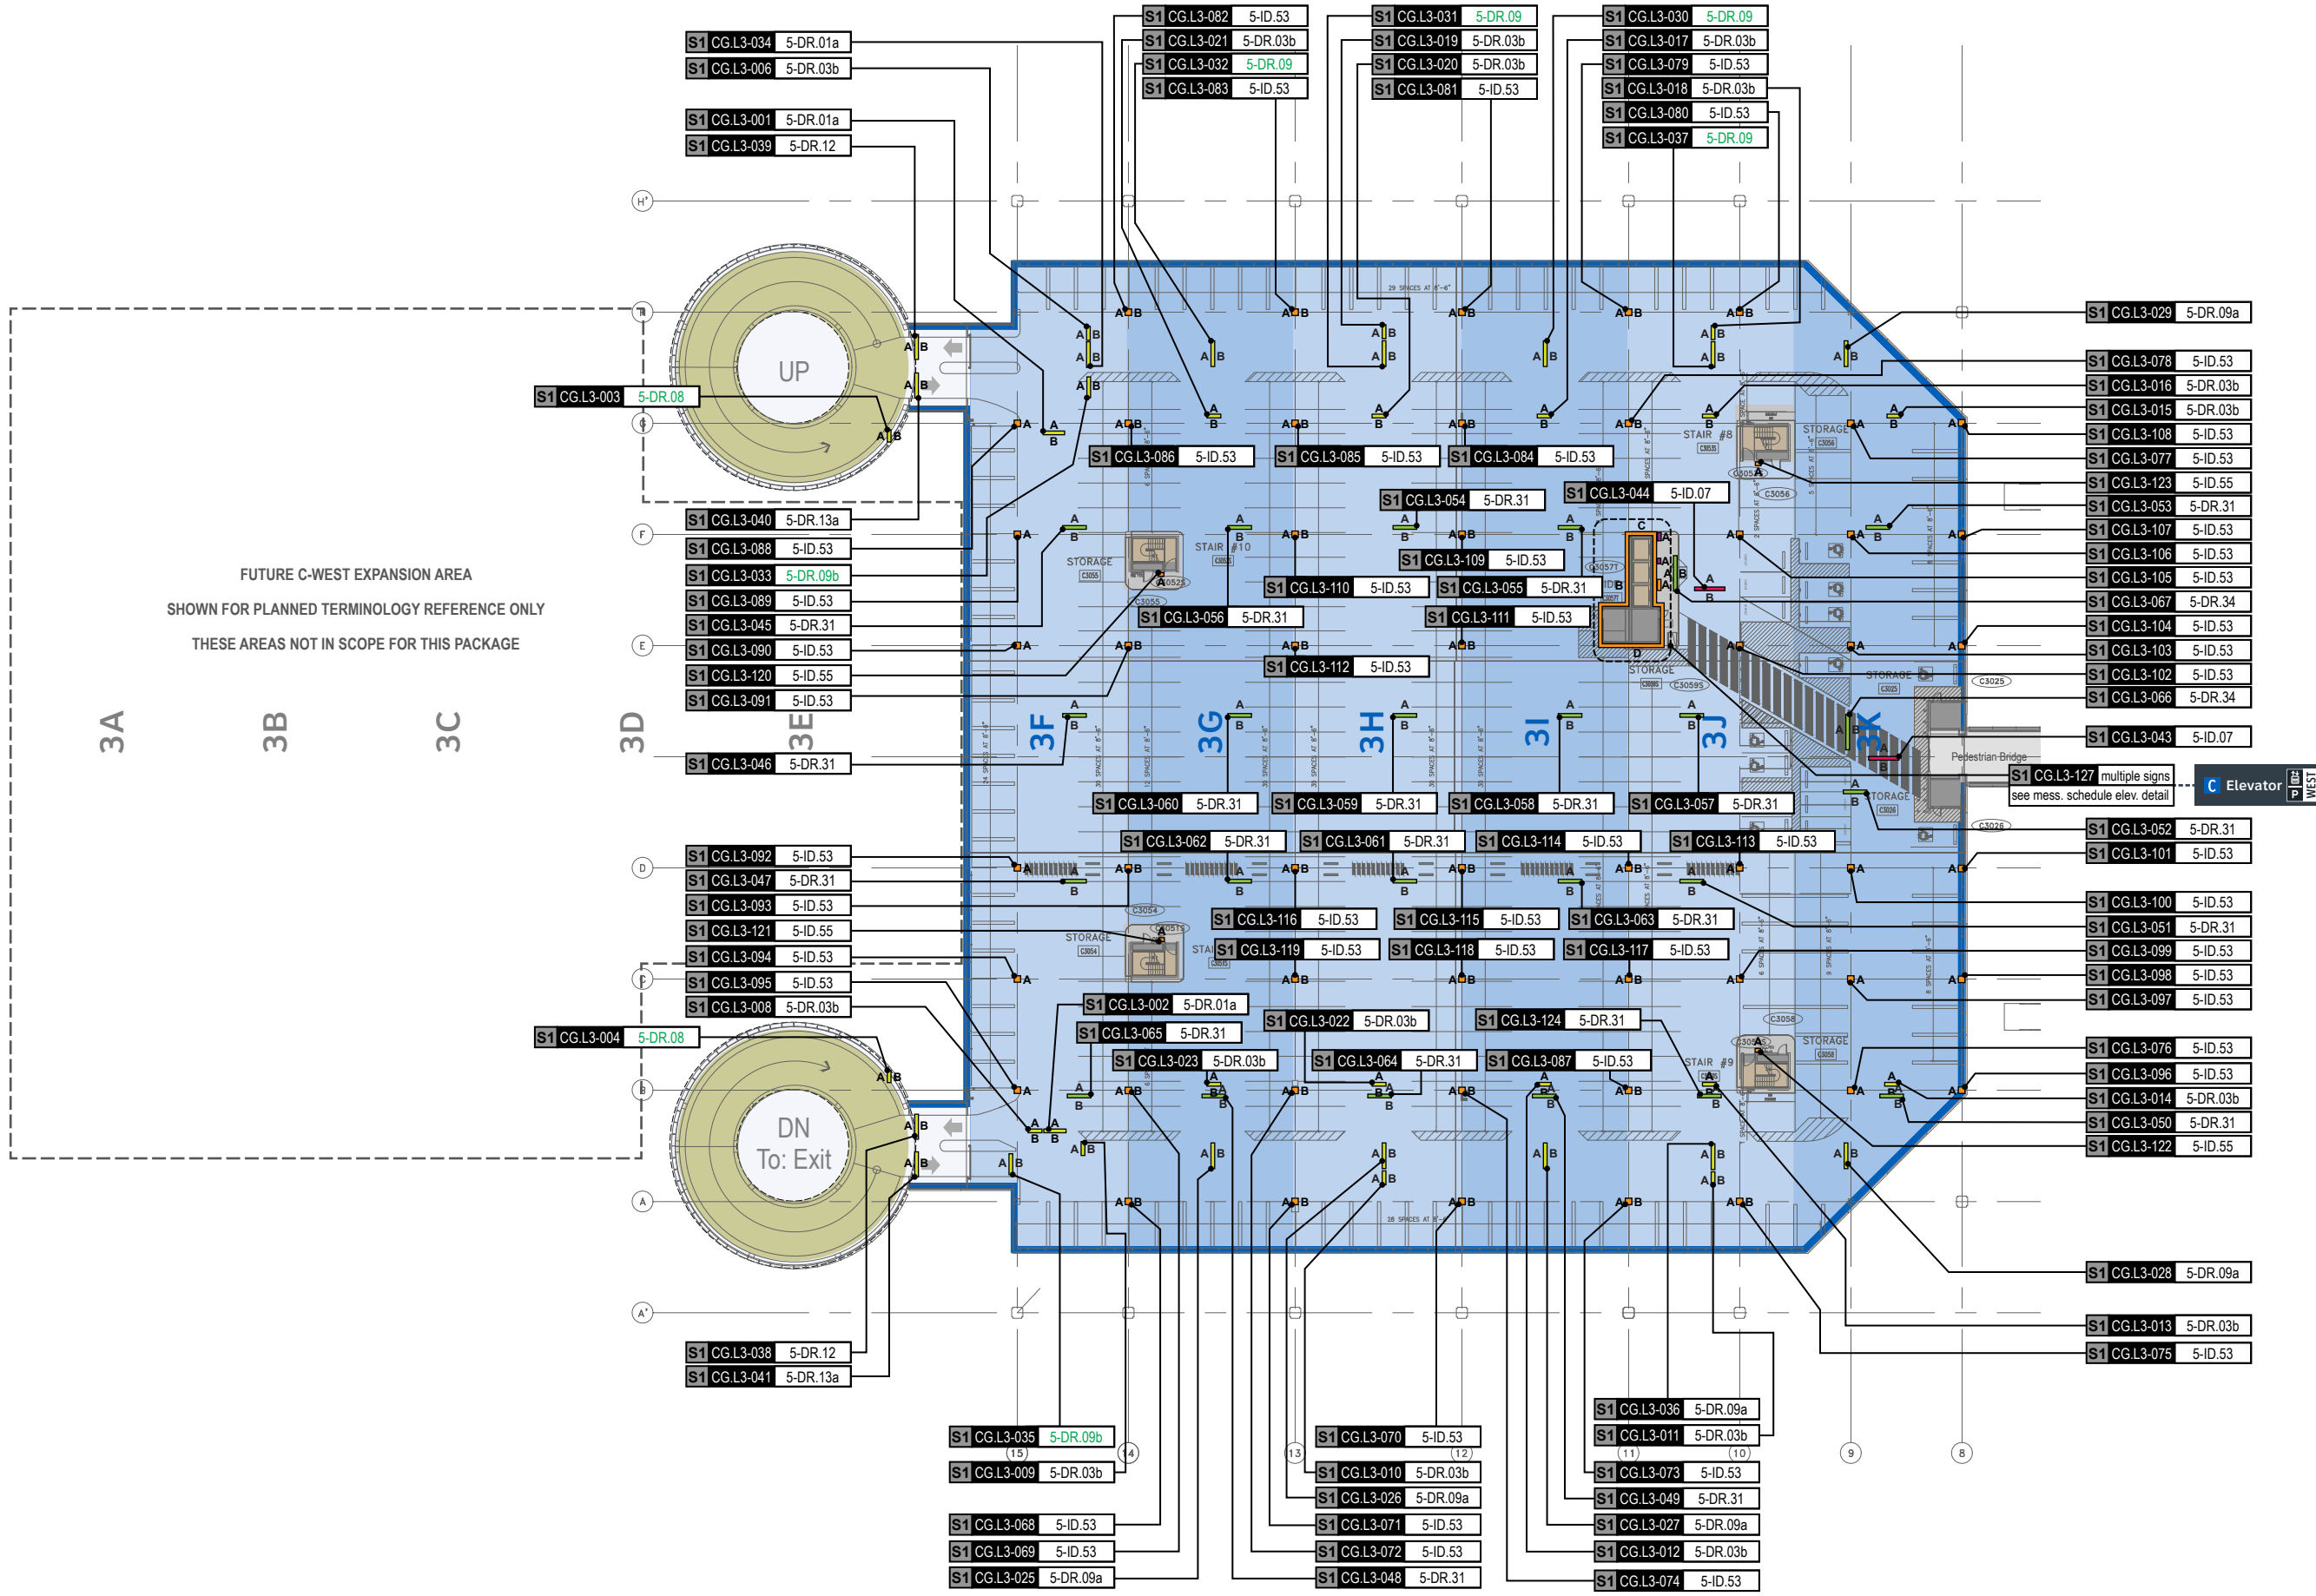
# 6.0

## **6.0 LOCATION PLANS & MESSAGE SCHEDULES: LEVEL 3**




FUTURE C-WEST EXPANSION AREA  
 SHOWN FOR PLANNED TERMINOLOGY REFERENCE ONLY  
 THESE AREAS NOT IN SCOPE FOR THIS PACKAGE

**GENERAL NOTES**

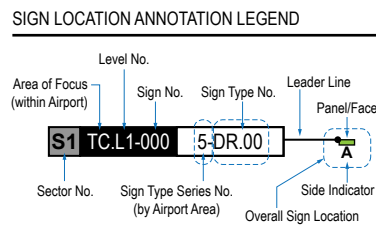- Sign locations & orientations shown here are approximations based on the most current plan drawings as provided to the designer by the architect at the time of this document's completion. These sign locations are for general design intent & wayfinding planning purposes only. They should not be construed or deemed as absolute or final locations. Field verification, marking & documentation of each final location is to be performed by the Fabricator/Installer, & coordinated with project staff & Wayfinding Design Consultants for final approval.
- All final install locations must be marked and verified in the field for proper structural integrity, adequate line of sight, utilities / property-line / other existing signage interferences & must be in complete compliance with all local, state and national codes prior to fabrication or installation.
- Adjustments to the sign locations shown in these drawings must be documented by the Fabricator/Installer, and provided to project staff & Wayfinding Design Consultants for final approval.

**NOTE:** Only priority wayfinding signage & locations as shown in this wayfinding plan package are in scope. All other signage not shown (including traffic control) are NOT IN SCOPE for this project/contract.



**LOCATION CODE DEFINITIONS:**

**AREA OF FOCUS:** (location within Airport)  
 TA = Terminal A  
 TB = Terminal B  
 TC = Terminal C  
 TD = Terminal D  
 TE = Terminal E  
 AB = AB Garage  
 CG = C Garage  
 DE = DE Garage

**SIGN TYPE SERIES NO.:** (by Airport Area)  
 1- = Terminals/Concourses  
 1t- = Terminals/Concourses: Temporary  
 2- = CBP Areas  
 3- = Curbside/Ground Trans.  
 4- = Roadways  
 5- = Parking

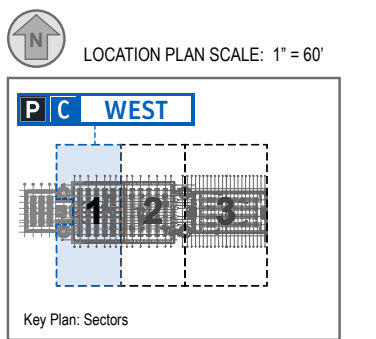
**WAYFINDING SIGN TYPE:**  
 DR.xx = Directional  
 ID.xx = Identification  
 IN.xx = Informational

**WAYFINDING SIGN LOCATIONS - Parking:**


**PEDESTRIAN Signs:**  
 A/B = Directional (DR)  
 A/B = Identification (ID)  
 A/B = Informational (IN)

**VEHICULAR Signs:**  
 A/B = Directional (DR)  
 A/B = Identification (ID)  
 A/B = Informational (IN)

**CIRCULATION:**  
 [Brown Box] = Public Use PEDESTRIAN Vertical Circulation (i.e. Elevators/Escalators/Stairs)  
 [Green Box] = Public Use VEHICULAR Vertical Circulation (i.e. Ramps)  
 [Blue Box] = Alpha-Numeric Parking Section Naming Areas (Blues = C Garages; Oranges = D/E Garage)  
 [Grey Box] = Areas Not In Scope for this Package




S1 CG.L3-001 5-DR.01a Notes: N/A

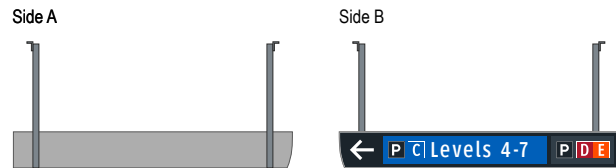


S1 CG.L3-005 N/A Notes: N/A

NOT USED

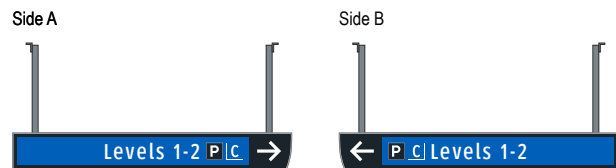
S1 CG.L3-002 5-DR.01a Notes: N/A



S1 CG.L3-006 5-DR.03b Notes: N/A

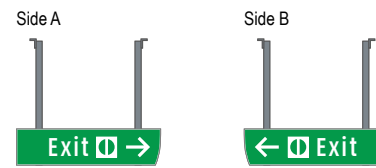

S1 CG.L3-003 5-DR.08 Notes: N/A

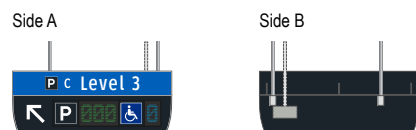


S1 CG.L3-007 N/A Notes: N/A

NOT USED

S1 CG.L3-004 5-DR.08 Notes: N/A




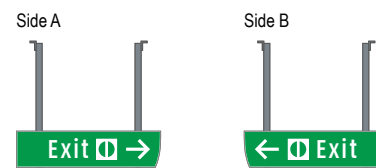S1 CG.L3-008 5-DR.03b Notes: N/A







S1 CG.L3-009 5-DR.03b Notes: N/A

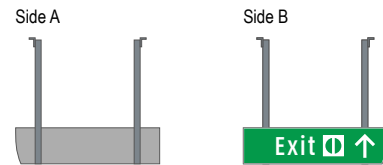


S1 CG.L3-013 5-DR.03b Notes: N/A

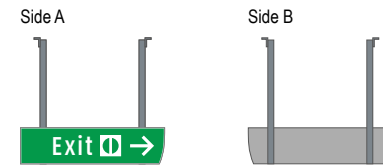


S1 CG.L3-010 5-DR.03b Notes: N/A

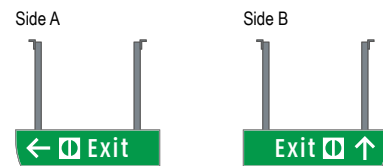


S1 CG.L3-014 5-DR.03b Notes: N/A

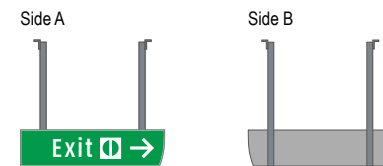


S1 CG.L3-011 5-DR.03b Notes: N/A

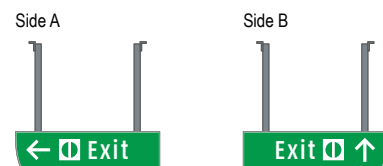


S1 CG.L3-015 5-DR.03b Notes: N/A

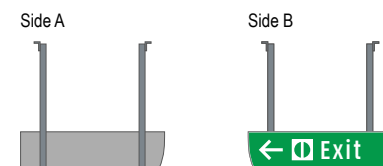

S1 CG.L3-012 5-DR.03b Notes: N/A

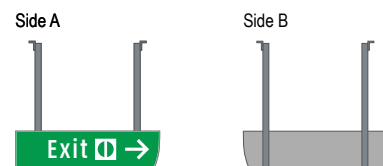

S1 CG.L3-016 5-DR.03b Notes: N/A

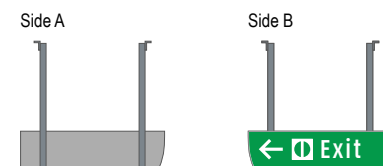

**Wayfinding Updates**

Issue Date: 08-23-2024

**Issue for Bid**

- REV. 
- REV. 
- REV. 

**WARNING:**

This record contains Sensitive Security Information that is controlled under 49 CFR parts 15 and 1520. No part of this record may be disclosed to persons with a "need to know," as defined in 49 CFR parts 15 and 1520, except with the written permission of the Administrator of the Transportation Security Administration or the Secretary of Transportation. Unauthorized release may result in civil penalty or other action. For U.S. government agencies, public disclosure is governed by 5 U.S.C. 552 and 49 CFR parts 15 and 1520.



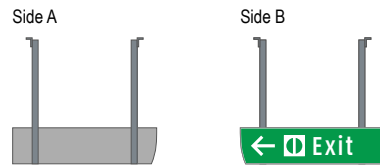
08-23-2024

THESE SHEETS ARE ISSUED FOR GRAPHICAL INFORMATION ONLY


**6.2 MESSAGE SCHEDULE - GARAGE C: LEVEL 3 - SECTOR 1 (C WEST)**

BSG PRJCT# BSG-2024-111-IAH  
 HAS TIP # 24 -103 - IAH


S1 CG.L3-017 5-DR.03b Notes: N/A




S1 CG.L3-021 5-DR.03b Notes: N/A

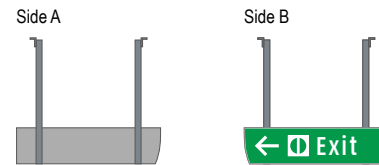


S1 CG.L3-018 5-DR.03b Notes: N/A

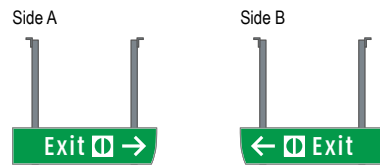


S1 CG.L3-022 5-DR.03b Notes: N/A

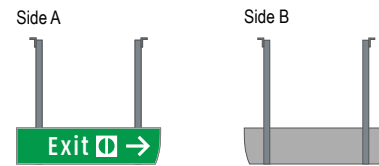


S1 CG.L3-019 5-DR.03b Notes: N/A

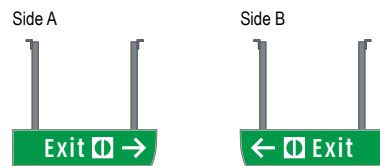

S1 CG.L3-023 5-DR.03b Notes: N/A

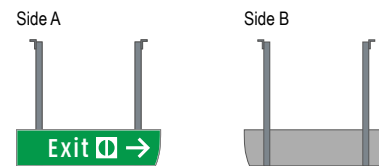

S1 CG.L3-020 5-DR.03b Notes: N/A

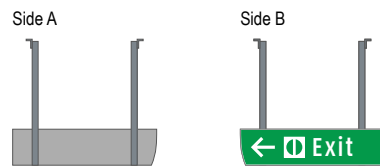

S1 CG.L3-024 N/A Notes: N/A

NOT USED

**Wayfinding Updates**

Issue Date: 08-23-2024

**Issue for Bid**

- REV. 
- REV. 
- REV. 

**WARNING:**

This record contains Sensitive Security Information that is controlled under 49 CFR parts 15 and 1520. No part of this record may be disclosed to persons with a "need to know," as defined in 49 CFR parts 15 and 1520, except with the written permission of the Administrator of the Transportation Security Administration or the Secretary of Transportation. Unauthorized release may result in civil penalty or other action. For U.S. government agencies, public disclosure is governed by 5 U.S.C. 552 and 49 CFR parts 15 and 1520.



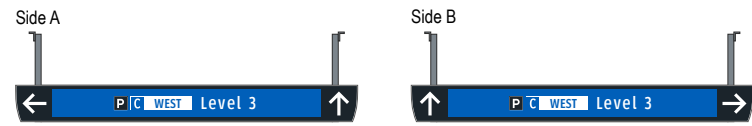
08-23-2024

THESE SHEETS ARE ISSUED FOR GRAPHICAL INFORMATION ONLY


**6.2 MESSAGE SCHEDULE - GARAGE C: LEVEL 3 - SECTOR 1 (C WEST)**

BSG PRJCT# BSG-2024-111-IAH  
 HAS TIP # 24 -103 - IAH


S1 CG.L3-025 5-DR.09a Notes: N/A




S1 CG.L3-029 5-DR.09a Notes: N/A

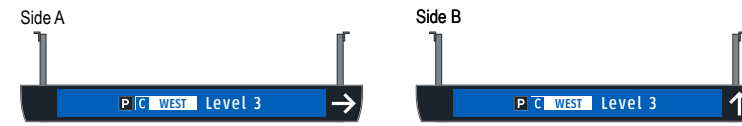


S1 CG.L3-026 5-DR.09a Notes: N/A

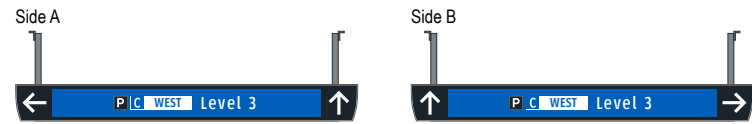


S1 CG.L3-030 5-DR.09 Notes: N/A

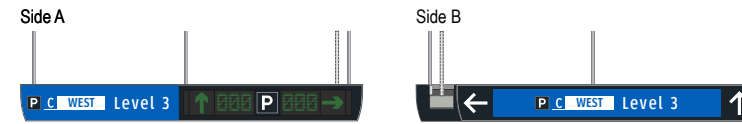


S1 CG.L3-027 5-DR.09a Notes: N/A

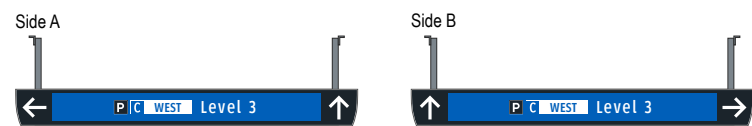


S1 CG.L3-031 5-DR.09 Notes: N/A

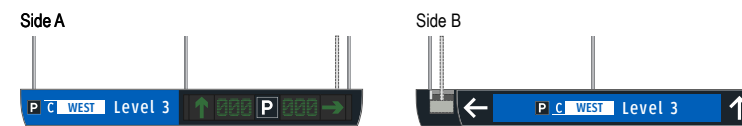

S1 CG.L3-028 5-DR.09a Notes: N/A

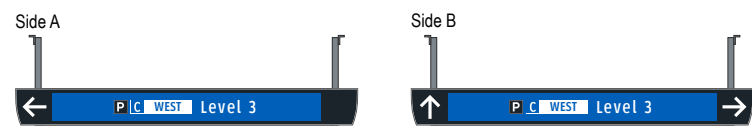

S1 CG.L3-032 5-DR.09 Notes: N/A

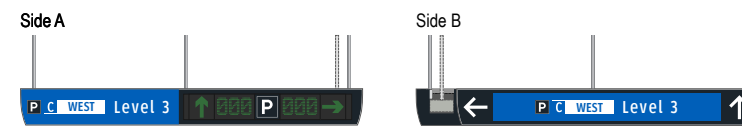

**Wayfinding Updates**

Issue Date: 08-23-2024

Issue for Bid

- REV. 
- REV. 
- REV. 

**WARNING:**

This record contains Sensitive Security Information that is controlled under 49 CFR parts 15 and 1520. No part of this record may be disclosed to persons with a "need to know," as defined in 49 CFR parts 15 and 1520, except with the written permission of the Administrator of the Transportation Security Administration or the Secretary of Transportation. Unauthorized release may result in civil penalty or other action. For U.S. government agencies, public disclosure is governed by 5 U.S.C. 552 and 49 CFR parts 15 and 1520.



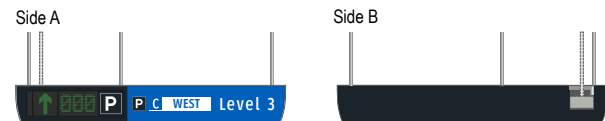
08-23-2024

THESE SHEETS ARE ISSUED FOR GRAPHICAL INFORMATION ONLY


**6.2 MESSAGE SCHEDULE - GARAGE C: LEVEL 3 - SECTOR 1 (C WEST)**

BSG PRJCT# BSG-2024-111-IAH  
 HAS TIP # 24 -103 - IAH


S1 CG.L3-033 5-DR.09b Notes: N/A




S1 CG.L3-037 5-DR.09 Notes: N/A

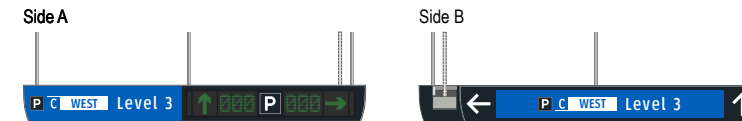


S1 CG.L3-034 5-DR.01a Notes: N/A

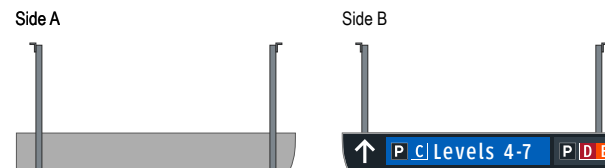


S1 CG.L3-038 5-DR.12 Notes: N/A

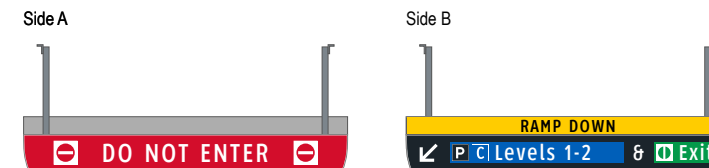


S1 CG.L3-035 5-DR.09b Notes: N/A

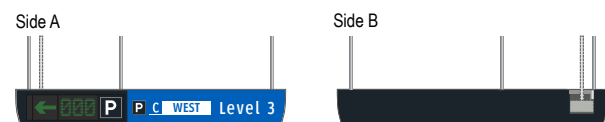


S1 CG.L3-039 5-DR.12 Notes: N/A

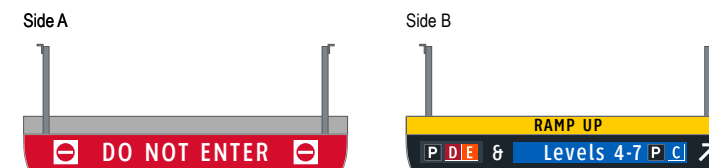


S1 CG.L3-036 5-DR.09a Notes: N/A

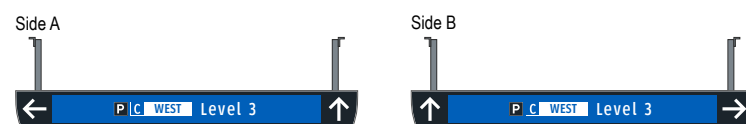


S1 CG.L3-040 5-DR.13a Notes: N/A

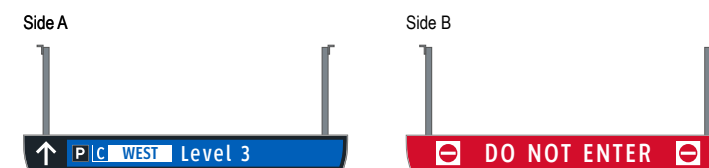

S1 CG.L3-041 5-DR.13a Notes: N/A

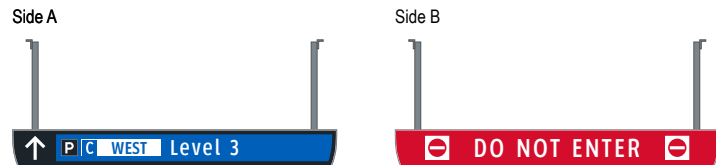


S1 CG.L3-045 5-DR.31 Notes: N/A

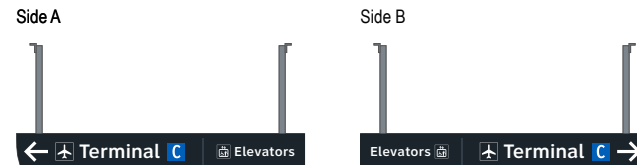


S1 CG.L3-042 N/A Notes: N/A

NOT USED

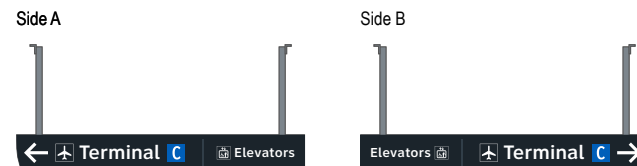
S1 CG.L3-046 5-DR.31 Notes: N/A




S1 CG.L3-043 5-ID.07 Notes: N/A

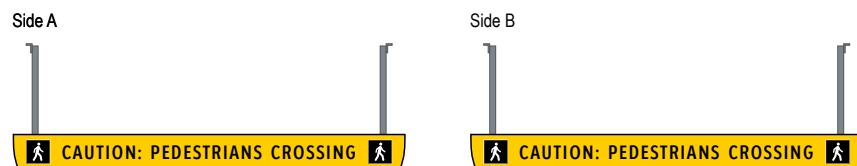


S1 CG.L3-047 5-DR.31 Notes: N/A

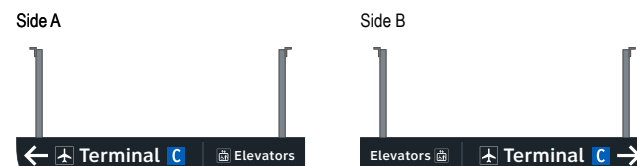


S1 CG.L3-044 5-ID.07 Notes: N/A

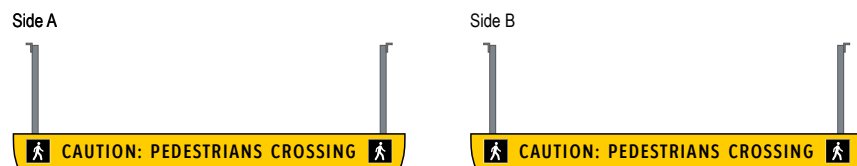


S1 CG.L3-048 5-DR.31 Notes: N/A

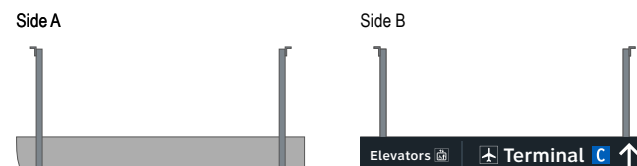


S1 CG.L3-049 5-DR.31 Notes: N/A

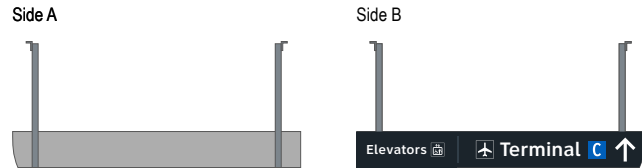


S1 CG.L3-053 5-DR.31 Notes: N/A

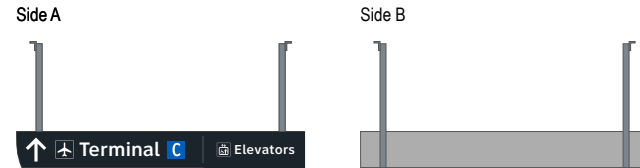


S1 CG.L3-050 5-DR.31 Notes: N/A

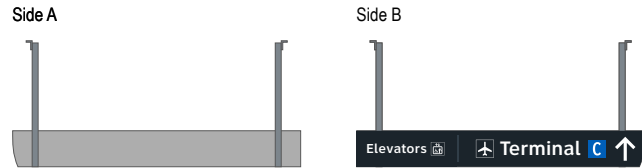


S1 CG.L3-054 5-DR.31 Notes: N/A

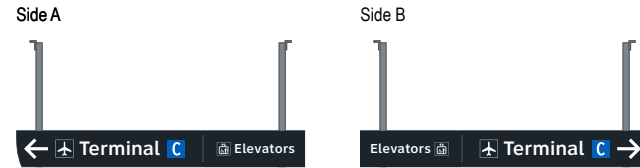


S1 CG.L3-051 5-DR.31 Notes: Notes: N/A

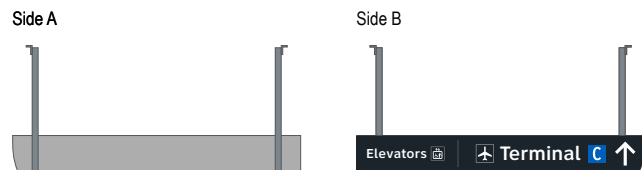


S1 CG.L3-055 5-DR.31 Notes: N/A

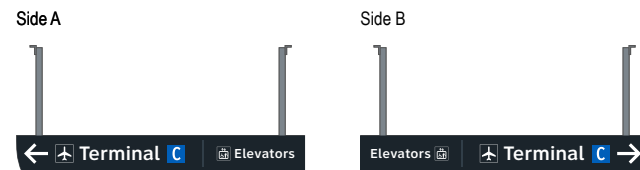

S1 CG.L3-052 5-DR.31 Notes: N/A

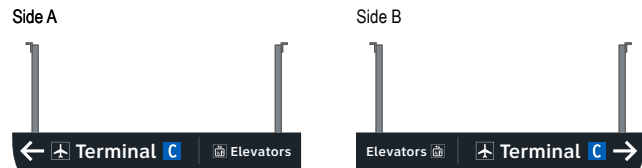

S1 CG.L3-056 5-DR.31 Notes: N/A

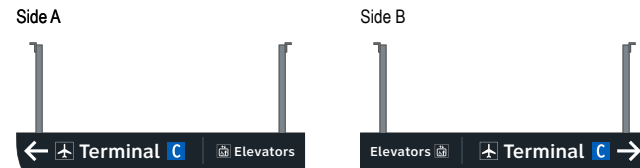

**Wayfinding Updates**

Issue Date: 08-23-2024  
Issue for Bid

- REV. 
- REV. 
- REV. 

**WARNING:**

This record contains Sensitive Security Information that is controlled under 49 CFR parts 15 and 1520. No part of this record may be disclosed to persons with a "need to know," as defined in 49 CFR parts 15 and 1520, except with the written permission of the Administrator of the Transportation Security Administration or the Secretary of Transportation. Unauthorized release may result in civil penalty or other action. For U.S. government agencies, public disclosure is governed by 5 U.S.C. 552 and 49 CFR parts 15 and 1520.

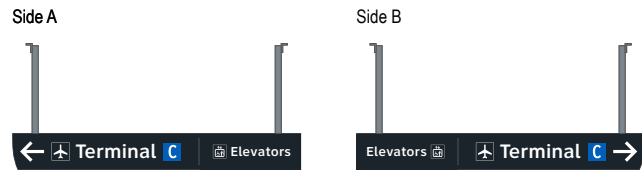


THESE SHEETS ARE ISSUED FOR GRAPHICAL INFORMATION ONLY


**6.2 MESSAGE SCHEDULE - GARAGE C: LEVEL 3 - SECTOR 1 (C WEST)**

BSG PRJCT# BSG-2024-111-IAH  
HAS TIP # 24 -103 - IAH


S1 CG.L3-057 5-DR.31 Notes: N/A




S1 CG.L3-061 5-DR.31 Notes: N/A

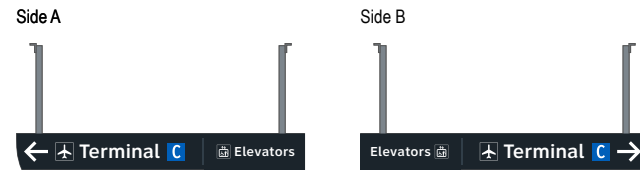


S1 CG.L3-058 5-DR.31 Notes: N/A

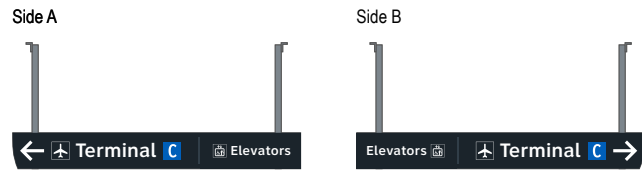


S1 CG.L3-062 5-DR.31 Notes: N/A

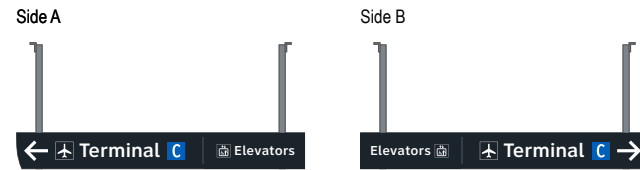


S1 CG.L3-059 5-DR.31 Notes: N/A

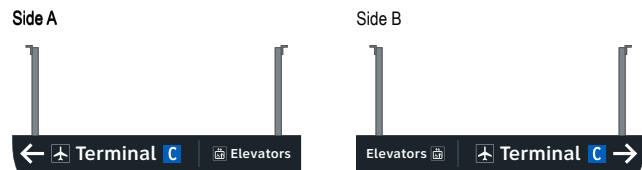


S1 CG.L3-063 5-DR.31 Notes: N/A

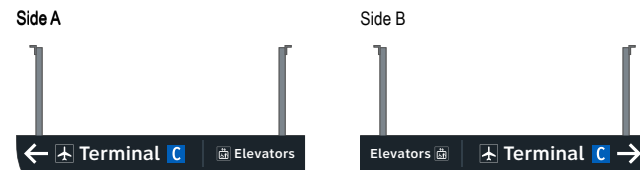

S1 CG.L3-060 5-DR.31 Notes: N/A

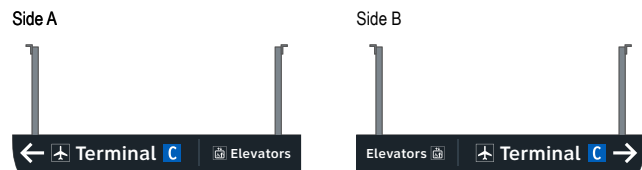

S1 CG.L3-064 5-DR.31 Notes: N/A

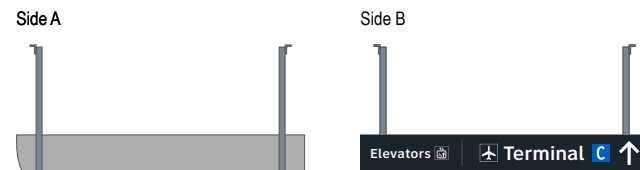

Wayfinding Updates

Issue Date: 08-23-2024

Issue for Bid

- REV. ⚠
- REV. ⚠
- REV. ⚠

WARNING:

This record contains Sensitive Security Information that is controlled under 49 CFR parts 15 and 1520. No part of this record may be disclosed to persons with a "need to know," as defined in 49 CFR parts 15 and 1520, except with the written permission of the Administrator of the Transportation Security Administration or the Secretary of Transportation. Unauthorized release may result in civil penalty or other action. For U.S. government agencies, public disclosure is governed by 5 U.S.C. 552 and 49 CFR parts 15 and 1520.

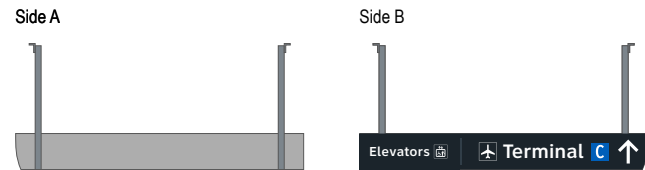


THESE SHEETS ARE ISSUED FOR GRAPHICAL INFORMATION ONLY


6.2 MESSAGE SCHEDULE - GARAGE C: LEVEL 3 - SECTOR 1 (C WEST)

BSG PRJCT# BSG-2024-111-IAH  
 HAS TIP # 24 -103 - IAH


S1 CG.L3-065 5-DR.31 Notes: N/A




S1 CG.L3-069 5-ID.53 Notes: N/A

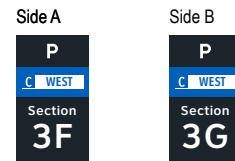


S1 CG.L3-066 5-DR.34 Notes: N/A

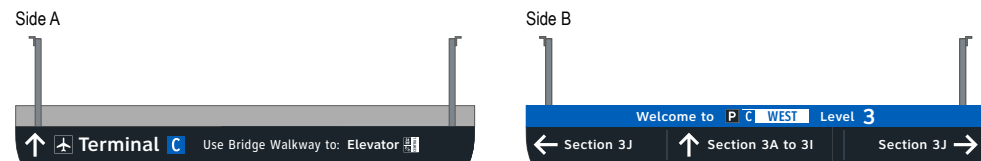


S1 CG.L3-070 5-ID.53 Notes: N/A

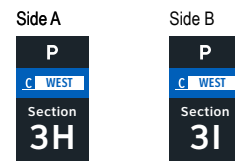


S1 CG.L3-067 5-DR.34 Notes: N/A

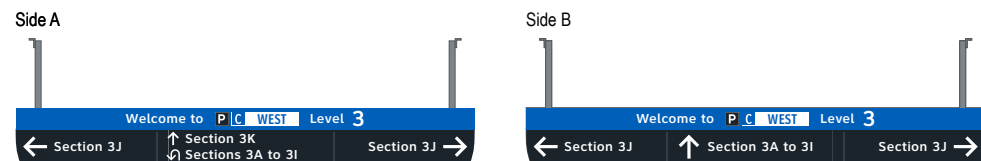


S1 CG.L3-071 5-ID.53 Notes: N/A

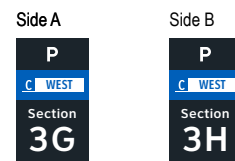

S1 CG.L3-068 5-ID.53 Notes: N/A

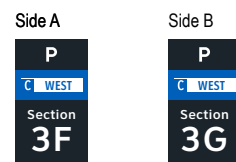

S1 CG.L3-072 5-ID.53 Notes: N/A

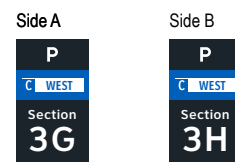



S1 CG.L3-073 5-ID.53 Notes: N/A

Side A	Side B
<b>P</b>	<b>P</b>
<b>C WEST</b>	<b>C WEST</b>
Section	Section
<b>3I</b>	<b>3J</b>

S1 CG.L3-077 5-ID.53 Notes: N/A

Side A
<b>P</b>
<b>C WEST</b>
Section
<b>3K</b>

S1 CG.L3-074 5-ID.53 Notes: N/A

Side A	Side B
<b>P</b>	<b>P</b>
<b>C WEST</b>	<b>C WEST</b>
Section	Section
<b>3H</b>	<b>3I</b>

S1 CG.L3-078 5-ID.53 Notes: N/A

Side A	Side B
<b>P</b>	<b>P</b>
<b>C WEST</b>	<b>C WEST</b>
Section	Section
<b>3I</b>	<b>3J</b>

S1 CG.L3-075 5-ID.53 Notes: N/A

Side A	Side B
<b>P</b>	<b>P</b>
<b>C WEST</b>	<b>C WEST</b>
Section	Section
<b>3J</b>	<b>3K</b>

S1 CG.L3-079 5-ID.53 Notes: N/A

Side A	Side B
<b>P</b>	<b>P</b>
<b>C WEST</b>	<b>C WEST</b>
Section	Section
<b>3I</b>	<b>3J</b>


S1 CG.L3-076 5-ID.53 Notes: N/A

Side A
<b>P</b>
<b>C WEST</b>
Section
<b>3K</b>


S1 CG.L3-080 5-ID.53 Notes: N/A

Side A	Side B
<b>P</b>	<b>P</b>
<b>C WEST</b>	<b>C WEST</b>
Section	Section
<b>3J</b>	<b>3K</b>

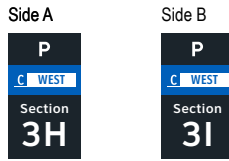
S1 CG.L3-081 5-ID.53 Notes: N/A




S1 CG.L3-085 5-ID.53 Notes: N/A

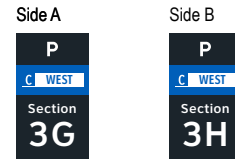


S1 CG.L3-082 5-ID.53 Notes: N/A

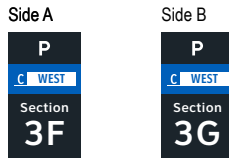


S1 CG.L3-086 5-ID.53 Notes: N/A

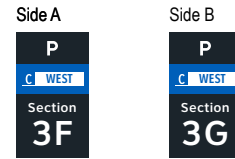


S1 CG.L3-083 5-ID.53 Notes: N/A

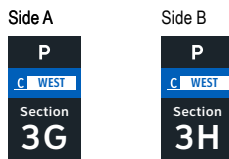


S1 CG.L3-087 5-ID.53 Notes: N/A

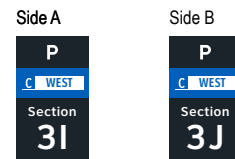

S1 CG.L3-084 5-ID.53 Notes: N/A

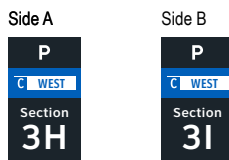


S1 CG.L3-088 5-ID.53 Notes: N/A

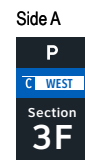


S1 CG.L3-089 5-ID.53 Notes: N/A

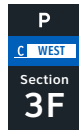Side A




S1 CG.L3-093 5-ID.53 Notes: N/A

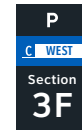Side A




Side B

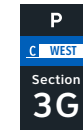


S1 CG.L3-090 5-ID.53 Notes: N/A

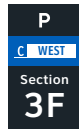Side A




S1 CG.L3-094 5-ID.53 Notes: N/A

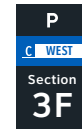Side A




S1 CG.L3-091 5-ID.53 Notes: N/A

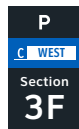Side A




Side B

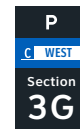


S1 CG.L3-095 5-ID.53 Notes: N/A

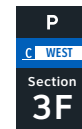Side A




S1 CG.L3-092 5-ID.53 Notes: N/A

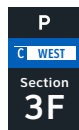Side A



S1 CG.L3-096 5-ID.53 Notes: N/A

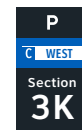Side A



GEORGE BUSH INTERCONTINENTAL AIRPORT  
Wayfinding Signage Design Intent Documents  
C Garage



Louisville, Colorado  
P: 303.494.7849  
www.labozan.com

These documents are intended to illustrate design intent, and should only be used as a general guideline. No information contained here should be construed as engineered elements. The fabricator/contractor shall be responsible for all engineering and specifications with regard to structural, electrical, mechanical, foundation and installation. Information and illustrations contained here are part of an original unpublished design by Labozan Associates, Inc. Detailing and information contained on these pages shall not be reproduced, copied or utilized in any way except for the specific project for which they were created without previous written authorization from Labozan Associates, Inc.  
© 2024 by Labozan Associates, Inc.

Wayfinding Updates

Issue Date: 08-23-2024  
Issue for Bid

- REV.
- REV.
- REV.

WARNING:

This record contains Sensitive Security Information that is controlled under 49 CFR parts 15 and 1520. No part of this record may be disclosed to persons with a "need to know," as defined in 49 CFR parts 15 and 1520, except with the written permission of the Administrator of the Transportation Security Administration or the Secretary of Transportation. Unauthorized release may result in civil penalty or other action. For U.S. government agencies, public disclosure is governed by 5 U.S.C. 552 and 49 CFR parts 15 and 1520.



08-23-2024

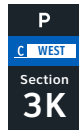
THESE SHEETS ARE ISSUED FOR GRAPHICAL INFORMATION ONLY

6.2 MESSAGE SCHEDULE - GARAGE C: LEVEL 3 - SECTOR 1 (C WEST)

BSG PRJCT# BSG-2024-111-IAH  
HAS TIP # 24 -103 - IAH


S1 CG.L3-097 5-ID.53 Notes: N/A

Side A




S1 CG.L3-101 5-ID.53 Notes: N/A

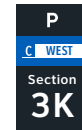Side A




S1 CG.L3-098 5-ID.53 Notes: N/A

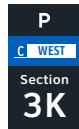Side A




S1 CG.L3-102 5-ID.53 Notes: N/A

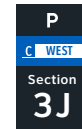Side A




S1 CG.L3-099 5-ID.53 Notes: N/A

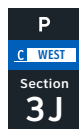Side A




S1 CG.L3-103 5-ID.53 Notes: N/A

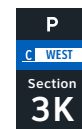Side A




S1 CG.L3-100 5-ID.53 Notes: N/A

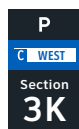Side A



S1 CG.L3-104 5-ID.53 Notes: N/A

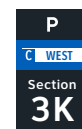Side A



GEORGE BUSH INTERCONTINENTAL AIRPORT  
Wayfinding Signage Design Intent Documents  
C Garage



Louisville, Colorado  
P: 303.494.7849  
www.labozan.com

These documents are intended to illustrate design intent, and should only be used as a general guideline. No information contained here should be construed as engineered elements. The fabricator/contractor shall be responsible for all engineering and specifications with regard to structural, electrical, mechanical, foundation and installation. Information and illustrations contained here are part of an original unpublished design by Labozan Associates, Inc. Detailing and information contained on these pages shall not be reproduced, copied or utilized in any way except for the specific project for which they were created without previous written authorization from Labozan Associates, Inc.  
© 2024 by Labozan Associates, Inc.

Wayfinding Updates

Issue Date: 08-23-2024  
Issue for Bid

- REV.
- REV.
- REV.

WARNING:

This record contains Sensitive Security Information that is controlled under 49 CFR parts 15 and 1520. No part of this record may be disclosed to persons with a "need to know," as defined in 49 CFR parts 15 and 1520, except with the written permission of the Administrator of the Transportation Security Administration or the Secretary of Transportation. Unauthorized release may result in civil penalty or other action. For U.S. government agencies, public disclosure is governed by 5 U.S.C. 552 and 49 CFR parts 15 and 1520.



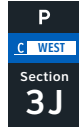
08-23-2024

THESE SHEETS ARE ISSUED FOR GRAPHICAL INFORMATION ONLY


6.2 MESSAGE SCHEDULE - GARAGE C: LEVEL 3 - SECTOR 1 (C WEST)

BSG PRJCT# BSG-2024-111-IAH  
HAS TIP # 24 -103 - IAH


Side A




Side A

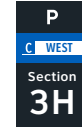

Side B

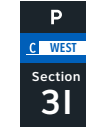


Side A

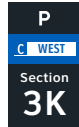


Side A



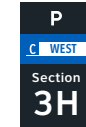
Side B



Side A

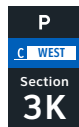


Side A

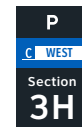


Side B



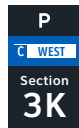
Side A



Side A

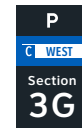

Side B

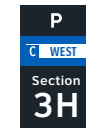

Wayfinding Updates

Issue Date: 08-23-2024  
Issue for Bid



WARNING:

This record contains Sensitive Security Information that is controlled under 49 CFR parts 15 and 1520. No part of this record may be disclosed to persons with a "need to know," as defined in 49 CFR parts 15 and 1520, except with the written permission of the Administrator of the Transportation Security Administration or the Secretary of Transportation. Unauthorized release may result in civil penalty or other action. For U.S. government agencies, public disclosure is governed by 5 U.S.C. 552 and 49 CFR parts 15 and 1520.



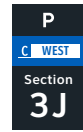
08-23-2024

THESE SHEETS ARE ISSUED FOR GRAPHICAL INFORMATION ONLY


6.2 MESSAGE SCHEDULE - GARAGE C: LEVEL 3 - SECTOR 1 (C WEST)

BSG PRJCT# BSG-2024-111-IAH  
HAS TIP # 24 -103 - IAH


Side A




Side A

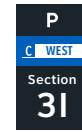

Side B

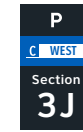


Side A

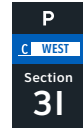


Side B



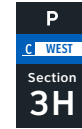
Side A




Side B

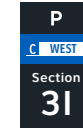


Side A

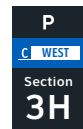


Side B

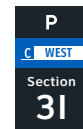


Side A

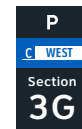


Side B

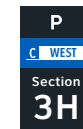

Side A

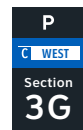

Side B

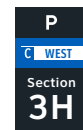

Side A



Wayfinding Updates

Issue Date: 08-23-2024

Issue for Bid

- REV. A
REV. A
REV. A

WARNING:

This record contains Sensitive Security Information that is controlled under 49 CFR parts 15 and 1520. No part of this record may be disclosed to persons with a "need to know," as defined in 49 CFR parts 15 and 1520, except with the written permission of the Administrator of the Transportation Security Administration or the Secretary of Transportation. Unauthorized release may result in civil penalty or other action. For U.S. government agencies, public disclosure is governed by 5 U.S.C. 552 and 49 CFR parts 15 and 1520.



08-23-2024

THESE SHEETS ARE ISSUED FOR GRAPHICAL INFORMATION ONLY

6.2 MESSAGE SCHEDULE - GARAGE C: LEVEL 3 - SECTOR 1 (C WEST)

BSG PRJCT# BSG-2024-111-IAH
HAS TIP # 24 -103 - IAH

Side A



NOT USED

Side A



NOT USED

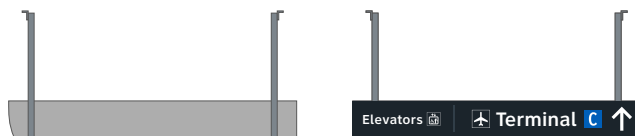
Side A



ELEVATOR CORE SIGNAGE CONTINUED ON NEXT SHEET

Side A

Side B



Wayfinding Updates

Issue Date: 08-23-2024

Issue for Bid

- REV. ⚠
- REV. ⚠
- REV. ⚠

WARNING:

This record contains Sensitive Security Information that is controlled under 49 CFR parts 15 and 1520. No part of this record may be disclosed to persons with a "need to know," as defined in 49 CFR parts 15 and 1520, except with the written permission of the Administrator of the Transportation Security Administration or the Secretary of Transportation. Unauthorized release may result in civil penalty or other action. For U.S. government agencies, public disclosure is governed by 5 U.S.C. 552 and 49 CFR parts 15 and 1520.



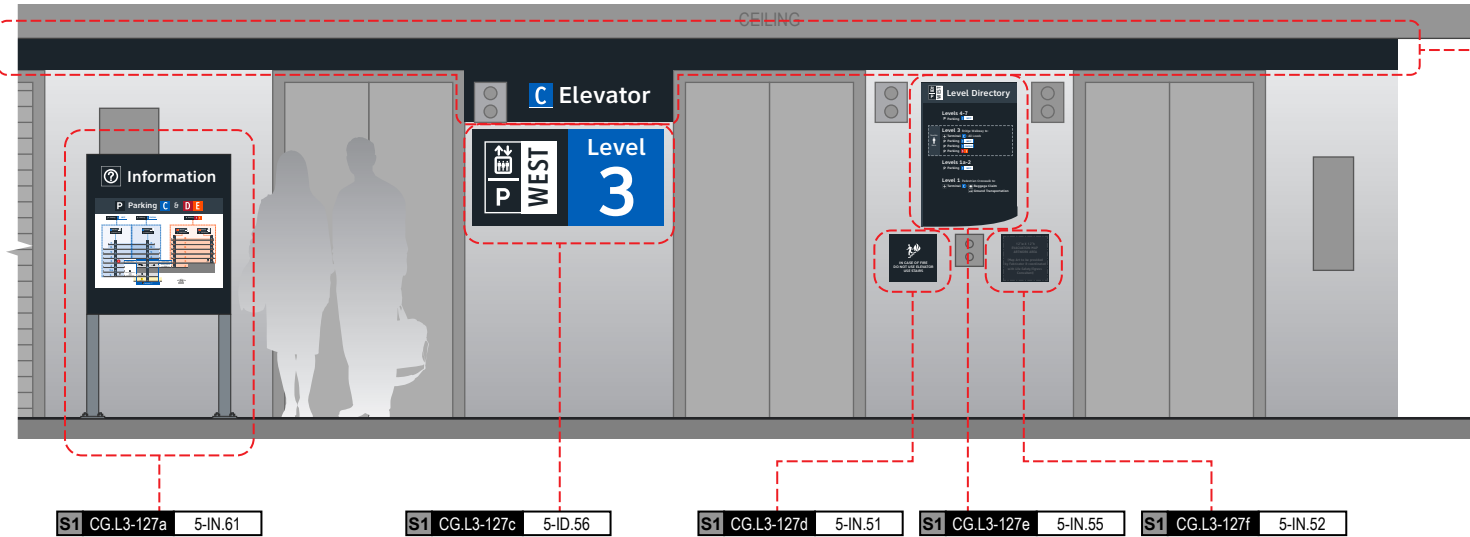
08-23-2024

THESE SHEETS ARE ISSUED FOR GRAPHICAL INFORMATION ONLY

6.2 MESSAGE SCHEDULE - GARAGE C: LEVEL 3 - SECTOR 1 (C WEST)

BSG PRJCT# BSG-2024-111-IAH  
HAS TIP # 24 -103 - IAH

Side A



NOTES: Directory artwork includes a "You Are Here" button graphic and is in a unique location per elevator core/level location; artwork included here is representative of final map artwork design intent for this location

NOTES: Level directory plaque includes a "You Are Here" graphic and is in a unique location per elevator core/level location; artwork included here is representative of final artwork design intent for this location

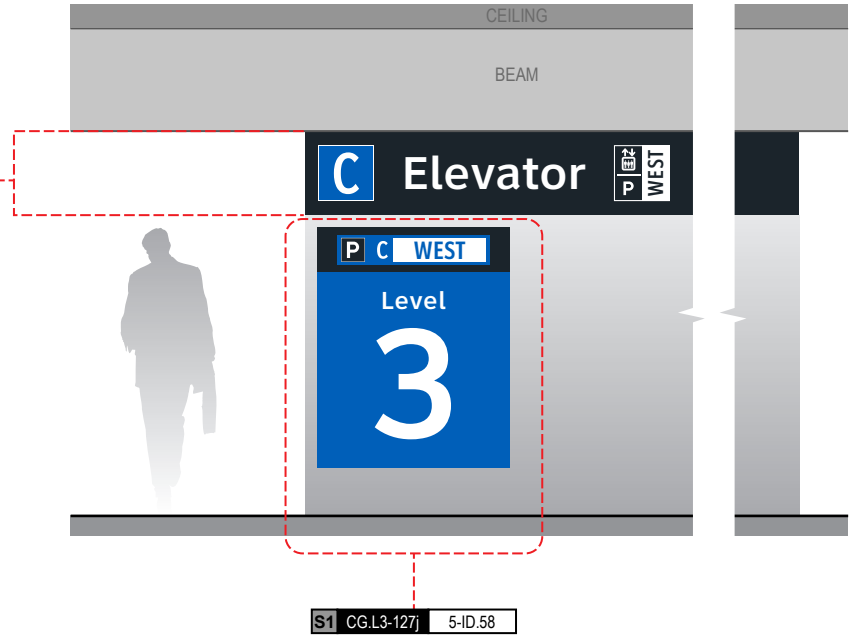
S1 CG.L3-127b 5-ID.57

NOTES: Wall paint and header graphics at front elevation only of elevator core included for this location number; wall elevation conditions shown are artistic representation based on rough site photo surveys; actual wall elevation conditions to be field verified by contractor/installer

S1 CG.L3-127g 5-ID.59


NOTES: Wall paint and header graphics on rear and two side elevations of elevator core included for this location number; wall elevation conditions shown are artistic representation based on rough site photo surveys; actual wall elevation conditions to be field verified by contractor/installer

Side C



S1 CG.L3-127j 5-ID.58

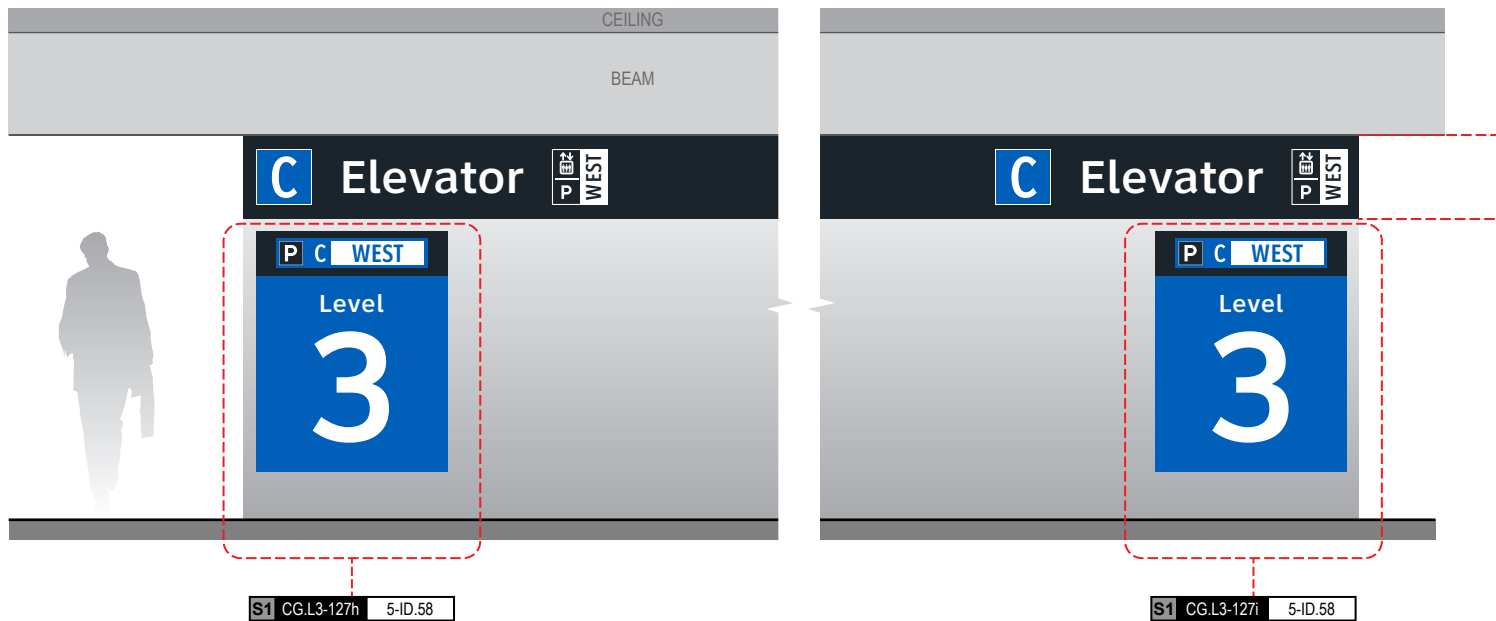
Side B



S1 CG.L3-127h 5-ID.58

S1 CG.L3-127i 5-ID.58

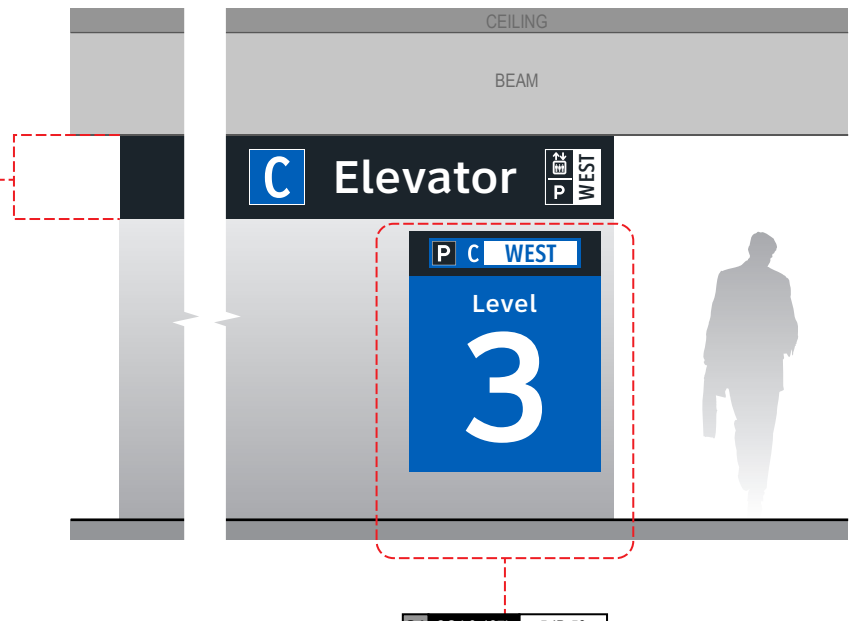Side D



S1 CG.L3-127k 5-ID.58

## END OF PARKING C: LEVEL 3 - SECTOR 1 MESSAGES

**Wayfinding Updates**

Issue Date: 08-23-2024

Issue for Bid

REV.   
 REV.   
 REV.

**WARNING:**

This record contains Sensitive Security Information that is controlled under 49 CFR parts 15 and 1520. No part of this record may be disclosed to persons with a "need to know," as defined in 49 CFR parts 15 and 1520, except with the written permission of the Administrator of the Transportation Security Administration or the Secretary of Transportation. Unauthorized release may result in civil penalty or other action. For U.S. government agencies, public disclosure is governed by 5 U.S.C. 552 and 49 CFR parts 15 and 1520.



08-23-2024

THESE SHEETS ARE ISSUED FOR GRAPHICAL INFORMATION ONLY

### 6.2 MESSAGE SCHEDULE - GARAGE C: LEVEL 3 - SECTOR 1 (C WEST)

BSG PRJCT# BSG-2024-111-IAH  
 HAS TIP # 24 -103 - IAH

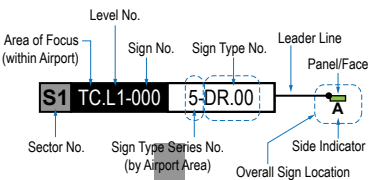


**GENERAL NOTES**

- Sign locations & orientations shown here are approximations based on the most current plan drawings as provided to the designer by the architect at the time of this document's completion. These sign locations are for general design intent & wayfinding planning purposes only. They should not be construed or deemed as absolute or final locations. Field verification, marking & documentation of each final location is to be performed by the Fabricator/Installer, & coordinated with project staff & Wayfinding Design Consultants for final approval.
- All final install locations must be marked and verified in the field for proper structural integrity, adequate line of sight, utilities / property-line / other existing signage interferences & must be in complete compliance with all local, state and national codes prior to fabrication or installation.
- Adjustments to the sign locations shown in these drawings must be documented by the Fabricator/Installer, and provided to project staff & Wayfinding Design Consultants for final approval.

**NOTE:** Only priority wayfinding signage & locations as shown in this wayfinding plan package are in scope. All other signage not shown (including traffic control) are NOT IN SCOPE for this project/contract.

**SIGN LOCATION ANNOTATION LEGEND**



**LOCATION CODE DEFINITIONS:**

- AREA OF FOCUS:** (location within Airport)  
 TA = Terminal A  
 TB = Terminal B  
 TC = Terminal C  
 TD = Terminal D  
 TE = Terminal E  
 AB = AB Garage  
 CG = C Garage  
 DE = DE Garage
- SIGN TYPE SERIES NO.:** (by Airport Area)  
 1- = Terminals/Concourses  
 1t- = Terminals/Concourses: Temporary  
 2- = CBP Areas  
 3- = Curbside/Ground Trans.  
 4- = Roadways  
 5- = Parking
- WAYFINDING SIGN TYPE:**  
 DR.xx = Directional  
 ID.xx = Identification  
 IN.xx = Informational

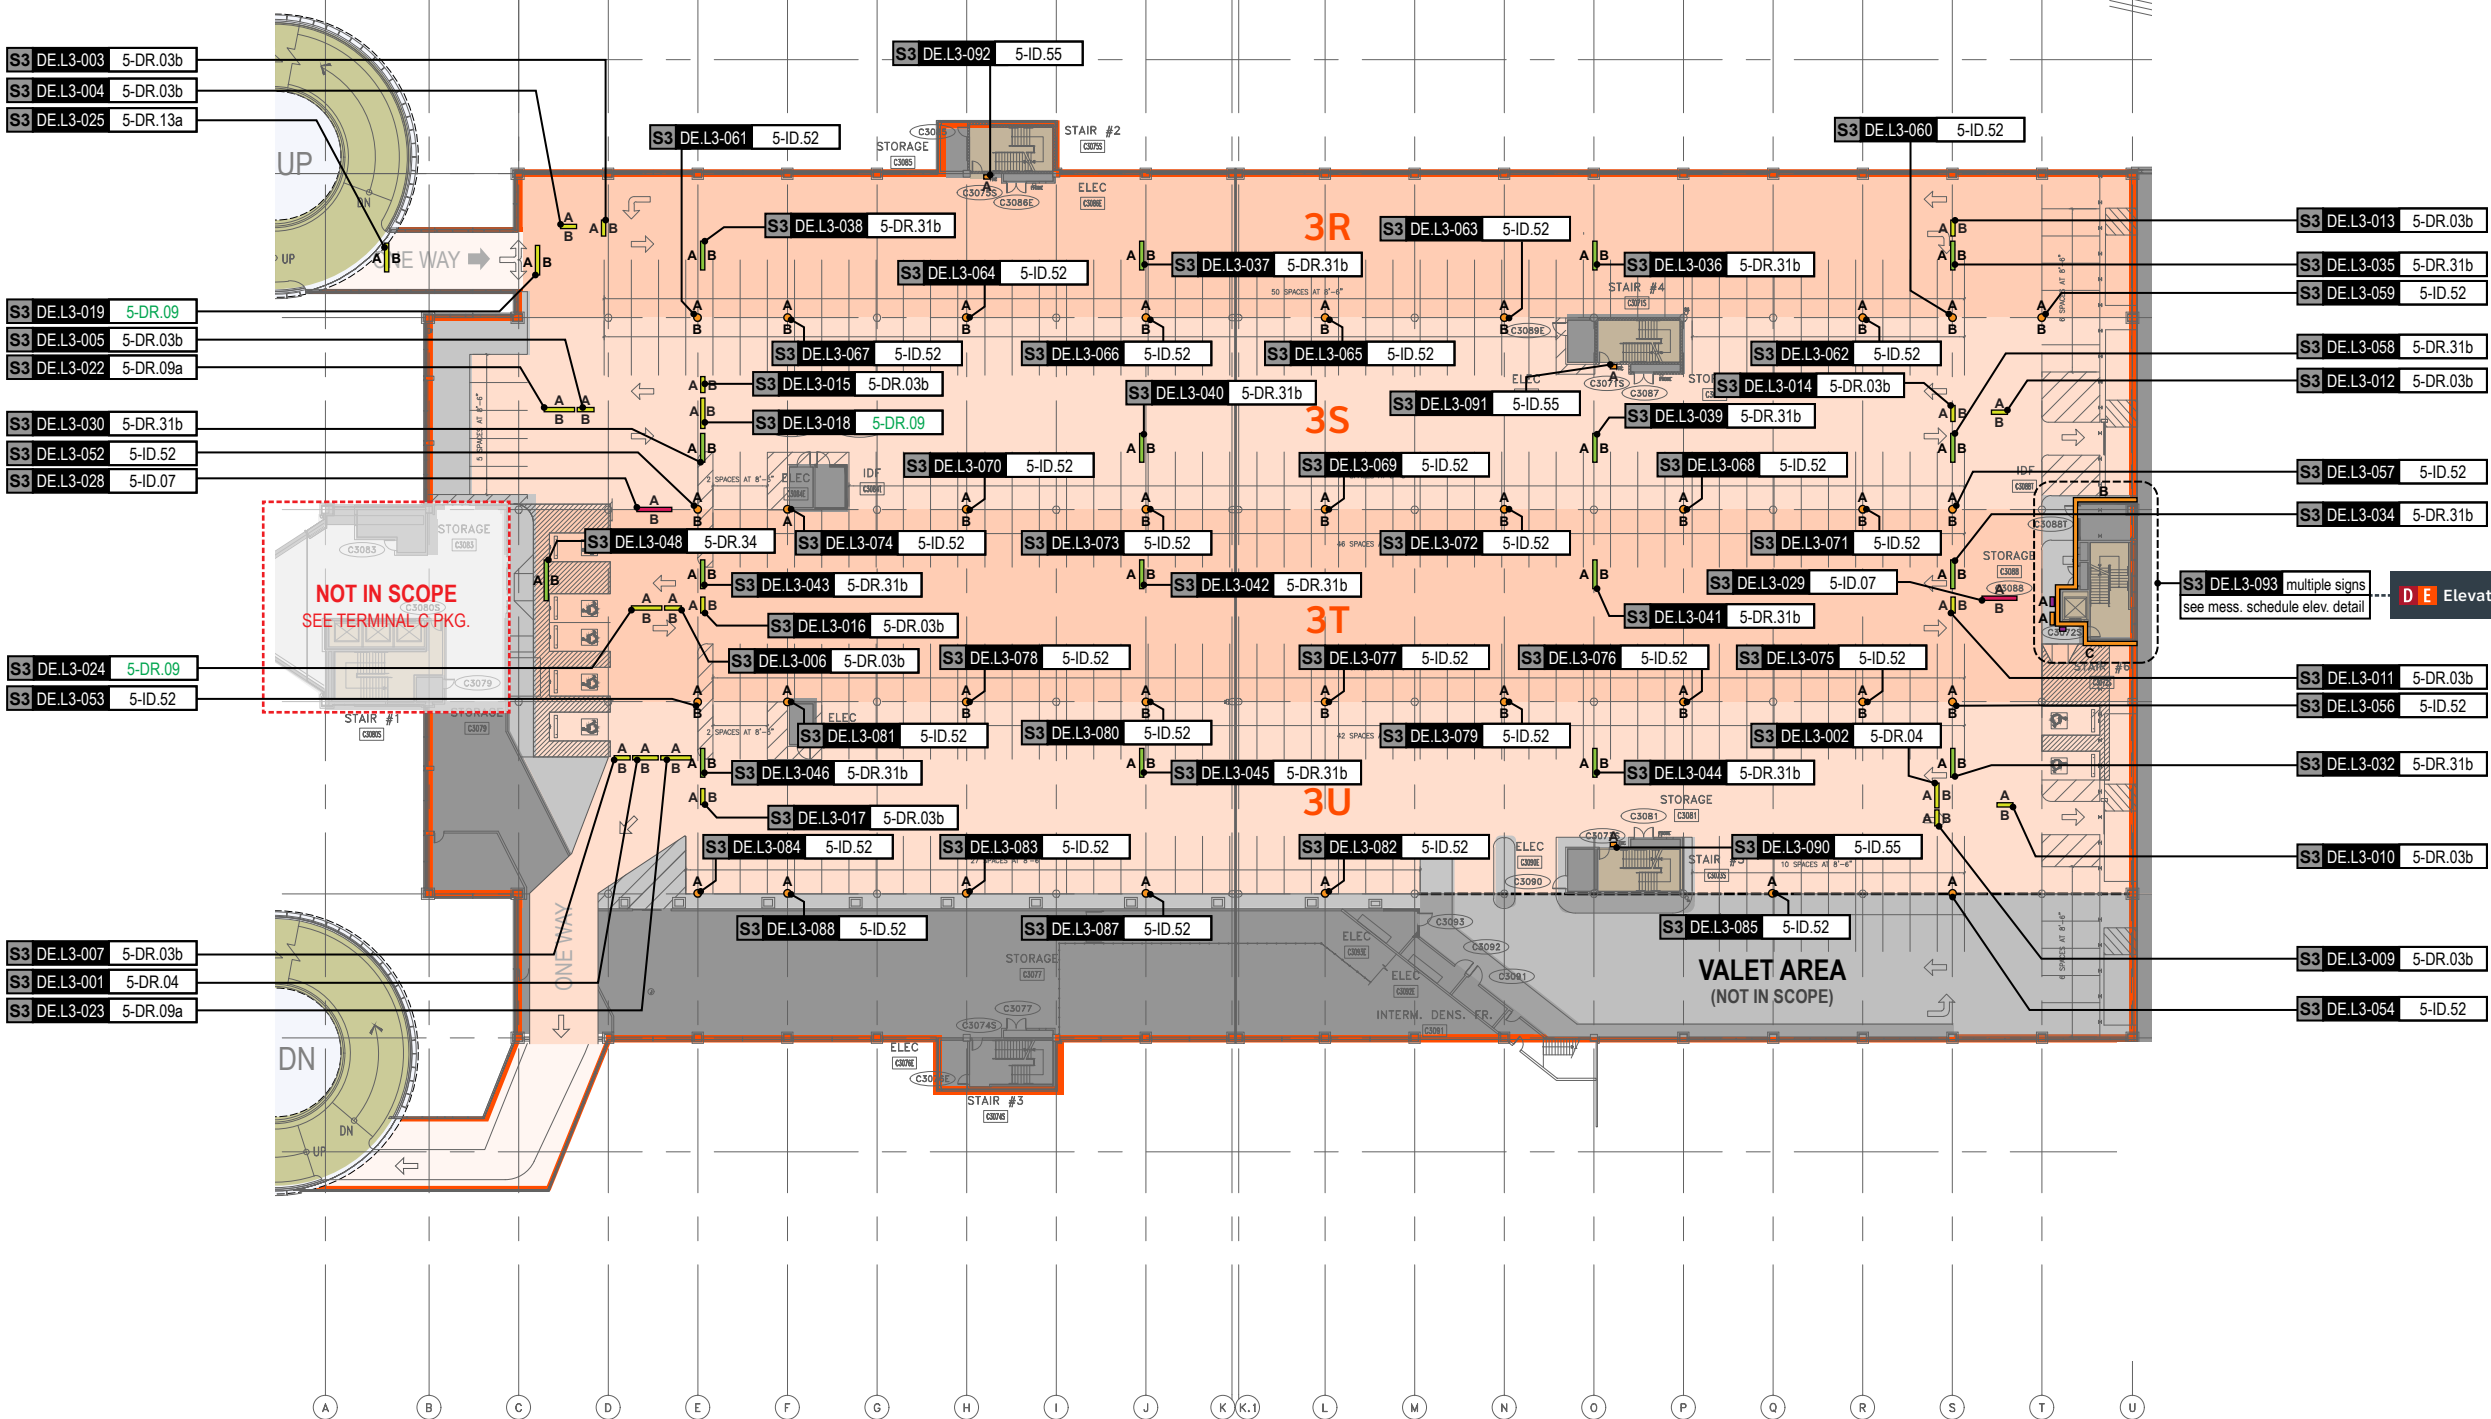
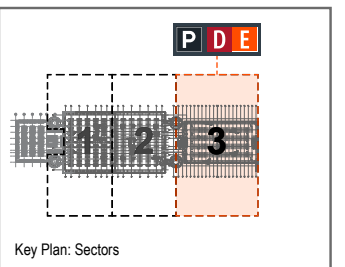
**WAYFINDING SIGN LOCATIONS - Parking:**

- PEDESTRIAN Signs:**  
 A = Directional (DR)  
 B = Identification (ID)  
 A/B = Informational (IN)
- VEHICULAR Signs:**  
 A = Directional (DR)  
 B = Identification (ID)  
 A/B = Informational (IN)

**CIRCULATION:**

- Public Use PEDESTRIAN Vertical Circulation (i.e. Elevators/Escalators/Stairs)
- Public Use VEHICULAR Vertical Circulation (i.e. Ramps)
- Alpha-Numeric Parking Section Naming Areas (Blues = C Garages; Oranges = D/E Garage)
- Areas Not In Scope for this Package

LOCATION PLAN SCALE: 1" = 60'



**Wayfinding Updates**

Issue Date: 08-23-2024  
 Issue for Bid  
 REV.   
 REV.   
 REV.

**WARNING:**  
 This record contains Sensitive Security Information that is controlled under 49 CFR parts 15 and 1520. No part of this record may be disclosed to persons with a "need to know," as defined in 49 CFR parts 15 and 1520, except with the written permission of the Administrator of the Transportation Security Administration or the Secretary of Transportation. Unauthorized release may result in civil penalty or other action. For U.S. government agencies, public disclosure is governed by 5 U.S.C. 552 and 49 CFR parts 15 and 1520.



THESE SHEETS ARE ISSUED FOR GRAPHICAL INFORMATION ONLY

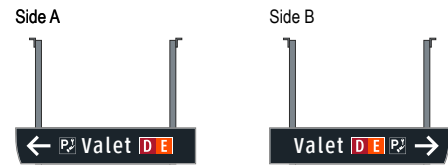
08-23-2024

**6.3 SIGN LOCATION PLAN - GARAGE D/E: LEVEL 3 - SECTOR 3 (D/E)**


BSG PRJCT# BSG-2024-111-IAH  
 HAS TIP # 24 -103 - IAH

Sheet: 6-19


S3 DE.L3-001 5-DR.04 Notes: N/A




S3 DE.L3-005 5-DR.03b Notes: N/A

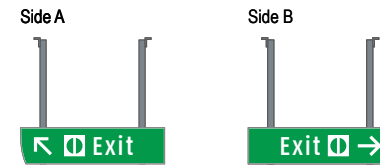


S3 DE.L3-002 5-DR.04 Notes: N/A

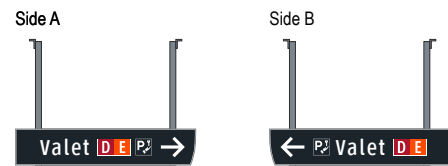


S3 DE.L3-006 5-DR.03b Notes: N/A

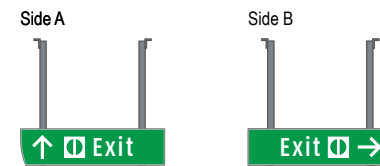


S3 DE.L3-003 5-DR.03b Notes: N/A

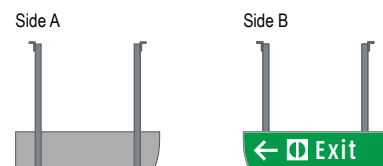

S3 DE.L3-007 5-DR.03b Notes: N/A

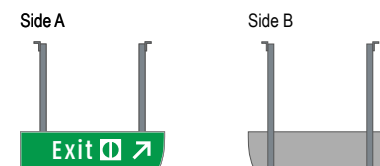


S3 DE.L3-004 5-DR.03b Notes: N/A

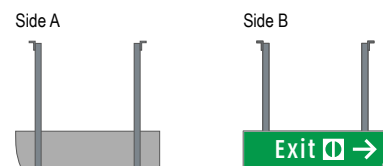


S3 DE.L3-008 N/A Notes: N/A

NOT USED

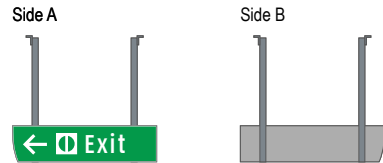
S3 DE.L3-009 5-DR.03b Notes: N/A




S3 DE.L3-013 5-DR.03b Notes: N/A

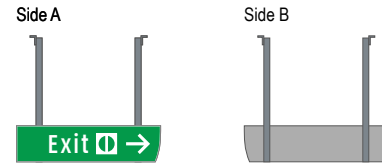


S3 DE.L3-010 5-DR.03b Notes: N/A

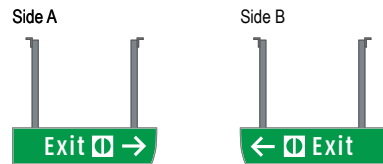


S3 DE.L3-014 5-DR.03b Notes: N/A

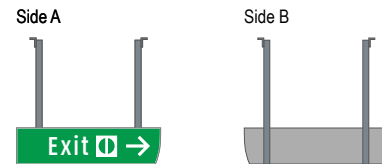


S3 DE.L3-011 5-DR.03b Notes: N/A

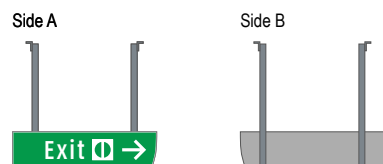


S3 DE.L3-015 5-DR.03b Notes: N/A

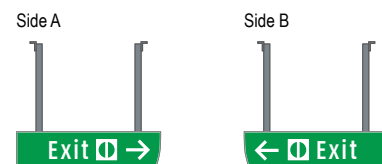


S3 DE.L3-012 5-DR.03b Notes: N/A

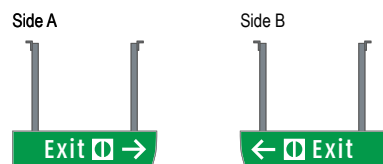

S3 DE.L3-016 5-DR.03b Notes: N/A

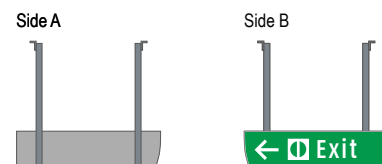


S3 DE.L3-017 5-DR.03b Notes: N/A

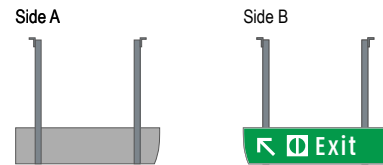


S3 DE.L3-021 N/A Notes: N/A

NOT USED

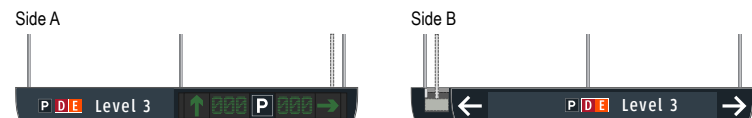
S3 DE.L3-018 5-DR.09 Notes: N/A




S3 DE.L3-022 5-DR.09a Notes: N/A

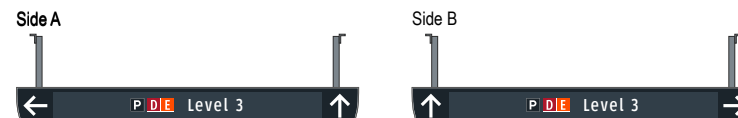


S3 DE.L3-019 5-DR.09 Notes: N/A

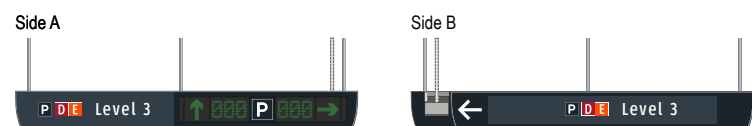

S3 DE.L3-023 5-DR.09a Notes: N/A

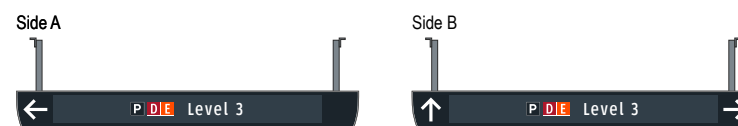

S3 DE.L3-020 5-DR.09a Notes: N/A

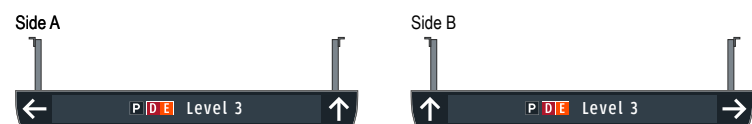

S3 DE.L3-024 5-DR.09 Notes: N/A



S3 DE.L3-025 5-DR.13a Notes: N/A

Side A

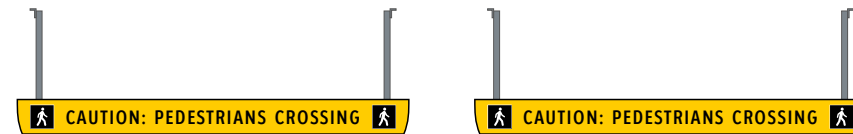
Side B



S3 DE.L3-029 5-ID.07 Notes: N/A

Side A

Side B




S3 DE.L3-026 N/A Notes: N/A

NOT USED

S3 DE.L3-030 5-DR.31b Notes: N/A

Side A

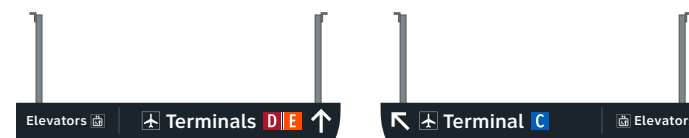Side B



S3 DE.L3-027 N/A Notes: N/A

NOT USED

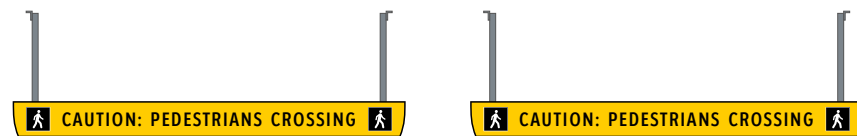
S3 DE.L3-031 N/A Notes: N/A

NOT USED

S3 DE.L3-028 5-ID.07 Notes: N/A

Side A


Side B



S3 DE.L3-032 5-DR.31b Notes: N/A

Side A

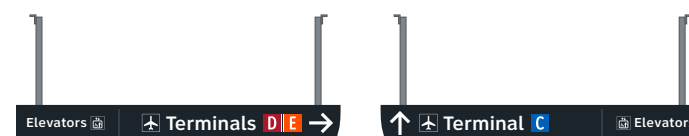Side B



GEORGE BUSH INTERCONTINENTAL AIRPORT  
Wayfinding Signage Design Intent Documents  
C Garage



Louisville, Colorado  
P: 303.494.7849  
www.labozan.com

These documents are intended to illustrate design intent, and should only be used as a general guideline. No information contained here should be construed as engineered elements. The fabricator/contractor shall be responsible for all engineering and specifications with regard to structural, electrical, mechanical, foundation and installation. Information and illustrations contained here are part of an original unpublished design by Labozan Associates, Inc. Detailing and information contained on these pages shall not be reproduced, copied or utilized in any way except for the specific project for which they were created without previous written authorization from Labozan Associates, Inc.  
© 2024 by Labozan Associates, Inc.

Wayfinding Updates

Issue Date: 08-23-2024  
Issue for Bid

- REV.
- REV.
- REV.

WARNING:

This record contains Sensitive Security Information that is controlled under 49 CFR parts 15 and 1520. No part of this record may be disclosed to persons with a "need to know," as defined in 49 CFR parts 15 and 1520, except with the written permission of the Administrator of the Transportation Security Administration or the Secretary of Transportation. Unauthorized release may result in civil penalty or other action. For U.S. government agencies, public disclosure is governed by 5 U.S.C. 552 and 49 CFR parts 15 and 1520.



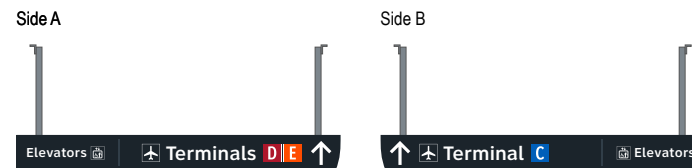
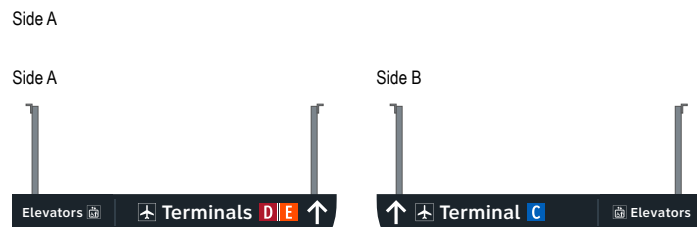
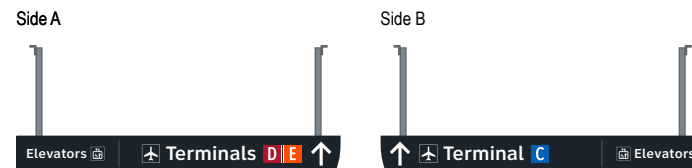
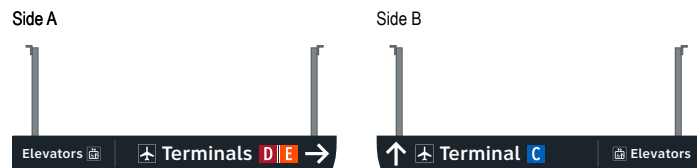
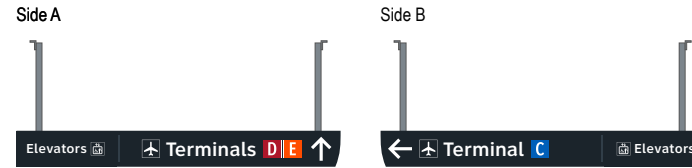
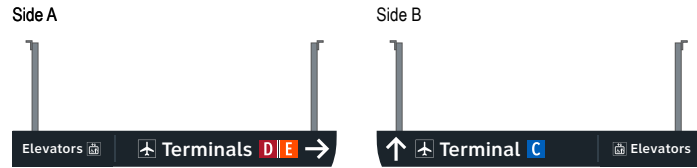
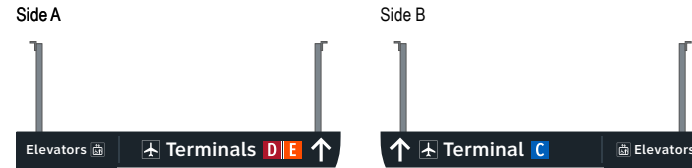
08-23-2024

THESE SHEETS ARE ISSUED FOR GRAPHICAL INFORMATION ONLY

6.4 MESSAGE SCHEDULE - GARAGE D/E: LEVEL 3 - SECTOR 3 (D/E)

BSG PRJCT# BSG-2024-111-IAH  
HAS TIP # 24 -103 - IAH

NOT USED



**Wayfinding Updates**

Issue Date: 08-23-2024

**Issue for Bid**

- REV. ⚠
- REV. ⚠
- REV. ⚠

**WARNING:**

This record contains Sensitive Security Information that is controlled under 49 CFR parts 15 and 1520. No part of this record may be disclosed to persons with a "need to know," as defined in 49 CFR parts 15 and 1520, except with the written permission of the Administrator of the Transportation Security Administration or the Secretary of Transportation. Unauthorized release may result in civil penalty or other action. For U.S. government agencies, public disclosure is governed by 5 U.S.C. 552 and 49 CFR parts 15 and 1520.

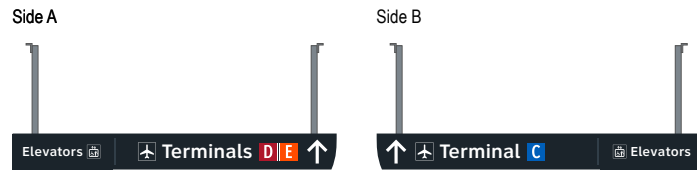


THESE SHEETS ARE ISSUED FOR GRAPHICAL INFORMATION ONLY


**6.4 MESSAGE SCHEDULE - GARAGE D/E: LEVEL 3 - SECTOR 3 (D/E)**

BSG PRJCT# BSG-2024-111-IAH  
 HAS TIP # 24 -103 - IAH


S3 DE.L3-041 5-DR.31b Notes: N/A




S3 DE.L3-045 5-DR.31b Notes: N/A

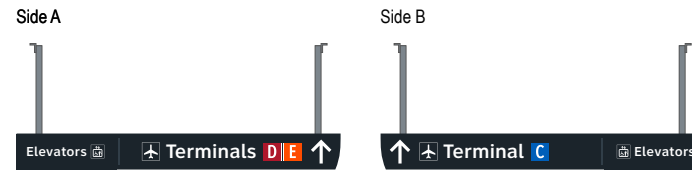


S3 DE.L3-042 5-DR.31b Notes: N/A

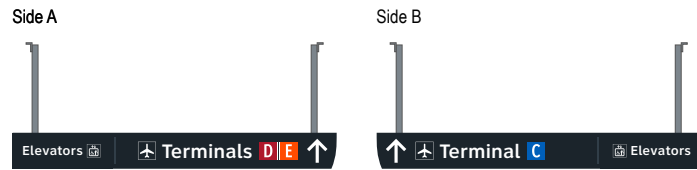

S3 DE.L3-046 5-DR.31b Notes: N/A

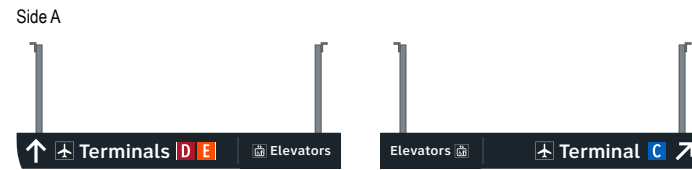


S3 DE.L3-043 5-DR.31b Notes: N/A

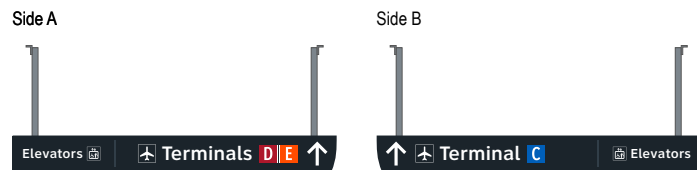


S3 DE.L3-047 N/A Notes: N/A

NOT USED

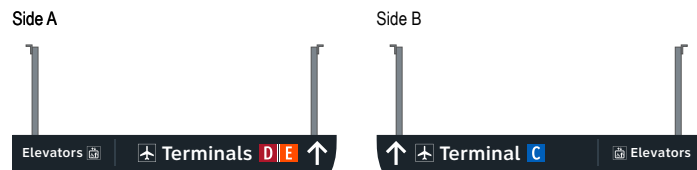S3 DE.L3-044 5-DR.31b Notes: N/A



S3 DE.L3-048 5-DR.34 Notes: N/A

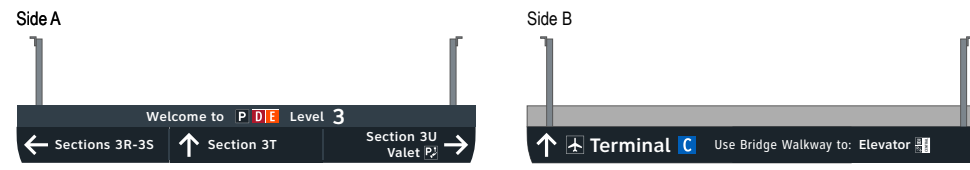

Wayfinding Updates

Issue Date: 08-23-2024  
Issue for Bid

- REV.
- REV.
- REV.

WARNING:

This record contains Sensitive Security Information that is controlled under 49 CFR parts 15 and 1520. No part of this record may be disclosed to persons with a "need to know," as defined in 49 CFR parts 15 and 1520, except with the written permission of the Administrator of the Transportation Security Administration or the Secretary of Transportation. Unauthorized release may result in civil penalty or other action. For U.S. government agencies, public disclosure is governed by 5 U.S.C. 552 and 49 CFR parts 15 and 1520.



THESE SHEETS ARE ISSUED FOR GRAPHICAL INFORMATION ONLY

6.4 MESSAGE SCHEDULE - GARAGE D/E: LEVEL 3 - SECTOR 3 (D/E)

BSG PRJCT# BSG-2024-111-IAH  
HAS TIP # 24 -103 - IAH

S3 DE.L3-049 N/A Notes: N/A

NOT USED

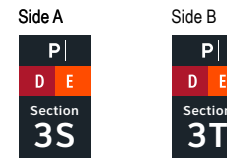
S3 DE.L3-050 N/A Notes: N/A

NOT USED


S3 DE.L3-051 N/A Notes: Notes: N/A

NOT USED

S3 DE.L3-052 5-ID.52 Notes: N/A



S3 DE.L3-053 5-ID.52 Notes: N/A

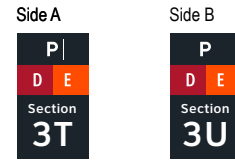


S3 DE.L3-054 5-ID.52 Notes: N/A



S3 DE.L3-055 N/A Notes: N/A

NOT USED

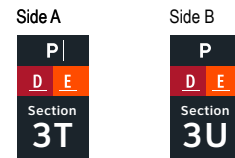S3 DE.L3-056 5-ID.52 Notes: N/A



GEORGE BUSH INTERCONTINENTAL AIRPORT  
Wayfinding Signage Design Intent Documents  
C Garage



Louisville, Colorado  
P: 303.494.7849  
www.labozan.com

These documents are intended to illustrate design intent, and should only be used as a general guideline. No information contained here should be construed as engineered elements. The fabricator/contractor shall be responsible for all engineering and specifications with regard to structural, electrical, mechanical, foundation and installation. Information and illustrations contained here are part of an original unpublished design by Labozan Associates, Inc. Detailing and information contained on these pages shall not be reproduced, copied or utilized in any way except for the specific project for which they were created without previous written authorization from Labozan Associates, Inc.

© 2024 by Labozan Associates, Inc.

Wayfinding Updates

Issue Date: 08-23-2024  
Issue for Bid

REV.   
REV.   
REV.

WARNING:

This record contains Sensitive Security Information that is controlled under 49 CFR parts 15 and 1520. No part of this record may be disclosed to persons with a "need to know," as defined in 49 CFR parts 15 and 1520, except with the written permission of the Administrator of the Transportation Security Administration or the Secretary of Transportation. Unauthorized release may result in civil penalty or other action. For U.S. government agencies, public disclosure is governed by 5 U.S.C. 552 and 49 CFR parts 15 and 1520.



THESE SHEETS ARE ISSUED FOR GRAPHICAL INFORMATION ONLY

08-23-2024

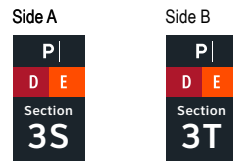
6.4 MESSAGE SCHEDULE - GARAGE D/E: LEVEL 3 - SECTOR 3 (D/E)

BSG PRJCT# BSG-2024-111-IAH  
HAS TIP # 24 -103 - IAH


Sheet: 6-26




S3 DE.L3-057 5-ID.52 Notes: N/A




S3 DE.L3-061 5-ID.52 Notes: N/A

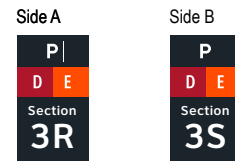


S3 DE.L3-058 5-DR.31b Notes: N/A

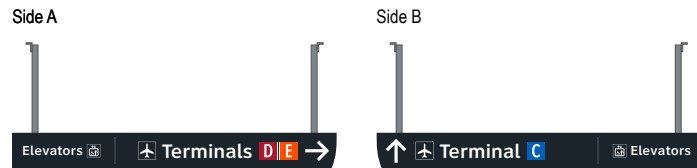


S3 DE.L3-062 5-ID.52 Notes: N/A

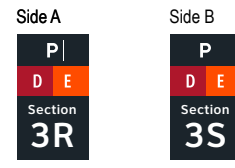


S3 DE.L3-059 5-ID.52 Notes: N/A

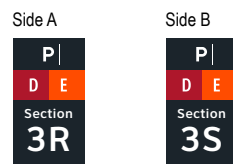


S3 DE.L3-063 5-ID.52 Notes: N/A

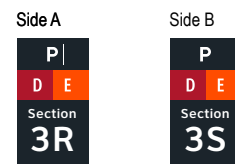

S3 DE.L3-060 5-ID.52 Notes: N/A

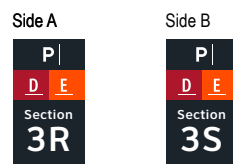

S3 DE.L3-064 5-ID.52 Notes: N/A

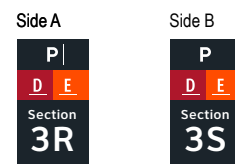

**Wayfinding Updates**

Issue Date: 08-23-2024

**Issue for Bid**

- REV. 
- REV. 
- REV. 

**WARNING:**

This record contains Sensitive Security Information that is controlled under 49 CFR parts 15 and 1520. No part of this record may be disclosed to persons with a "need to know," as defined in 49 CFR parts 15 and 1520, except with the written permission of the Administrator of the Transportation Security Administration or the Secretary of Transportation. Unauthorized release may result in civil penalty or other action. For U.S. government agencies, public disclosure is governed by 5 U.S.C. 552 and 49 CFR parts 15 and 1520.

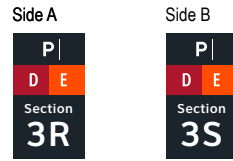


THESE SHEETS ARE ISSUED FOR GRAPHICAL INFORMATION ONLY


**6.4 MESSAGE SCHEDULE - GARAGE D/E: LEVEL 3 - SECTOR 3 (D/E)**

BSG PRJCT# BSG-2024-111-IAH  
HAS TIP # 24 -103 - IAH


S3 DE.L3-065 5-ID.52 Notes: N/A




S3 DE.L3-069 5-ID.52 Notes: N/A

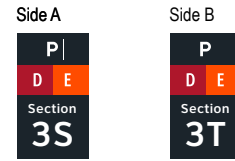


S3 DE.L3-066 5-ID.52 Notes: N/A

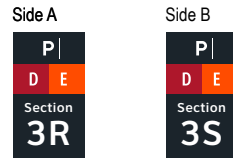


S3 DE.L3-070 5-ID.52 Notes: N/A

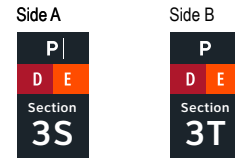


S3 DE.L3-067 5-ID.52 Notes: N/A

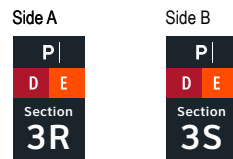


S3 DE.L3-071 5-ID.52 Notes: N/A

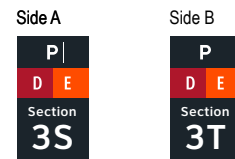

S3 DE.L3-068 5-ID.52 Notes: N/A

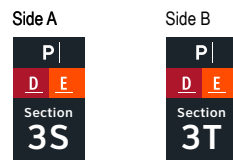

S3 DE.L3-072 5-ID.52 Notes: N/A

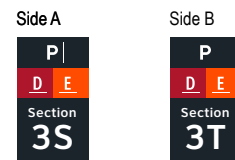

GEORGE BUSH INTERCONTINENTAL AIRPORT  
Wayfinding Signage Design Intent Documents  
C Garage



Louisville, Colorado  
P: 303.494.7849  
www.labozan.com

These documents are intended to illustrate design intent, and should only be used as a general guideline. No information contained here should be construed as engineered elements. The fabricator/contractor shall be responsible for all engineering and specifications with regard to structural, electrical, mechanical, foundation and installation. Information and illustrations contained here are part of an original unpublished design by Labozan Associates, Inc. Detailing and information contained on these pages shall not be reproduced, copied or utilized in any way except for the specific project for which they were created without previous written authorization from Labozan Associates, Inc.

© 2024 by Labozan Associates, Inc.

Wayfinding Updates

Issue Date: 08-23-2024  
Issue for Bid

- REV.
- REV.
- REV.

WARNING:

This record contains Sensitive Security Information that is controlled under 49 CFR parts 15 and 1520. No part of this record may be disclosed to persons with a "need to know," as defined in 49 CFR parts 15 and 1520, except with the written permission of the Administrator of the Transportation Security Administration or the Secretary of Transportation. Unauthorized release may result in civil penalty or other action. For U.S. government agencies, public disclosure is governed by 5 U.S.C. 552 and 49 CFR parts 15 and 1520.



08-23-2024

THESE SHEETS ARE ISSUED FOR GRAPHICAL INFORMATION ONLY

6.4 MESSAGE SCHEDULE - GARAGE D/E: LEVEL 3 - SECTOR 3 (D/E)

BSG PRJCT# BSG-2024-111-IAH  
HAS TIP # 24 -103 - IAH

S3 DE.L3-073 5-ID.52 Notes: N/A

Side A      Side B

P	P
D E	D E
Section	Section
3S	3T

S3 DE.L3-077 5-ID.52 Notes: N/A

Side A      Side B

P	P
D E	D E
Section	Section
3T	3U

S3 DE.L3-074 5-ID.52 Notes: N/A

Side A

P
D E
Section
3T

S3 DE.L3-078 5-ID.52 Notes: N/A

Side A      Side B

P	P
D E	D E
Section	Section
3T	3U

S3 DE.L3-075 5-ID.52 Notes: N/A

Side A      Side B

P	P
D E	D E
Section	Section
3T	3U

S3 DE.L3-079 5-ID.52 Notes: N/A

Side A      Side B

P	P
D E	D E
Section	Section
3T	3U

S3 DE.L3-076 5-ID.52 Notes: N/A

Side A      Side B

P	P
D E	D E
Section	Section
3T	3U

S3 DE.L3-080 5-ID.52 Notes: N/A

Side A      Side B

P	P
D E	D E
Section	Section
3T	3U

**Wayfinding Updates**

Issue Date: 08-23-2024

**Issue for Bid**

- REV. 
- REV. 
- REV. 

**WARNING:**

This record contains Sensitive Security Information that is controlled under 49 CFR parts 15 and 1520. No part of this record may be disclosed to persons with a "need to know," as defined in 49 CFR parts 15 and 1520, except with the written permission of the Administrator of the Transportation Security Administration or the Secretary of Transportation. Unauthorized release may result in civil penalty or other action. For U.S. government agencies, public disclosure is governed by 5 U.S.C. 552 and 49 CFR parts 15 and 1520.



THESE SHEETS ARE ISSUED FOR GRAPHICAL INFORMATION ONLY

**6.4 MESSAGE SCHEDULE - GARAGE D/E: LEVEL 3 - SECTOR 3 (D/E)**

BSG PRJCT# BSG-2024-111-IAH  
HAS TIP # 24 -103 - IAH

S3 DE.L3-081 5-ID.52 Notes: N/A

Side A



S3 DE.L3-085 5-ID.52 Notes: N/A

Side A



S3 DE.L3-082 5-ID.52 Notes: N/A

Side A



S3 DE.L3-086 N/A Notes: N/A

NOT USED

S3 DE.L3-083 5-ID.52 Notes: N/A

Side A



S3 DE.L3-087 5-ID.52 Notes: N/A

Side A



S3 DE.L3-084 5-ID.52 Notes: N/A

Side A



S3 DE.L3-088 5-ID.52 Notes: N/A

Side A



GEORGE BUSH INTERCONTINENTAL AIRPORT  
Wayfinding Signage Design Intent Documents  
C Garage



Louisville, Colorado  
P: 303.494.7849  
www.labozan.com

These documents are intended to illustrate design intent, and should only be used as a general guideline. No information contained here should be construed as engineered elements. The fabricator/contractor shall be responsible for all engineering and specifications with regard to structural, electrical, mechanical, foundation and installation. Information and illustrations contained here are part of an original unpublished design by Labozan Associates, Inc. Detailing and information contained on these pages shall not be reproduced, copied or utilized in any way except for the specific project for which they were created without previous written authorization from Labozan Associates, Inc.  
© 2024 by Labozan Associates, Inc.

Wayfinding Updates

Issue Date: 08-23-2024  
Issue for Bid

- REV.
- REV.
- REV.

WARNING:

This record contains Sensitive Security Information that is controlled under 49 CFR parts 15 and 1520. No part of this record may be disclosed to persons with a "need to know," as defined in 49 CFR parts 15 and 1520, except with the written permission of the Administrator of the Transportation Security Administration or the Secretary of Transportation. Unauthorized release may result in civil penalty or other action. For U.S. government agencies, public disclosure is governed by 5 U.S.C. 552 and 49 CFR parts 15 and 1520.



THESE SHEETS ARE ISSUED FOR GRAPHICAL INFORMATION ONLY

08-23-2024

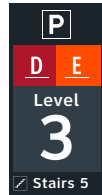
6.4 MESSAGE SCHEDULE - GARAGE D/E: LEVEL 3 - SECTOR 3 (D/E)

BSG PRJCT# BSG-2024-111-IAH  
HAS TIP # 24 -103 - IAH


NOT USED

ELEVATOR CORE SIGNAGE CONTINUED ON NEXT SHEET

Side A




Side A

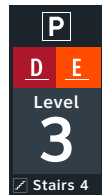

Side A



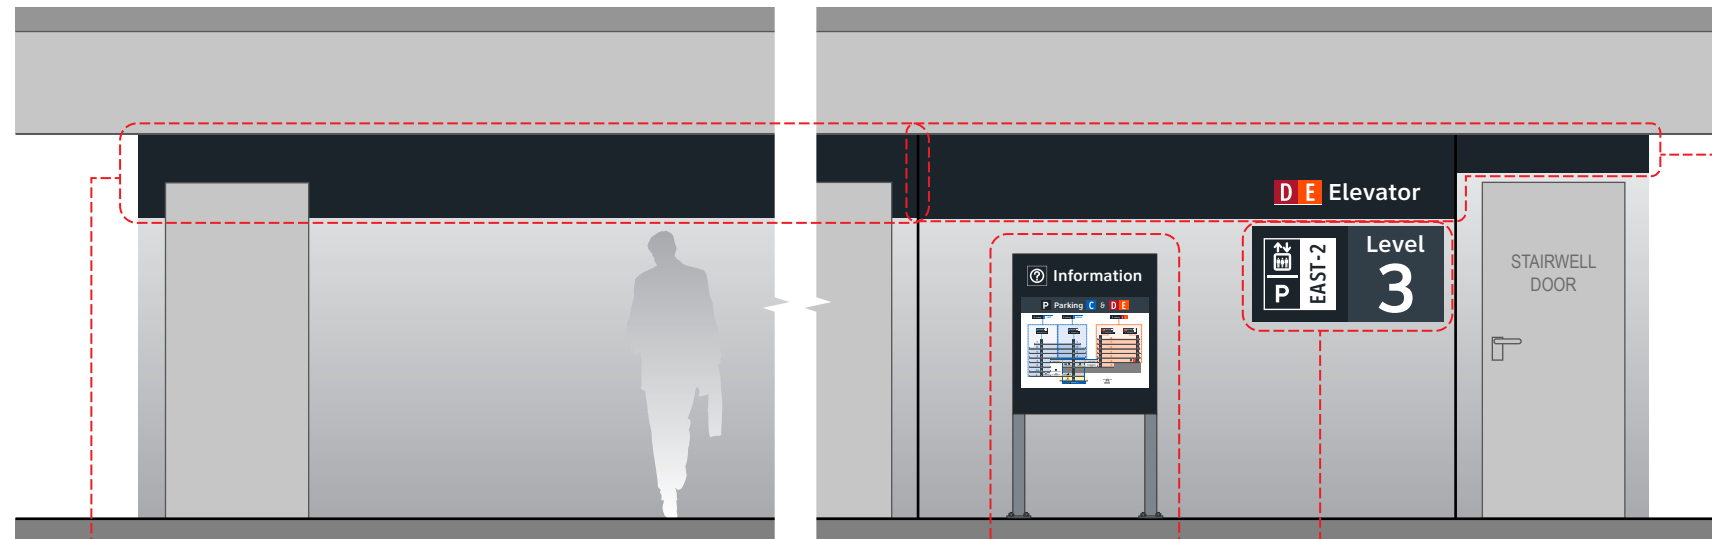Side A



S3 DE.L3-093a 5-IN.61

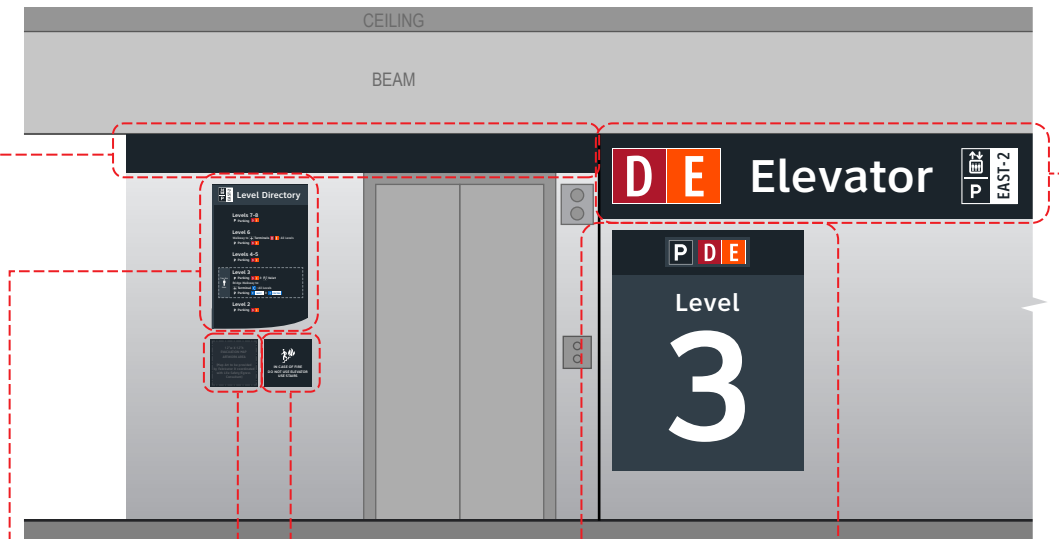
NOTES: Directory artwork includes a "You Are Here" button graphic and is in a unique location per elevator core/level location; artwork included here is representative of final map artwork design intent for this location

S3 DE.L3-093b 5-ID.56

S3 DE.L3-093 5-ID.57

NOTES: Wall paint and header graphics at A & C elevations only of elevator core included for this location number; wall elevation conditions shown are artistic representation based on rough site photo surveys; actual wall elevation conditions to be field verified by contractor/installer

Side C



S3 DE.L3-093c 5-IN.55

NOTES: Level directory plaque includes a "You Are Here" graphic and is in a unique location per elevator core/level location; artwork included here is representative of final artwork design intent for this location

S3 DE.L3-093d 5-IN.51

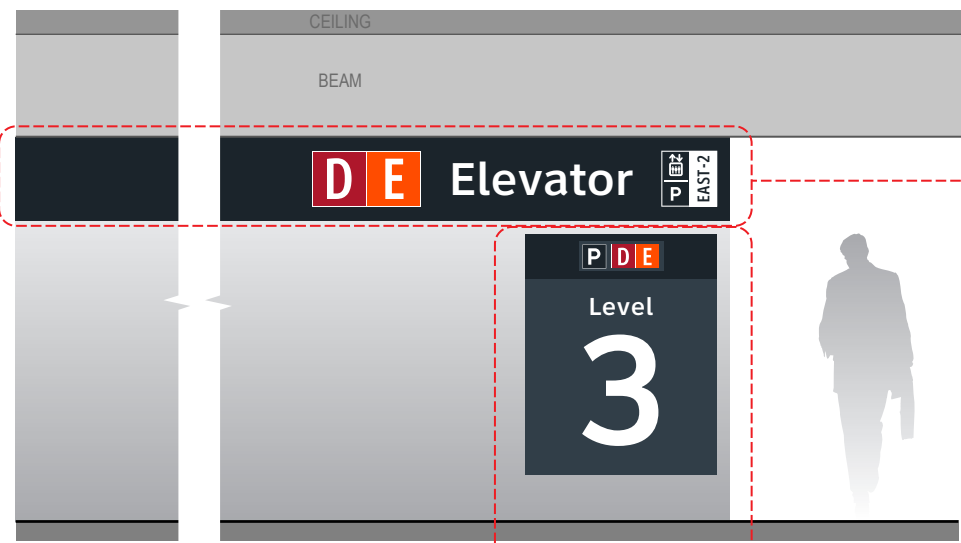
S3 DE.L3-093e 5-IN.52

S3 DE.L3-093h 5-ID.58

S3 DE.L3-093f 5-ID.59

NOTES: Wall paint and header graphics on rear and two side elevations of elevator core included for this location number; wall elevation conditions shown are artistic representation based on rough site photo surveys; actual wall elevation conditions to be field verified by contractor/installer

Side B



S3 DE.L3-093g 5-ID.59

NOTES: Wall paint and header graphics on rear and two side elevations of elevator core included for this location number; wall elevation conditions shown are artistic representation based on rough site photo surveys; actual wall elevation conditions to be field verified by contractor/installer

S3 DE.L3-093i 5-ID.58

## END OF GARAGE D/E: LEVEL 3 - SECTOR 3 MESSAGES

# 7.0

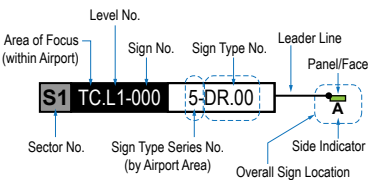
## **7.0 LOCATION PLANS & MESSAGE SCHEDULES: LEVEL 4**

GENERAL NOTES

- Sign locations & orientations shown here are approximations based on the most current plan drawings as provided to the designer by the architect at the time of this document's completion. These sign locations are for general design intent & wayfinding planning purposes only. They should not be construed or deemed as absolute or final locations. Field verification, marking & documentation of each final location is to be performed by the Fabricator/Installer, & coordinated with project staff & Wayfinding Design Consultants for final approval.
- All final install locations must be marked and verified in the field for proper structural integrity, adequate line of sight, utilities / property-line / other existing signage interferences & must be in complete compliance with all local, state and national codes prior to fabrication or installation.
- Adjustments to the sign locations shown in these drawings must be documented by the Fabricator/Installer, and provided to project staff & Wayfinding Design Consultants for final approval.

**NOTE:** Only priority wayfinding signage & locations as shown in this wayfinding plan package are in scope. All other signage not shown (including traffic control) are NOT IN SCOPE for this project/contract.

SIGN LOCATION ANNOTATION LEGEND



LOCATION CODE DEFINITIONS:

- AREA OF FOCUS:** (location within Airport)
- TA = Terminal A
  - TB = Terminal B
  - TC = Terminal C
  - TD = Terminal D
  - TE = Terminal E
  - AB = AB Garage
  - CG = C Garage
  - DE = DE Garage
- SIGN TYPE SERIES NO.:** (by Airport Area)
- 1- = Terminals/Concourses
  - 1t- = Terminals/Concourses: Temporary
  - 2- = CBP Areas
  - 3- = Curbside/Ground Trans.
  - 4- = Roadways
  - 5- = Parking
- WAYFINDING SIGN TYPE:**
- DR.xx = Directional
  - ID.xx = Identification
  - IN.xx = Informational

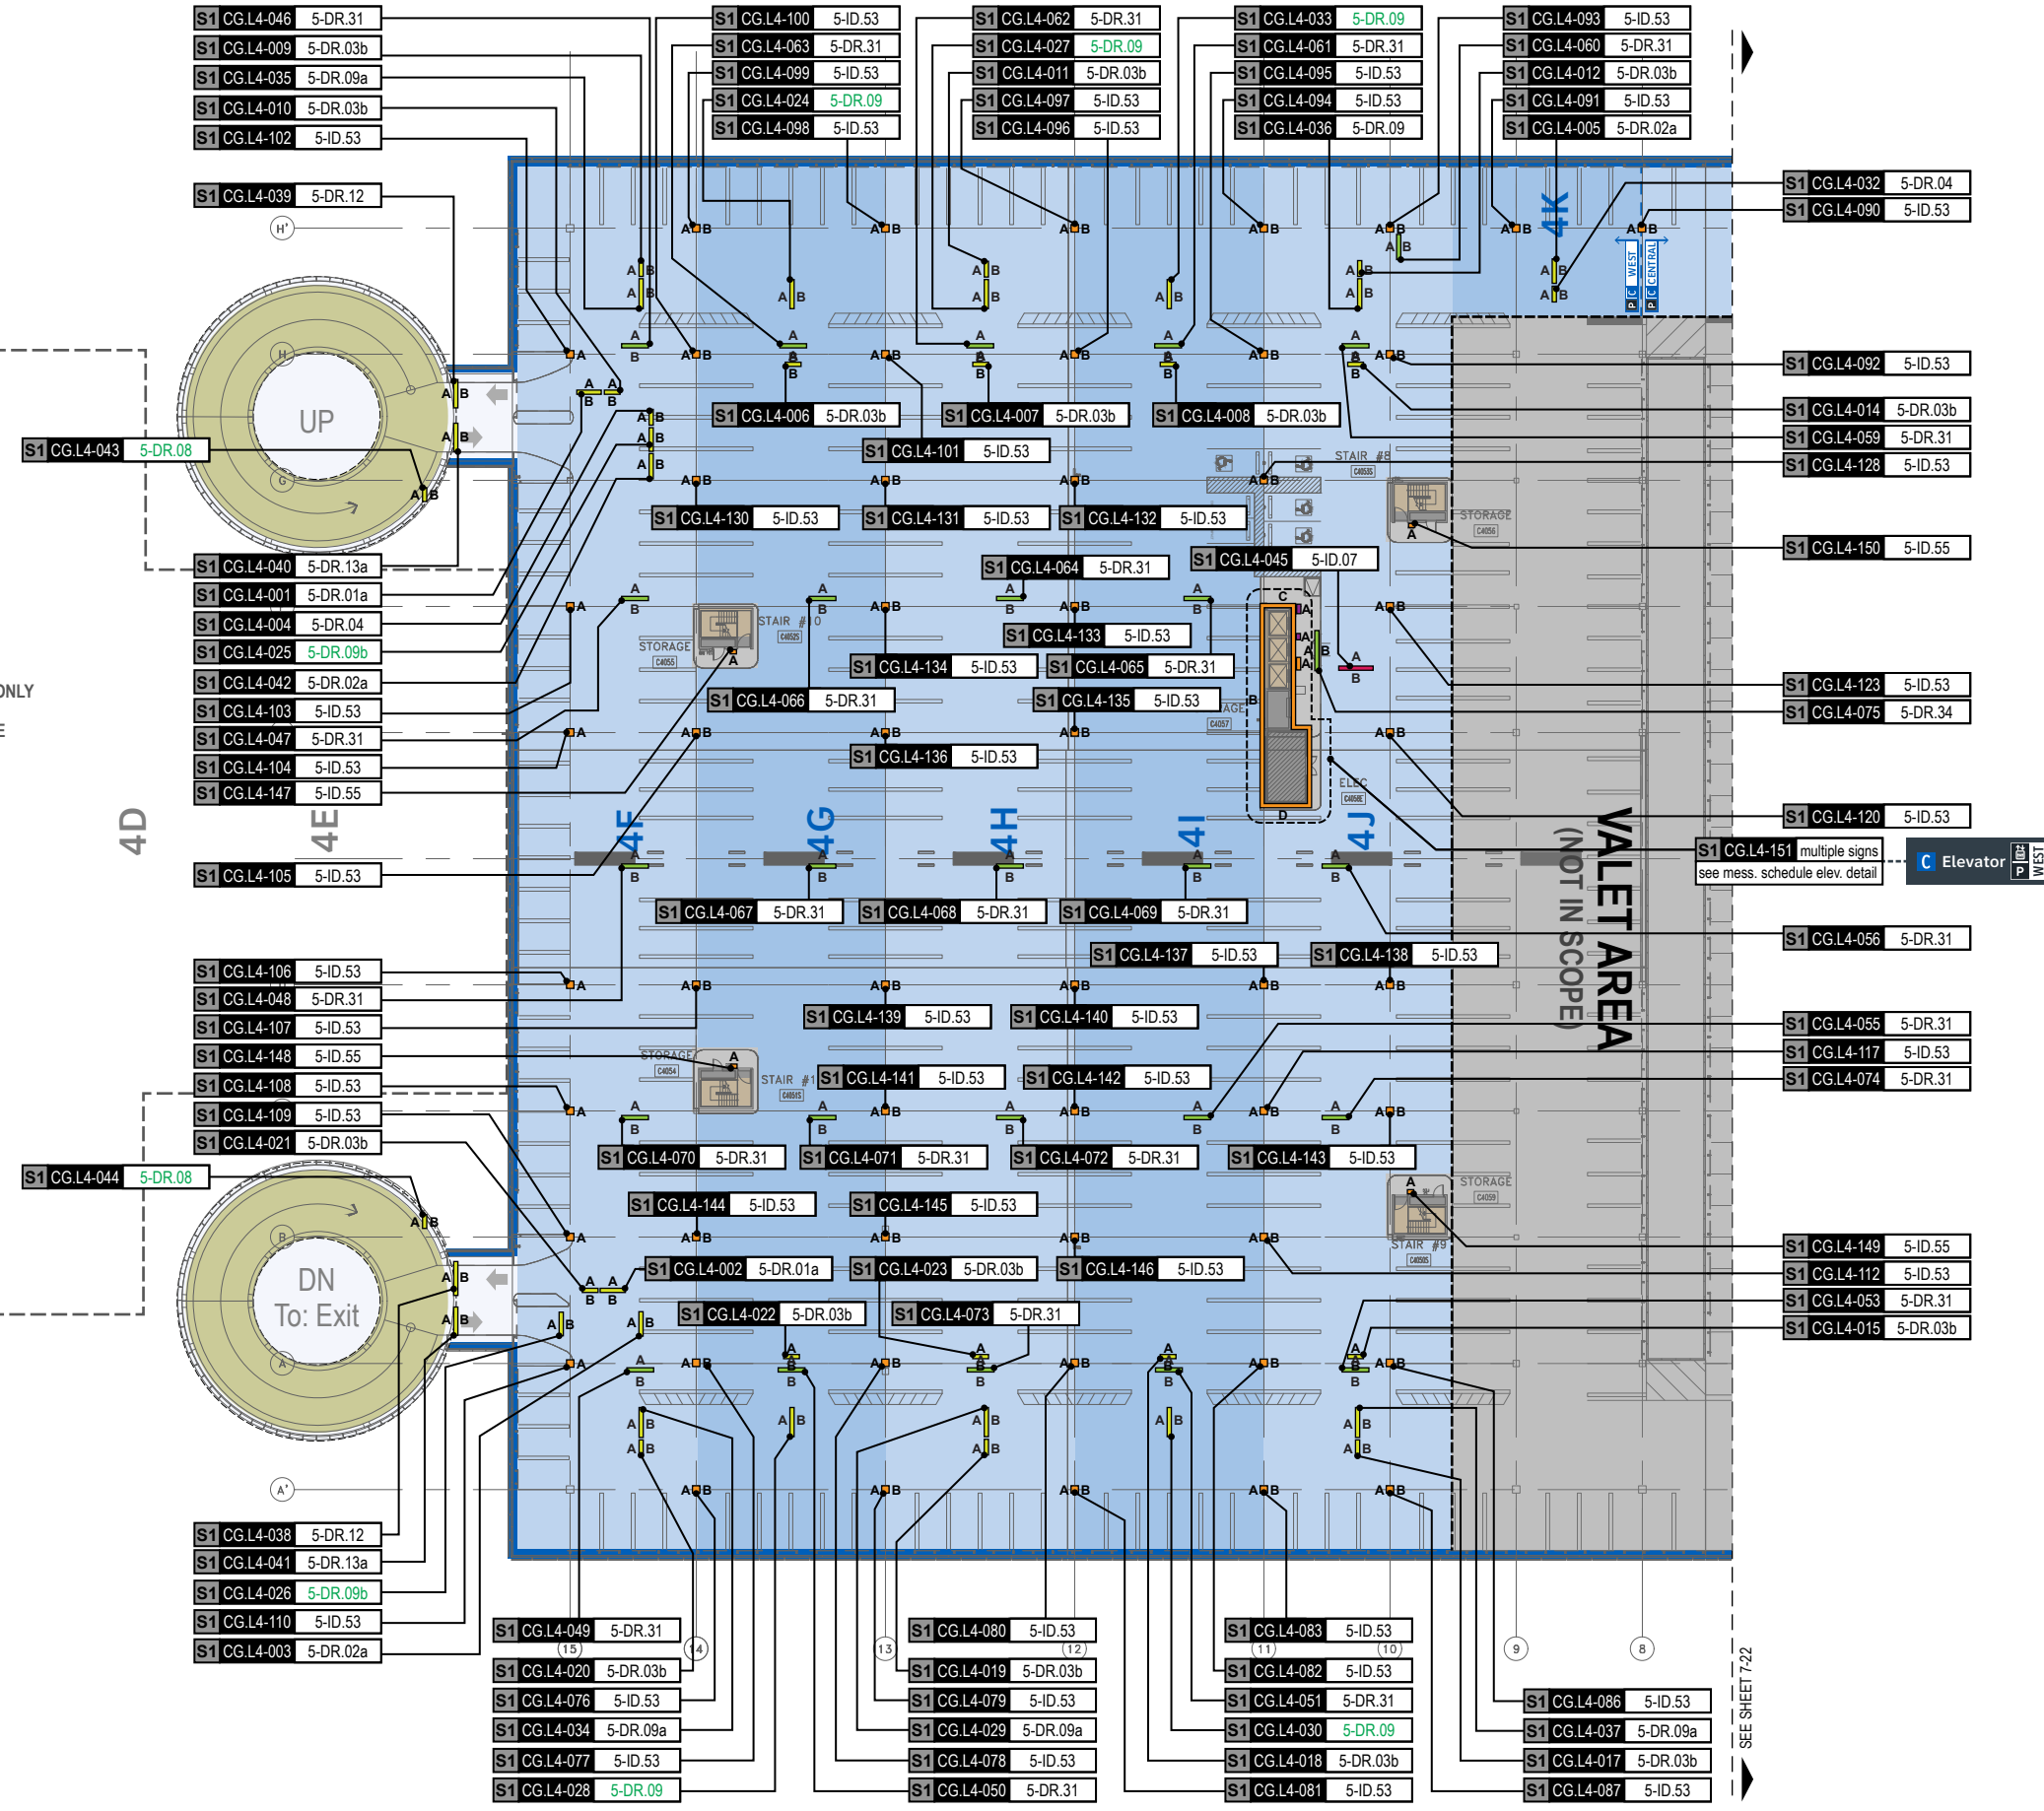
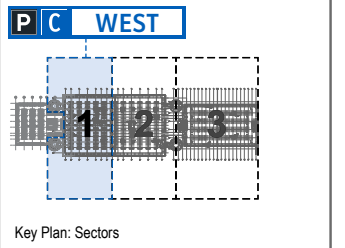
WAYFINDING SIGN LOCATIONS - Parking:

- PEDESTRIAN Signs:**
- A/B = Directional (DR)
  - A/B = Identification (ID)
  - A/B = Informational (IN)
- VEHICULAR Signs:**
- A/B = Directional (DR)
  - A/B = Identification (ID)
  - A/B = Informational (IN)

CIRCULATION:

- Public Use PEDESTRIAN Vertical Circulation (i.e. Elevators/Escalators/Stairs)
- Public Use VEHICULAR Vertical Circulation (i.e. Ramps)
- Alpha-Numeric Parking Section Naming Areas (Blues = C Garages; Oranges = D/E Garage)
- Areas Not In Scope for this Package

LOCATION PLAN SCALE: 1" = 60'



FUTURE C-WEST EXPANSION AREA  
SHOWN FOR PLANNED TERMINOLOGY REFERENCE ONLY  
THESE AREAS NOT IN SCOPE FOR THIS PACKAGE

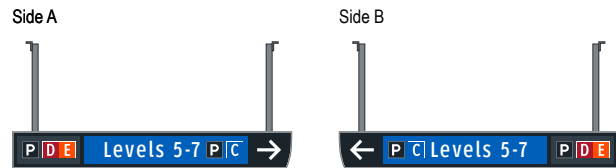
VALET AREA  
(NOT IN SCOPE)

SEE SHEET 7-2







S1 CG.L4-001 5-DR.01a Notes: N/A




S1 CG.L4-005 5-DR.02a Notes: N/A

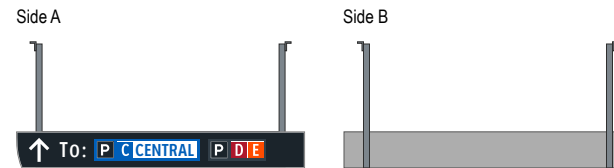


S1 CG.L4-002 5-DR.01a Notes: N/A

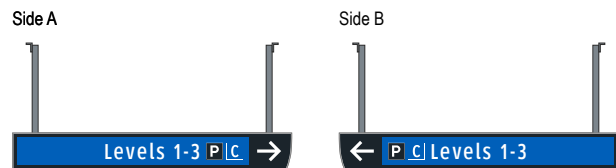


S1 CG.L4-006 5-DR.03b Notes: N/A

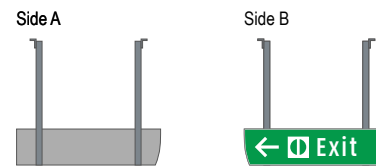


S1 CG.L4-003 5-DR.02a Notes: N/A

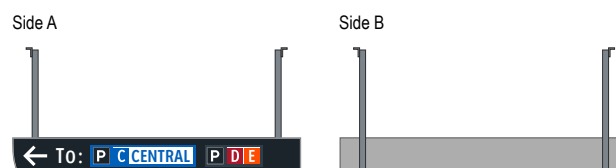


S1 CG.L4-007 5-DR.03b Notes: N/A

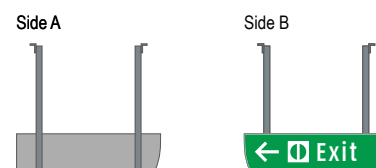


S1 CG.L4-004 5-DR.04 Notes: N/A

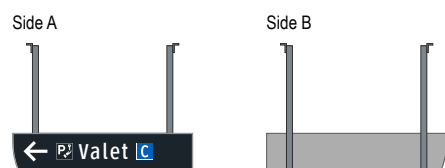

S1 CG.L4-008 5-DR.03b Notes: N/A

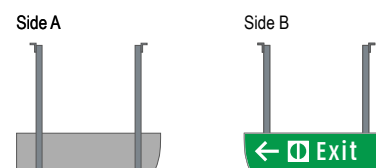


S1 CG.L4-009 5-DR.03b Notes: N/A

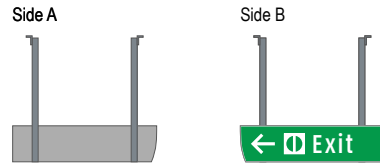


S1 CG.L4-013 N/A Notes: N/A

NOT USED

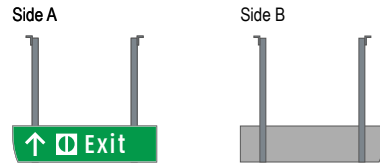
S1 CG.L4-010 5-DR.03b Notes: N/A




S1 CG.L4-014 5-DR.03b Notes: N/A

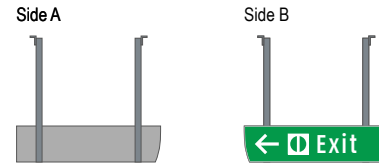


S1 CG.L4-011 5-DR.03b Notes: N/A

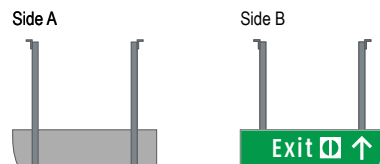

S1 CG.L4-015 5-DR.03b Notes: N/A

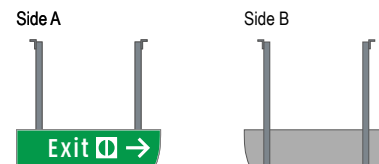


S1 CG.L4-012 5-DR.03b Notes: N/A

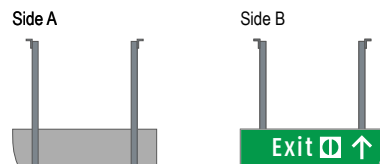


S1 CG.L4-016 N/A Notes: N/A

NOT USED

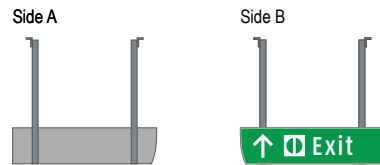
S1 CG.L4-017 5-DR.03b Notes: N/A




S1 CG.L4-021 5-DR.03b Notes: N/A

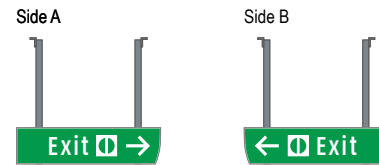


S1 CG.L4-018 5-DR.03b Notes: N/A

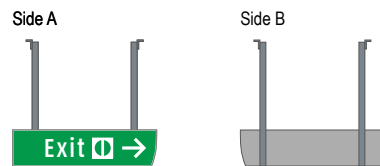


S1 CG.L4-022 5-DR.03b Notes: N/A

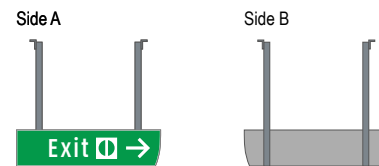


S1 CG.L4-019 5-DR.03b Notes: N/A

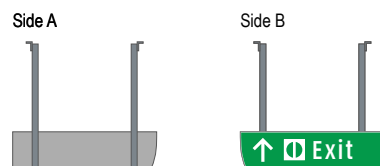


S1 CG.L4-023 5-DR.03b Notes: N/A

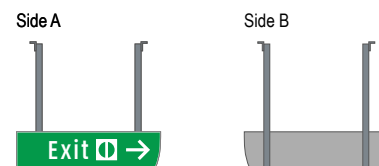

S1 CG.L4-020 5-DR.03b Notes: N/A

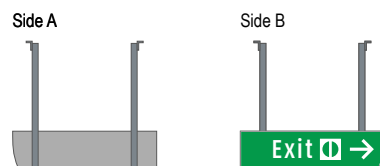

S1 CG.L4-024 5-DR.09 Notes: N/A

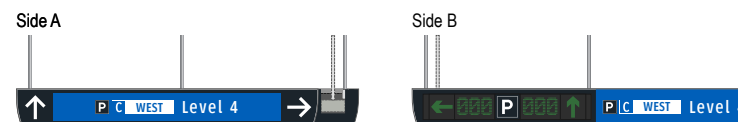

**Wayfinding Updates**

Issue Date: 08-23-2024

Issue for Bid

- REV. 
- REV. 
- REV. 

**WARNING:**

This record contains Sensitive Security Information that is controlled under 49 CFR parts 15 and 1520. No part of this record may be disclosed to persons with a "need to know," as defined in 49 CFR parts 15 and 1520, except with the written permission of the Administrator of the Transportation Security Administration or the Secretary of Transportation. Unauthorized release may result in civil penalty or other action. For U.S. government agencies, public disclosure is governed by 5 U.S.C. 552 and 49 CFR parts 15 and 1520.

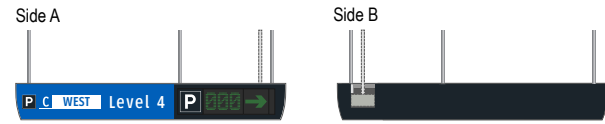


THESE SHEETS ARE ISSUED FOR GRAPHICAL INFORMATION ONLY


**7.2 MESSAGE SCHEDULE - GARAGE C: LEVEL 4 - SECTOR 1 (C WEST)**

BSG PRJCT# BSG-2024-111-IAH  
 HAS TIP # 24 -103 - IAH


S1 CG.L4-025 5-DR.09b Notes: N/A




S1 CG.L4-029 5-DR.09a Notes: N/A

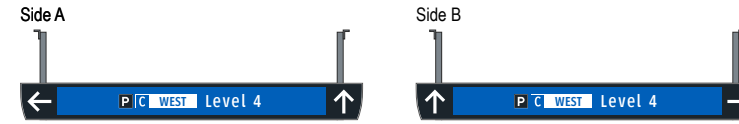


S1 CG.L4-026 5-DR.09b Notes: N/A

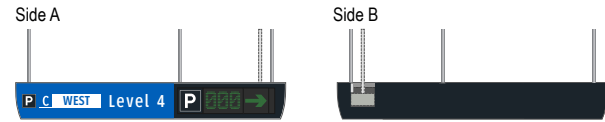

S1 CG.L4-030 5-DR.09 Notes: N/A

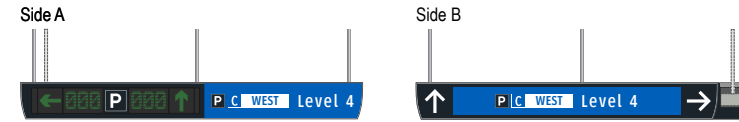


S1 CG.L4-027 5-DR.09 Notes: N/A

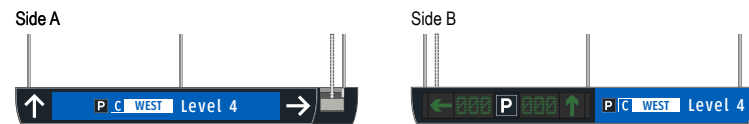


S1 CG.L4-031 N/A Notes: N/A

NOT USED

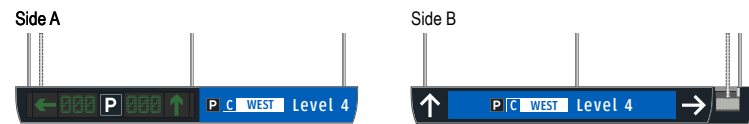
S1 CG.L4-028 5-DR.09 Notes: N/A




S1 CG.L4-032 5-DR.04 Notes: N/A

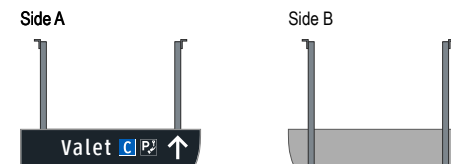


S1 CG.L4-033 5-DR.09 Notes: N/A

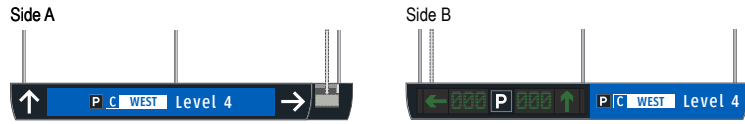


S1 CG.L4-037 5-DR.09a Notes: N/A

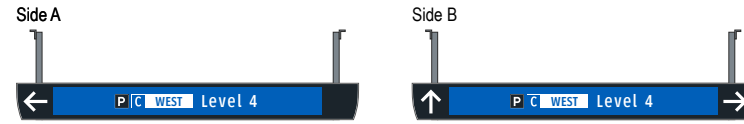


S1 CG.L4-034 5-DR.09a Notes: N/A

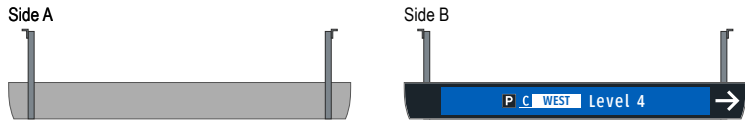


S1 CG.L4-038 5-DR.12 Notes: N/A

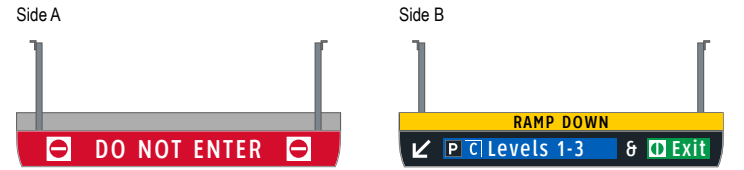


S1 CG.L4-035 5-DR.09a Notes: N/A

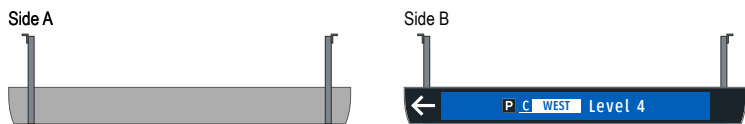


S1 CG.L4-039 5-DR.12 Notes: N/A

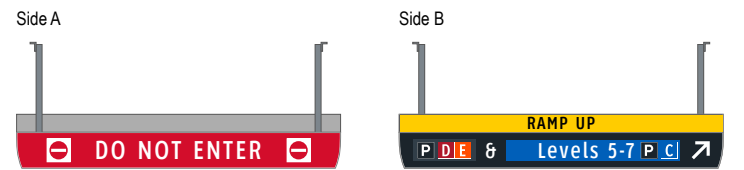


S1 CG.L4-036 5-DR.09 Notes: N/A

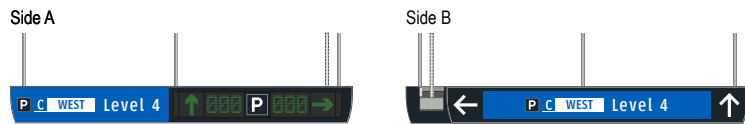


S1 CG.L4-040 5-DR.13a Notes: N/A

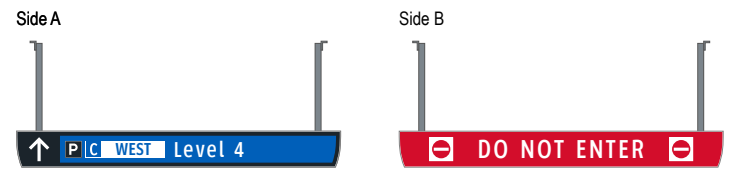


S1 CG.L4-041 5-DR.13a Notes: N/A

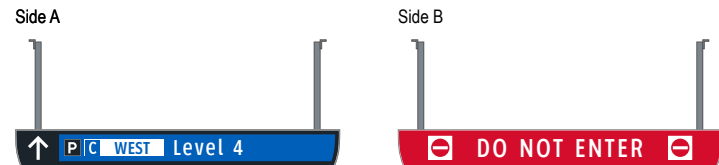


S1 CG.L4-045 5-ID.07 Notes: N/A

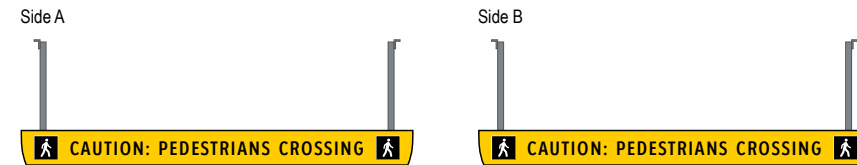


S1 CG.L4-042 5-DR.02a Notes: N/A

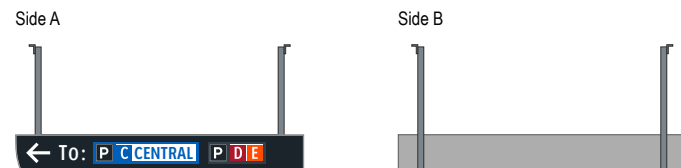


S1 CG.L4-046 5-DR.31 Notes: N/A

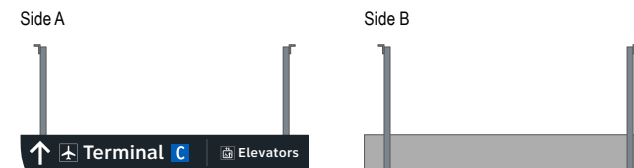

S1 CG.L4-043 5-DR.08 Notes: N/A

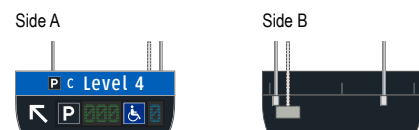


S1 CG.L4-047 5-DR.31 Notes: N/A

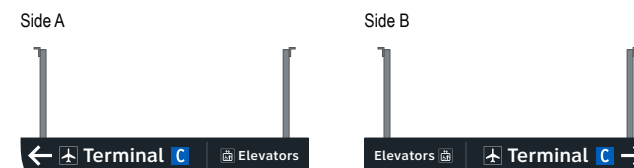


S1 CG.L4-044 5-DR.08 Notes: N/A



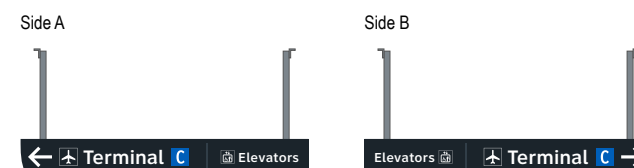
S1 CG.L4-048 5-DR.31 Notes: N/A




S1 CG.L4-049 5-DR.31 Notes: N/A

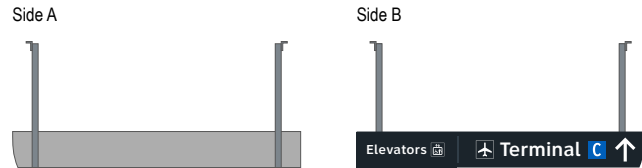

S1 CG.L4-053 5-DR.31 Notes: N/A

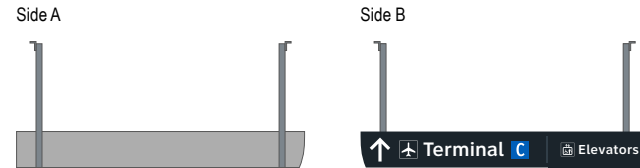


S1 CG.L4-050 5-DR.31 Notes: N/A

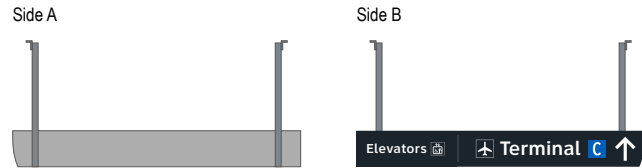


S1 CG.L4-054 N/A Notes: N/A

NOT USED

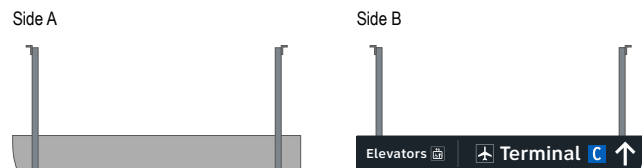S1 CG.L4-051 5-DR.31 Notes: Notes: N/A




S1 CG.L4-055 5-DR.31 Notes: N/A

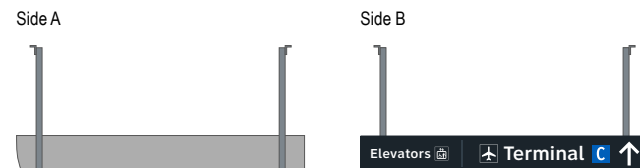

S1 CG.L4-052 N/A Notes: N/A

NOT USED

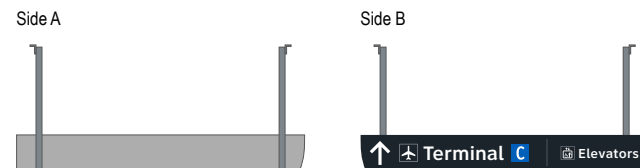S1 CG.L4-056 5-DR.31 Notes: N/A



**Wayfinding Updates**

Issue Date: 08-23-2024

**Issue for Bid**

- REV. 
- REV. 
- REV. 

**WARNING:**

This record contains Sensitive Security Information that is controlled under 49 CFR parts 15 and 1520. No part of this record may be disclosed to persons with a "need to know," as defined in 49 CFR parts 15 and 1520, except with the written permission of the Administrator of the Transportation Security Administration or the Secretary of Transportation. Unauthorized release may result in civil penalty or other action. For U.S. government agencies, public disclosure is governed by 5 U.S.C. 552 and 49 CFR parts 15 and 1520.



THESE SHEETS ARE ISSUED FOR GRAPHICAL INFORMATION ONLY

**7.2 MESSAGE SCHEDULE - GARAGE C: LEVEL 4 - SECTOR 1 (C WEST)**

BSG PRJCT# BSG-2024-111-IAH  
 HAS TIP # 24 -103 - IAH

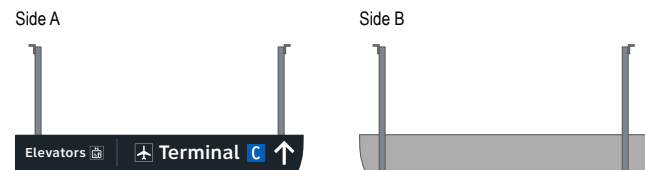
S1 CG.L4-057 N/A Notes: N/A

NOT USED


S1 CG.L4-058 N/A Notes: N/A

NOT USED


S1 CG.L4-059 5-DR.31 Notes: N/A




S1 CG.L4-061 5-DR.31 Notes: N/A

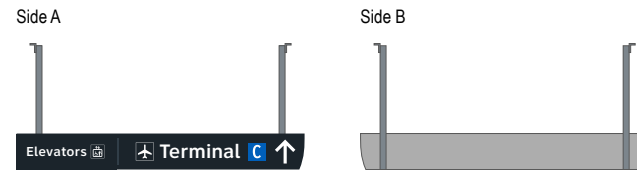


S1 CG.L4-062 5-DR.31 Notes: N/A

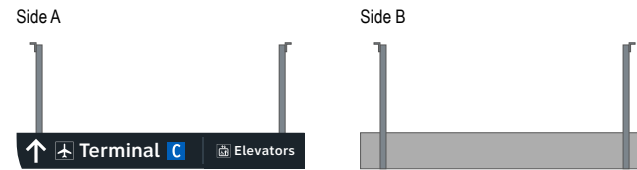


S1 CG.L4-063 5-DR.31 Notes: N/A

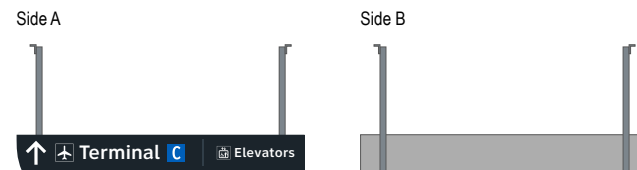

S1 CG.L4-060 5-DR.31 Notes: N/A

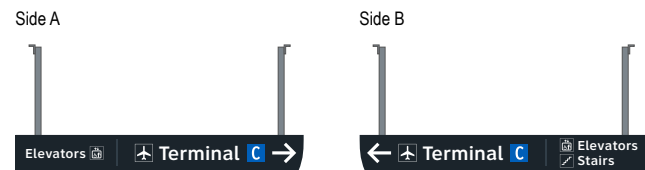


S1 CG.L4-064 5-DR.31 Notes: N/A

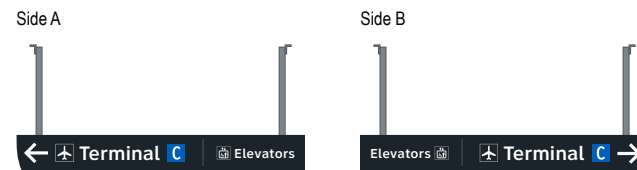





S1 CG.L4-065 5-DR.31 Notes: N/A

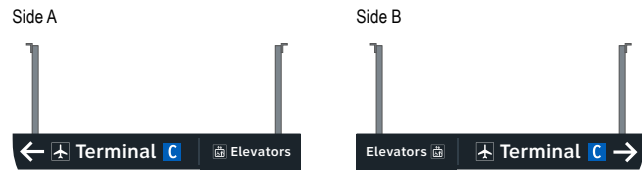


S1 CG.L4-069 5-DR.31 Notes: N/A

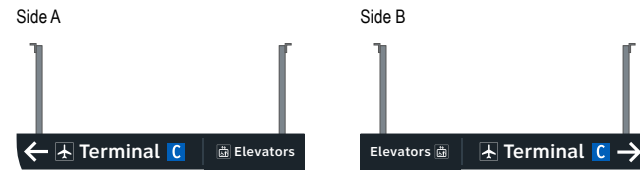


S1 CG.L4-066 5-DR.31 Notes: N/A

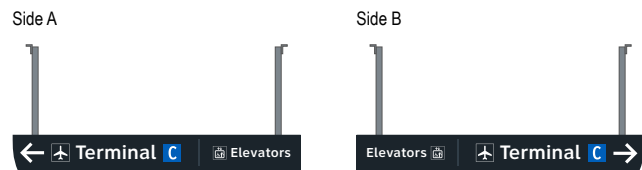


S1 CG.L4-070 5-DR.31 Notes: N/A

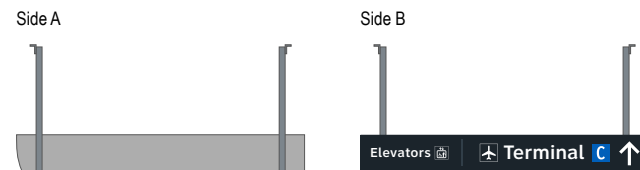


S1 CG.L4-067 5-DR.31 Notes: N/A

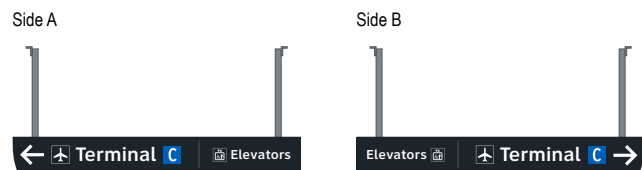


S1 CG.L4-071 5-DR.31 Notes: N/A

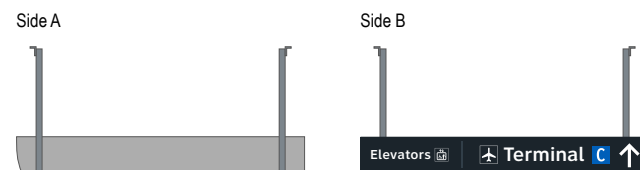

S1 CG.L4-068 5-DR.31 Notes: N/A

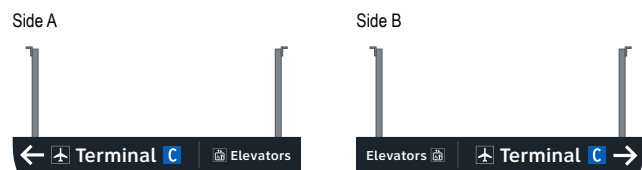

S1 CG.L4-072 5-DR.31 Notes: N/A

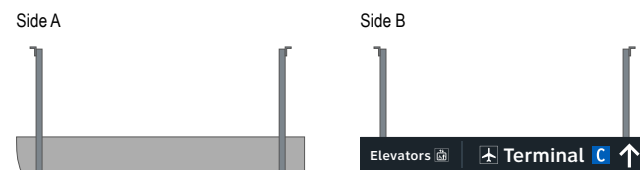

**Wayfinding Updates**

Issue Date: 08-23-2024

**Issue for Bid**

- REV. 
- REV. 
- REV. 

**WARNING:**

This record contains Sensitive Security Information that is controlled under 49 CFR parts 15 and 1520. No part of this record may be disclosed to persons with a "need to know," as defined in 49 CFR parts 15 and 1520, except with the written permission of the Administrator of the Transportation Security Administration or the Secretary of Transportation. Unauthorized release may result in civil penalty or other action. For U.S. government agencies, public disclosure is governed by 5 U.S.C. 552 and 49 CFR parts 15 and 1520.



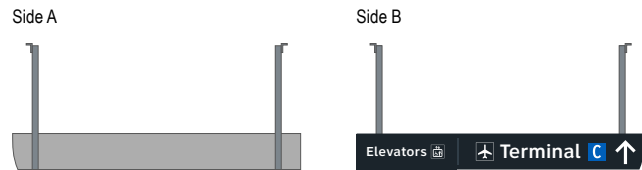
08-23-2024

THESE SHEETS ARE ISSUED FOR GRAPHICAL INFORMATION ONLY


**7.2 MESSAGE SCHEDULE - GARAGE C: LEVEL 4 - SECTOR 1 (C WEST)**

BSG PRJCT# BSG-2024-111-IAH  
 HAS TIP # 24 -103 - IAH


S1 CG.L4-073 5-DR.31 Notes: N/A




S1 CG.L4-077 5-ID.53 Notes: N/A

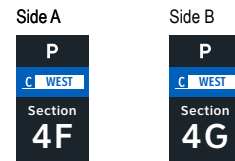


S1 CG.L4-074 5-DR.31 Notes: N/A

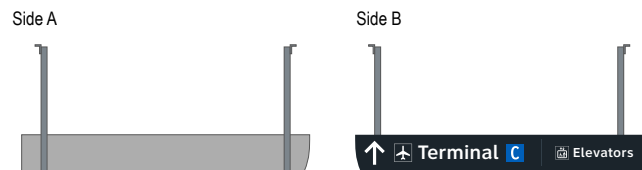


S1 CG.L4-078 5-ID.53 Notes: N/A

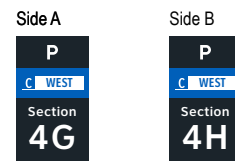


S1 CG.L4-075 5-DR.34 Notes: N/A

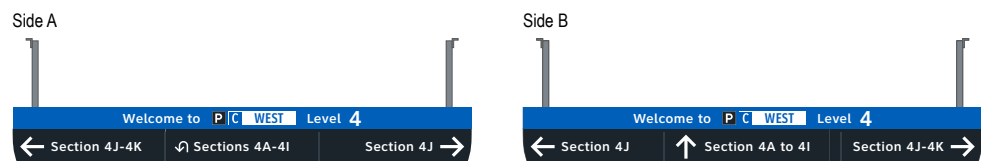


S1 CG.L4-079 5-ID.53 Notes: N/A

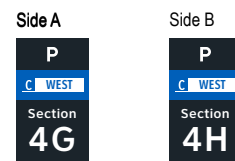


S1 CG.L4-076 5-ID.53 Notes: N/A

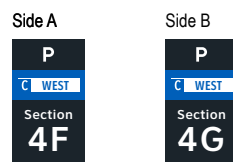


S1 CG.L4-080 5-ID.53 Notes: N/A

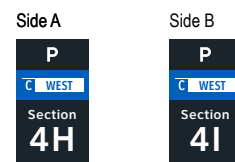


S1 CG.L4-081 5-ID.53 Notes: N/A

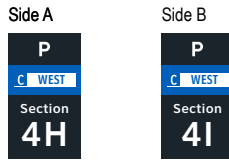


S1 CG.L4-085 5-ID.53 Notes: N/A

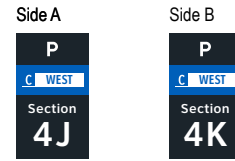


S1 CG.L4-082 5-ID.53 Notes: N/A

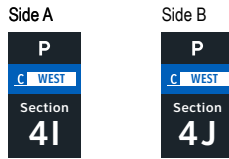


S1 CG.L4-086 5-ID.53 Notes: N/A

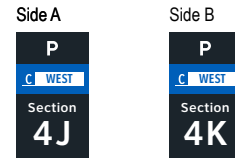


S1 CG.L4-083 5-ID.53 Notes: N/A

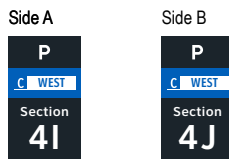

S1 CG.L4-087 5-ID.53 Notes: N/A

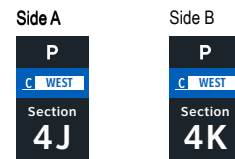








S1 CG.L4-084 5-ID.53 Notes: N/A

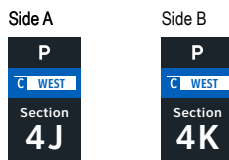


S1 CG.L4-088 N/A Notes: N/A

NOT USED

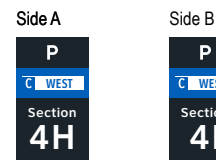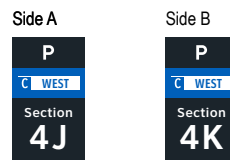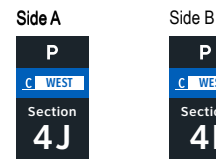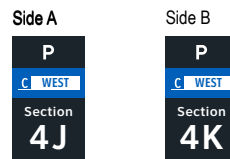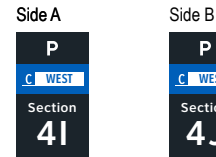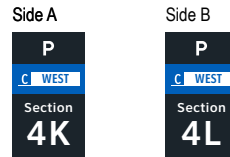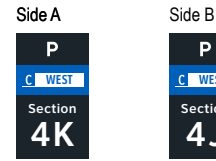
NOT USED




S1 CG.L4-097 5-ID.53 Notes: N/A

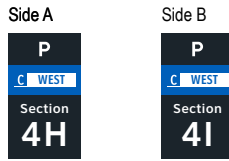


S1 CG.L4-101 5-ID.53 Notes: N/A

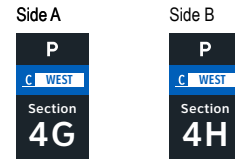


S1 CG.L4-098 5-ID.53 Notes: N/A

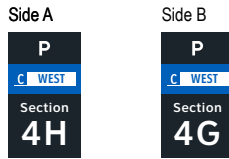


S1 CG.L4-102 5-ID.53 Notes: N/A

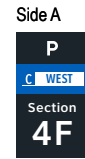


S1 CG.L4-099 5-ID.53 Notes: N/A

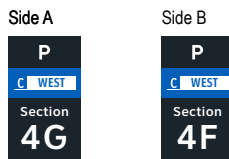


S1 CG.L4-103 5-ID.53 Notes: N/A

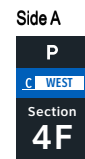


S1 CG.L4-100 5-ID.53 Notes: N/A

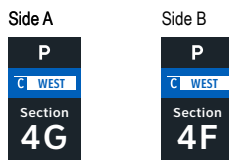


S1 CG.L4-104 5-ID.53 Notes: N/A

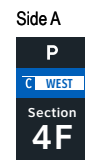


S1 CG.L4-105 5-ID.53 Notes: N/A

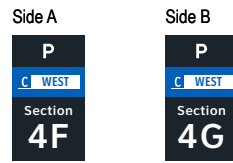


S1 CG.L4-109 5-ID.53 Notes: N/A

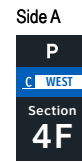


S1 CG.L4-106 5-ID.53 Notes: N/A

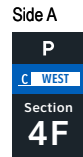

S1 CG.L4-110 5-ID.53 Notes: N/A

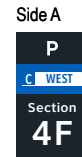


S1 CG.L4-107 5-ID.53 Notes: N/A

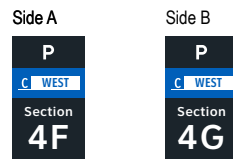


S1 CG.L4-111 N/A Notes: N/A

NOT USED

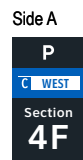S1 CG.L4-108 5-ID.53 Notes: N/A



S1 CG.L4-112 5-ID.53 Notes: N/A

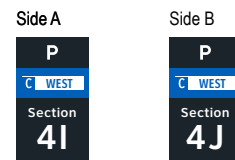

**Wayfinding Updates**

Issue Date: 08-23-2024

**Issue for Bid**

- REV. 
- REV. 
- REV. 

**WARNING:**

This record contains Sensitive Security Information that is controlled under 49 CFR parts 15 and 1520. No part of this record may be disclosed to persons with a "need to know," as defined in 49 CFR parts 15 and 1520, except with the written permission of the Administrator of the Transportation Security Administration or the Secretary of Transportation. Unauthorized release may result in civil penalty or other action. For U.S. government agencies, public disclosure is governed by 5 U.S.C. 552 and 49 CFR parts 15 and 1520.



THESE SHEETS ARE ISSUED FOR GRAPHICAL INFORMATION ONLY

**7.2 MESSAGE SCHEDULE - GARAGE C: LEVEL 4 - SECTOR 1 (C WEST)**

BSG PRJCT# BSG-2024-111-IAH  
HAS TIP # 24 -103 - IAH

S1 CGL4-113 N/A Notes: N/A

NOT USED

S1 CGL4-114 N/A Notes: N/A

NOT USED

S1 CGL4-115 N/A Notes: N/A

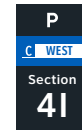
NOT USED

S1 CGL4-116 N/A Notes: N/A


NOT USED

S1 CGL4-117 5-ID.53 Notes: N/A

Side A



Side B

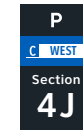

S1 CGL4-118 N/A Notes: N/A

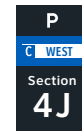
NOT USED

S1 CGL4-119 N/A Notes: N/A


NOT USED

S1 CGL4-120 5-ID.53 Notes: N/A

Side A



Side B

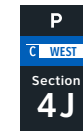

Wayfinding Updates

Issue Date: 08-23-2024

Issue for Bid

- REV. A
REV. B
REV. C

WARNING:

This record contains Sensitive Security Information that is controlled under 49 CFR parts 15 and 1520. No part of this record may be disclosed to persons with a "need to know," as defined in 49 CFR parts 15 and 1520, except with the written permission of the Administrator of the Transportation Security Administration or the Secretary of Transportation. Unauthorized release may result in civil penalty or other action. For U.S. government agencies, public disclosure is governed by 5 U.S.C. 552 and 49 CFR parts 15 and 1520.



08-23-2024

THESE SHEETS ARE ISSUED FOR GRAPHICAL INFORMATION ONLY

7.2 MESSAGE SCHEDULE - GARAGE C: LEVEL 4 - SECTOR 1 (C WEST)

BSG PRJCT# BSG-2024-111-IAH
HAS TIP # 24 -103 - IAH

NOT USED

NOT USED

NOT USED

NOT USED

Side A      Side B

P	P
C WEST	C WEST
Section	Section
4J	4J

NOT USED








NOT USED

Side A      Side B


P	P
C WEST	C WEST
Section	Section
4I	4J



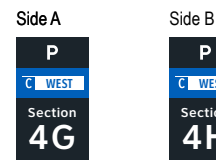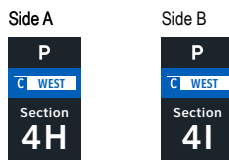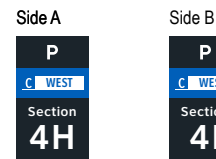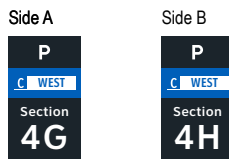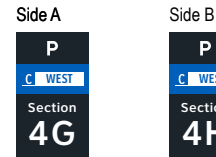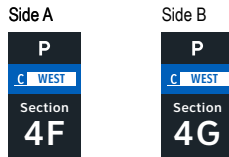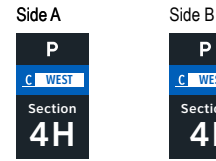
NOT USED




S1 CG.L4-137 5-ID.53 Notes: N/A

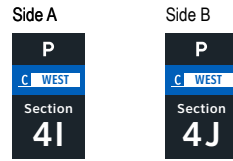


S1 CG.L4-141 5-ID.53 Notes: N/A

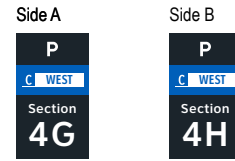


S1 CG.L4-138 5-ID.53 Notes: N/A

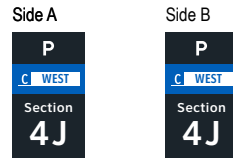


S1 CG.L4-142 5-ID.53 Notes: N/A

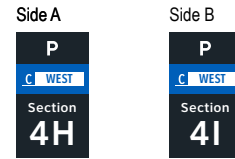


S1 CG.L4-139 5-ID.53 Notes: N/A

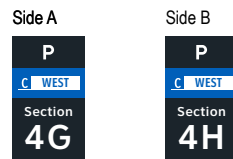


S1 CG.L4-143 5-ID.53 Notes: N/A

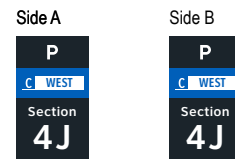


S1 CG.L4-140 5-ID.53 Notes: N/A

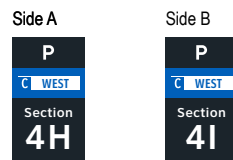

S1 CG.L4-144 5-ID.53 Notes: N/A

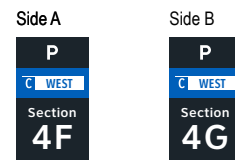


S1 CG.L4-145 5-ID.53 Notes: N/A

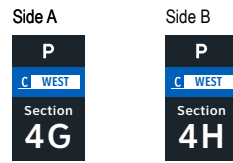


S1 CG.L4-149 5-ID.55 Notes: N/A



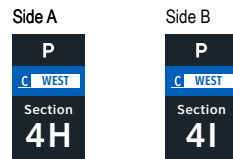S1 CG.L4-146 5-ID.53 Notes: N/A



S1 CG.L4-150 5-ID.55 Notes: N/A

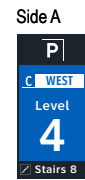

S1 CG.L4-147 5-ID.55 Notes: N/A



ELEVATOR CORE SIGNAGE CONTINUED ON NEXT SHEET

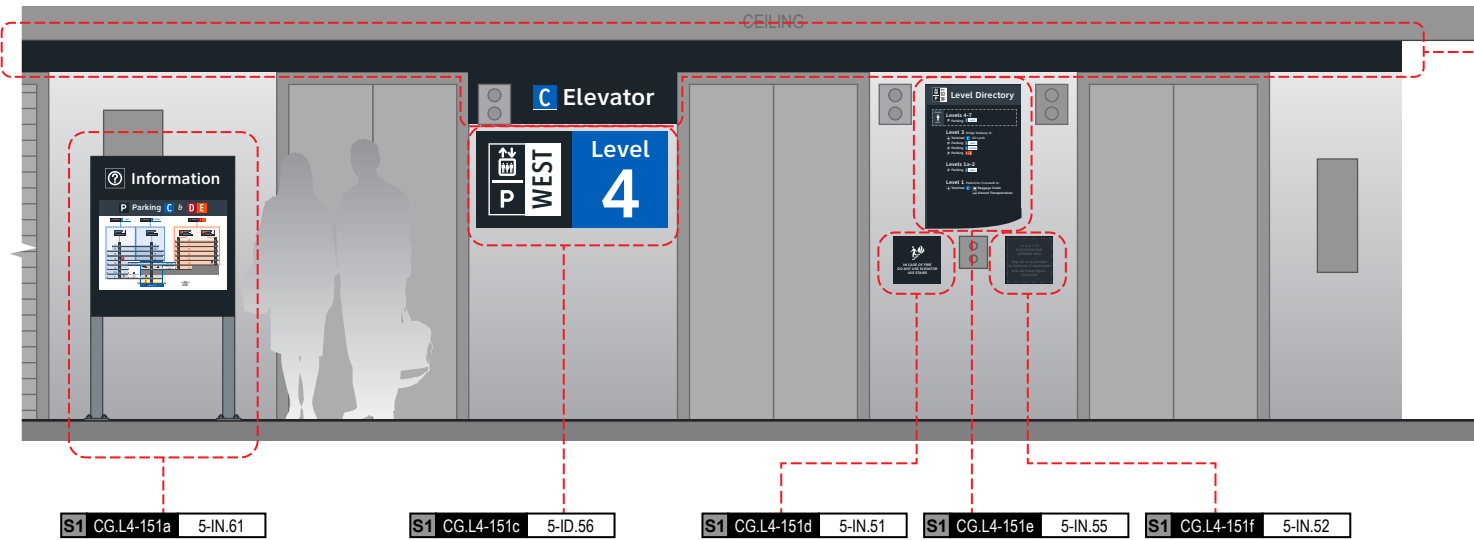
S1 CG.L4-148 5-ID.55 Notes: N/A



S1 CG.L4-151 multiple signs Notes: N/A

C Elevator WEST

Side A



S1 CG.L4-151b 5-ID.57

NOTES: Wall paint and header graphics at front elevation only of elevator core included for this location number; wall elevation conditions shown are artistic representation based on rough site photo surveys; actual wall elevation conditions to be field verified by contractor/installer

S1 CG.L4-151a 5-IN.61

NOTES: Directory artwork includes a "You Are Here" button graphic and is in a unique location per elevator core/level location; artwork included here is representative of final map artwork design intent for this location

S1 CG.L4-151c 5-ID.56

S1 CG.L4-151d 5-IN.51

S1 CG.L4-151e 5-IN.55

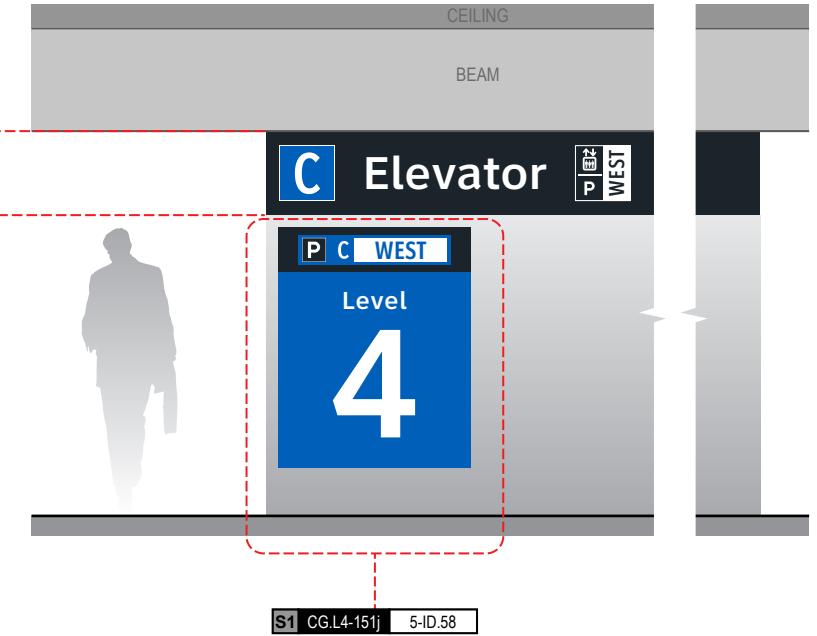
NOTES: Level directory plaque includes a "You Are Here" graphic and is in a unique location per elevator core/level location; artwork included here is representative of final artwork design intent for this location

S1 CG.L4-151f 5-IN.52

S1 CG.L4-151g 5-ID.59


NOTES: Wall paint and header graphics on rear and two side elevations of elevator core included for this location number; wall elevation conditions shown are artistic representation based on rough site photo surveys; actual wall elevation conditions to be field verified by contractor/installer

Side C



S1 CG.L4-151j 5-ID.58

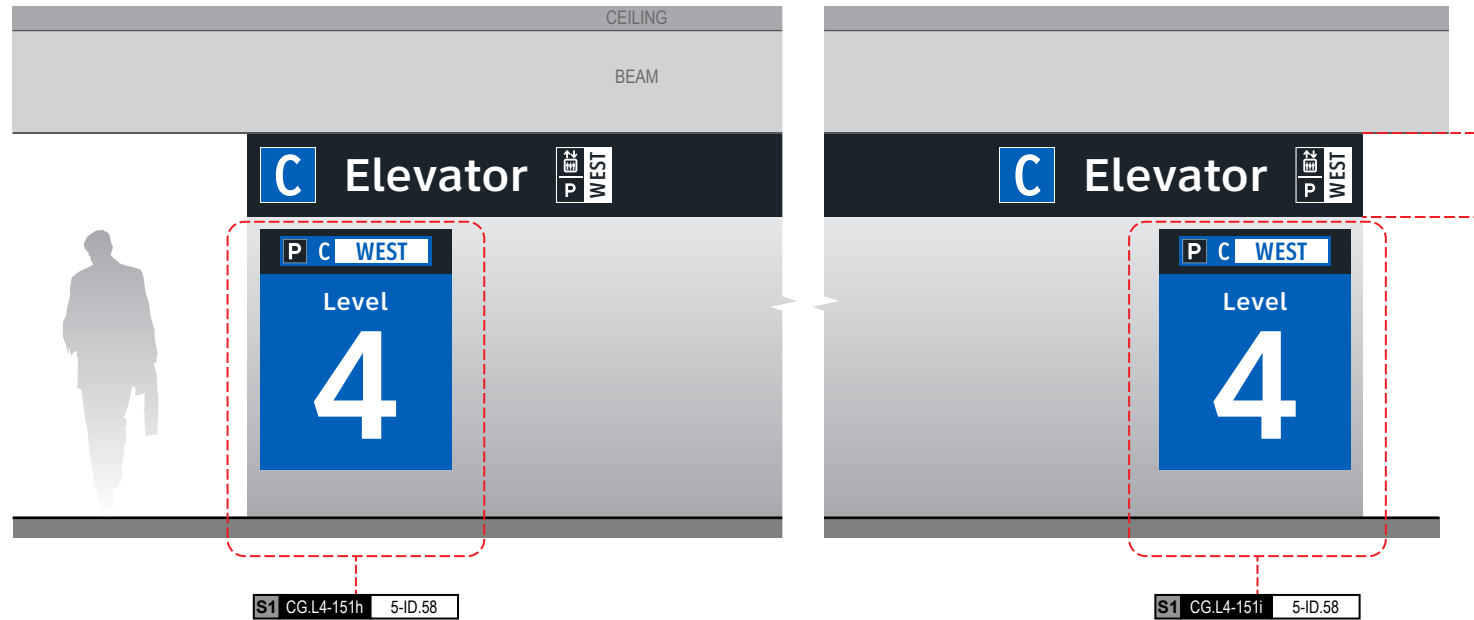
Side B



S1 CG.L4-151h 5-ID.58


S1 CG.L4-151i 5-ID.58

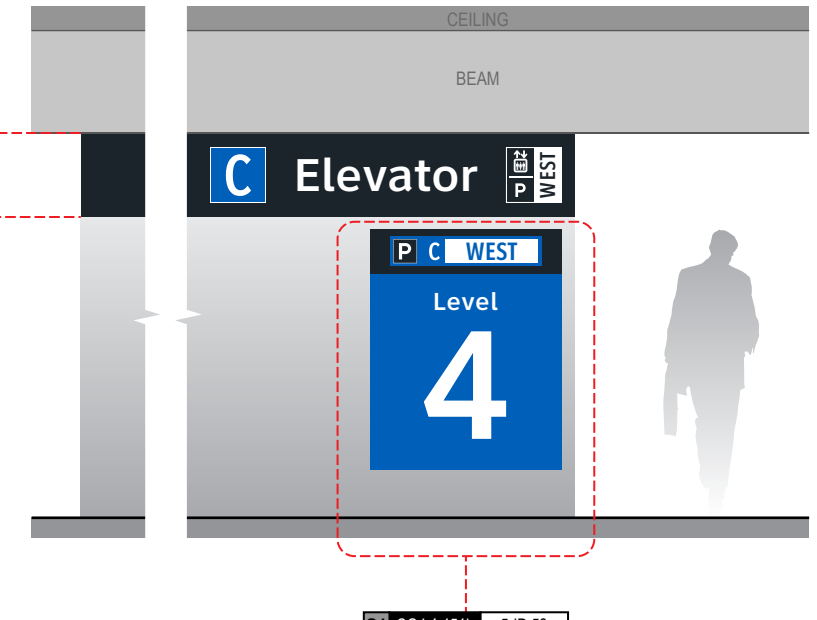Side D



S1 CG.L4-151k 5-ID.58

## END OF PARKING C: LEVEL 4 - SECTOR 1 MESSAGES

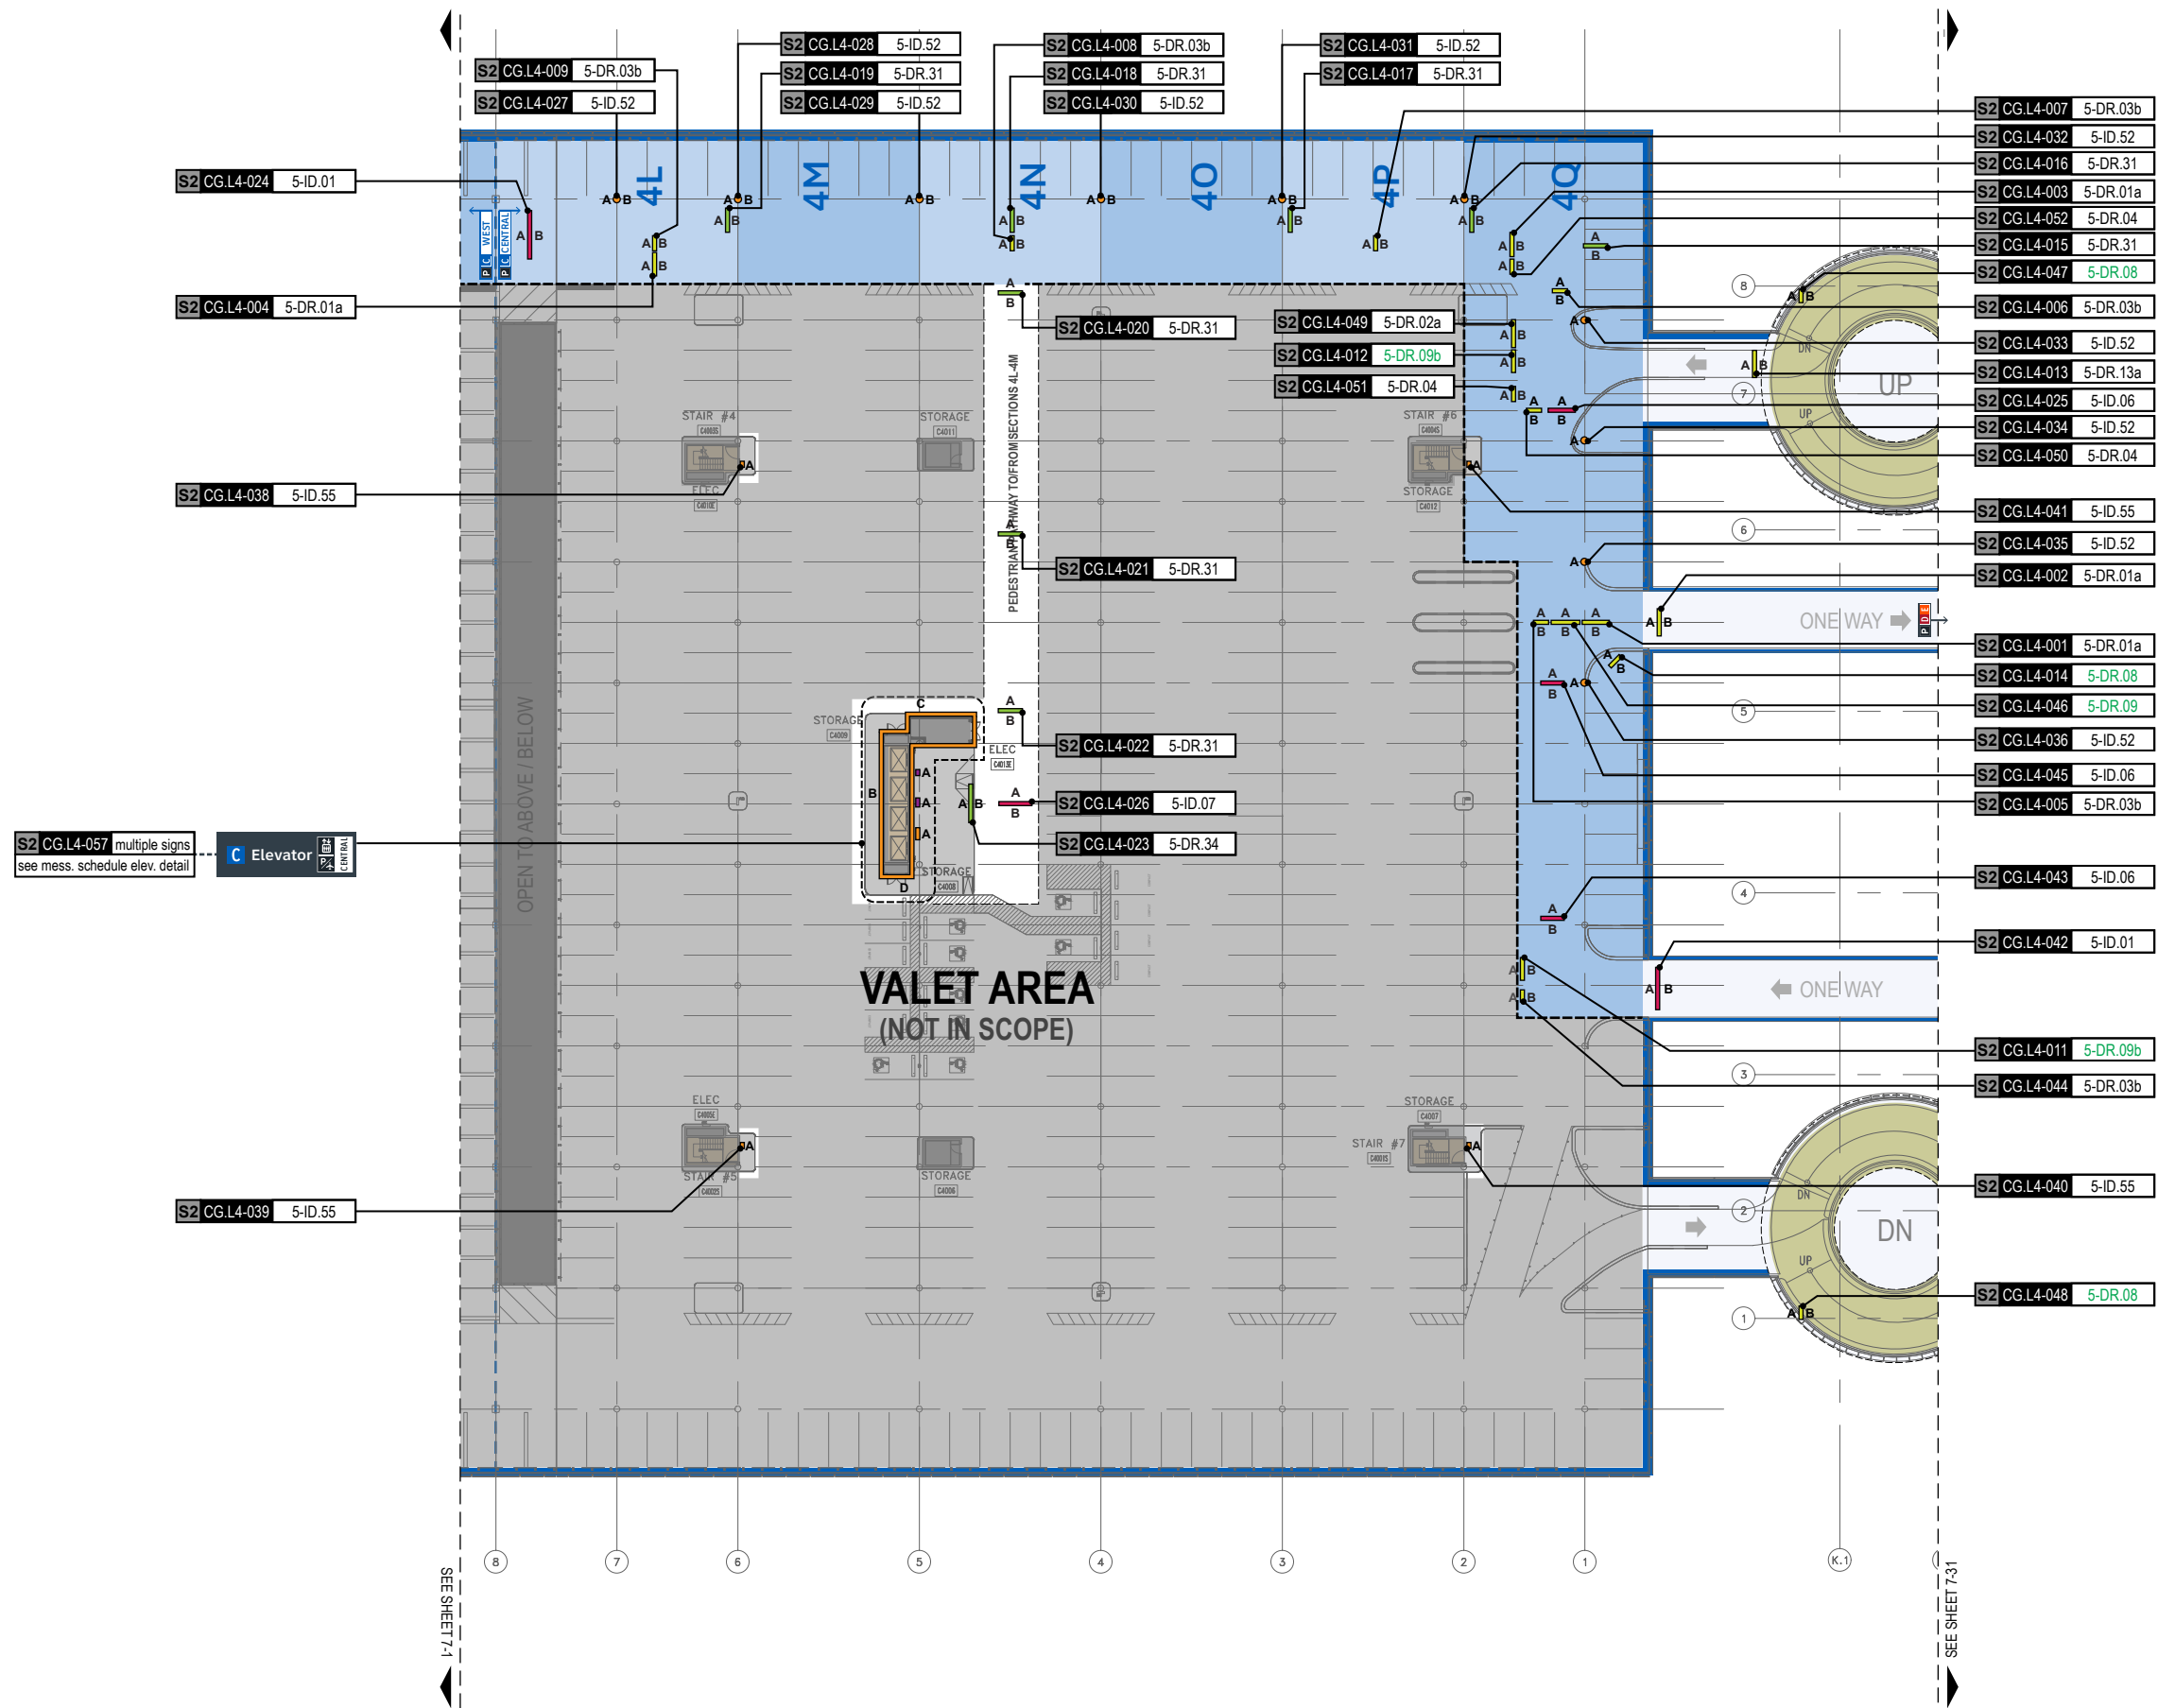


**GENERAL NOTES**

- Sign locations & orientations shown here are approximations based on the most current plan drawings as provided to the designer by the architect at the time of this document's completion. These sign locations are for general design intent & wayfinding planning purposes only. They should not be construed or deemed as absolute or final locations. Field verification, marking & documentation of each final location is to be performed by the Fabricator/Installer & coordinated with project staff & Wayfinding Design Consultants for final approval.
- All final install locations must be marked and verified in the field for proper structural integrity, adequate line of sight, utilities / property-line / other existing signage interferences & must be in complete compliance with all local, state and national codes prior to fabrication or installation.
- Adjustments to the sign locations shown in these drawings must be documented by the Fabricator/Installer, and provided to project staff & Wayfinding Design Consultants for final approval.

**NOTE:** Only priority wayfinding signage & locations as shown in this wayfinding plan package are in scope. All other signage not shown (including traffic control) are NOT IN SCOPE for this project/contract.

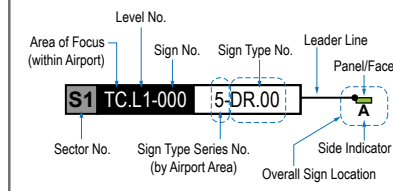
**SIGN LOCATION ANNOTATION LEGEND**




- LOCATION CODE DEFINITIONS:**
- AREA OF FOCUS:** (location within Airport)  
 TA = Terminal A  
 TB = Terminal B  
 TC = Terminal C  
 TD = Terminal D  
 TE = Terminal E  
 AB = AB Garage  
 CG = C Garage  
 DE = DE Garage
- SIGN TYPE SERIES NO.:** (by Airport Area)  
 1- = Terminals/Concourses  
 1t- = Terminals/Concourses: Temporary  
 2- = CBP Areas  
 3- = Curbside/Ground Trans.  
 4- = Roadways  
 5- = Parking
- WAYFINDING SIGN TYPE:**  
 DR.xx = Directional  
 ID.xx = Identification  
 IN.xx = Informational

- WAYFINDING SIGN LOCATIONS - Parking:**
- PEDESTRIAN Signs:**  
 A/B = Directional (DR)  
 A/B = Identification (ID)  
 A/B = Informational (IN)
- VEHICULAR Signs:**  
 A/B = Directional (DR)  
 A/B = Identification (ID)  
 A/B = Informational (IN)
- CIRCULATION:**  
 = Public Use PEDESTRIAN Vertical Circulation (i.e. Elevators/Escalators/Stairs)  
 = Public Use VEHICULAR Vertical Circulation (i.e. Ramps)  
 = Alpha-Numeric Parking Section Naming Areas (Blues = C Garages; Oranges = D/E Garage)  
 = Areas Not In Scope for this Package

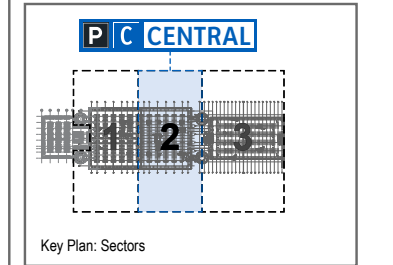
LOCATION PLAN SCALE: 1" = 60'




S2 CG.L4-001 5-DR.01a Notes: N/A

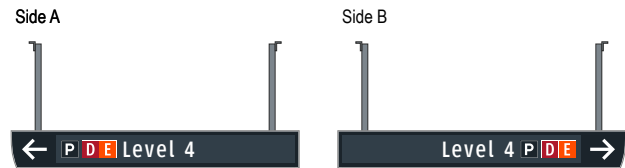


S2 CG.L4-005 5-DR.03b Notes: N/A

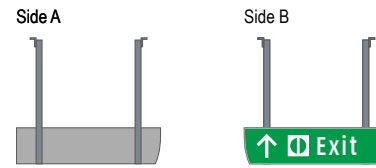


S2 CG.L4-002 5-DR.01a Notes: N/A

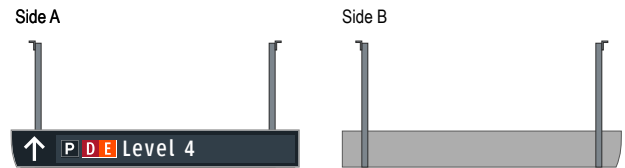


S2 CG.L4-006 5-DR.03b Notes: N/A

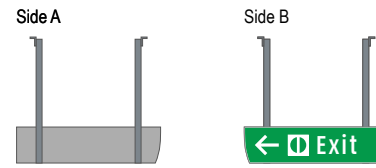


S2 CG.L4-003 5-DR.01a Notes: N/A

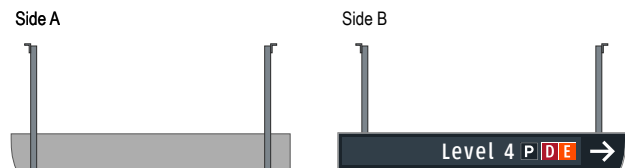


S2 CG.L4-007 5-DR.03b Notes: N/A

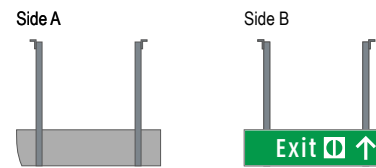

S2 CG.L4-004 5-DR.01a Notes: N/A

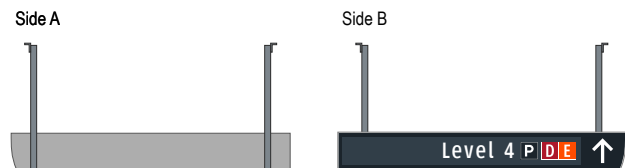

S2 CG.L4-008 5-DR.03b Notes: N/A

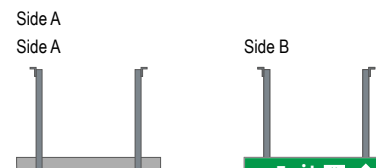

**Wayfinding Updates**

Issue Date: 08-23-2024

**Issue for Bid**

- REV. 
- REV. 
- REV. 

**WARNING:**

This record contains Sensitive Security Information that is controlled under 49 CFR parts 15 and 1520. No part of this record may be disclosed to persons with a "need to know," as defined in 49 CFR parts 15 and 1520, except with the written permission of the Administrator of the Transportation Security Administration or the Secretary of Transportation. Unauthorized release may result in civil penalty or other action. For U.S. government agencies, public disclosure is governed by 5 U.S.C. 552 and 49 CFR parts 15 and 1520.



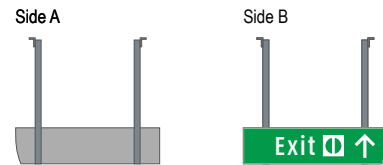
08-23-2024

**7.4 MESSAGE SCHEDULE - GARAGE C: LEVEL 4 - SECTOR 2 (C CENTRAL)**


THESE SHEETS ARE ISSUED FOR GRAPHICAL INFORMATION ONLY

BSG PRJCT# BSG-2024-111-IAH  
 HAS TIP # 24 -103 - IAH


S2 CG.L4-009 5-DR.03b Notes: N/A



S2 CG.L4-013 5-DR.13a Notes: N/A

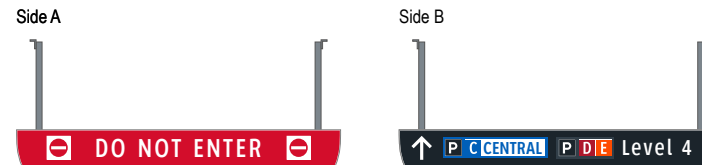


S2 CG.L4-010 5-DR.09a Notes: N/A

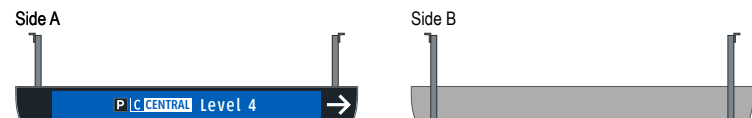


S2 CG.L4-014 5-DR.08 Notes: N/A



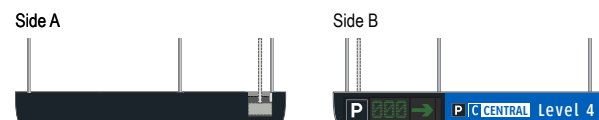
S2 CG.L4-011 5-DR.09b Notes: N/A




S2 CG.L4-015 5-DR.31 Notes: N/A

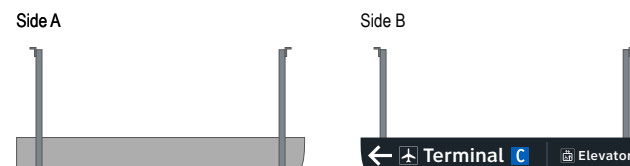


S2 CG.L4-012 5-DR.09b Notes: N/A

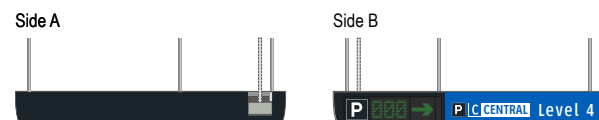


S2 CG.L4-016 5-DR.31 Notes: N/A

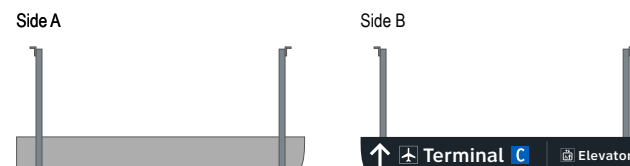


S2 CG.L4-017 5-DR.31 Notes: N/A

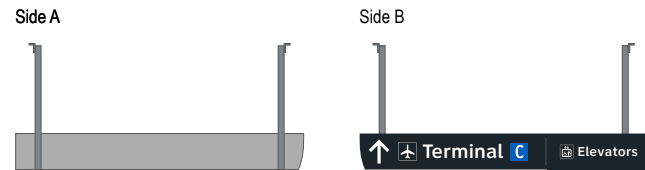


S2 CG.L4-021 5-DR.31 Notes: N/A

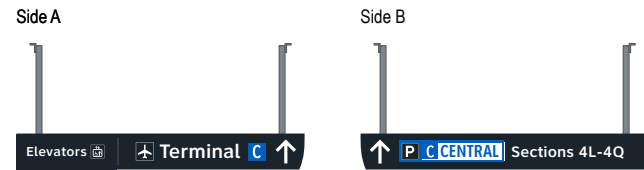


S2 CG.L4-018 5-DR.31 Notes: N/A

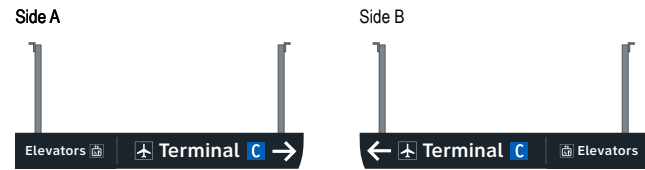


S2 CG.L4-022 5-DR.31 Notes: N/A

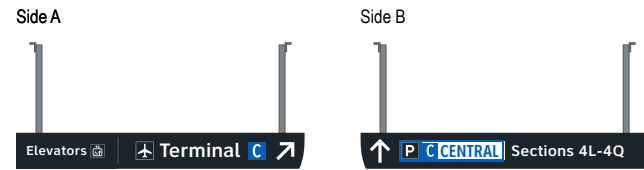


S2 CG.L4-019 5-DR.31 Notes: N/A

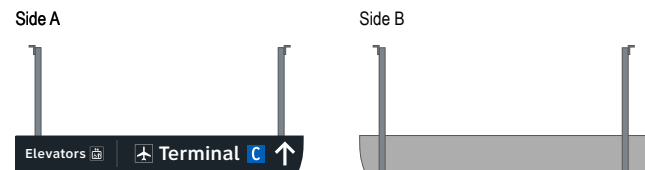


S2 CG.L4-023 5-DR.34 Notes: N/A

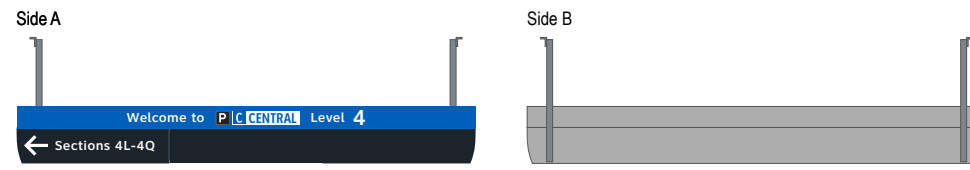

S2 CG.L4-020 5-DR.31 Notes: N/A

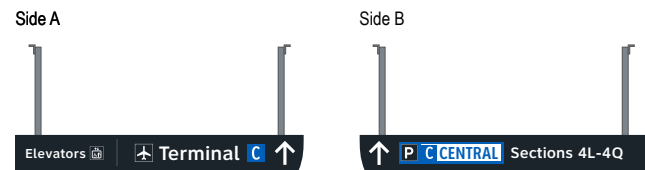

S2 CG.L4-024 5-ID.01 Notes: N/A

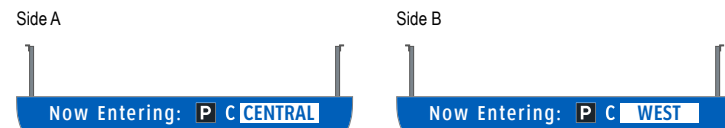

**Wayfinding Updates**

Issue Date: 08-23-2024

Issue for Bid

- REV. 
- REV. 
- REV. 

**WARNING:**

This record contains Sensitive Security Information that is controlled under 49 CFR parts 15 and 1520. No part of this record may be disclosed to persons with a "need to know," as defined in 49 CFR parts 15 and 1520, except with the written permission of the Administrator of the Transportation Security Administration or the Secretary of Transportation. Unauthorized release may result in civil penalty or other action. For U.S. government agencies, public disclosure is governed by 5 U.S.C. 552 and 49 CFR parts 15 and 1520.



08-23-2024

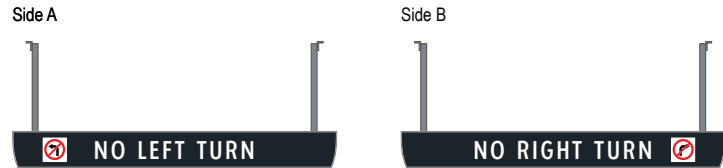
**7.4 MESSAGE SCHEDULE - GARAGE C: LEVEL 4 - SECTOR 2 (C CENTRAL)**

THESE SHEETS ARE ISSUED FOR GRAPHICAL INFORMATION ONLY


BSG PRJCT# BSG-2024-111-IAH  
 HAS TIP # 24 -103 - IAH




S2 CG.L4-025 5-ID.06 Notes: N/A




S2 CG.L4-029 5-ID.52 Notes: N/A

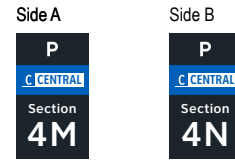


S2 CG.L4-026 5-ID.07 Notes: N/A

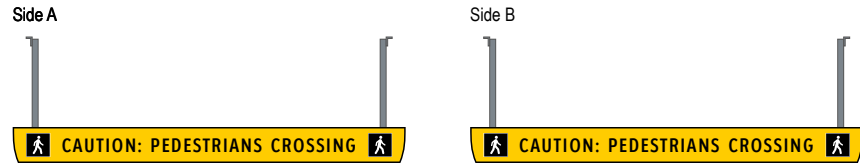


S2 CG.L4-030 5-ID.52 Notes: N/A

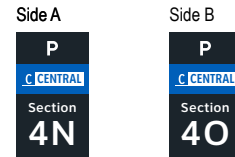


S2 CG.L4-027 5-ID.52 Notes: N/A

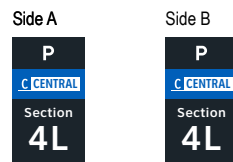


S2 CG.L4-031 5-ID.52 Notes: N/A

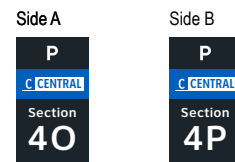

S2 CG.L4-028 5-ID.52 Notes: N/A

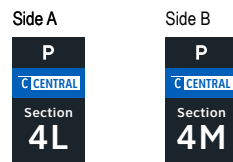


S2 CG.L4-032 5-ID.52 Notes: N/A

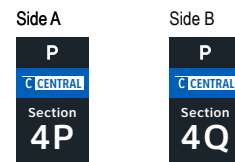

S2 CG.L4-033 5-ID.52 Notes: N/A

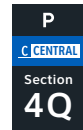Side A




S2 CG.L4-037 5-ID.52 Notes: N/A

Side A



S2 CG.L4-034 5-ID.52 Notes: N/A

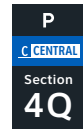Side A




S2 CG.L4-038 5-ID.55 Notes: N/A

Side A



S2 CG.L4-035 5-ID.52 Notes: N/A

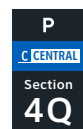Side A




S2 CG.L4-039 5-ID.55 Notes: N/A

Side A



S2 CG.L4-036 5-ID.52 Notes: N/A

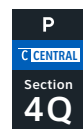Side A



S2 CG.L4-040 5-ID.55 Notes: N/A

Side A



GEORGE BUSH INTERCONTINENTAL AIRPORT  
Wayfinding Signage Design Intent Documents  
C Garage



Louisville, Colorado  
P: 303.494.7849  
www.labozan.com

These documents are intended to illustrate design intent, and should only be used as a general guideline. No information contained here should be construed as engineered elements. The fabricator/contractor shall be responsible for all engineering and specifications with regard to structural, electrical, mechanical, foundation and installation. Information and illustrations contained here are part of an original unpublished design by Labozan Associates, Inc. Detailing and information contained on these pages shall not be reproduced, copied or utilized in any way except for the specific project for which they were created without previous written authorization from Labozan Associates, Inc.

© 2024 by Labozan Associates, Inc.

Wayfinding Updates

Issue Date: 08-23-2024  
Issue for Bid

- REV.
- REV.
- REV.

WARNING:

This record contains Sensitive Security Information that is controlled under 49 CFR parts 15 and 1520. No part of this record may be disclosed to persons with a "need to know," as defined in 49 CFR parts 15 and 1520, except with the written permission of the Administrator of the Transportation Security Administration or the Secretary of Transportation. Unauthorized release may result in civil penalty or other action. For U.S. government agencies, public disclosure is governed by 5 U.S.C. 552 and 49 CFR parts 15 and 1520.



08-23-2024

7.4 MESSAGE SCHEDULE - GARAGE C: LEVEL 4 - SECTOR 2 (C CENTRAL)

THESE SHEETS ARE ISSUED FOR GRAPHICAL INFORMATION ONLY

BSG PRJCT# BSG-2024-111-IAH  
HAS TIP # 24 -103 - IAH

S2 CG.L4-041 5-ID.55 Notes: N/A

Side A



S2 CG.L4-045 5-ID.06 Notes: N/A

Side A



Side B



S2 CG.L4-042 5-ID.01 Notes: N/A

Side A

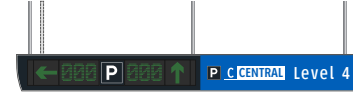


Side B



S2 CG.L4-046 5-DR.09 Notes: N/A

Side A



Side B



S2 CG.L4-043 5-ID.06 Notes: N/A

Side A



Side B

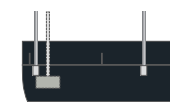


S2 CG.L4-047 5-DR.08 Notes: N/A

Side A




Side B




S2 CG.L4-044 5-DR.03b Notes: N/A

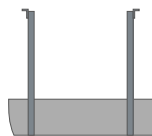Side A



Side B

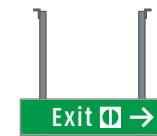

S2 CG.L4-048 5-DR.08 Notes: N/A

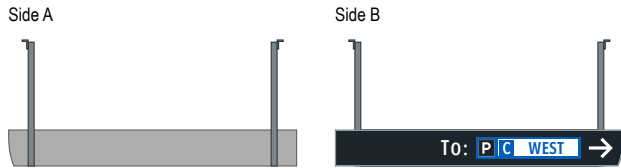
Side A



Side B




S2 CG.L4-049 5-DR.02a Notes: N/A



S2 CG.L4-053 N/A Notes: N/A

NOT USED

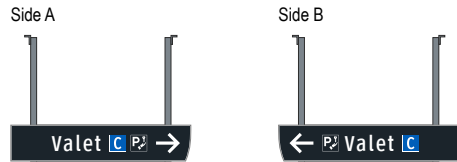
S2 CG.L4-050 5-DR.04 Notes: N/A



S2 CG.L4-054 N/A Notes: N/A

NOT USED

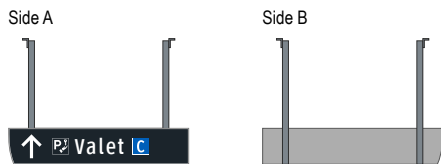
S2 CG.L4-051 5-DR.04 Notes: N/A



S2 CG.L4-055 N/A Notes: N/A

NOT USED

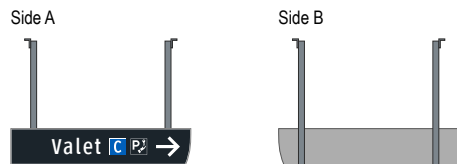S2 CG.L4-052 5-DR.04 Notes: N/A



S2 CG.L4-056 N/A Notes: N/A

NOT USED

ELEVATOR CORE SIGNAGE CONTINUED ON NEXT SHEET

**Wayfinding Updates**

Issue Date: 08-23-2024

**Issue for Bid**

- REV. 
- REV. 
- REV. 

**WARNING:**

This record contains Sensitive Security Information that is controlled under 49 CFR parts 15 and 1520. No part of this record may be disclosed to persons with a "need to know," as defined in 49 CFR parts 15 and 1520, except with the written permission of the Administrator of the Transportation Security Administration or the Secretary of Transportation. Unauthorized release may result in civil penalty or other action. For U.S. government agencies, public disclosure is governed by 5 U.S.C. 552 and 49 CFR parts 15 and 1520.



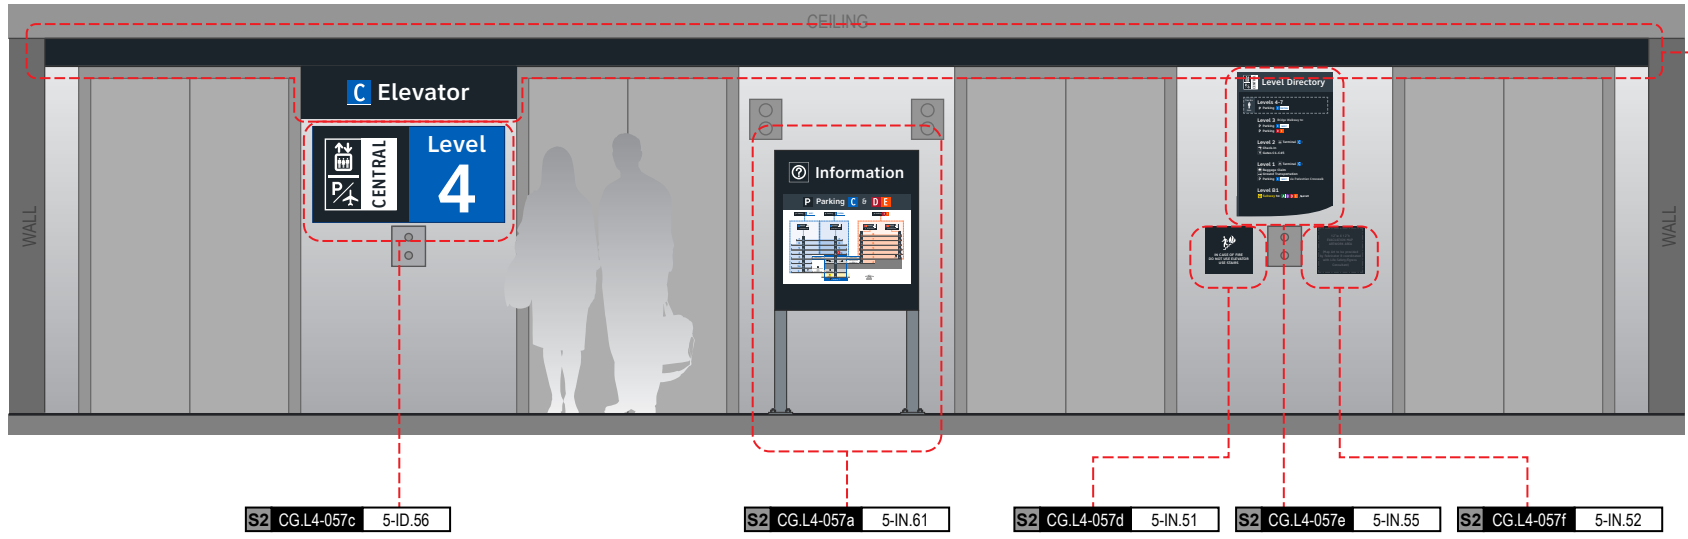
08-23-2024

**7.4 MESSAGE SCHEDULE - GARAGE C: LEVEL 4 - SECTOR 2 (C CENTRAL)**

THESE SHEETS ARE ISSUED FOR GRAPHICAL INFORMATION ONLY

BSG PRJCT# BSG-2024-111-IAH  
 HAS TIP # 24 -103 - IAH

Side A



S2 CG.L4-057c 5-ID.56

S2 CG.L4-057a 5-IN.61

S2 CG.L4-057d 5-IN.51

S2 CG.L4-057e 5-IN.55

S2 CG.L4-057f 5-IN.52

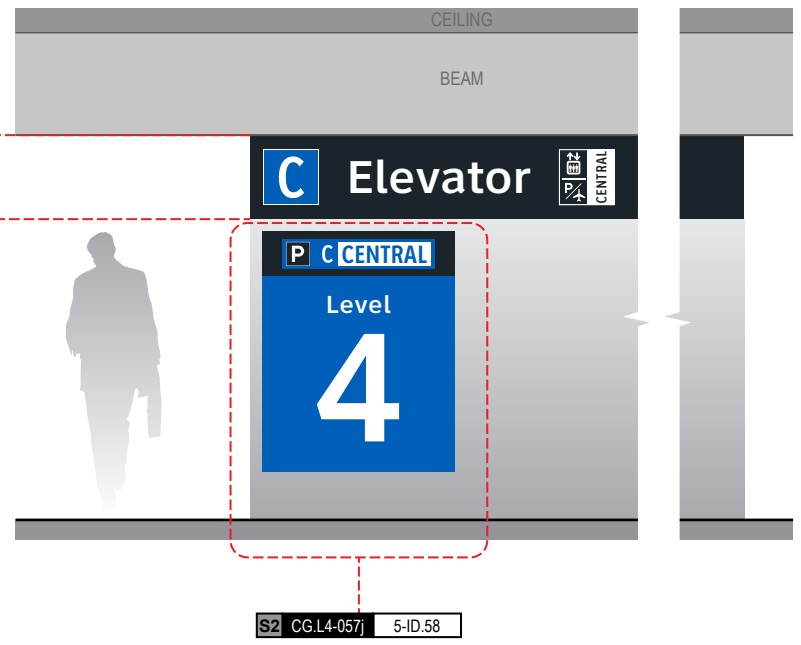
NOTES: Directory artwork includes a "You Are Here" button graphic and is in a unique location per elevator core/level location; artwork included here is representative of final map artwork design intent for this location

NOTES: Level directory plaque includes a "You Are Here" graphic and is in a unique location per elevator core/level location; artwork included here is representative of final artwork design intent for this location

S2 CG.L4-057b 5-ID.57


NOTES: Wall paint and header graphics at front elevation only of elevator core included for this location number; wall elevation conditions shown are artistic representation based on rough site photo surveys; actual wall elevation conditions to be field verified by contractor/installer

Side C



S2 CG.L4-057j 5-ID.58

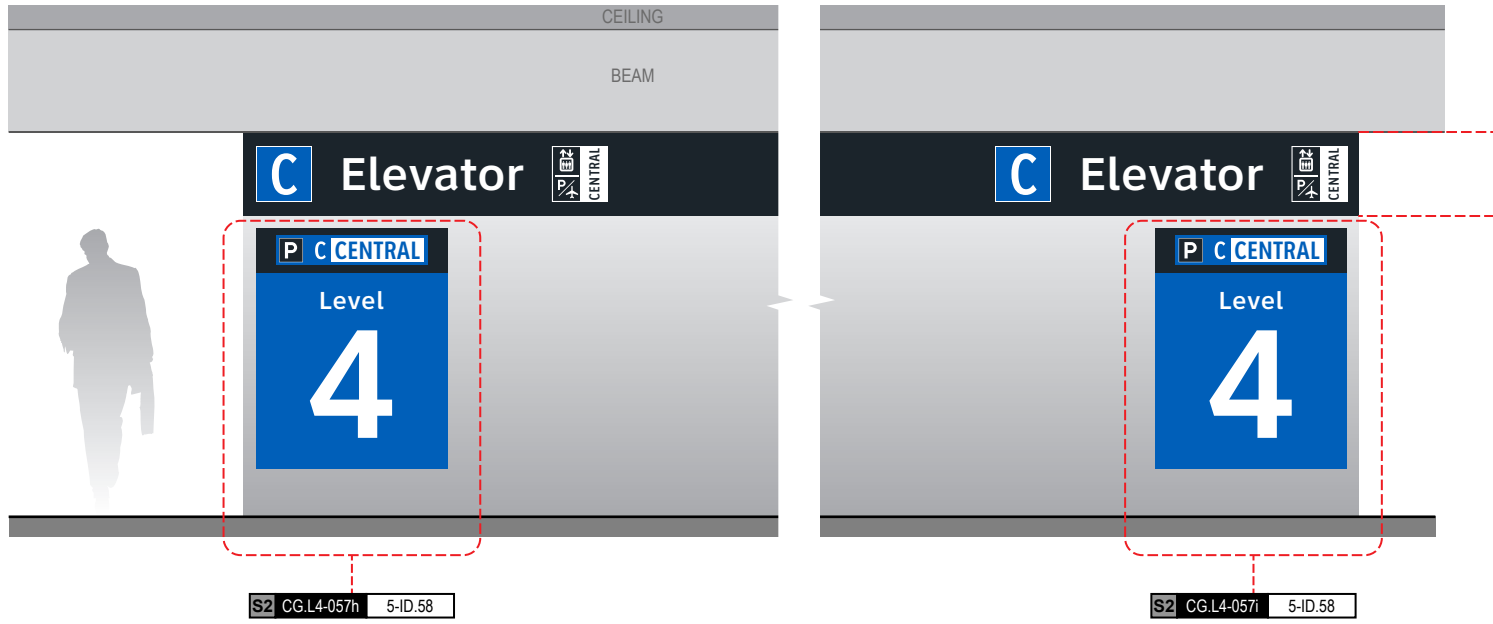
Side B



S2 CG.L4-057h 5-ID.58

S2 CG.L4-057i 5-ID.58

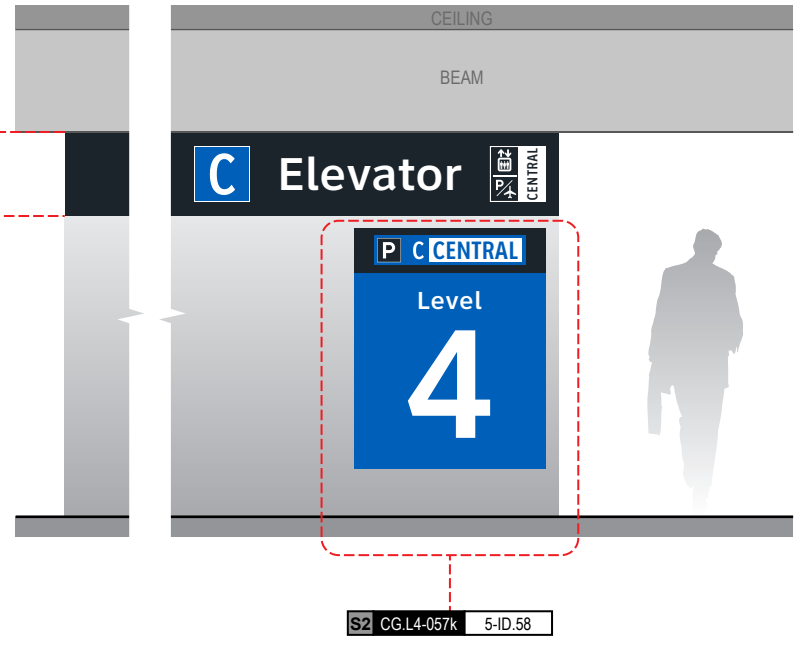Side D



S2 CG.L4-057k 5-ID.58

S2 CG.L4-057g 5-ID.59

NOTES: Wall paint and header graphics on rear and two side elevations of elevator core included for this location number; wall elevation conditions shown are artistic representation based on rough site photo surveys; actual wall elevation conditions to be field verified by contractor/installer


### END OF GARAGE C: LEVEL 4 - SECTOR 2 MESSAGES

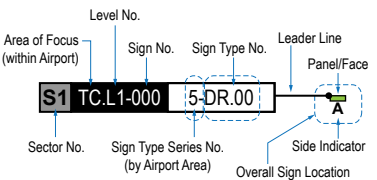**GENERAL NOTES**

- Sign locations & orientations shown here are approximations based on the most current plan drawings as provided to the designer by the architect at the time of this document's completion. These sign locations are for general design intent & wayfinding planning purposes only. They should not be construed or deemed as absolute or final locations. Field verification, marking & documentation of each final location is to be performed by the Fabricator/Installer & coordinated with project staff & Wayfinding Design Consultants for final approval.
- All final install locations must be marked and verified in the field for proper structural integrity, adequate line of sight, utilities / property-line / other existing signage interferences & must be in complete compliance with all local, state and national codes prior to fabrication or installation.
- Adjustments to the sign locations shown in these drawings must be documented by the Fabricator/Installer, and provided to project staff & Wayfinding Design Consultants for final approval.

**NOTE:** Only priority wayfinding signage & locations as shown in this wayfinding plan package are in scope. All other signage not shown (including traffic control) are NOT IN SCOPE for this project/contract.

**SIGN LOCATION ANNOTATION LEGEND**



**LOCATION CODE DEFINITIONS:**

- AREA OF FOCUS:** (location within Airport)  
 TA = Terminal A  
 TB = Terminal B  
 TC = Terminal C  
 TD = Terminal D  
 TE = Terminal E  
 AB = AB Garage  
 CG = C Garage  
 DE = DE Garage
- SIGN TYPE SERIES NO.:** (by Airport Area)  
 1- = Terminals/Concourses  
 1t- = Terminals/Concourses: Temporary  
 2- = CBP Areas  
 3- = Curbside/Ground Trans.  
 4- = Roadways  
 5- = Parking
- WAYFINDING SIGN TYPE:**  
 DR.xx = Directional  
 ID.xx = Identification  
 IN.xx = Informational

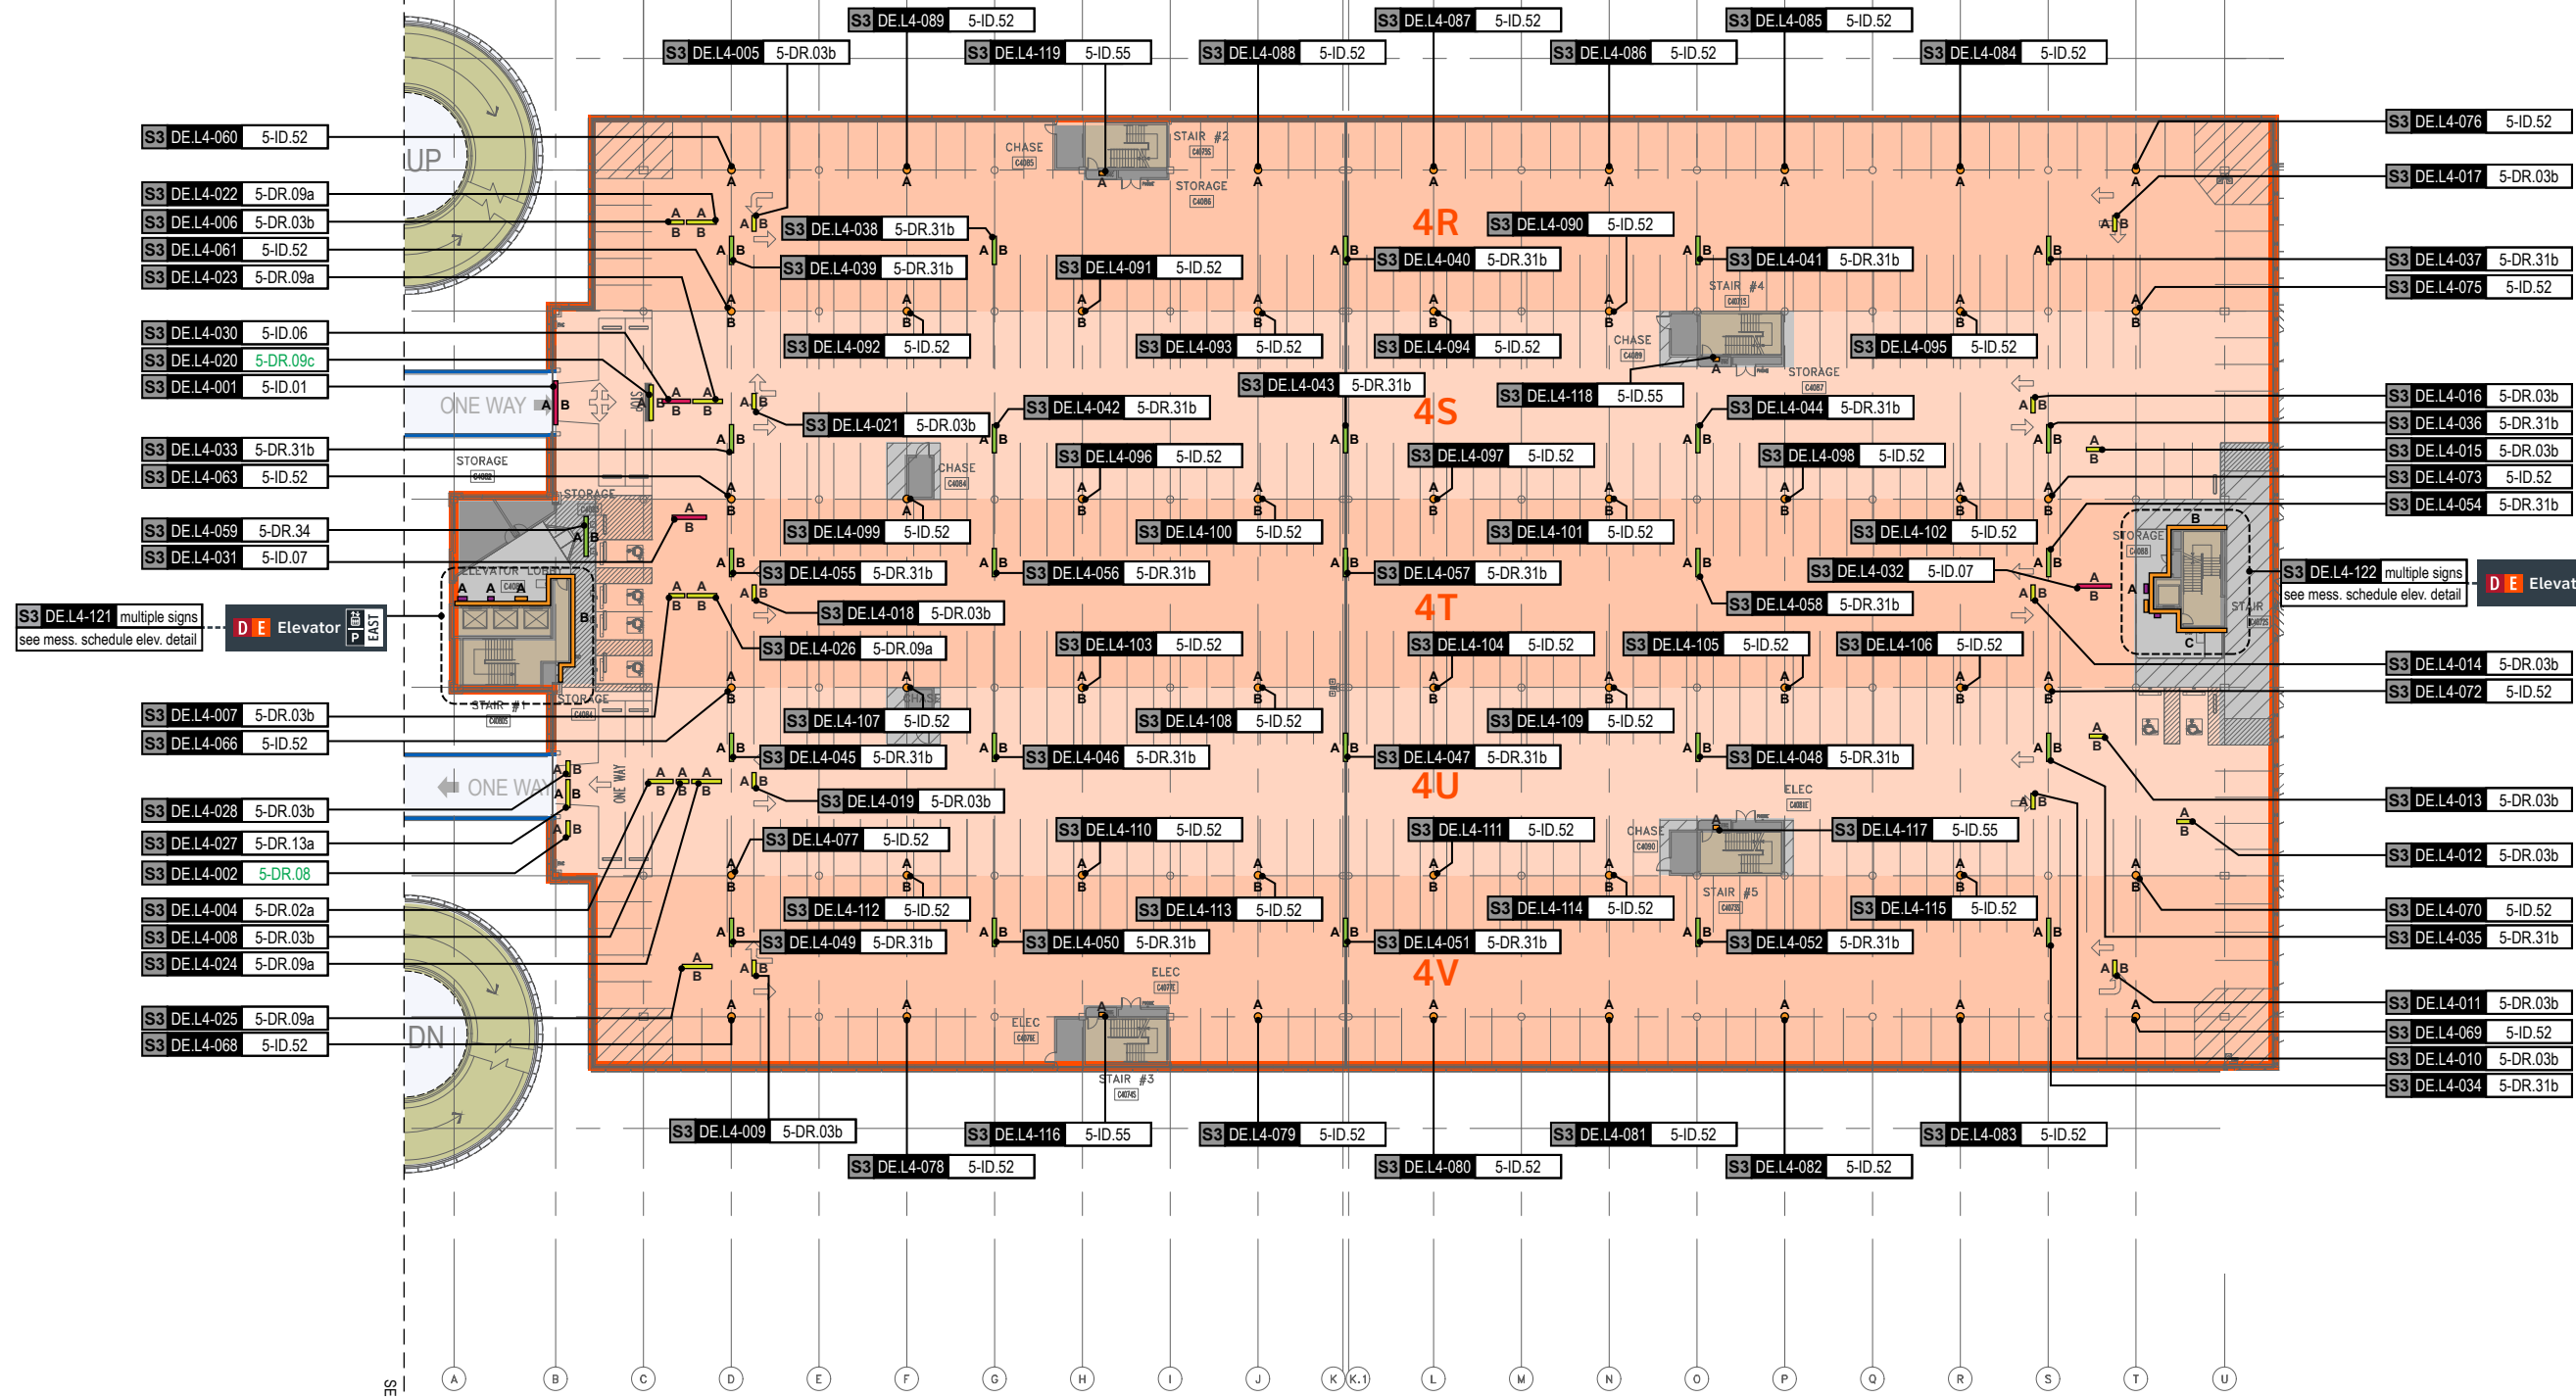
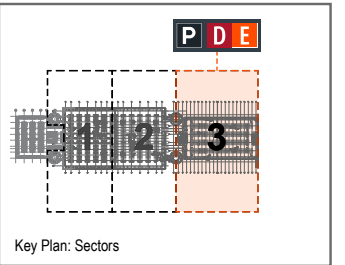
**WAYFINDING SIGN LOCATIONS - Parking:**

- PEDESTRIAN Signs:**  
 A = Directional (DR)  
 B = Identification (ID)  
 AB = Informational (IN)
- VEHICULAR Signs:**  
 A = Directional (DR)  
 B = Identification (ID)  
 AB = Informational (IN)


**CIRCULATION:**

- Public Use PEDESTRIAN Vertical Circulation (i.e. Elevators/Escalators/Stairs)
- Public Use VEHICULAR Vertical Circulation (i.e. Ramps)
- Alpha-Numeric Parking Section Naming Areas (Blues = C Garages; Oranges = D/E Garage)
- Areas Not In Scope for this Package

LOCATION PLAN SCALE: 1" = 60'




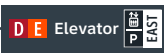S3 DE.L4-121 multiple signs see mess. schedule elev. detail




THESE SHEETS ARE ISSUED FOR GRAPHICAL INFORMATION ONLY  
08-23-2024

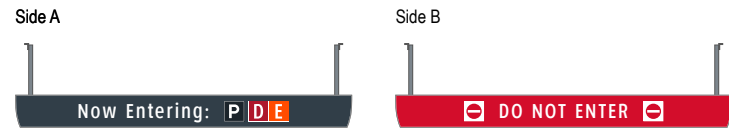
S3 DE.L4-001 5-ID.01 Notes: N/A




S3 DE.L4-005 5-DR.03b Notes: N/A

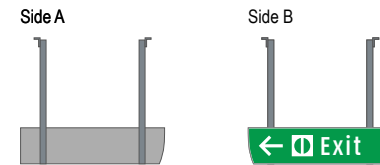

S3 DE.L4-002 5-DR.08 Notes: N/A

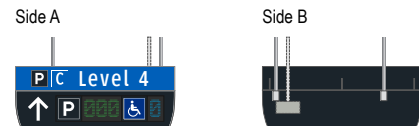


S3 DE.L4-006 5-DR.03b Notes: N/A

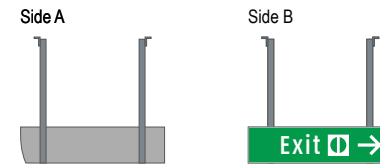


S3 DE.L4-003 N/A Notes: N/A

NOT USED

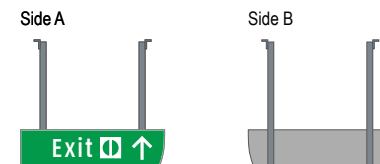
S3 DE.L4-007 5-DR.03b Notes: N/A




S3 DE.L4-004 5-DR.02a Notes: N/A

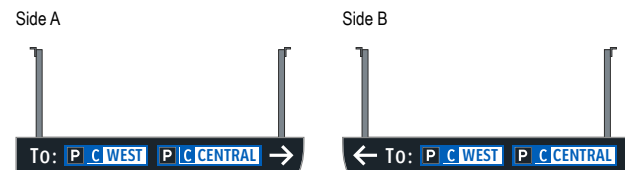


S3 DE.L4-008 5-DR.03b Notes: N/A

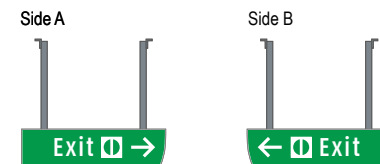


S3 DE.L4-009 5-DR.03b Notes: N/A

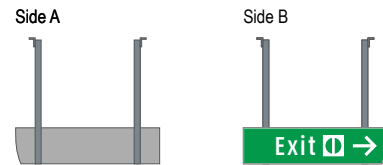


S3 DE.L4-013 5-DR.03b Notes: N/A

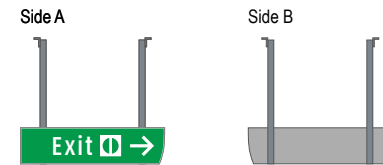


S3 DE.L4-010 5-DR.03b Notes: N/A

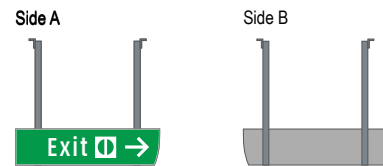


S3 DE.L4-014 5-DR.03b Notes: N/A

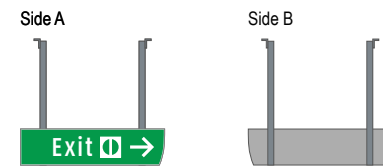


S3 DE.L4-011 5-DR.03b Notes: N/A

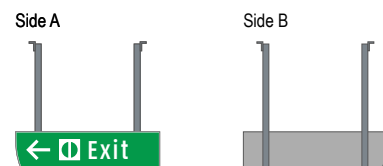


S3 DE.L4-015 5-DR.03b Notes: N/A

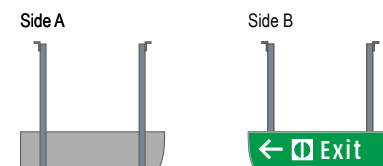

S3 DE.L4-012 5-DR.03b Notes: N/A

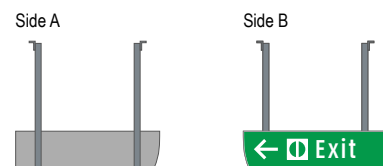


S3 DE.L4-016 5-DR.03b Notes: N/A

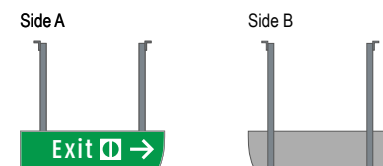





S3 DE.L4-017 5-DR.03b Notes: N/A

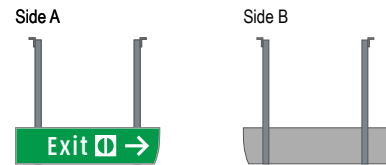


S3 DE.L4-021 5-DR.03b Notes: N/A

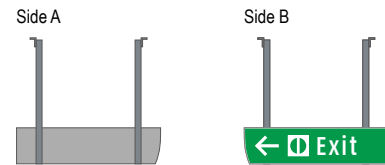


S3 DE.L4-018 5-DR.03b Notes: N/A

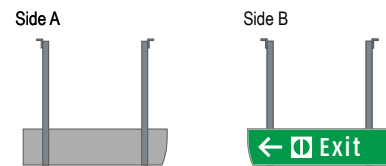


S3 DE.L4-022 5-DR.09a Notes: N/A

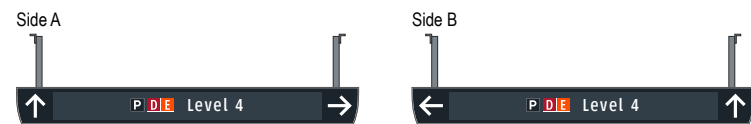


S3 DE.L4-019 5-DR.03b Notes: N/A

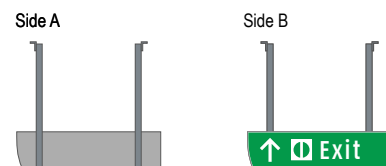


S3 DE.L4-023 5-DR.09a Notes: N/A

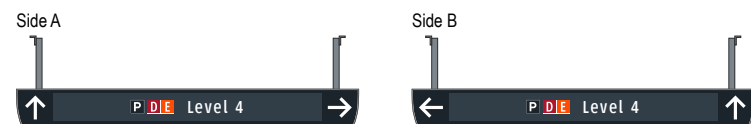


S3 DE.L4-020 5-DR.09c Notes: N/A

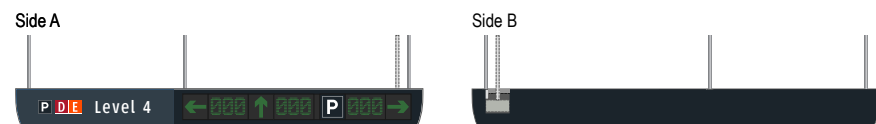

S3 DE.L4-024 5-DR.09a Notes: N/A

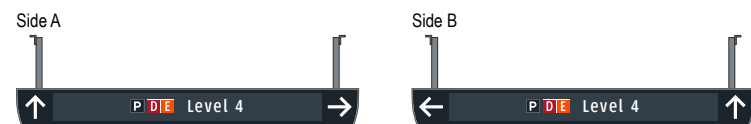


S3 DE.L4-025 5-DR.09a Notes: N/A

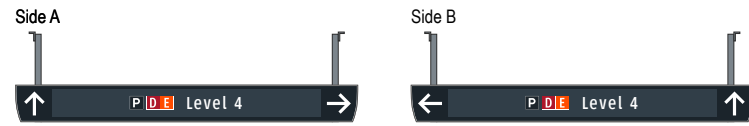


S3 DE.L4-029 N/A Notes: N/A

NOT USED

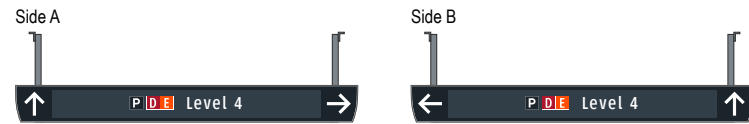
S3 DE.L4-026 5-DR.09a Notes: N/A




S3 DE.L4-030 5-ID.06 Notes: N/A

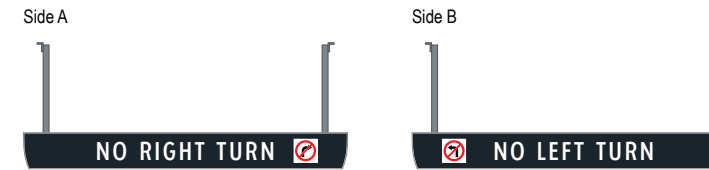


S3 DE.L4-027 5-DR.13a Notes: N/A

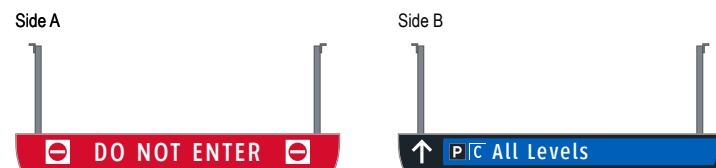


S3 DE.L4-031 5-ID.07 Notes: N/A

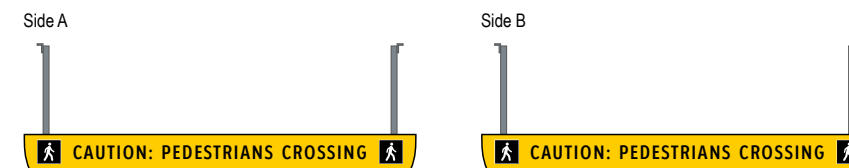


S3 DE.L4-028 5-DR.03b Notes: N/A

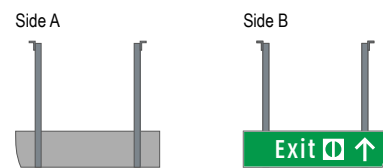


S3 DE.L4-032 5-ID.07 Notes: N/A

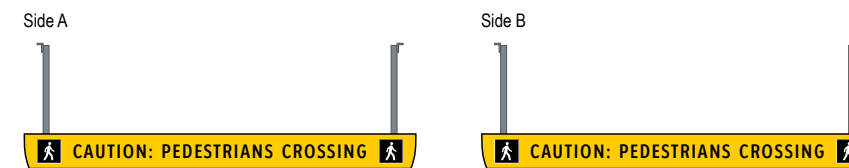


S3 DE.L4-033 5-DR.31b Notes: N/A

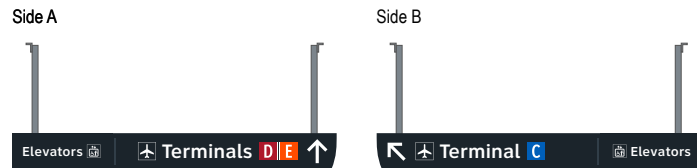


S3 DE.L4-037 5-DR.31b Notes: N/A

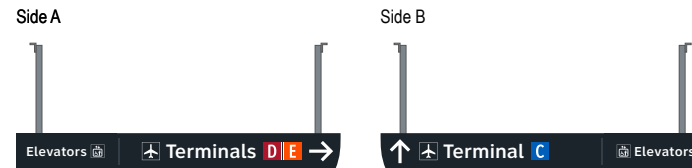


S3 DE.L4-034 5-DR.31b Notes: N/A

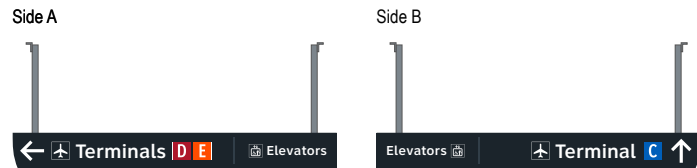


S3 DE.L4-038 5-DR.31b Notes: N/A

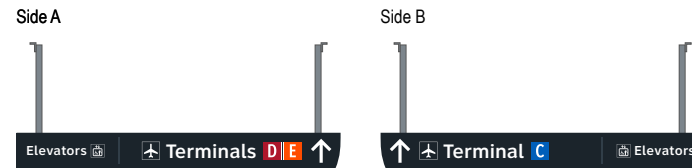


S3 DE.L4-035 5-DR.31b Notes: N/A

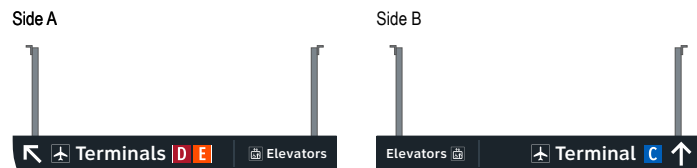


S3 DE.L4-039 5-DR.31b Notes: N/A

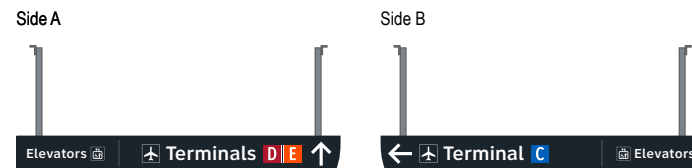

S3 DE.L4-036 5-DR.31b Notes: N/A

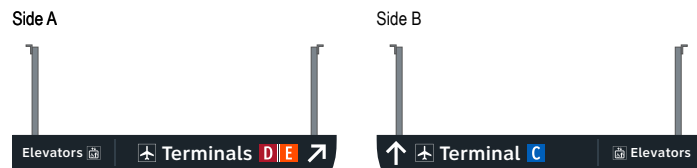

S3 DE.L4-040 5-DR.31b Notes: N/A

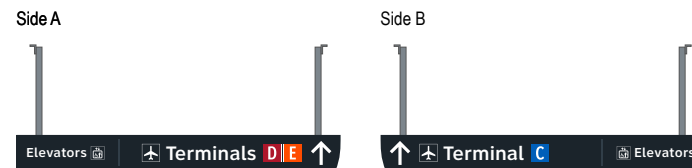

**Wayfinding Updates**

Issue Date: 08-23-2024

**Issue for Bid**

- REV. ⚠
- REV. ⚠
- REV. ⚠

**WARNING:**

This record contains Sensitive Security Information that is controlled under 49 CFR parts 15 and 1520. No part of this record may be disclosed to persons with a "need to know," as defined in 49 CFR parts 15 and 1520, except with the written permission of the Administrator of the Transportation Security Administration or the Secretary of Transportation. Unauthorized release may result in civil penalty or other action. For U.S. government agencies, public disclosure is governed by 5 U.S.C. 552 and 49 CFR parts 15 and 1520.

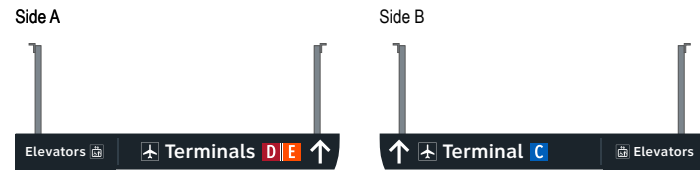


THESE SHEETS ARE ISSUED FOR GRAPHICAL INFORMATION ONLY


**7.6 MESSAGE SCHEDULE - GARAGE D/E: LEVEL 4 - SECTOR 3 (D/E)**

BSG PRJCT# BSG-2024-111-IAH  
 HAS TIP # 24 -103 - IAH


S3 DE.L4-041 5-DR.31b Notes: N/A




S3 DE.L4-045 5-DR.31b Notes: N/A

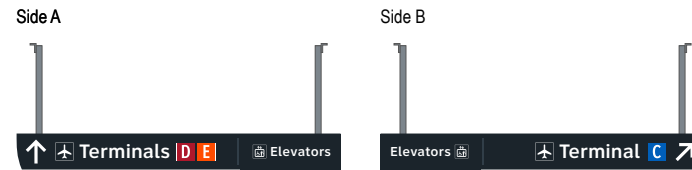


S3 DE.L4-042 5-DR.31b Notes: N/A

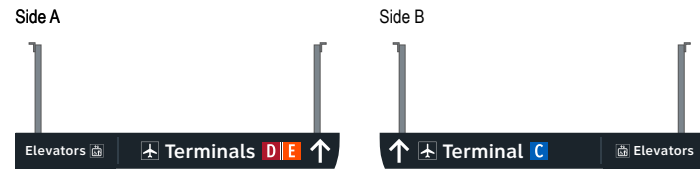


S3 DE.L4-046 5-DR.31b Notes: N/A

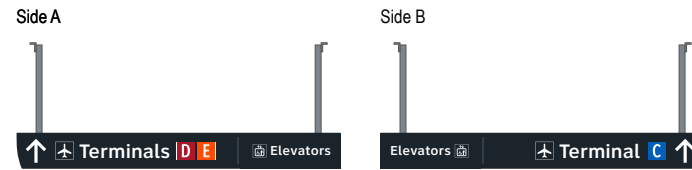


S3 DE.L4-043 5-DR.31b Notes: N/A

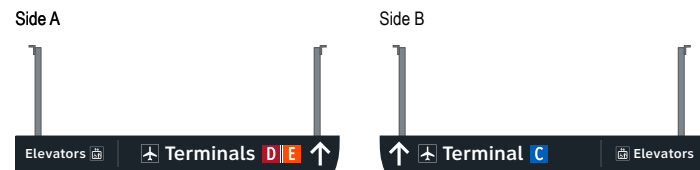


S3 DE.L4-047 5-DR.31b Notes: N/A

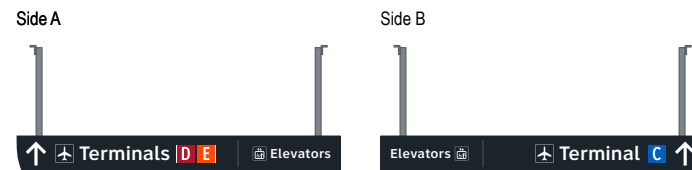

S3 DE.L4-044 5-DR.31b Notes: N/A

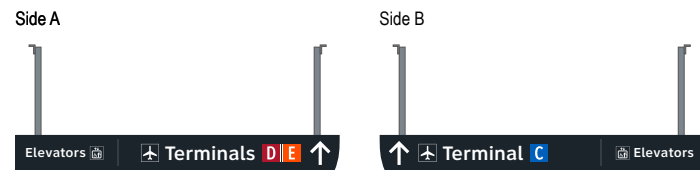

S3 DE.L4-048 5-DR.31b Notes: N/A

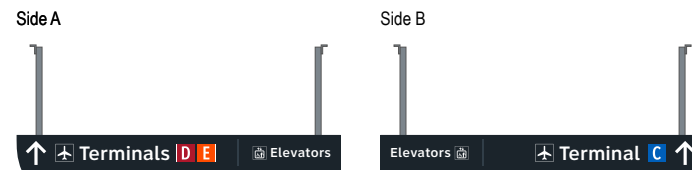

**Wayfinding Updates**

Issue Date: 08-23-2024

**Issue for Bid**

- REV.
- REV.
- REV.

**WARNING:**

This record contains Sensitive Security Information that is controlled under 49 CFR parts 15 and 1520. No part of this record may be disclosed to persons with a "need to know," as defined in 49 CFR parts 15 and 1520, except with the written permission of the Administrator of the Transportation Security Administration or the Secretary of Transportation. Unauthorized release may result in civil penalty or other action. For U.S. government agencies, public disclosure is governed by 5 U.S.C. 552 and 49 CFR parts 15 and 1520.

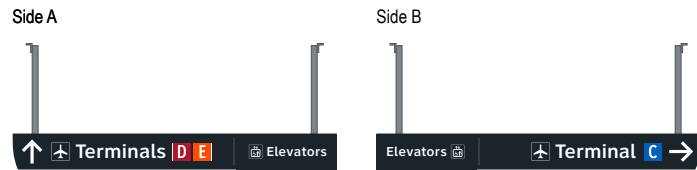


THESE SHEETS ARE ISSUED FOR GRAPHICAL INFORMATION ONLY

**7.6 MESSAGE SCHEDULE - GARAGE D/E: LEVEL 4 - SECTOR 3 (D/E)**

BSG PRJCT# BSG-2024-111-IAH  
HAS TIP # 24 -103 - IAH


S3 DE.L4-049 5-DR.31b Notes: N/A




S3 DE.L4-053 N/A Notes: N/A

NOT USED

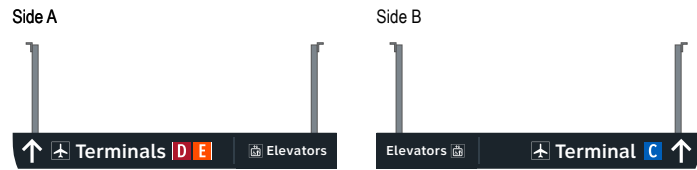
S3 DE.L4-050 5-DR.31b Notes: N/A




S3 DE.L4-054 5-DR.31b Notes: N/A

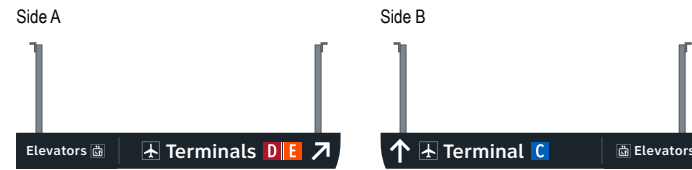


S3 DE.L4-051 5-DR.31b Notes: Notes: N/A

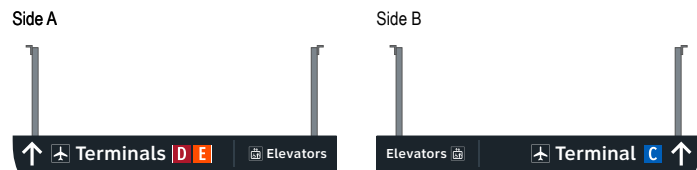


S3 DE.L4-055 5-DR.31b Notes: N/A

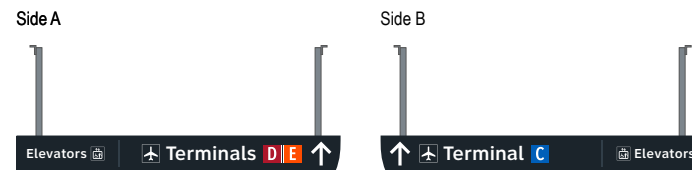

S3 DE.L4-052 5-DR.31b Notes: N/A

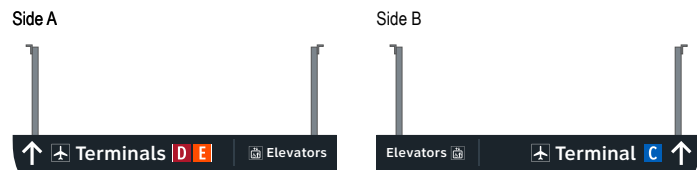

S3 DE.L4-056 5-DR.31b Notes: N/A

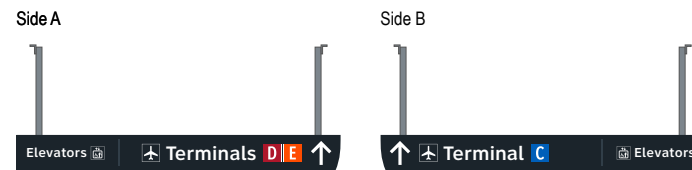

**Wayfinding Updates**

Issue Date: 08-23-2024  
Issue for Bid

- REV. 
- REV. 
- REV. 

**WARNING:**

This record contains Sensitive Security Information that is controlled under 49 CFR parts 15 and 1520. No part of this record may be disclosed to persons with a "need to know," as defined in 49 CFR parts 15 and 1520, except with the written permission of the Administrator of the Transportation Security Administration or the Secretary of Transportation. Unauthorized release may result in civil penalty or other action. For U.S. government agencies, public disclosure is governed by 5 U.S.C. 552 and 49 CFR parts 15 and 1520.

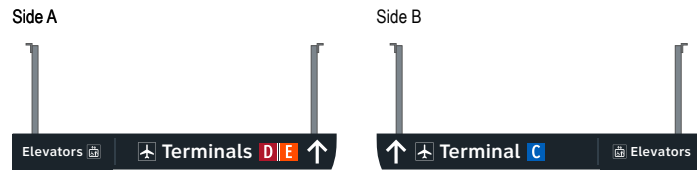


THESE SHEETS ARE ISSUED FOR GRAPHICAL INFORMATION ONLY


**7.6 MESSAGE SCHEDULE - GARAGE D/E: LEVEL 4 - SECTOR 3 (D/E)**

BSG PRJCT# BSG-2024-111-IAH  
HAS TIP # 24 -103 - IAH


S3 DE.L4-057 5-DR.31b Notes: N/A



S3 DE.L4-061 5-ID.52 Notes: N/A

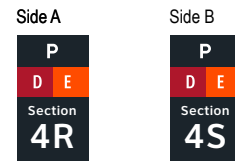


S3 DE.L4-058 5-DR.31b Notes: N/A

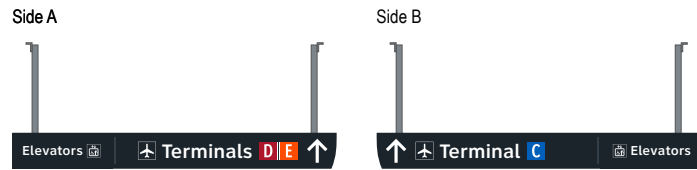


S3 DE.L4-062 N/A Notes: N/A

NOT USED

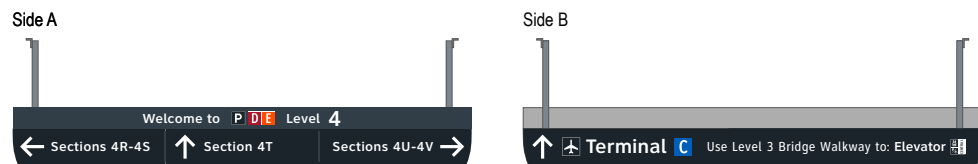S3 DE.L4-059 5-DR.34 Notes: N/A



S3 DE.L4-063 5-ID.52 Notes: N/A

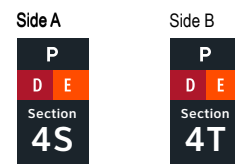

S3 DE.L4-060 5-ID.52 Notes: N/A



S3 DE.L4-064 N/A Notes: N/A

NOT USED

NOT USED

Side A



Side A



Side B



Side A



Side B



NOT USED

NOT USED

Side A



Side A



Side B



**Wayfinding Updates**

Issue Date: 08-23-2024  
Issue for Bid

- REV.
- REV.
- REV.

**WARNING:**

This record contains Sensitive Security Information that is controlled under 49 CFR parts 15 and 1520. No part of this record may be disclosed to persons with a "need to know," as defined in 49 CFR parts 15 and 1520, except with the written permission of the Administrator of the Transportation Security Administration or the Secretary of Transportation. Unauthorized release may result in civil penalty or other action. For U.S. government agencies, public disclosure is governed by 5 U.S.C. 552 and 49 CFR parts 15 and 1520.



08-23-2024

S3 DE.L4-073 5-ID.52 Notes: N/A

Side A      Side B

P	P
D E	D E
Section	Section
4S	4T

S3 DE.L4-077 5-ID.52 Notes: N/A

Side A      Side B

P	P
D E	D E
Section	Section
4U	4V

S3 DE.L4-074 N/A Notes: N/A

NOT USED

S3 DE.L4-078 5-ID.52 Notes: N/A

Side A

P
D E
Section
4V

S3 DE.L4-075 5-ID.52 Notes: N/A

Side A      Side B

P	P
D E	D E
Section	Section
4R	4S

S3 DE.L4-079 5-ID.52 Notes: N/A

Side A

P
D E
Section
4V

S3 DE.L4-076 5-ID.52 Notes: N/A

Side A

P
D E
Section
4R

S3 DE.L4-080 5-ID.52 Notes: N/A

Side A

P
D E
Section
4V



Wayfinding Updates

Issue Date: 08-23-2024

Issue for Bid

- REV.
- REV.
- REV.

WARNING:

This record contains Sensitive Security Information that is controlled under 49 CFR parts 15 and 1520. No part of this record may be disclosed to persons with a "need to know," as defined in 49 CFR parts 15 and 1520, except with the written permission of the Administrator of the Transportation Security Administration or the Secretary of Transportation. Unauthorized release may result in civil penalty or other action. For U.S. government agencies, public disclosure is governed by 5 U.S.C. 552 and 49 CFR parts 15 and 1520.



THESE SHEETS ARE ISSUED FOR GRAPHICAL INFORMATION ONLY

08-23-2024

7.6 MESSAGE SCHEDULE - GARAGE D/E: LEVEL 4 - SECTOR 3 (D/E)

BSG PRJCT# BSG-2024-111-IAH  
HAS TIP # 24 -103 - IAH



S3 DE.L4-081 5-ID.52 Notes: N/A

Side A



S3 DE.L4-085 5-ID.52 Notes: N/A

Side A



S3 DE.L4-082 5-ID.52 Notes: N/A

Side A



S3 DE.L4-086 5-ID.52 Notes: N/A

Side A



S3 DE.L4-083 5-ID.52 Notes: N/A

Side A



S3 DE.L4-087 5-ID.52 Notes: N/A

Side A



S3 DE.L4-084 5-ID.52 Notes: N/A

Side A



S3 DE.L4-088 5-ID.52 Notes: N/A

Side A



GEORGE BUSH INTERCONTINENTAL AIRPORT  
Wayfinding Signage Design Intent Documents  
C Garage



Louisville, Colorado  
P: 303.494.7849  
www.labozan.com

These documents are intended to illustrate design intent, and should only be used as a general guideline. No information contained here should be construed as engineered elements. The fabricator/contractor shall be responsible for all engineering and specifications with regard to structural, electrical, mechanical, foundation and installation. Information and illustrations contained here are part of an original unpublished design by Labozan Associates, Inc. Detailing and information contained on these pages shall not be reproduced, copied or utilized in any way except for the specific project for which they were created without previous written authorization from Labozan Associates, Inc.

© 2024 by Labozan Associates, Inc.

**Wayfinding Updates**

Issue Date: 08-23-2024  
Issue for Bid

- REV.
- REV.
- REV.

**WARNING:**

This record contains Sensitive Security Information that is controlled under 49 CFR parts 15 and 1520. No part of this record may be disclosed to persons with a "need to know," as defined in 49 CFR parts 15 and 1520, except with the written permission of the Administrator of the Transportation Security Administration or the Secretary of Transportation. Unauthorized release may result in civil penalty or other action. For U.S. government agencies, public disclosure is governed by 5 U.S.C. 552 and 49 CFR parts 15 and 1520.



08-23-2024

THESE SHEETS ARE ISSUED FOR GRAPHICAL INFORMATION ONLY

**7.6 MESSAGE SCHEDULE - GARAGE D/E: LEVEL 4 - SECTOR 3 (D/E)**

BSG PRJCT# BSG-2024-111-IAH  
HAS TIP # 24 -103 - IAH

S3 DE.L4-089 5-ID.52 Notes: N/A

Side A



S3 DE.L4-093 5-ID.52 Notes: N/A

Side A



Side B



S3 DE.L4-090 5-ID.52 Notes: N/A

Side A



Side B



S3 DE.L4-094 5-ID.52 Notes: N/A

Side A



Side B



S3 DE.L4-091 5-ID.52 Notes: N/A

Side A



Side B



S3 DE.L4-095 5-ID.52 Notes: N/A

Side A



Side B



S3 DE.L4-092 5-ID.52 Notes: N/A

Side A



Side B



S3 DE.L4-096 5-ID.52 Notes: N/A

Side A



Side B



GEORGE BUSH INTERCONTINENTAL AIRPORT  
Wayfinding Signage Design Intent Documents  
C Garage



Louisville, Colorado  
P: 303.494.7849  
www.labozan.com

These documents are intended to illustrate design intent, and should only be used as a general guideline. No information contained here should be construed as engineered elements. The fabricator/contractor shall be responsible for all engineering and specifications with regard to structural, electrical, mechanical, foundation and installation. Information and illustrations contained here are part of an original unpublished design by Labozan Associates, Inc. Detailing and information contained on these pages shall not be reproduced, copied or utilized in any way except for the specific project for which they were created without previous written authorization from Labozan Associates, Inc.

© 2024 by Labozan Associates, Inc.

Wayfinding Updates

Issue Date: 08-23-2024  
Issue for Bid

- REV.
- REV.
- REV.

WARNING:

This record contains Sensitive Security Information that is controlled under 49 CFR parts 15 and 1520. No part of this record may be disclosed to persons with a "need to know," as defined in 49 CFR parts 15 and 1520, except with the written permission of the Administrator of the Transportation Security Administration or the Secretary of Transportation. Unauthorized release may result in civil penalty or other action. For U.S. government agencies, public disclosure is governed by 5 U.S.C. 552 and 49 CFR parts 15 and 1520.



08-23-2024

THESE SHEETS ARE ISSUED FOR GRAPHICAL INFORMATION ONLY

7.6 MESSAGE SCHEDULE - GARAGE D/E: LEVEL 4 - SECTOR 3 (D/E)

BSG PRJCT# BSG-2024-111-IAH  
HAS TIP # 24 -103 - IAH

S3 DE.L4-097 5-ID.52 Notes: N/A

Side A      Side B

P	P
D E	D E
Section	Section
4S	4T

S3 DE.L4-101 5-ID.52 Notes: N/A

Side A      Side B

P	P
D E	D E
Section	Section
4S	4T

S3 DE.L4-098 5-ID.52 Notes: N/A

Side A      Side B

P	P
D E	D E
Section	Section
4S	4T

S3 DE.L4-102 5-ID.52 Notes: N/A

Side A      Side B

P	P
D E	D E
Section	Section
4S	4T

S3 DE.L4-099 5-ID.52 Notes: N/A

Side A

P
D E
Section
4T

S3 DE.L4-103 5-ID.52 Notes: N/A

Side A      Side B

P	P
D E	D E
Section	Section
4T	4U

S3 DE.L4-100 5-ID.52 Notes: N/A

Side A      Side B

P	P
D E	D E
Section	Section
4S	4T

S3 DE.L4-104 5-ID.52 Notes: N/A

Side A      Side B

P	P
D E	D E
Section	Section
4T	4U



GEORGE BUSH INTERCONTINENTAL AIRPORT  
Wayfinding Signage Design Intent Documents  
C Garage



Louisville, Colorado  
P: 303.494.7849  
www.labozan.com

These documents are intended to illustrate design intent, and should only be used as a general guideline. No information contained here should be construed as engineered elements. The fabricator/contractor shall be responsible for all engineering and specifications with regard to structural, electrical, mechanical, foundation and installation. Information and illustrations contained here are part of an original unpublished design by Labozan Associates, Inc. Detailing and information contained on these pages shall not be reproduced, copied or utilized in any way except for the specific project for which they were created without previous written authorization from Labozan Associates, Inc.  
© 2024 by Labozan Associates, Inc.

Wayfinding Updates

Issue Date: 08-23-2024  
Issue for Bid

- REV.
- REV.
- REV.

WARNING:

This record contains Sensitive Security Information that is controlled under 49 CFR parts 15 and 1520. No part of this record may be disclosed to persons with a "need to know," as defined in 49 CFR parts 15 and 1520, except with the written permission of the Administrator of the Transportation Security Administration or the Secretary of Transportation. Unauthorized release may result in civil penalty or other action. For U.S. government agencies, public disclosure is governed by 5 U.S.C. 552 and 49 CFR parts 15 and 1520.



THESE SHEETS ARE ISSUED FOR GRAPHICAL INFORMATION ONLY

08-23-2024

7.6 MESSAGE SCHEDULE - GARAGE D/E: LEVEL 4 - SECTOR 3 (D/E)

BSG PRJCT# BSG-2024-111-IAH  
HAS TIP # 24 -103 - IAH

S3 DE.L4-105 5-ID.52 Notes: N/A

Side A      Side B

P	P
D E	D E
Section	Section
4T	4U

S3 DE.L4-109 5-ID.52 Notes: N/A

Side A      Side B

P	P
D E	D E
Section	Section
4T	4U

S3 DE.L4-106 5-ID.52 Notes: N/A

Side A      Side B

P	P
D E	D E
Section	Section
4T	4U

S3 DE.L4-110 5-ID.52 Notes: N/A

Side A      Side B

P	P
D E	D E
Section	Section
4U	4V

S3 DE.L4-107 5-ID.52 Notes: N/A

Side A

P
D E
Section
4T

S3 DE.L4-111 5-ID.52 Notes: N/A

Side A      Side B

P	P
D E	D E
Section	Section
4U	4V

S3 DE.L4-108 5-ID.52 Notes: N/A

Side A      Side B

P	P
D E	D E
Section	Section
4T	4U

S3 DE.L4-112 5-ID.52 Notes: N/A

Side A      Side B

P	P
D E	D E
Section	Section
4U	4V



GEORGE BUSH INTERCONTINENTAL AIRPORT  
Wayfinding Signage Design Intent Documents  
C Garage



Louisville, Colorado  
P: 303.494.7849  
www.labozan.com

These documents are intended to illustrate design intent, and should only be used as a general guideline. No information contained here should be construed as engineered elements. The fabricator/contractor shall be responsible for all engineering and specifications with regard to structural, electrical, mechanical, foundation and installation. Information and illustrations contained here are part of an original unpublished design by Labozan Associates, Inc. Detailing and information contained on these pages shall not be reproduced, copied or utilized in any way except for the specific project for which they were created without previous written authorization from Labozan Associates, Inc.  
© 2024 by Labozan Associates, Inc.

Wayfinding Updates

Issue Date: 08-23-2024  
Issue for Bid

REV.   
REV.   
REV.

WARNING:

This record contains Sensitive Security Information that is controlled under 49 CFR parts 15 and 1520. No part of this record may be disclosed to persons with a "need to know," as defined in 49 CFR parts 15 and 1520, except with the written permission of the Administrator of the Transportation Security Administration or the Secretary of Transportation. Unauthorized release may result in civil penalty or other action. For U.S. government agencies, public disclosure is governed by 5 U.S.C. 552 and 49 CFR parts 15 and 1520.



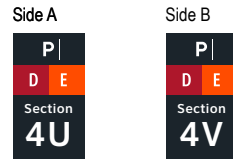
THESE SHEETS ARE ISSUED FOR GRAPHICAL INFORMATION ONLY

08-23-2024

7.6 MESSAGE SCHEDULE - GARAGE D/E: LEVEL 4 - SECTOR 3 (D/E)

BSG PRJCT# BSG-2024-111-IAH  
HAS TIP # 24 -103 - IAH


S3 DE.L4-113 5-ID.52 Notes: N/A



S3 DE.L4-117 5-ID.55 Notes: N/A



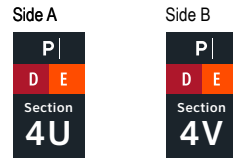
S3 DE.L4-114 5-ID.52 Notes: N/A



S3 DE.L4-118 5-ID.55 Notes: N/A



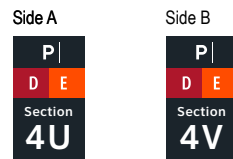S3 DE.L4-115 5-ID.52 Notes: N/A



S3 DE.L4-119 5-ID.55 Notes: N/A



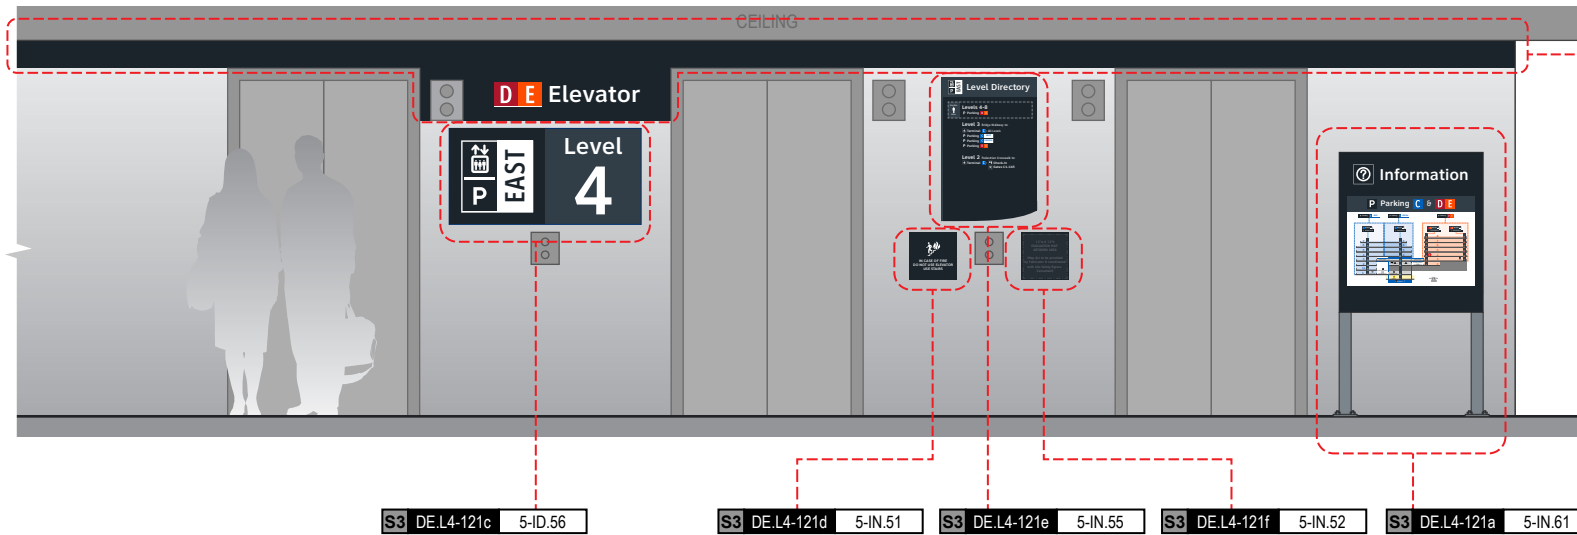
S3 DE.L4-116 5-ID.55 Notes: N/A



S3 DE.L4-120 N/A Notes: N/A

NOT USED

Side A




S3 DE.L4-121b 5-ID.57

NOTES: Wall paint and header graphics at front elevation only of elevator core included for this location number; wall elevation conditions shown are artistic representation based on rough site photo surveys; actual wall elevation conditions to be field verified by contractor/installer

NOTES: Level directory plaque includes a "You Are Here" graphic and is in a unique location per elevator core/level location; artwork included here is representative of final artwork design intent for this location

NOTES: Directory artwork includes a "You Are Here" button graphic and is in a unique location per elevator core/level location; artwork included here is representative of final map artwork design intent for this location

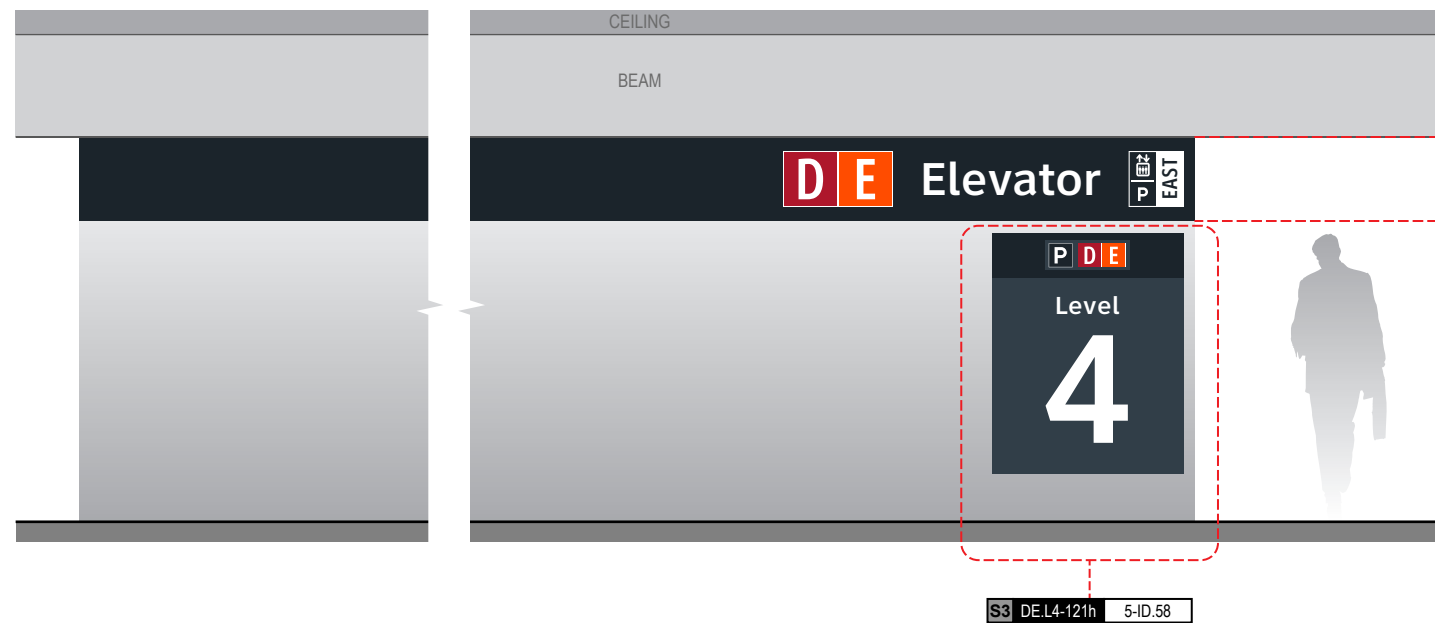Side B




S3 DE.L4-121g 5-ID.59

NOTES: Wall paint and header graphics on garage-facing elevation of elevator core included for this location number; wall elevation conditions shown are artistic representation based on rough site photo surveys; actual wall elevation conditions to be field verified by contractor/installer

S3 DE.L4-121h 5-ID.58

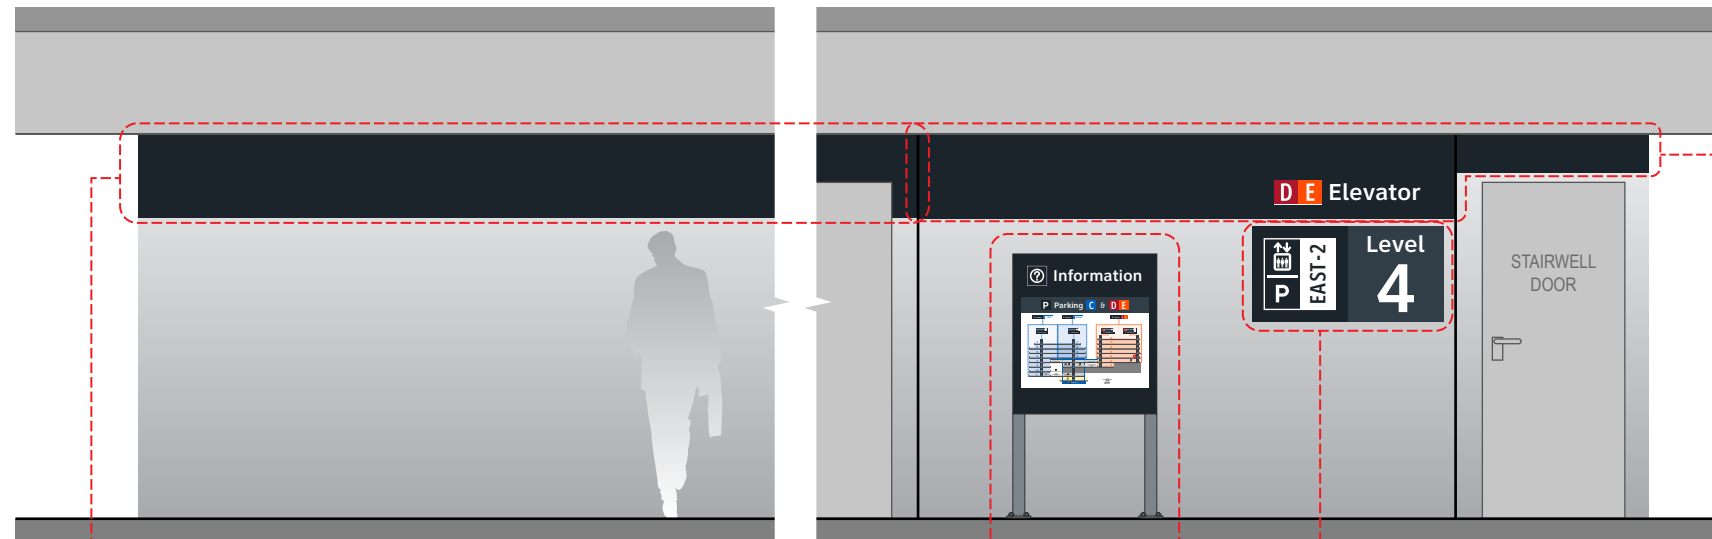Side A



S3 DE.L4-122a 5-IN.61

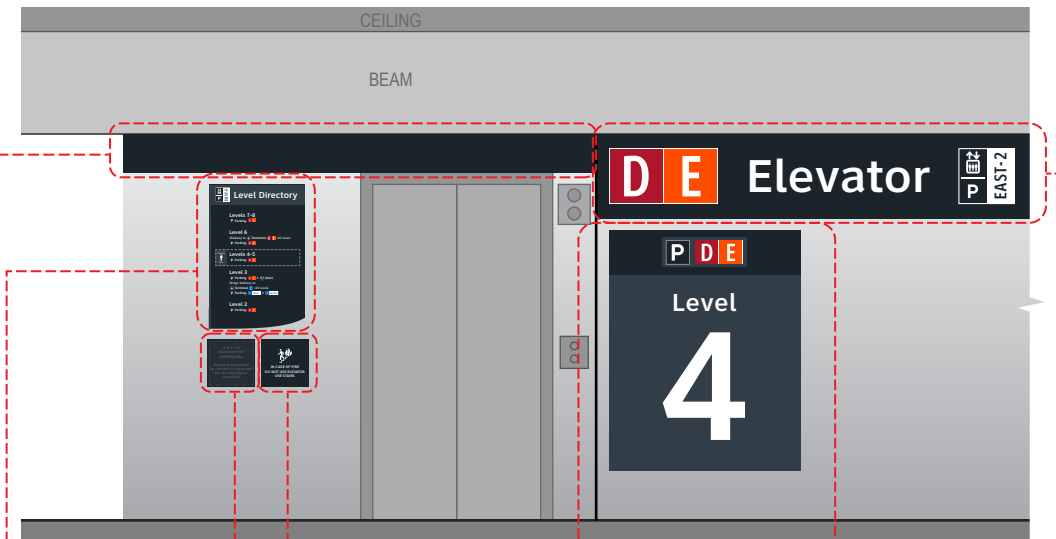
NOTES: Directory artwork includes a "You Are Here" button graphic and is in a unique location per elevator core/level location; artwork included here is representative of final map artwork design intent for this location

S3 DE.L4-122b 5-ID.56

S3 DE.L4-122 5-ID.57

NOTES: Wall paint and header graphics at A & C elevations only of elevator core included for this location number; wall elevation conditions shown are artistic representation based on rough site photo surveys; actual wall elevation conditions to be field verified by contractor/installer

Side C



S3 DE.L4-122c 5-IN.55

NOTES: Level directory plaque includes a "You Are Here" graphic and is in a unique location per elevator core/level location; artwork included here is representative of final artwork design intent for this location

S3 DE.L4-122d 5-IN.51

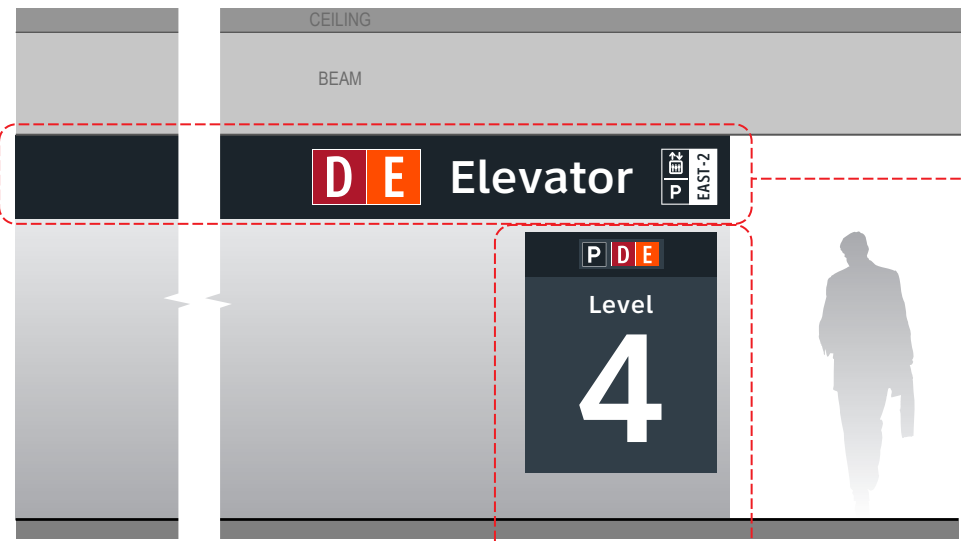
S3 DE.L4-122e 5-IN.52

S3 DE.L4-122h 5-ID.58

S3 DE.L4-122f 5-ID.59

NOTES: Wall paint and header graphics on rear and two side elevations of elevator core included for this location number; wall elevation conditions shown are artistic representation based on rough site photo surveys; actual wall elevation conditions to be field verified by contractor/installer

Side B



S3 DE.L4-122g 5-ID.59

NOTES: Wall paint and header graphics on rear and two side elevations of elevator core included for this location number; wall elevation conditions shown are artistic representation based on rough site photo surveys; actual wall elevation conditions to be field verified by contractor/installer

S3 DE.L4-122i 5-ID.58

## END OF GARAGE C: LEVEL 4 - SECTOR 3 MESSAGES

**Wayfinding Updates**

Issue Date: 08-23-2024

Issue for Bid

REV.   
 REV.   
 REV.

**WARNING:**

This record contains Sensitive Security Information that is controlled under 49 CFR parts 15 and 1520. No part of this record may be disclosed to persons with a "need to know," as defined in 49 CFR parts 15 and 1520, except with the written permission of the Administrator of the Transportation Security Administration or the Secretary of Transportation. Unauthorized release may result in civil penalty or other action. For U.S. government agencies, public disclosure is governed by 5 U.S.C. 552 and 49 CFR parts 15 and 1520.



08-23-2024

THESE SHEETS ARE ISSUED FOR GRAPHICAL INFORMATION ONLY

### 7.6 MESSAGE SCHEDULE - GARAGE D/E: LEVEL 4 - SECTOR 3 (D/E)

BSG PRJCT# BSG-2024-111-IAH  
 HAS TIP # 24 -103 - IAH

Sheet: 7-48

# 8.0

## **8.0 LOCATION PLANS & MESSAGE SCHEDULES: LEVEL 5**

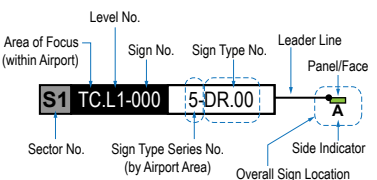


GENERAL NOTES

- Sign locations & orientations shown here are approximations based on the most current plan drawings as provided to the designer by the architect at the time of this document's completion. These sign locations are for general design intent & wayfinding planning purposes only. They should not be construed or deemed as absolute or final locations. Field verification, marking & documentation of each final location is to be performed by the Fabricator/Installer, & coordinated with project staff & Wayfinding Design Consultants for final approval.
- All final install locations must be marked and verified in the field for proper structural integrity, adequate line of sight, utilities / property-line / other existing signage interferences & must be in complete compliance with all local, state and national codes prior to fabrication or installation.
- Adjustments to the sign locations shown in these drawings must be documented by the Fabricator/Installer, and provided to project staff & Wayfinding Design Consultants for final approval.

**NOTE:** Only priority wayfinding signage & locations as shown in this wayfinding plan package are in scope. All other signage not shown (including traffic control) are NOT IN SCOPE for this project/contract.

SIGN LOCATION ANNOTATION LEGEND



LOCATION CODE DEFINITIONS:

- AREA OF FOCUS: (location within Airport)
- SIGN TYPE SERIES NO.: (by Airport Area)
- TA = Terminal A
  - TB = Terminal B
  - TC = Terminal C
  - TD = Terminal D
  - TE = Terminal E
  - AB = AB Garage
  - CG = C Garage
  - DE = DE Garage
- SIGN TYPE DEFINITIONS:
- 1- = Terminals/Concourses
  - 1- = Terminals/Concourses: Temporary
  - 2- = CBP Areas
  - 3- = Curbside/Ground Trans.
  - 4- = Roadways
  - 5- = Parking
- WAYFINDING SIGN TYPE:
- DR.xx = Directional
  - ID.xx = Identification
  - IN.xx = Informational

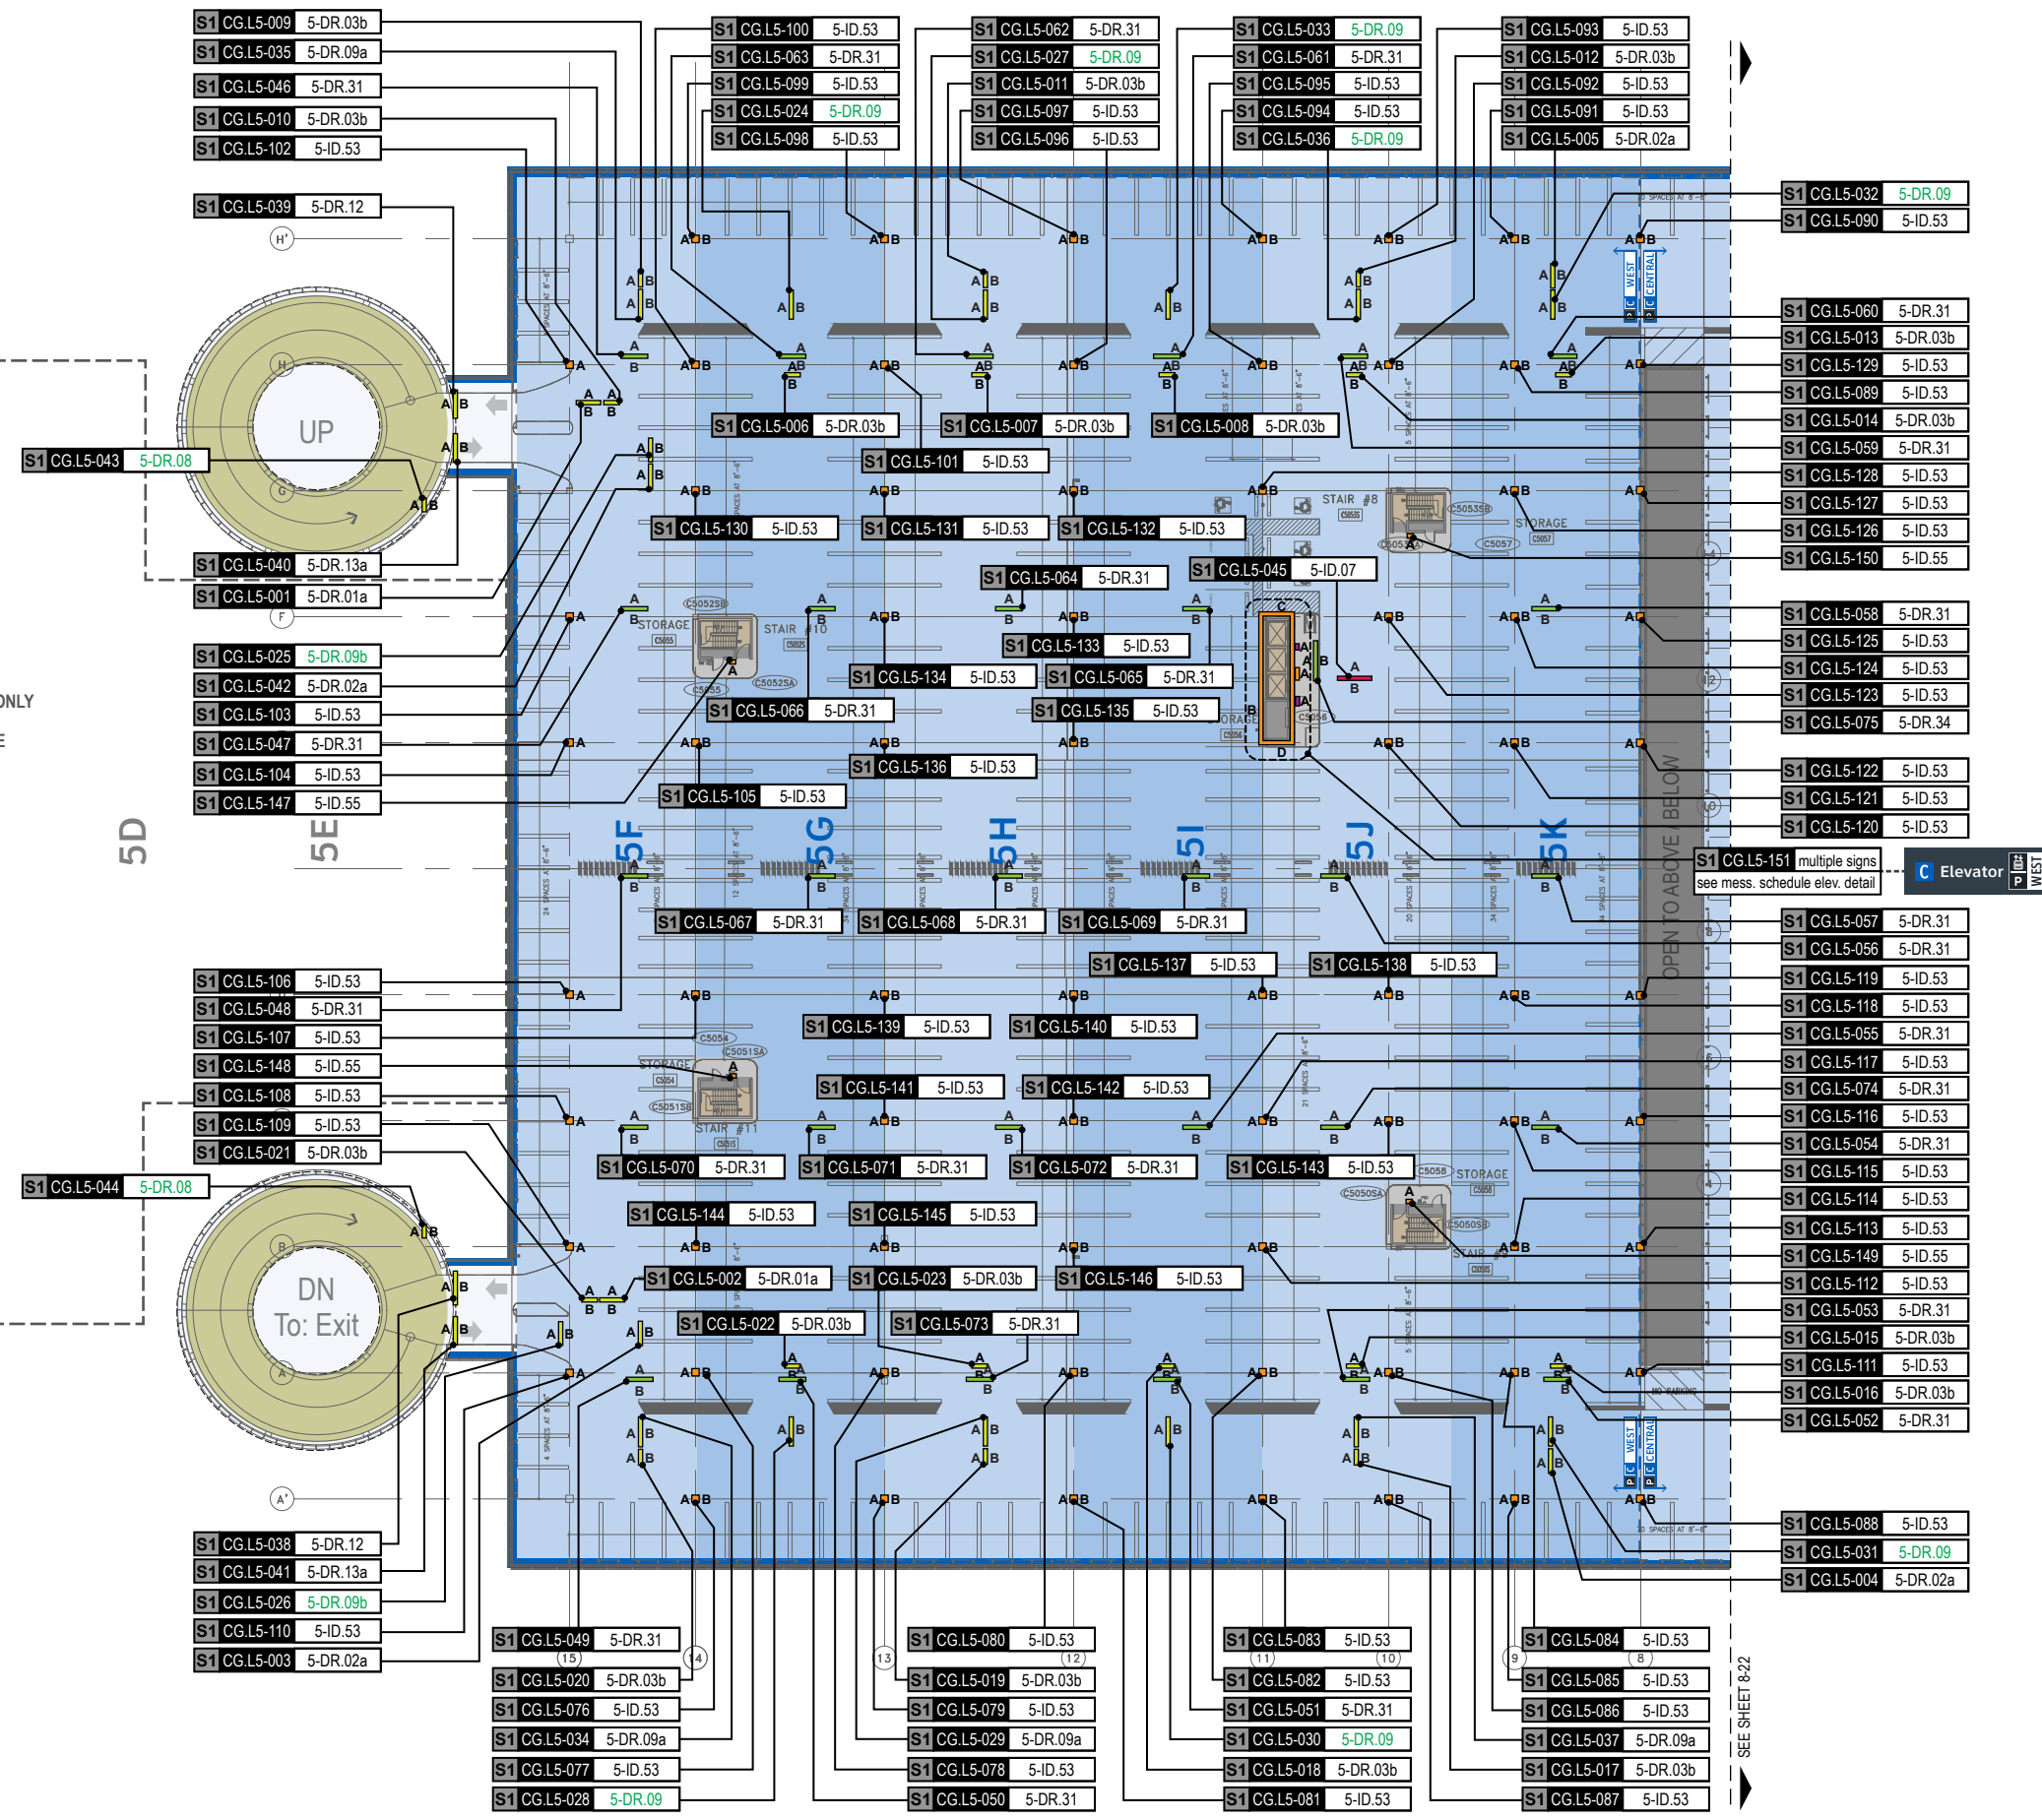
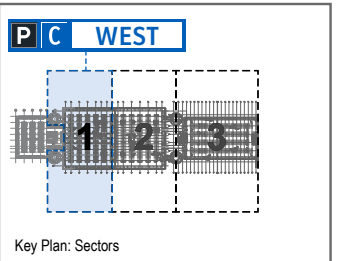
WAYFINDING SIGN LOCATIONS - Parking:

- PEDESTRIAN Signs:
- A/B = Directional (DR)
  - A/B = Identification (ID)
  - A/B = Informational (IN)
- VEHICULAR Signs:
- A/B = Directional (DR)
  - A/B = Identification (ID)
  - A/B = Informational (IN)

CIRCULATION:


- Public Use PEDESTRIAN Vertical Circulation (i.e. Elevators/Escalators/Stairs)
- Public Use VEHICULAR Vertical Circulation (i.e. Ramps)
- Alpha-Numeric Parking Section Naming Areas (Blues = C Garages; Oranges = D/E Garage)
- Areas Not In Scope for this Package

LOCATION PLAN SCALE: 1" = 60'




FUTURE C-WEST EXPANSION AREA  
SHOWN FOR PLANNED TERMINOLOGY REFERENCE ONLY  
THESE AREAS NOT IN SCOPE FOR THIS PACKAGE

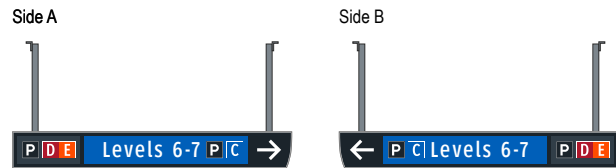
S1 CG.L5-001 5-DR.01a Notes: N/A




S1 CG.L5-005 5-DR.02a Notes: N/A

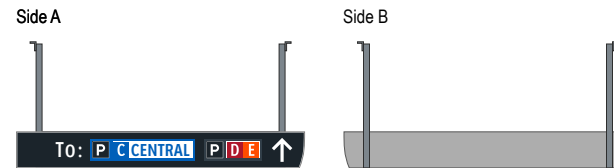


S1 CG.L5-002 5-DR.01a Notes: N/A

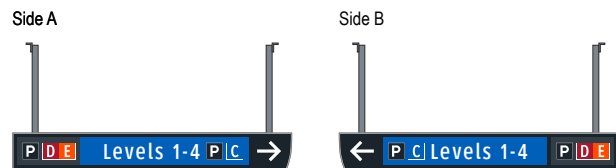


S1 CG.L5-006 5-DR.03b Notes: N/A

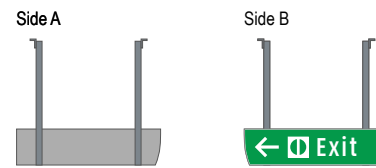


S1 CG.L5-003 5-DR.02a Notes: N/A

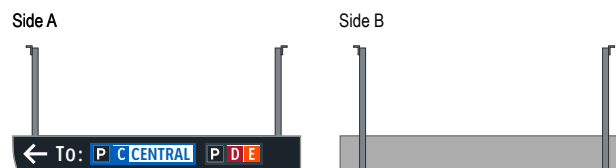


S1 CG.L5-007 5-DR.03b Notes: N/A

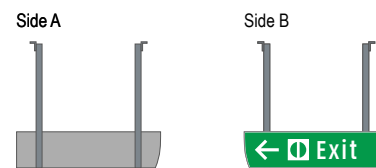


S1 CG.L5-004 5-DR.02a Notes: N/A

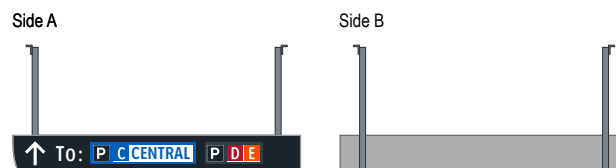


S1 CG.L5-008 5-DR.03b Notes: N/A

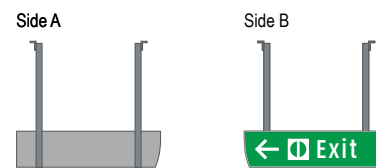


S1 CG.L5-009 5-DR.03b Notes: N/A

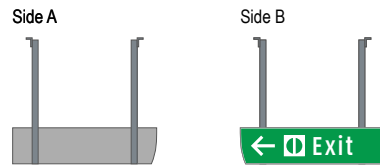


S1 CG.L5-013 5-DR.03b Notes: N/A

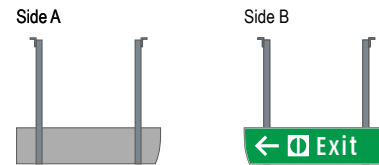


S1 CG.L5-010 5-DR.03b Notes: N/A

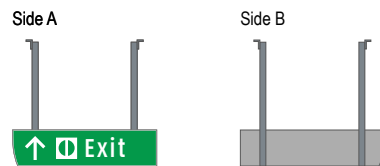


S1 CG.L5-014 5-DR.03b Notes: N/A

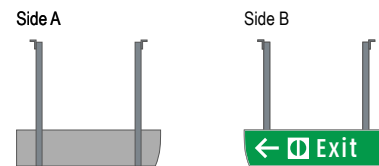


S1 CG.L5-011 5-DR.03b Notes: N/A

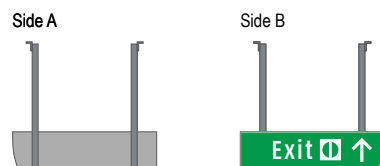


S1 CG.L5-015 5-DR.03b Notes: N/A

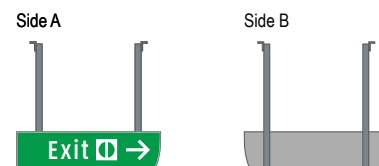


S1 CG.L5-012 5-DR.03b Notes: N/A

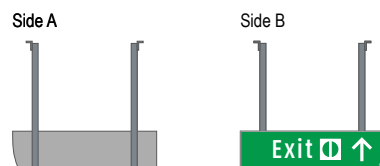


S1 CG.L5-016 5-DR.03b Notes: N/A

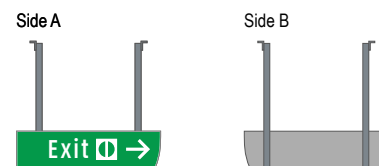


S1 CG.L5-017 5-DR.03b Notes: N/A

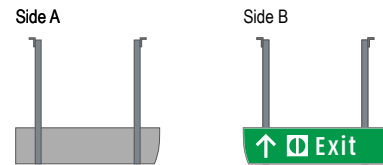


S1 CG.L5-021 5-DR.03b Notes: N/A

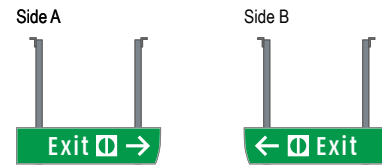


S1 CG.L5-018 5-DR.03b Notes: N/A

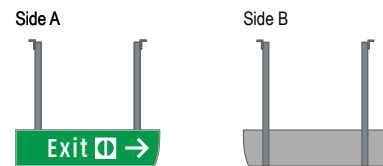


S1 CG.L5-022 5-DR.03b Notes: N/A

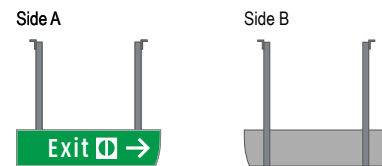


S1 CG.L5-019 5-DR.03b Notes: N/A

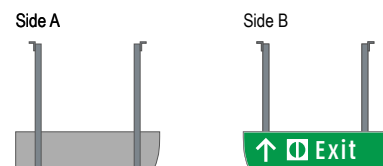


S1 CG.L5-023 5-DR.03b Notes: N/A

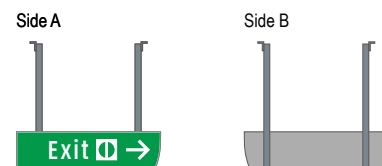

S1 CG.L5-020 5-DR.03b Notes: N/A

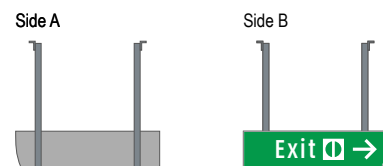

S1 CG.L5-024 5-DR.09 Notes: N/A

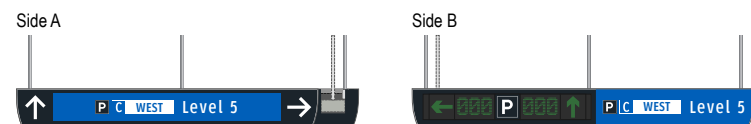

**Wayfinding Updates**

Issue Date: 08-23-2024  
Issue for Bid

- REV. 
- REV. 
- REV. 

**WARNING:**

This record contains Sensitive Security Information that is controlled under 49 CFR parts 15 and 1520. No part of this record may be disclosed to persons with a "need to know," as defined in 49 CFR parts 15 and 1520, except with the written permission of the Administrator of the Transportation Security Administration or the Secretary of Transportation. Unauthorized release may result in civil penalty or other action. For U.S. government agencies, public disclosure is governed by 5 U.S.C. 552 and 49 CFR parts 15 and 1520.

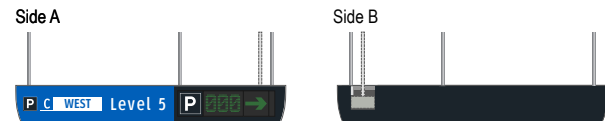


THESE SHEETS ARE ISSUED FOR GRAPHICAL INFORMATION ONLY


**8.2 MESSAGE SCHEDULE - GARAGE C: LEVEL 5 - SECTOR 1 (C WEST)**

BSG PRJCT# BSG-2024-111-IAH  
 HAS TIP # 24 -103 - IAH


S1 CG.L5-025 5-DR.09b Notes: N/A



S1 CG.L5-029 5-DR.09a Notes: N/A

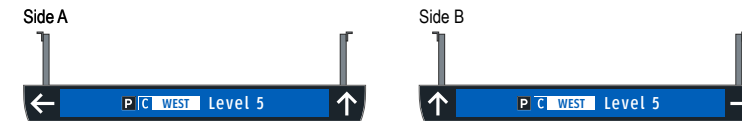


S1 CG.L5-026 5-DR.09b Notes: N/A

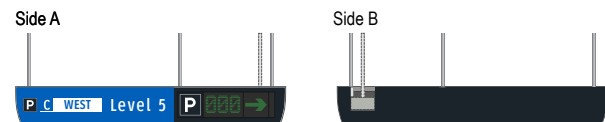

S1 CG.L5-030 5-DR.09 Notes: N/A



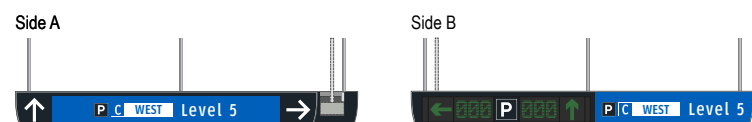
S1 CG.L5-027 5-DR.09 Notes: N/A




S1 CG.L5-031 5-DR.09 Notes: N/A



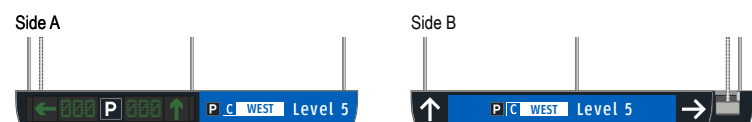
S1 CG.L5-028 5-DR.09 Notes: N/A




S1 CG.L5-032 5-DR.09 Notes: N/A

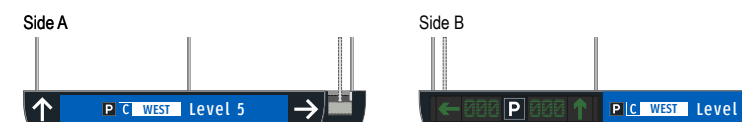


S1 CG.L5-033 5-DR.09 Notes: N/A

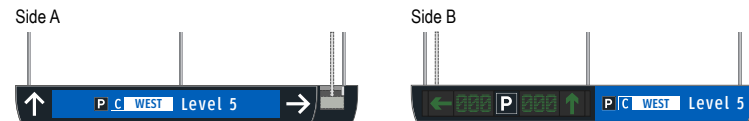


S1 CG.L5-037 5-DR.09a Notes: N/A

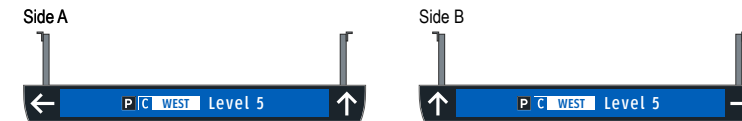


S1 CG.L5-034 5-DR.09a Notes: N/A

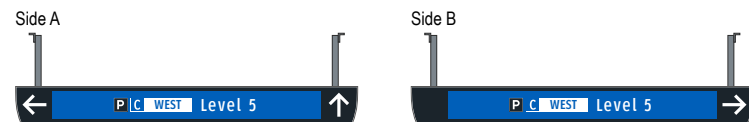


S1 CG.L5-038 5-DR.12 Notes: N/A

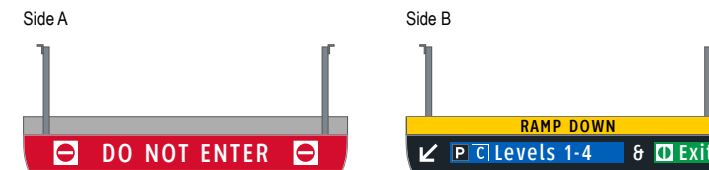


S1 CG.L5-035 5-DR.09a Notes: N/A

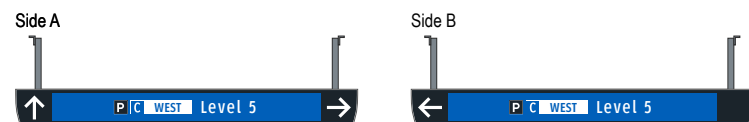


S1 CG.L5-039 5-DR.12 Notes: N/A

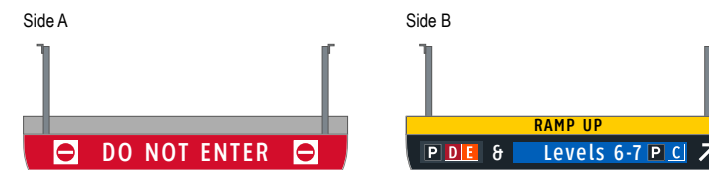


S1 CG.L5-036 5-DR.09 Notes: N/A

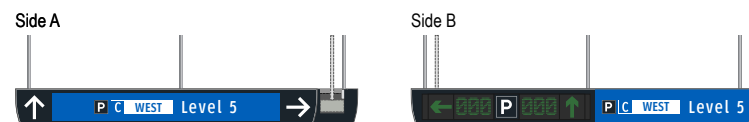


S1 CG.L5-040 5-DR.13a Notes: N/A

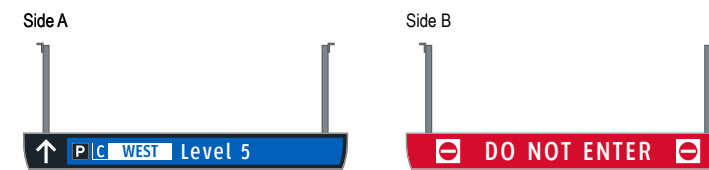


S1 CG.L5-041 5-DR.13a Notes: N/A

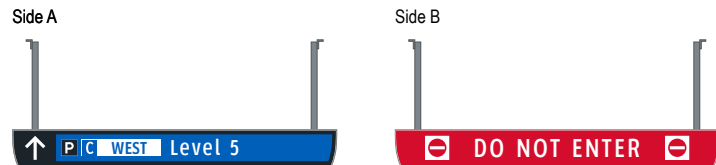


S1 CG.L5-045 5-ID.07 Notes: N/A

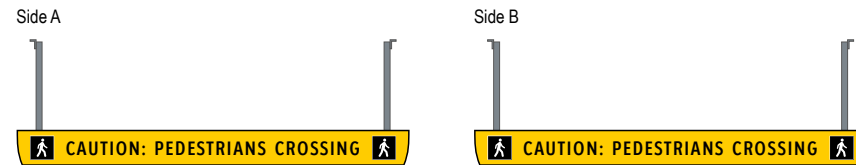


S1 CG.L5-042 5-DR.02a Notes: N/A

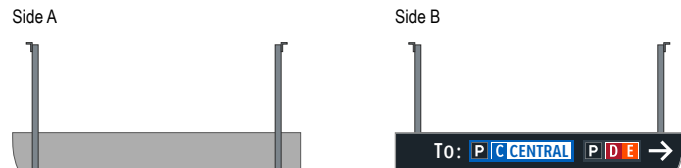


S1 CG.L5-046 5-DR.31 Notes: N/A

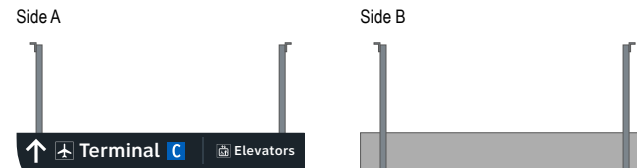


S1 CG.L5-043 5-DR.08 Notes: N/A

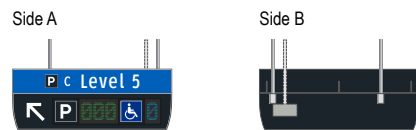


S1 CG.L5-047 5-DR.31 Notes: N/A

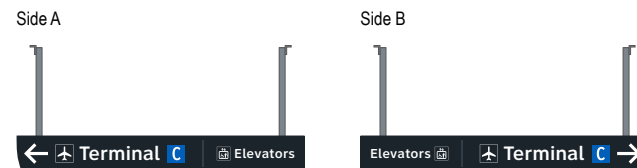

S1 CG.L5-044 5-DR.08 Notes: N/A

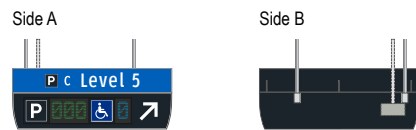

S1 CG.L5-048 5-DR.31 Notes: N/A

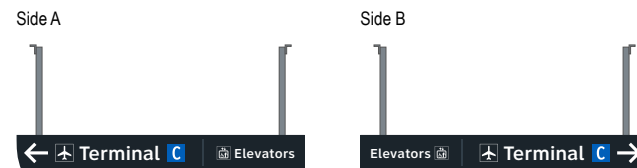

**Wayfinding Updates**

Issue Date: 08-23-2024

Issue for Bid

- REV. 
- REV. 
- REV. 

**WARNING:**

This record contains Sensitive Security Information that is controlled under 49 CFR parts 15 and 1520. No part of this record may be disclosed to persons with a "need to know," as defined in 49 CFR parts 15 and 1520, except with the written permission of the Administrator of the Transportation Security Administration or the Secretary of Transportation. Unauthorized release may result in civil penalty or other action. For U.S. government agencies, public disclosure is governed by 5 U.S.C. 552 and 49 CFR parts 15 and 1520.

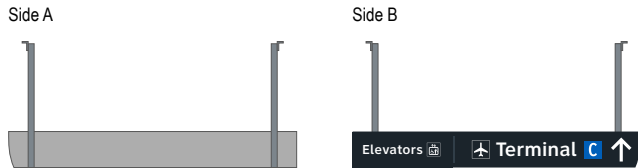


THESE SHEETS ARE ISSUED FOR GRAPHICAL INFORMATION ONLY


**8.2 MESSAGE SCHEDULE - GARAGE C: LEVEL 5 - SECTOR 1 (C WEST)**

BSG PRJCT# BSG-2024-111-IAH  
 HAS TIP # 24 -103 - IAH


S1 CG.L5-049 5-DR.31 Notes: N/A




S1 CG.L5-053 5-DR.31 Notes: N/A

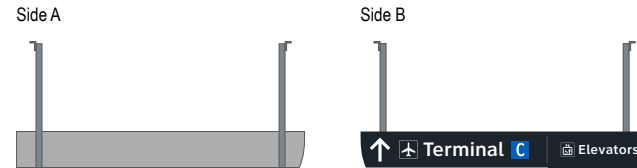


S1 CG.L5-050 5-DR.31 Notes: N/A

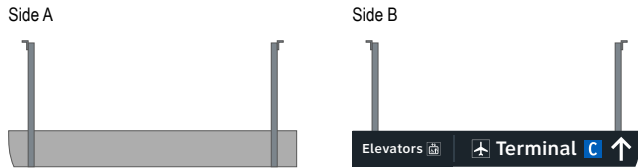


S1 CG.L5-054 5-DR.31 Notes: N/A

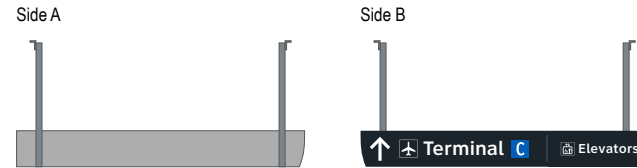


S1 CG.L5-051 5-DR.31 Notes: Notes: N/A

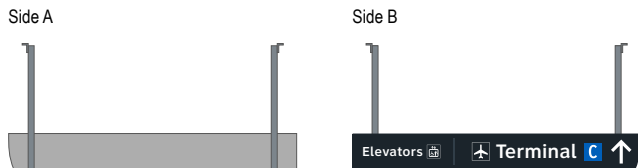


S1 CG.L5-055 5-DR.31 Notes: N/A

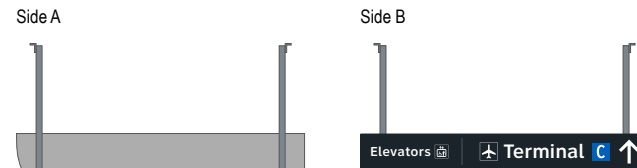

S1 CG.L5-052 5-DR.31 Notes: N/A

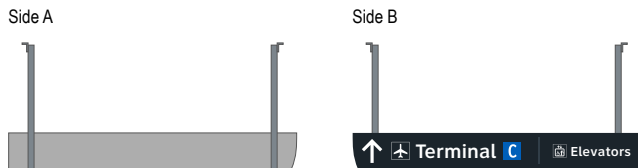

S1 CG.L5-056 5-DR.31 Notes: N/A

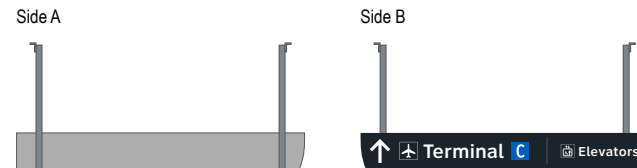

**Wayfinding Updates**

Issue Date: 08-23-2024  
Issue for Bid

- REV. 
- REV. 
- REV. 

**WARNING:**

This record contains Sensitive Security Information that is controlled under 49 CFR parts 15 and 1520. No part of this record may be disclosed to persons with a "need to know," as defined in 49 CFR parts 15 and 1520, except with the written permission of the Administrator of the Transportation Security Administration or the Secretary of Transportation. Unauthorized release may result in civil penalty or other action. For U.S. government agencies, public disclosure is governed by 5 U.S.C. 552 and 49 CFR parts 15 and 1520.



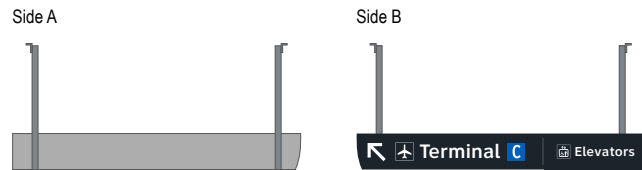
THESE SHEETS ARE ISSUED FOR GRAPHICAL INFORMATION ONLY

**8.2 MESSAGE SCHEDULE - GARAGE C: LEVEL 5 - SECTOR 1 (C WEST)**


BSG PRJCT# BSG-2024-111-IAH  
HAS TIP # 24 -103 - IAH




S1 CG.L5-057 5-DR.31 Notes: N/A




S1 CG.L5-061 5-DR.31 Notes: N/A

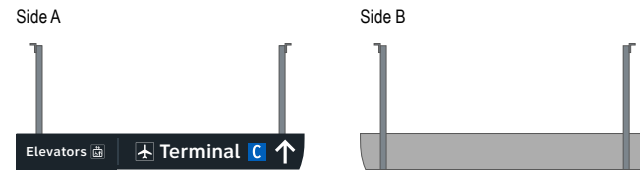


S1 CG.L5-058 5-DR.31 Notes: N/A

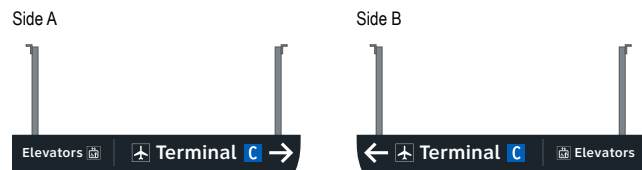


S1 CG.L5-062 5-DR.31 Notes: N/A

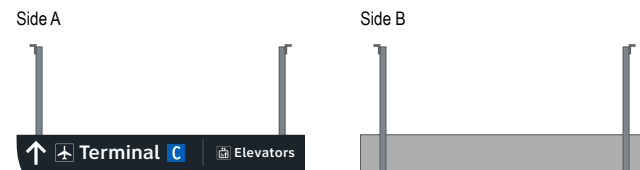


S1 CG.L5-059 5-DR.31 Notes: N/A

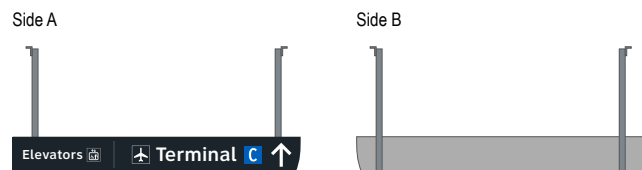


S1 CG.L5-063 5-DR.31 Notes: N/A

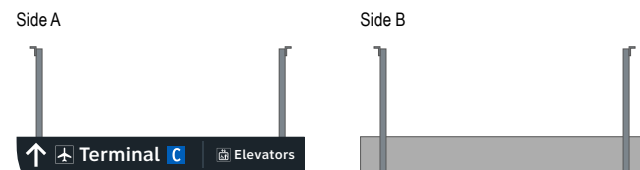

S1 CG.L5-060 5-DR.31 Notes: N/A

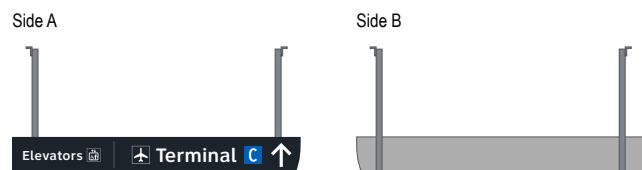

S1 CG.L5-064 5-DR.31 Notes: N/A

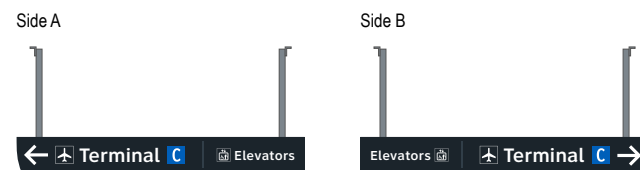

**Wayfinding Updates**

Issue Date: 08-23-2024  
Issue for Bid

- REV. 
- REV. 
- REV. 

**WARNING:**

This record contains Sensitive Security Information that is controlled under 49 CFR parts 15 and 1520. No part of this record may be disclosed to persons with a "need to know," as defined in 49 CFR parts 15 and 1520, except with the written permission of the Administrator of the Transportation Security Administration or the Secretary of Transportation. Unauthorized release may result in civil penalty or other action. For U.S. government agencies, public disclosure is governed by 5 U.S.C. 552 and 49 CFR parts 15 and 1520.

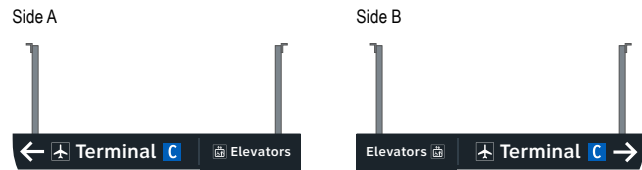


THESE SHEETS ARE ISSUED FOR GRAPHICAL INFORMATION ONLY


**8.2 MESSAGE SCHEDULE - GARAGE C: LEVEL 5 - SECTOR 1 (C WEST)**

BSG PRJCT# BSG-2024-111-IAH  
 HAS TIP # 24 -103 - IAH


S1 CG.L5-065 5-DR.31 Notes: N/A




S1 CG.L5-069 5-DR.31 Notes: N/A

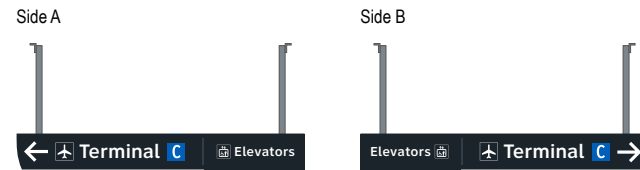


S1 CG.L5-066 5-DR.31 Notes: N/A

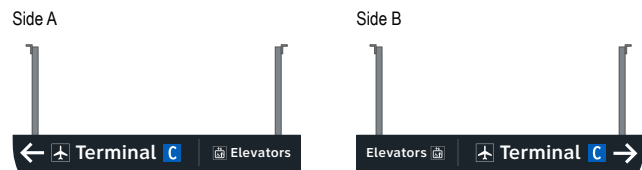


S1 CG.L5-070 5-DR.31 Notes: N/A

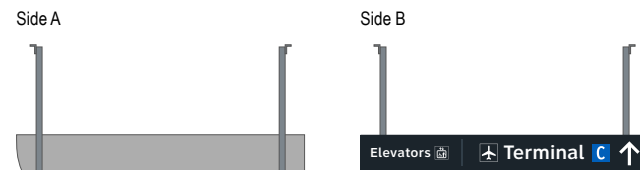


S1 CG.L5-067 5-DR.31 Notes: N/A

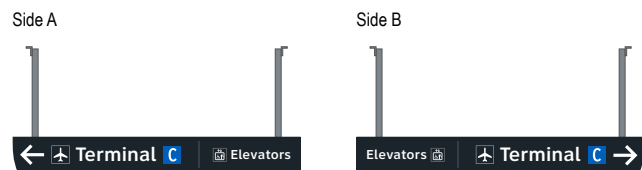


S1 CG.L5-071 5-DR.31 Notes: N/A

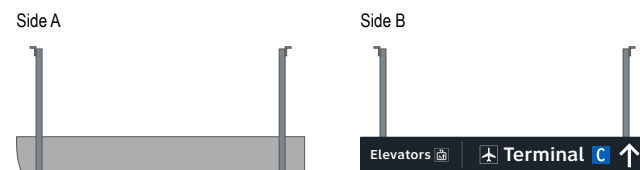

S1 CG.L5-068 5-DR.31 Notes: N/A

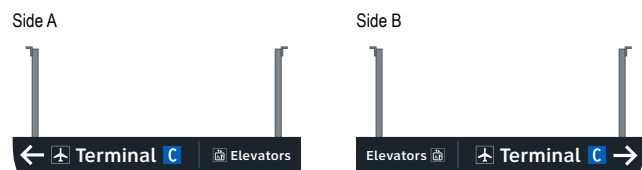

S1 CG.L5-072 5-DR.31 Notes: N/A

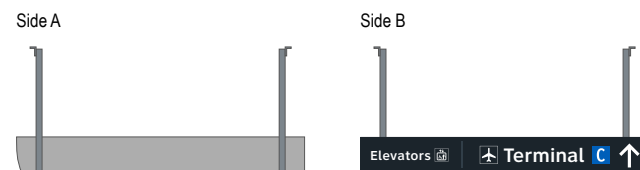

**Wayfinding Updates**

Issue Date: 08-23-2024

**Issue for Bid**

- REV. 
- REV. 
- REV. 

**WARNING:**

This record contains Sensitive Security Information that is controlled under 49 CFR parts 15 and 1520. No part of this record may be disclosed to persons with a "need to know," as defined in 49 CFR parts 15 and 1520, except with the written permission of the Administrator of the Transportation Security Administration or the Secretary of Transportation. Unauthorized release may result in civil penalty or other action. For U.S. government agencies, public disclosure is governed by 5 U.S.C. 552 and 49 CFR parts 15 and 1520.

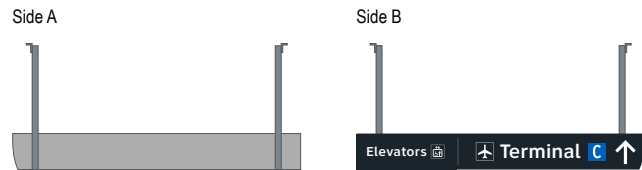


THESE SHEETS ARE ISSUED FOR GRAPHICAL INFORMATION ONLY


**8.2 MESSAGE SCHEDULE - GARAGE C: LEVEL 5 - SECTOR 1 (C WEST)**

BSG PRJCT# BSG-2024-111-IAH  
 HAS TIP # 24 -103 - IAH


S1 CG.L5-073 5-DR.31 Notes: N/A




S1 CG.L5-077 5-ID.53 Notes: N/A

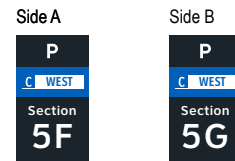


S1 CG.L5-074 5-DR.31 Notes: N/A

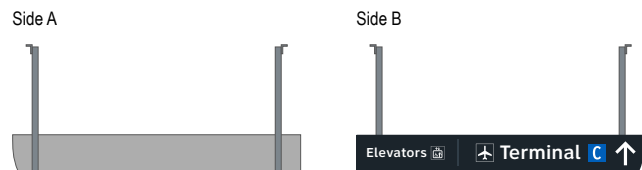


S1 CG.L5-078 5-ID.53 Notes: N/A

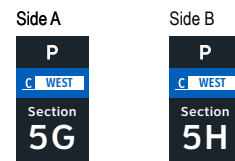


S1 CG.L5-075 5-DR.34 Notes: N/A

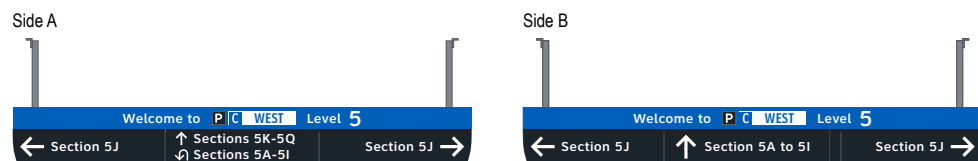


S1 CG.L5-079 5-ID.53 Notes: N/A

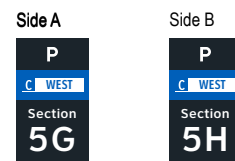


S1 CG.L5-076 5-ID.53 Notes: N/A

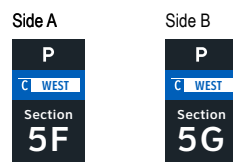


S1 CG.L5-080 5-ID.53 Notes: N/A

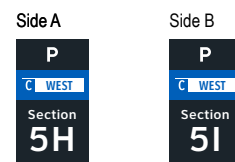


S1 CG.L5-081 5-ID.53 Notes: N/A

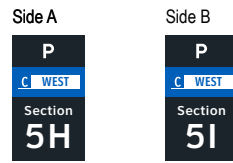


S1 CG.L5-085 5-ID.53 Notes: N/A

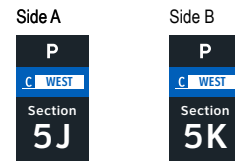


S1 CG.L5-082 5-ID.53 Notes: N/A

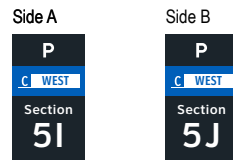


S1 CG.L5-086 5-ID.53 Notes: N/A

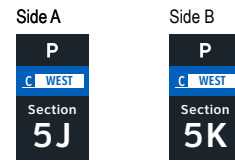


S1 CG.L5-083 5-ID.53 Notes: N/A

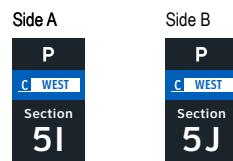


S1 CG.L5-087 5-ID.53 Notes: N/A

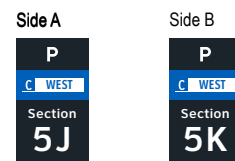


S1 CG.L5-084 5-ID.53 Notes: N/A

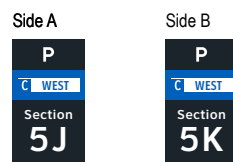


S1 CG.L5-088 5-ID.53 Notes: N/A

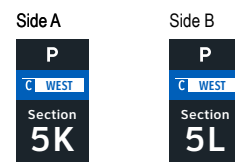


S1 CG.L5-089 5-ID.53 Notes: N/A

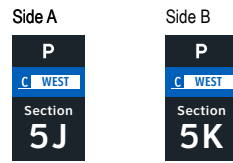


S1 CG.L5-093 5-ID.53 Notes: N/A

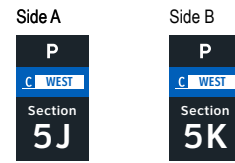


S1 CG.L5-090 5-ID.53 Notes: N/A

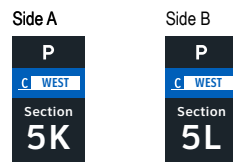


S1 CG.L5-094 5-ID.53 Notes: N/A

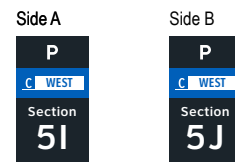


S1 CG.L5-091 5-ID.53 Notes: N/A

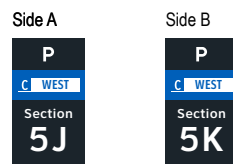


S1 CG.L5-095 5-ID.53 Notes: N/A

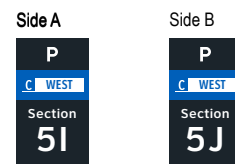


S1 CG.L5-092 5-ID.53 Notes: N/A

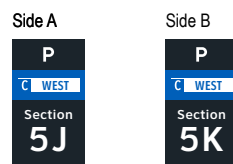


S1 CG.L5-096 5-ID.53 Notes: N/A

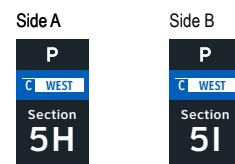


S1 CG.L5-097 5-ID.53 Notes: N/A

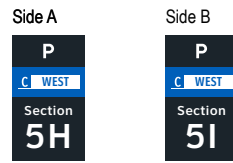


S1 CG.L5-101 5-ID.53 Notes: N/A

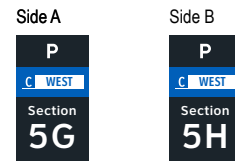


S1 CG.L5-098 5-ID.53 Notes: N/A

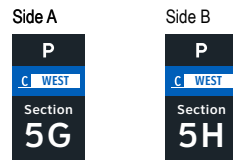


S1 CG.L5-102 5-ID.53 Notes: N/A

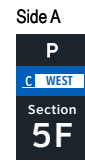


S1 CG.L5-099 5-ID.53 Notes: N/A

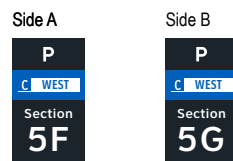


S1 CG.L5-103 5-ID.53 Notes: N/A

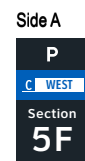


S1 CG.L5-100 5-ID.53 Notes: N/A

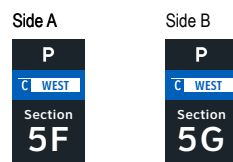


S1 CG.L5-104 5-ID.53 Notes: N/A

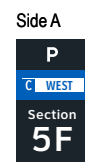


S1 CG.L5-105 5-ID.53 Notes: N/A

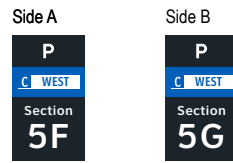


S1 CG.L5-109 5-ID.53 Notes: N/A

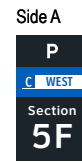


S1 CG.L5-106 5-ID.53 Notes: N/A

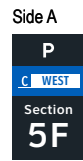


S1 CG.L5-110 5-ID.53 Notes: N/A

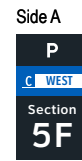


S1 CG.L5-107 5-ID.53 Notes: N/A

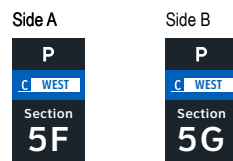


S1 CG.L5-111 5-ID.53 Notes: N/A

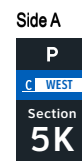


S1 CG.L5-108 5-ID.53 Notes: N/A

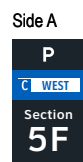


S1 CG.L5-112 5-ID.53 Notes: N/A

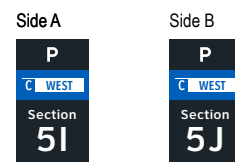


Side A

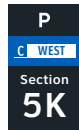


Side A

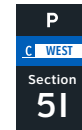


Side B

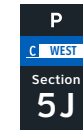


Side A

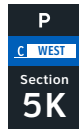


Side B

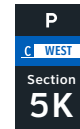


Side A

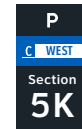

Side B

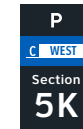


Side A

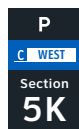


Side B



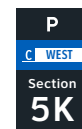
Side A




Side A

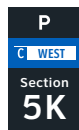

Side A

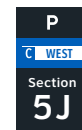

Side B

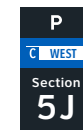

Wayfinding Updates

Issue Date: 08-23-2024  
Issue for Bid



WARNING:

This record contains Sensitive Security Information that is controlled under 49 CFR parts 15 and 1520. No part of this record may be disclosed to persons with a "need to know," as defined in 49 CFR parts 15 and 1520, except with the written permission of the Administrator of the Transportation Security Administration or the Secretary of Transportation. Unauthorized release may result in civil penalty or other action. For U.S. government agencies, public disclosure is governed by 5 U.S.C. 552 and 49 CFR parts 15 and 1520.



08-23-2024

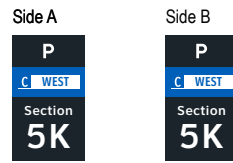
THESE SHEETS ARE ISSUED FOR GRAPHICAL INFORMATION ONLY

8.2 MESSAGE SCHEDULE - GARAGE C: LEVEL 5 - SECTOR 1 (C WEST)


BSG PRJCT# BSG-2024-111-IAH  
HAS TIP # 24 -103 - IAH




S1 CG.L5-121 5-ID.53 Notes: N/A




S1 CG.L5-125 5-ID.53 Notes: N/A

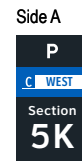


S1 CG.L5-122 5-ID.53 Notes: N/A

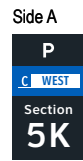


S1 CG.L5-126 5-ID.53 Notes: N/A

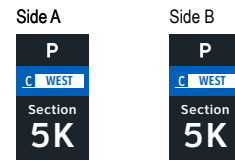


S1 CG.L5-123 5-ID.53 Notes: N/A

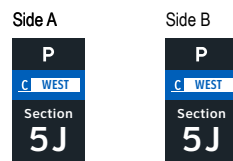


S1 CG.L5-127 5-ID.53 Notes: N/A

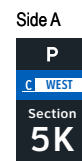


S1 CG.L5-124 5-ID.53 Notes: N/A

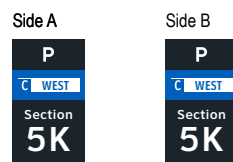


S1 CG.L5-128 5-ID.53 Notes: N/A

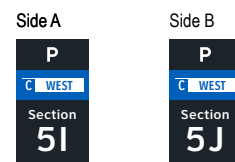

Side A

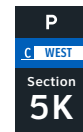


Side A

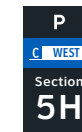

Side B



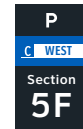Side A



Side B



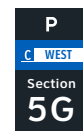
Side A




Side B



Side A



Side B

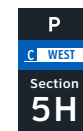


Side A




Side B



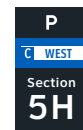
Side A



Side B

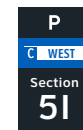


Side A

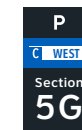


Side B



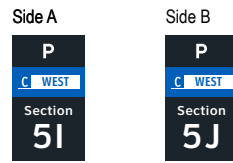
S1 CG.L5-137 5-ID.53 Notes: N/A




S1 CG.L5-141 5-ID.53 Notes: N/A

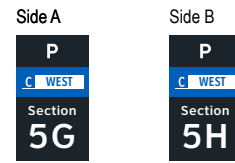


S1 CG.L5-138 5-ID.53 Notes: N/A

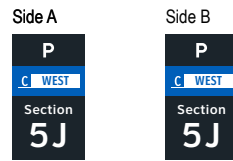


S1 CG.L5-142 5-ID.53 Notes: N/A

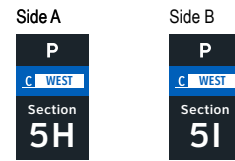


S1 CG.L5-139 5-ID.53 Notes: N/A

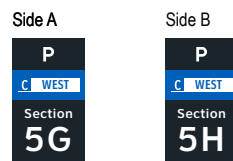


S1 CG.L5-143 5-ID.53 Notes: N/A

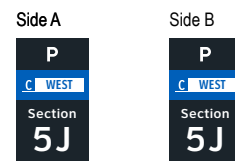


S1 CG.L5-140 5-ID.53 Notes: N/A

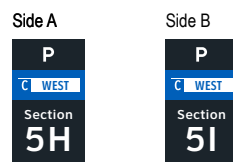


S1 CG.L5-144 5-ID.53 Notes: N/A

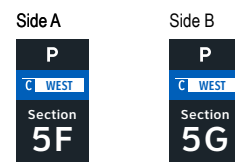


S1 CG.L5-145 5-ID.53 Notes: N/A

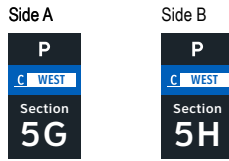


S1 CG.L5-149 5-ID.55 Notes: N/A

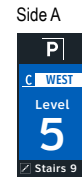


S1 CG.L5-146 5-ID.53 Notes: N/A

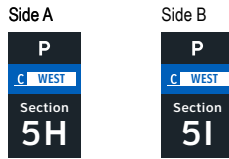


S1 CG.L5-150 5-ID.55 Notes: N/A

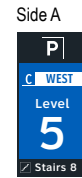

S1 CG.L5-147 5-ID.55 Notes: N/A

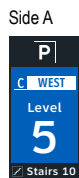


S1 CG.L5-148 5-ID.55 Notes: N/A

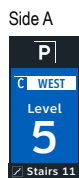

ELEVATOR CORE SIGNAGE CONTINUED ON NEXT SHEET

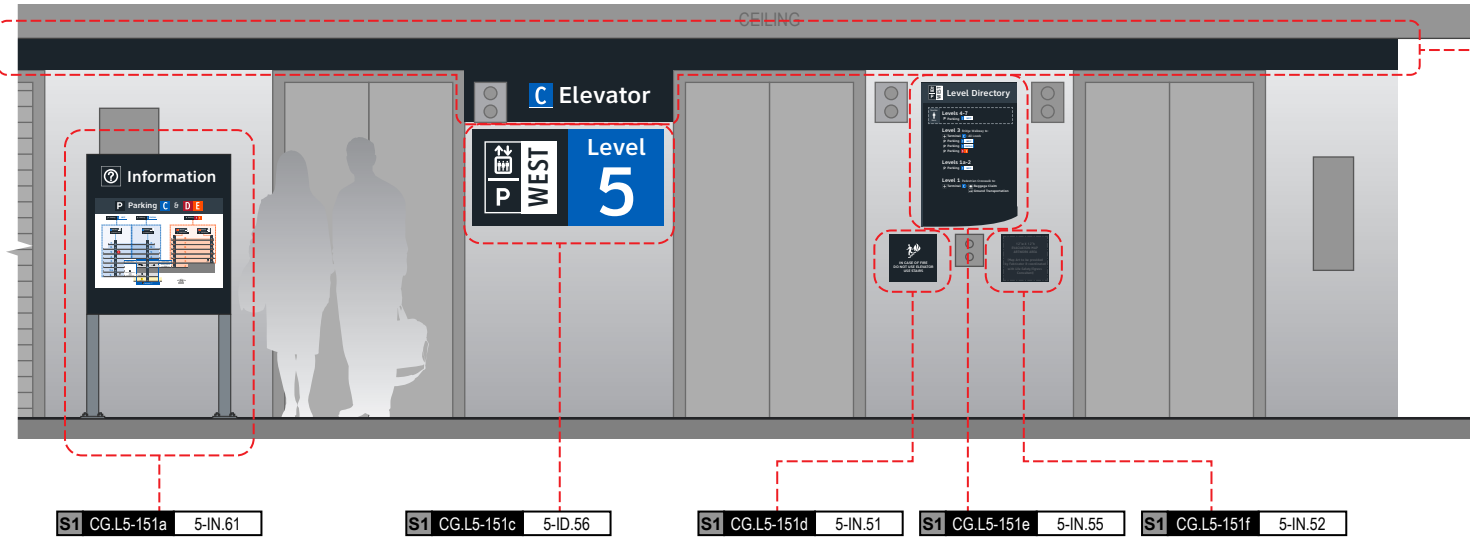Side A



- S1 CG.L5-151a 5-IN.61
- S1 CG.L5-151c 5-ID.56
- S1 CG.L5-151d 5-IN.51
- S1 CG.L5-151e 5-IN.55
- S1 CG.L5-151f 5-IN.52

NOTES: Directory artwork includes a "You Are Here" button graphic and is in a unique location per elevator core/level location; artwork included here is representative of final map artwork design intent for this location

NOTES: Level directory plaque includes a "You Are Here" graphic and is in a unique location per elevator core/level location; artwork included here is representative of final artwork design intent for this location

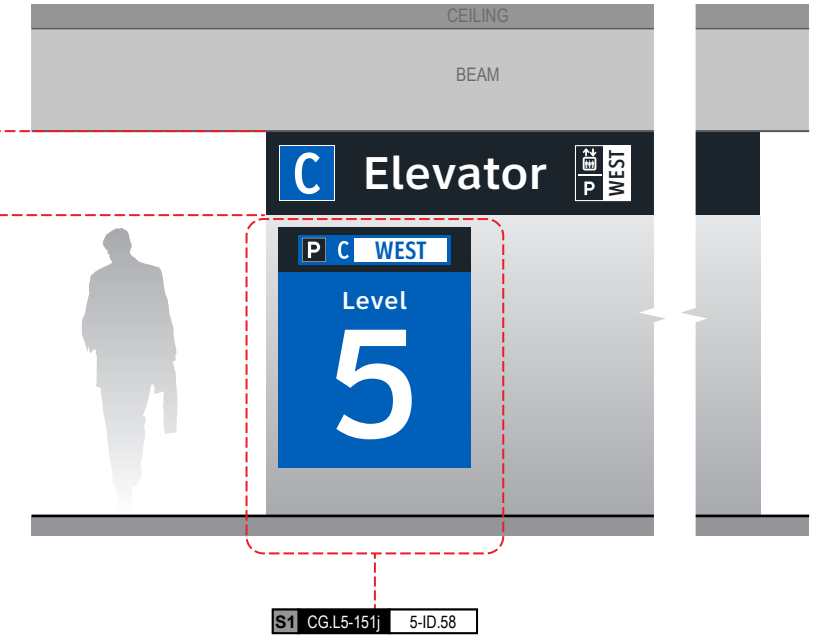
S1 CG.L5-151b 5-ID.57

NOTES: Wall paint and header graphics at front elevation only of elevator core included for this location number; wall elevation conditions shown are artistic representation based on rough site photo surveys; actual wall elevation conditions to be field verified by contractor/installer

S1 CG.L5-151g 5-ID.59


NOTES: Wall paint and header graphics on rear and two side elevations of elevator core included for this location number; wall elevation conditions shown are artistic representation based on rough site photo surveys; actual wall elevation conditions to be field verified by contractor/installer

Side C



S1 CG.L5-151j 5-ID.58

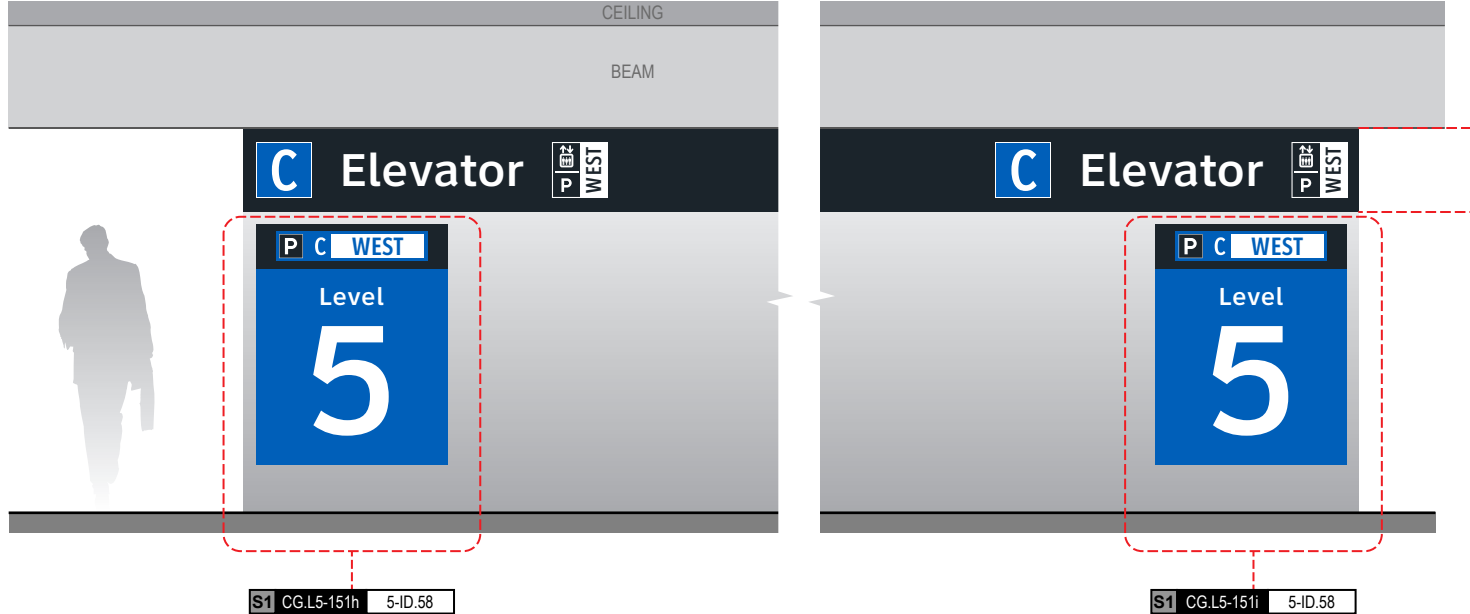
Side B



S1 CG.L5-151h 5-ID.58


S1 CG.L5-151i 5-ID.58

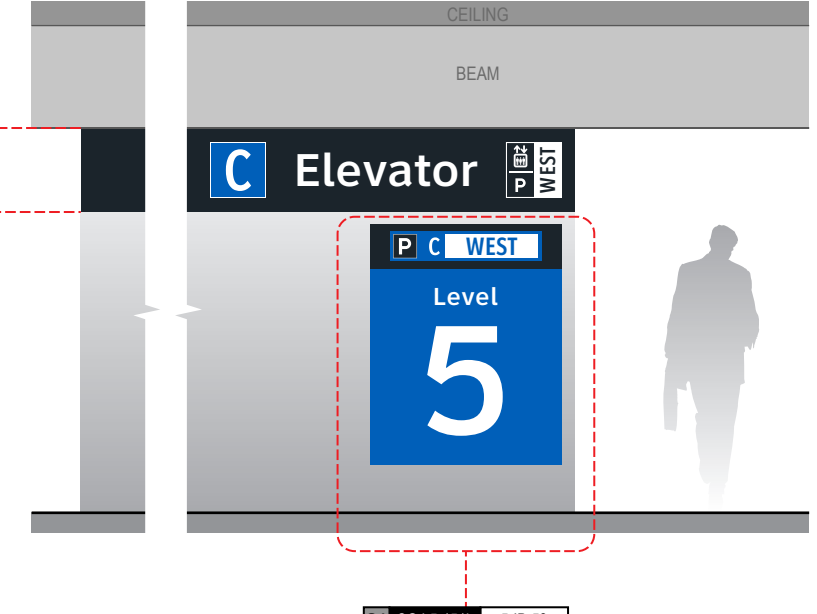Side D



S1 CG.L5-151k 5-ID.58


## END OF GARAGE C: LEVEL 5 - SECTOR 1 MESSAGES

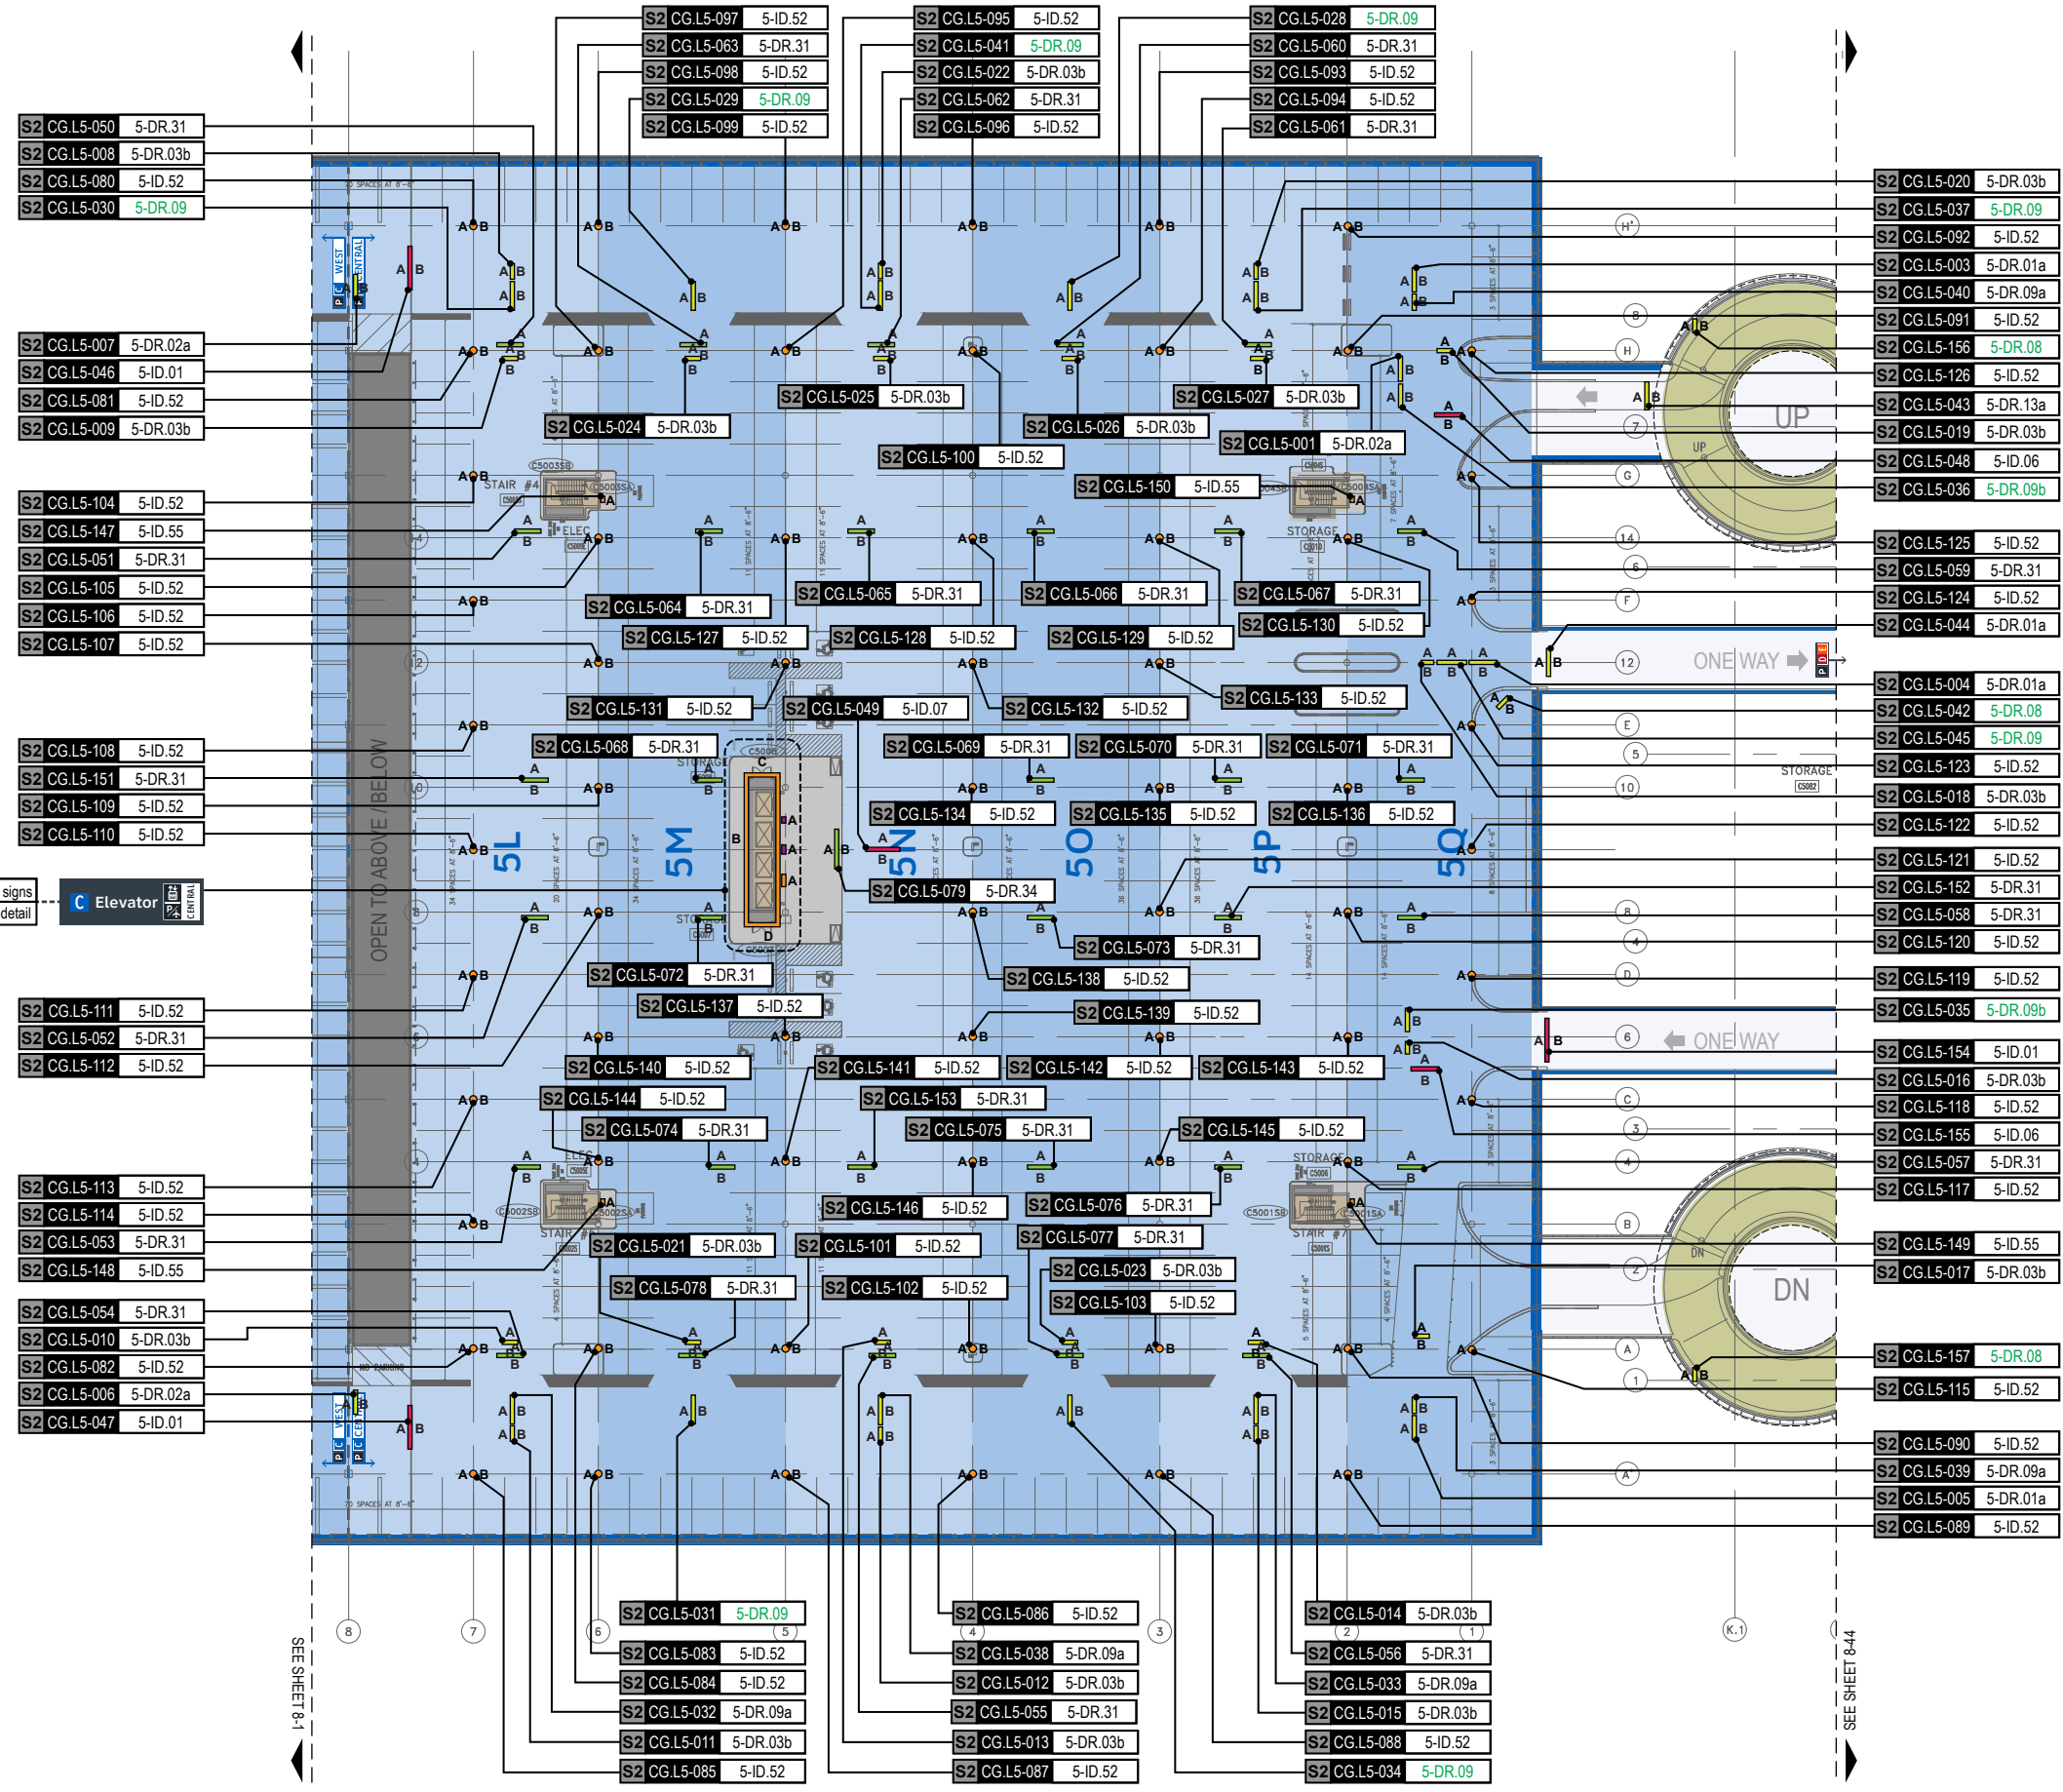

**GENERAL NOTES**

- Sign locations & orientations shown here are approximations based on the most current plan drawings as provided to the designer by the architect at the time of this document's completion. These sign locations are for general design intent & wayfinding planning purposes only. They should not be construed or deemed as absolute or final locations. Field verification, marking & documentation of each final location is to be performed by the Fabricator/Installer & coordinated with project staff & Wayfinding Design Consultants for final approval.
- All final install locations must be marked and verified in the field for proper structural integrity, adequate line of sight, utilities / property-line / other existing signage interferences & must be in complete compliance with all local, state and national codes prior to fabrication or installation.
- Adjustments to the sign locations shown in these drawings must be documented by the Fabricator/Installer, and provided to project staff & Wayfinding Design Consultants for final approval.

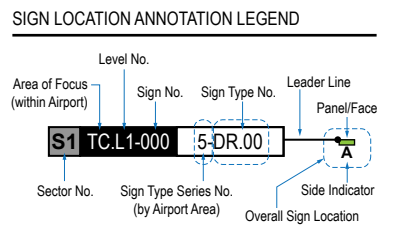**NOTE:** Only priority wayfinding signage & locations as shown in this wayfinding plan package are in scope. All other signage not shown (including traffic control) are NOT IN SCOPE for this project/contract.



**LOCATION CODE DEFINITIONS:**

**AREA OF FOCUS:** (location within Airport)

**SIGN TYPE SERIES NO.:** (by Airport Area)

TA = Terminal A  
TB = Terminal B  
TC = Terminal C  
TD = Terminal D  
TE = Terminal E  
AB = AB Garage  
CG = C Garage  
DE = DE Garage

1- = Terminals/Concourses  
2- = CBP Areas  
3- = Curbside/Ground Trans.  
4- = Roadways  
5- = Parking

**WAYFINDING SIGN TYPE:**  
DR.xx = Directional  
ID.xx = Identification  
IN.xx = Informational

**WAYFINDING SIGN LOCATIONS - Parking:**

**PEDESTRIAN Signs:**

- A = Directional (DR)
- B = Identification (ID)
- C = Informational (IN)

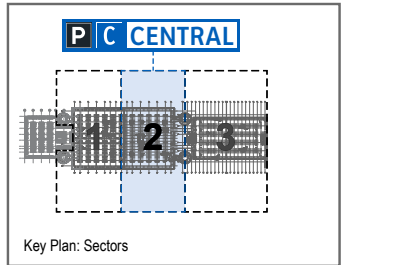
**VEHICULAR Signs:**

- A = Directional (DR)
- B = Identification (ID)
- C = Informational (IN)


**CIRCULATION:**

- Public Use PEDESTRIAN Vertical Circulation (i.e. Elevators/Escalators/Stairs)
- Public Use VEHICULAR Vertical Circulation (i.e. Ramps)
- Alpha-Numeric Parking Section Naming Areas (Blues = C Garages; Oranges = D/E Garage)
- Areas Not In Scope for this Package


**LOCATION PLAN SCALE: 1" = 60'**



S2 CG.L5-001 5-DR.02a Notes: N/A

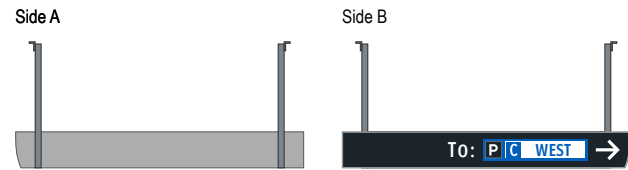


S2 CG.L5-005 5-DR.01a Notes: N/A

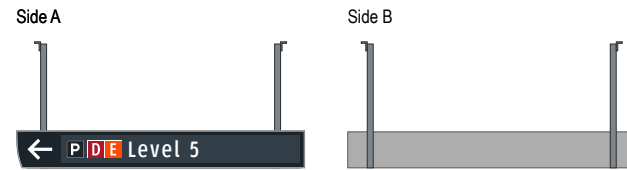


S2 CG.L5-002 N/A Notes: N/A

NOT USED

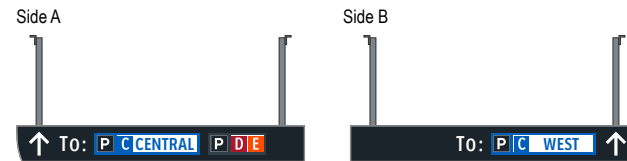
S2 CG.L5-006 5-DR.02a Notes: N/A




S2 CG.L5-003 5-DR.01a Notes: N/A

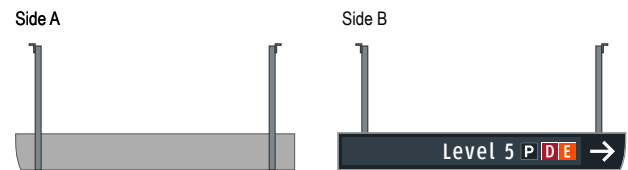


S2 CG.L5-007 5-DR.02a Notes: N/A

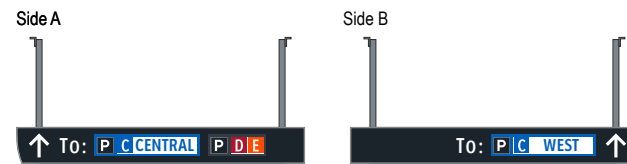

S2 CG.L5-004 5-DR.01a Notes: N/A

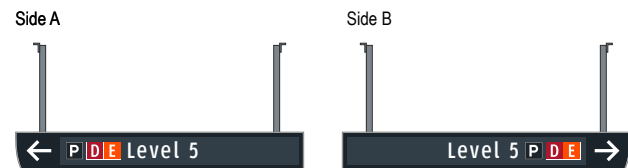

S2 CG.L5-008 5-DR.03b Notes: N/A

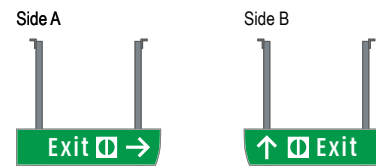

**Wayfinding Updates**

Issue Date: 08-23-2024

**Issue for Bid**

- REV. 
- REV. 
- REV. 

**WARNING:**

This record contains Sensitive Security Information that is controlled under 49 CFR parts 15 and 1520. No part of this record may be disclosed to persons with a "need to know," as defined in 49 CFR parts 15 and 1520, except with the written permission of the Administrator of the Transportation Security Administration or the Secretary of Transportation. Unauthorized release may result in civil penalty or other action. For U.S. government agencies, public disclosure is governed by 5 U.S.C. 552 and 49 CFR parts 15 and 1520.



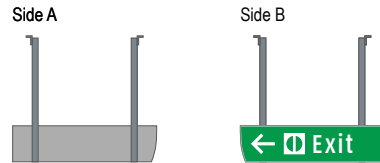
08-23-2024

**8.4 MESSAGE SCHEDULE - GARAGE C: LEVEL 5 - SECTOR 2 (C CENTRAL)**


THESE SHEETS ARE ISSUED FOR GRAPHICAL INFORMATION ONLY

BSG PRJCT# BSG-2024-111-IAH  
 HAS TIP # 24 -103 - IAH


S2 CG.L5-009 5-DR.03b Notes: N/A




S2 CG.L5-013 5-DR.03b Notes: N/A

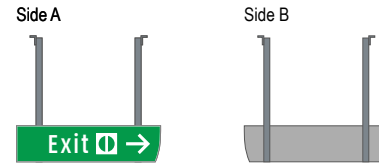


S2 CG.L5-010 5-DR.03b Notes: N/A

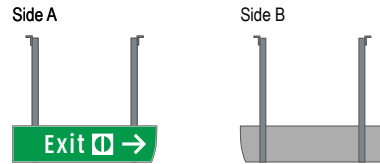


S2 CG.L5-014 5-DR.03b Notes: N/A

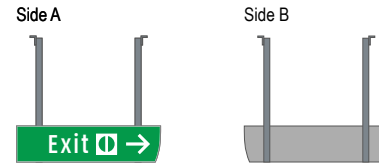


S2 CG.L5-011 5-DR.03b Notes: N/A

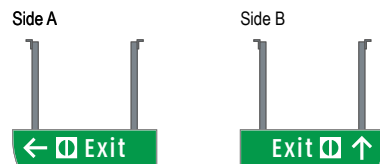


S2 CG.L5-015 5-DR.03b Notes: N/A

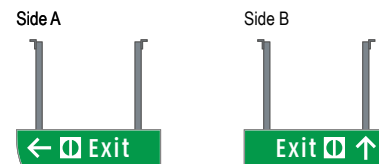

S2 CG.L5-012 5-DR.03b Notes: N/A

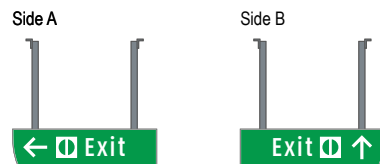


S2 CG.L5-016 5-DR.03b Notes: N/A

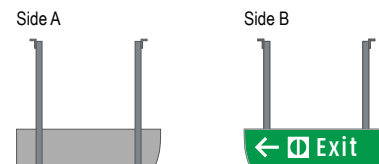





S2 CG.L5-017 5-DR.03b Notes: N/A

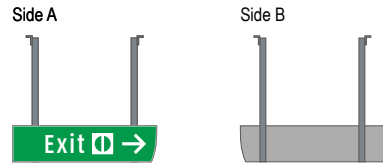


S2 CG.L5-021 5-DR.03b Notes: N/A

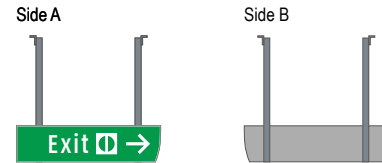


S2 CG.L5-018 5-DR.03b Notes: N/A

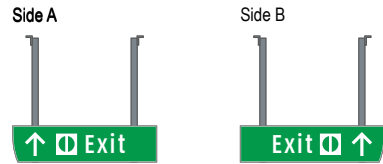


S2 CG.L5-022 5-DR.03b Notes: N/A

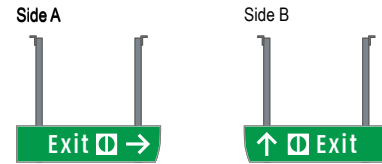


S2 CG.L5-019 5-DR.03b Notes: N/A

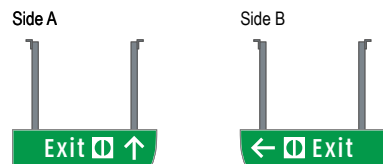


S2 CG.L5-023 5-DR.03b Notes: N/A

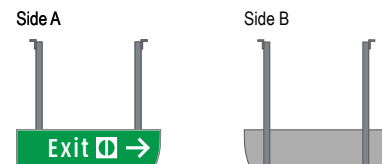

S2 CG.L5-020 5-DR.03b Notes: N/A

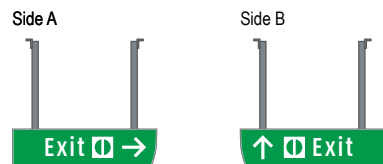

S2 CG.L5-024 5-DR.03b Notes: N/A

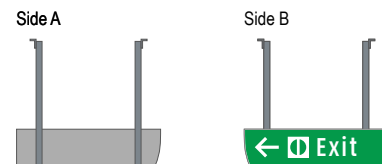

**Wayfinding Updates**

Issue Date: 08-23-2024

**Issue for Bid**

- REV. 
- REV. 
- REV. 

**WARNING:**

This record contains Sensitive Security Information that is controlled under 49 CFR parts 15 and 1520. No part of this record may be disclosed to persons with a "need to know," as defined in 49 CFR parts 15 and 1520, except with the written permission of the Administrator of the Transportation Security Administration or the Secretary of Transportation. Unauthorized release may result in civil penalty or other action. For U.S. government agencies, public disclosure is governed by 5 U.S.C. 552 and 49 CFR parts 15 and 1520.



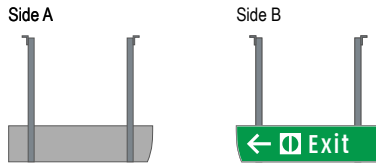
08-23-2024

**8.4 MESSAGE SCHEDULE - GARAGE C: LEVEL 5 - SECTOR 2 (C CENTRAL)**


THESE SHEETS ARE ISSUED FOR GRAPHICAL INFORMATION ONLY

BSG PRJCT# BSG-2024-111-IAH  
 HAS TIP # 24 -103 - IAH


S2 CG.L5-025 5-DR.03b Notes: N/A




S2 CG.L5-029 5-DR.09 Notes: N/A

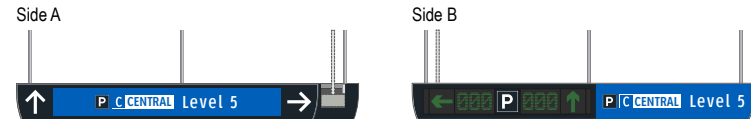


S2 CG.L5-026 5-DR.03b Notes: N/A

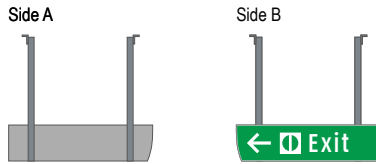


S2 CG.L5-030 5-DR.09 Notes: N/A

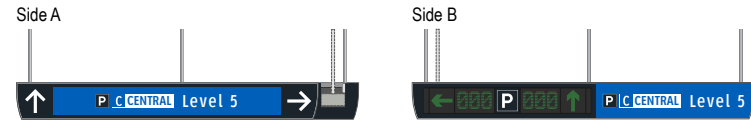


S2 CG.L5-027 5-DR.03b Notes: N/A

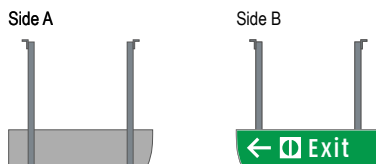


S2 CG.L5-031 5-DR.09 Notes: N/A

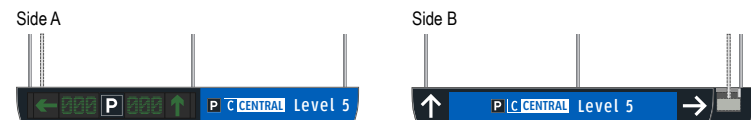


S2 CG.L5-028 5-DR.09 Notes: N/A

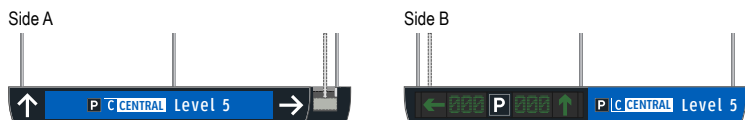


S2 CG.L5-032 5-DR.09a Notes: N/A

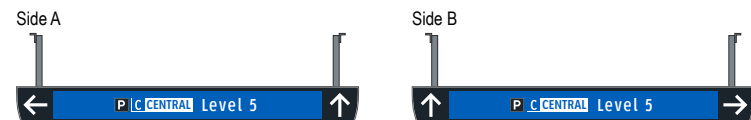


S2 CG.L5-033 5-DR.09a Notes: N/A

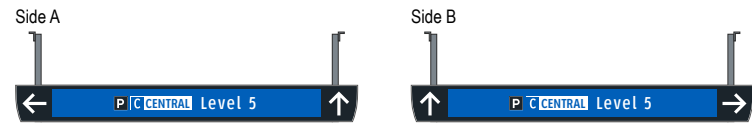


S2 CG.L5-037 5-DR.09 Notes: N/A

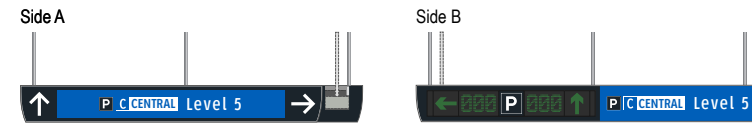


S2 CG.L5-034 5-DR.09 Notes: N/A

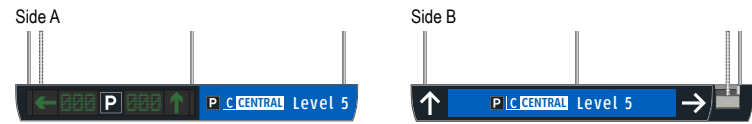


S2 CG.L5-038 5-DR.09a Notes: N/A

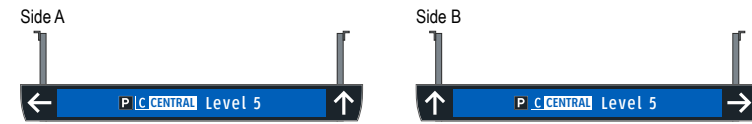


S2 CG.L5-035 5-DR.09b Notes: N/A

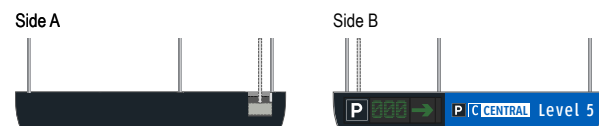


S2 CG.L5-039 5-DR.09a Notes: N/A

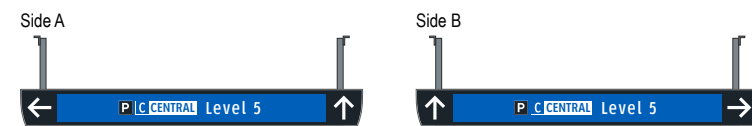

S2 CG.L5-036 5-DR.09b Notes: N/A

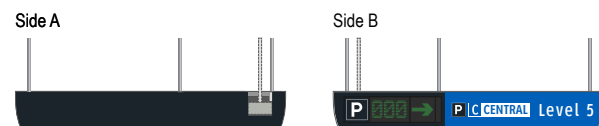

S2 CG.L5-040 5-DR.09a Notes: N/A

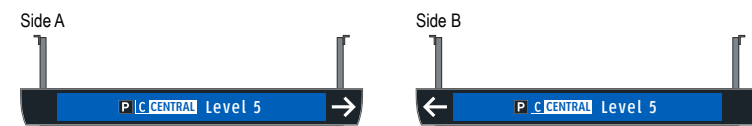

**Wayfinding Updates**

Issue Date: 08-23-2024  
Issue for Bid

- REV. 
- REV. 
- REV. 

**WARNING:**

This record contains Sensitive Security Information that is controlled under 49 CFR parts 15 and 1520. No part of this record may be disclosed to persons with a "need to know," as defined in 49 CFR parts 15 and 1520, except with the written permission of the Administrator of the Transportation Security Administration or the Secretary of Transportation. Unauthorized release may result in civil penalty or other action. For U.S. government agencies, public disclosure is governed by 5 U.S.C. 552 and 49 CFR parts 15 and 1520.



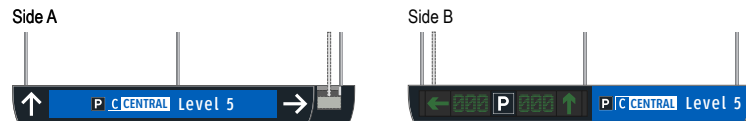
08-23-2024

THESE SHEETS ARE ISSUED FOR GRAPHICAL INFORMATION ONLY


**8.4 MESSAGE SCHEDULE - GARAGE C: LEVEL 5 - SECTOR 2 (C CENTRAL)**

BSG PRJCT# BSG-2024-111-IAH  
HAS TIP # 24 -103 - IAH

S2 CG.L5-041 5-DR.09 Notes: N/A




S2 CG.L5-045 5-DR.09 Notes: N/A

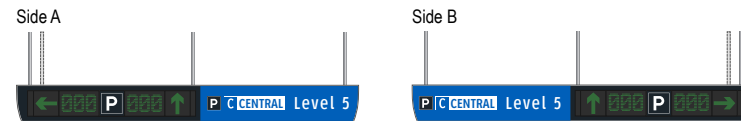


S2 CG.L5-042 5-DR.08 Notes: N/A



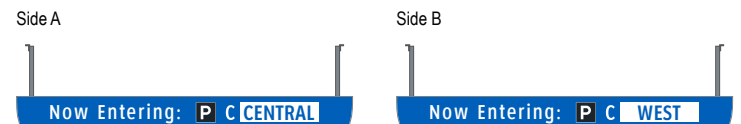
S2 CG.L5-046 5-ID.01 Notes: N/A




S2 CG.L5-043 5-DR.13a Notes: N/A

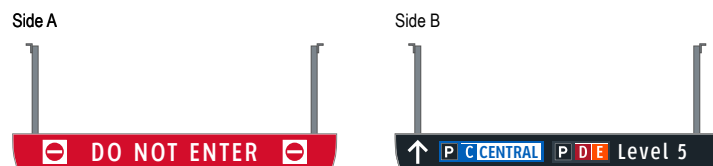


S2 CG.L5-047 5-ID.01 Notes: N/A

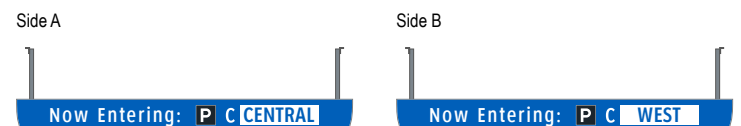


S2 CG.L5-044 5-DR.01a Notes: N/A

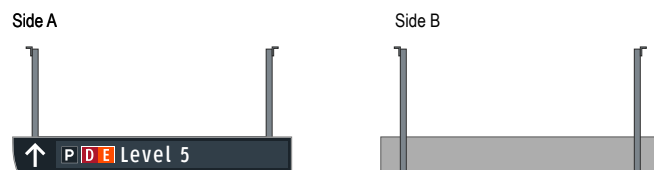


S2 CG.L5-048 5-ID.06 Notes: N/A

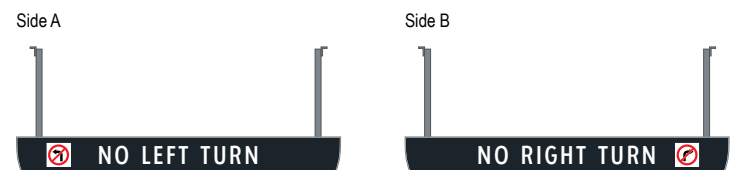


S2 CG.L5-049 5-ID.07 Notes: N/A

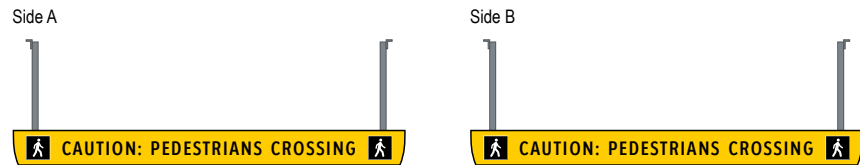


S2 CG.L5-053 5-DR.31 Notes: N/A

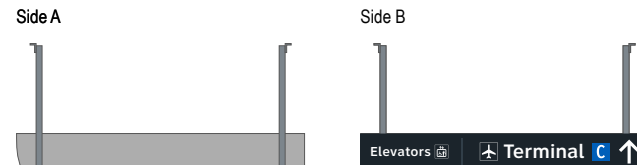


S2 CG.L5-050 5-DR.31 Notes: N/A

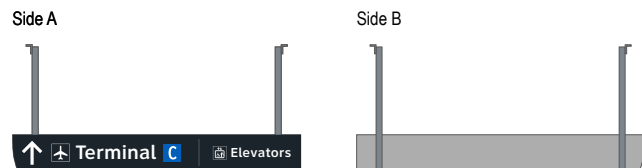


S2 CG.L5-054 5-DR.31 Notes: N/A

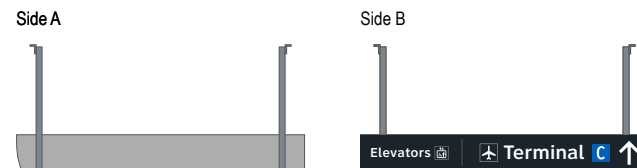


S2 CG.L5-051 5-DR.31 Notes: Notes: N/A

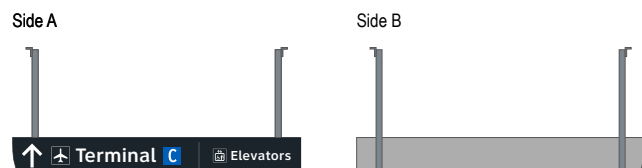


S2 CG.L5-055 5-DR.31 Notes: N/A

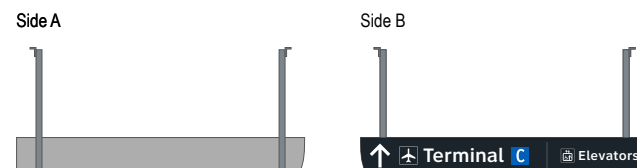

S2 CG.L5-052 5-DR.31 Notes: N/A

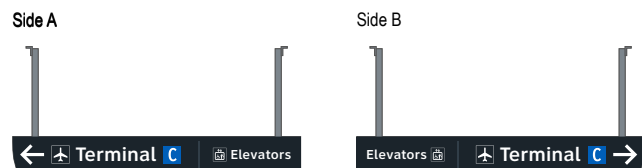

S2 CG.L5-056 5-DR.31 Notes: N/A

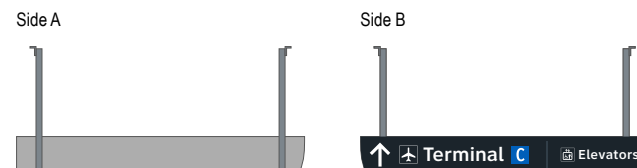

Wayfinding Updates

Issue Date: 08-23-2024

Issue for Bid

- REV.
- REV.
- REV.

WARNING:

This record contains Sensitive Security Information that is controlled under 49 CFR parts 15 and 1520. No part of this record may be disclosed to persons with a "need to know," as defined in 49 CFR parts 15 and 1520, except with the written permission of the Administrator of the Transportation Security Administration or the Secretary of Transportation. Unauthorized release may result in civil penalty or other action. For U.S. government agencies, public disclosure is governed by 5 U.S.C. 552 and 49 CFR parts 15 and 1520.



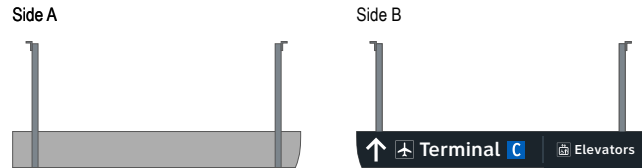
08-23-2024

8.4 MESSAGE SCHEDULE - GARAGE C: LEVEL 5 - SECTOR 2 (C CENTRAL)


THESE SHEETS ARE ISSUED FOR GRAPHICAL INFORMATION ONLY

BSG PRJCT# BSG-2024-111-IAH  
 HAS TIP # 24 -103 - IAH


S2 CG.L5-057 5-DR.31 Notes: N/A




S2 CG.L5-061 5-DR.31 Notes: N/A

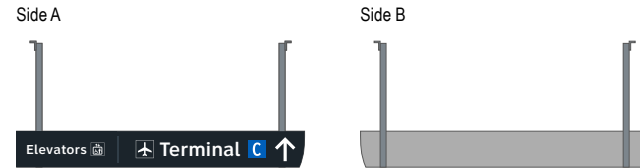


S2 CG.L5-058 5-DR.31 Notes: N/A

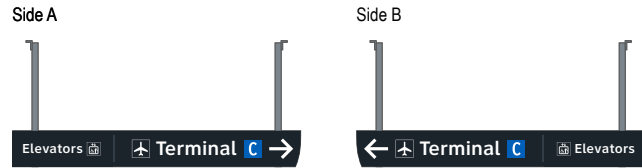


S2 CG.L5-062 5-DR.31 Notes: N/A

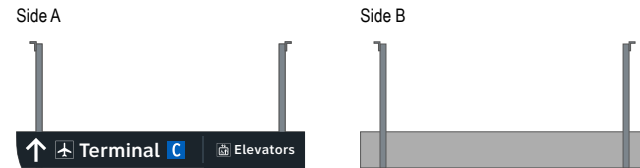


S2 CG.L5-059 5-DR.31 Notes: N/A

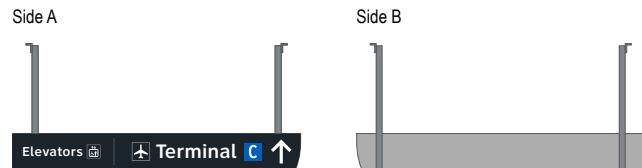


S2 CG.L5-063 5-DR.31 Notes: N/A

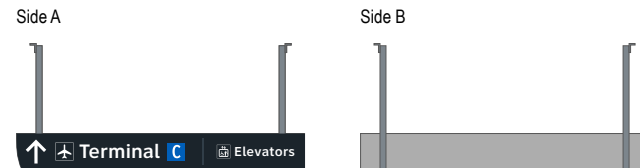

S2 CG.L5-060 5-DR.31 Notes: N/A

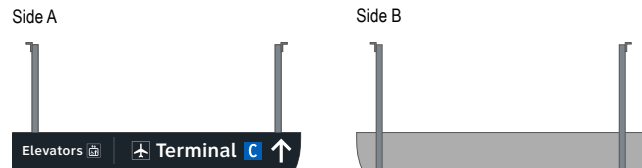

S2 CG.L5-064 5-DR.31 Notes: N/A

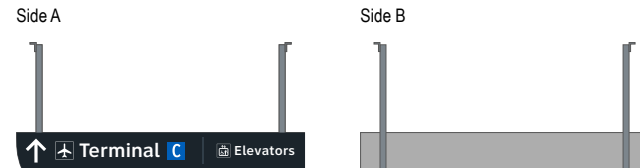

**Wayfinding Updates**

Issue Date: 08-23-2024

**Issue for Bid**

- REV. 
- REV. 
- REV. 

**WARNING:**

This record contains Sensitive Security Information that is controlled under 49 CFR parts 15 and 1520. No part of this record may be disclosed to persons with a "need to know," as defined in 49 CFR parts 15 and 1520, except with the written permission of the Administrator of the Transportation Security Administration or the Secretary of Transportation. Unauthorized release may result in civil penalty or other action. For U.S. government agencies, public disclosure is governed by 5 U.S.C. 552 and 49 CFR parts 15 and 1520.

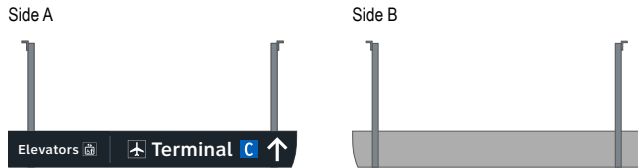


**8.4 MESSAGE SCHEDULE - GARAGE C: LEVEL 5 - SECTOR 2 (C CENTRAL)**


THESE SHEETS ARE ISSUED FOR GRAPHICAL INFORMATION ONLY

BSG PRJCT# BSG-2024-111-IAH  
 HAS TIP # 24 -103 - IAH


S2 CG.L5-065 5-DR.31 Notes: N/A




S2 CG.L5-069 5-DR.31 Notes: N/A

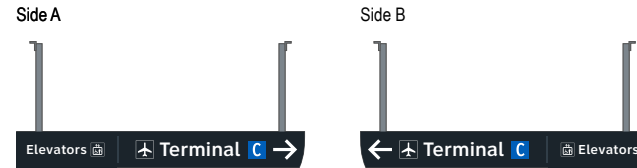


S2 CG.L5-066 5-DR.31 Notes: N/A

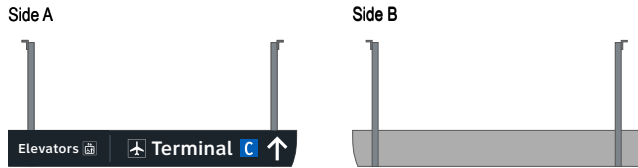


S2 CG.L5-070 5-DR.31 Notes: N/A

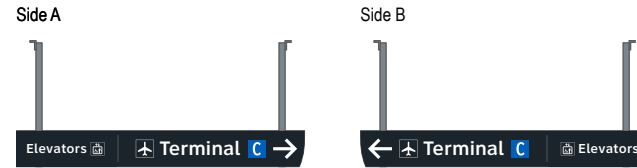


S2 CG.L5-067 5-DR.31 Notes: N/A

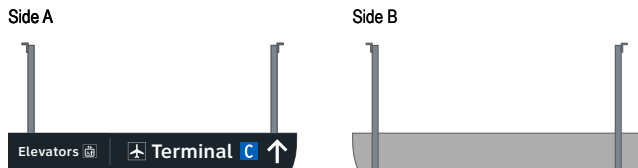


S2 CG.L5-071 5-DR.31 Notes: N/A

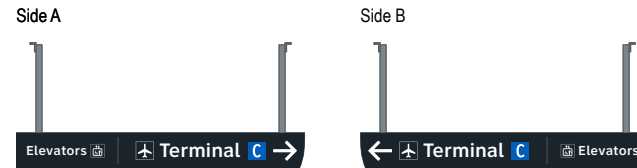

S2 CG.L5-068 5-DR.31 Notes: N/A

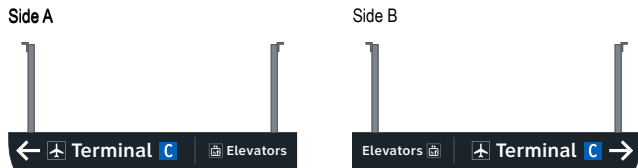

S2 CG.L5-072 5-DR.31 Notes: N/A

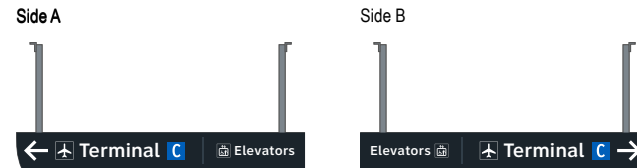

**Wayfinding Updates**

Issue Date: 08-23-2024

**Issue for Bid**

- REV. 
- REV. 
- REV. 

**WARNING:**

This record contains Sensitive Security Information that is controlled under 49 CFR parts 15 and 1520. No part of this record may be disclosed to persons with a "need to know," as defined in 49 CFR parts 15 and 1520, except with the written permission of the Administrator of the Transportation Security Administration or the Secretary of Transportation. Unauthorized release may result in civil penalty or other action. For U.S. government agencies, public disclosure is governed by 5 U.S.C. 552 and 49 CFR parts 15 and 1520.



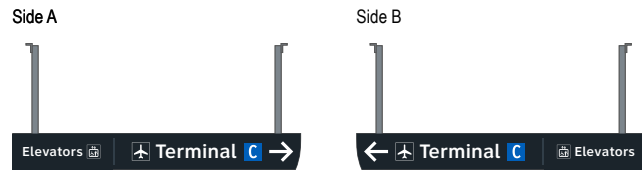
08-23-2024

**8.4 MESSAGE SCHEDULE - GARAGE C: LEVEL 5 - SECTOR 2 (C CENTRAL)**


THESE SHEETS ARE ISSUED FOR GRAPHICAL INFORMATION ONLY

BSG PRJCT# BSG-2024-111-IAH  
 HAS TIP # 24 -103 - IAH


S2 CG.L5-073 5-DR.31 Notes: N/A




S2 CG.L5-077 5-DR.31 Notes: N/A

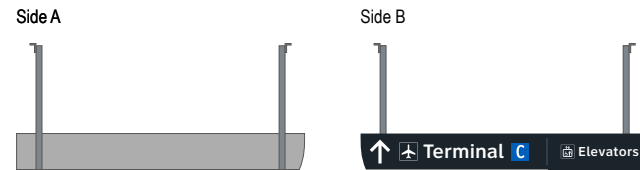


S2 CG.L5-074 5-DR.31 Notes: N/A

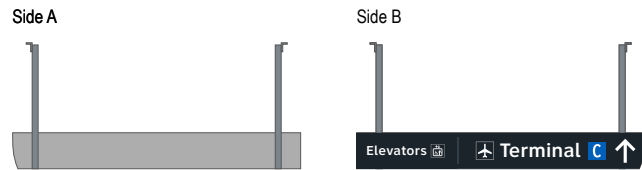


S2 CG.L5-078 5-DR.31 Notes: N/A

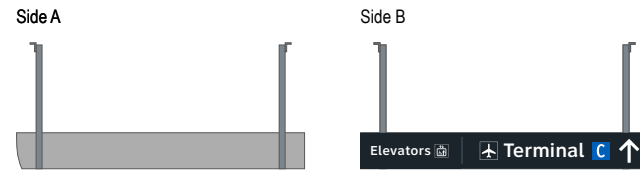


S2 CG.L5-075 5-DR.31 Notes: N/A

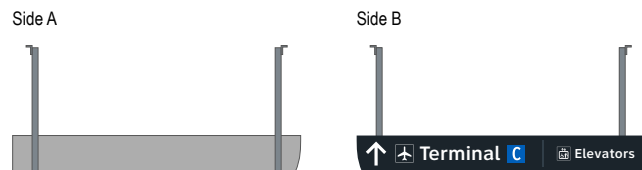


S2 CG.L5-079 5-DR.34 Notes: N/A

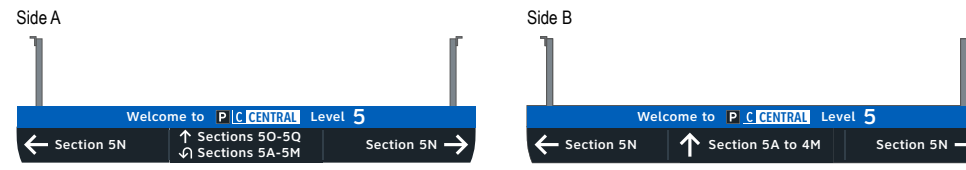

S2 CG.L5-076 5-DR.31 Notes: N/A

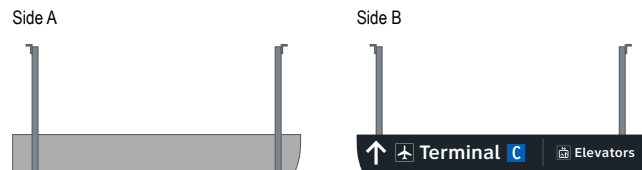

S2 CG.L5-080 5-ID.52 Notes: N/A

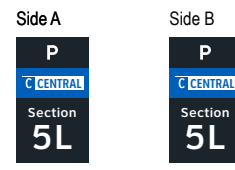

**Wayfinding Updates**

Issue Date: 08-23-2024

**Issue for Bid**

- REV. 
- REV. 
- REV. 

**WARNING:**

This record contains Sensitive Security Information that is controlled under 49 CFR parts 15 and 1520. No part of this record may be disclosed to persons with a "need to know," as defined in 49 CFR parts 15 and 1520, except with the written permission of the Administrator of the Transportation Security Administration or the Secretary of Transportation. Unauthorized release may result in civil penalty or other action. For U.S. government agencies, public disclosure is governed by 5 U.S.C. 552 and 49 CFR parts 15 and 1520.



08-23-2024

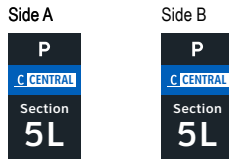
**8.4 MESSAGE SCHEDULE - GARAGE C: LEVEL 5 - SECTOR 2 (C CENTRAL)**

THESE SHEETS ARE ISSUED FOR GRAPHICAL INFORMATION ONLY


BSG PRJCT# BSG-2024-111-IAH  
 HAS TIP # 24 -103 - IAH




S2 CG.L5-081 5-ID.52 Notes: N/A




S2 CG.L5-085 5-ID.52 Notes: N/A

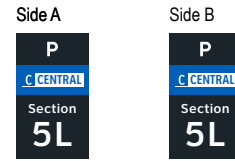


S2 CG.L5-082 5-ID.52 Notes: N/A

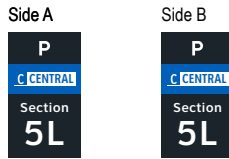


S2 CG.L5-086 5-ID.52 Notes: N/A

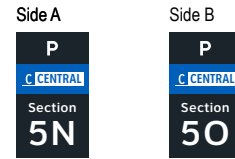


S2 CG.L5-083 5-ID.52 Notes: N/A

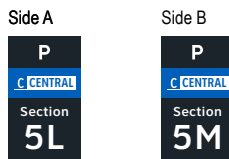


S2 CG.L5-087 5-ID.52 Notes: N/A

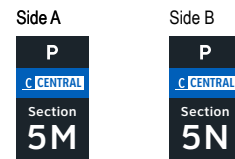


S2 CG.L5-084 5-ID.52 Notes: N/A

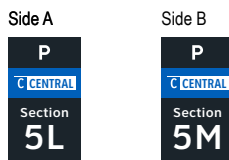


S2 CG.L5-088 5-ID.52 Notes: N/A

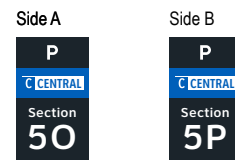


S2 CG.L5-089 5-ID.52 Notes: N/A

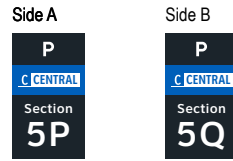


S2 CG.L5-093 5-ID.52 Notes: N/A

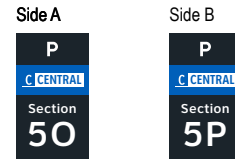


S2 CG.L5-090 5-ID.52 Notes: N/A

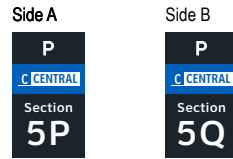


S2 CG.L5-094 5-ID.52 Notes: N/A

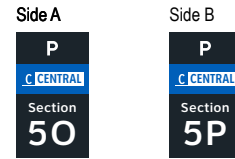


S2 CG.L5-091 5-ID.52 Notes: N/A

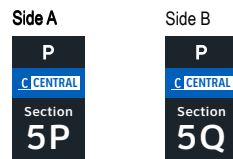


S2 CG.L5-095 5-ID.52 Notes: N/A

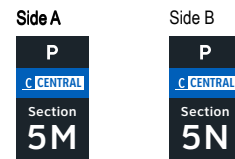

S2 CG.L5-092 5-ID.52 Notes: N/A

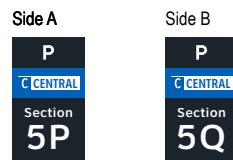

S2 CG.L5-096 5-ID.52 Notes: N/A

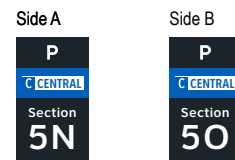

**Wayfinding Updates**

Issue Date: 08-23-2024

Issue for Bid

- REV. 
- REV. 
- REV. 

**WARNING:**

This record contains Sensitive Security Information that is controlled under 49 CFR parts 15 and 1520. No part of this record may be disclosed to persons with a "need to know," as defined in 49 CFR parts 15 and 1520, except with the written permission of the Administrator of the Transportation Security Administration or the Secretary of Transportation. Unauthorized release may result in civil penalty or other action. For U.S. government agencies, public disclosure is governed by 5 U.S.C. 552 and 49 CFR parts 15 and 1520.



08-23-2024

**8.4 MESSAGE SCHEDULE - GARAGE C: LEVEL 5 - SECTOR 2 (C CENTRAL)**

THESE SHEETS ARE ISSUED FOR GRAPHICAL INFORMATION ONLY

BSG PRJCT# BSG-2024-111-IAH  
HAS TIP # 24 -103 - IAH

S2 CG.L5-097 5-ID.52 Notes: N/A

Side A	Side B
<b>P</b>	<b>P</b>
<b>C CENTRAL</b>	<b>C CENTRAL</b>
Section	Section
<b>5L</b>	<b>5M</b>

S2 CG.L5-101 5-ID.52 Notes: N/A

Side A	Side B
<b>P</b>	<b>P</b>
<b>C CENTRAL</b>	<b>C CENTRAL</b>
Section	Section
<b>5M</b>	<b>5N</b>

S2 CG.L5-098 5-ID.52 Notes: N/A

Side A	Side B
<b>P</b>	<b>P</b>
<b>C CENTRAL</b>	<b>C CENTRAL</b>
Section	Section
<b>5L</b>	<b>5M</b>

S2 CG.L5-102 5-ID.52 Notes: N/A

Side A	Side B
<b>P</b>	<b>P</b>
<b>C CENTRAL</b>	<b>C CENTRAL</b>
Section	Section
<b>5N</b>	<b>5O</b>

S2 CG.L5-099 5-ID.52 Notes: N/A

Side A	Side B
<b>P</b>	<b>P</b>
<b>C CENTRAL</b>	<b>C CENTRAL</b>
Section	Section
<b>5M</b>	<b>5N</b>

S2 CG.L5-103 5-ID.52 Notes: N/A

Side A	Side B
<b>P</b>	<b>P</b>
<b>C CENTRAL</b>	<b>C CENTRAL</b>
Section	Section
<b>5O</b>	<b>5P</b>

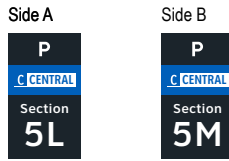
S2 CG.L5-100 5-ID.52 Notes: N/A

Side A	Side B
<b>P</b>	<b>P</b>
<b>C CENTRAL</b>	<b>C CENTRAL</b>
Section	Section
<b>5N</b>	<b>5O</b>


S2 CG.L5-104 5-ID.52 Notes: N/A

Side A	Side B
<b>P</b>	<b>P</b>
<b>C CENTRAL</b>	<b>C CENTRAL</b>
Section	Section
<b>5L</b>	<b>5L</b>


S2 CG.L5-105 5-ID.52 Notes: N/A




S2 CG.L5-109 5-ID.52 Notes: N/A

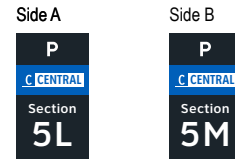


S2 CG.L5-106 5-ID.52 Notes: N/A

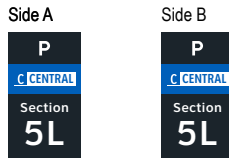


S2 CG.L5-110 5-ID.52 Notes: N/A

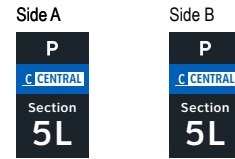


S2 CG.L5-107 5-ID.52 Notes: N/A

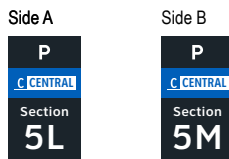


S2 CG.L5-111 5-ID.52 Notes: N/A

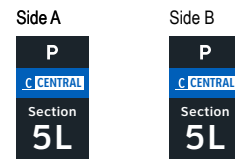

S2 CG.L5-108 5-ID.52 Notes: N/A

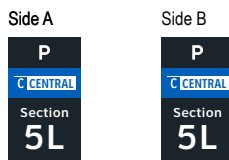

S2 CG.L5-112 5-ID.52 Notes: N/A

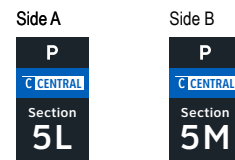

**Wayfinding Updates**

Issue Date: 08-23-2024  
Issue for Bid

- REV. 
- REV. 
- REV. 

**WARNING:**

This record contains Sensitive Security Information that is controlled under 49 CFR parts 15 and 1520. No part of this record may be disclosed to persons with a "need to know," as defined in 49 CFR parts 15 and 1520, except with the written permission of the Administrator of the Transportation Security Administration or the Secretary of Transportation. Unauthorized release may result in civil penalty or other action. For U.S. government agencies, public disclosure is governed by 5 U.S.C. 552 and 49 CFR parts 15 and 1520.



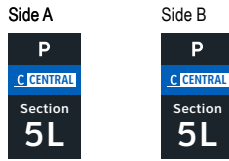
08-23-2024

**8.4 MESSAGE SCHEDULE - GARAGE C: LEVEL 5 - SECTOR 2 (C CENTRAL)**


THESE SHEETS ARE ISSUED FOR GRAPHICAL INFORMATION ONLY

BSG PRJCT# BSG-2024-111-IAH  
HAS TIP # 24 -103 - IAH


S2 CG.L5-113 5-ID.52 Notes: N/A




S2 CG.L5-117 5-ID.52 Notes: N/A

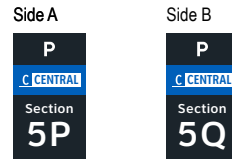


S2 CG.L5-114 5-ID.52 Notes: N/A

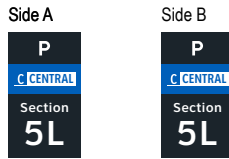


S2 CG.L5-118 5-ID.52 Notes: N/A

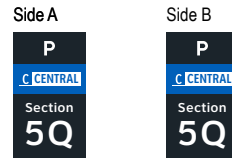

S2 CG.L5-115 5-ID.52 Notes: N/A

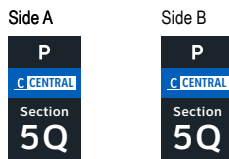


S2 CG.L5-119 5-ID.52 Notes: N/A

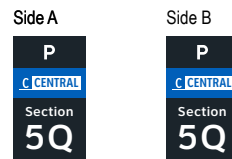


S2 CG.L5-116 N/A Notes: N/A

NOT USED

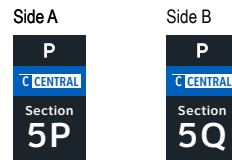
S2 CG.L5-120 5-ID.52 Notes: N/A




S2 CG.L5-121 5-ID.52 Notes: N/A

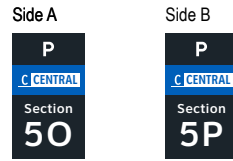


S2 CG.L5-125 5-ID.52 Notes: N/A

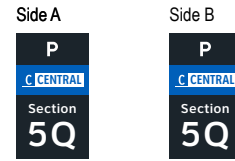


S2 CG.L5-122 5-ID.52 Notes: N/A

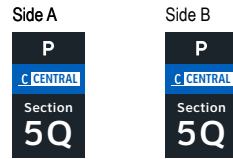


S2 CG.L5-126 5-ID.52 Notes: N/A

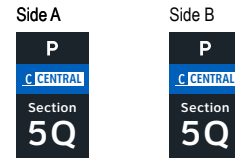


S2 CG.L5-123 5-ID.52 Notes: N/A

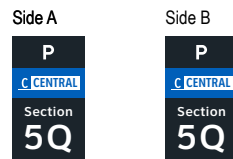


S2 CG.L5-127 5-ID.52 Notes: N/A

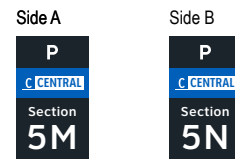

S2 CG.L5-124 5-ID.52 Notes: N/A

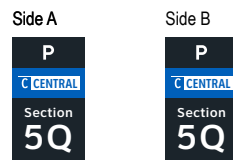

S2 CG.L5-128 5-ID.52 Notes: N/A

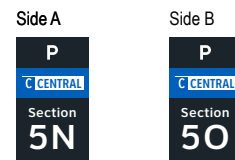

Side A	Side B
<b>P</b> C CENTRAL Section <b>50</b>	<b>P</b> C CENTRAL Section <b>5P</b>

Side A	Side B
<b>P</b> C CENTRAL Section <b>50</b>	<b>P</b> C CENTRAL Section <b>5P</b>

Side A	Side B
<b>P</b> C CENTRAL Section <b>5P</b>	<b>P</b> C CENTRAL Section <b>5Q</b>

Side A	Side B
<b>P</b> C CENTRAL Section <b>5N</b>	<b>P</b> C CENTRAL Section <b>5O</b>


Side A	Side B
<b>P</b> C CENTRAL Section <b>5M</b>	<b>P</b> C CENTRAL Section <b>5N</b>

Side A	Side B
<b>P</b> C CENTRAL Section <b>5O</b>	<b>P</b> C CENTRAL Section <b>5P</b>


Side A	Side B
<b>P</b> C CENTRAL Section <b>5N</b>	<b>P</b> C CENTRAL Section <b>5O</b>

Side A	Side B
<b>P</b> C CENTRAL Section <b>5P</b>	<b>P</b> C CENTRAL Section <b>5Q</b>

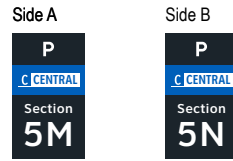
S2 CG.L5-137 5-ID.52 Notes: N/A




S2 CG.L5-141 5-ID.52 Notes: N/A

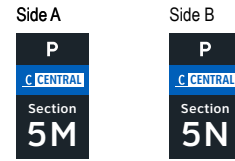


S2 CG.L5-138 5-ID.52 Notes: N/A

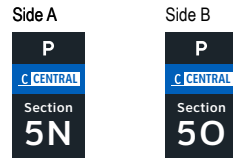


S2 CG.L5-142 5-ID.52 Notes: N/A

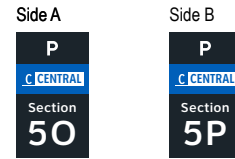


S2 CG.L5-139 5-ID.52 Notes: N/A

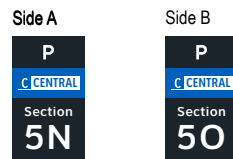


S2 CG.L5-143 5-ID.52 Notes: N/A

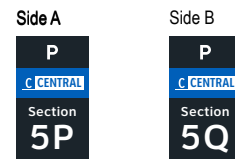

S2 CG.L5-140 5-ID.52 Notes: N/A

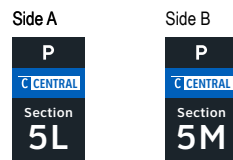


S2 CG.L5-144 5-ID.52 Notes: N/A

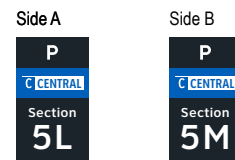




S2 CG.L5-145 5-ID.52 Notes: N/A

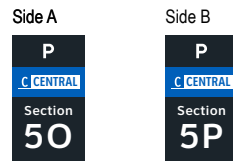

S2 CG.L5-149 5-ID.55 Notes: N/A



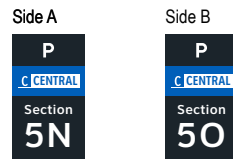S2 CG.L5-146 5-ID.52 Notes: N/A




S2 CG.L5-150 5-ID.55 Notes: N/A



S2 CG.L5-147 5-ID.55 Notes: N/A



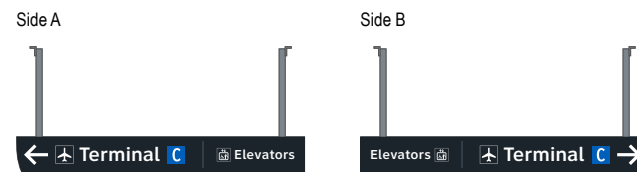
S2 CG.L5-151 5-DR.31 Notes: N/A




S2 CG.L5-148 5-ID.55 Notes: N/A



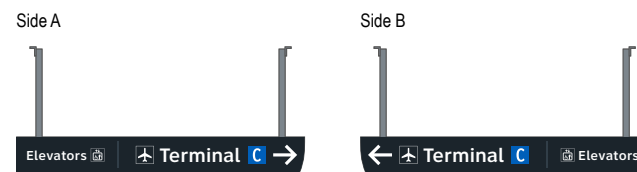S2 CG.L5-152 5-DR.31 Notes: N/A




S2 CG.L5-153 5-DR.31 Notes: N/A

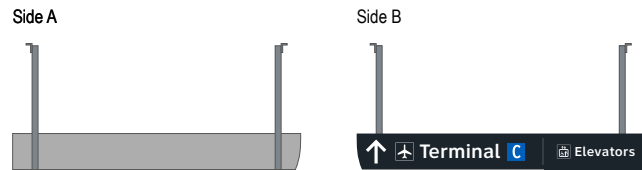


S2 CG.L5-157 5-DR.08 Notes: N/A



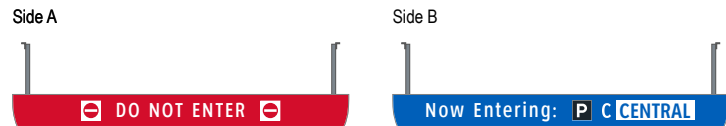
S2 CG.L5-154 5-ID.01 Notes: N/A



S2 CG.L5-155 5-ID.06 Notes: N/A

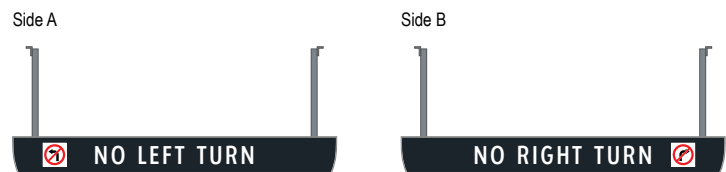

S2 CG.L5-156 5-DR.08 Notes: N/A

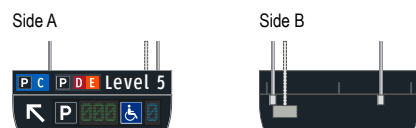

ELEVATOR CORE SIGNAGE CONTINUED ON NEXT SHEET

**Wayfinding Updates**

Issue Date: 08-23-2024

Issue for Bid

- REV. 
- REV. 
- REV. 

**WARNING:**

This record contains Sensitive Security Information that is controlled under 49 CFR parts 15 and 1520. No part of this record may be disclosed to persons with a "need to know," as defined in 49 CFR parts 15 and 1520, except with the written permission of the Administrator of the Transportation Security Administration or the Secretary of Transportation. Unauthorized release may result in civil penalty or other action. For U.S. government agencies, public disclosure is governed by 5 U.S.C. 552 and 49 CFR parts 15 and 1520.



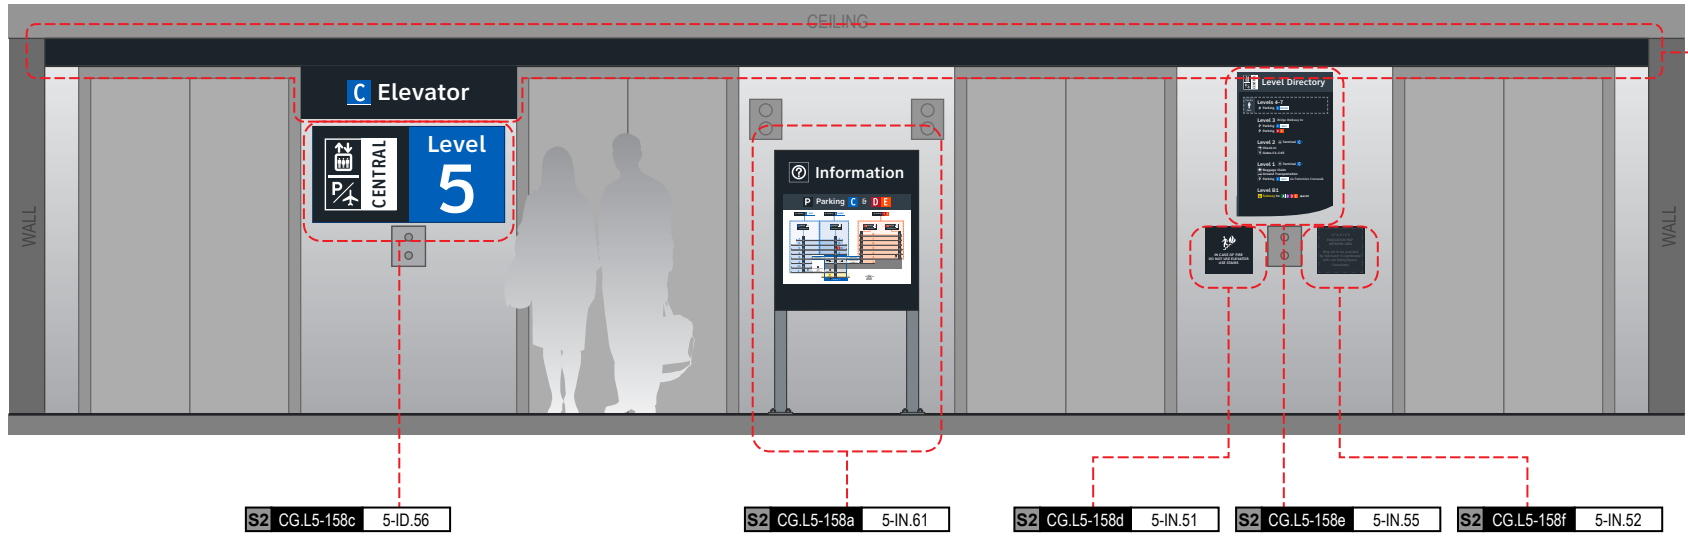
08-23-2024

**8.4 MESSAGE SCHEDULE - GARAGE C: LEVEL 5 - SECTOR 2 (C CENTRAL)**

THESE SHEETS ARE ISSUED FOR GRAPHICAL INFORMATION ONLY

BSG PRJCT# BSG-2024-111-IAH  
 HAS TIP # 24 -103 - IAH

Side A



S2 CG.L5-158c 5-ID.56

S2 CG.L5-158a 5-IN.61

S2 CG.L5-158d 5-IN.51

S2 CG.L5-158e 5-IN.55

S2 CG.L5-158f 5-IN.52

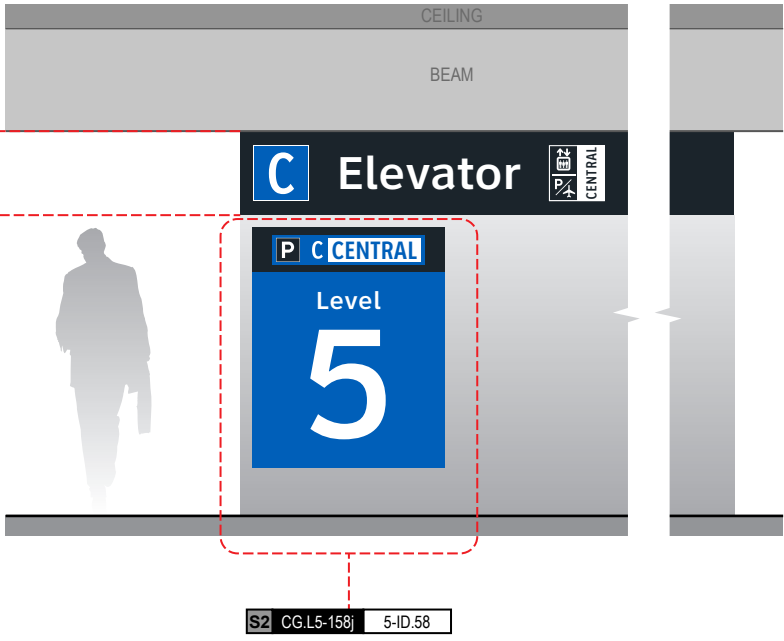
NOTES: Directory artwork includes a "You Are Here" button graphic and is in a unique location per elevator core/level location; artwork included here is representative of final map artwork design intent for this location

NOTES: Level directory plaque includes a "You Are Here" graphic and is in a unique location per elevator core/level location; artwork included here is representative of final artwork design intent for this location

S2 CG.L5-158b 5-ID.57


NOTES: Wall paint and header graphics at front elevation only of elevator core included for this location number; wall elevation conditions shown are artistic representation based on rough site photo surveys; actual wall elevation conditions to be field verified by contractor/installer

Side C



S2 CG.L5-158j 5-ID.58

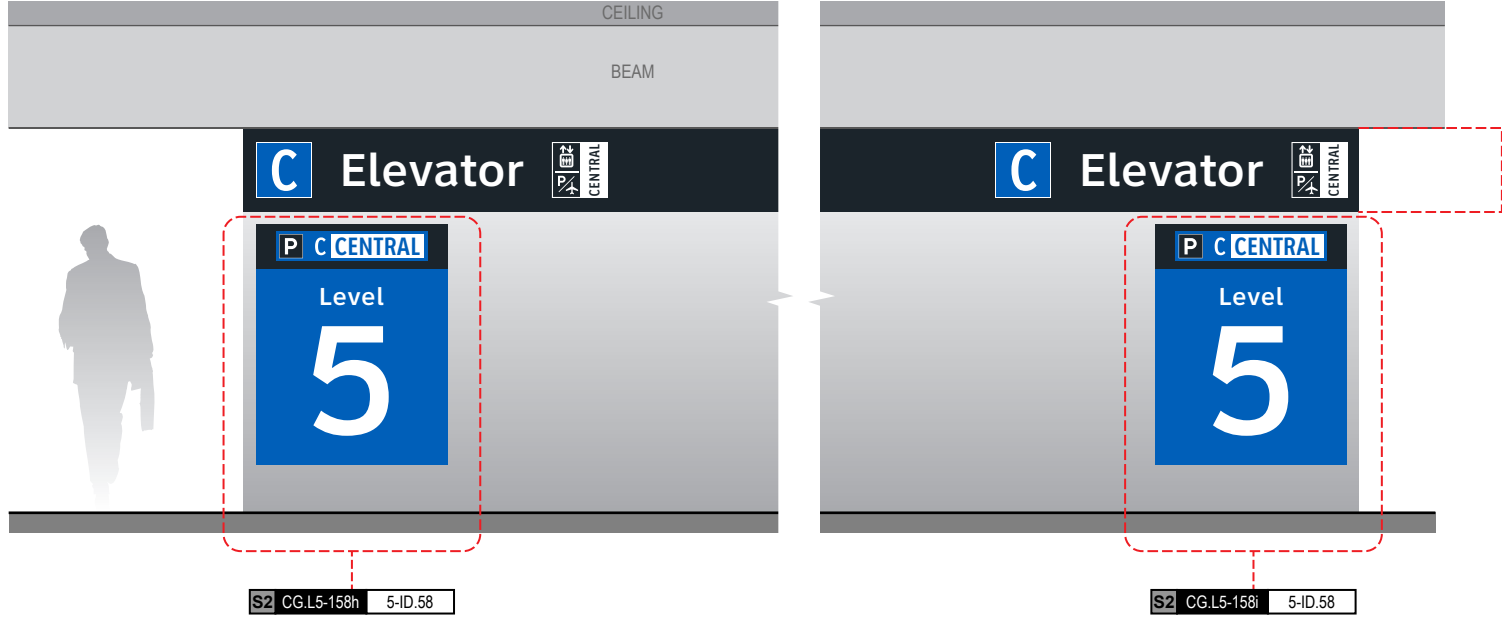Side B




S2 CG.L5-158h 5-ID.58

S2 CG.L5-158i 5-ID.58

S2 CG.L5-158g 5-ID.59

NOTES: Wall paint and header graphics on rear and two side elevations of elevator core included for this location number; wall elevation conditions shown are artistic representation based on rough site photo surveys; actual wall elevation conditions to be field verified by contractor/installer

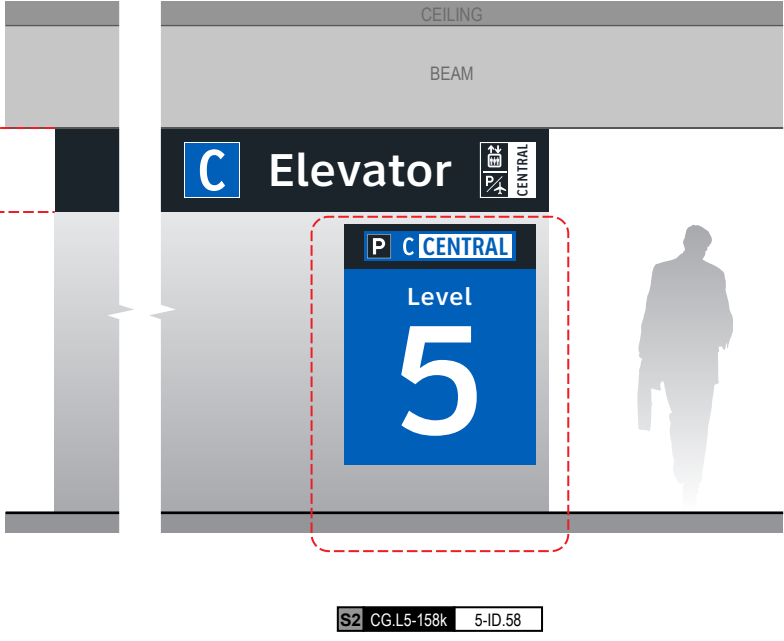Side D



S2 CG.L5-158k 5-ID.58


END OF GARAGE C: LEVEL 5 - SECTOR 2 MESSAGES

**GENERAL NOTES**

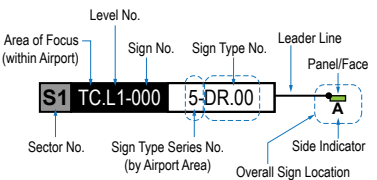- Sign locations & orientations shown here are approximations based on the most current plan drawings as provided to the designer by the architect at the time of this document's completion. These sign locations are for general design intent & wayfinding planning purposes only. They should not be construed or deemed as absolute or final locations. Field verification, marking & documentation of each final location is to be performed by the Fabricator/Installer & coordinated with project staff & Wayfinding Design Consultants for final approval.
- All final install locations must be marked and verified in the field for proper structural integrity, adequate line of sight, utilities / property-line / other existing signage interferences & must be in complete compliance with all local, state and national codes prior to fabrication or installation.
- Adjustments to the sign locations shown in these drawings must be documented by the Fabricator/Installer, and provided to project staff & Wayfinding Design Consultants for final approval.

**NOTE:** Only priority wayfinding signage & locations as shown in this wayfinding plan package are in scope. All other signage not shown (including traffic control) are NOT IN SCOPE for this project/contract.

**SIGN LOCATION ANNOTATION LEGEND**



**LOCATION CODE DEFINITIONS:**

- AREA OF FOCUS:** (location within Airport)  
 TA = Terminal A  
 TB = Terminal B  
 TC = Terminal C  
 TD = Terminal D  
 TE = Terminal E  
 AB = AB Garage  
 CG = C Garage  
 DE = DE Garage
- SIGN TYPE SERIES NO.:** (by Airport Area)  
 1- = Terminals/Concourses  
 11- = Terminals/Concourses: Temporary  
 2- = CBP Areas  
 3- = Curbside/Ground Trans.  
 4- = Roadways  
 5- = Parking
- WAYFINDING SIGN TYPE:**  
 DR.xx = Directional  
 ID.xx = Identification  
 IN.xx = Informational

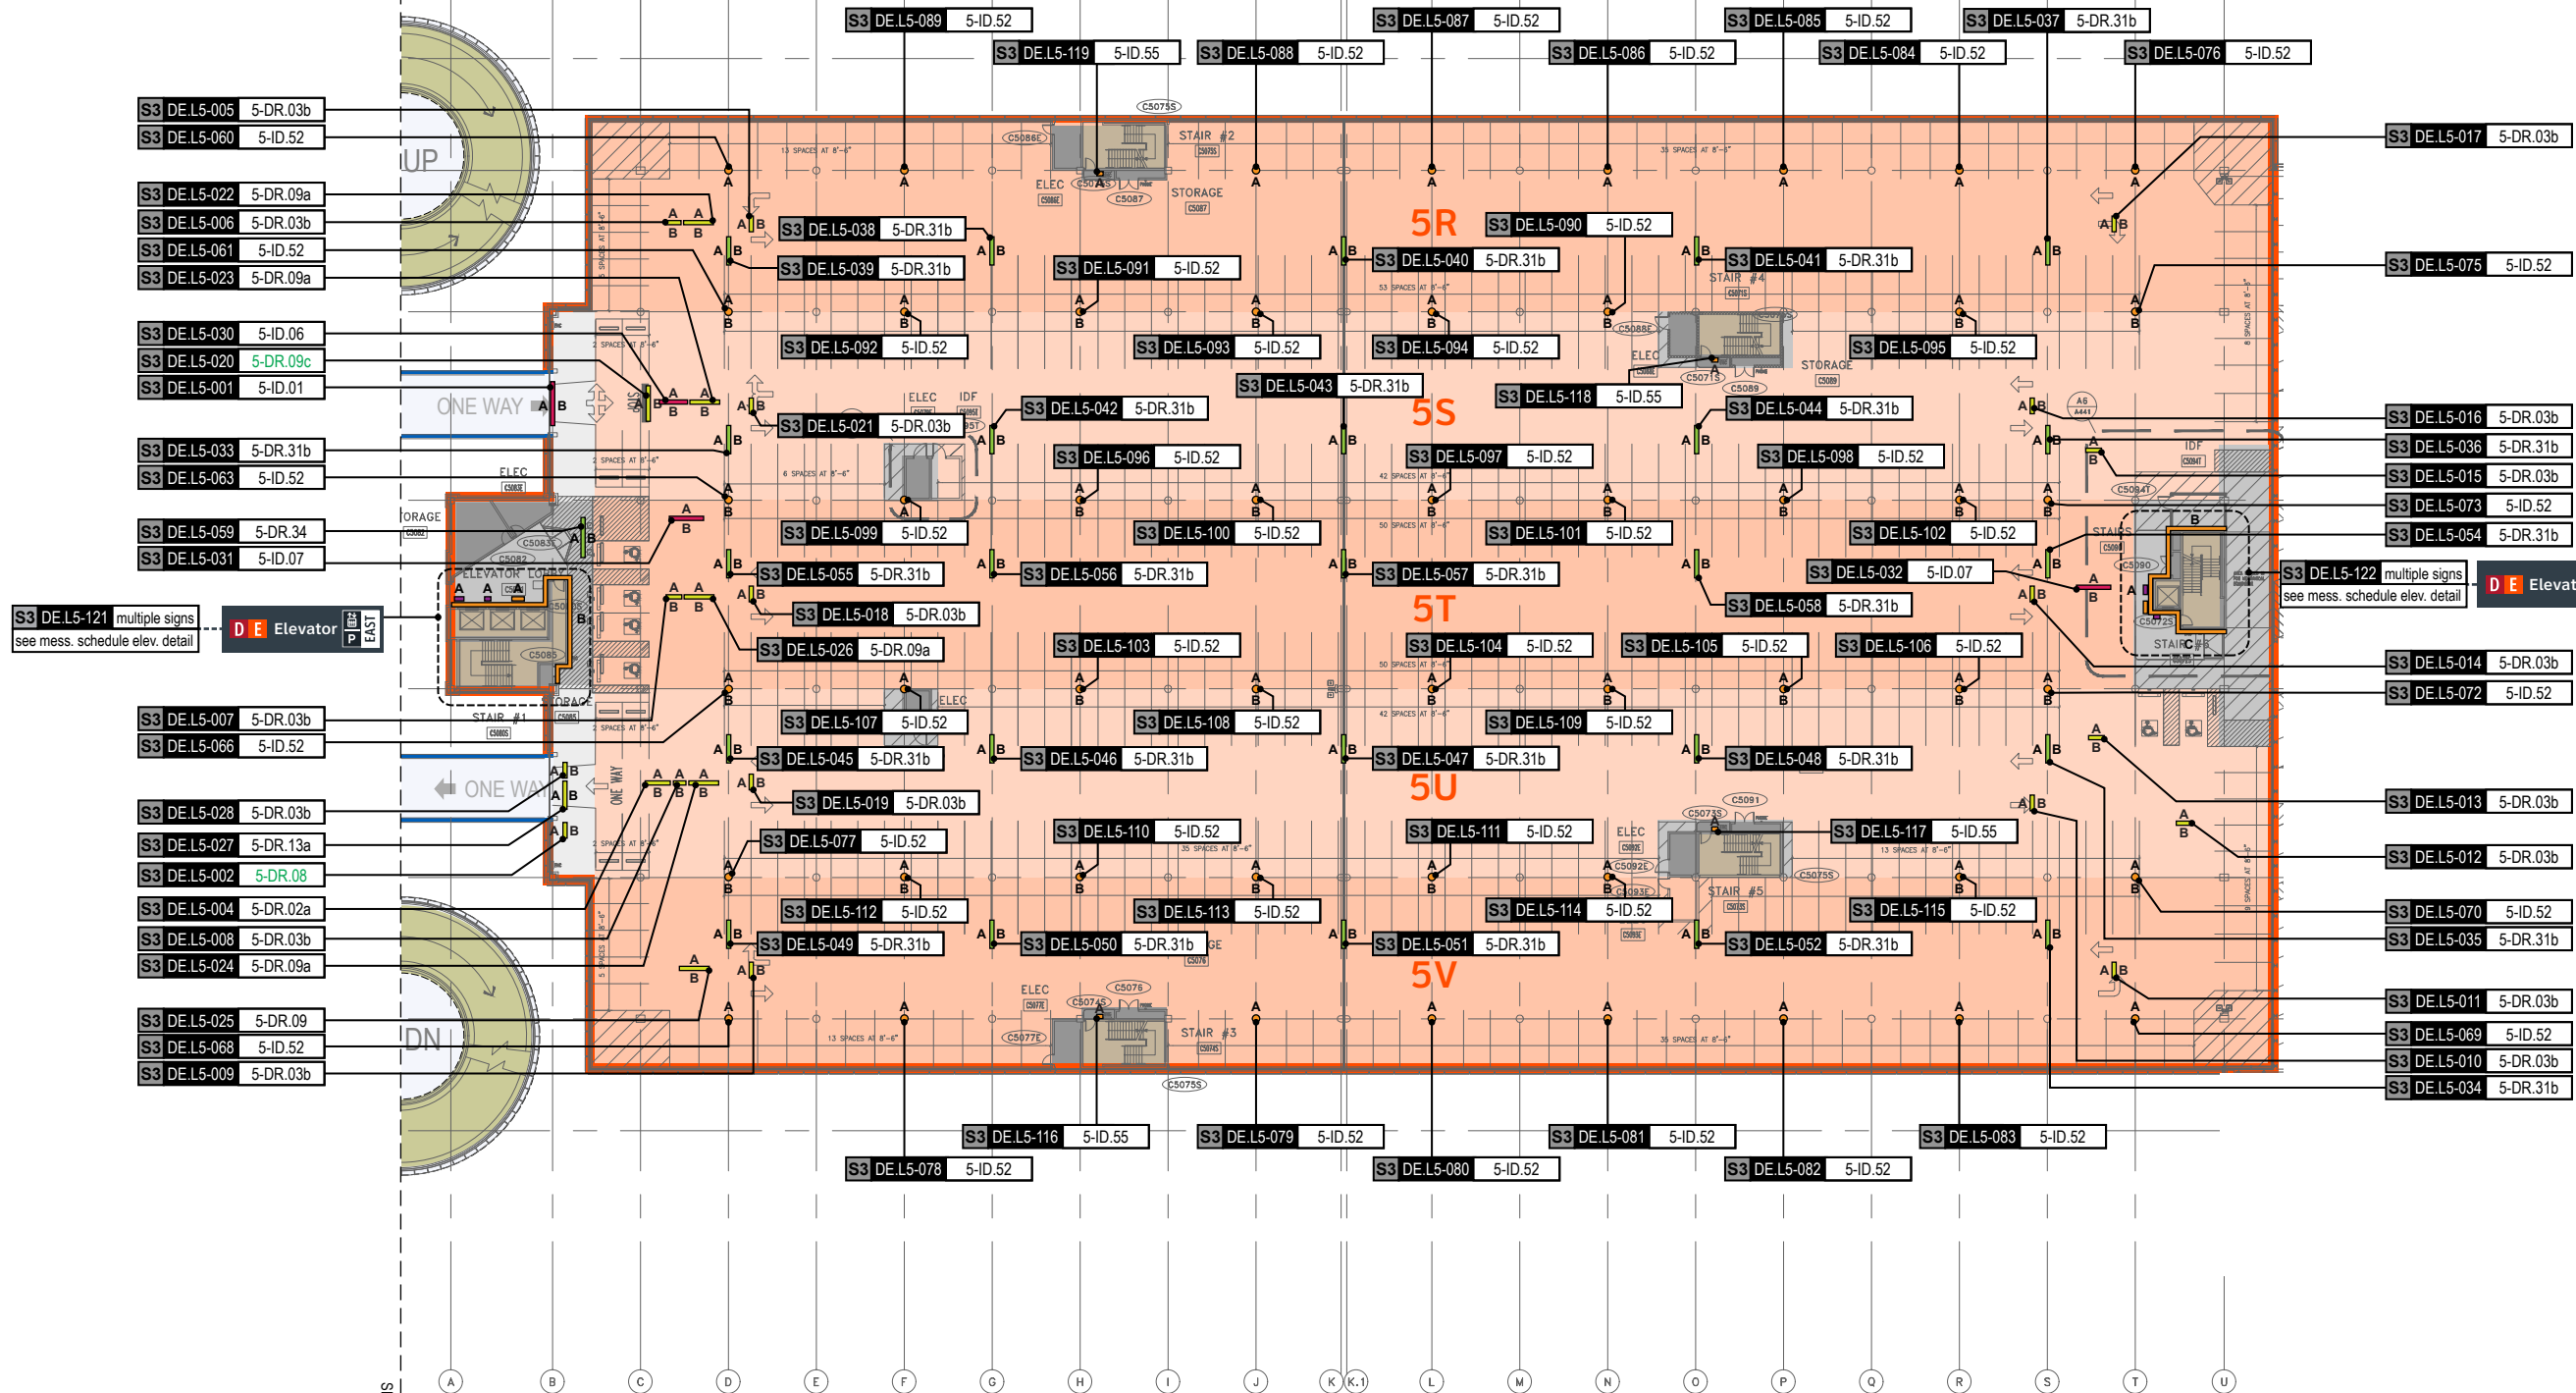
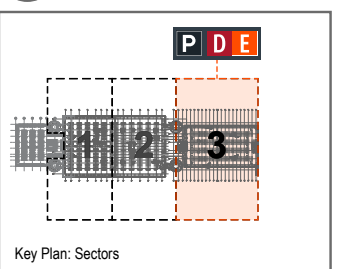
**WAYFINDING SIGN LOCATIONS - Parking:**

- PEDESTRIAN Signs:**  
 A = Directional (DR)  
 B = Identification (ID)  
 AB = Informational (IN)
- VEHICULAR Signs:**  
 A = Directional (DR)  
 B = Identification (ID)  
 AB = Informational (IN)

**CIRCULATION:**

- = Public Use PEDESTRIAN Vertical Circulation (i.e. Elevators/Escalators/Stairs)
- = Public Use VEHICULAR Vertical Circulation (i.e. Ramps)
- = Alpha-Numeric Parking Section Naming Areas (Blues = C Garages; Oranges = D/E Garage)
- = Areas Not In Scope for this Package

LOCATION PLAN SCALE: 1" = 60'



S3 DE.L5-121 multiple signs see mess. schedule elev. detail

**D E Elevator**

**D E Elevator**

SEE SHEET 8-22

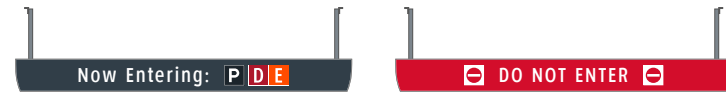


THESE SHEETS ARE ISSUED FOR GRAPHICAL INFORMATION ONLY  
 08-23-2024

S3 DE.L5-001 5-ID.01 Notes: N/A

Side A


Side B



S3 DE.L5-005 5-DR.03b Notes: N/A

Side A

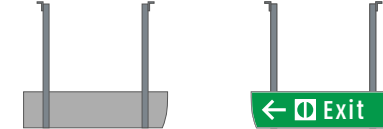Side B



S3 DE.L5-002 5-DR.08 Notes: N/A

Side A

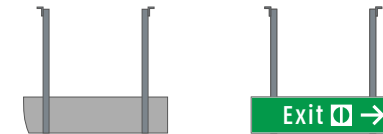
Side B



S3 DE.L5-006 5-DR.03b Notes: N/A

Side A

Side B




S3 DE.L5-003 N/A Notes: N/A

NOT USED

S3 DE.L5-007 5-DR.03b Notes: N/A

Side A

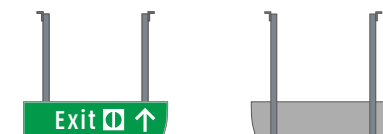
Side B



S3 DE.L5-004 5-DR.02a Notes: N/A

Side A

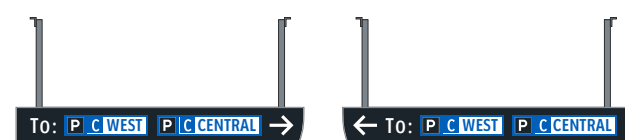
Side B




S3 DE.L5-008 5-DR.03b Notes: N/A

Side A

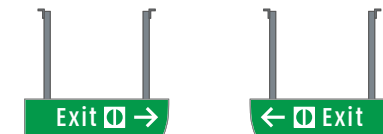
Side B




S3 DE.L5-009 5-DR.03b Notes: N/A

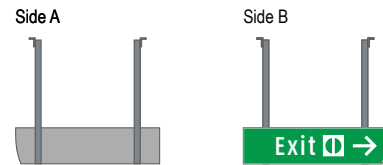


S3 DE.L5-013 5-DR.03b Notes: N/A

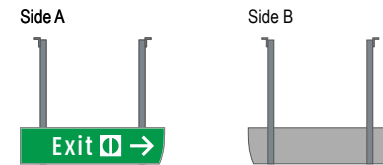


S3 DE.L5-010 5-DR.03b Notes: N/A

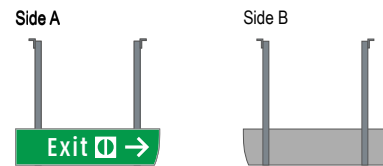


S3 DE.L5-014 5-DR.03b Notes: N/A

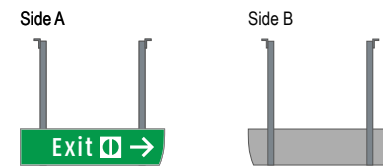


S3 DE.L5-011 5-DR.03b Notes: N/A

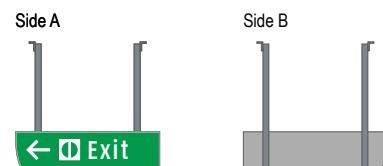


S3 DE.L5-015 5-DR.03b Notes: N/A

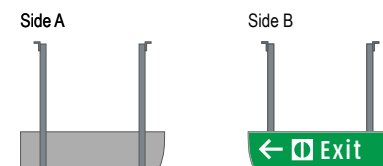

S3 DE.L5-012 5-DR.03b Notes: N/A

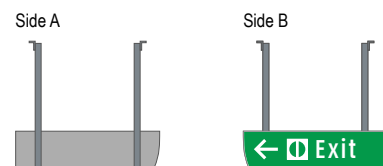

S3 DE.L5-016 5-DR.03b Notes: N/A

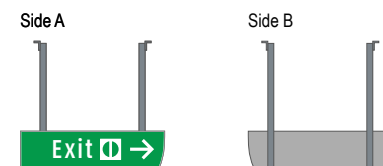

**Wayfinding Updates**

Issue Date: 08-23-2024

**Issue for Bid**

- REV. 
- REV. 
- REV. 

**WARNING:**

This record contains Sensitive Security Information that is controlled under 49 CFR parts 15 and 1520. No part of this record may be disclosed to persons with a "need to know," as defined in 49 CFR parts 15 and 1520, except with the written permission of the Administrator of the Transportation Security Administration or the Secretary of Transportation. Unauthorized release may result in civil penalty or other action. For U.S. government agencies, public disclosure is governed by 5 U.S.C. 552 and 49 CFR parts 15 and 1520.



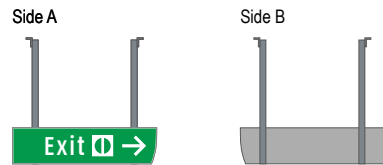
THESE SHEETS ARE ISSUED FOR GRAPHICAL INFORMATION ONLY

08-23-2024


**8.6 MESSAGE SCHEDULE - GARAGE D/E: LEVEL 5 - SECTOR 3 (D/E)**

BSG PRJCT# BSG-2024-111-IAH  
 HAS TIP # 24 -103 - IAH


S3 DE.L5-017 5-DR.03b Notes: N/A




S3 DE.L5-021 5-DR.03b Notes: N/A

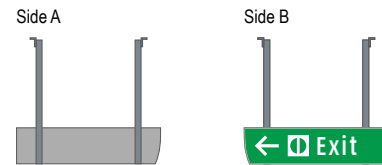


S3 DE.L5-018 5-DR.03b Notes: N/A

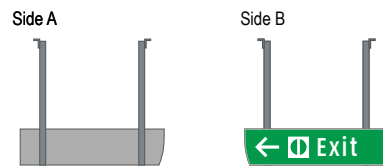


S3 DE.L5-022 5-DR.09a Notes: N/A

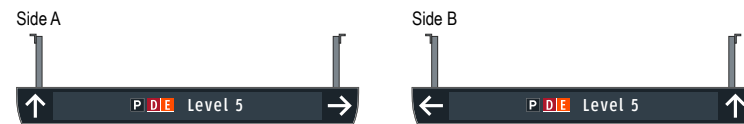


S3 DE.L5-019 5-DR.03b Notes: N/A

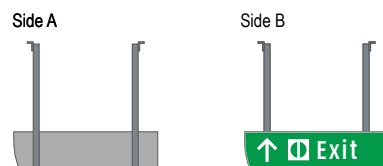


S3 DE.L5-023 5-DR.09a Notes: N/A

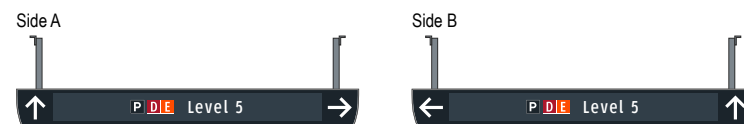


S3 DE.L5-020 5-DR.09c Notes: N/A

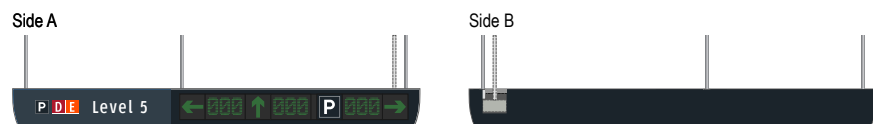

S3 DE.L5-024 5-DR.09a Notes: N/A

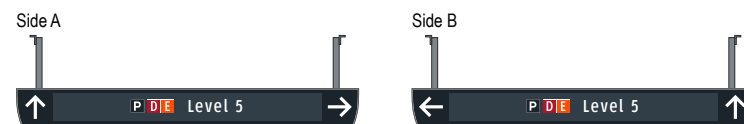


S3 DE.L5-025 5-DR.09a Notes: N/A

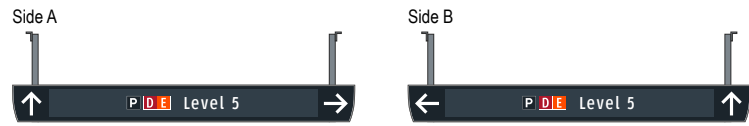


S3 DE.L5-029 N/A Notes: N/A

NOT USED

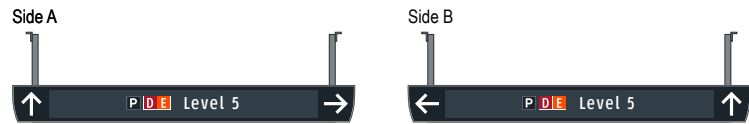
S3 DE.L5-026 5-DR.09a Notes: N/A




S3 DE.L5-030 5-ID.06 Notes: N/A

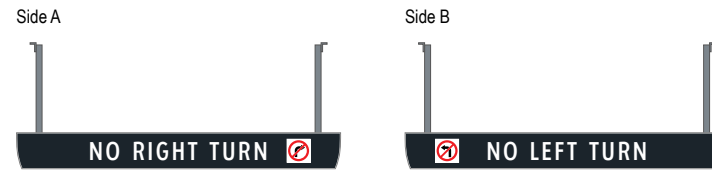


S3 DE.L5-027 5-DR.13a Notes: N/A

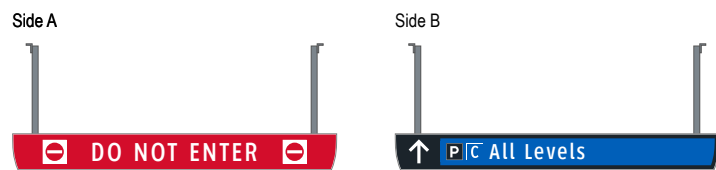


S3 DE.L5-031 5-ID.07 Notes: N/A

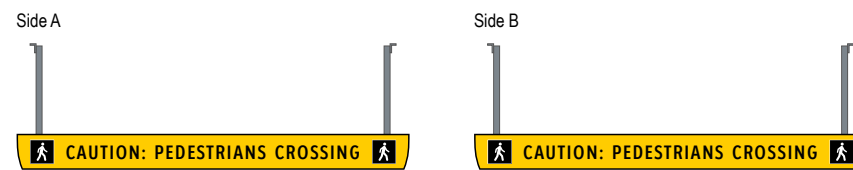

S3 DE.L5-028 5-DR.03b Notes: N/A

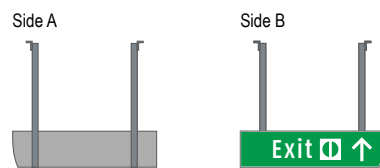

S3 DE.L5-032 5-ID.07 Notes: N/A

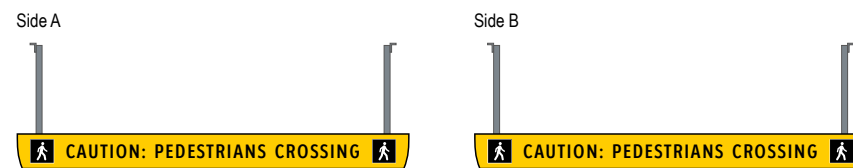

**Wayfinding Updates**

Issue Date: 08-23-2024

Issue for Bid

- REV. 
- REV. 
- REV. 

**WARNING:**

This record contains Sensitive Security Information that is controlled under 49 CFR parts 15 and 1520. No part of this record may be disclosed to persons with a "need to know," as defined in 49 CFR parts 15 and 1520, except with the written permission of the Administrator of the Transportation Security Administration or the Secretary of Transportation. Unauthorized release may result in civil penalty or other action. For U.S. government agencies, public disclosure is governed by 5 U.S.C. 552 and 49 CFR parts 15 and 1520.



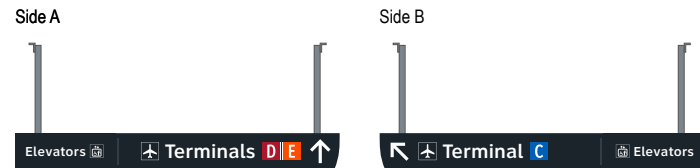
THESE SHEETS ARE ISSUED FOR GRAPHICAL INFORMATION ONLY

**8.6 MESSAGE SCHEDULE - GARAGE D/E: LEVEL 5 - SECTOR 3 (D/E)**


BSG PRJCT# BSG-2024-111-IAH  
 HAS TIP # 24 -103 - IAH




S3 DE.L5-033 5-DR.31b Notes: N/A




S3 DE.L5-037 5-DR.31b Notes: N/A

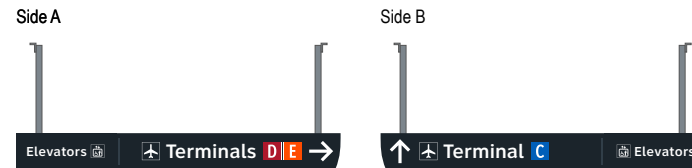


S3 DE.L5-034 5-DR.31b Notes: N/A

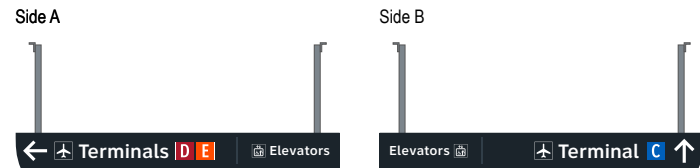


S3 DE.L5-038 5-DR.31b Notes: N/A

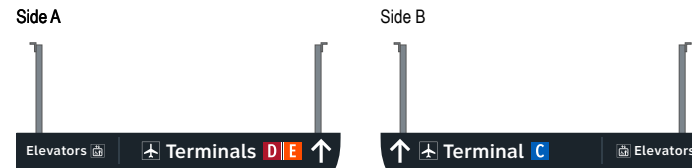


S3 DE.L5-035 5-DR.31b Notes: N/A

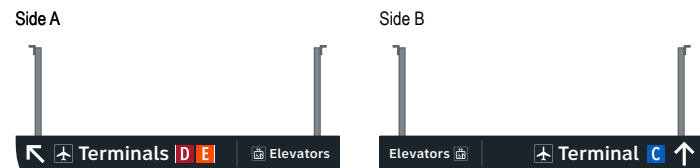


S3 DE.L5-039 5-DR.31b Notes: N/A

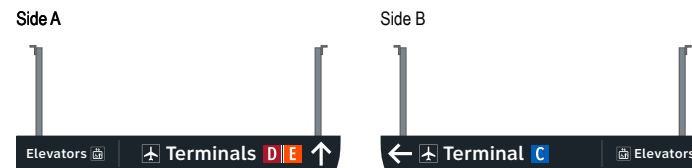

S3 DE.L5-036 5-DR.31b Notes: N/A

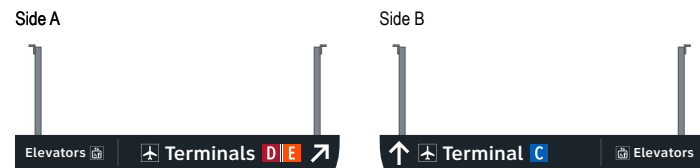

S3 DE.L5-040 5-DR.31b Notes: N/A

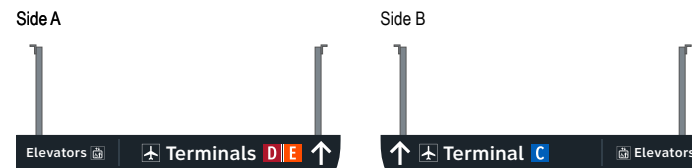

**Wayfinding Updates**

Issue Date: 08-23-2024

**Issue for Bid**

- REV. 
- REV. 
- REV. 

**WARNING:**

This record contains Sensitive Security Information that is controlled under 49 CFR parts 15 and 1520. No part of this record may be disclosed to persons with a "need to know," as defined in 49 CFR parts 15 and 1520, except with the written permission of the Administrator of the Transportation Security Administration or the Secretary of Transportation. Unauthorized release may result in civil penalty or other action. For U.S. government agencies, public disclosure is governed by 5 U.S.C. 552 and 49 CFR parts 15 and 1520.

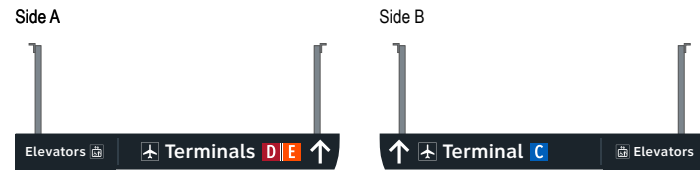


THESE SHEETS ARE ISSUED FOR GRAPHICAL INFORMATION ONLY


**8.6 MESSAGE SCHEDULE - GARAGE D/E: LEVEL 5 - SECTOR 3 (D/E)**

BSG PRJCT# BSG-2024-111-IAH  
 HAS TIP # 24 -103 - IAH


S3 DE.L5-041 5-DR.31b Notes: N/A




S3 DE.L5-045 5-DR.31b Notes: N/A

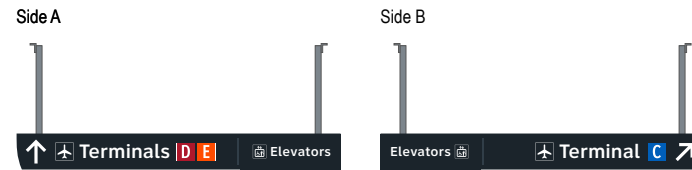


S3 DE.L5-042 5-DR.31b Notes: N/A

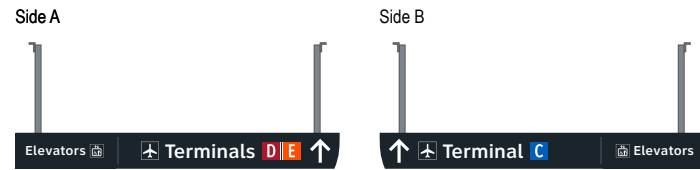


S3 DE.L5-046 5-DR.31b Notes: N/A

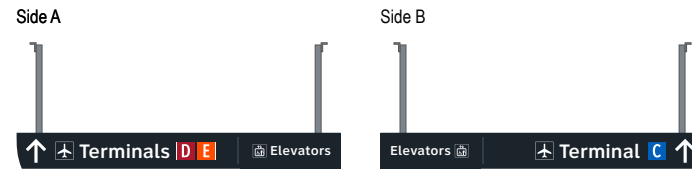


S3 DE.L5-043 5-DR.31b Notes: N/A

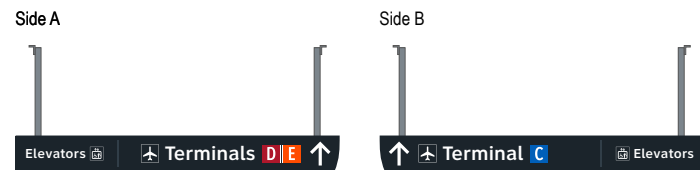


S3 DE.L5-047 5-DR.31b Notes: N/A

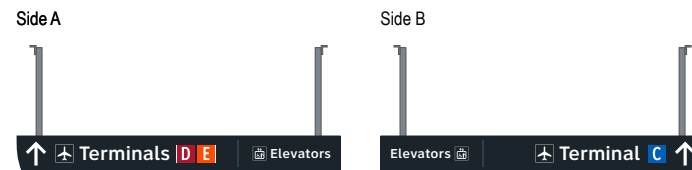

S3 DE.L5-044 5-DR.31b Notes: N/A

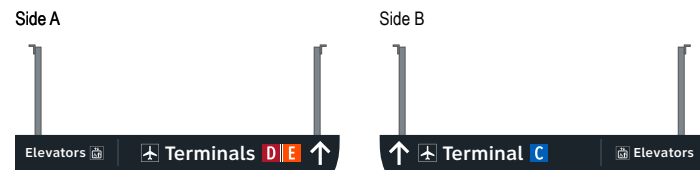

S3 DE.L5-048 5-DR.31b Notes: N/A

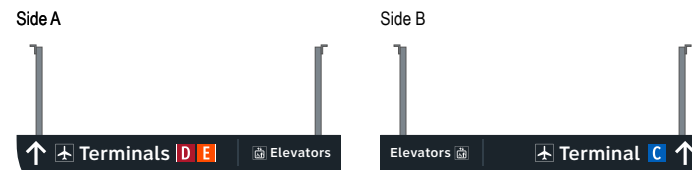

**Wayfinding Updates**

Issue Date: 08-23-2024

**Issue for Bid**

- REV.
- REV.
- REV.

**WARNING:**

This record contains Sensitive Security Information that is controlled under 49 CFR parts 15 and 1520. No part of this record may be disclosed to persons with a "need to know," as defined in 49 CFR parts 15 and 1520, except with the written permission of the Administrator of the Transportation Security Administration or the Secretary of Transportation. Unauthorized release may result in civil penalty or other action. For U.S. government agencies, public disclosure is governed by 5 U.S.C. 552 and 49 CFR parts 15 and 1520.

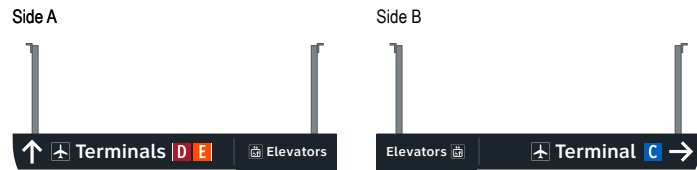


THESE SHEETS ARE ISSUED FOR GRAPHICAL INFORMATION ONLY

**8.6 MESSAGE SCHEDULE - GARAGE D/E: LEVEL 5 - SECTOR 3 (D/E)**

BSG PRJCT# BSG-2024-111-IAH  
HAS TIP # 24 -103 - IAH


S3 DE.L5-049 5-DR.31b Notes: N/A




S3 DE.L5-053 N/A Notes: N/A

NOT USED

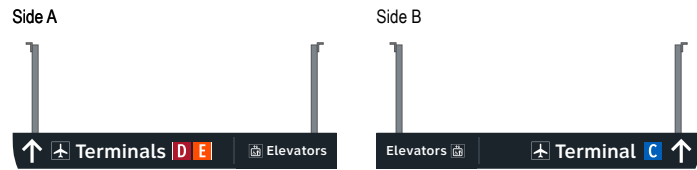
S3 DE.L5-050 5-DR.31b Notes: N/A




S3 DE.L5-054 5-DR.31b Notes: N/A

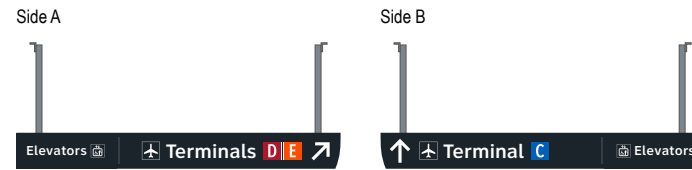


S3 DE.L5-051 5-DR.31b Notes: Notes: N/A

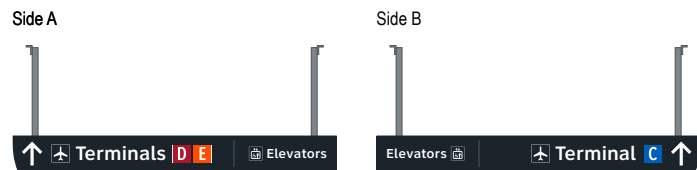


S3 DE.L5-055 5-DR.31b Notes: N/A

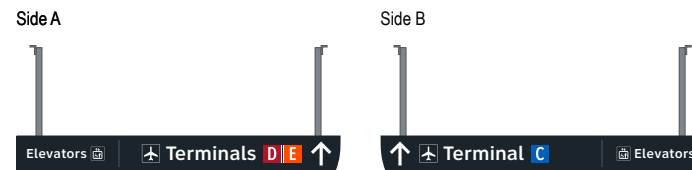

S3 DE.L5-052 5-DR.31b Notes: N/A

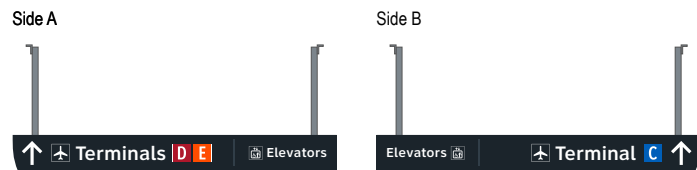

S3 DE.L5-056 5-DR.31b Notes: N/A

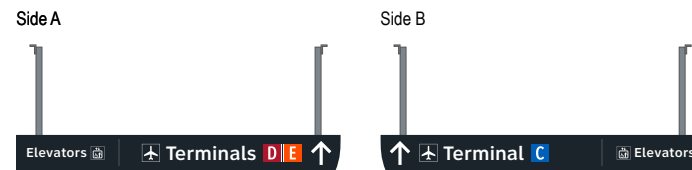

**Wayfinding Updates**

Issue Date: 08-23-2024

**Issue for Bid**

- REV. 
- REV. 
- REV. 

**WARNING:**

This record contains Sensitive Security Information that is controlled under 49 CFR parts 15 and 1520. No part of this record may be disclosed to persons with a "need to know," as defined in 49 CFR parts 15 and 1520, except with the written permission of the Administrator of the Transportation Security Administration or the Secretary of Transportation. Unauthorized release may result in civil penalty or other action. For U.S. government agencies, public disclosure is governed by 5 U.S.C. 552 and 49 CFR parts 15 and 1520.

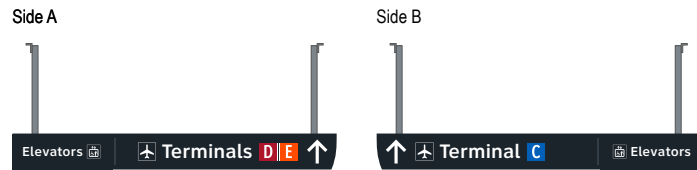


THESE SHEETS ARE ISSUED FOR GRAPHICAL INFORMATION ONLY


**8.6 MESSAGE SCHEDULE - GARAGE D/E: LEVEL 5 - SECTOR 3 (D/E)**

BSG PRJCT# BSG-2024-111-IAH  
HAS TIP # 24 -103 - IAH


S3 DE.L5-057 5-DR.31b Notes: N/A



S3 DE.L5-061 5-ID.52 Notes: N/A

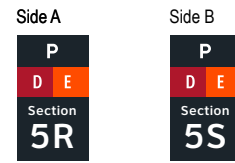


S3 DE.L5-058 5-DR.31b Notes: N/A

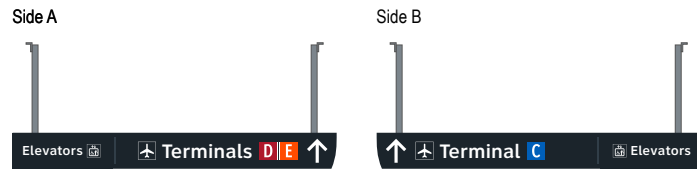


S3 DE.L5-062 N/A Notes: N/A

NOT USED

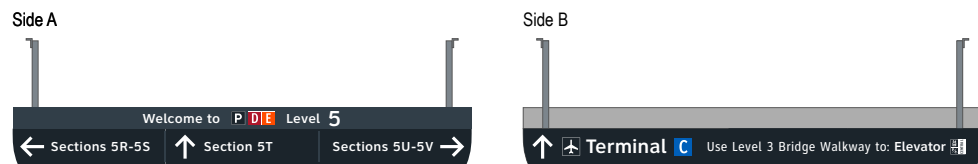S3 DE.L5-059 5-DR.34 Notes: N/A



S3 DE.L5-063 5-ID.52 Notes: N/A

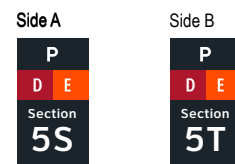

S3 DE.L5-060 5-ID.52 Notes: N/A



S3 DE.L5-064 N/A Notes: N/A

NOT USED

**Wayfinding Updates**

Issue Date: 08-23-2024  
Issue for Bid

- REV.
- REV.
- REV.

**WARNING:**

This record contains Sensitive Security Information that is controlled under 49 CFR parts 15 and 1520. No part of this record may be disclosed to persons with a "need to know," as defined in 49 CFR parts 15 and 1520, except with the written permission of the Administrator of the Transportation Security Administration or the Secretary of Transportation. Unauthorized release may result in civil penalty or other action. For U.S. government agencies, public disclosure is governed by 5 U.S.C. 552 and 49 CFR parts 15 and 1520.



THESE SHEETS ARE ISSUED FOR GRAPHICAL INFORMATION ONLY

**8.6 MESSAGE SCHEDULE - GARAGE D/E: LEVEL 5 - SECTOR 3 (D/E)**

BSG PRJCT# BSG-2024-111-IAH  
HAS TIP # 24 -103 - IAH

NOT USED

Side A



Side A



Side B



Side A



Side B



NOT USED

NOT USED

Side A



Side A



Side B



Wayfinding Updates

Issue Date: 08-23-2024

Issue for Bid

- REV.
- REV.
- REV.

WARNING:

This record contains Sensitive Security Information that is controlled under 49 CFR parts 15 and 1520. No part of this record may be disclosed to persons with a "need to know," as defined in 49 CFR parts 15 and 1520, except with the written permission of the Administrator of the Transportation Security Administration or the Secretary of Transportation. Unauthorized release may result in civil penalty or other action. For U.S. government agencies, public disclosure is governed by 5 U.S.C. 552 and 49 CFR parts 15 and 1520.



08-23-2024

THESE SHEETS ARE ISSUED FOR GRAPHICAL INFORMATION ONLY

8.6 MESSAGE SCHEDULE - GARAGE D/E: LEVEL 5 - SECTOR 3 (D/E)

BSG PRJCT# BSG-2024-111-IAH  
HAS TIP # 24 -103 - IAH

S3 DE.L5-073 5-ID.52 Notes: N/A

Side A      Side B

P	P
D E	D E
Section	Section
5S	5T

S3 DE.L5-077 5-ID.52 Notes: N/A

Side A      Side B

P	P
D E	D E
Section	Section
5U	5V

S3 DE.L5-074 N/A Notes: N/A

S3 DE.L5-078 5-ID.52 Notes: N/A

Side A

P
D E
Section
5V

S3 DE.L5-075 5-ID.52 Notes: N/A

Side A      Side B

P	P
D E	D E
Section	Section
5R	5S

S3 DE.L5-079 5-ID.52 Notes: N/A

Side A

P
D E
Section
5V

S3 DE.L5-076 5-ID.52 Notes: N/A

Side A

P
D E
Section
5R

S3 DE.L5-080 5-ID.52 Notes: N/A

Side A

P
D E
Section
5V

**Wayfinding Updates**

Issue Date: 08-23-2024

**Issue for Bid**

- REV. 
- REV. 
- REV. 

**WARNING:**

This record contains Sensitive Security Information that is controlled under 49 CFR parts 15 and 1520. No part of this record may be disclosed to persons with a "need to know," as defined in 49 CFR parts 15 and 1520, except with the written permission of the Administrator of the Transportation Security Administration or the Secretary of Transportation. Unauthorized release may result in civil penalty or other action. For U.S. government agencies, public disclosure is governed by 5 U.S.C. 552 and 49 CFR parts 15 and 1520.



THESE SHEETS ARE ISSUED FOR GRAPHICAL INFORMATION ONLY

**8.6 MESSAGE SCHEDULE - GARAGE D/E: LEVEL 5 - SECTOR 3 (D/E)**

BSG PRJCT# BSG-2024-111-IAH  
HAS TIP # 24 -103 - IAH

S3 DE.L5-081 5-ID.52 Notes: N/A

Side A



S3 DE.L5-085 5-ID.52 Notes: N/A

Side A



S3 DE.L5-082 5-ID.52 Notes: N/A

Side A



S3 DE.L5-086 5-ID.52 Notes: N/A

Side A



S3 DE.L5-083 5-ID.52 Notes: N/A

Side A



S3 DE.L5-087 5-ID.52 Notes: N/A

Side A



S3 DE.L5-084 5-ID.52 Notes: N/A

Side A



S3 DE.L5-088 5-ID.52 Notes: N/A

Side A



GEORGE BUSH INTERCONTINENTAL AIRPORT  
Wayfinding Signage Design Intent Documents  
C Garage



Louisville, Colorado  
P: 303.494.7849  
www.labozan.com

These documents are intended to illustrate design intent, and should only be used as a general guideline. No information contained here should be construed as engineered elements. The fabricator/contractor shall be responsible for all engineering and specifications with regard to structural, electrical, mechanical, foundation and installation. Information and illustrations contained here are part of an original unpublished design by Labozan Associates, Inc. Detailing and information contained on these pages shall not be reproduced, copied or utilized in any way except for the specific project for which they were created without previous written authorization from Labozan Associates, Inc.

© 2024 by Labozan Associates, Inc.

Wayfinding Updates

Issue Date: 08-23-2024  
Issue for Bid

- REV.
- REV.
- REV.

WARNING:

This record contains Sensitive Security Information that is controlled under 49 CFR parts 15 and 1520. No part of this record may be disclosed to persons with a "need to know," as defined in 49 CFR parts 15 and 1520, except with the written permission of the Administrator of the Transportation Security Administration or the Secretary of Transportation. Unauthorized release may result in civil penalty or other action. For U.S. government agencies, public disclosure is governed by 5 U.S.C. 552 and 49 CFR parts 15 and 1520.



THESE SHEETS ARE ISSUED FOR GRAPHICAL INFORMATION ONLY

08-23-2024

8.6 MESSAGE SCHEDULE - GARAGE D/E: LEVEL 5 - SECTOR 3 (D/E)

BSG PRJCT# BSG-2024-111-IAH  
HAS TIP # 24 -103 - IAH

S3 DE.L5-089 5-ID.52 Notes: N/A

Side A



S3 DE.L5-093 5-ID.52 Notes: N/A

Side A



Side B



S3 DE.L5-090 5-ID.52 Notes: N/A

Side A



Side B



S3 DE.L5-094 5-ID.52 Notes: N/A

Side A



Side B



S3 DE.L5-091 5-ID.52 Notes: N/A

Side A



Side B



S3 DE.L5-095 5-ID.52 Notes: N/A

Side A



Side B



S3 DE.L5-092 5-ID.52 Notes: N/A

Side A



Side B



S3 DE.L5-096 5-ID.52 Notes: N/A

Side A



Side B



GEORGE BUSH INTERCONTINENTAL AIRPORT  
Wayfinding Signage Design Intent Documents  
C Garage



Louisville, Colorado  
P: 303.494.7849  
www.labozan.com

These documents are intended to illustrate design intent, and should only be used as a general guideline. No information contained here should be construed as engineered elements. The fabricator/contractor shall be responsible for all engineering and specifications with regard to structural, electrical, mechanical, foundation and installation. Information and illustrations contained here are part of an original unpublished design by Labozan Associates, Inc. Detailing and information contained on these pages shall not be reproduced, copied or utilized in any way except for the specific project for which they were created without previous written authorization from Labozan Associates, Inc.

© 2024 by Labozan Associates, Inc.

Wayfinding Updates

Issue Date: 08-23-2024  
Issue for Bid

- REV.
- REV.
- REV.

WARNING:

This record contains Sensitive Security Information that is controlled under 49 CFR parts 15 and 1520. No part of this record may be disclosed to persons with a "need to know," as defined in 49 CFR parts 15 and 1520, except with the written permission of the Administrator of the Transportation Security Administration or the Secretary of Transportation. Unauthorized release may result in civil penalty or other action. For U.S. government agencies, public disclosure is governed by 5 U.S.C. 552 and 49 CFR parts 15 and 1520.



08-23-2024

THESE SHEETS ARE ISSUED FOR GRAPHICAL INFORMATION ONLY

8.6 MESSAGE SCHEDULE - GARAGE D/E: LEVEL 5 - SECTOR 3 (D/E)

BSG PRJCT# BSG-2024-111-IAH  
HAS TIP # 24 -103 - IAH

Sheet: 8-56



S3 DE.L5-097 5-ID.52 Notes: N/A

Side A      Side B

P	P
D E	D E
Section	Section
5S	5T

S3 DE.L5-101 5-ID.52 Notes: N/A

Side A      Side B

P	P
D E	D E
Section	Section
5S	5T

S3 DE.L5-098 5-ID.52 Notes: N/A

Side A      Side B

P	P
D E	D E
Section	Section
5S	5T

S3 DE.L5-102 5-ID.52 Notes: N/A

Side A      Side B

P	P
D E	D E
Section	Section
5S	5T

S3 DE.L5-099 5-ID.52 Notes: N/A

Side A

P
D E
Section
5T

S3 DE.L5-103 5-ID.52 Notes: N/A

Side A      Side B

P	P
D E	D E
Section	Section
5T	5U

S3 DE.L5-100 5-ID.52 Notes: N/A

Side A      Side B

P	P
D E	D E
Section	Section
5S	5T

S3 DE.L5-104 5-ID.52 Notes: N/A

Side A      Side B

P	P
D E	D E
Section	Section
5T	5U



GEORGE BUSH INTERCONTINENTAL AIRPORT  
Wayfinding Signage Design Intent Documents  
C Garage



Louisville, Colorado  
P: 303.494.7849  
www.labozan.com

These documents are intended to illustrate design intent, and should only be used as a general guideline. No information contained here should be construed as engineered elements. The fabricator/contractor shall be responsible for all engineering and specifications with regard to structural, electrical, mechanical, foundation and installation. Information and illustrations contained here are part of an original unpublished design by Labozan Associates, Inc. Detailing and information contained on these pages shall not be reproduced, copied or utilized in any way except for the specific project for which they were created without previous written authorization from Labozan Associates, Inc.  
© 2024 by Labozan Associates, Inc.

Wayfinding Updates

Issue Date: 08-23-2024  
Issue for Bid

- REV.
- REV.
- REV.

WARNING:

This record contains Sensitive Security Information that is controlled under 49 CFR parts 15 and 1520. No part of this record may be disclosed to persons with a "need to know," as defined in 49 CFR parts 15 and 1520, except with the written permission of the Administrator of the Transportation Security Administration or the Secretary of Transportation. Unauthorized release may result in civil penalty or other action. For U.S. government agencies, public disclosure is governed by 5 U.S.C. 552 and 49 CFR parts 15 and 1520.



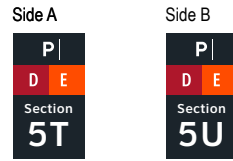
THESE SHEETS ARE ISSUED FOR GRAPHICAL INFORMATION ONLY

08-23-2024


8.6 MESSAGE SCHEDULE - GARAGE D/E: LEVEL 5 - SECTOR 3 (D/E)

BSG PRJCT# BSG-2024-111-IAH  
HAS TIP # 24 -103 - IAH


S3 DE.L5-105 5-ID.52 Notes: N/A




S3 DE.L5-109 5-ID.52 Notes: N/A

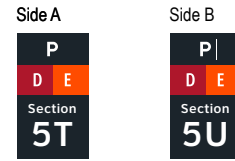

S3 DE.L5-106 5-ID.52 Notes: N/A

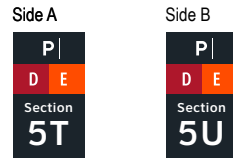


S3 DE.L5-110 5-ID.52 Notes: N/A

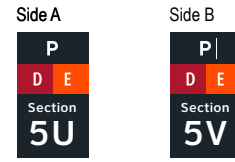


S3 DE.L5-107 5-ID.52 Notes: N/A



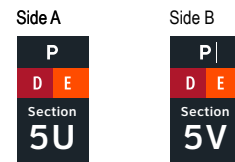
S3 DE.L5-111 5-ID.52 Notes: N/A




S3 DE.L5-108 5-ID.52 Notes: N/A

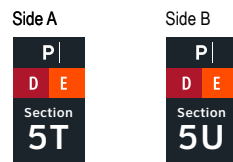

S3 DE.L5-112 5-ID.52 Notes: N/A

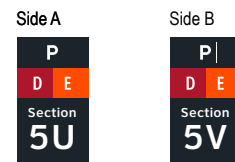


S3 DE.L5-113 5-ID.52 Notes: N/A

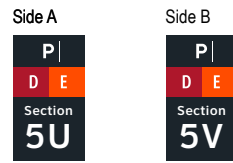

S3 DE.L5-117 5-ID.55 Notes: N/A



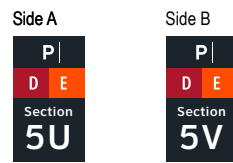
S3 DE.L5-114 5-ID.52 Notes: N/A



S3 DE.L5-118 5-ID.55 Notes: N/A



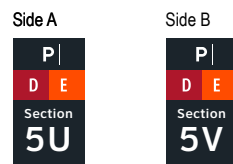S3 DE.L5-115 5-ID.52 Notes: N/A



S3 DE.L5-119 5-ID.55 Notes: N/A



S3 DE.L5-116 5-ID.55 Notes: N/A

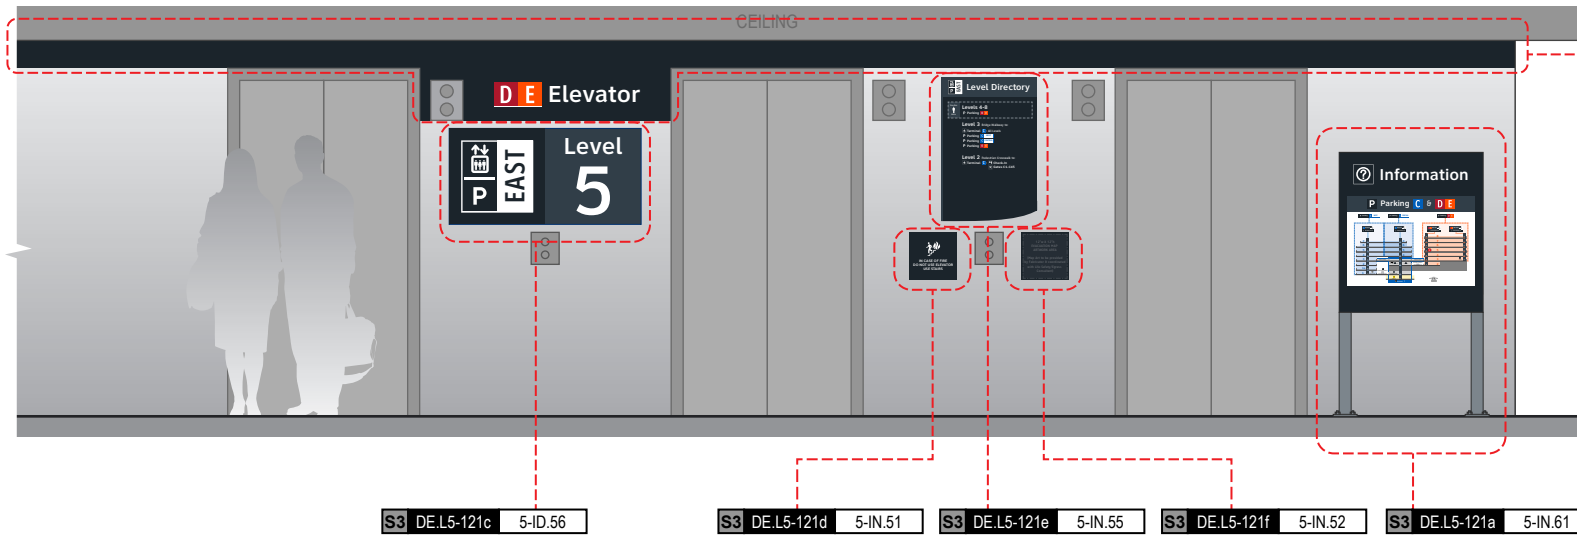


S3 DE.L5-120 N/A Notes: N/A

NOT USED

ELEVATOR CORE SIGNAGE CONTINUED ON NEXT SHEET

Side A



S3 DE.L5-121b 5-ID.57

NOTES: Wall paint and header graphics at front elevation only of elevator core included for this location number; wall elevation conditions shown are artistic representation based on rough site photo surveys; actual wall elevation conditions to be field verified by contractor/installer

S3 DE.L5-121c 5-ID.56

S3 DE.L5-121d 5-IN.51

NOTES: Level directory plaque includes a "You Are Here" graphic and is in a unique location per elevator core/level location; artwork included here is representative of final artwork design intent for this location

S3 DE.L5-121e 5-IN.55

S3 DE.L5-121f 5-IN.52

NOTES: Directory artwork includes a "You Are Here" button graphic and is in a unique location per elevator core/level location; artwork included here is representative of final map artwork design intent for this location

S3 DE.L5-121a 5-IN.61

Side B

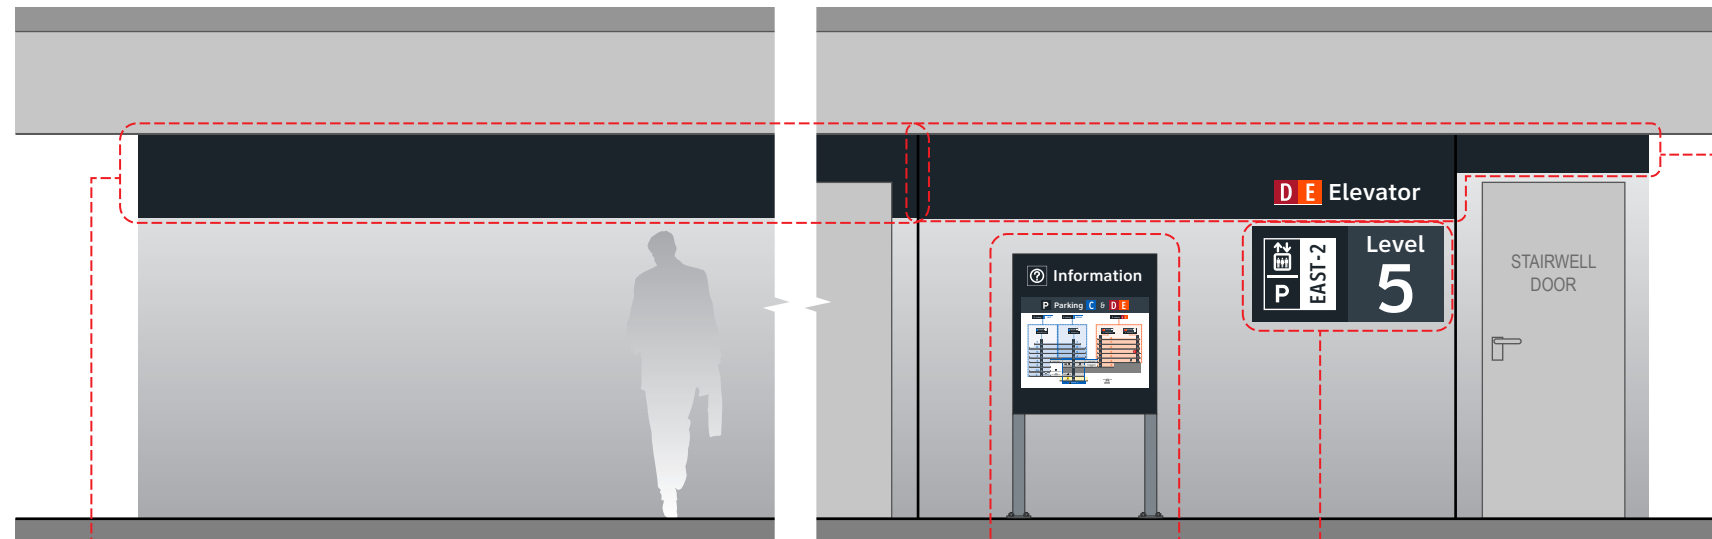


S3 DE.L5-121g 5-ID.59

NOTES: Wall paint and header graphics on garage-facing elevation of elevator core included for this location number; wall elevation conditions shown are artistic representation based on rough site photo surveys; actual wall elevation conditions to be field verified by contractor/installer

S3 DE.L5-121h 5-ID.58

Side A



S3 DE.L5-122a 5-IN.61

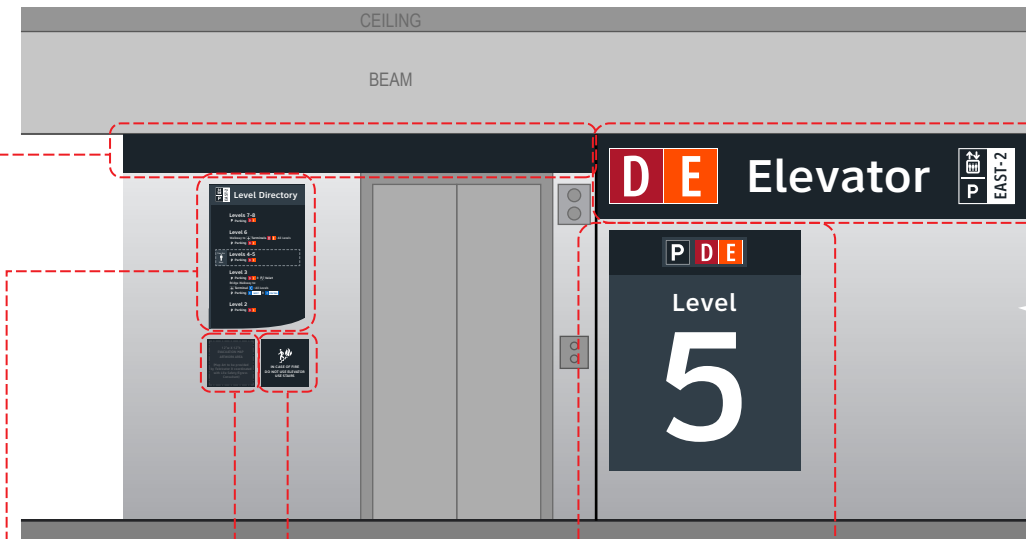
NOTES: Directory artwork includes a "You Are Here" button graphic and is in a unique location per elevator core/level location; artwork included here is representative of final map artwork design intent for this location

S3 DE.L5-122b 5-ID.56

S3 DE.L5-122 5-ID.57

NOTES: Wall paint and header graphics at A & C elevations only of elevator core included for this location number; wall elevation conditions shown are artistic representation based on rough site photo surveys; actual wall elevation conditions to be field verified by contractor/installer

Side C



S3 DE.L5-122c 5-IN.55

NOTES: Level directory plaque includes a "You Are Here" graphic and is in a unique location per elevator core/level location; artwork included here is representative of final artwork design intent for this location

S3 DE.L5-122d 5-IN.51

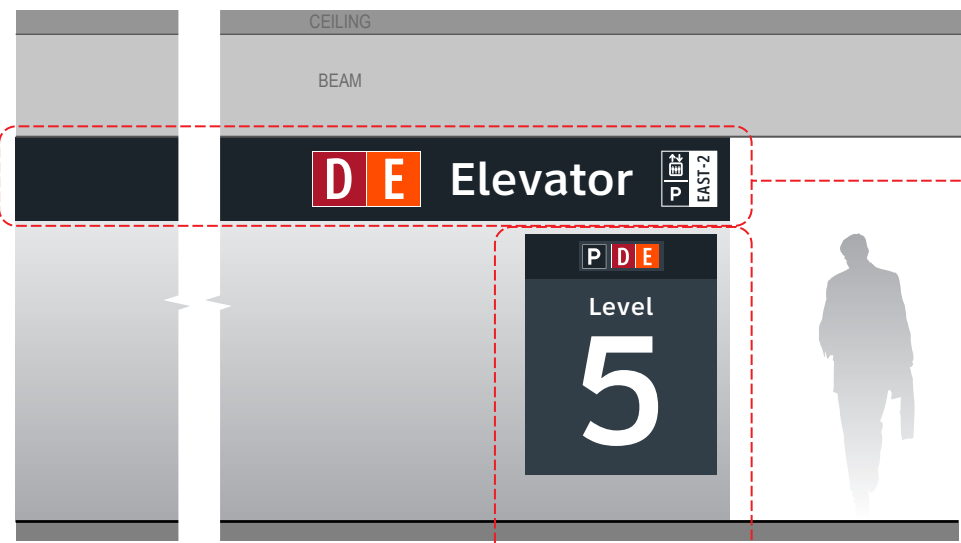
S3 DE.L5-122e 5-IN.52

S3 DE.L5-122h 5-ID.58

S3 DE.L5-122f 5-ID.59

NOTES: Wall paint and header graphics on rear and two side elevations of elevator core included for this location number; wall elevation conditions shown are artistic representation based on rough site photo surveys; actual wall elevation conditions to be field verified by contractor/installer

Side B



S3 DE.L5-122g 5-ID.59


NOTES: Wall paint and header graphics on rear and two side elevations of elevator core included for this location number; wall elevation conditions shown are artistic representation based on rough site photo surveys; actual wall elevation conditions to be field verified by contractor/installer

S3 DE.L5-122i 5-ID.58

## END OF GARAGE C: LEVEL 5 - SECTOR 3 MESSAGES
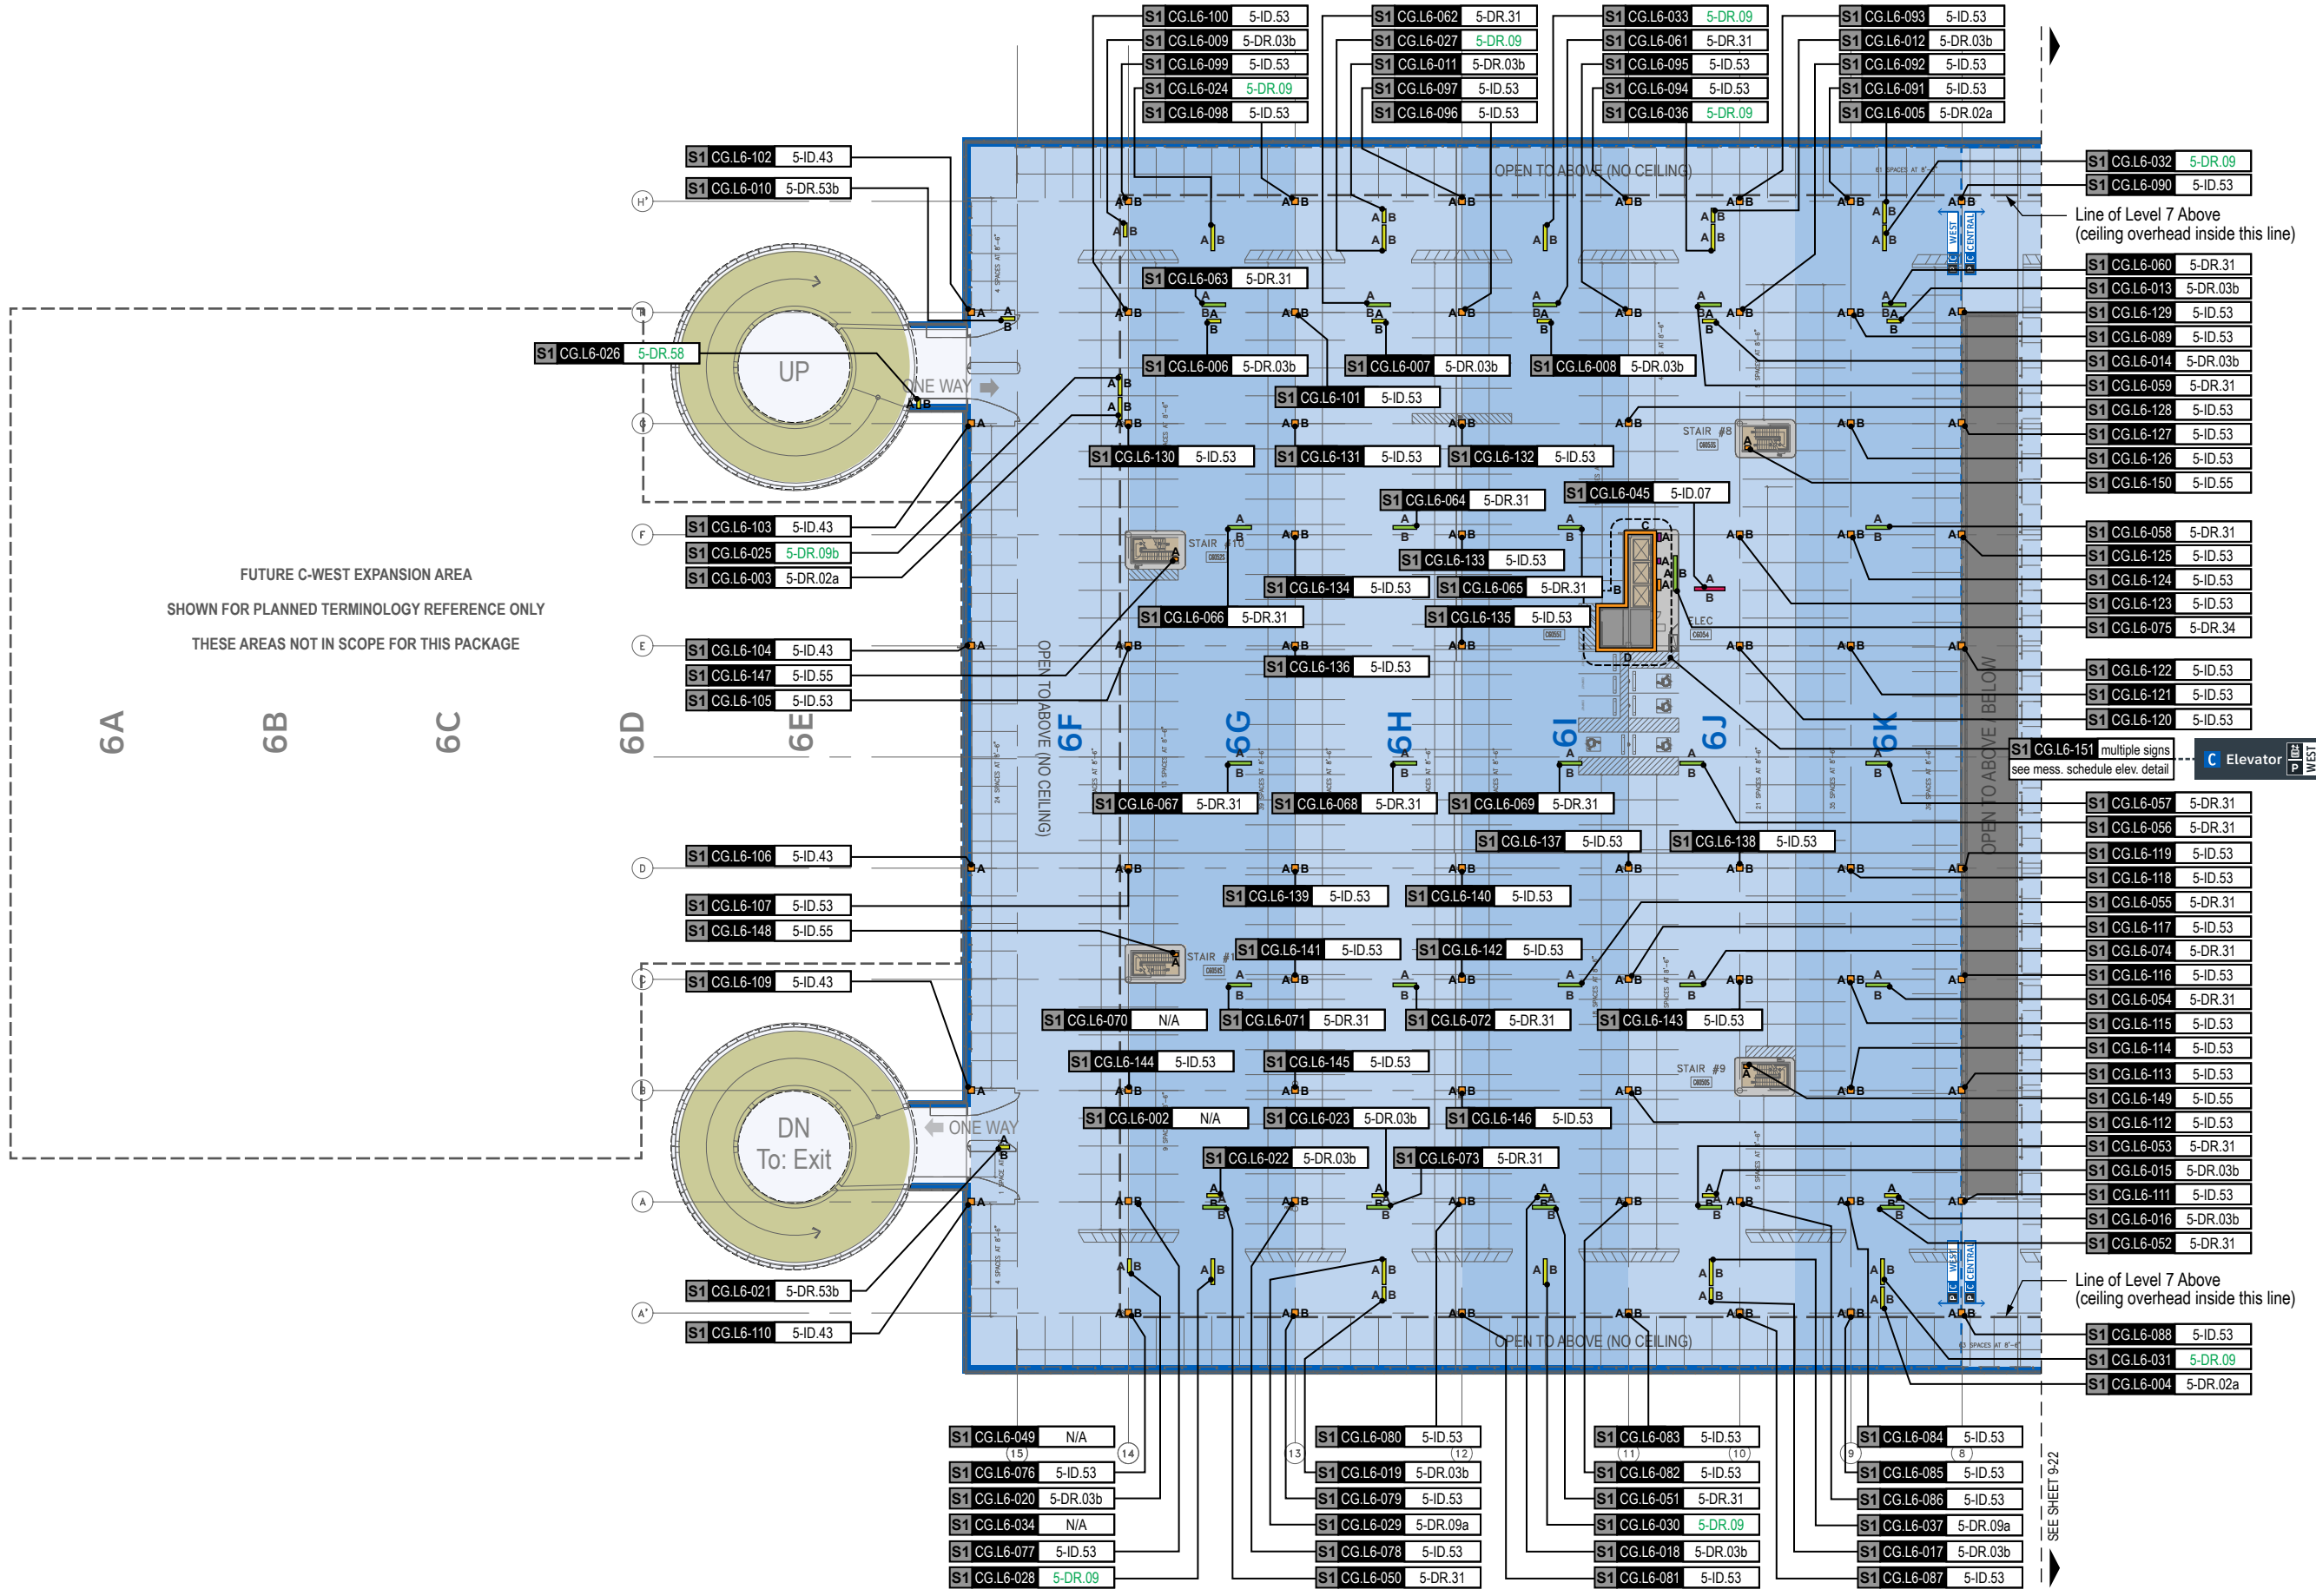
# 9.0

## **9.0 LOCATION PLANS & MESSAGE SCHEDULES: LEVEL 6**




FUTURE C-WEST EXPANSION AREA  
SHOWN FOR PLANNED TERMINOLOGY REFERENCE ONLY  
THESE AREAS NOT IN SCOPE FOR THIS PACKAGE

**GENERAL NOTES**

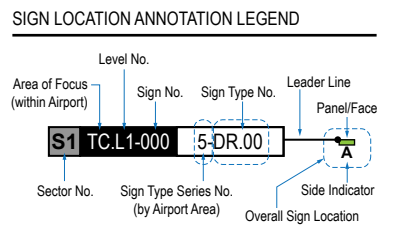- Sign locations & orientations shown here are approximations based on the most current plan drawings as provided to the designer by the architect at the time of this document's completion. These sign locations are for general design intent & wayfinding planning purposes only. They should not be construed or deemed as absolute or final locations. Field verification, marking & documentation of each final location is to be performed by the Fabricator/Installer & coordinated with project staff & Wayfinding Design Consultants for final approval.
- All final install locations must be marked and verified in the field for proper structural integrity, adequate line of sight, utilities / property-line / other existing signage interferences & must be in complete compliance with all local, state and national codes prior to fabrication or installation.
- Adjustments to the sign locations shown in these drawings must be documented by the Fabricator/Installer, and provided to project staff & Wayfinding Design Consultants for final approval.

**NOTE:** Only priority wayfinding signage & locations as shown in this wayfinding plan package are in scope. All other signage not shown (including traffic control) are NOT IN SCOPE for this project/contract.



**LOCATION CODE DEFINITIONS:**

AREA OF FOCUS: (location within Airport)

SIGN TYPE SERIES NO.: (by Airport Area)

TA = Terminal A  
TB = Terminal B  
TC = Terminal C  
TD = Terminal D  
TE = Terminal E  
AB = AB Garage  
CG = C Garage  
DE = DE Garage

SIGN TYPE DEFINITIONS: (by Airport Area)

1 = Terminals/Concourses  
2 = CBP Areas  
3 = Curbside/Ground Trans.  
4 = Roadways  
5 = Parking

WAYFINDING SIGN TYPE:

DR.xx = Directional  
ID.xx = Identification  
IN.xx = Informational

**WAYFINDING SIGN LOCATIONS - Parking:**

PEDESTRIAN Signs:

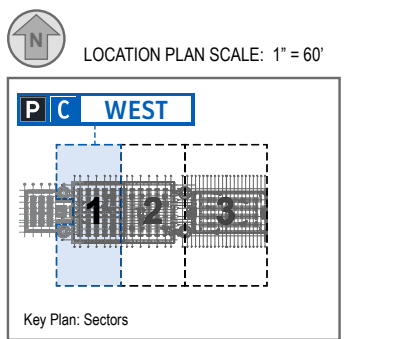
- A/B = Directional (DR)
- A/B = Identification (ID)
- A/B = Informational (IN)

VEHICULAR Signs:

- A/B = Directional (DR)
- A/B = Identification (ID)
- A/B = Informational (IN)

**CIRCULATION:**

- Public Use PEDESTRIAN Vertical Circulation (i.e. Elevators/Escalators/Stairs)
- Public Use VEHICULAR Vertical Circulation (i.e. Ramps)
- Alpha-Numeric Parking Section Naming Areas (Blues = C Garages; Oranges = D/E Garage)
- Areas Not In Scope for this Package




S1 CG.L6-001 N/A Notes: N/A

NOT USED


S1 CG.L6-002 N/A Notes: N/A

NOT USED

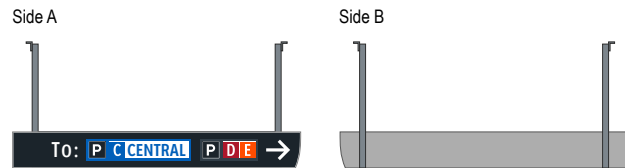
S1 CG.L6-003 5-DR.02a Notes: N/A




S1 CG.L6-005 5-DR.02a Notes: N/A

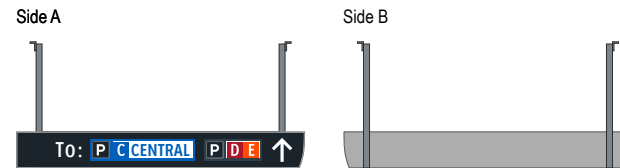


S1 CG.L6-006 5-DR.03b Notes: N/A

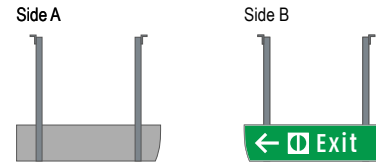


S1 CG.L6-007 5-DR.03b Notes: N/A

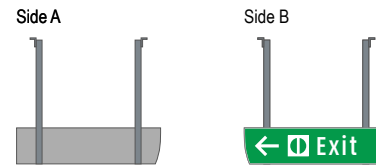

S1 CG.L6-004 5-DR.02a Notes: N/A

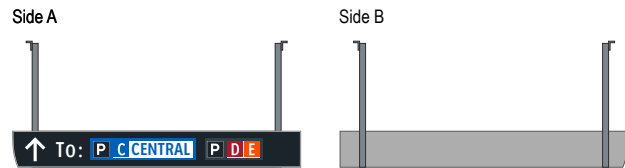


S1 CG.L6-008 5-DR.03b Notes: N/A

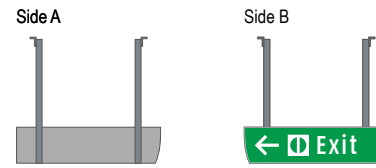





S1 CG.L6-009 5-DR.03b Notes: N/A

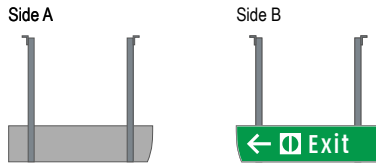


S1 CG.L6-013 5-DR.03b Notes: N/A

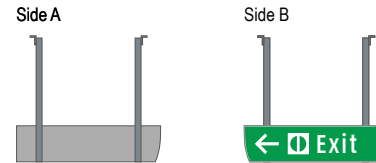


S1 CG.L6-010 5-DR.53b Notes: N/A

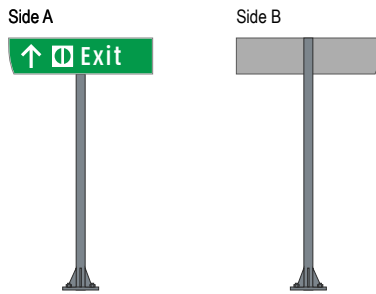


S1 CG.L6-014 5-DR.03b Notes: N/A

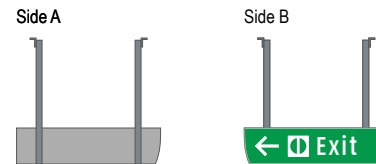


S1 CG.L6-011 5-DR.03b Notes: N/A

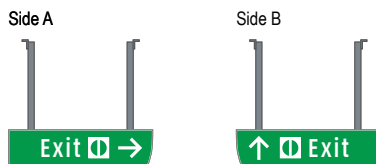


S1 CG.L6-015 5-DR.03b Notes: N/A

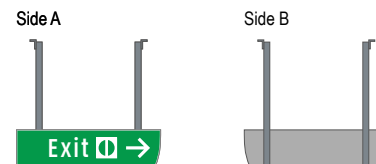


S1 CG.L6-012 5-DR.03b Notes: N/A

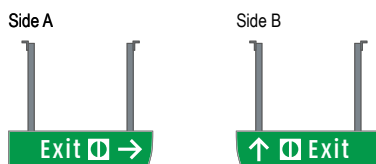


S1 CG.L6-016 5-DR.03b Notes: N/A

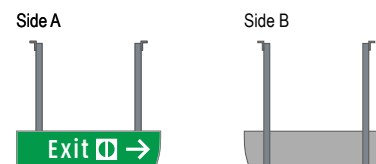


S1 CG.L6-017 5-DR.03b Notes: N/A

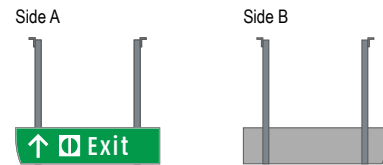


S1 CG.L6-021 5-DR.53b Notes: N/A

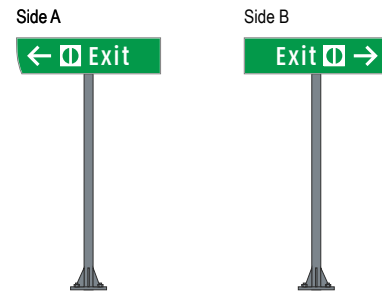


S1 CG.L6-018 5-DR.03b Notes: N/A

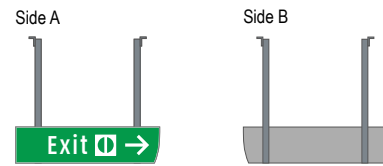


S1 CG.L6-022 5-DR.03b Notes: N/A

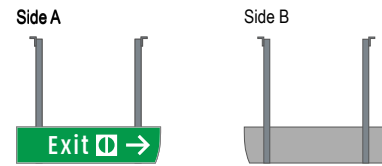


S1 CG.L6-019 5-DR.03b Notes: N/A

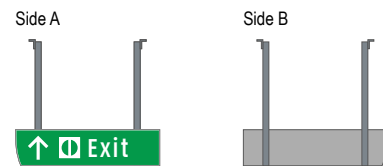


S1 CG.L6-023 5-DR.03b Notes: N/A

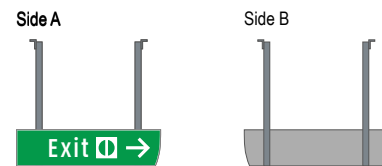


S1 CG.L6-020 5-DR.03b Notes: N/A

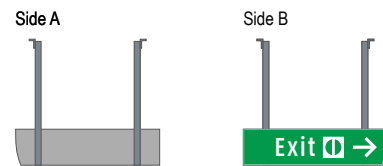


S1 CG.L6-024 5-DR.09 Notes: N/A

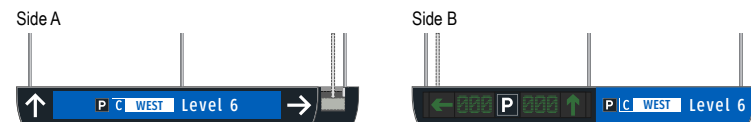

S1 CG.L6-025 5-DR.09b Notes: N/A

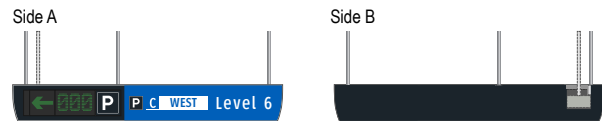

S1 CG.L6-029 5-DR.09a Notes: N/A

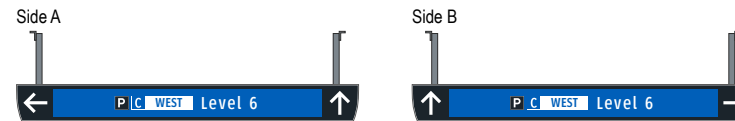


S1 CG.L6-026 5-DR.58 Notes: N/A



S1 CG.L6-030 5-DR.09 Notes: N/A



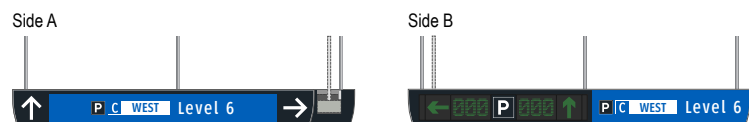
S1 CG.L6-027 5-DR.09 Notes: N/A




S1 CG.L6-031 5-DR.09 Notes: N/A



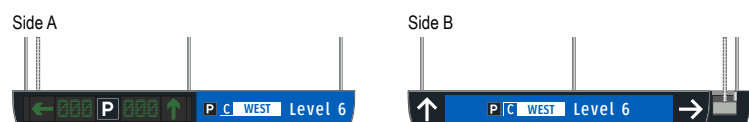S1 CG.L6-028 5-DR.09 Notes: N/A



S1 CG.L6-032 5-DR.09 Notes: N/A

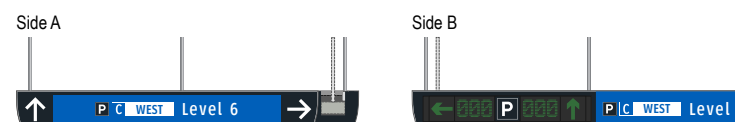

**Wayfinding Updates**

Issue Date: 08-23-2024

**Issue for Bid**

- REV. 
- REV. 
- REV. 

**WARNING:**

This record contains Sensitive Security Information that is controlled under 49 CFR parts 15 and 1520. No part of this record may be disclosed to persons with a "need to know," as defined in 49 CFR parts 15 and 1520, except with the written permission of the Administrator of the Transportation Security Administration or the Secretary of Transportation. Unauthorized release may result in civil penalty or other action. For U.S. government agencies, public disclosure is governed by 5 U.S.C. 552 and 49 CFR parts 15 and 1520.

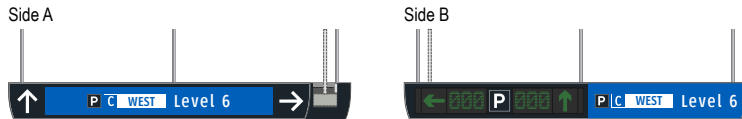


THESE SHEETS ARE ISSUED FOR GRAPHICAL INFORMATION ONLY


**9.2 MESSAGE SCHEDULE - GARAGE C: LEVEL 6 - SECTOR 1 (C WEST)**

BSG PRJCT# BSG-2024-111-IAH  
 HAS TIP # 24 -103 - IAH

S1 CG.L6-033 5-DR.09 Notes: N/A



S1 CG.L6-037 5-DR.09a Notes: N/A

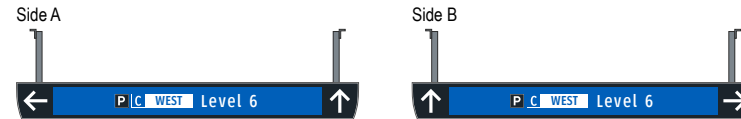

S1 CG.L6-034 N/A Notes: N/A

NOT USED

S1 CG.L6-038 N/A Notes: N/A

NOT USED

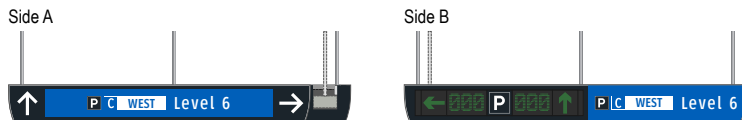
S1 CG.L6-035 N/A Notes: N/A

NOT USED

S1 CG.L6-039 N/A Notes: N/A

NOT USED

S1 CG.L6-036 5-DR.09 Notes: N/A



S1 CG.L6-040 N/A Notes: N/A

NOT USED

S1 CG.L6-041 N/A Notes: N/A

NOT USED

S1 CG.L6-042 N/A Notes: N/A

NOT USED

S1 CG.L6-043 N/A Notes: N/A

NOT USED

S1 CG.L6-044 N/A Notes: N/A

NOT USED

S1 CG.L6-045 5-ID.07 Notes: N/A

Side A

Side B



S1 CG.L6-046 N/A Notes: N/A

NOT USED

S1 CG.L6-047 N/A Notes: N/A

NOT USED

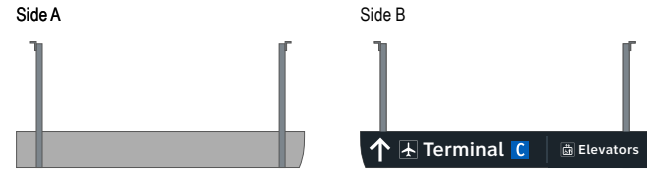
S1 CG.L6-048 N/A Notes: N/A

NOT USED


S1 CG.L6-049 N/A Notes: N/A

NOT USED


S1 CG.L6-053 5-DR.31 Notes: N/A




S1 CG.L6-050 5-DR.31 Notes: N/A

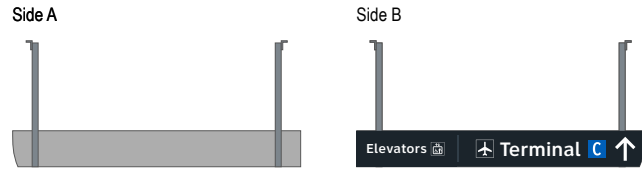


S1 CG.L6-054 5-DR.31 Notes: N/A

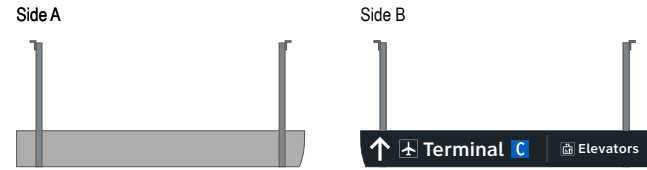


S1 CG.L6-051 5-DR.31 Notes: Notes: N/A

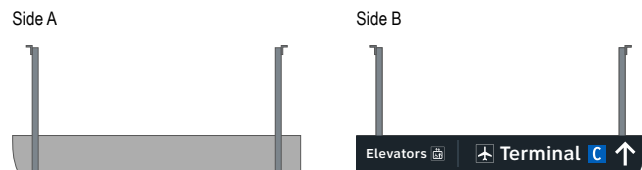


S1 CG.L6-055 5-DR.31 Notes: N/A

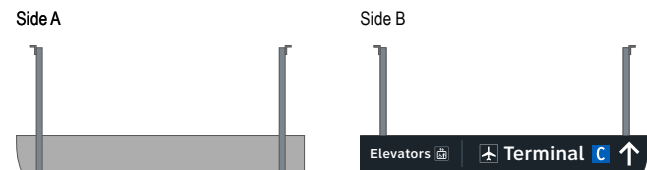

S1 CG.L6-052 5-DR.31 Notes: N/A

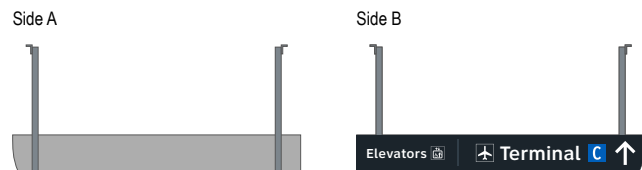

S1 CG.L6-056 5-DR.31 Notes: N/A

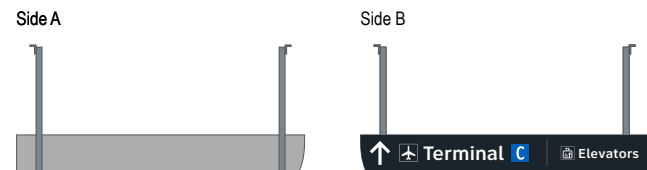

**Wayfinding Updates**

Issue Date: 08-23-2024

**Issue for Bid**

- REV. 
- REV. 
- REV. 

**WARNING:**

This record contains Sensitive Security Information that is controlled under 49 CFR parts 15 and 1520. No part of this record may be disclosed to persons with a "need to know," as defined in 49 CFR parts 15 and 1520, except with the written permission of the Administrator of the Transportation Security Administration or the Secretary of Transportation. Unauthorized release may result in civil penalty or other action. For U.S. government agencies, public disclosure is governed by 5 U.S.C. 552 and 49 CFR parts 15 and 1520.

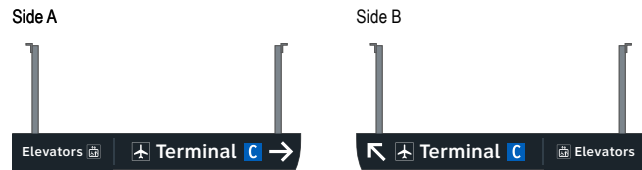


THESE SHEETS ARE ISSUED FOR GRAPHICAL INFORMATION ONLY


**9.2 MESSAGE SCHEDULE - GARAGE C: LEVEL 6 - SECTOR 1 (C WEST)**

BSG PRJCT# BSG-2024-111-IAH  
 HAS TIP # 24 -103 - IAH


S1 CG.L6-057 5-DR.31 Notes: N/A




S1 CG.L6-061 5-DR.31 Notes: N/A

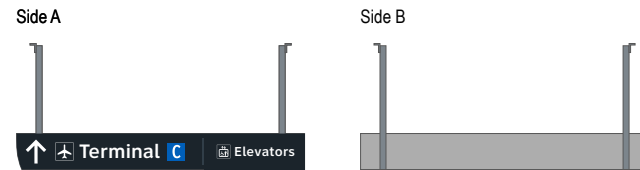


S1 CG.L6-058 5-DR.31 Notes: N/A

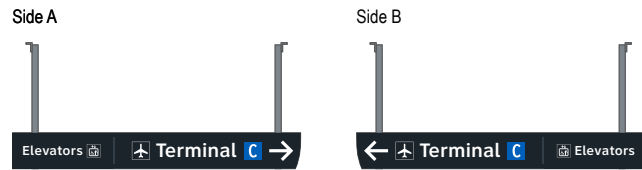


S1 CG.L6-062 5-DR.31 Notes: N/A

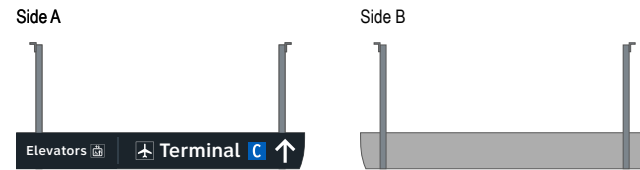


S1 CG.L6-059 5-DR.31 Notes: N/A

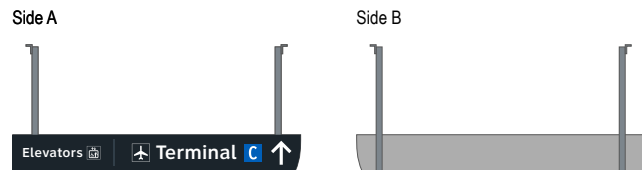


S1 CG.L6-063 5-DR.31 Notes: N/A

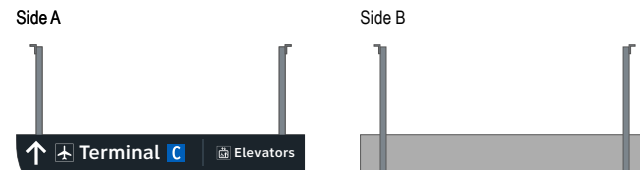

S1 CG.L6-060 5-DR.31 Notes: N/A

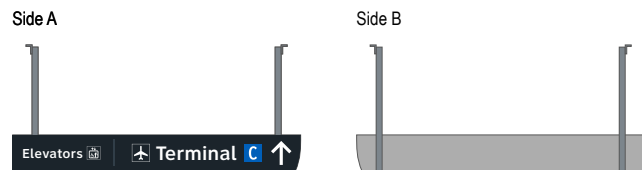

S1 CG.L6-064 5-DR.31 Notes: N/A

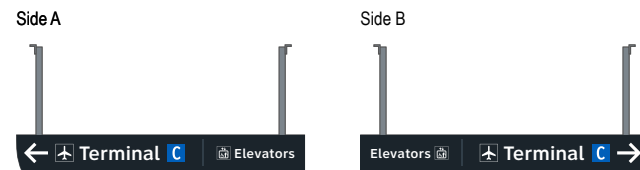

**Wayfinding Updates**

Issue Date: 08-23-2024

Issue for Bid

- REV. 
- REV. 
- REV. 

**WARNING:**

This record contains Sensitive Security Information that is controlled under 49 CFR parts 15 and 1520. No part of this record may be disclosed to persons with a "need to know," as defined in 49 CFR parts 15 and 1520, except with the written permission of the Administrator of the Transportation Security Administration or the Secretary of Transportation. Unauthorized release may result in civil penalty or other action. For U.S. government agencies, public disclosure is governed by 5 U.S.C. 552 and 49 CFR parts 15 and 1520.

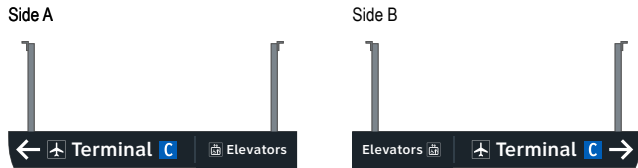


THESE SHEETS ARE ISSUED FOR GRAPHICAL INFORMATION ONLY


**9.2 MESSAGE SCHEDULE - GARAGE C: LEVEL 6 - SECTOR 1 (C WEST)**

BSG PRJCT# BSG-2024-111-IAH  
 HAS TIP # 24 -103 - IAH


S1 CG.L6-065 5-DR.31 Notes: N/A



S1 CG.L6-069 5-DR.31 Notes: N/A

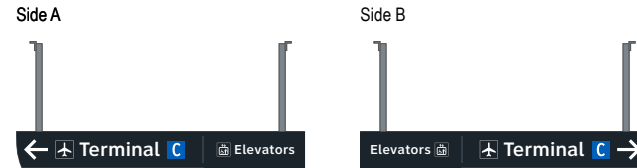


S1 CG.L6-066 5-DR.31 Notes: N/A

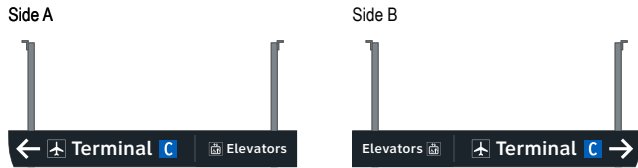


S1 CG.L6-070 N/A Notes: N/A

NOT USED

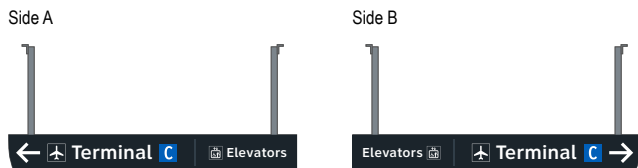
S1 CG.L6-067 5-DR.31 Notes: N/A




S1 CG.L6-071 5-DR.31 Notes: N/A

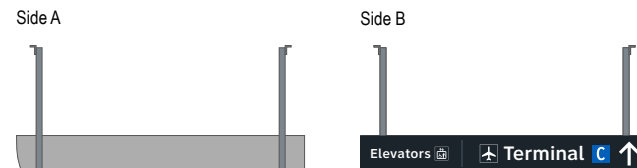

S1 CG.L6-068 5-DR.31 Notes: N/A

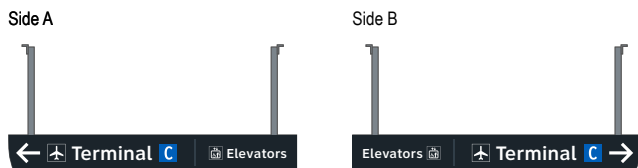

S1 CG.L6-072 5-DR.31 Notes: N/A

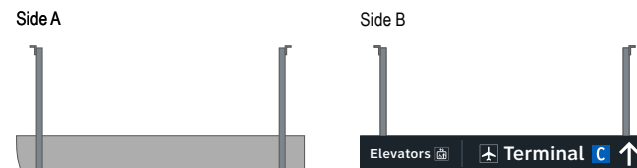

Wayfinding Updates

Issue Date: 08-23-2024

Issue for Bid

- REV. ⚠
- REV. ⚠
- REV. ⚠

WARNING:

This record contains Sensitive Security Information that is controlled under 49 CFR parts 15 and 1520. No part of this record may be disclosed to persons with a "need to know," as defined in 49 CFR parts 15 and 1520, except with the written permission of the Administrator of the Transportation Security Administration or the Secretary of Transportation. Unauthorized release may result in civil penalty or other action. For U.S. government agencies, public disclosure is governed by 5 U.S.C. 552 and 49 CFR parts 15 and 1520.



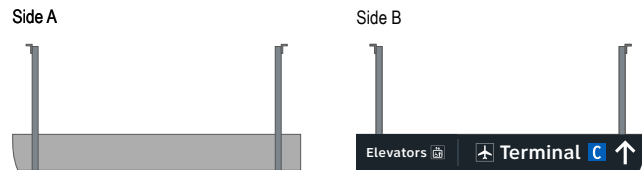
THESE SHEETS ARE ISSUED FOR GRAPHICAL INFORMATION ONLY

9.2 MESSAGE SCHEDULE - GARAGE C: LEVEL 6 - SECTOR 1 (C WEST)


BSG PRJCT# BSG-2024-111-IAH  
 HAS TIP # 24 -103 - IAH




S1 CG.L6-073 5-DR.31 Notes: N/A




S1 CG.L6-077 5-ID.53 Notes: N/A

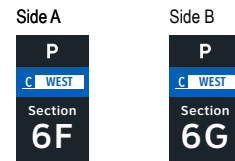


S1 CG.L6-074 5-DR.31 Notes: N/A

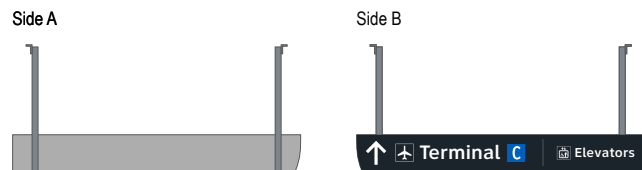


S1 CG.L6-078 5-ID.53 Notes: N/A

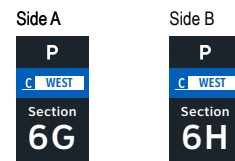


S1 CG.L6-075 5-DR.34 Notes: N/A

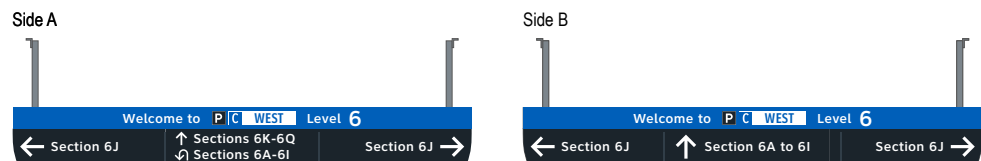


S1 CG.L6-079 5-ID.53 Notes: N/A

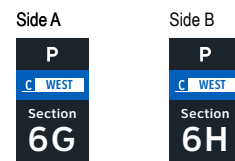

S1 CG.L6-076 5-ID.53 Notes: N/A

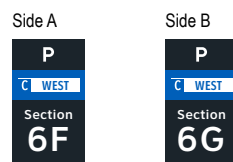

S1 CG.L6-080 5-ID.53 Notes: N/A

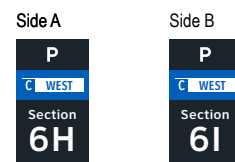

**Wayfinding Updates**

Issue Date: 08-23-2024

**Issue for Bid**

- REV. 
- REV. 
- REV. 

**WARNING:**

This record contains Sensitive Security Information that is controlled under 49 CFR parts 15 and 1520. No part of this record may be disclosed to persons with a "need to know," as defined in 49 CFR parts 15 and 1520, except with the written permission of the Administrator of the Transportation Security Administration or the Secretary of Transportation. Unauthorized release may result in civil penalty or other action. For U.S. government agencies, public disclosure is governed by 5 U.S.C. 552 and 49 CFR parts 15 and 1520.

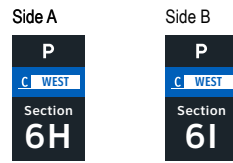


THESE SHEETS ARE ISSUED FOR GRAPHICAL INFORMATION ONLY


**9.2 MESSAGE SCHEDULE - GARAGE C: LEVEL 6 - SECTOR 1 (C WEST)**

BSG PRJCT# BSG-2024-111-IAH  
 HAS TIP # 24 -103 - IAH


S1 CG.L6-081 5-ID.53 Notes: N/A




S1 CG.L6-085 5-ID.53 Notes: N/A

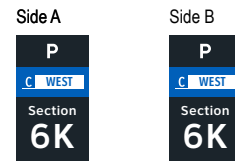


S1 CG.L6-082 5-ID.53 Notes: N/A

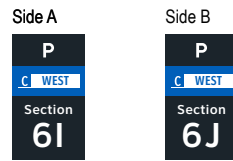


S1 CG.L6-086 5-ID.53 Notes: N/A

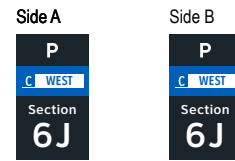


S1 CG.L6-083 5-ID.53 Notes: N/A

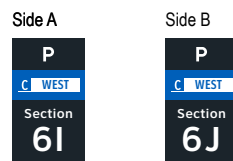


S1 CG.L6-087 5-ID.53 Notes: N/A

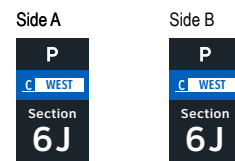


S1 CG.L6-084 5-ID.53 Notes: N/A

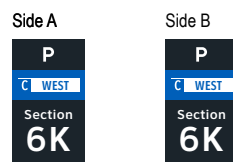


S1 CG.L6-088 5-ID.53 Notes: N/A

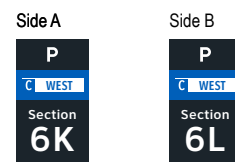


S1 CG.L6-089 5-ID.53 Notes: N/A

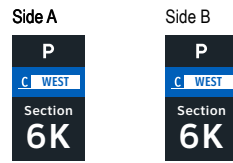


S1 CG.L6-093 5-ID.53 Notes: N/A

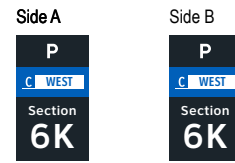


S1 CG.L6-090 5-ID.53 Notes: N/A

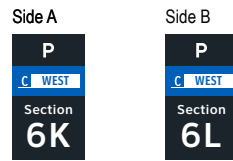


S1 CG.L6-094 5-ID.53 Notes: N/A

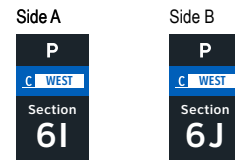


S1 CG.L6-091 5-ID.53 Notes: N/A

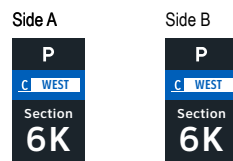


S1 CG.L6-095 5-ID.53 Notes: N/A

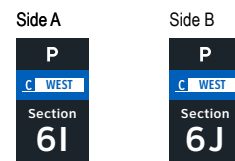


S1 CG.L6-092 5-ID.53 Notes: N/A

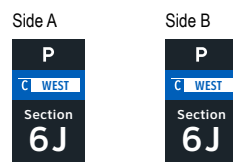


S1 CG.L6-096 5-ID.53 Notes: N/A

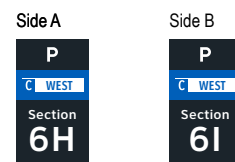


S1 CG.L6-097 5-ID.53 Notes: N/A

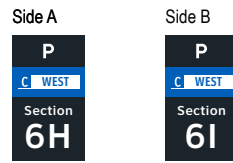


S1 CG.L6-101 5-ID.53 Notes: N/A

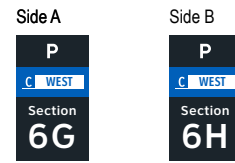


S1 CG.L6-098 5-ID.53 Notes: N/A

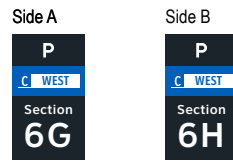


S1 CG.L6-102 5-ID.43 Notes: N/A

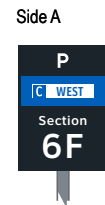


S1 CG.L6-099 5-ID.53 Notes: N/A

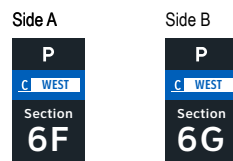


S1 CG.L6-103 5-ID.43 Notes: N/A

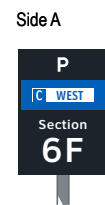


S1 CG.L6-100 5-ID.53 Notes: N/A

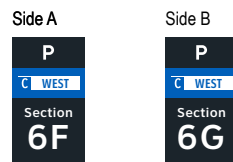


S1 CG.L6-104 5-ID.43 Notes: N/A

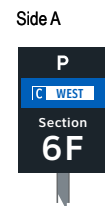


S1 CG.L6-105 5-ID.53 Notes: N/A

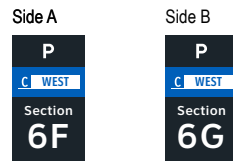


S1 CG.L6-109 5-ID.43 Notes: N/A

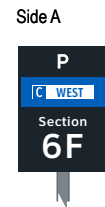


S1 CG.L6-106 5-ID.43 Notes: N/A

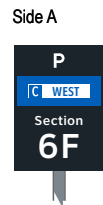

S1 CG.L6-110 5-ID.43 Notes: N/A

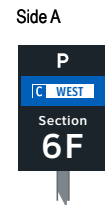


S1 CG.L6-107 5-ID.53 Notes: N/A

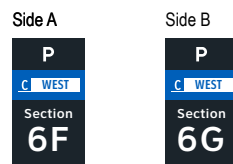


S1 CG.L6-111 5-ID.53 Notes: N/A



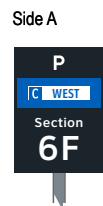S1 CG.L6-108 5-ID.43 Notes: N/A




S1 CG.L6-112 5-ID.53 Notes: N/A

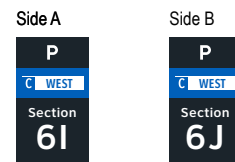


Side A



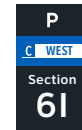
Side A




Side B

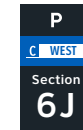


Side A

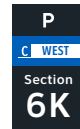


Side B

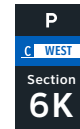

Side A

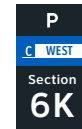

Side B

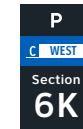

Side A



Side B



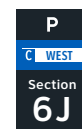
Side A



Side A



Side A



Side B



**Wayfinding Updates**

Issue Date: 08-23-2024

**Issue for Bid**

- REV.
- REV.
- REV.

**WARNING:**

This record contains Sensitive Security Information that is controlled under 49 CFR parts 15 and 1520. No part of this record may be disclosed to persons with a "need to know," as defined in 49 CFR parts 15 and 1520, except with the written permission of the Administrator of the Transportation Security Administration or the Secretary of Transportation. Unauthorized release may result in civil penalty or other action. For U.S. government agencies, public disclosure is governed by 5 U.S.C. 552 and 49 CFR parts 15 and 1520.



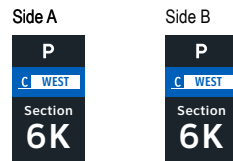
08-23-2024

THESE SHEETS ARE ISSUED FOR GRAPHICAL INFORMATION ONLY


**9.2 MESSAGE SCHEDULE - GARAGE C: LEVEL 6 - SECTOR 1 (C WEST)**

BSG PRJCT# BSG-2024-111-IAH  
HAS TIP # 24 -103 - IAH


S1 CG.L6-121 5-ID.53 Notes: N/A




S1 CG.L6-125 5-ID.53 Notes: N/A

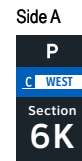


S1 CG.L6-122 5-ID.53 Notes: N/A

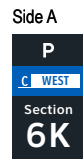


S1 CG.L6-126 5-ID.53 Notes: N/A

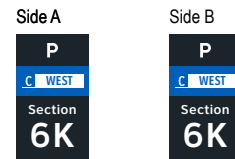


S1 CG.L6-123 5-ID.53 Notes: N/A

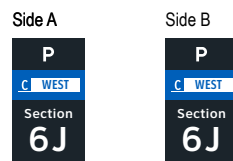


S1 CG.L6-127 5-ID.53 Notes: N/A

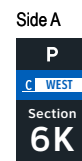

S1 CG.L6-124 5-ID.53 Notes: N/A

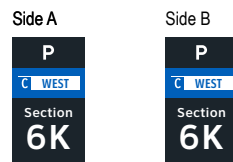

S1 CG.L6-128 5-ID.53 Notes: N/A

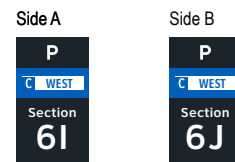

GEORGE BUSH INTERCONTINENTAL AIRPORT  
Wayfinding Signage Design Intent Documents  
C Garage



Louisville, Colorado  
P: 303.494.7849  
www.labozan.com

These documents are intended to illustrate design intent, and should only be used as a general guideline. No information contained here should be construed as engineered elements. The fabricator/contractor shall be responsible for all engineering and specifications with regard to structural, electrical, mechanical, foundation and installation. Information and illustrations contained here are part of an original unpublished design by Labozan Associates, Inc. Detailing and information contained on these pages shall not be reproduced, copied or utilized in any way except for the specific project for which they were created without previous written authorization from Labozan Associates, Inc.  
© 2024 by Labozan Associates, Inc.

Wayfinding Updates

Issue Date: 08-23-2024  
Issue for Bid

- REV.
- REV.
- REV.

WARNING:

This record contains Sensitive Security Information that is controlled under 49 CFR parts 15 and 1520. No part of this record may be disclosed to persons with a "need to know," as defined in 49 CFR parts 15 and 1520, except with the written permission of the Administrator of the Transportation Security Administration or the Secretary of Transportation. Unauthorized release may result in civil penalty or other action. For U.S. government agencies, public disclosure is governed by 5 U.S.C. 552 and 49 CFR parts 15 and 1520.



08-23-2024

THESE SHEETS ARE ISSUED FOR GRAPHICAL INFORMATION ONLY

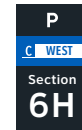
9.2 MESSAGE SCHEDULE - GARAGE C: LEVEL 6 - SECTOR 1 (C WEST)

BSG PRJCT# BSG-2024-111-IAH  
HAS TIP # 24 -103 - IAH


Side A




Side A



Side B

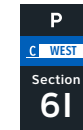


Side A

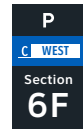


Side B



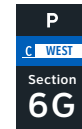
Side A



Side B

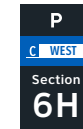


Side A

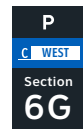


Side B



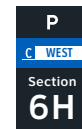
Side A




Side B

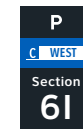


Side A

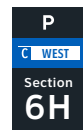


Side B

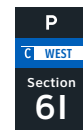

Side A

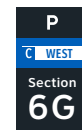

Side B

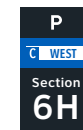

Wayfinding Updates

Issue Date: 08-23-2024  
Issue for Bid



WARNING:

This record contains Sensitive Security Information that is controlled under 49 CFR parts 15 and 1520. No part of this record may be disclosed to persons with a "need to know," as defined in 49 CFR parts 15 and 1520, except with the written permission of the Administrator of the Transportation Security Administration or the Secretary of Transportation. Unauthorized release may result in civil penalty or other action. For U.S. government agencies, public disclosure is governed by 5 U.S.C. 552 and 49 CFR parts 15 and 1520.



08-23-2024

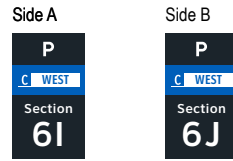
THESE SHEETS ARE ISSUED FOR GRAPHICAL INFORMATION ONLY

9.2 MESSAGE SCHEDULE - GARAGE C: LEVEL 6 - SECTOR 1 (C WEST)


BSG PRJCT# BSG-2024-111-IAH  
HAS TIP # 24 -103 - IAH




S1 CG.L6-137 5-ID.53 Notes: N/A




S1 CG.L6-141 5-ID.53 Notes: N/A

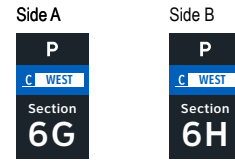


S1 CG.L6-138 5-ID.53 Notes: N/A

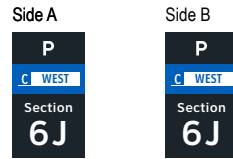


S1 CG.L6-142 5-ID.53 Notes: N/A

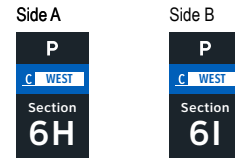


S1 CG.L6-139 5-ID.53 Notes: N/A

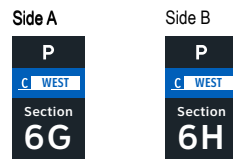


S1 CG.L6-143 5-ID.53 Notes: N/A

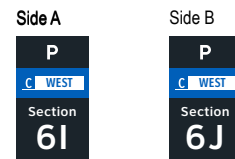

S1 CG.L6-140 5-ID.53 Notes: N/A

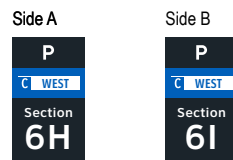

S1 CG.L6-144 5-ID.53 Notes: N/A

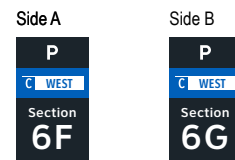

S1 CG.L6-145 5-ID.53 Notes: N/A

Side A      Side B

P

C WEST

Section

**6G**

P

C WEST

Section

**6H**

S1 CG.L6-149 5-ID.55 Notes: N/A

Side A

P

C WEST

Level

**6**

Stairs 9

S1 CG.L6-146 5-ID.53 Notes: N/A

Side A      Side B

P

C WEST

Section

**6H**

P

C WEST

Section

**6I**

S1 CG.L6-150 5-ID.55 Notes: N/A

Side A

P

C WEST

Level

**6**

Stairs 8

S1 CG.L6-147 5-ID.55 Notes: N/A

Side A

P

C WEST

Level

**6**

Stairs 10

ELEVATOR CORE SIGNAGE CONTINUED ON NEXT SHEET

S1 CG.L6-148 5-ID.55 Notes: N/A

Side A

P

C WEST

Level

**6**

Stairs 11

**Wayfinding Updates**

Issue Date: 08-23-2024

**Issue for Bid**

- REV. 
- REV. 
- REV. 

**WARNING:**

This record contains Sensitive Security Information that is controlled under 49 CFR parts 15 and 1520. No part of this record may be disclosed to persons with a "need to know," as defined in 49 CFR parts 15 and 1520, except with the written permission of the Administrator of the Transportation Security Administration or the Secretary of Transportation. Unauthorized release may result in civil penalty or other action. For U.S. government agencies, public disclosure is governed by 5 U.S.C. 552 and 49 CFR parts 15 and 1520.

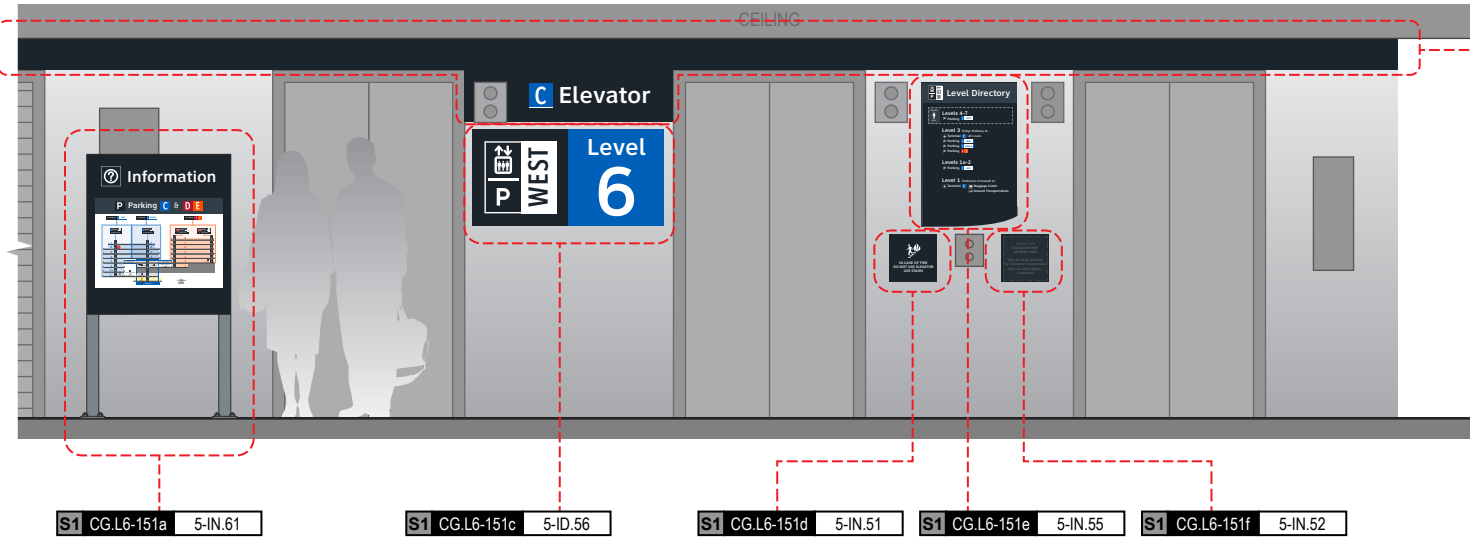


THESE SHEETS ARE ISSUED FOR GRAPHICAL INFORMATION ONLY

**9.2 MESSAGE SCHEDULE - GARAGE C: LEVEL 6 - SECTOR 1 (C WEST)**

BSG PRJCT# BSG-2024-111-IAH  
HAS TIP # 24 -103 - IAH

Side A



S1 CG.L6-151a 5-IN.61

S1 CG.L6-151c 5-ID.56

S1 CG.L6-151d 5-IN.51

S1 CG.L6-151e 5-IN.55

S1 CG.L6-151f 5-IN.52

NOTES: Directory artwork includes a "You Are Here" button graphic and is in a unique location per elevator core/level location; artwork included here is representative of final map artwork design intent for this location

NOTES: Level directory plaque includes a "You Are Here" graphic and is in a unique location per elevator core/level location; artwork included here is representative of final artwork design intent for this location

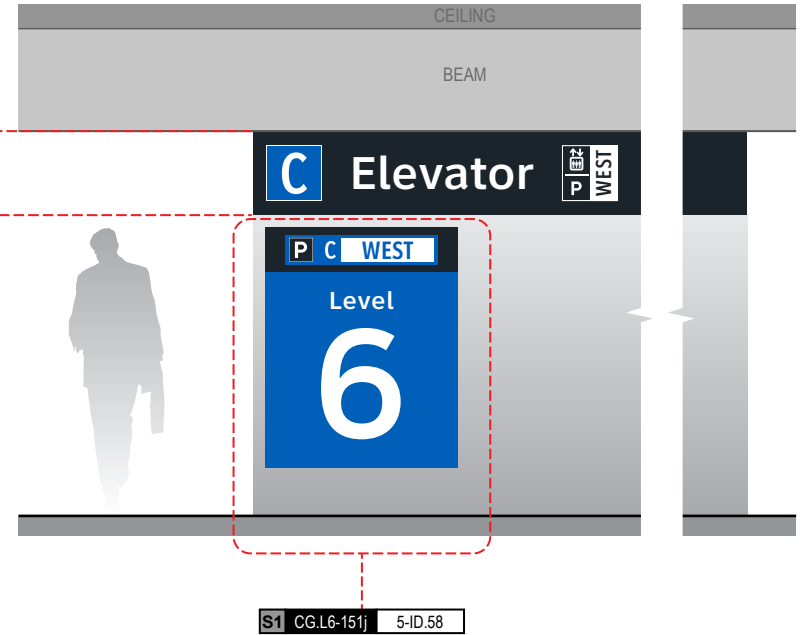
S1 CG.L6-151b 5-ID.57

NOTES: Wall paint and header graphics at front elevation only of elevator core included for this location number; wall elevation conditions shown are artistic representation based on rough site photo surveys; actual wall elevation conditions to be field verified by contractor/installer

S1 CG.L6-151g 5-ID.59


NOTES: Wall paint and header graphics on rear and two side elevations of elevator core included for this location number; wall elevation conditions shown are artistic representation based on rough site photo surveys; actual wall elevation conditions to be field verified by contractor/installer

Side C



S1 CG.L6-151j 5-ID.58

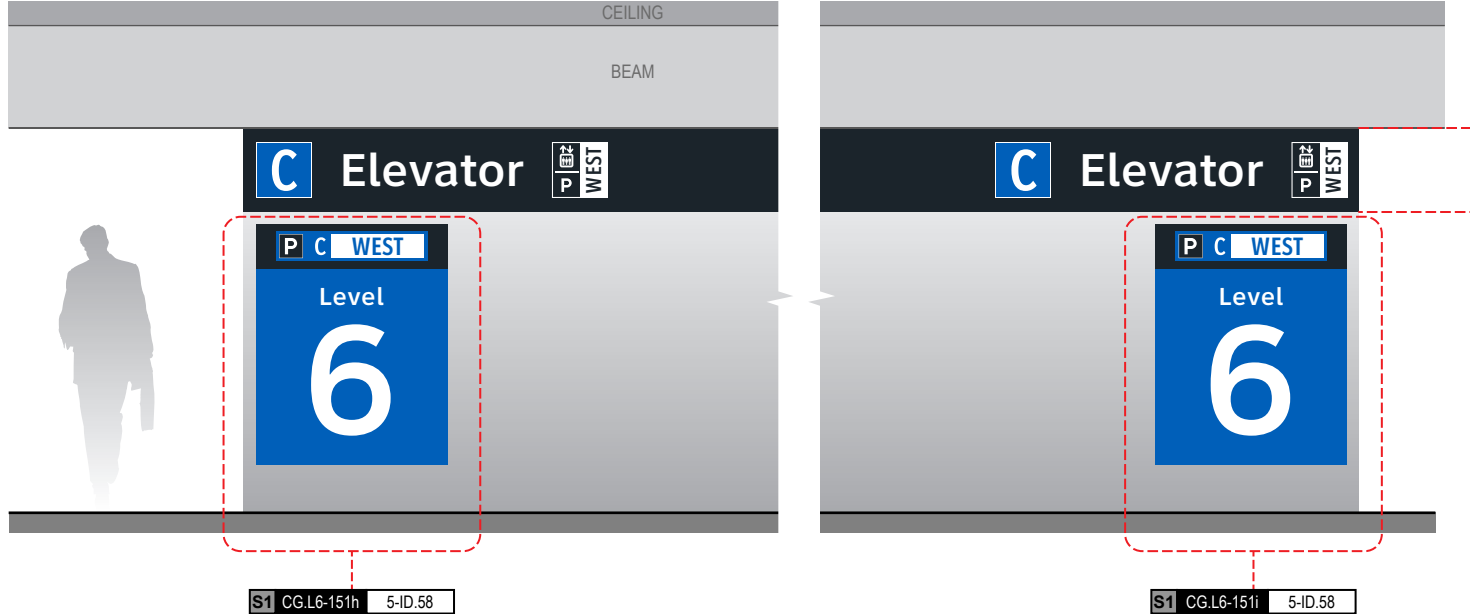
Side B



S1 CG.L6-151h 5-ID.58


S1 CG.L6-151i 5-ID.58

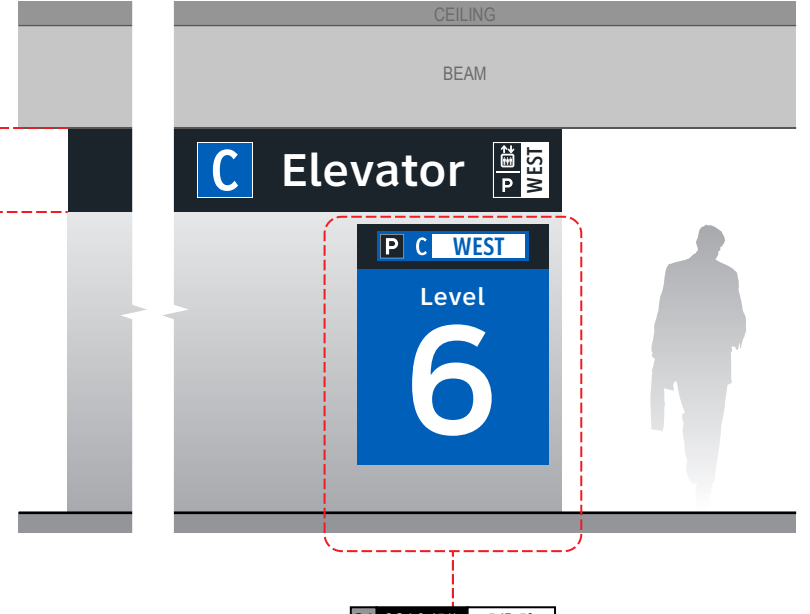Side D



S1 CG.L6-151k 5-ID.58


**END OF GARAGE C: LEVEL 6 - SECTOR 1 MESSAGES**

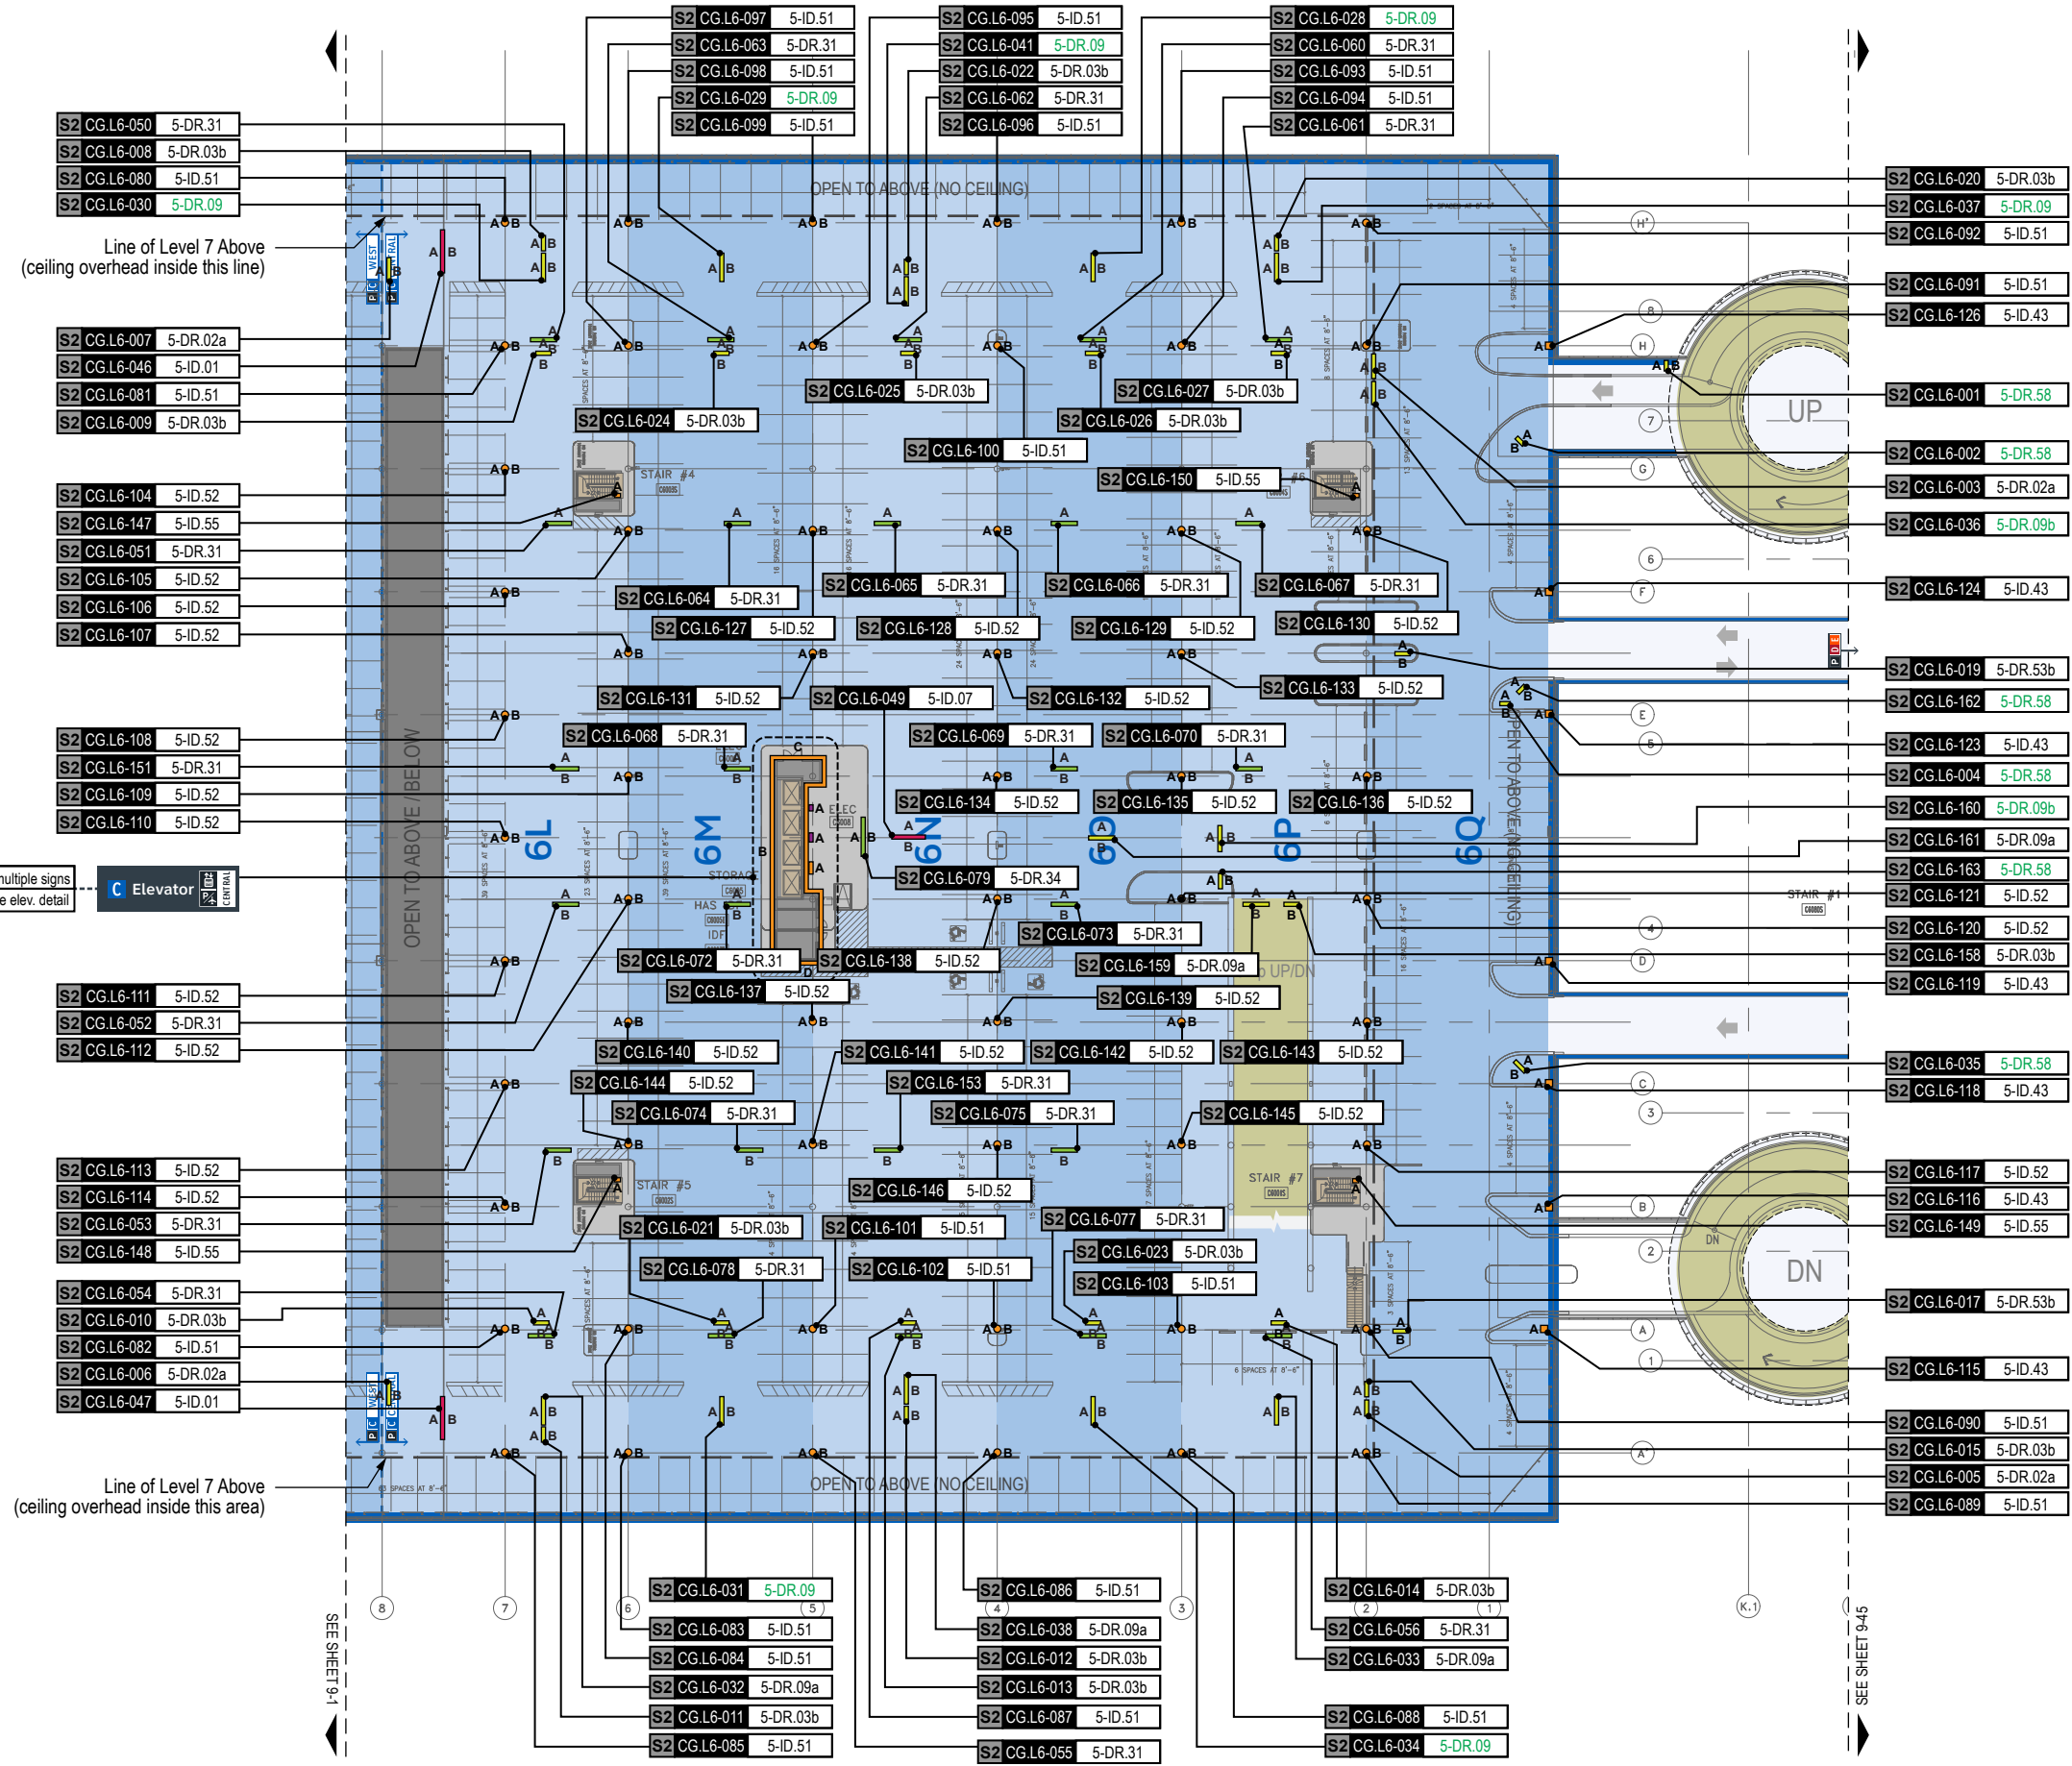

**GENERAL NOTES**

- Sign locations & orientations shown here are approximations based on the most current plan drawings as provided to the designer by the architect at the time of this document's completion. These sign locations are for general design intent & wayfinding planning purposes only. They should not be construed or deemed as absolute or final locations. Field verification, marking & documentation of each final location is to be performed by the Fabricator/Installer & coordinated with project staff & Wayfinding Design Consultants for final approval.
- All final install locations must be marked and verified in the field for proper structural integrity, adequate line of sight, utilities / property-line / other existing signage interferences & must be in complete compliance with all local, state and national codes prior to fabrication or installation.
- Adjustments to the sign locations shown in these drawings must be documented by the Fabricator/Installer, and provided to project staff & Wayfinding Design Consultants for final approval.

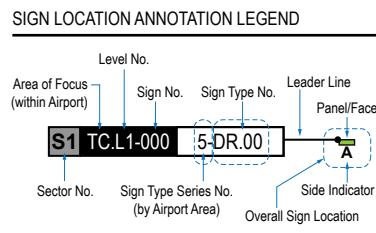**NOTE:** Only priority wayfinding signage & locations as shown in this wayfinding plan package are in scope. All other signage not shown (including traffic control) are NOT IN SCOPE for this project/contract.



**LOCATION CODE DEFINITIONS:**

**AREA OF FOCUS:** (location within Airport)

**SIGN TYPE SERIES NO.:** (by Airport Area)

TA = Terminal A  
TB = Terminal B  
TC = Terminal C  
TD = Terminal D  
TE = Terminal E  
AB = AB Garage  
CG = C Garage  
DE = DE Garage

1- = Terminals/Concourses  
2- = CBP Areas  
3- = Curbside/Ground Trans.  
4- = Roadways  
5- = Parking

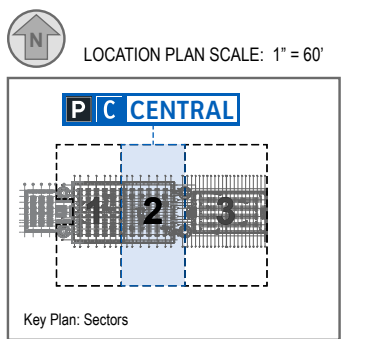
**WAYFINDING SIGN TYPE:**  
DR.xx = Directional  
ID.xx = Identification  
IN.xx = Informational

**WAYFINDING SIGN LOCATIONS - Parking:**


**PEDESTRIAN Signs:**  
A = Directional (DR)  
B = Identification (ID)  
IN = Informational (IN)

**VEHICULAR Signs:**  
A = Directional (DR)  
B = Identification (ID)  
IN = Informational (IN)


**CIRCULATION:**  
Public Use PEDESTRIAN Vertical Circulation (i.e. Elevators/Escalators/Stairs)  
Public Use VEHICULAR Vertical Circulation (i.e. Ramps)  
Alpha-Numeric Parking Section Naming Areas (Blues = C Garages; Oranges = D/E Garage)  
Areas Not In Scope for this Package




S2 CG.L6-001 5-DR.58 Notes: N/A

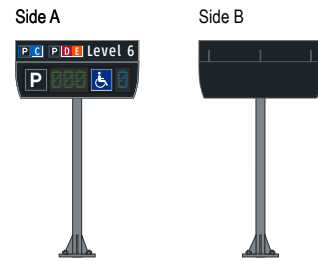


S2 CG.L6-005 5-DR.02a Notes: N/A

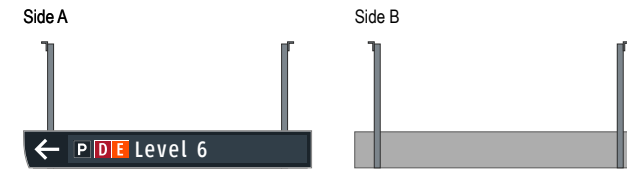


S2 CG.L6-002 5-DR.58 Notes: N/A

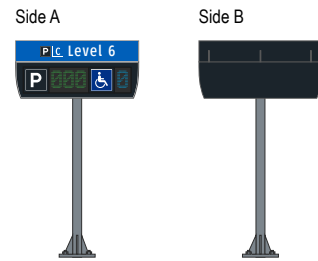


S2 CG.L6-006 5-DR.02a Notes: N/A

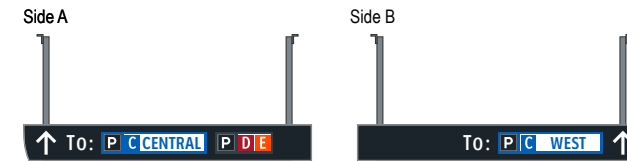


S2 CG.L6-003 5-DR.02a Notes: N/A

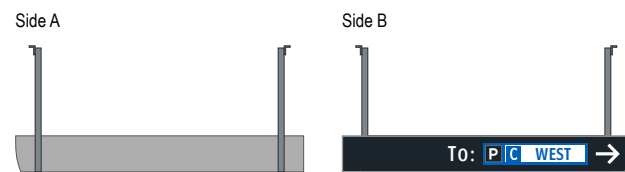


S2 CG.L6-007 5-DR.02a Notes: N/A

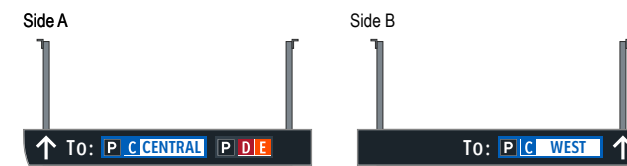

S2 CG.L6-004 5-DR.58 Notes: N/A

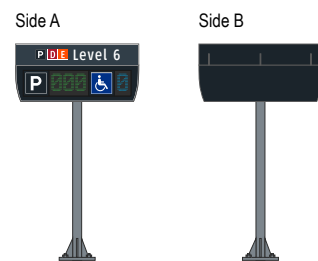

S2 CG.L6-008 5-DR.03b Notes: N/A

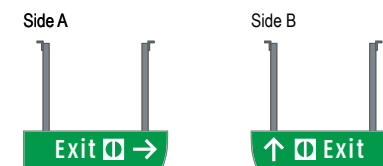

**Wayfinding Updates**

Issue Date: 08-23-2024  
Issue for Bid

- REV. 
- REV. 
- REV. 

**WARNING:**

This record contains Sensitive Security Information that is controlled under 49 CFR parts 15 and 1520. No part of this record may be disclosed to persons with a "need to know," as defined in 49 CFR parts 15 and 1520, except with the written permission of the Administrator of the Transportation Security Administration or the Secretary of Transportation. Unauthorized release may result in civil penalty or other action. For U.S. government agencies, public disclosure is governed by 5 U.S.C. 552 and 49 CFR parts 15 and 1520.



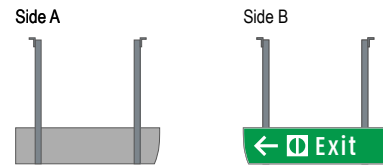
08-23-2024

**9.4 MESSAGE SCHEDULE - GARAGE C: LEVEL 6 - SECTOR 2 (C CENTRAL)**


THESE SHEETS ARE ISSUED FOR GRAPHICAL INFORMATION ONLY

BSG PRJCT# BSG-2024-111-IAH  
 HAS TIP # 24 -103 - IAH


S2 CG.L6-009 5-DR.03b Notes: N/A




S2 CG.L6-013 5-DR.03b Notes: N/A

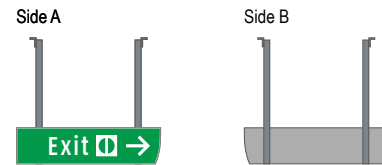


S2 CG.L6-010 5-DR.03b Notes: N/A

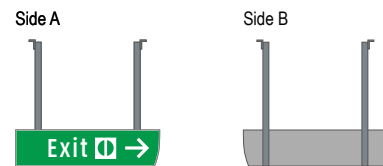


S2 CG.L6-014 5-DR.03b Notes: N/A

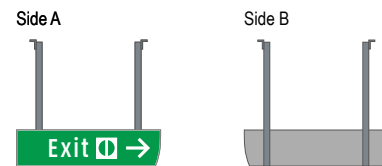


S2 CG.L6-011 5-DR.03b Notes: N/A

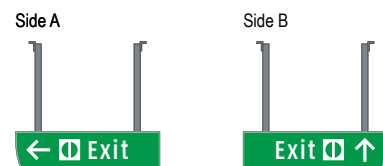

S2 CG.L6-015 5-DR.03b Notes: N/A

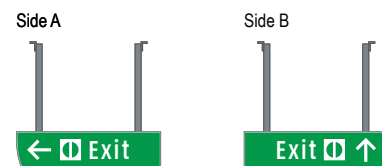

S2 CG.L6-012 5-DR.03b Notes: N/A

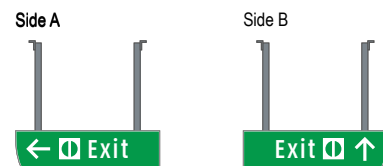

S2 CG.L6-016 N/A Notes: N/A

NOT USED

**Wayfinding Updates**

Issue Date: 08-23-2024

**Issue for Bid**

- REV. 
- REV. 
- REV. 

**WARNING:**

This record contains Sensitive Security Information that is controlled under 49 CFR parts 15 and 1520. No part of this record may be disclosed to persons with a "need to know," as defined in 49 CFR parts 15 and 1520, except with the written permission of the Administrator of the Transportation Security Administration or the Secretary of Transportation. Unauthorized release may result in civil penalty or other action. For U.S. government agencies, public disclosure is governed by 5 U.S.C. 552 and 49 CFR parts 15 and 1520.



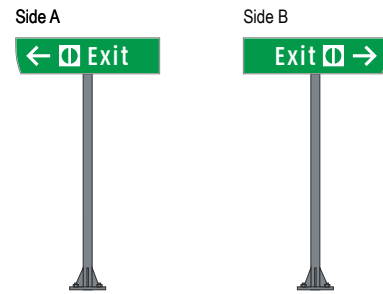
08-23-2024

**9.4 MESSAGE SCHEDULE - GARAGE C: LEVEL 6 - SECTOR 2 (C CENTRAL)**


THESE SHEETS ARE ISSUED FOR GRAPHICAL INFORMATION ONLY

BSG PRJCT# BSG-2024-111-IAH  
 HAS TIP # 24 -103 - IAH

S2 CG.L6-017 5-DR.53b Notes: N/A




S2 CG.L6-021 5-DR.03b Notes: N/A

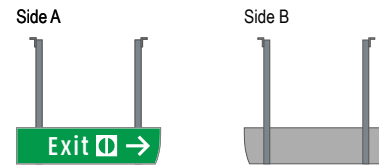


S2 CG.L6-018 N/A Notes: N/A

NOT USED

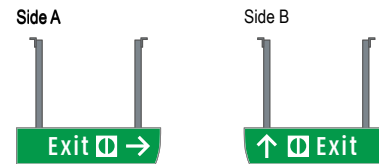
S2 CG.L6-022 5-DR.03b Notes: N/A




S2 CG.L6-019 5-DR.53b Notes: N/A

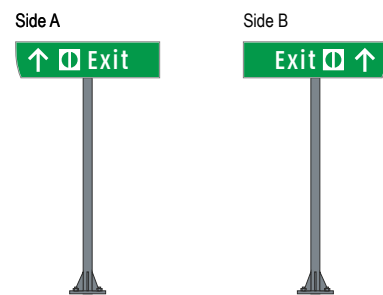


S2 CG.L6-023 5-DR.03b Notes: N/A

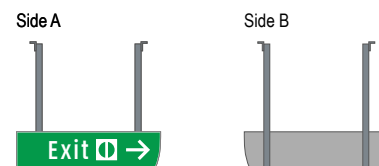


S2 CG.L6-020 5-DR.03b Notes: N/A

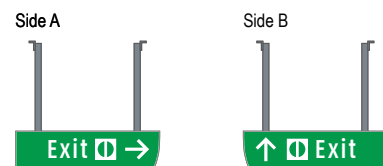


S2 CG.L6-024 5-DR.03b Notes: N/A

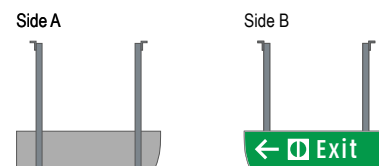


S2 CG.L6-025 5-DR.03b Notes: N/A

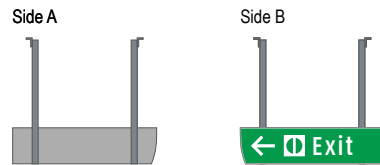


S2 CG.L6-029 5-DR.09 Notes: N/A

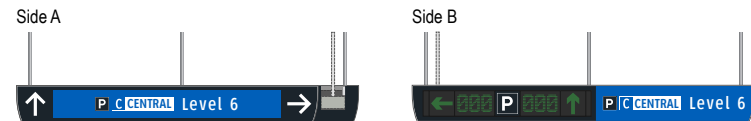


S2 CG.L6-026 5-DR.03b Notes: N/A

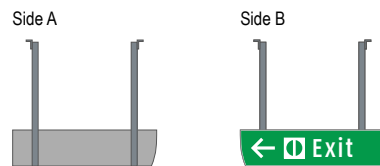


S2 CG.L6-030 5-DR.09 Notes: N/A

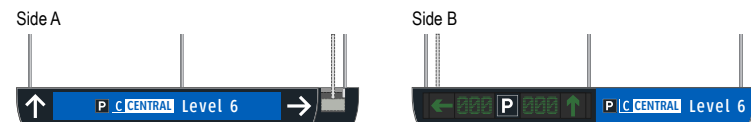


S2 CG.L6-027 5-DR.03b Notes: N/A

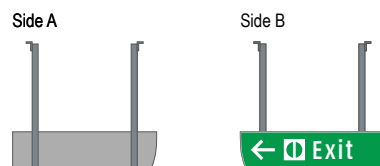


S2 CG.L6-031 5-DR.09 Notes: N/A

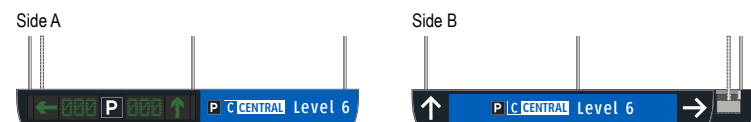

S2 CG.L6-028 5-DR.09 Notes: N/A

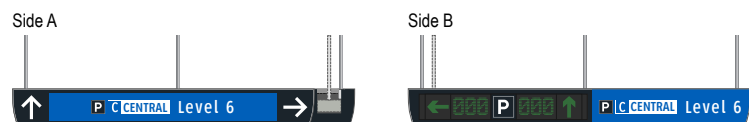

S2 CG.L6-032 5-DR.09a Notes: N/A

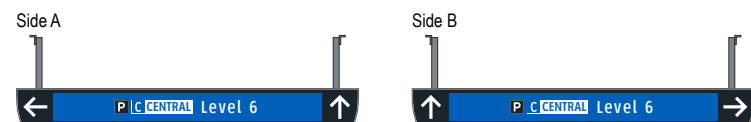

**Wayfinding Updates**

Issue Date: 08-23-2024

**Issue for Bid**

- REV. 
- REV. 
- REV. 

**WARNING:**

This record contains Sensitive Security Information that is controlled under 49 CFR parts 15 and 1520. No part of this record may be disclosed to persons with a "need to know," as defined in 49 CFR parts 15 and 1520, except with the written permission of the Administrator of the Transportation Security Administration or the Secretary of Transportation. Unauthorized release may result in civil penalty or other action. For U.S. government agencies, public disclosure is governed by 5 U.S.C. 552 and 49 CFR parts 15 and 1520.



08-23-2024

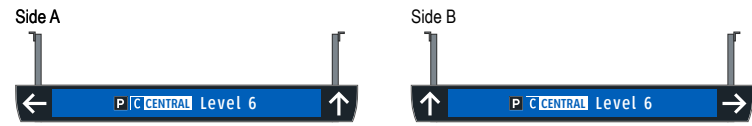
**9.4 MESSAGE SCHEDULE - GARAGE C: LEVEL 6 - SECTOR 2 (C CENTRAL)**

THESE SHEETS ARE ISSUED FOR GRAPHICAL INFORMATION ONLY


BSG PRJCT# BSG-2024-111-IAH  
 HAS TIP # 24 -103 - IAH




S2 CG.L6-033 5-DR.09a Notes: N/A




S2 CG.L6-037 5-DR.09 Notes: N/A

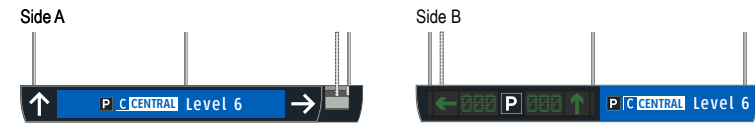


S2 CG.L6-034 5-DR.09 Notes: N/A

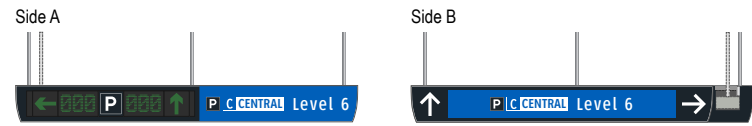

S2 CG.L6-038 5-DR.09a Notes: N/A

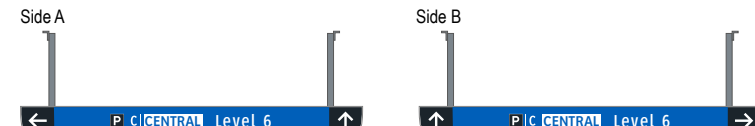


S2 CG.L6-035 5-DR.58 Notes: N/A

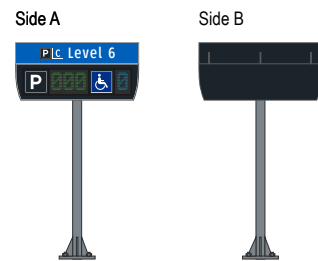

S2 CG.L6-039 N/A Notes: N/A

NOT USED

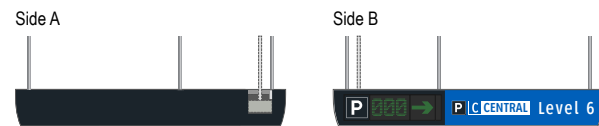S2 CG.L6-036 5-DR.09b



S2 CG.L6-040 N/A Notes: N/A

NOT USED

**Wayfinding Updates**

Issue Date: 08-23-2024

Issue for Bid

- REV. 
- REV. 
- REV. 

**WARNING:**

This record contains Sensitive Security Information that is controlled under 49 CFR parts 15 and 1520. No part of this record may be disclosed to persons with a "need to know," as defined in 49 CFR parts 15 and 1520, except with the written permission of the Administrator of the Transportation Security Administration or the Secretary of Transportation. Unauthorized release may result in civil penalty or other action. For U.S. government agencies, public disclosure is governed by 5 U.S.C. 552 and 49 CFR parts 15 and 1520.



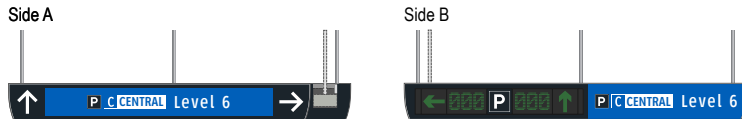
08-23-2024

**9.4 MESSAGE SCHEDULE - GARAGE C: LEVEL 6 - SECTOR 2 (C CENTRAL)**

THESE SHEETS ARE ISSUED FOR GRAPHICAL INFORMATION ONLY

BSG PRJCT# BSG-2024-111-IAH  
 HAS TIP # 24 -103 - IAH

S2 CG.L6-041 5-DR.09 Notes: N/A




S2 CG.L6-045 N/A Notes: N/A

NOT USED

S2 CG.L6-042 N/A Notes: N/A

NOT USED

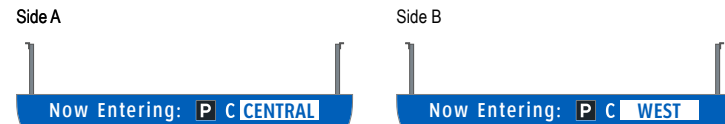
S2 CG.L6-046 5-ID.01 Notes: N/A



S2 CG.L6-043 N/A Notes: N/A

NOT USED

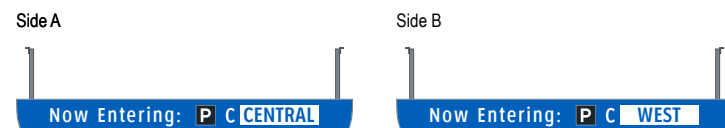S2 CG.L6-047 5-ID.01 Notes: N/A




S2 CG.L6-044 N/A Notes: N/A

NOT USED


S2 CG.L6-048 N/A Notes: N/A

NOT USED

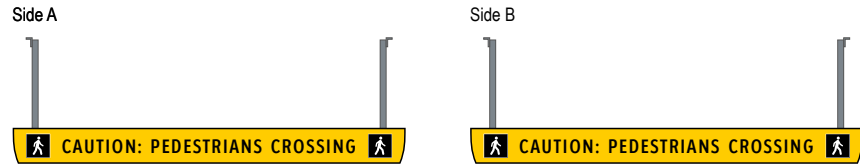
S2 CG.L6-049 5-ID.07 Notes: N/A




S2 CG.L6-053 5-DR.31 Notes: N/A

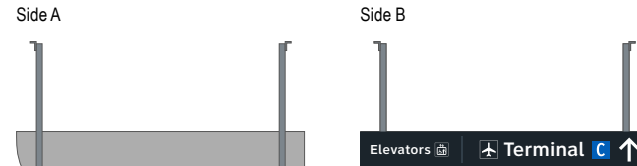


S2 CG.L6-050 5-DR.31 Notes: N/A

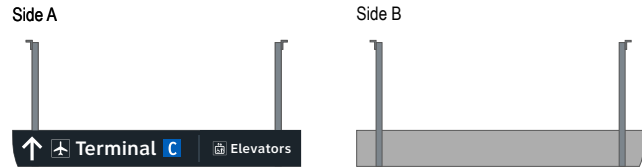


S2 CG.L6-054 5-DR.31 Notes: N/A

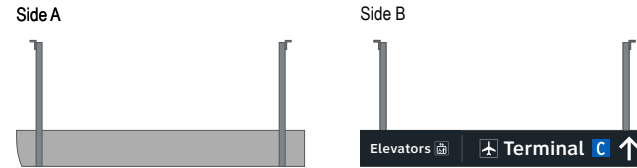


S2 CG.L6-051 5-DR.31 Notes: Notes: N/A

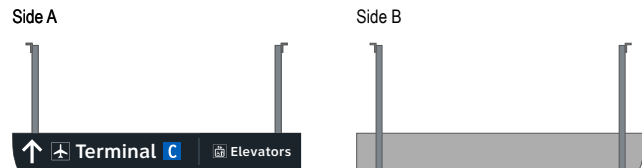


S2 CG.L6-055 5-DR.31 Notes: N/A

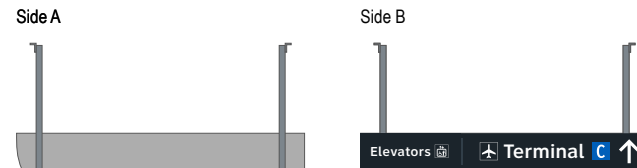

S2 CG.L6-052 5-DR.31 Notes: N/A

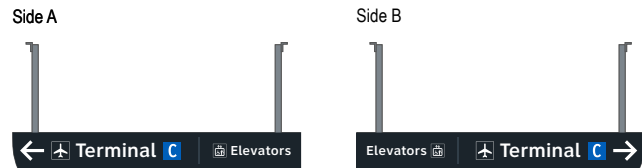

S2 CG.L6-056 5-DR.31 Notes: N/A

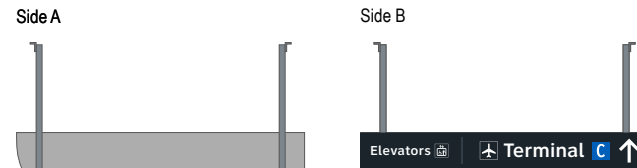

Wayfinding Updates

Issue Date: 08-23-2024

Issue for Bid

- REV.
- REV.
- REV.

WARNING:

This record contains Sensitive Security Information that is controlled under 49 CFR parts 15 and 1520. No part of this record may be disclosed to persons with a "need to know," as defined in 49 CFR parts 15 and 1520, except with the written permission of the Administrator of the Transportation Security Administration or the Secretary of Transportation. Unauthorized release may result in civil penalty or other action. For U.S. government agencies, public disclosure is governed by 5 U.S.C. 552 and 49 CFR parts 15 and 1520.



08-23-2024

THESE SHEETS ARE ISSUED FOR GRAPHICAL INFORMATION ONLY

9.4 MESSAGE SCHEDULE - GARAGE C: LEVEL 6 - SECTOR 2 (C CENTRAL)

BSG PRJCT# BSG-2024-111-IAH  
 HAS TIP # 24 -103 - IAH

S2 CG.L6-057 N/A Notes: N/A

NOT USED

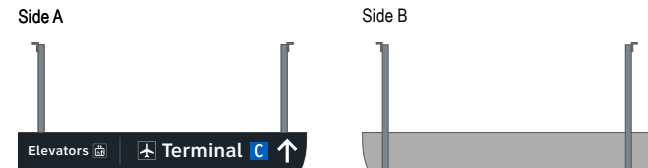
S2 CG.L6-058 N/A Notes: N/A

NOT USED


S2 CG.L6-059 N/A Notes: N/A

NOT USED


S2 CG.L6-060 5-DR.31 Notes: N/A




S2 CG.L6-061 5-DR.31 Notes: N/A

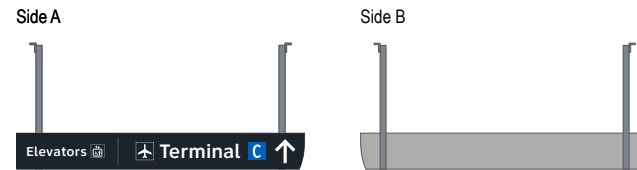


S2 CG.L6-062 5-DR.31 Notes: N/A

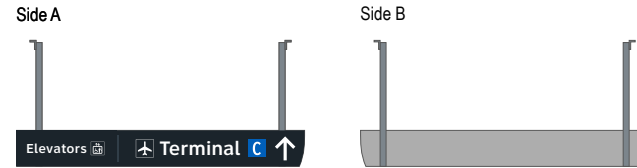

S2 CG.L6-063 5-DR.31 Notes: N/A

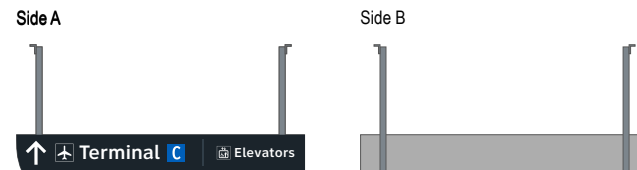

S2 CG.L6-064 5-DR.31 Notes: N/A

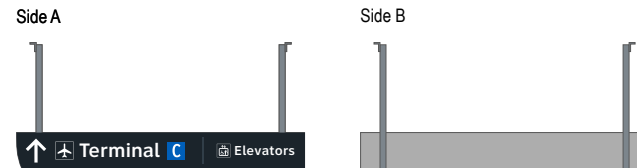

**Wayfinding Updates**

Issue Date: 08-23-2024  
Issue for Bid

- REV. 
- REV. 
- REV. 

**WARNING:**

This record contains Sensitive Security Information that is controlled under 49 CFR parts 15 and 1520. No part of this record may be disclosed to persons with a "need to know," as defined in 49 CFR parts 15 and 1520, except with the written permission of the Administrator of the Transportation Security Administration or the Secretary of Transportation. Unauthorized release may result in civil penalty or other action. For U.S. government agencies, public disclosure is governed by 5 U.S.C. 552 and 49 CFR parts 15 and 1520.

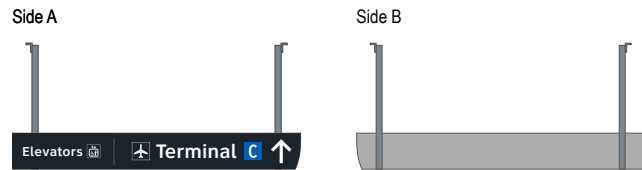


THESE SHEETS ARE ISSUED FOR GRAPHICAL INFORMATION ONLY


**9.4 MESSAGE SCHEDULE - GARAGE C: LEVEL 6 - SECTOR 2 (C CENTRAL)**

BSG PRJCT# BSG-2024-111-IAH  
HAS TIP # 24 -103 - IAH


S2 CG.L6-065 5-DR.31 Notes: N/A




S2 CG.L6-069 5-DR.31 Notes: N/A

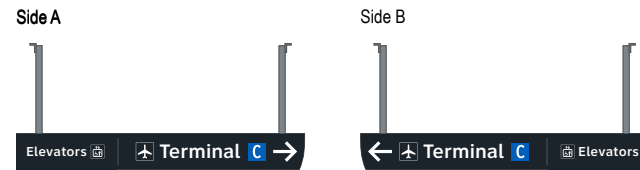


S2 CG.L6-066 5-DR.31 Notes: N/A

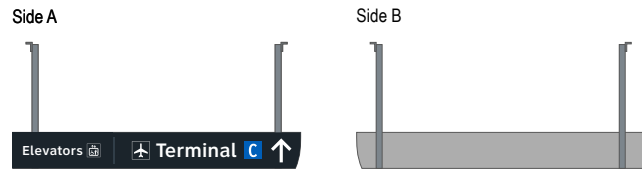

S2 CG.L6-070 5-DR.31 Notes: N/A

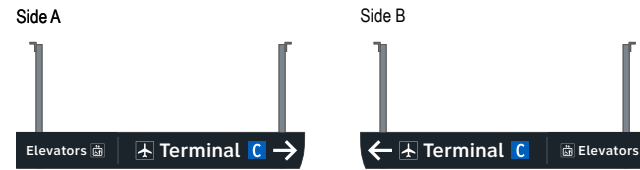


S2 CG.L6-067 5-DR.31 Notes: N/A

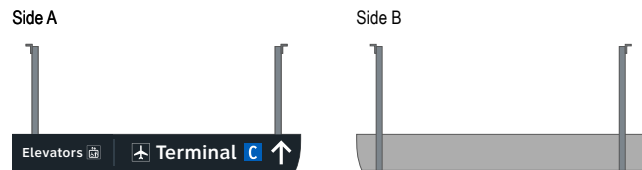


S2 CG.L6-071 N/A Notes: N/A

NOT USED

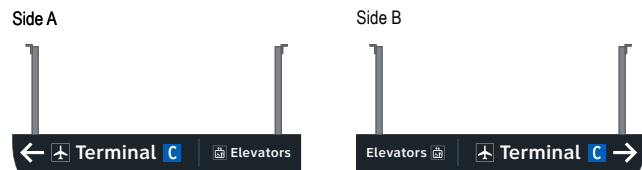S2 CG.L6-068 5-DR.31 Notes: N/A



S2 CG.L6-072 5-DR.31 Notes: N/A

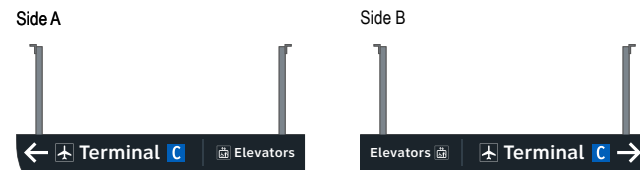

**Wayfinding Updates**

Issue Date: 08-23-2024

**Issue for Bid**

- REV. 
- REV. 
- REV. 

**WARNING:**

This record contains Sensitive Security Information that is controlled under 49 CFR parts 15 and 1520. No part of this record may be disclosed to persons with a "need to know," as defined in 49 CFR parts 15 and 1520, except with the written permission of the Administrator of the Transportation Security Administration or the Secretary of Transportation. Unauthorized release may result in civil penalty or other action. For U.S. government agencies, public disclosure is governed by 5 U.S.C. 552 and 49 CFR parts 15 and 1520.



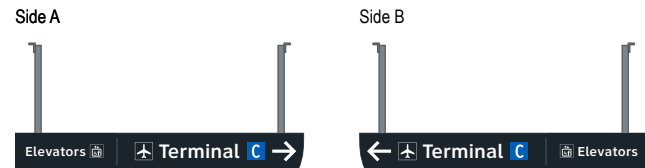
08-23-2024

**9.4 MESSAGE SCHEDULE - GARAGE C: LEVEL 6 - SECTOR 2 (C CENTRAL)**


THESE SHEETS ARE ISSUED FOR GRAPHICAL INFORMATION ONLY

BSG PRJCT# BSG-2024-111-IAH  
 HAS TIP # 24 -103 - IAH


S2 CG.L6-073 5-DR.31 Notes: N/A




S2 CG.L6-077 5-DR.31 Notes: N/A

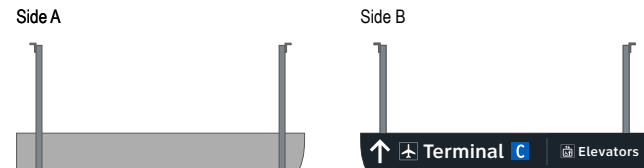


S2 CG.L6-074 5-DR.31 Notes: N/A

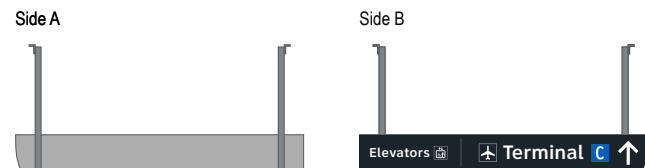


S2 CG.L6-078 5-DR.31 Notes: N/A

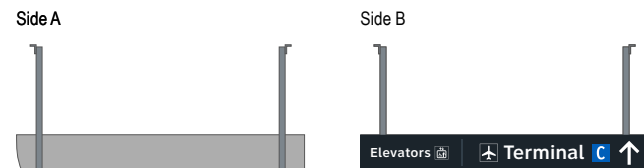

S2 CG.L6-075 5-DR.31 Notes: N/A

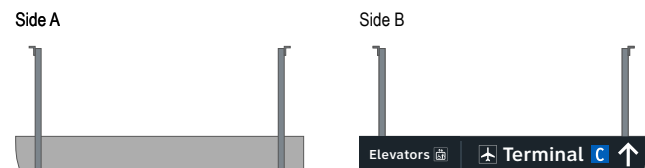


S2 CG.L6-079 5-DR.34 Notes: N/A

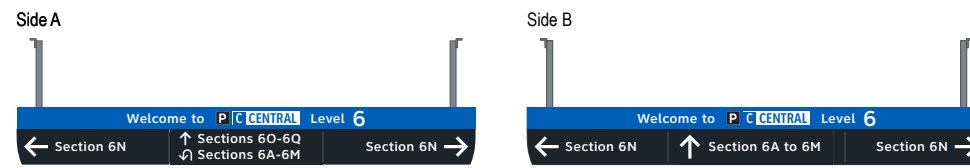

S2 CG.L6-076 N/A Notes: N/A

NOT USED

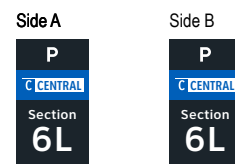S2 CG.L6-080 5-ID.51 Notes: N/A



**Wayfinding Updates**

Issue Date: 08-23-2024

**Issue for Bid**

- REV. 
- REV. 
- REV. 

**WARNING:**

This record contains Sensitive Security Information that is controlled under 49 CFR parts 15 and 1520. No part of this record may be disclosed to persons with a "need to know," as defined in 49 CFR parts 15 and 1520, except with the written permission of the Administrator of the Transportation Security Administration or the Secretary of Transportation. Unauthorized release may result in civil penalty or other action. For U.S. government agencies, public disclosure is governed by 5 U.S.C. 552 and 49 CFR parts 15 and 1520.

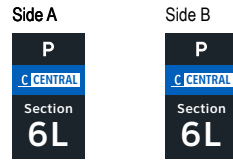


**9.4 MESSAGE SCHEDULE - GARAGE C: LEVEL 6 - SECTOR 2 (C CENTRAL)**


THESE SHEETS ARE ISSUED FOR GRAPHICAL INFORMATION ONLY

BSG PRJCT# BSG-2024-111-IAH  
 HAS TIP # 24 -103 - IAH


S2 CG.L6-081 5-ID.51 Notes: N/A




S2 CG.L6-085 5-ID.51 Notes: N/A

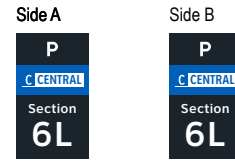


S2 CG.L6-082 5-ID.51 Notes: N/A

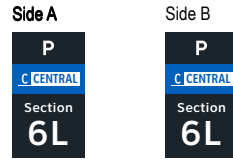


S2 CG.L6-086 5-ID.51 Notes: N/A

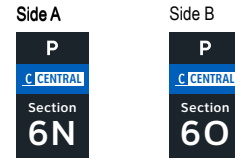


S2 CG.L6-083 5-ID.51 Notes: N/A

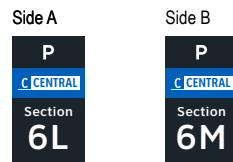


S2 CG.L6-087 5-ID.51 Notes: N/A

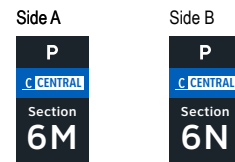


S2 CG.L6-084 5-ID.51 Notes: N/A

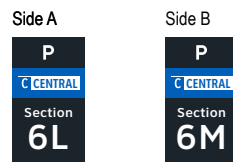


S2 CG.L6-088 5-ID.51 Notes: N/A

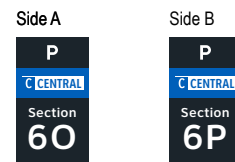


S2 CG.L6-089 5-ID.51 Notes: N/A

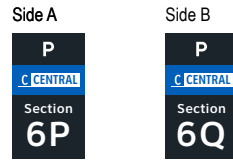


S2 CG.L6-093 5-ID.51 Notes: N/A

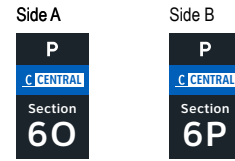


S2 CG.L6-090 5-ID.51 Notes: N/A

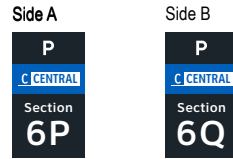


S2 CG.L6-094 5-ID.51 Notes: N/A

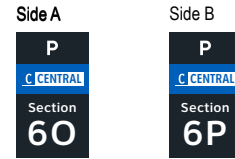


S2 CG.L6-091 5-ID.51 Notes: N/A

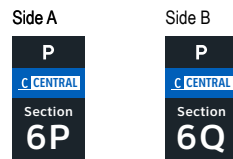


S2 CG.L6-095 5-ID.51 Notes: N/A

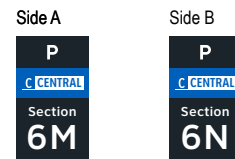

S2 CG.L6-092 5-ID.51 Notes: N/A

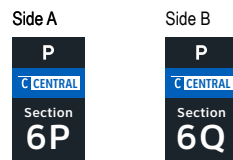

S2 CG.L6-096 5-ID.51 Notes: N/A

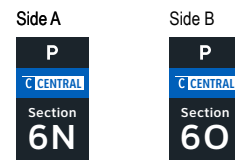



S2 CG.L6-097 5-ID.51 Notes: N/A

Side A	Side B
<b>P</b>	<b>P</b>
<b>C CENTRAL</b>	<b>C CENTRAL</b>
Section	Section
<b>6L</b>	<b>6M</b>

S2 CG.L6-101 5-ID.51 Notes: N/A

Side A	Side B
<b>P</b>	<b>P</b>
<b>C CENTRAL</b>	<b>C CENTRAL</b>
Section	Section
<b>6M</b>	<b>6N</b>

S2 CG.L6-098 5-ID.51 Notes: N/A

Side A	Side B
<b>P</b>	<b>P</b>
<b>C CENTRAL</b>	<b>C CENTRAL</b>
Section	Section
<b>6L</b>	<b>6M</b>

S2 CG.L6-102 5-ID.51 Notes: N/A

Side A	Side B
<b>P</b>	<b>P</b>
<b>C CENTRAL</b>	<b>C CENTRAL</b>
Section	Section
<b>6N</b>	<b>6O</b>

S2 CG.L6-099 5-ID.51 Notes: N/A

Side A	Side B
<b>P</b>	<b>P</b>
<b>C CENTRAL</b>	<b>C CENTRAL</b>
Section	Section
<b>6M</b>	<b>6N</b>

S2 CG.L6-103 5-ID.51 Notes: N/A

Side A	Side B
<b>P</b>	<b>P</b>
<b>C CENTRAL</b>	<b>C CENTRAL</b>
Section	Section
<b>6O</b>	<b>6P</b>

S2 CG.L6-100 5-ID.51 Notes: N/A

Side A	Side B
<b>P</b>	<b>P</b>
<b>C CENTRAL</b>	<b>C CENTRAL</b>
Section	Section
<b>6N</b>	<b>6O</b>

S2 CG.L6-104 5-ID.52 Notes: N/A

Side A	Side B
<b>P</b>	<b>P</b>
<b>C CENTRAL</b>	<b>C CENTRAL</b>
Section	Section
<b>6L</b>	<b>6L</b>

S2 CG.L6-105 5-ID.52 Notes: N/A

Side A	Side B
<b>P</b>	<b>P</b>
<b>C CENTRAL</b>	<b>C CENTRAL</b>
Section	Section
<b>6L</b>	<b>6M</b>

S2 CG.L6-109 5-ID.52 Notes: N/A

Side A	Side B
<b>P</b>	<b>P</b>
<b>C CENTRAL</b>	<b>C CENTRAL</b>
Section	Section
<b>6L</b>	<b>6M</b>

S2 CG.L6-106 5-ID.52 Notes: N/A

Side A	Side B
<b>P</b>	<b>P</b>
<b>C CENTRAL</b>	<b>C CENTRAL</b>
Section	Section
<b>6L</b>	<b>6L</b>

S2 CG.L6-110 5-ID.52 Notes: N/A

Side A	Side B
<b>P</b>	<b>P</b>
<b>C CENTRAL</b>	<b>C CENTRAL</b>
Section	Section
<b>6L</b>	<b>6L</b>

S2 CG.L6-107 5-ID.52 Notes: N/A

Side A	Side B
<b>P</b>	<b>P</b>
<b>C CENTRAL</b>	<b>C CENTRAL</b>
Section	Section
<b>6L</b>	<b>6M</b>

S2 CG.L6-111 5-ID.52 Notes: N/A

Side A	Side B
<b>P</b>	<b>P</b>
<b>C CENTRAL</b>	<b>C CENTRAL</b>
Section	Section
<b>6L</b>	<b>6L</b>


S2 CG.L6-108 5-ID.52 Notes: N/A

Side A	Side B
<b>P</b>	<b>P</b>
<b>C CENTRAL</b>	<b>C CENTRAL</b>
Section	Section
<b>6L</b>	<b>6L</b>


S2 CG.L6-112 5-ID.52 Notes: N/A

Side A	Side B
<b>P</b>	<b>P</b>
<b>C CENTRAL</b>	<b>C CENTRAL</b>
Section	Section
<b>6L</b>	<b>6M</b>

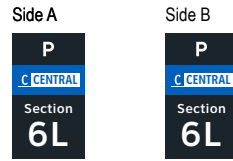
S2 CG.L6-113 5-ID.52 Notes: N/A




S2 CG.L6-117 5-ID.52 Notes: N/A

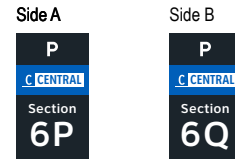


S2 CG.L6-114 5-ID.52 Notes: N/A

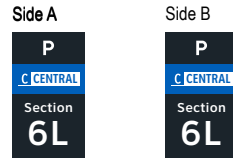


S2 CG.L6-118 5-ID.43 Notes: N/A

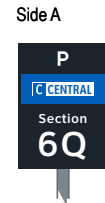


S2 CG.L6-115 5-ID.43 Notes: N/A

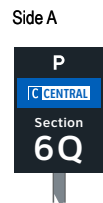


S2 CG.L6-119 5-ID.43 Notes: N/A

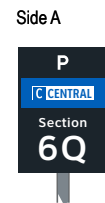

S2 CG.L6-116 5-ID.43 Notes: N/A

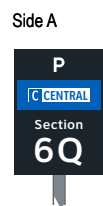

S2 CG.L6-120 5-ID.52 Notes: N/A

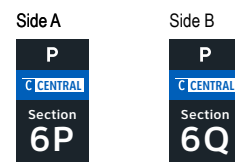

S2 CG.L6-121 5-ID.52 Notes: N/A

Side A      Side B

P

C CENTRAL

Section

**6O**

P

C CENTRAL

Section

**6P**

S2 CG.L6-125 N/A Notes: N/A

NOT USED

S2 CG.L6-122 N/A Notes: N/A

NOT USED

S2 CG.L6-126 5-ID.43 Notes: N/A

Side A

P

C CENTRAL

Section

**6Q**

S2 CG.L6-123 5-ID.43 Notes: N/A

Side A

P

C CENTRAL

Section

**6Q**

S2 CG.L6-127 5-ID.52 Notes: N/A

Side A

P

C CENTRAL

Section

**6M**

Side B

P

C CENTRAL

Section

**6N**

S2 CG.L6-124 5-ID.43 Notes: N/A

Side A

P

C CENTRAL

Section

**6Q**

S2 CG.L6-128 5-ID.52 Notes: N/A

Side A

P

C CENTRAL

Section

**6N**

Side B

P

C CENTRAL

Section

**6O**

**Wayfinding Updates**

Issue Date: 08-23-2024  
Issue for Bid

- REV. 
- REV. 
- REV. 

**WARNING:**

This record contains Sensitive Security Information that is controlled under 49 CFR parts 15 and 1520. No part of this record may be disclosed to persons with a "need to know," as defined in 49 CFR parts 15 and 1520, except with the written permission of the Administrator of the Transportation Security Administration or the Secretary of Transportation. Unauthorized release may result in civil penalty or other action. For U.S. government agencies, public disclosure is governed by 5 U.S.C. 552 and 49 CFR parts 15 and 1520.



08-23-2024

**9.4 MESSAGE SCHEDULE - GARAGE C: LEVEL 6 - SECTOR 2 (C CENTRAL)**

THESE SHEETS ARE ISSUED FOR GRAPHICAL INFORMATION ONLY

BSG PRJCT# BSG-2024-111-IAH  
HAS TIP # 24 -103 - IAH

S2 CG.L6-129 5-ID.52 Notes: N/A

Side A	Side B
<b>P</b>	<b>P</b>
<b>C CENTRAL</b>	<b>C CENTRAL</b>
Section	Section
<b>60</b>	<b>6P</b>

S2 CG.L6-133 5-ID.52 Notes: N/A

Side A	Side B
<b>P</b>	<b>P</b>
<b>C CENTRAL</b>	<b>C CENTRAL</b>
Section	Section
<b>60</b>	<b>6P</b>

S2 CG.L6-130 5-ID.52 Notes: N/A

Side A	Side B
<b>P</b>	<b>P</b>
<b>C CENTRAL</b>	<b>C CENTRAL</b>
Section	Section
<b>6P</b>	<b>6Q</b>

S2 CG.L6-134 5-ID.52 Notes: N/A

Side A	Side B
<b>P</b>	<b>P</b>
<b>C CENTRAL</b>	<b>C CENTRAL</b>
Section	Section
<b>6N</b>	<b>6O</b>

S2 CG.L6-131 5-ID.52 Notes: N/A

Side A	Side B
<b>P</b>	<b>P</b>
<b>C CENTRAL</b>	<b>C CENTRAL</b>
Section	Section
<b>6M</b>	<b>6N</b>

S2 CG.L6-135 5-ID.52 Notes: N/A

Side A	Side B
<b>P</b>	<b>P</b>
<b>C CENTRAL</b>	<b>C CENTRAL</b>
Section	Section
<b>6O</b>	<b>6P</b>

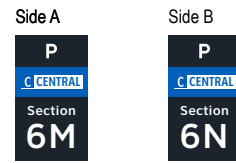
S2 CG.L6-132 5-ID.52 Notes: N/A

Side A	Side B
<b>P</b>	<b>P</b>
<b>C CENTRAL</b>	<b>C CENTRAL</b>
Section	Section
<b>6N</b>	<b>6O</b>


S2 CG.L6-136 5-ID.52 Notes: N/A

Side A	Side B
<b>P</b>	<b>P</b>
<b>C CENTRAL</b>	<b>C CENTRAL</b>
Section	Section
<b>6P</b>	<b>6Q</b>


S2 CG.L6-137 5-ID.52 Notes: N/A




S2 CG.L6-141 5-ID.52 Notes: N/A

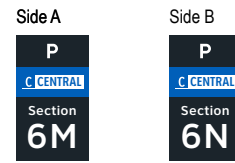


S2 CG.L6-138 5-ID.52 Notes: N/A

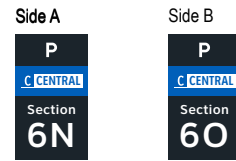


S2 CG.L6-142 5-ID.52 Notes: N/A

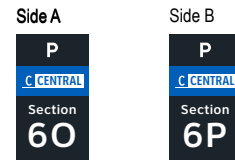


S2 CG.L6-139 5-ID.52 Notes: N/A

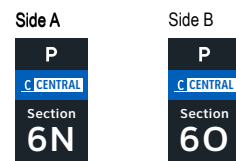


S2 CG.L6-143 5-ID.52 Notes: N/A

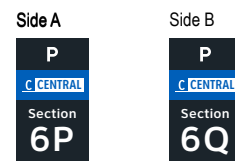


S2 CG.L6-140 5-ID.52 Notes: N/A

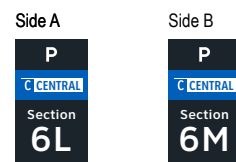


S2 CG.L6-144 5-ID.52 Notes: N/A

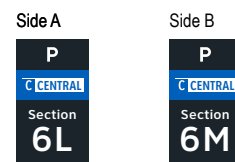


S2 CG.L6-145 5-ID.52 Notes: N/A

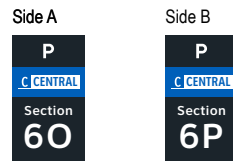


S2 CG.L6-149 5-ID.55 Notes: N/A

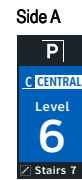

S2 CG.L6-146 5-ID.52 Notes: N/A

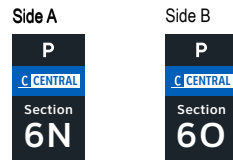


S2 CG.L6-150 5-ID.55 Notes: N/A

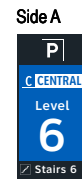

S2 CG.L6-147 5-ID.55 Notes: N/A



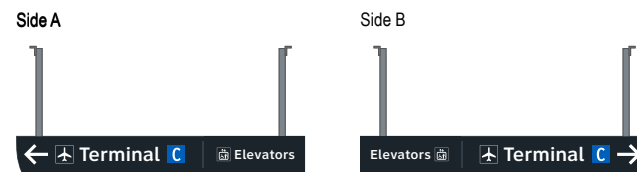S2 CG.L6-151 5-DR.31 Notes: N/A



S2 CG.L6-148 5-ID.55 Notes: N/A



S2 CG.L6-152 N/A Notes: N/A

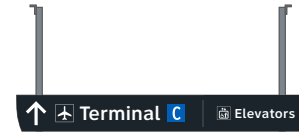
NOT USED

S2 CG.L6-153 5-DR.31 Notes: N/A

Side A



Side B



S2 CG.L6-154 N/A Notes: N/A

NOT USED

S2 CG.L6-155 N/A Notes: N/A

NOT USED

S2 CG.L6-156 N/A Notes: N/A

NOT USED

ELEVATOR CORE SIGNAGE CONTINUED ON NEXT SHEET



GEORGE BUSH INTERCONTINENTAL AIRPORT  
Wayfinding Signage Design Intent Documents  
C Garage



Louisville, Colorado  
P: 303.494.7849  
www.labozan.com

These documents are intended to illustrate design intent, and should only be used as a general guideline. No information contained here should be construed as engineered elements. The fabricator/contractor shall be responsible for all engineering and specifications with regard to structural, electrical, mechanical, foundation and installation. Information and illustrations contained here are part of an original unpublished design by Labozan Associates, Inc. Detailing and information contained on these pages shall not be reproduced, copied or utilized in any way except for the specific project for which they were created without previous written authorization from Labozan Associates, Inc.  
© 2024 by Labozan Associates, Inc.

Wayfinding Updates

Issue Date: 08-23-2024  
Issue for Bid

- REV.
- REV.
- REV.

WARNING:

This record contains Sensitive Security Information that is controlled under 49 CFR parts 15 and 1520. No part of this record may be disclosed to persons with a "need to know," as defined in 49 CFR parts 15 and 1520, except with the written permission of the Administrator of the Transportation Security Administration or the Secretary of Transportation. Unauthorized release may result in civil penalty or other action. For U.S. government agencies, public disclosure is governed by 5 U.S.C. 552 and 49 CFR parts 15 and 1520.



08-23-2024

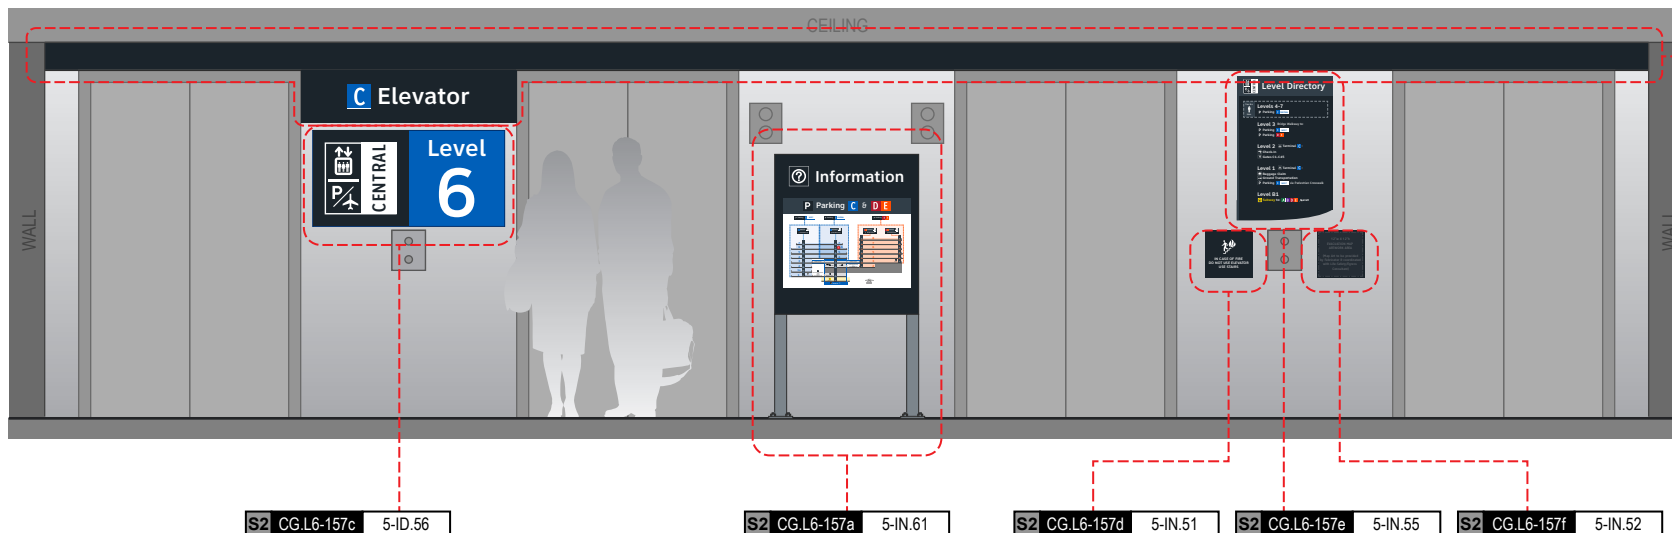
THESE SHEETS ARE ISSUED FOR GRAPHICAL INFORMATION ONLY

9.4 MESSAGE SCHEDULE - GARAGE C: LEVEL 6 - SECTOR 2 (C CENTRAL)

BSG PRJCT# BSG-2024-111-IAH  
HAS TIP # 24 -103 - IAH



Side A



S2 CG.L6-157c 5-ID.56

S2 CG.L6-157a 5-IN.61

S2 CG.L6-157d 5-IN.51

S2 CG.L6-157e 5-IN.55

S2 CG.L6-157f 5-IN.52

NOTES: Directory artwork includes a "You Are Here" button graphic and is in a unique location per elevator core/level location; artwork included here is representative of final map artwork design intent for this location

NOTES: Level directory plaque includes a "You Are Here" graphic and is in a unique location per elevator core/level location; artwork included here is representative of final artwork design intent for this location

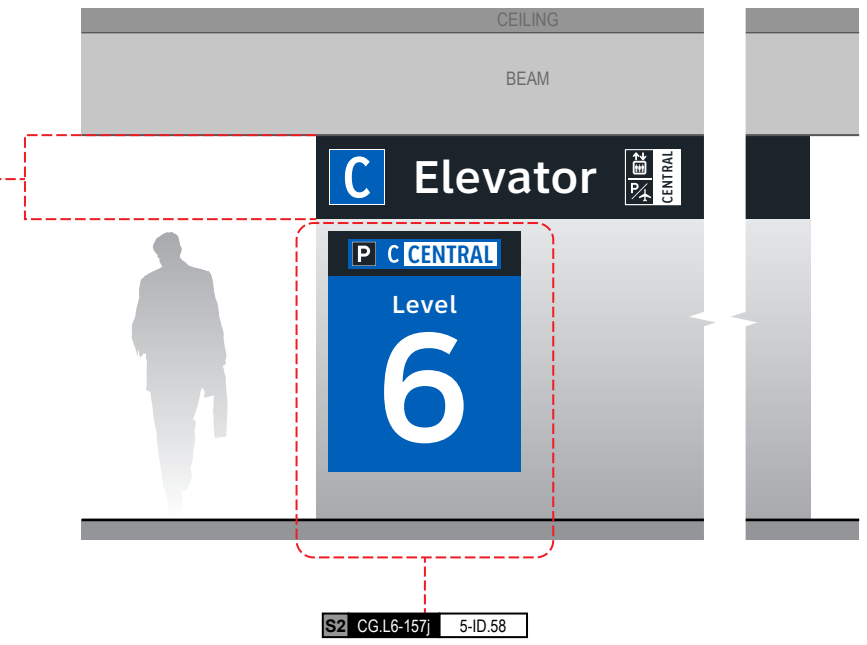
S2 CG.L6-157b 5-ID.57

NOTES: Wall paint and header graphics at front elevation only of elevator core included for this location number; wall elevation conditions shown are artistic representation based on rough site photo surveys; actual wall elevation conditions to be field verified by contractor/installer

S2 CG.L6-157g 5-ID.59


NOTES: Wall paint and header graphics on rear and two side elevations of elevator core included for this location number; wall elevation conditions shown are artistic representation based on rough site photo surveys; actual wall elevation conditions to be field verified by contractor/installer

Side C



S2 CG.L6-157j 5-ID.58

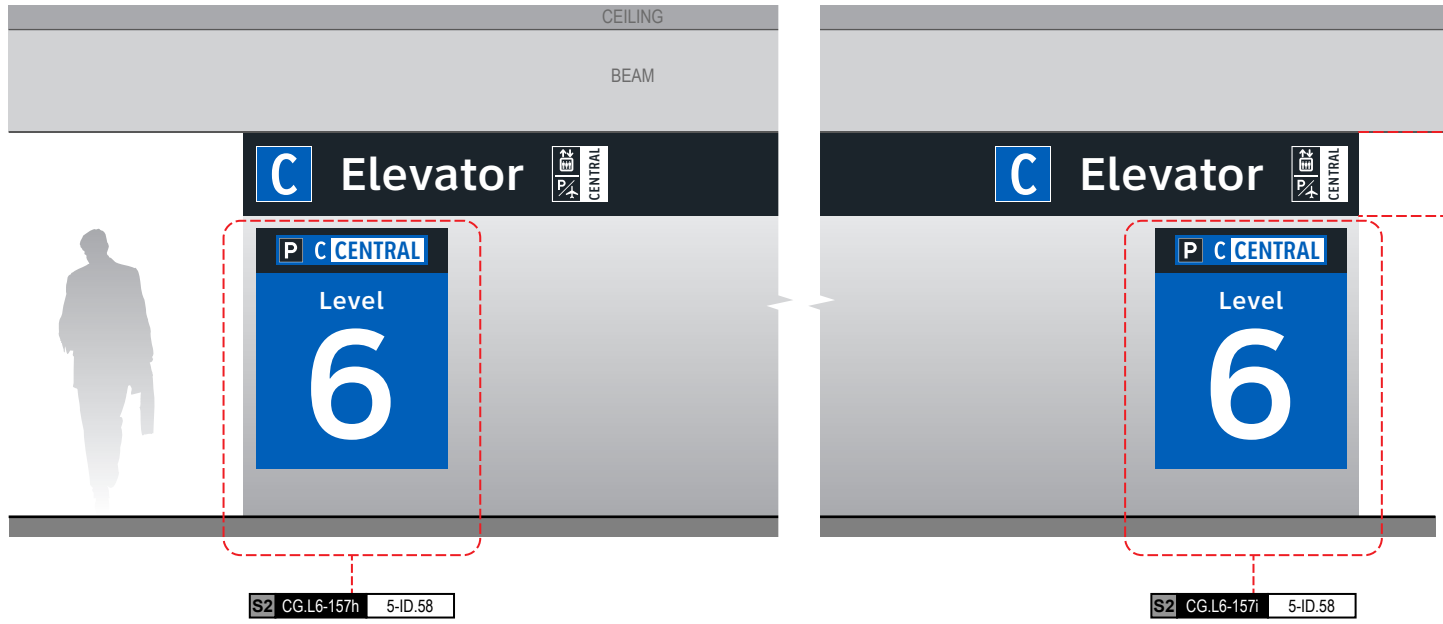
Side B



S2 CG.L6-157h 5-ID.58


S2 CG.L6-157i 5-ID.58

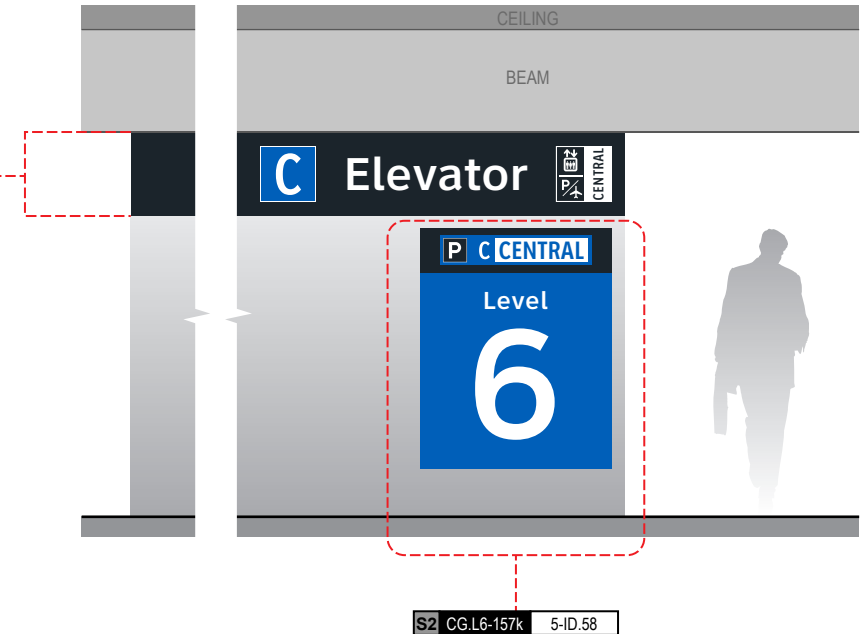Side D




S2 CG.L6-157k 5-ID.58

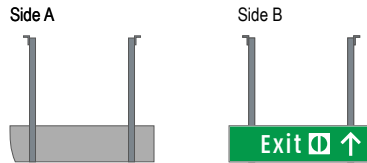
S2 CG.L6-158 5-DR.03b Notes: N/A




S2 CG.L6-162 5-DR.58 Notes: N/A

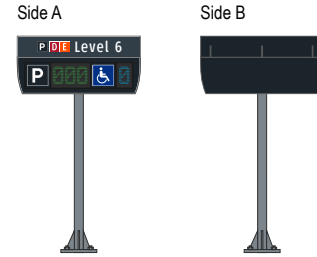


S2 CG.L6-159 5-DR.09a Notes: N/A

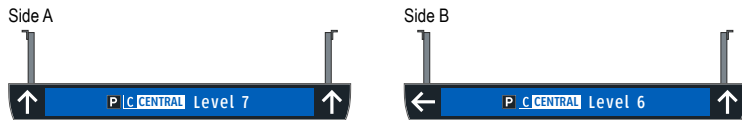


S2 CG.L6-163 5-DR.58 Notes: N/A

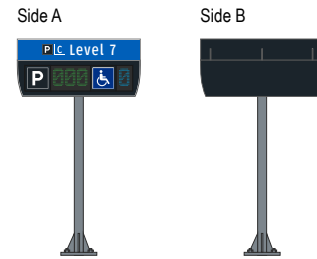

S2 CG.L6-160 5-DR.09b Notes: N/A

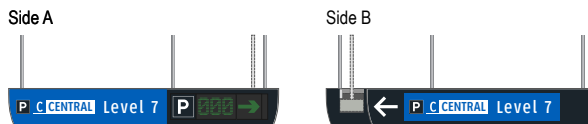

S2 CG.L6-161 5-DR.09a Notes: N/A

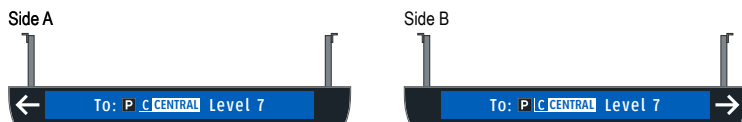


## END OF GARAGE C: LEVEL 6 - SECTOR 2 MESSAGES

**GENERAL NOTES**

- Sign locations & orientations shown here are approximations based on the most current plan drawings as provided to the designer by the architect at the time of this document's completion. These sign locations are for general design intent & wayfinding planning purposes only. They should not be construed or deemed as absolute or final locations. Field verification, marking & documentation of each final location is to be performed by the Fabricator/Installer & coordinated with project staff & Wayfinding Design Consultants for final approval.
- All final install locations must be marked and verified in the field for proper structural integrity, adequate line of sight, utilities / property-line / other existing signage interferences & must be in complete compliance with all local, state and national codes prior to fabrication or installation.
- Adjustments to the sign locations shown in these drawings must be documented by the Fabricator/Installer, and provided to project staff & Wayfinding Design Consultants for final approval.

**NOTE:** Only priority wayfinding signage & locations as shown in this wayfinding plan package are in scope. All other signage not shown (including traffic control) are **NOT IN SCOPE** for this project/contract.

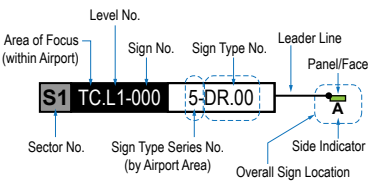**SIGN LOCATION ANNOTATION LEGEND**



**LOCATION CODE DEFINITIONS:**

- AREA OF FOCUS:** (location within Airport)  
 TA = Terminal A  
 TB = Terminal B  
 TC = Terminal C  
 TD = Terminal D  
 TE = Terminal E  
 AB = AB Garage  
 CG = C Garage  
 DE = DE Garage
- SIGN TYPE SERIES NO.:** (by Airport Area)  
 1- = Terminals/Concourses  
 1t- = Terminals/Concourses: Temporary  
 2- = CBP Areas  
 3- = Curbside/Ground Trans.  
 4- = Roadways  
 5- = Parking
- WAYFINDING SIGN TYPE:**  
 DR.xx = Directional  
 ID.xx = Identification  
 IN.xx = Informational

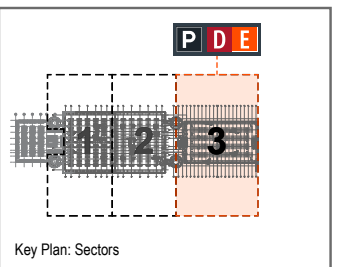
**WAYFINDING SIGN LOCATIONS - Parking:**

- PEDESTRIAN Signs:**  
 A = Directional (DR)  
 B = Identification (ID)  
 C = Informational (IN)
- VEHICULAR Signs:**  
 A = Directional (DR)  
 B = Identification (ID)  
 C = Informational (IN)


**CIRCULATION:**

- Public Use PEDESTRIAN Vertical Circulation (i.e. Elevators/Escalators/Stairs)
- Public Use VEHICULAR Vertical Circulation (i.e. Ramps)
- Alpha-Numeric Parking Section Naming Areas (Blues = C Garages; Oranges = D/E Garage)
- Areas Not In Scope for this Package

LOCATION PLAN SCALE: 1" = 60'



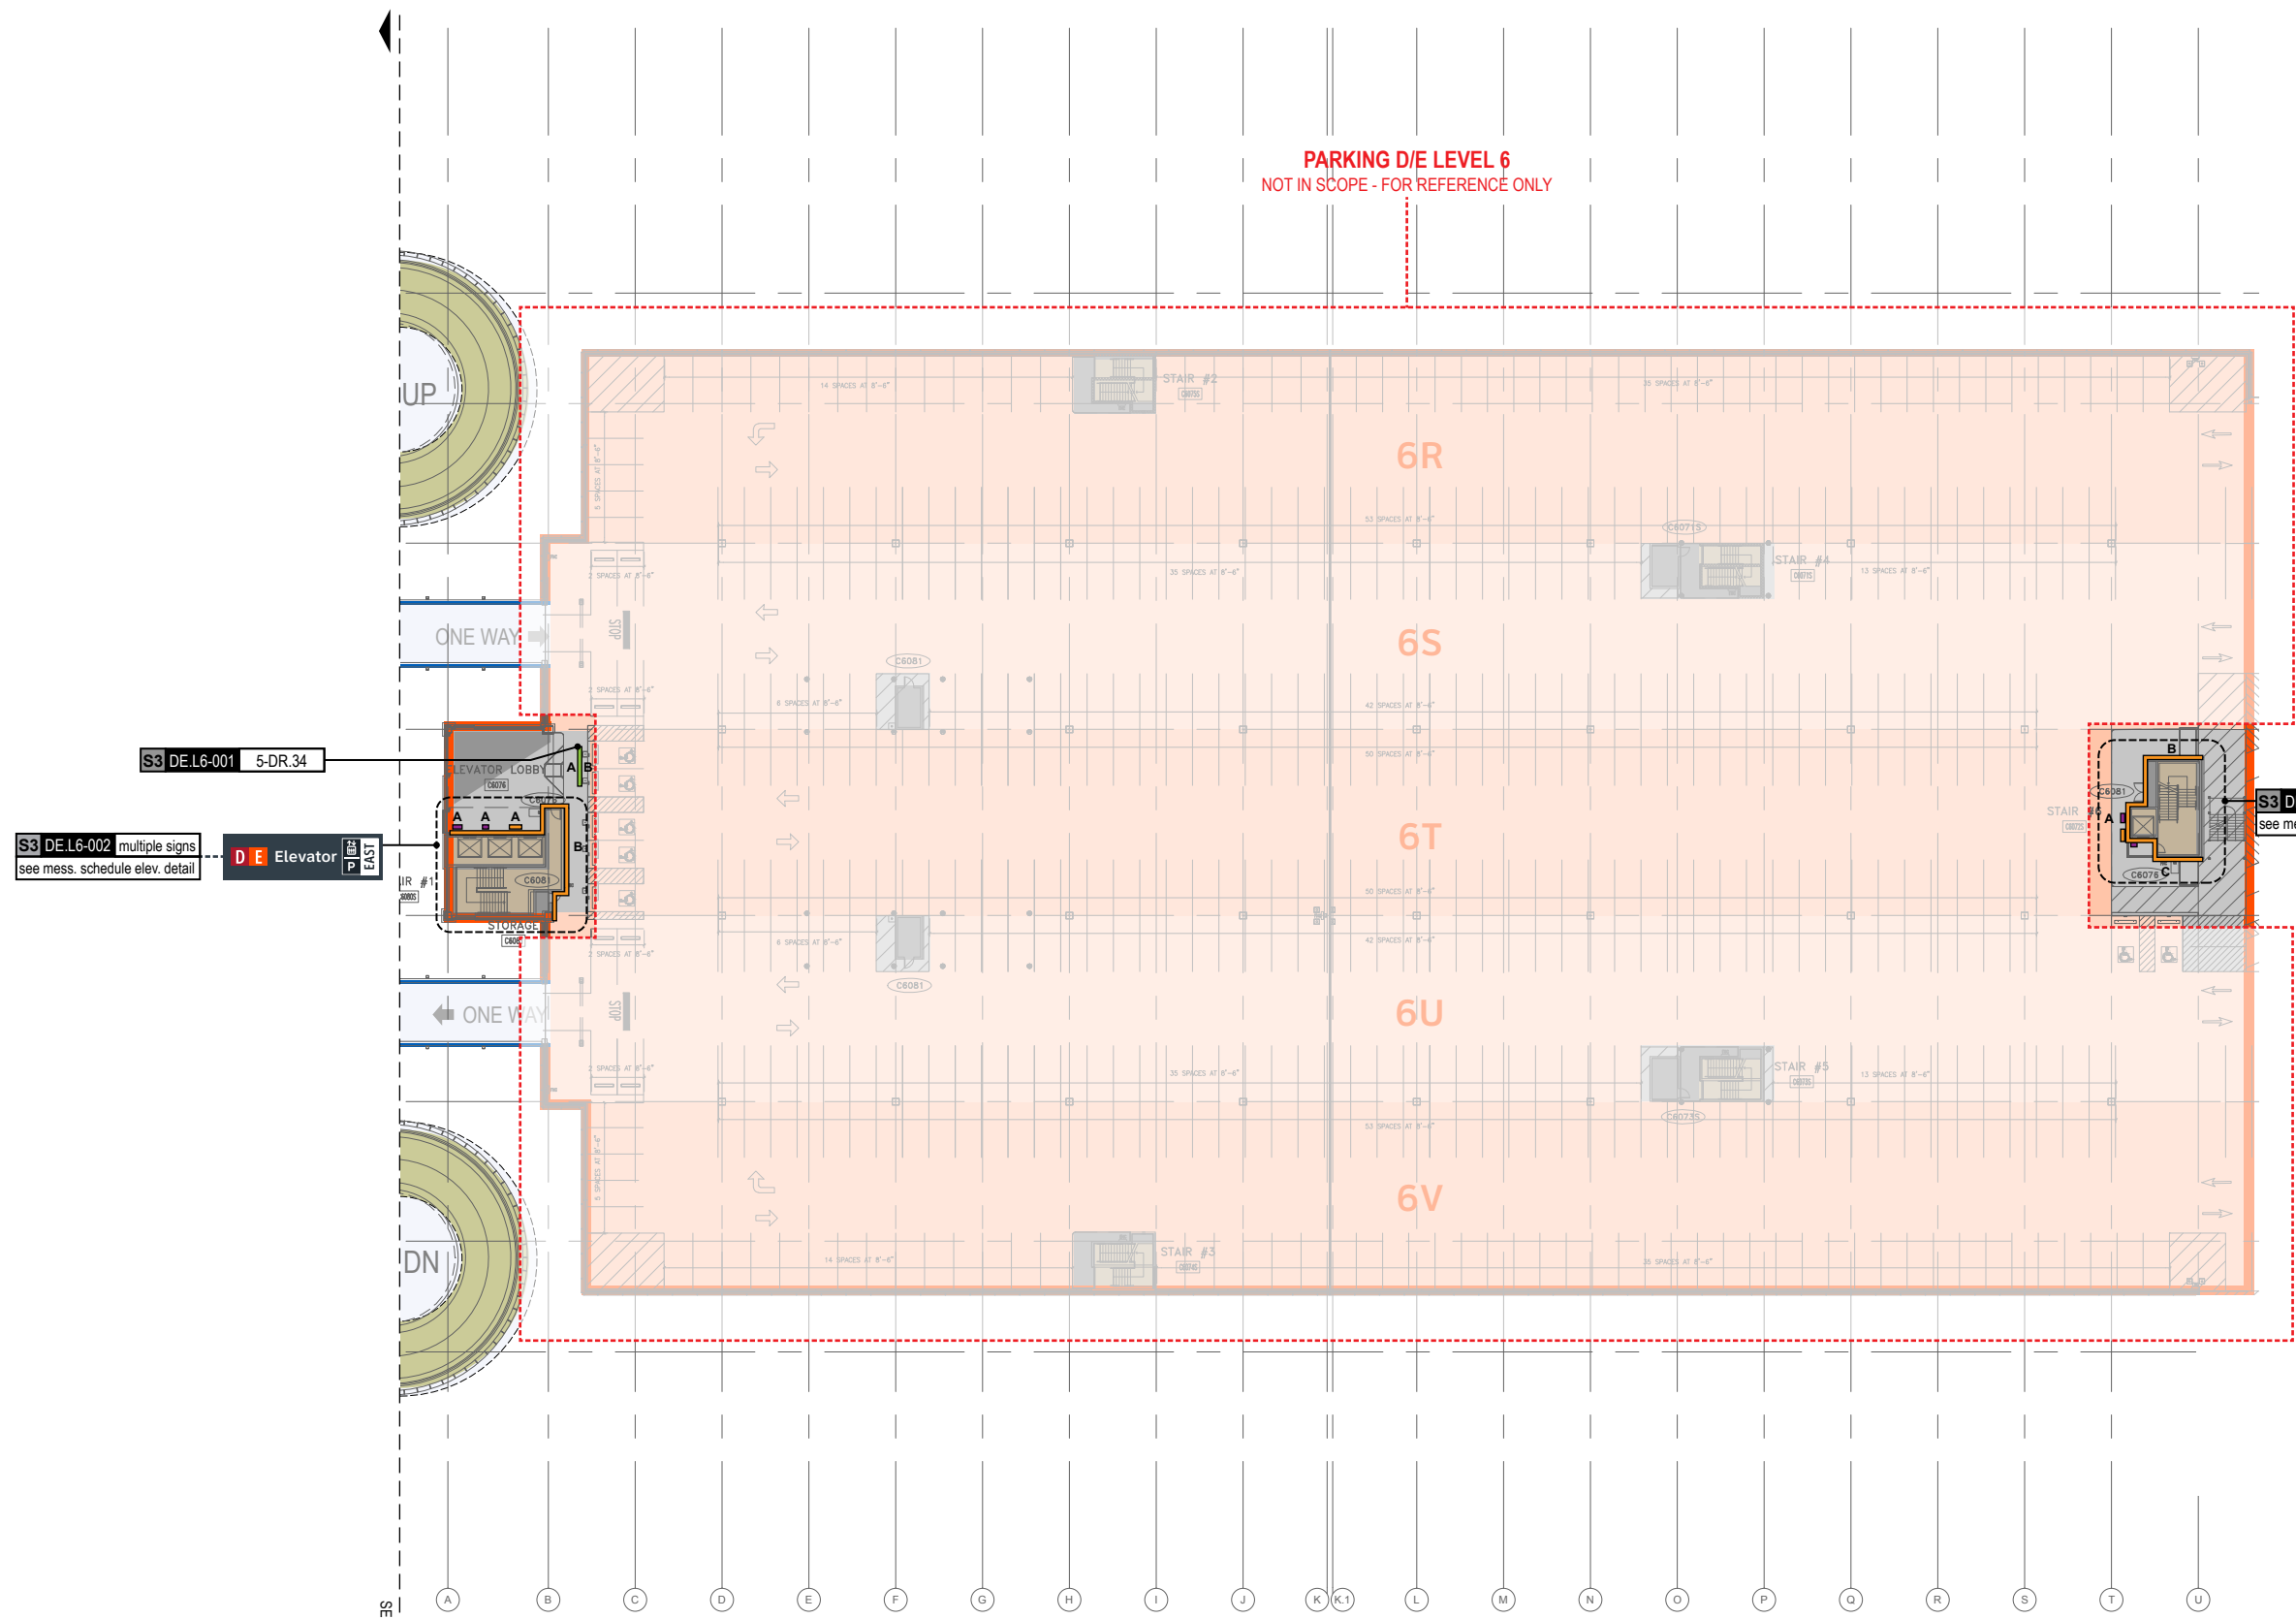**PARKING D/E LEVEL 6  
NOT IN SCOPE - FOR REFERENCE ONLY**



S3 DE.L6-001 5-DR.34

S3 DE.L6-002 multiple signs see mess. schedule elev. detail

D E Elevator EAST

S3 DE.L6-003 multiple signs see mess. schedule elev. detail

D E Elevator EAST

SEE SHEET 9-22



THESE SHEETS ARE ISSUED FOR GRAPHICAL INFORMATION ONLY

08-23-2024

**9.5 SIGN LOCATION PLAN - GARAGE D/E: LEVEL 6 - SECTOR 3 (D/E)**

BSG PRJCT# BSG-2024-111-IAH  
HAS TIP # 24 -103 - IAH

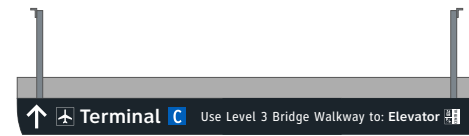
Sheet: 9-45

S3 DE.L6-001 5-DR.34 Notes: N/A

Side A




Side B



S3 DE.L6-002 multiple signs Notes: N/A

D E Elevator EAST

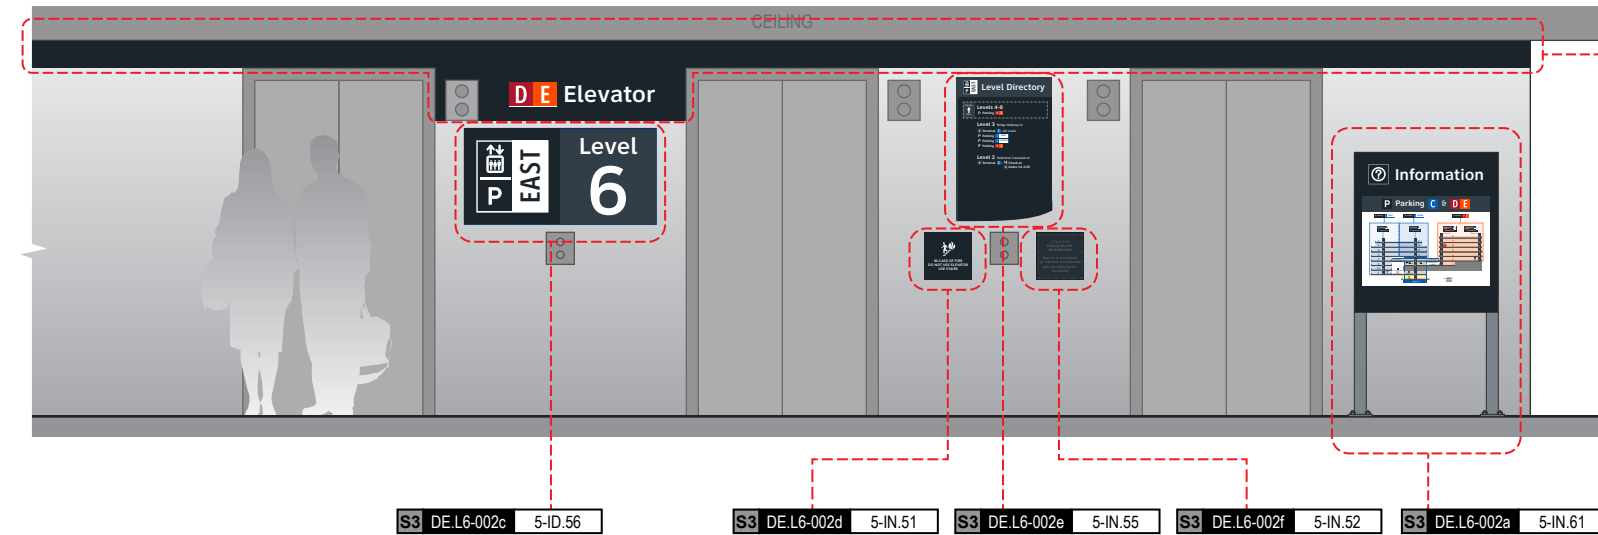Side A



S3 DE.L6-002b 5-ID.57

NOTES: Wall paint and header graphics at front elevation only of elevator core included for this location number; wall elevation conditions shown are artistic representation based on rough site photo surveys; actual wall elevation conditions to be field verified by contractor/installer

S3 DE.L6-002c 5-ID.56

S3 DE.L6-002d 5-IN.51

NOTES: Level directory plaque includes a "You Are Here" graphic and is in a unique location per elevator core/level location; artwork included here is representative of final artwork design intent for this location

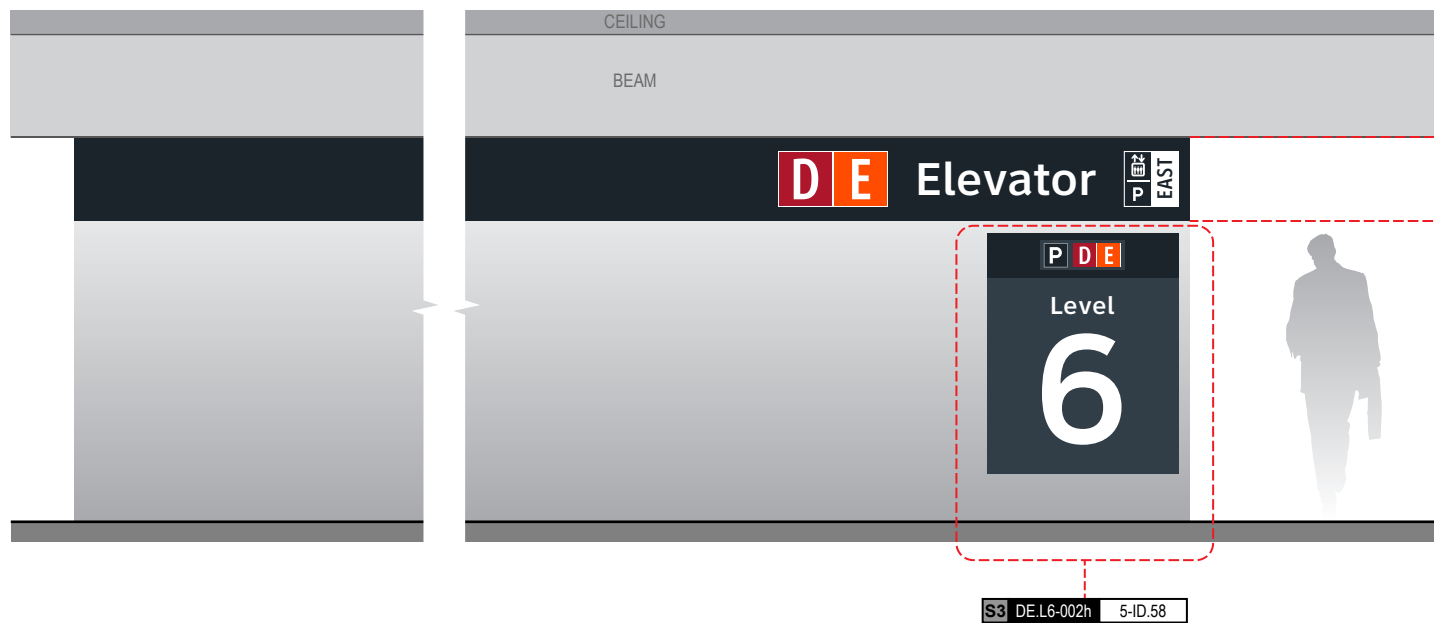
S3 DE.L6-002e 5-IN.55

S3 DE.L6-002f 5-IN.52

NOTES: Directory artwork includes a "You Are Here" button graphic and is in a unique location per elevator core/level location; artwork included here is representative of final map artwork design intent for this location

S3 DE.L6-002a 5-IN.61

Side B




S3 DE.L6-002g 5-ID.59

NOTES: Wall paint and header graphics on garage-facing elevation of elevator core included for this location number; wall elevation conditions shown are artistic representation based on rough site photo surveys; actual wall elevation conditions to be field verified by contractor/installer

S3 DE.L6-002h 5-ID.58

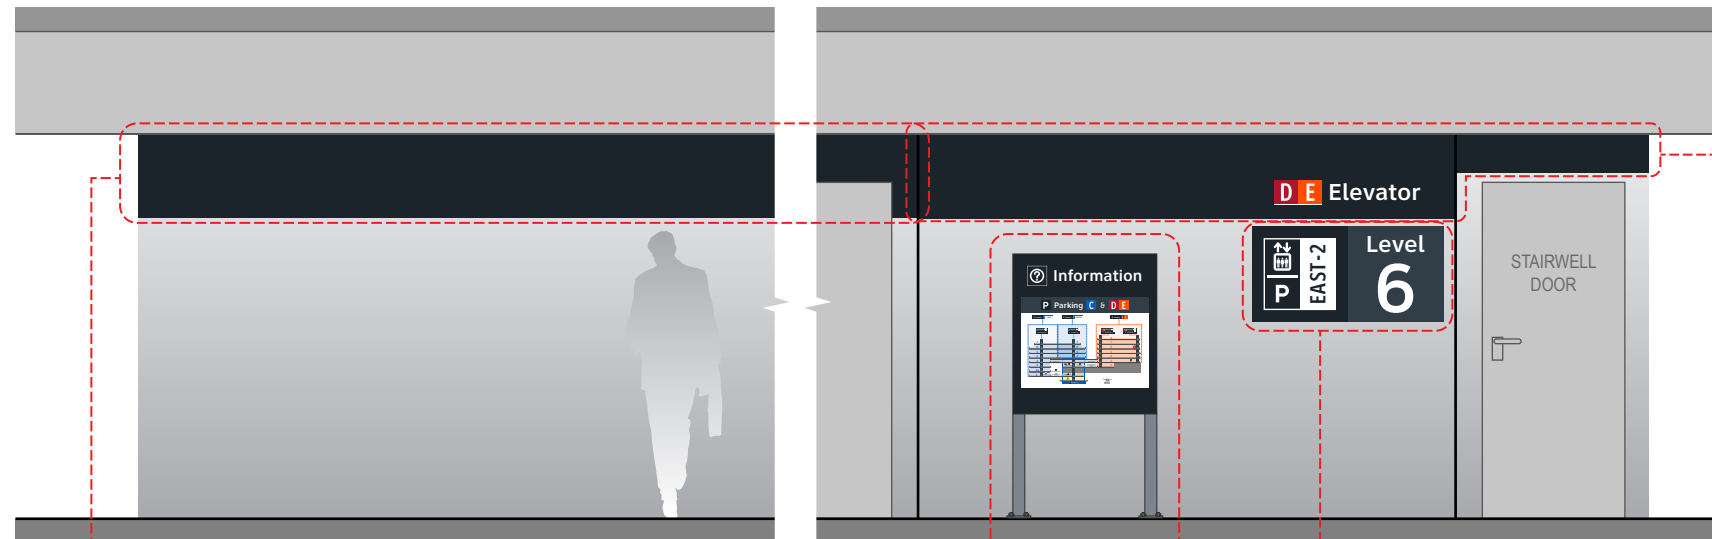Side A



S3 DE.L6-003a 5-IN.61

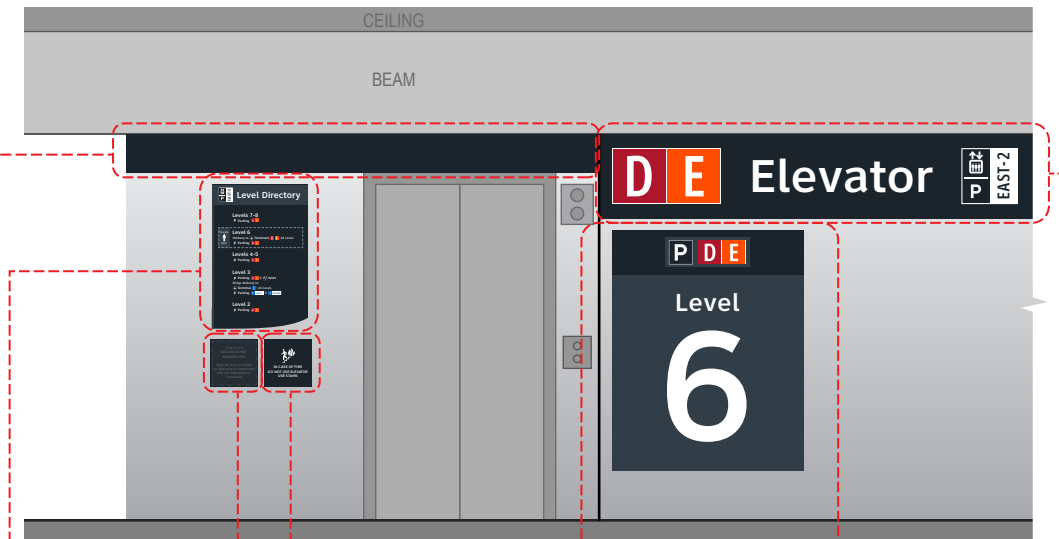
NOTES: Directory artwork includes a "You Are Here" button graphic and is in a unique location per elevator core/level location; artwork included here is representative of final map artwork design intent for this location

S3 DE.L6-003b 5-ID.56

S3 DE.L6-003 5-ID.57

NOTES: Wall paint and header graphics at A & C elevations only of elevator core included for this location number; wall elevation conditions shown are artistic representation based on rough site photo surveys; actual wall elevation conditions to be field verified by contractor/installer

Side C



S3 DE.L6-003c 5-IN.55

NOTES: Level directory plaque includes a "You Are Here" graphic and is in a unique location per elevator core/level location; artwork included here is representative of final artwork design intent for this location

S3 DE.L6-003d 5-IN.51

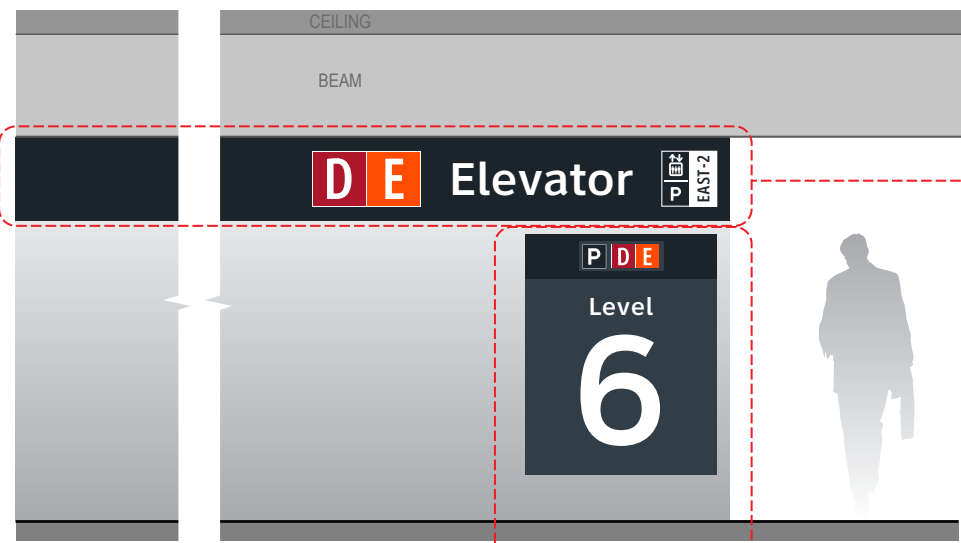
S3 DE.L6-003e 5-IN.52

S3 DE.L6-003h 5-ID.58

S3 DE.L6-003f 5-ID.59

NOTES: Wall paint and header graphics on rear and two side elevations of elevator core included for this location number; wall elevation conditions shown are artistic representation based on rough site photo surveys; actual wall elevation conditions to be field verified by contractor/installer

Side B



S3 DE.L6-003g 5-ID.59


NOTES: Wall paint and header graphics on rear and two side elevations of elevator core included for this location number; wall elevation conditions shown are artistic representation based on rough site photo surveys; actual wall elevation conditions to be field verified by contractor/installer

S3 DE.L6-003i 5-ID.58

## END OF GARAGE C: LEVEL 6 - SECTOR 3 MESSAGES
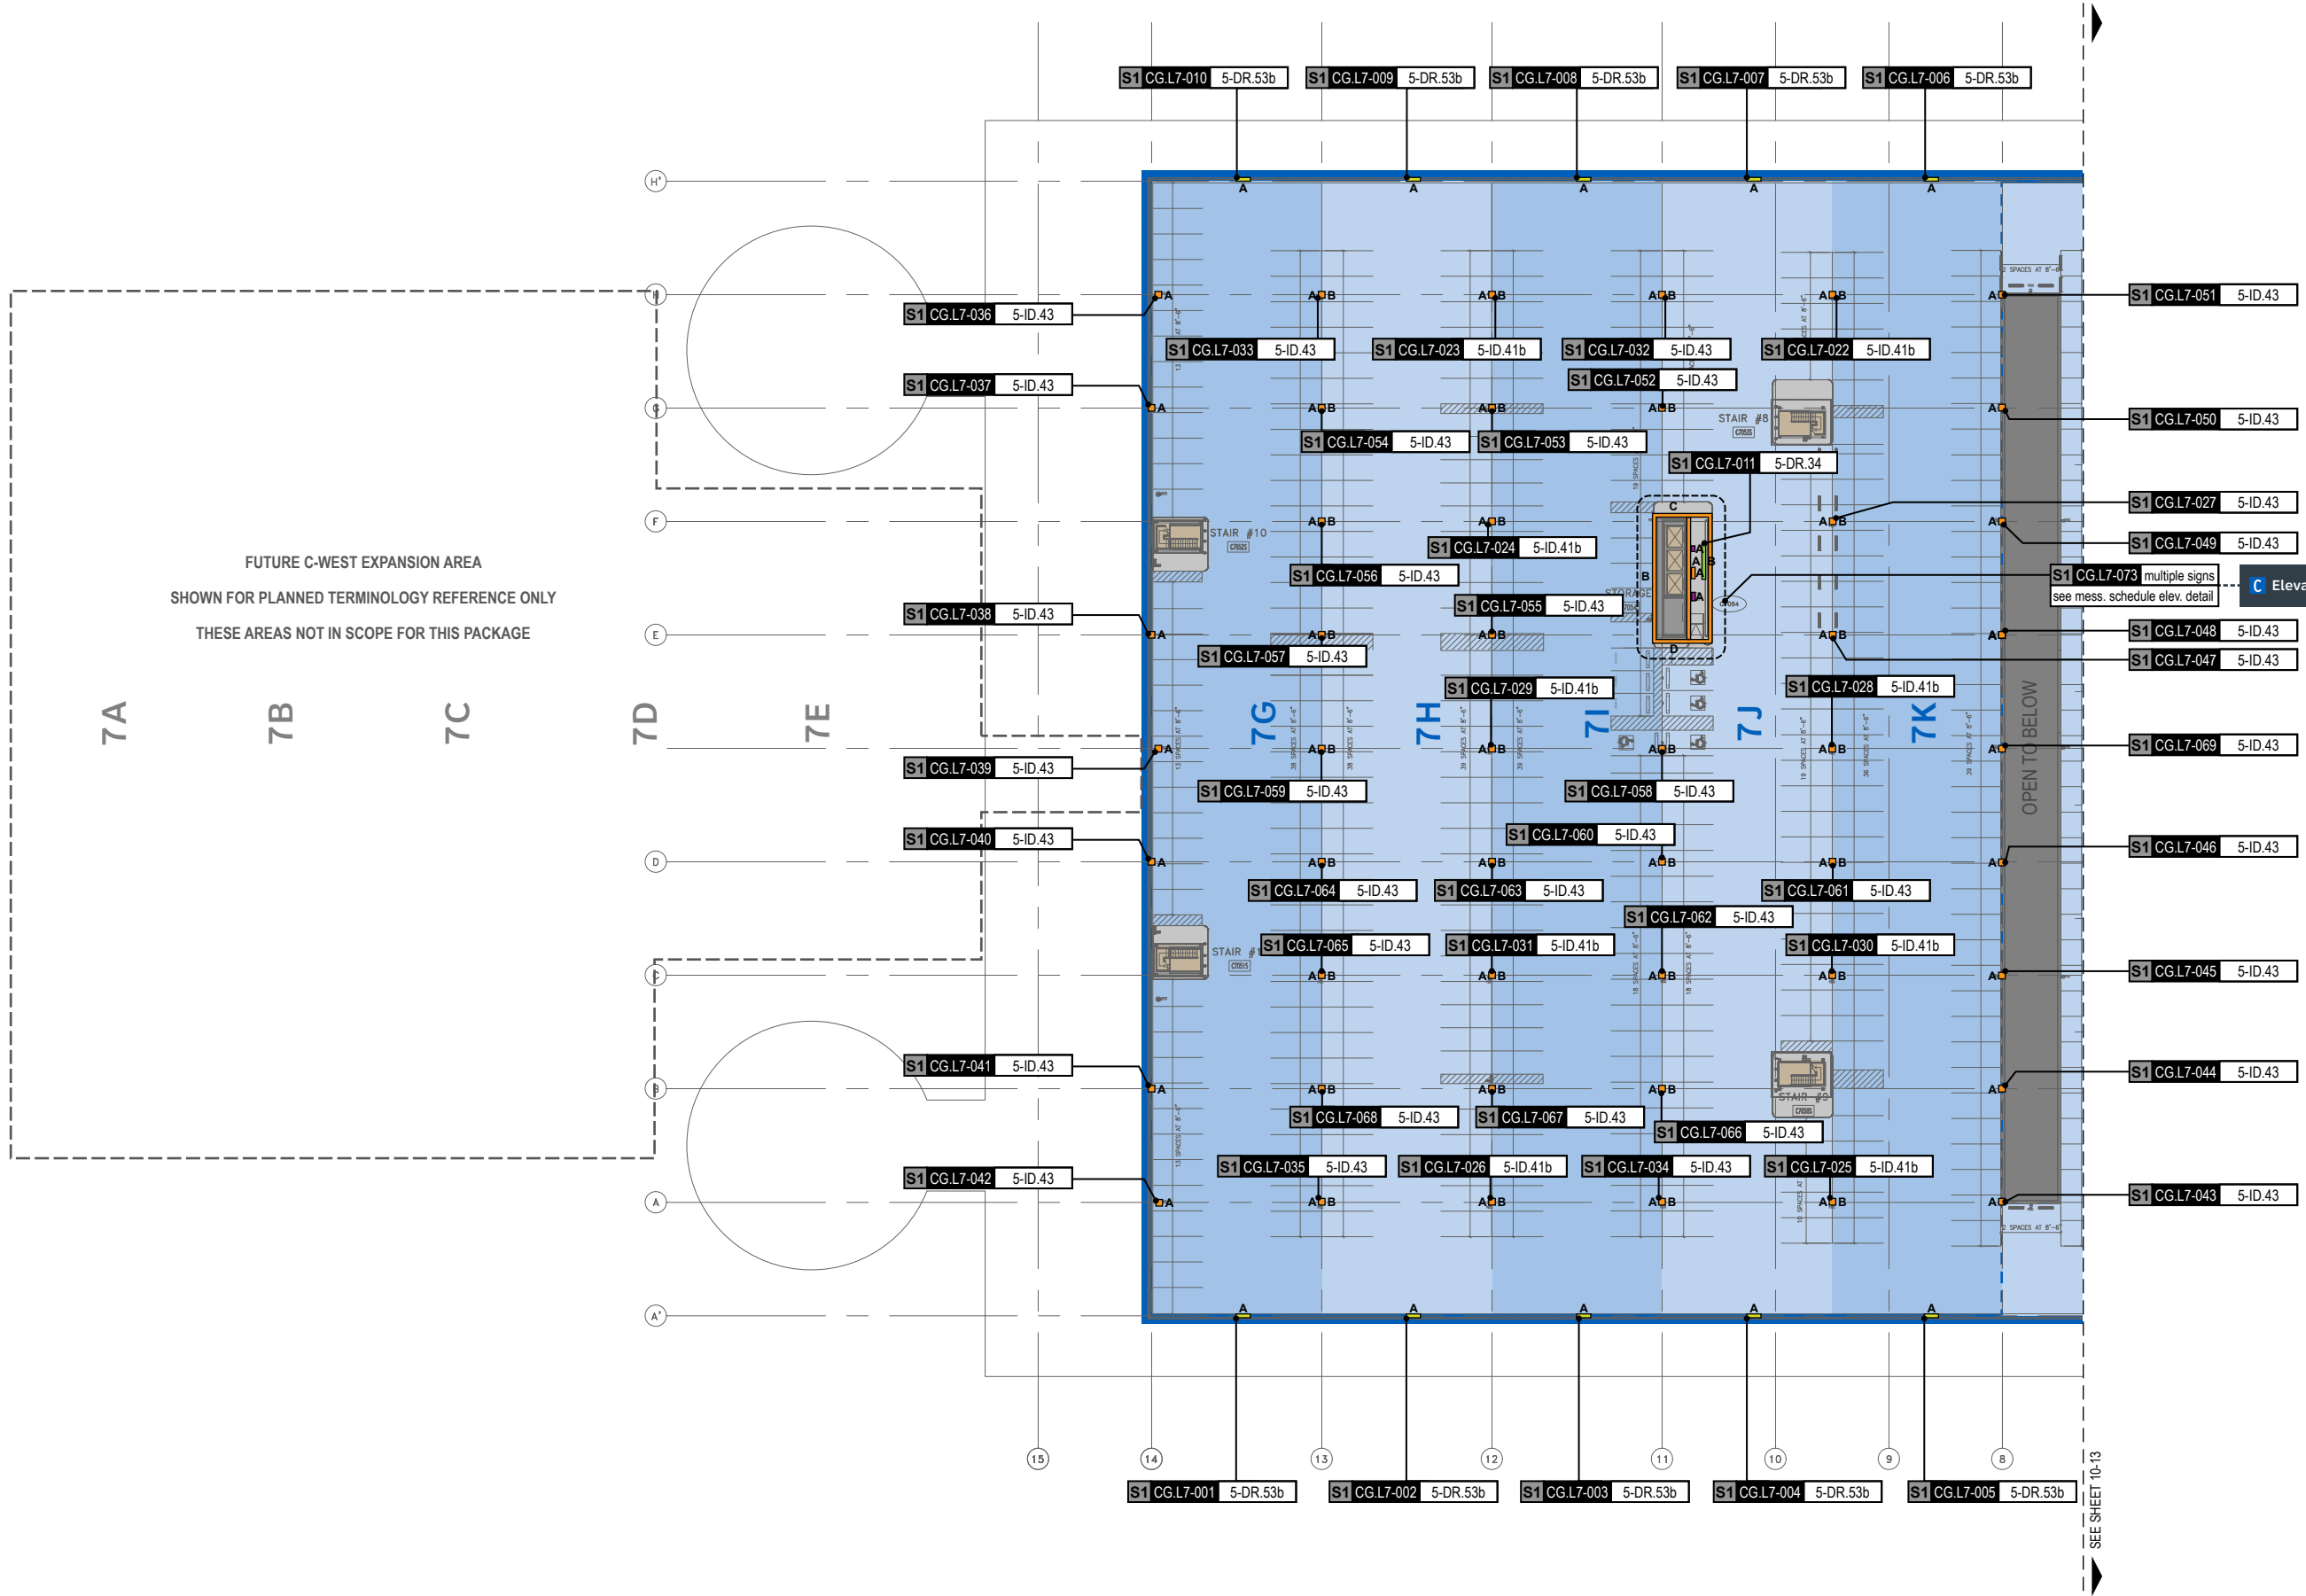
# 10.0

**10.0 LOCATION PLANS & MESSAGE SCHEDULES:  
LEVEL 7**




**GENERAL NOTES**

- Sign locations & orientations shown here are approximations based on the most current plan drawings as provided to the designer by the architect at the time of this document's completion. These sign locations are for general design intent & wayfinding planning purposes only. They should not be construed or deemed as absolute or final locations. Field verification, marking & documentation of each final location is to be performed by the Fabricator/Installer & coordinated with project staff & Wayfinding Design Consultants for final approval.
- All final install locations must be marked and verified in the field for proper structural integrity, adequate line of sight, utilities / property-line / other existing signage interferences & must be in complete compliance with all local, state and national codes prior to fabrication or installation.
- Adjustments to the sign locations shown in these drawings must be documented by the Fabricator/Installer, and provided to project staff & Wayfinding Design Consultants for final approval.

**NOTE:** Only priority wayfinding signage & locations as shown in this wayfinding plan package are in scope. All other signage not shown (including traffic control) are NOT IN SCOPE for this project/contract.

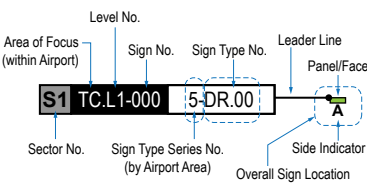**SIGN LOCATION ANNOTATION LEGEND**




- LOCATION CODE DEFINITIONS:**
- |  |   |
|--|---|
| <b>AREA OF FOCUS:</b><br>(location within Airport) | <b>SIGN TYPE SERIES NO.:</b><br>(by Airport Area) |
| TA = Terminal A                                    | 1- = Terminals/Concourses                         |
| TB = Terminal B                                    | 1t- = Terminals/Concourses: Temporary             |
| TC = Terminal C                                    | 2- = CBP Areas                                    |
| TD = Terminal D                                    | 3- = Curbside/Ground Trans.                       |
| TE = Terminal E                                    | 4- = Roadways                                     |
| AB = AB Garage                                     | 5- = Parking                                      |
| CG = C Garage                                      |   |
| DE = DE Garage                                     |   |
- WAYFINDING SIGN TYPE:**
- DR.xx = Directional  
ID.xx = Identification  
IN.xx = Informational

- WAYFINDING SIGN LOCATIONS - Parking:**
- |                          |                         |
|--------------------------|-------------------------|
| <b>PEDESTRIAN Signs:</b> | <b>VEHICULAR Signs:</b> |
| A = Directional (DR)     | A = Directional (DR)    |
| B = Identification (ID)  | B = Identification (ID) |
| A = Informational (IN)   | A = Informational (IN)  |
| B = Informational (IN)   | B = Informational (IN)  |


- CIRCULATION:**
- Public Use PEDESTRIAN Vertical Circulation (i.e. Elevators/Escalators/Stairs)
  - Public Use VEHICULAR Vertical Circulation (i.e. Ramps)
  - Alpha-Numeric Parking Section Naming Areas (Blues = C Garages; Oranges = D/E Garage)
  - Areas Not In Scope for this Package

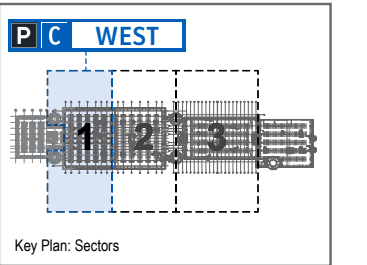LOCATION PLAN SCALE: 1" = 60'




S1 CG.L7-001 5-DR.53b Notes: N/A

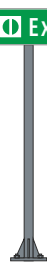Side A




Side B

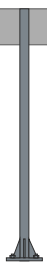


S1 CG.L7-002 5-DR.53b Notes: N/A

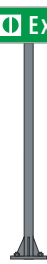Side A




Side B

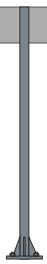


S1 CG.L7-003 5-DR.53b Notes: N/A

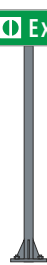Side A




Side B

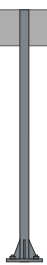


S1 CG.L7-004 5-DR.53b Notes: N/A

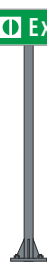Side A




Side B

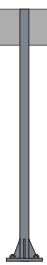


S1 CG.L7-005 5-DR.53b Notes: N/A

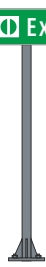Side A




Side B

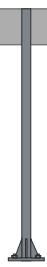


S1 CG.L7-006 5-DR.53b Notes: N/A

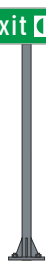Side A




Side B

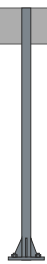


S1 CG.L7-007 5-DR.53b Notes: N/A

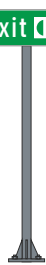Side A




Side B

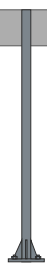


S1 CG.L7-008 5-DR.53b Notes: N/A

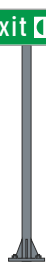Side A




Side B

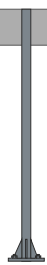




S1 CG.L7-009 5-DR.53b Notes: N/A

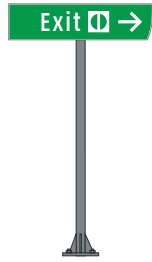Side A




Side B

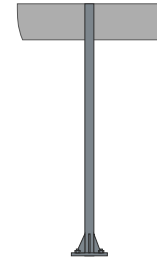


S1 CG.L7-010 5-DR.53b Notes: N/A

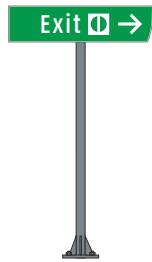Side A




Side B

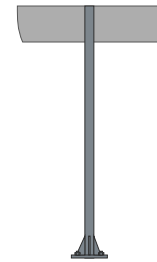

S1 CG.L7-011 5-DR.34 Notes: N/A

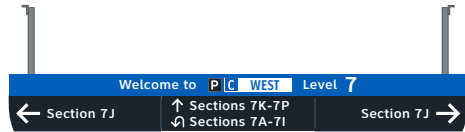Side A



Side B



S1 CG.L7-012 N/A Notes: N/A

NOT USED

S1 CG.L7-013 N/A Notes: N/A

NOT USED

S1 CG.L7-014 N/A Notes: N/A

NOT USED

S1 CG.L7-015 N/A Notes: N/A

NOT USED

S1 CG.L7-016 N/A Notes: N/A

NOT USED

Wayfinding Updates

Issue Date: 08-23-2024

Issue for Bid

- REV. A
- REV. A
- REV. A

WARNING:

This record contains Sensitive Security Information that is controlled under 49 CFR parts 15 and 1520. No part of this record may be disclosed to persons with a "need to know," as defined in 49 CFR parts 15 and 1520, except with the written permission of the Administrator of the Transportation Security Administration or the Secretary of Transportation. Unauthorized release may result in civil penalty or other action. For U.S. government agencies, public disclosure is governed by 5 U.S.C. 552 and 49 CFR parts 15 and 1520.



THESE SHEETS ARE ISSUED FOR GRAPHICAL INFORMATION ONLY

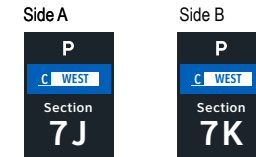
10.2 MESSAGE SCHEDULE - GARAGE C: LEVEL 7 - SECTOR 1 (C WEST)

BSG PRJCT# BSG-2024-111-IAH HAS TIP # 24 -103 - IAH


NOT USED

NOT USED


NOT USED



NOT USED

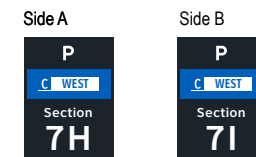

NOT USED

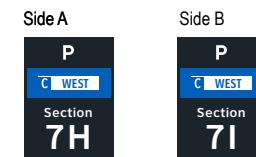

**Wayfinding Updates**

Issue Date: 08-23-2024

**Issue for Bid**

- REV.
- REV.
- REV.

**WARNING:**

This record contains Sensitive Security Information that is controlled under 49 CFR parts 15 and 1520. No part of this record may be disclosed to persons with a "need to know," as defined in 49 CFR parts 15 and 1520, except with the written permission of the Administrator of the Transportation Security Administration or the Secretary of Transportation. Unauthorized release may result in civil penalty or other action. For U.S. government agencies, public disclosure is governed by 5 U.S.C. 552 and 49 CFR parts 15 and 1520.

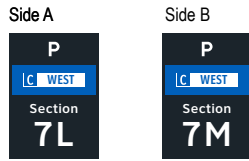


THESE SHEETS ARE ISSUED FOR GRAPHICAL INFORMATION ONLY


**10.2 MESSAGE SCHEDULE - GARAGE C: LEVEL 7 - SECTOR 1 (C WEST)**

BSG PRJCT# BSG-2024-111-IAH  
HAS TIP # 24 -103 - IAH


S1 CG.L7-025 5-ID.41b Notes: N/A




S1 CG.L7-029 5-ID.41b Notes: N/A

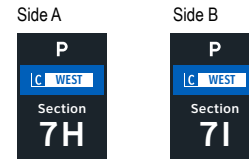


S1 CG.L7-026 5-ID.41b Notes: N/A

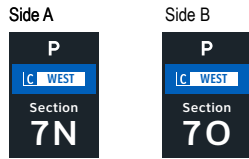


S1 CG.L7-030 5-ID.41b Notes: N/A

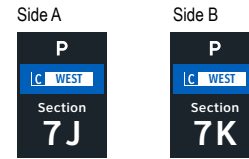


S1 CG.L7-027 5-ID.43 Notes: N/A

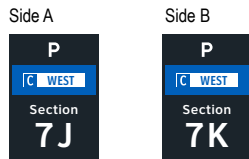


S1 CG.L7-031 5-ID.41b Notes: N/A

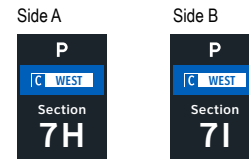


S1 CG.L7-028 5-ID.41b Notes: N/A

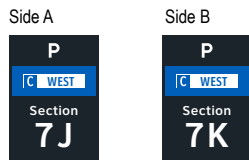


S1 CG.L7-032 5-ID.43 Notes: N/A

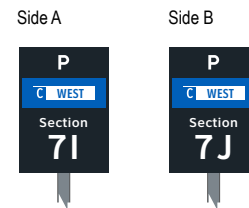


Side A Side B

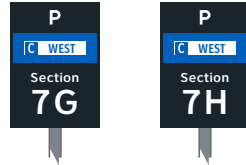


Side A Side B

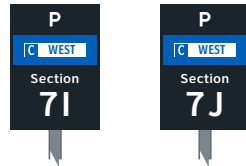


Side A Side B

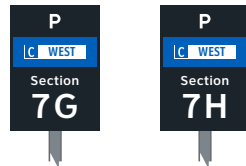


Side A

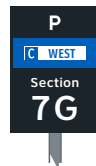


Side A

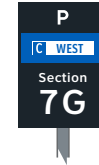


Side A

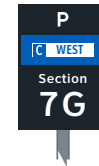

Side A

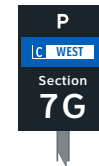

Side A

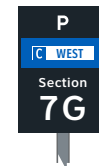

Wayfinding Updates

Issue Date: 08-23-2024

Issue for Bid

- REV. A
REV. B
REV. C

WARNING:

This record contains Sensitive Security Information that is controlled under 49 CFR parts 15 and 1520. No part of this record may be disclosed to persons with a "need to know," as defined in 49 CFR parts 15 and 1520, except with the written permission of the Administrator of the Transportation Security Administration or the Secretary of Transportation. Unauthorized release may result in civil penalty or other action. For U.S. government agencies, public disclosure is governed by 5 U.S.C. 552 and 49 CFR parts 15 and 1520.



THESE SHEETS ARE ISSUED FOR GRAPHICAL INFORMATION ONLY

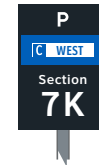
10.2 MESSAGE SCHEDULE - GARAGE C: LEVEL 7 - SECTOR 1 (C WEST)

BSG PRJCT# BSG-2024-111-IAH
HAS TIP # 24 -103 - IAH


Side A




Side A




Side A

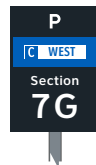

Side A


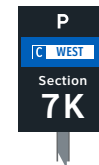


Side A

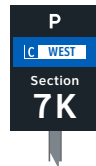


Side A

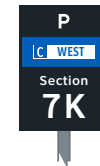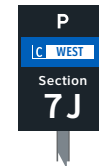
Side B




Side A

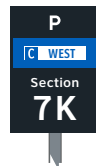


Side A

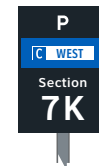


Side A

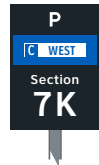


Side A

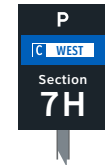


Side B

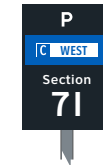


Side A

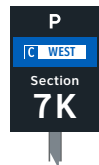


Side A

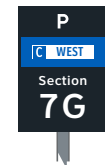


Side B

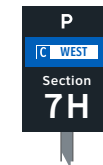


Side A

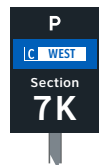


Side A

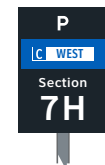


Side B

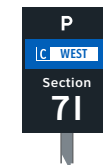


Side A

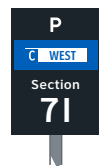


Side B

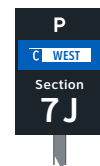

Side A

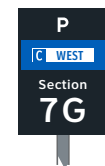

Side B

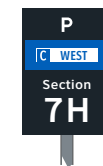

Wayfinding Updates

Issue Date: 08-23-2024

Issue for Bid

- REV. A
- REV. A
- REV. A

WARNING:

This record contains Sensitive Security Information that is controlled under 49 CFR parts 15 and 1520. No part of this record may be disclosed to persons with a "need to know," as defined in 49 CFR parts 15 and 1520, except with the written permission of the Administrator of the Transportation Security Administration or the Secretary of Transportation. Unauthorized release may result in civil penalty or other action. For U.S. government agencies, public disclosure is governed by 5 U.S.C. 552 and 49 CFR parts 15 and 1520.

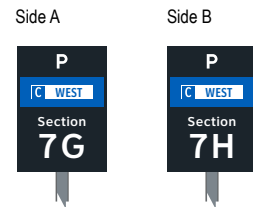


THESE SHEETS ARE ISSUED FOR GRAPHICAL INFORMATION ONLY


10.2 MESSAGE SCHEDULE - GARAGE C: LEVEL 7 - SECTOR 1 (C WEST)

BSG PRJCT# BSG-2024-111-IAH HAS TIP # 24 -103 - IAH


S1 CG.L7-057 5-ID.43 Notes: N/A




S1 CG.L7-060 5-ID.43 Notes: N/A

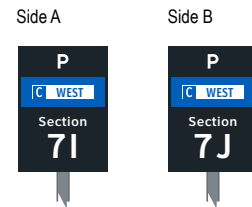


S1 CG.L7-058 5-ID.43 Notes: N/A

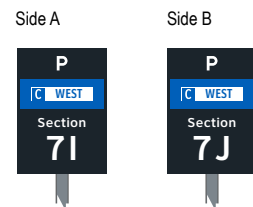


S1 CG.L7-061 5-ID.43 Notes: N/A

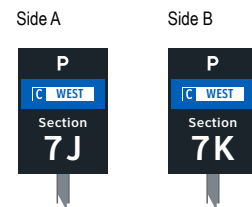


S1 CG.L7-059 5-ID.43 Notes: N/A

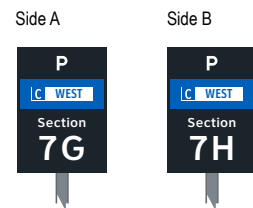


S1 CG.L7-062 5-ID.43 Notes: N/A

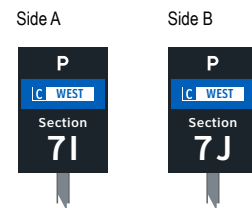

S1 CG.L7-060 5-ID.43 Notes: N/A

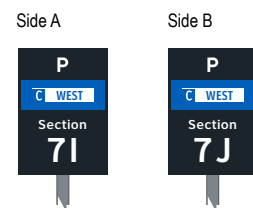

S1 CG.L7-063 5-ID.43 Notes: N/A

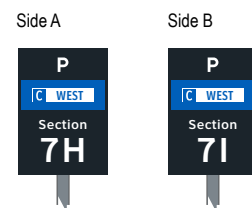

GEORGE BUSH INTERCONTINENTAL AIRPORT  
Wayfinding Signage Design Intent Documents  
C Garage



Louisville, Colorado  
P: 303.494.7849  
www.labozan.com

These documents are intended to illustrate design intent, and should only be used as a general guideline. No information contained here should be construed as engineered elements. The fabricator/contractor shall be responsible for all engineering and specifications with regard to structural, electrical, mechanical, foundation and installation. Information and illustrations contained here are part of an original unpublished design by Labozan Associates, Inc. Detailing and information contained on these pages shall not be reproduced, copied or utilized in any way except for the specific project for which they were created without previous written authorization from Labozan Associates, Inc.  
© 2024 by Labozan Associates, Inc.

Wayfinding Updates

Issue Date: 08-23-2024  
Issue for Bid

- REV.
- REV.
- REV.

WARNING:

This record contains Sensitive Security Information that is controlled under 49 CFR parts 15 and 1520. No part of this record may be disclosed to persons with a "need to know," as defined in 49 CFR parts 15 and 1520, except with the written permission of the Administrator of the Transportation Security Administration or the Secretary of Transportation. Unauthorized release may result in civil penalty or other action. For U.S. government agencies, public disclosure is governed by 5 U.S.C. 552 and 49 CFR parts 15 and 1520.



08-23-2024

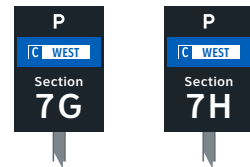
THESE SHEETS ARE ISSUED FOR GRAPHICAL INFORMATION ONLY

10.2 MESSAGE SCHEDULE - GARAGE C: LEVEL 7 - SECTOR 1 (C WEST)

BSG PRJCT# BSG-2024-111-IAH  
HAS TIP # 24 -103 - IAH


S1 CG.L7-064 5-ID.43 Notes: N/A

Side A Side B




S1 CG.L7-068 5-ID.43 Notes: N/A

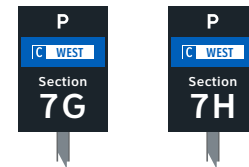Side A Side B




S1 CG.L7-065 5-ID.43 Notes: N/A

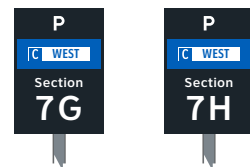Side A Side B




S1 CG.L7-069 5-ID.43 Notes: N/A

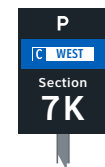Side A



S1 CG.L7-066 5-ID.43 Notes: N/A

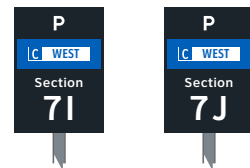Side A Side B




S1 CG.L7-070 N/A Notes: N/A

NOT USED

S1 CG.L7-067 5-ID.43 Notes: N/A

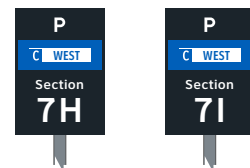Side A Side B



S1 CG.L7-071 N/A Notes: N/A

NOT USED



NOT USED

ELEVATOR CORE SIGNAGE CONTINUED ON NEXT SHEET



GEORGE BUSH INTERCONTINENTAL AIRPORT  
Wayfinding Signage Design Intent Documents  
C Garage



Louisville, Colorado  
P: 303.494.7849  
www.labozan.com

These documents are intended to illustrate design intent, and should only be used as a general guideline. No information contained here should be construed as engineered elements. The fabricator/contractor shall be responsible for all engineering and specifications with regard to structural, electrical, mechanical, foundation and installation. Information and illustrations contained here are part of an original unpublished design by Labozan Associates, Inc. Detailing and information contained on these pages shall not be reproduced, copied or utilized in any way except for the specific project for which they were created without previous written authorization from Labozan Associates, Inc.

**Wayfinding Updates**

Issue Date: 08-23-2024  
Issue for Bid

- REV.
- REV.
- REV.

**WARNING:**

This record contains Sensitive Security Information that is controlled under 49 CFR parts 15 and 1520. No part of this record may be disclosed to persons with a "need to know," as defined in 49 CFR parts 15 and 1520, except with the written permission of the Administrator of the Transportation Security Administration or the Secretary of Transportation. Unauthorized release may result in civil penalty or other action. For U.S. government agencies, public disclosure is governed by 5 U.S.C. 552 and 49 CFR parts 15 and 1520.



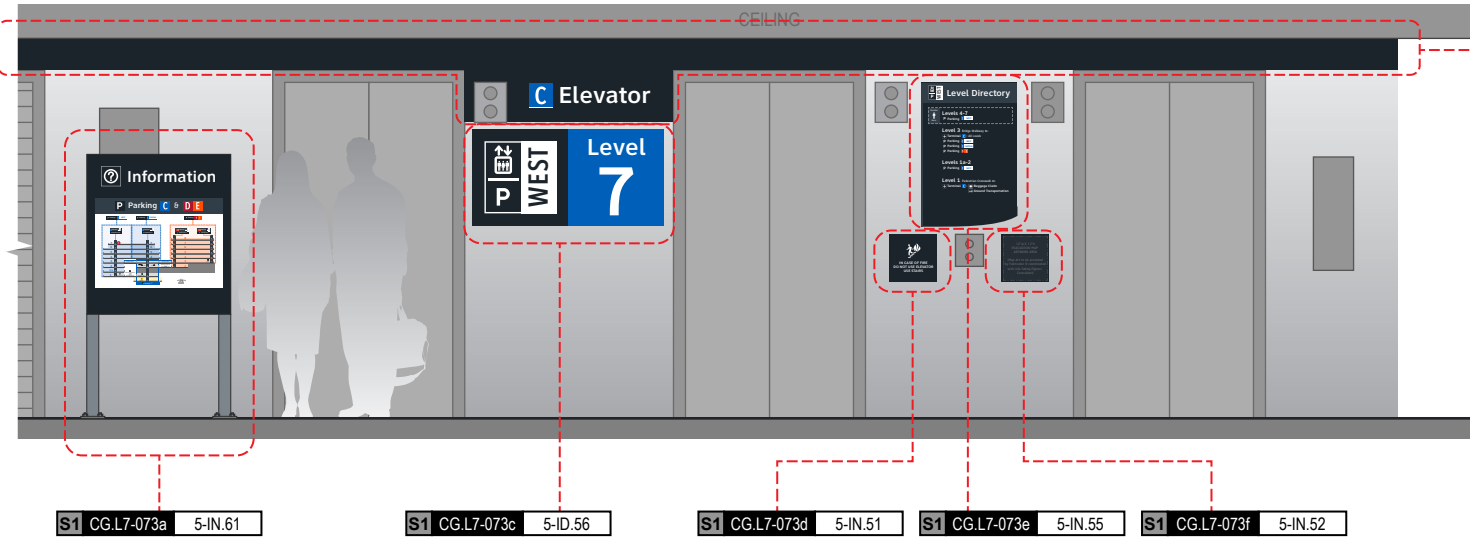
08-23-2024

THESE SHEETS ARE ISSUED FOR GRAPHICAL INFORMATION ONLY

**10.2 MESSAGE SCHEDULE - GARAGE C: LEVEL 7 - SECTOR 1 (C WEST)**

BSG PRJCT# BSG-2024-111-IAH  
HAS TIP # 24 -103 - IAH

Side A



- S1 CG.L7-073a 5-IN.61
- S1 CG.L7-073c 5-ID.56
- S1 CG.L7-073d 5-IN.51
- S1 CG.L7-073e 5-IN.55
- S1 CG.L7-073f 5-IN.52

NOTES: Directory artwork includes a "You Are Here" button graphic and is in a unique location per elevator core/level location; artwork included here is representative of final map artwork design intent for this location

NOTES: Level directory plaque includes a "You Are Here" graphic and is in a unique location per elevator core/level location; artwork included here is representative of final artwork design intent for this location

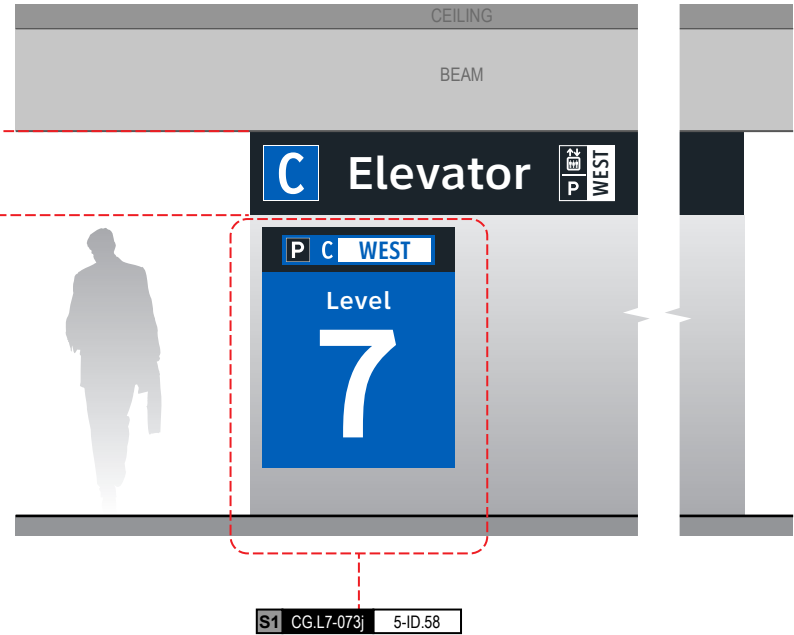
S1 CG.L7-073b 5-ID.57

NOTES: Wall paint and header graphics at front elevation only of elevator core included for this location number; wall elevation conditions shown are artistic representation based on rough site photo surveys; actual wall elevation conditions to be field verified by contractor/installer

S1 CG.L7-073g 5-ID.59


NOTES: Wall paint and header graphics on rear and two side elevations of elevator core included for this location number; wall elevation conditions shown are artistic representation based on rough site photo surveys; actual wall elevation conditions to be field verified by contractor/installer

Side C



S1 CG.L7-073j 5-ID.58

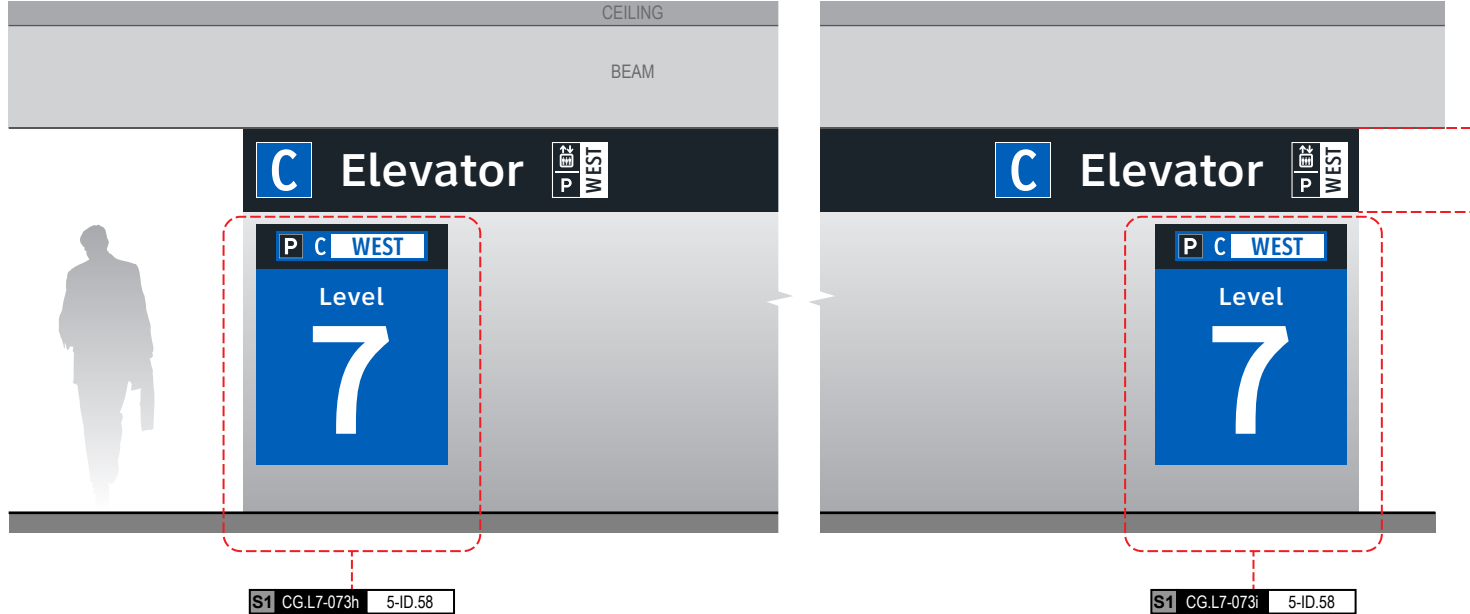
Side B



S1 CG.L7-073h 5-ID.58


S1 CG.L7-073i 5-ID.58

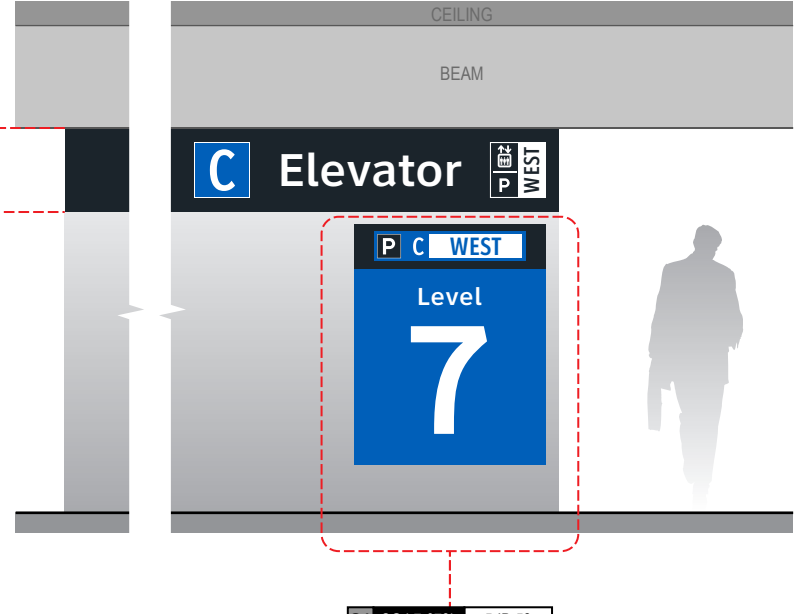Side D



S1 CG.L7-073k 5-ID.58

**END OF GARAGE C: LEVEL 7 - SECTOR 1 MESSAGES**

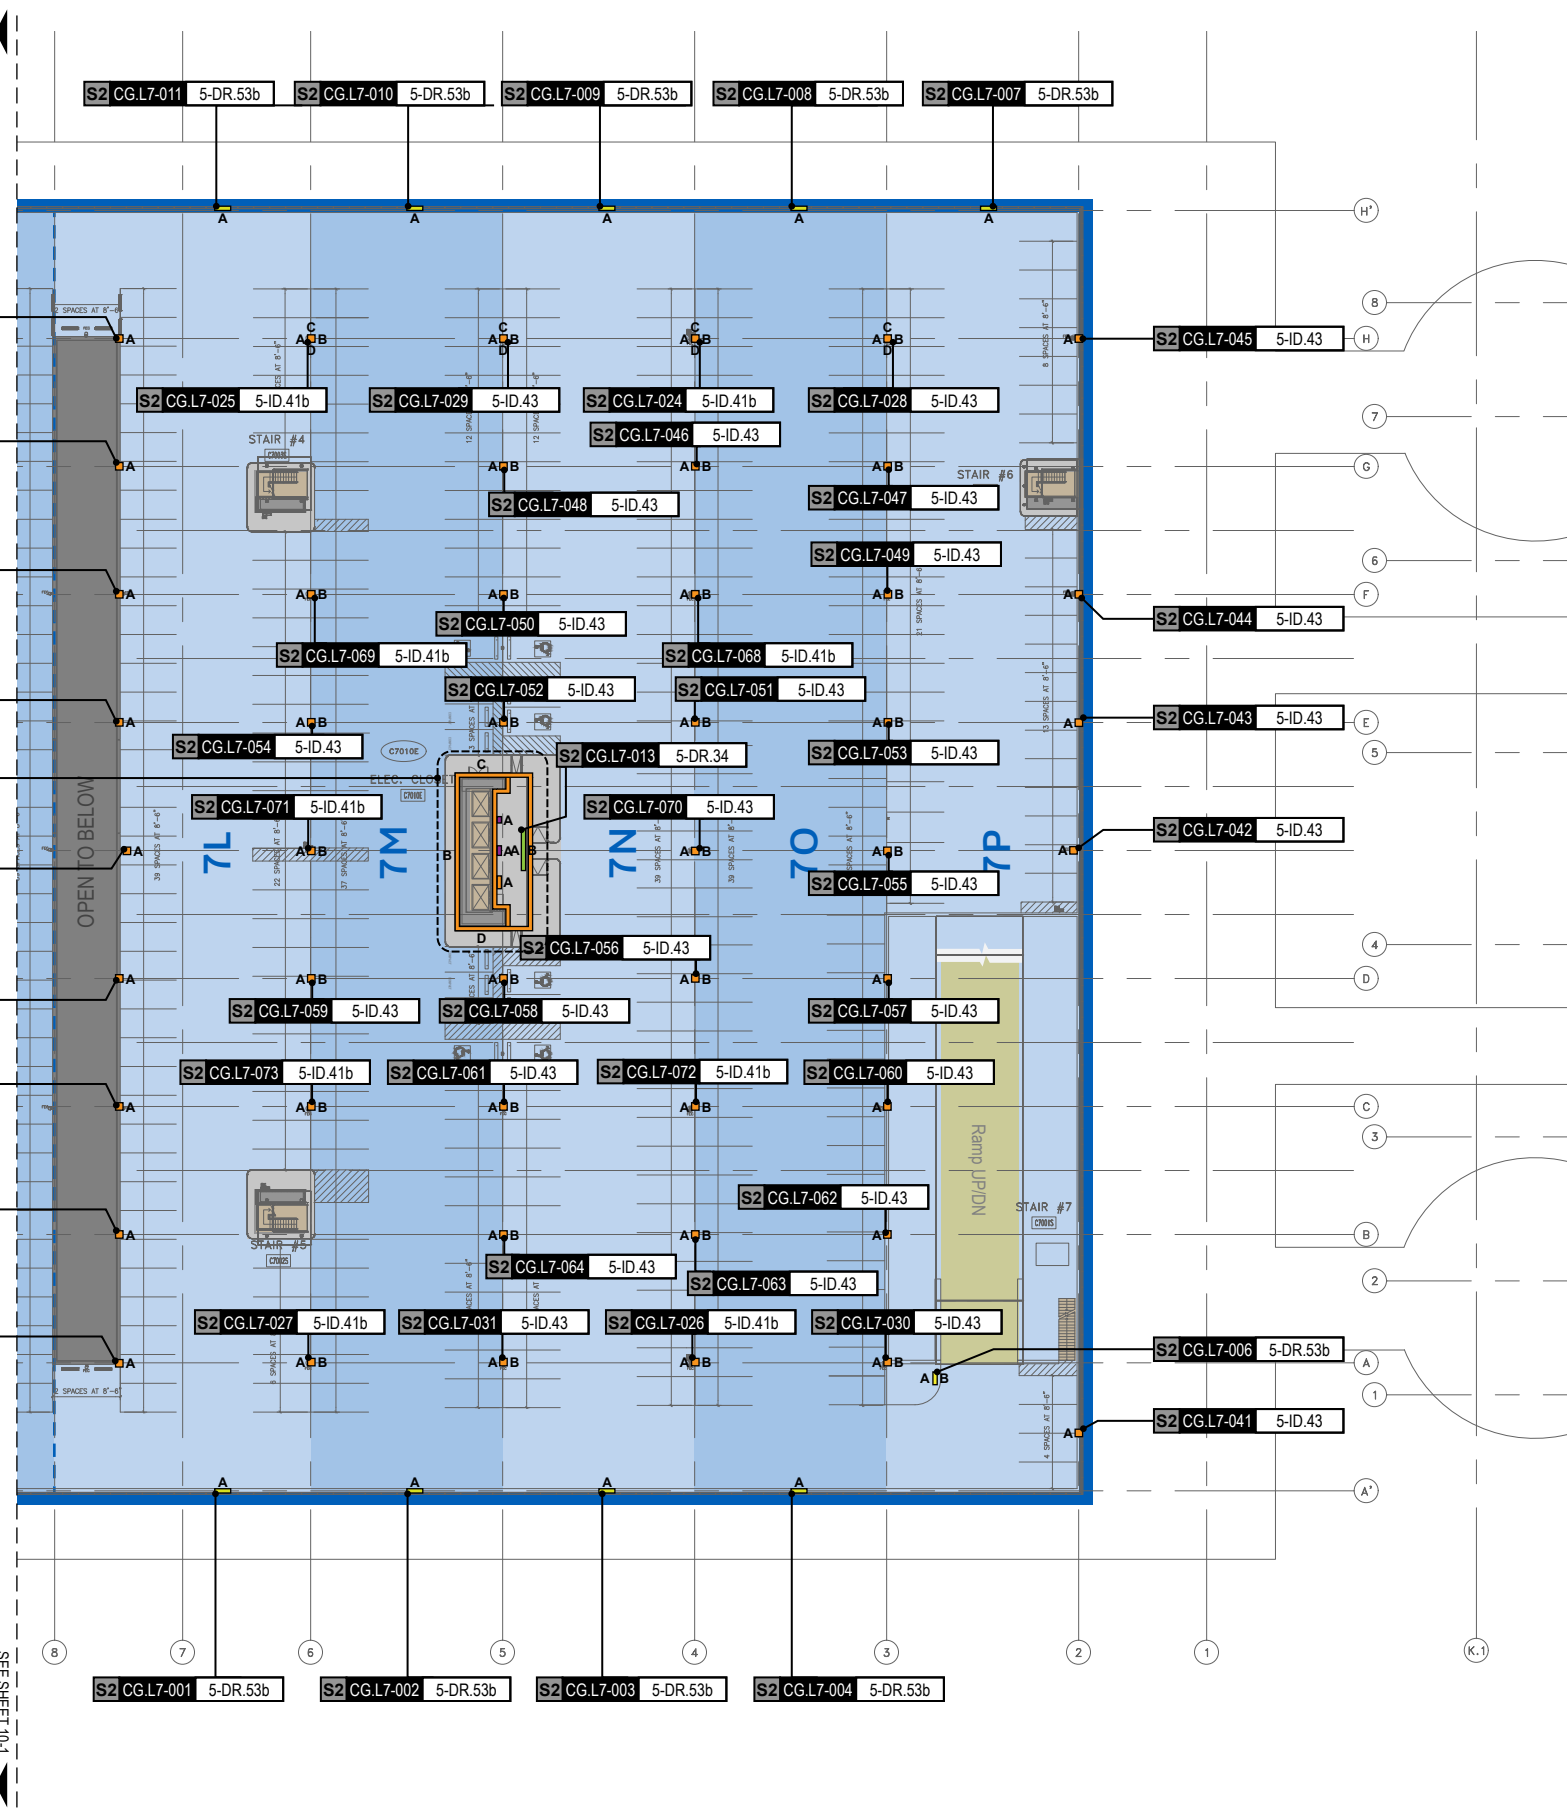


S2 CG.L7-075 multiple signs  
see mess. schedule elev. detail

SEE SHEET 10-1

**GENERAL NOTES**

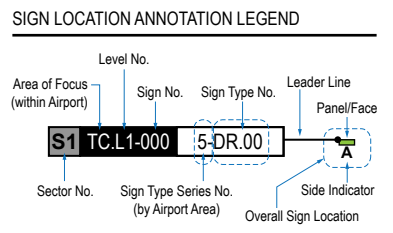- Sign locations & orientations shown here are approximations based on the most current plan drawings as provided to the designer by the architect at the time of this document's completion. These sign locations are for general design intent & wayfinding planning purposes only. They should not be construed or deemed as absolute or final locations. Field verification, marking & documentation of each final location is to be performed by the Fabricator/Installer & coordinated with project staff & Wayfinding Design Consultants for final approval.
- All final install locations must be marked and verified in the field for proper structural integrity, adequate line of sight, utilities / property-line / other existing signage interferences & must be in complete compliance with all local, state and national codes prior to fabrication or installation.
- Adjustments to the sign locations shown in these drawings must be documented by the Fabricator/Installer, and provided to project staff & Wayfinding Design Consultants for final approval.

**NOTE:** Only priority wayfinding signage & locations as shown in this wayfinding plan package are in scope. All other signage not shown (including traffic control) are NOT IN SCOPE for this project/contract.



**LOCATION CODE DEFINITIONS:**

**AREA OF FOCUS:** (location within Airport)  
 TA = Terminal A  
 TB = Terminal B  
 TC = Terminal C  
 TD = Terminal D  
 TE = Terminal E  
 AB = AB Garage  
 CG = C Garage  
 DE = DE Garage

**SIGN TYPE SERIES NO.:** (by Airport Area)  
 1- = Terminals/Concourses  
 1t- = Terminals/Concourses: Temporary  
 2- = CBP Areas  
 3- = Curbside/Ground Trans.  
 4- = Roadways  
 5- = Parking

**WAYFINDING SIGN TYPE:**  
 DR.xx = Directional  
 ID.xx = Identification  
 IN.xx = Informational

**WAYFINDING SIGN LOCATIONS - Parking:**

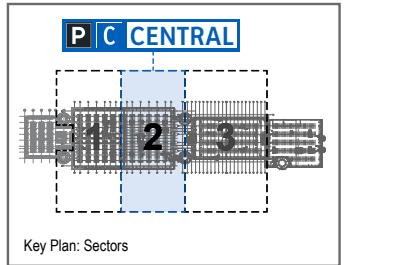
**PEDESTRIAN Signs:**  
 A = Directional (DR)  
 B = Identification (ID)  
 A/B = Informational (IN)

**VEHICULAR Signs:**  
 A = Directional (DR)  
 B = Identification (ID)  
 A/B = Informational (IN)

**CIRCULATION:**

- Public Use PEDESTRIAN Vertical Circulation (i.e. Elevators/Escalators/Stairs)
- Public Use VEHICULAR Vertical Circulation (i.e. Ramps)
- Alpha-Numeric Parking Section Naming Areas (Blues = C Garages; Oranges = D/E Garage)
- Areas Not In Scope for this Package

LOCATION PLAN SCALE: 1" = 60'



S2 CG.L7-001 5-DR.53b Notes: N/A

Side A



Side B



S2 CG.L7-002 5-DR.53b Notes: N/A

Side A



Side B



S2 CG.L7-003 5-DR.53b Notes: N/A

Side A



Side B



S2 CG.L7-004 5-DR.53b Notes: N/A

Side A



Side B



S2 CG.L7-005 N/A Notes: N/A

NOT USED

S2 CG.L7-006 5-DR.53b Notes: N/A

Side A



Side B



S2 CG.L7-007 5-DR.53b Notes: N/A

Side A



Side B



S2 CG.L7-008 5-DR.53b Notes: N/A

Side A



Side B



S2 CG.L7-009 5-DR.53b Notes: N/A

Side A



Side B



S2 CG.L7-010 5-DR.53b Notes: N/A

Side A



Side B



S2 CG.L7-011 5-DR.53b Notes: N/A

Side A



Side B

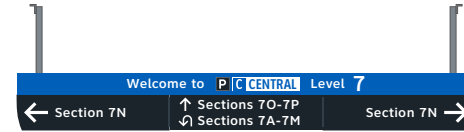


S2 CG.L7-012 N/A Notes: N/A

NOT USED

S2 CG.L7-013 5-DR.34 Notes: N/A

Side A



Side B



S2 CG.L7-014 N/A Notes: N/A

NOT USED

S2 CG.L7-015 N/A Notes: N/A

NOT USED

S2 CG.L7-016 N/A Notes: N/A

NOT USED

S2 CG.L7-017 N/A Notes: N/A

NOT USED

S2 CG.L7-021 N/A Notes: N/A

NOT USED

S2 CG.L7-018 N/A Notes: N/A

NOT USED

S2 CG.L7-022 N/A Notes: N/A

NOT USED

S2 CG.L7-019 N/A Notes: N/A

NOT USED

S2 CG.L7-023 N/A Notes: N/A

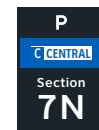
NOT USED

S2 CG.L7-020 N/A Notes: N/A


NOT USED

S2 CG.L7-024 5-ID.41 Notes: N/A

Side A



Side B

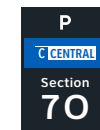

GEORGE BUSH INTERCONTINENTAL AIRPORT  
Wayfinding Signage Design Intent Documents  
C Garage



Louisville, Colorado  
P: 303.494.7849  
www.labozan.com

These documents are intended to illustrate design intent, and should only be used as a general guideline. No information contained here should be construed as engineered elements. The fabricator/contractor shall be responsible for all engineering and specifications with regard to structural, electrical, mechanical, foundation and installation. Information and illustrations contained here are part of an original unpublished design by Labozan Associates, Inc. Detailing and information contained on these pages shall not be reproduced, copied or utilized in any way except for the specific project for which they were created without previous written authorization from Labozan Associates, Inc.

© 2024 by Labozan Associates, Inc.

Wayfinding Updates

Issue Date: 08-23-2024  
Issue for Bid

- REV.
- REV.
- REV.

WARNING:

This record contains Sensitive Security Information that is controlled under 49 CFR parts 15 and 1520. No part of this record may be disclosed to persons with a "need to know," as defined in 49 CFR parts 15 and 1520, except with the written permission of the Administrator of the Transportation Security Administration or the Secretary of Transportation. Unauthorized release may result in civil penalty or other action. For U.S. government agencies, public disclosure is governed by 5 U.S.C. 552 and 49 CFR parts 15 and 1520.



08-23-2024

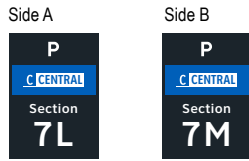
10.4 MESSAGE SCHEDULE - GARAGE C: LEVEL 7 - SECTOR 2 (C CENTRAL)

THESE SHEETS ARE ISSUED FOR GRAPHICAL INFORMATION ONLY


BSG PRJCT# BSG-2024-111-IAH  
HAS TIP # 24 -103 - IAH

Sheet: 10-16


S2 CG.L7-025 5-ID.41 Notes: N/A




S2 CG.L7-029 5-ID.42 Notes: N/A

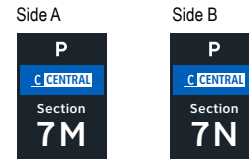


S2 CG.L7-026 5-ID.41 Notes: N/A

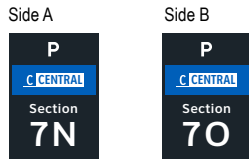


S2 CG.L7-030 5-ID.42 Notes: N/A

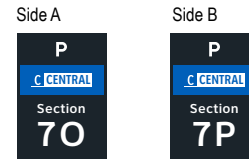


S2 CG.L7-027 5-ID.41 Notes: N/A

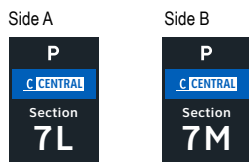


S2 CG.L7-031 5-ID.42 Notes: N/A

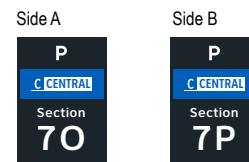


S2 CG.L7-028 5-ID.42 Notes: N/A

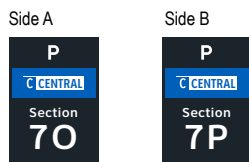


S2 CG.L7-032 5-ID.43 Notes: N/A

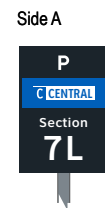


Side A

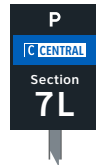


Side A

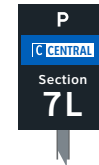


Side A

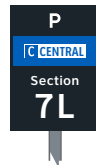


Side A

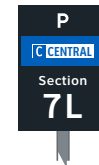


Side A

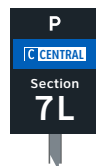


Side A

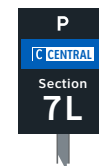

Side A

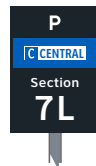


Side A

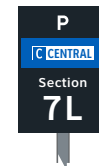





Side A

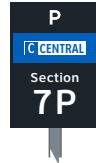

Side A

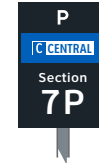


Side A

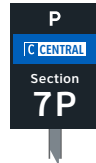


Side A



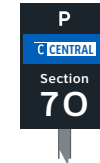
Side B




Side A

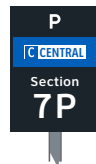


Side A

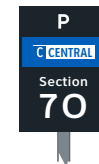


Side B

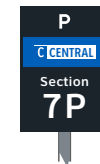


Side A

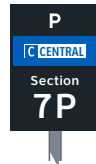

Side A

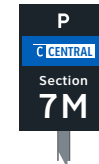


Side B

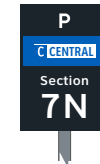


S2 CG.L7-049 5-ID.43 Notes: N/A

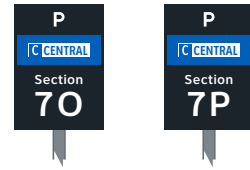Side A Side B




S2 CG.L7-053 5-ID.43 Notes: N/A

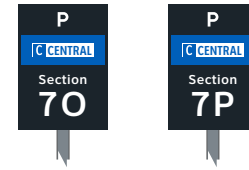Side A Side B




S2 CG.L7-050 5-ID.43 Notes: N/A

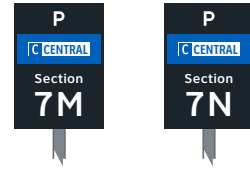Side A Side B




S2 CG.L7-054 5-ID.43 Notes: N/A

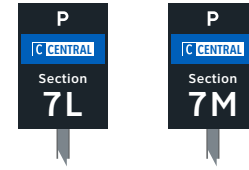Side A Side B




S2 CG.L7-051 5-ID.43 Notes: Notes: N/A

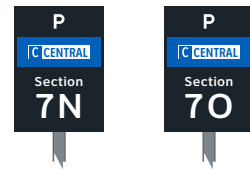Side A Side B




S2 CG.L7-055 5-ID.43 Notes: N/A

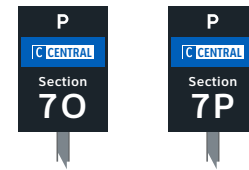Side A Side B




S2 CG.L7-052 5-ID.43 Notes: N/A

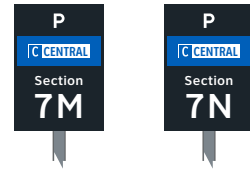Side A Side B



S2 CG.L7-056 5-ID.43 Notes: N/A

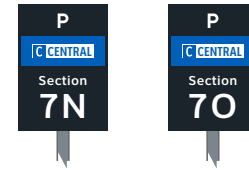Side A Side B



**Wayfinding Updates**

Issue Date: 08-23-2024  
Issue for Bid

- REV. 
- REV. 
- REV. 

**WARNING:**

This record contains Sensitive Security Information that is controlled under 49 CFR parts 15 and 1520. No part of this record may be disclosed to persons with a "need to know," as defined in 49 CFR parts 15 and 1520, except with the written permission of the Administrator of the Transportation Security Administration or the Secretary of Transportation. Unauthorized release may result in civil penalty or other action. For U.S. government agencies, public disclosure is governed by 5 U.S.C. 552 and 49 CFR parts 15 and 1520.



08-23-2024

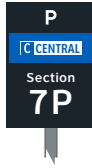
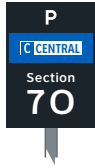
**10.4 MESSAGE SCHEDULE - GARAGE C: LEVEL 7 - SECTOR 2 (C CENTRAL)**

THESE SHEETS ARE ISSUED FOR GRAPHICAL INFORMATION ONLY

BSG PRJCT# BSG-2024-111-IAH  
HAS TIP # 24 -103 - IAH



S2 CG.L7-057 5-ID.43 Notes: N/A

Side A Side B





S2 CG.L7-058 5-ID.43 Notes: N/A

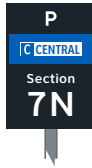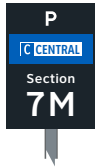Side A Side B




S2 CG.L7-059 5-ID.43 Notes: N/A

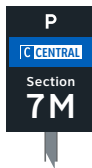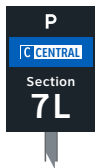Side A Side B




S2 CG.L7-060 5-ID.43 Notes: N/A

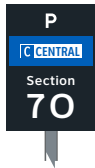Side A




S2 CG.L7-061 5-ID.43 Notes: N/A

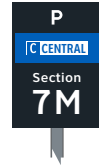Side A Side B




S2 CG.L7-062 5-ID.43 Notes: N/A

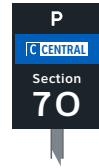Side A



S2 CG.L7-063 5-ID.43 Notes: N/A

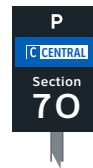Side A Side B




S2 CG.L7-064 5-ID.43 Notes: N/A

Side A



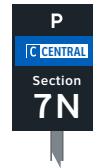Side B



Wayfinding Updates

Issue Date: 08-23-2024

Issue for Bid

- REV. A
REV. B
REV. C

WARNING:

This record contains Sensitive Security Information that is controlled under 49 CFR parts 15 and 1520. No part of this record may be disclosed to persons with a "need to know," as defined in 49 CFR parts 15 and 1520, except with the written permission of the Administrator of the Transportation Security Administration or the Secretary of Transportation. Unauthorized release may result in civil penalty or other action. For U.S. government agencies, public disclosure is governed by 5 U.S.C. 552 and 49 CFR parts 15 and 1520.



08-23-2024

10.4 MESSAGE SCHEDULE - GARAGE C: LEVEL 7 - SECTOR 2 (C CENTRAL)

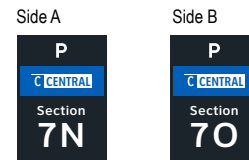
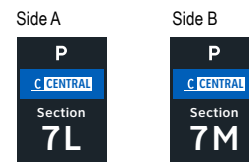
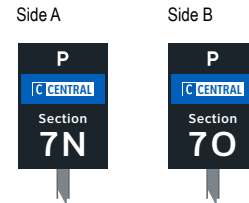
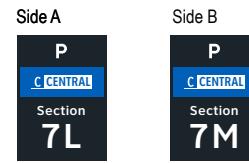
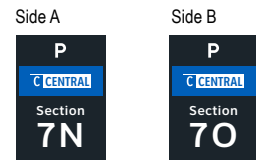
THESE SHEETS ARE ISSUED FOR GRAPHICAL INFORMATION ONLY

BSG PRJCT# BSG-2024-111-IAH
HAS TIP # 24 -103 - IAH


NOT USED

NOT USED


NOT USED



Side A

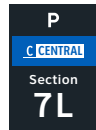

Side B

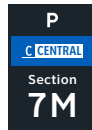

NOT USED

ELEVATOR CORE SIGNAGE CONTINUED ON NEXT SHEET



GEORGE BUSH INTERCONTINENTAL AIRPORT  
Wayfinding Signage Design Intent Documents  
C Garage



Louisville, Colorado  
P: 303.494.7849  
www.labozan.com

These documents are intended to illustrate design intent, and should only be used as a general guideline. No information contained here should be construed as engineered elements. The fabricator/contractor shall be responsible for all engineering and specifications with regard to structural, electrical, mechanical, foundation and installation. Information and illustrations contained here are part of an original unpublished design by Labozan Associates, Inc. Detailing and information contained on these pages shall not be reproduced, copied or utilized in any way except for the specific project for which they were created without previous written authorization from Labozan Associates, Inc.

**Wayfinding Updates**

Issue Date: 08-23-2024  
Issue for Bid

- REV.
- REV.
- REV.

**WARNING:**

This record contains Sensitive Security Information that is controlled under 49 CFR parts 15 and 1520. No part of this record may be disclosed to persons with a "need to know," as defined in 49 CFR parts 15 and 1520, except with the written permission of the Administrator of the Transportation Security Administration or the Secretary of Transportation. Unauthorized release may result in civil penalty or other action. For U.S. government agencies, public disclosure is governed by 5 U.S.C. 552 and 49 CFR parts 15 and 1520.



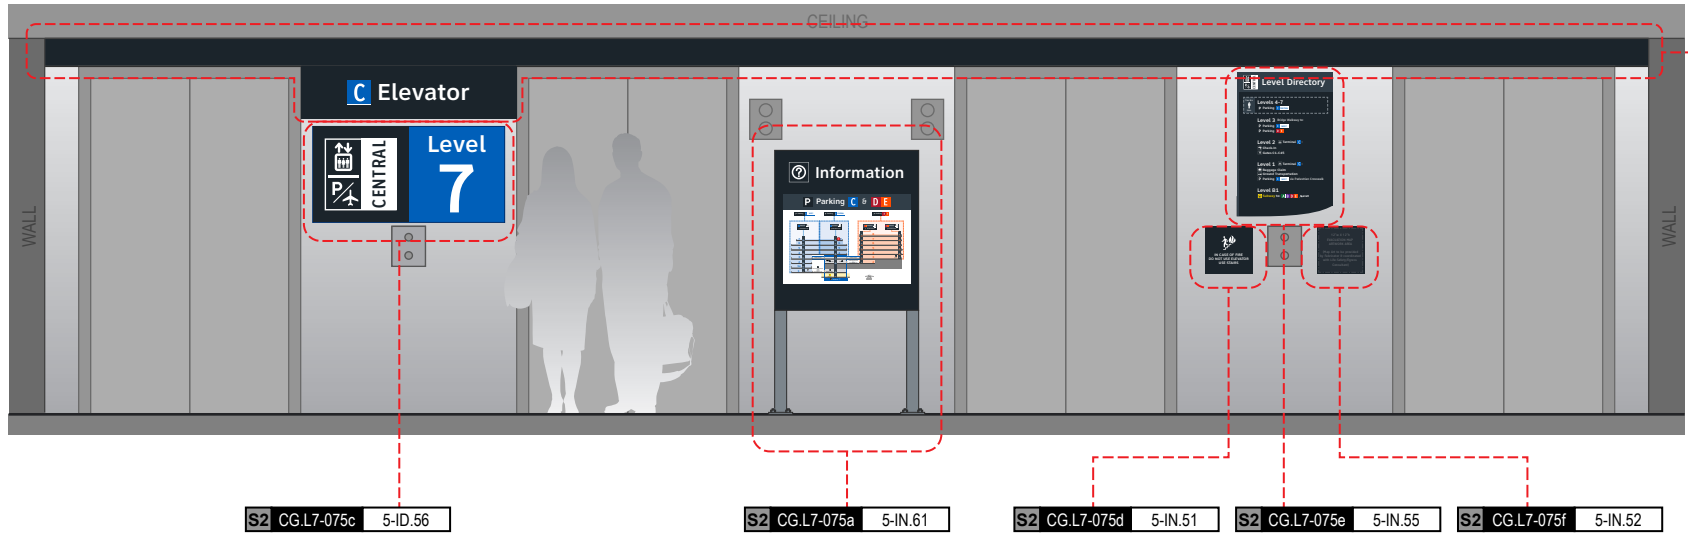
08-23-2024

**10.4 MESSAGE SCHEDULE - GARAGE C: LEVEL 7 - SECTOR 2 (C CENTRAL)**

THESE SHEETS ARE ISSUED FOR GRAPHICAL INFORMATION ONLY

BSG PRJCT# BSG-2024-111-IAH  
HAS TIP # 24 -103 - IAH

Side A




NOTES: Directory artwork includes a "You Are Here" button graphic and is in a unique location per elevator core/level location; artwork included here is representative of final map artwork design intent for this location


NOTES: Level directory plaque includes a "You Are Here" graphic and is in a unique location per elevator core/level location; artwork included here is representative of final artwork design intent for this location

S2 CG.L7-075b 5-ID.57  
 NOTES: Wall paint and header graphics at front elevation only of elevator core included for this location number; wall elevation conditions shown are artistic representation based on rough site photo surveys; actual wall elevation conditions to be field verified by contractor/installer

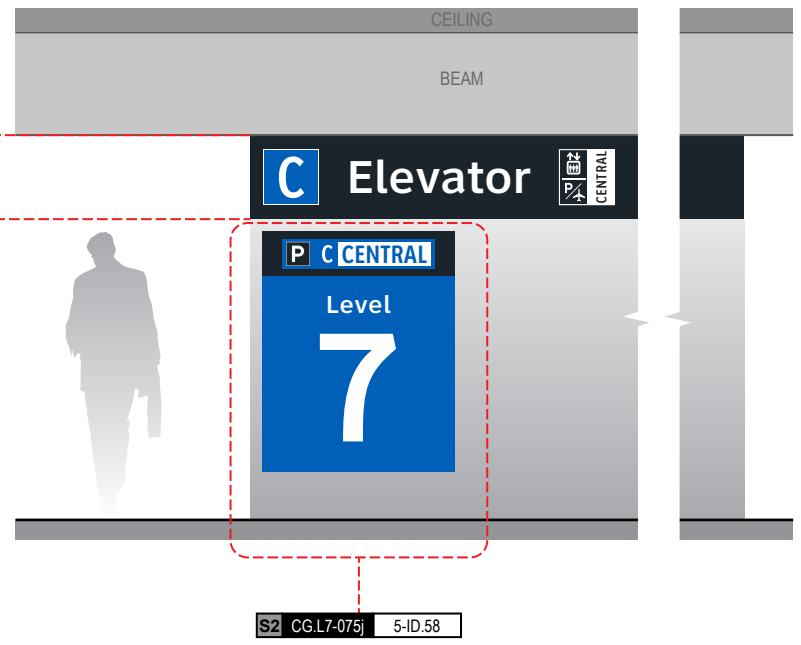Side C




Side B

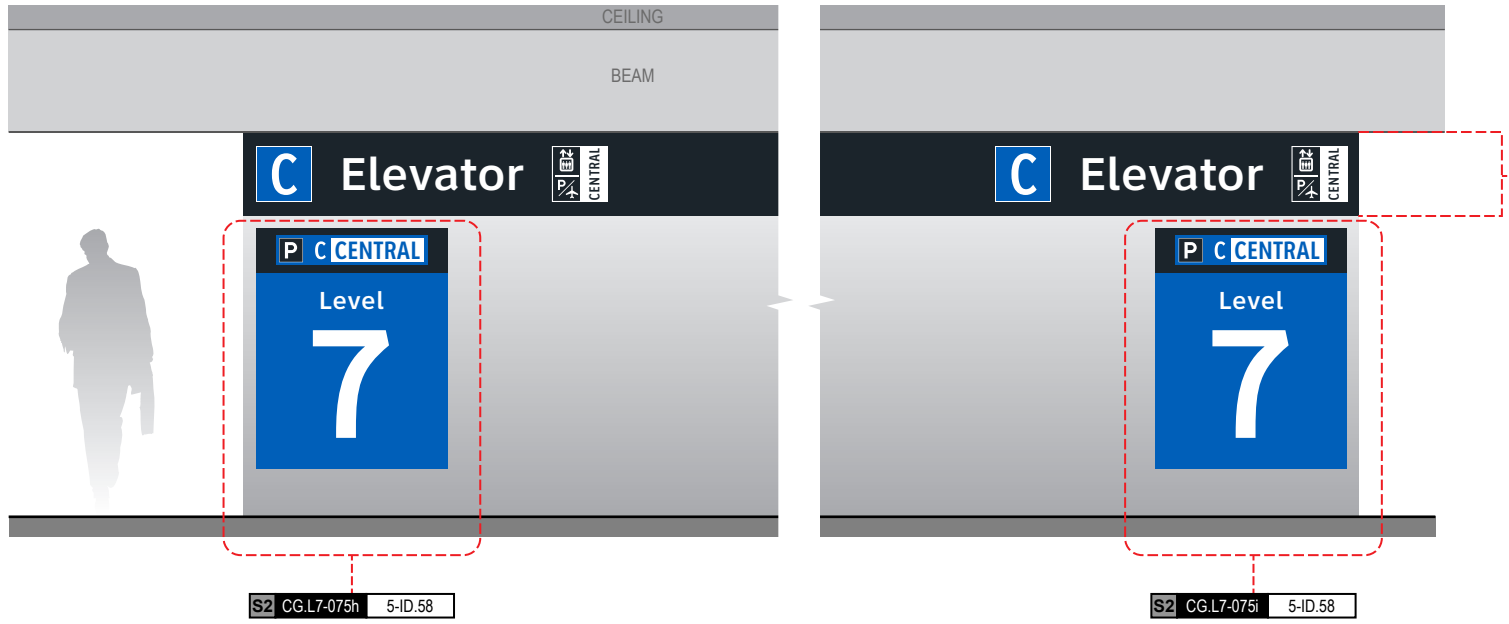


S2 CG.L7-075g 5-ID.59  
 NOTES: Wall paint and header graphics on rear and two side elevations of elevator core included for this location number; wall elevation conditions shown are artistic representation based on rough site photo surveys; actual wall elevation conditions to be field verified by contractor/installer

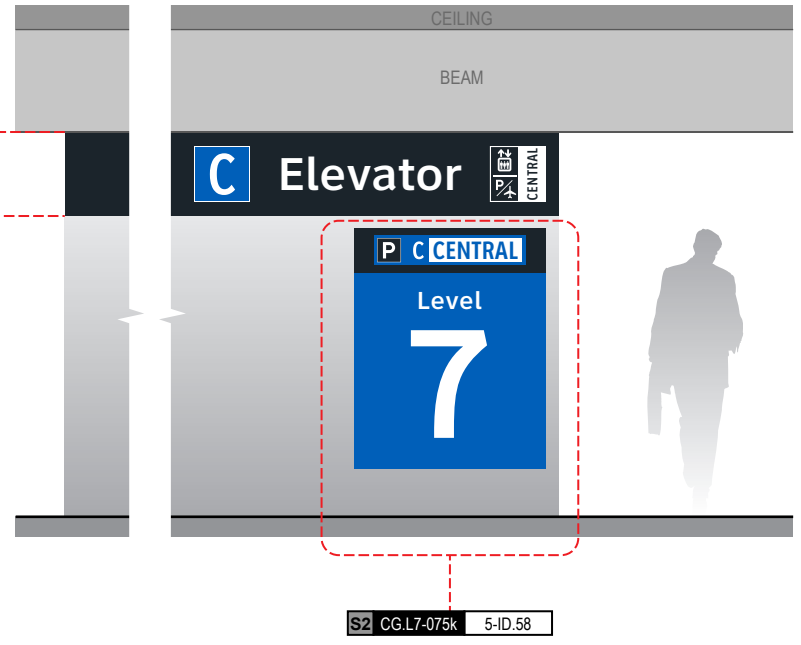Side D



## END OF GARAGE C: LEVEL 7 - SECTOR 2 MESSAGES

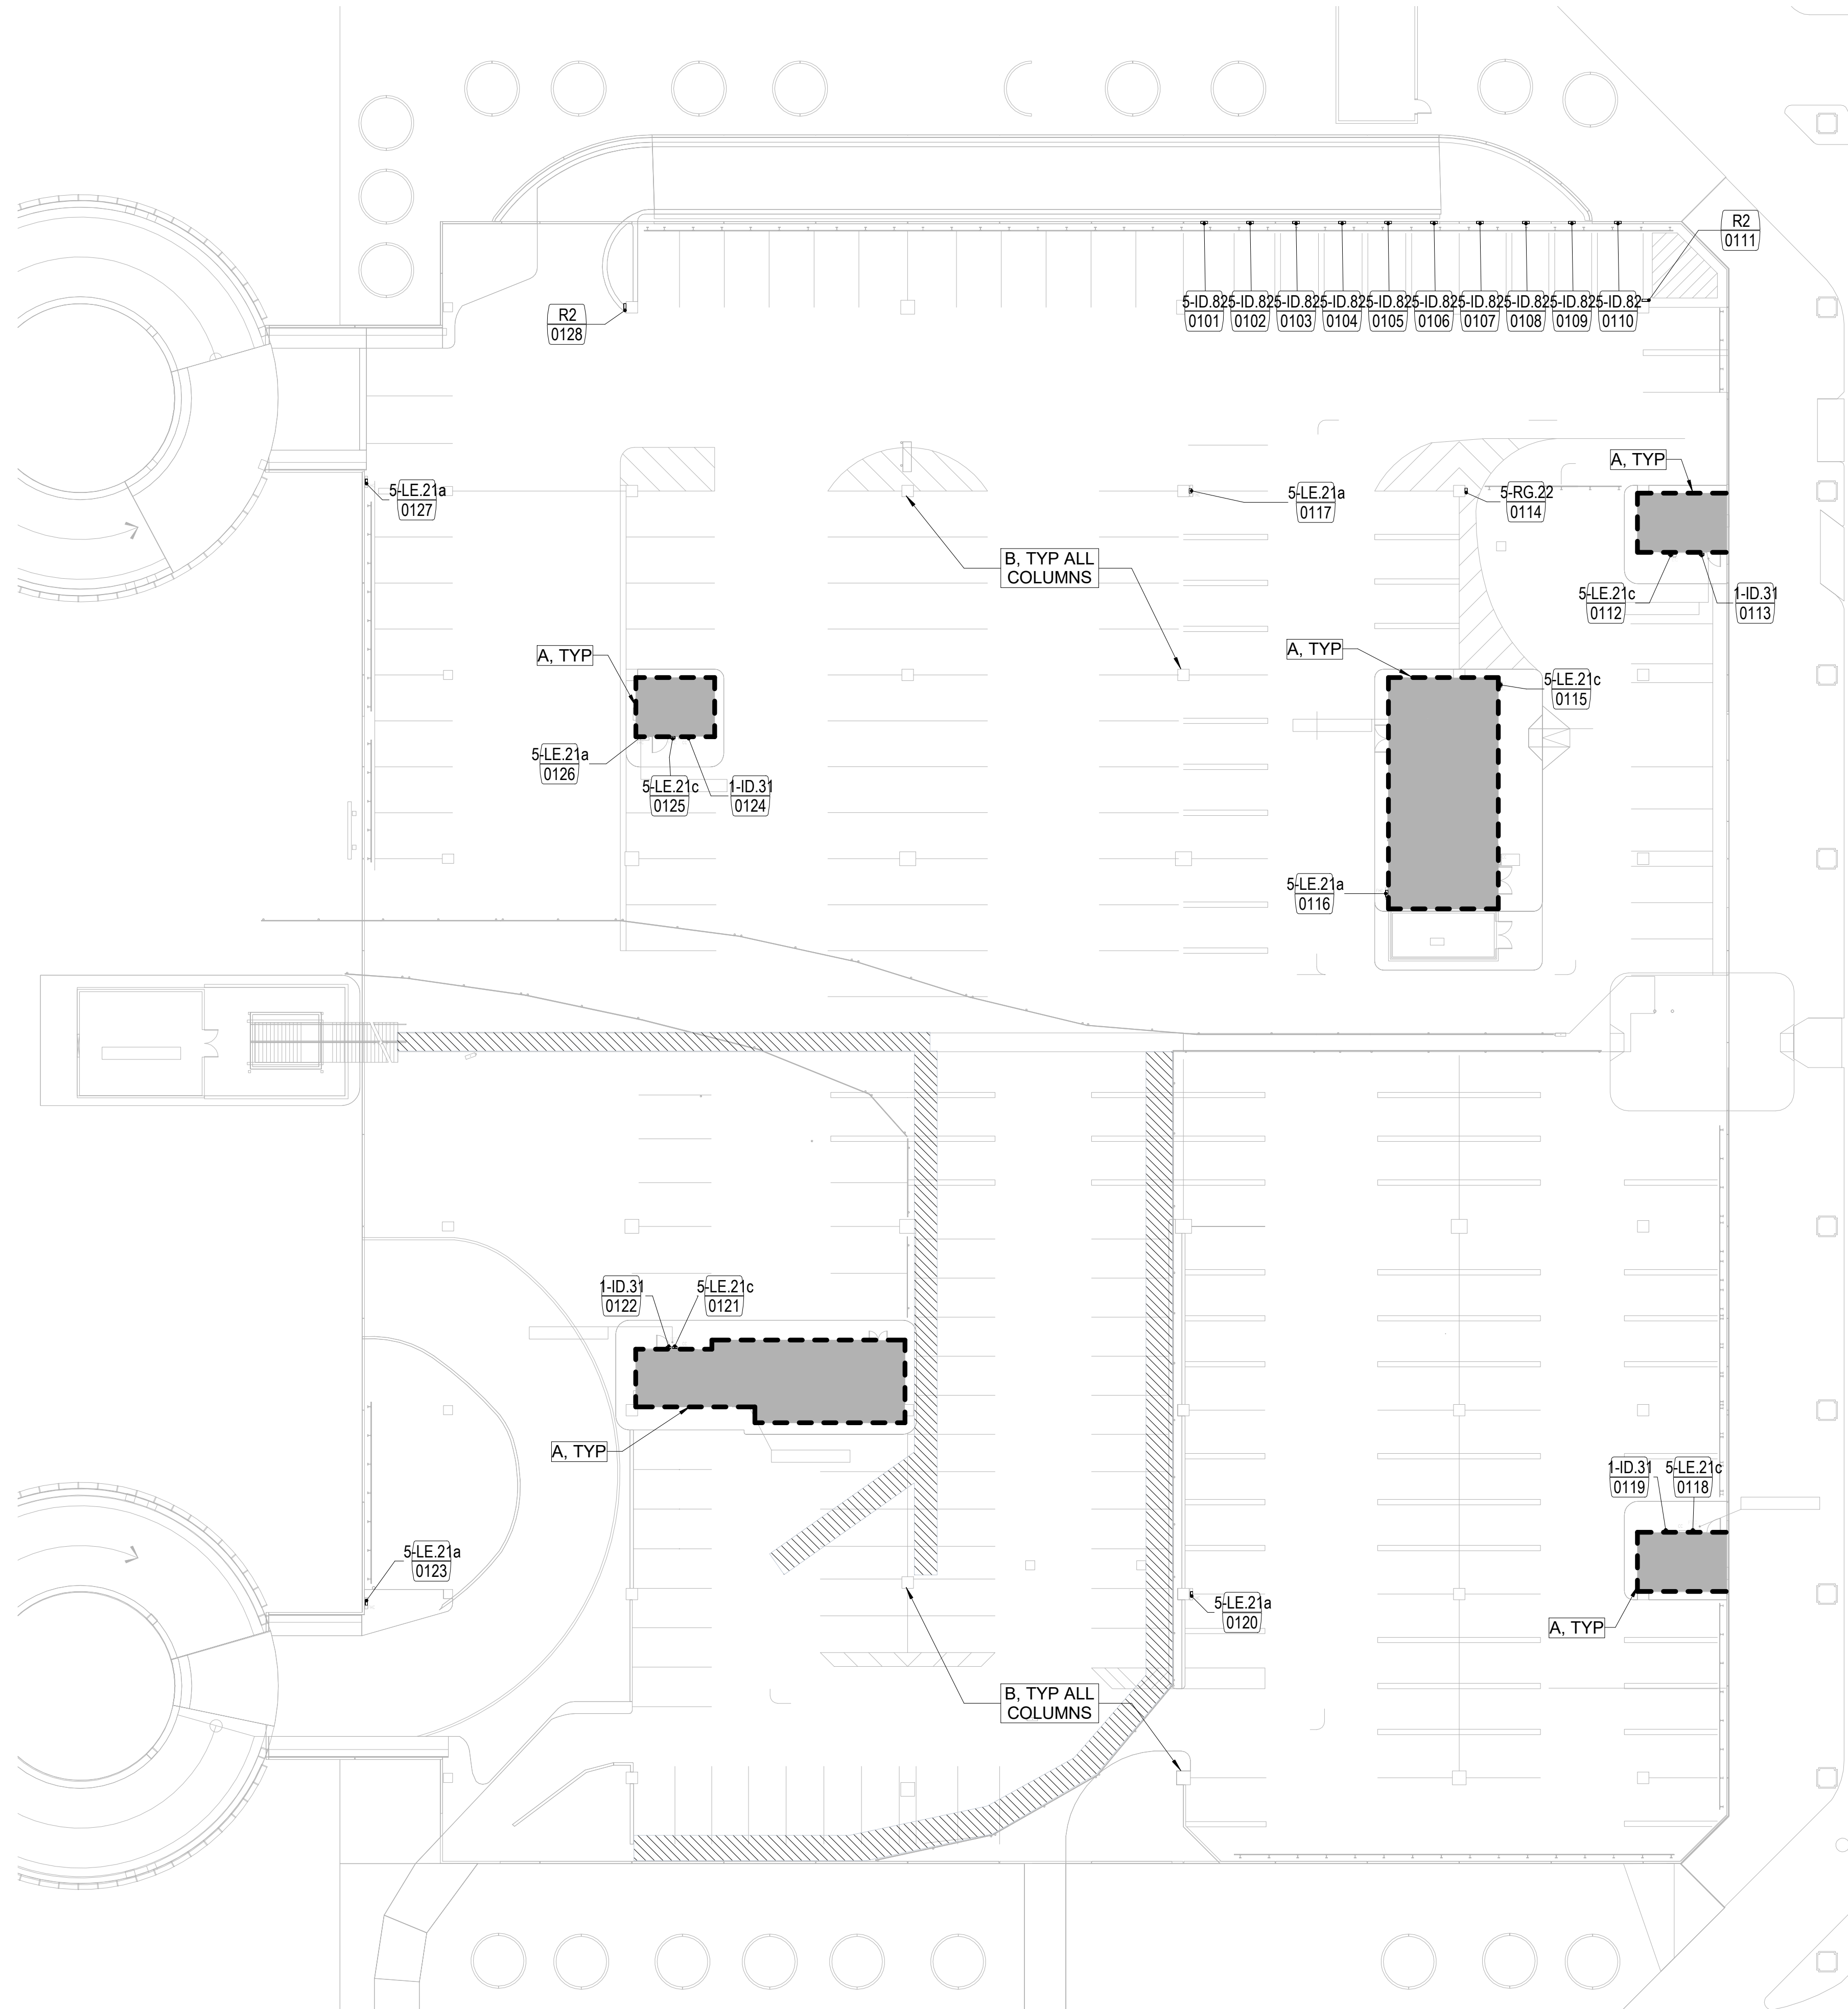FILE NAME: C:\Revit\Locals\TERM C SIGNAGE GARAGE\_DBhatti@pgal.com.rvt  
 DATE/TIME: 4/8/2024 4:39:24 PM



\*\* 48 +/- COLUMNS TO BE PAINTED IN THIS SECTOR, V.I.F.

**SIGNAGE SCHEDULE - LEVEL 01 - SECTOR A**

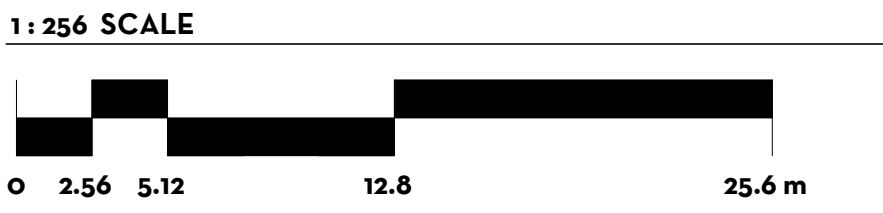
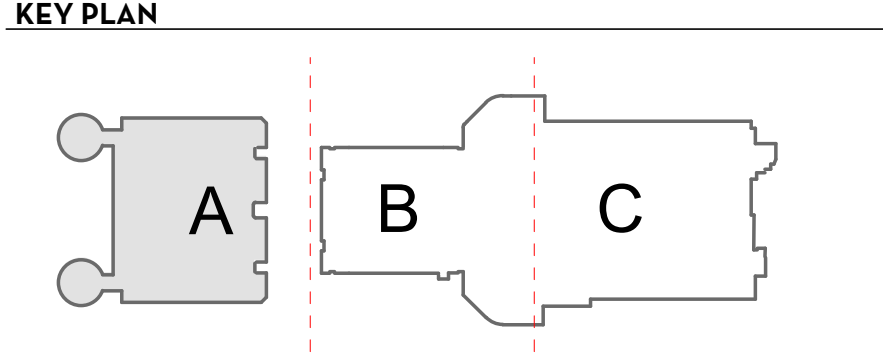
SIGN NUMBER	SIGN TYPE	HAS SYMBOL	TEXT LINE 1	TEXT LINE 2	TEXT LINE 3	REFERENCE PLAN
0101	5-ID.82		HPD	PARKING		2-36
0102	5-ID.82		DIRECTOR'S	PARKING		2-36
0103	5-ID.82		DIRECTOR'S	PARKING		2-36
0104	5-ID.82		DIRECTOR'S	PARKING		2-36
0105	5-ID.82		USO	PARKING		2-36
0106	5-ID.82		USO	PARKING		2-36
0107	5-ID.82		USO	PARKING		2-36
0108	5-ID.82		USO	PARKING		2-36
0109	5-ID.82		USO	PARKING		2-36
0110	5-ID.82		VENDOR	PARKING	ONLY	2-36
0111	R2					AG3.000
0112	5-LE.21c	FIRE EXTINGUISHER				2-37
0113	1-ID.31	STAIR	STAIR 8	LEVEL 1	NO RE-ENTRY	2-30
0114	5-RG.22			COURTESY		2-38
0115	5-LE.21c	FIRE EXTINGUISHER				2-37
0116	5-LE.21a	FIRE HOSE REEL				2-37
0117	5-LE.21a	FIRE HOSE REEL				2-37
0118	5-LE.21c	FIRE EXTINGUISHER				2-37
0119	1-ID.31	STAIR	STAIR 9	LEVEL 1	NO RE-ENTRY	2-30
0120	5-LE.21a	FIRE HOSE REEL				2-37
0121	5-LE.21c	FIRE EXTINGUISHER				2-37
0122	1-ID.31	STAIR	STAIR 11	LEVEL 1	NO RE-ENTRY	2-30
0123	5-LE.21a	FIRE HOSE REEL				2-37
0124	1-ID.31	STAIR	STAIR 10	LEVEL 1	NO RE-ENTRY	2-30
0125	5-LE.21c	FIRE EXTINGUISHER				2-37
0126	5-LE.21a	FIRE HOSE REEL				2-37
0127	5-LE.21a	FIRE HOSE REEL				2-37
0128	R2					AG3.000

**FLOOR PLAN KEYNOTES**

- A SKIM COAT WITH SIKA QUICK SMOOTH FINISH AT EXTERIOR WALL PERIMETER AT ELEVATOR AND STAIR CORES. TO BE PRIMED AND PAINTED.
- B SKIM COAT WITH SIKA QUICK SMOOTH FINISH AT ALL GARAGE COLUMNS ONLY. TO BE PRIMED AND PAINTED. REFER TO \*\* IN REGARDS TO APPROXIMATE COLUMN QUANTITY.

**GENERAL NOTES**

1. REFER TO SHEETS 1-1 THROUGH 10-24 FOR ADDITIONAL INFORMATION, INCLUDING NEW SIGN LOCATIONS, SIGN TYPES, AND MOUNTING DETAILS
2. REFER TO SHEET AG3.000 FOR ADDITIONAL SIGN TYPES
3. REFER TO SHEET 1-17 FOR HAS WAYFINDING SYMBOLS



CLIENT  
  
 Client Name

ARCHITECT  
  
 PGAL  
 3131 BRIARPARK DR. SUITE 200  
 HOUSTON, TX 77042  
 [T] 713 622 1444  
 [F] 713 968 9333  
 www.pgal.com


BSG PRJCT#  
 BSG-2024-111-IAH  
 DEPARTMENT OF AVIATION  
 RECOMMENDED:  
 HOUSTON AIRPORT SYSTEM  
 DIRECTOR OR DESIGN REPRESENTATIVE  
 HAS TIP # 24-103 - IAH

REGISTRATION  
 Copyright © 2024

**DRAWING HISTORY**

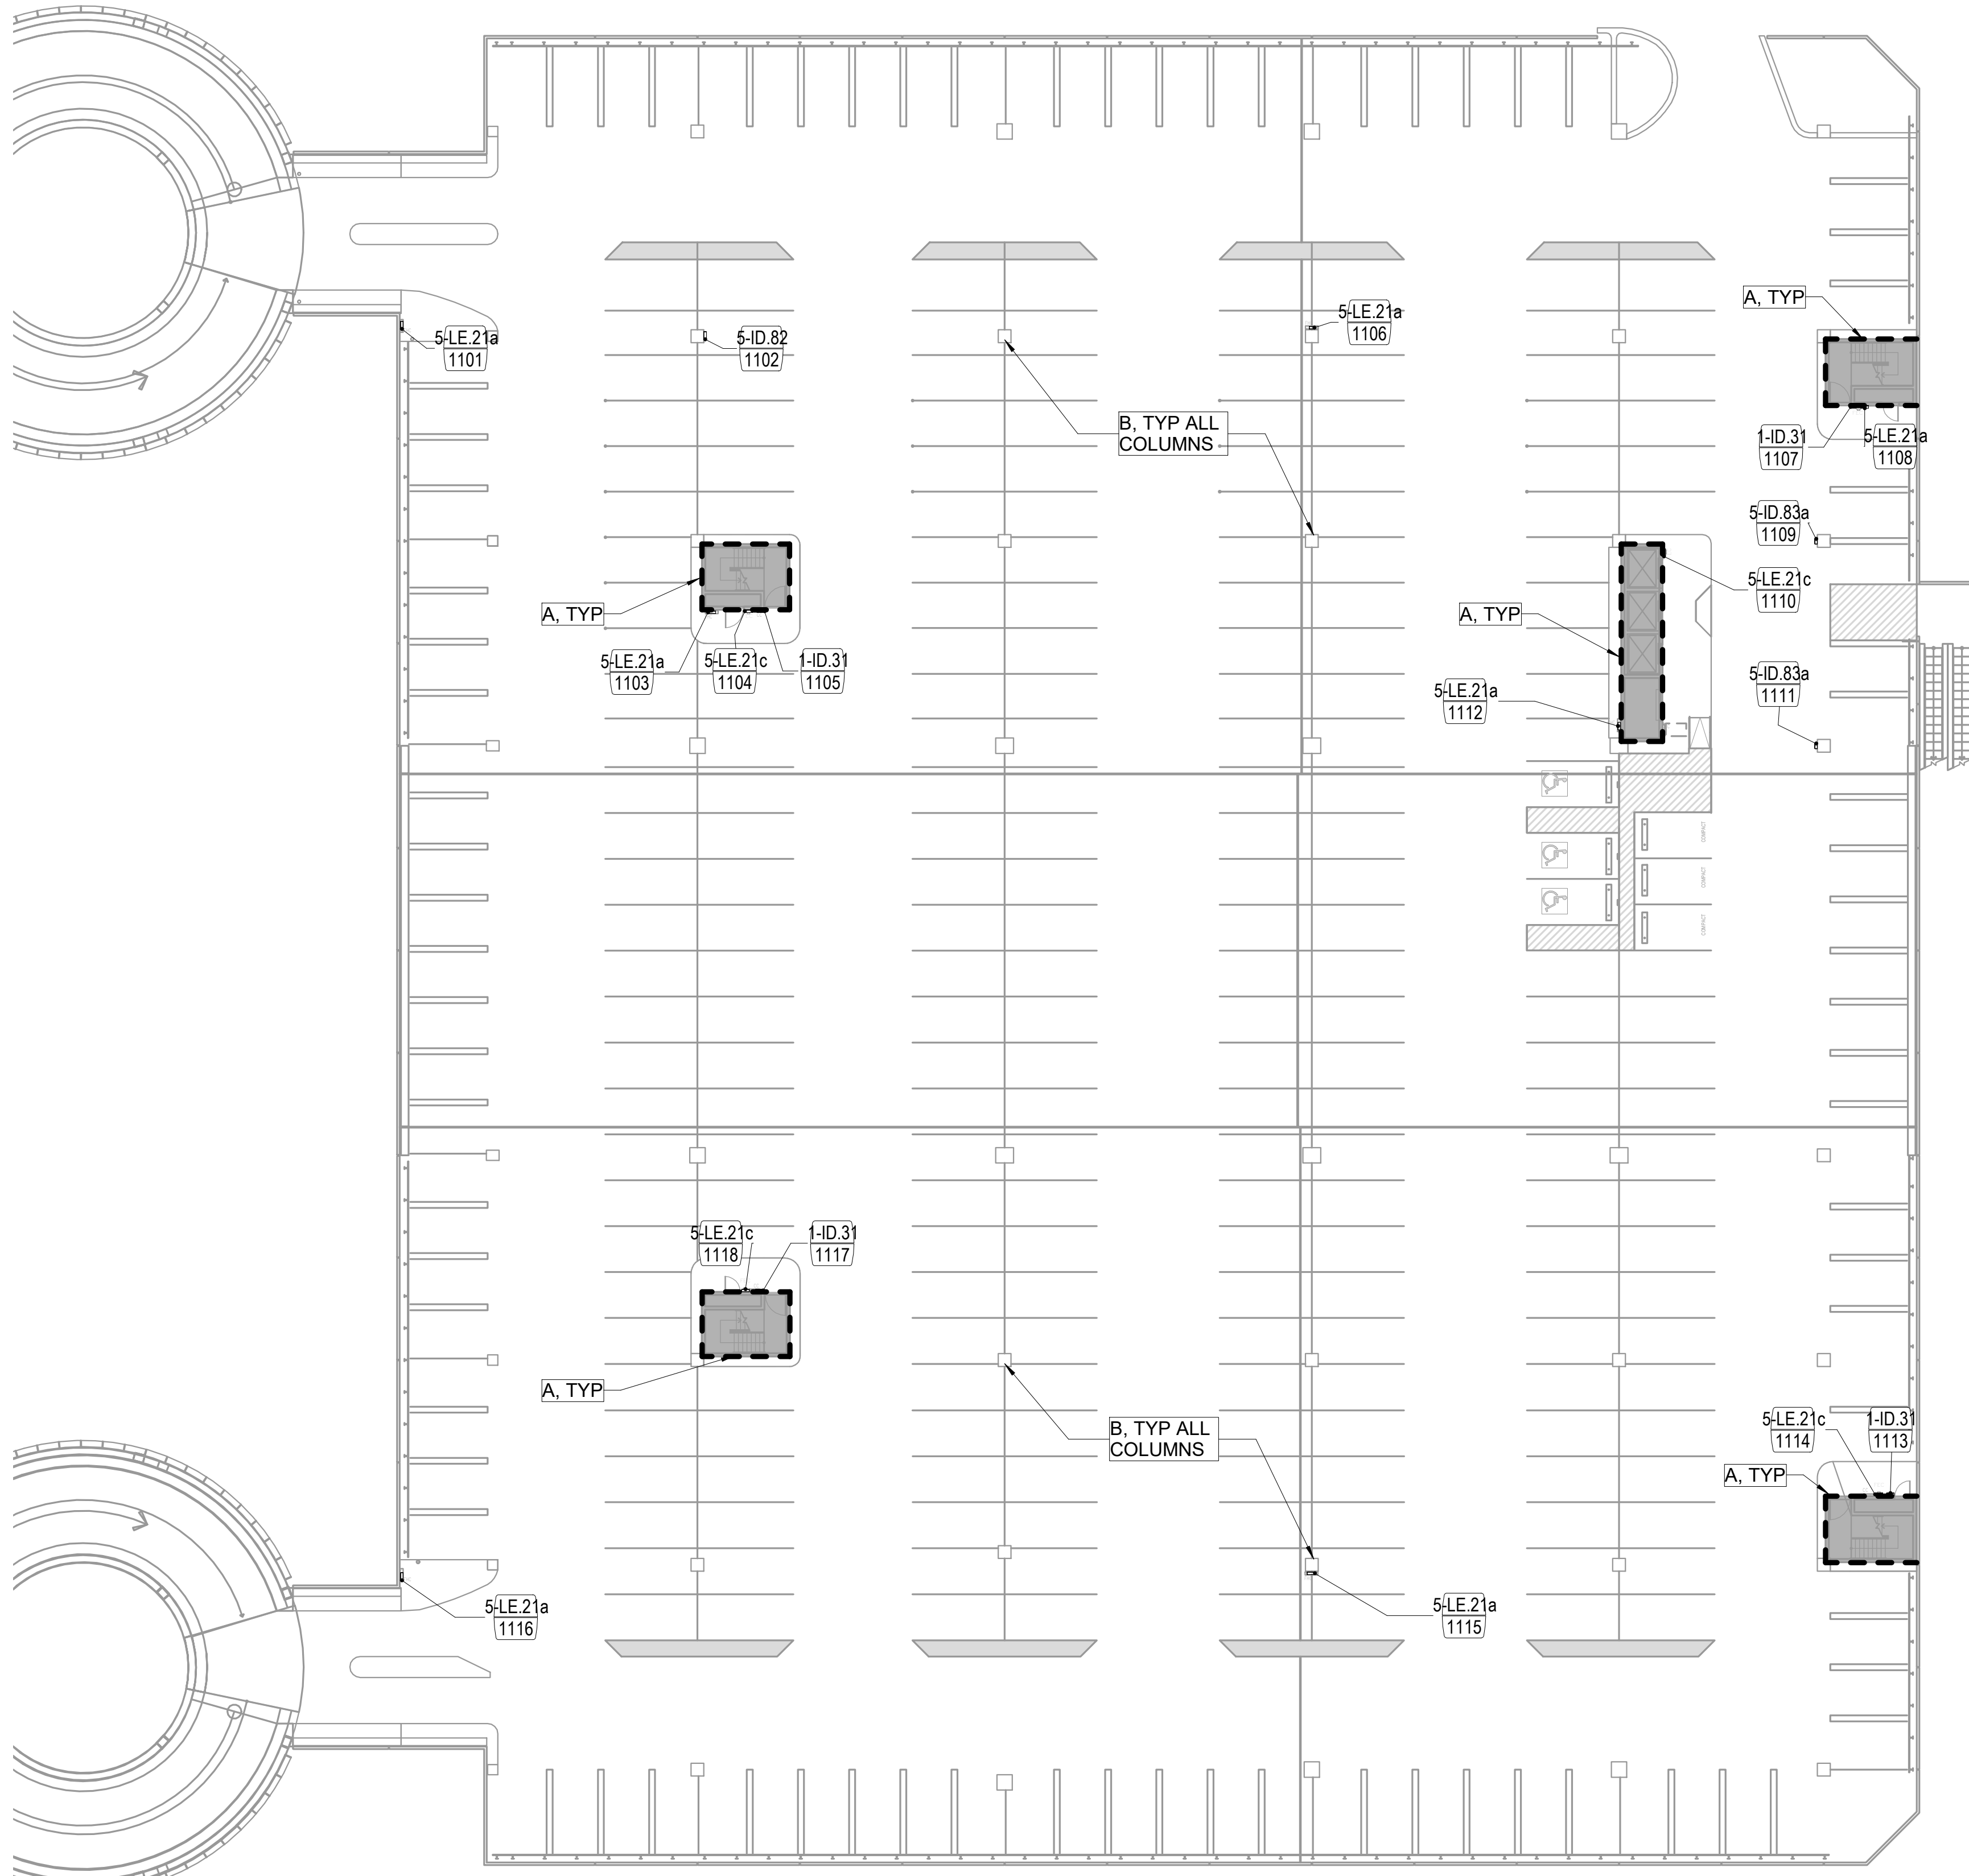NO.	DATE	DESCRIPTION
01	04/10/2024	ISSUE FOR PERMIT
02	08/23/2024	ISSUE FOR BID

PROJECT NAME  
 IAH TERMINAL C GARAGE SIGNAGE & WAYFINDING  
 PROJECT LOCATION  
 TERMINAL C  
 3500 NORTH TERMINAL RD.  
 HOUSTON, TX 77032  
 PROJECT NUMBER  
 1004395  
 SHEET TITLE  
 LEVEL 01 FLOOR PLAN  
 SHEET NUMBER  
**A2.00A**



SIGNAGE SCHEDULE - LEVEL 01A - SECTOR A						
SIGN NUMBER	SIGN TYPE	HAS SYMBOL	TEXT LINE 1	TEXT LINE 2	TEXT LINE 3	REFERENCE PLAN
1101	5-LE.21a	FIRE HOSE REEL				2-37
1102	5-ID.82		COURTESY	SHUTTLES	ONLY	2-36
1103	5-LE.21a	FIRE HOSE REEL				2-37
1104	5-LE.21c	FIRE EXTINGUISHER				2-37
1105	1-ID.31	STAIR	STAIR 10	LEVEL 1A	NO RE-ENTRY	2-30
1106	5-LE.21a	FIRE HOSE REEL				2-37
1107	1-ID.31	STAIR	STAIR 8	LEVEL 1A	NO RE-ENTRY	2-30
1108	5-LE.21a	FIRE HOSE REEL				2-37
1109	5-ID.83a					2-36
1110	5-LE.21c	FIRE EXTINGUISHER				2-37
1111	5-ID.83a					2-36
1112	5-LE.21a	FIRE HOSE REEL				2-37
1113	1-ID.31	STAIR	STAIR 9	LEVEL 1A	NO RE-ENTRY	2-30
1114	5-LE.21c	FIRE EXTINGUISHER				2-37
1115	5-LE.21a	FIRE HOSE REEL				2-37
1116	5-LE.21a	FIRE HOSE REEL				2-37
1117	1-ID.31	STAIR	STAIR 11	LEVEL 1A	NO RE-ENTRY	2-30
1118	5-LE.21c	FIRE EXTINGUISHER				2-37



Client Name

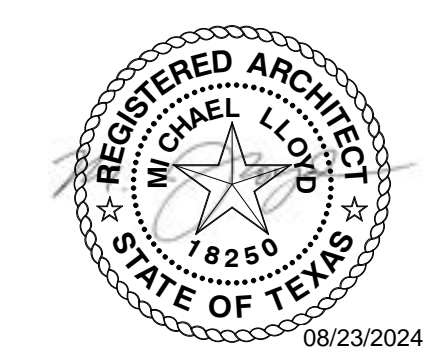


PGAL  
3131 BRIARPARK DR.  
SUITE 200  
HOUSTON, TX 77042  
[T] 713 622 1444  
[F] 713 968 9333  
www.pgal.com

BSG PRJCT#  
BSG-2024-111-IAH

DEPARTMENT OF AVIATION  
RECOMMENDED:  
HOUSTON AIRPORT SYSTEM  
DIRECTOR OR DESIGN REPRESENTATIVE  
HAS TIP # 24-103 - IAH

REGISTRATION  
Copyright © 2024



DRAWING HISTORY		
NO.	DATE	DESCRIPTION
01	04/10/2024	ISSUE FOR PERMIT
02	08/23/2024	ISSUE FOR BID

PROJECT NAME  
IAH TERMINAL C  
GARAGE  
SIGNAGE &  
WAYFINDING

PROJECT LOCATION  
TERMINAL C  
3500 NORTH  
TERMINAL RD.  
HOUSTON, TX 77032

PROJECT NUMBER  
1004395

SHEET TITLE  
LEVEL 01A FLOOR  
PLAN

SHEET NUMBER

A2.01A


### FLOOR PLAN KEYNOTES

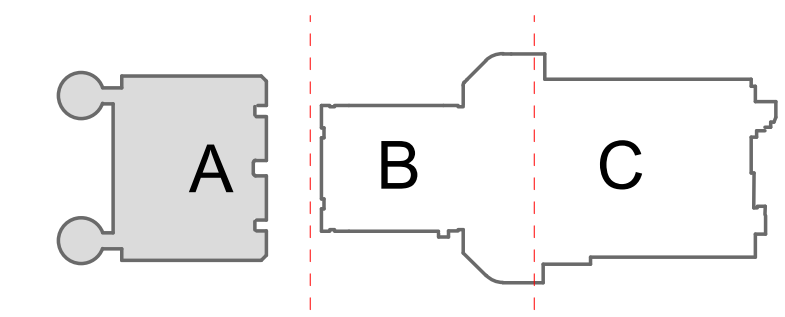- A SKIM COAT WITH SIKA QUICK SMOOTH FINISH AT EXTERIOR WALL PERIMETER AT ELEVATOR AND STAIR CORES. TO BE PRIMED AND PAINTED.
- B SKIM COAT WITH SIKA QUICK SMOOTH FINISH AT ALL GARAGE COLUMNS ONLY. TO BE PRIMED AND PAINTED. REFER TO \*\* IN REGARDS TO APPROXIMATE COLUMN QUANTITY.


### GENERAL NOTES

- REFER TO SHEETS 1-1 THROUGH 10-24 FOR ADDITIONAL INFORMATION, INCLUDING NEW SIGN LOCATIONS, SIGN TYPES, AND MOUNTING DETAILS
- REFER TO SHEET AG3.000 FOR ADDITIONAL SIGN TYPES
- REFER TO SHEET 1-17 FOR HAS WAYFINDING SYMBOLS


#### KEY PLAN




#### LEGEND

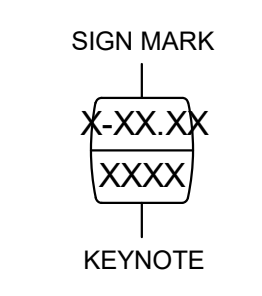

1: 25.6 SCALE

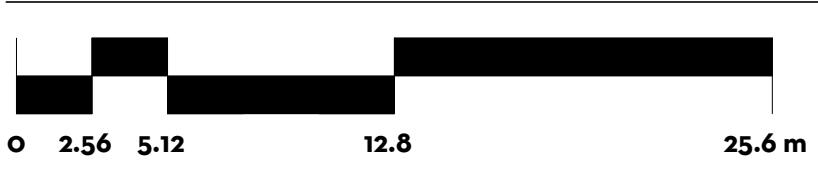

#### PLAN NORTH

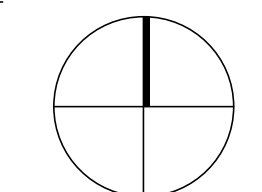


\*\* 48 +/- COLUMNS TO BE PAINTED IN THIS SECTOR, V.I.F.

### LEVEL 01A - FLOOR PLAN 3/64" = 1'-0" 1

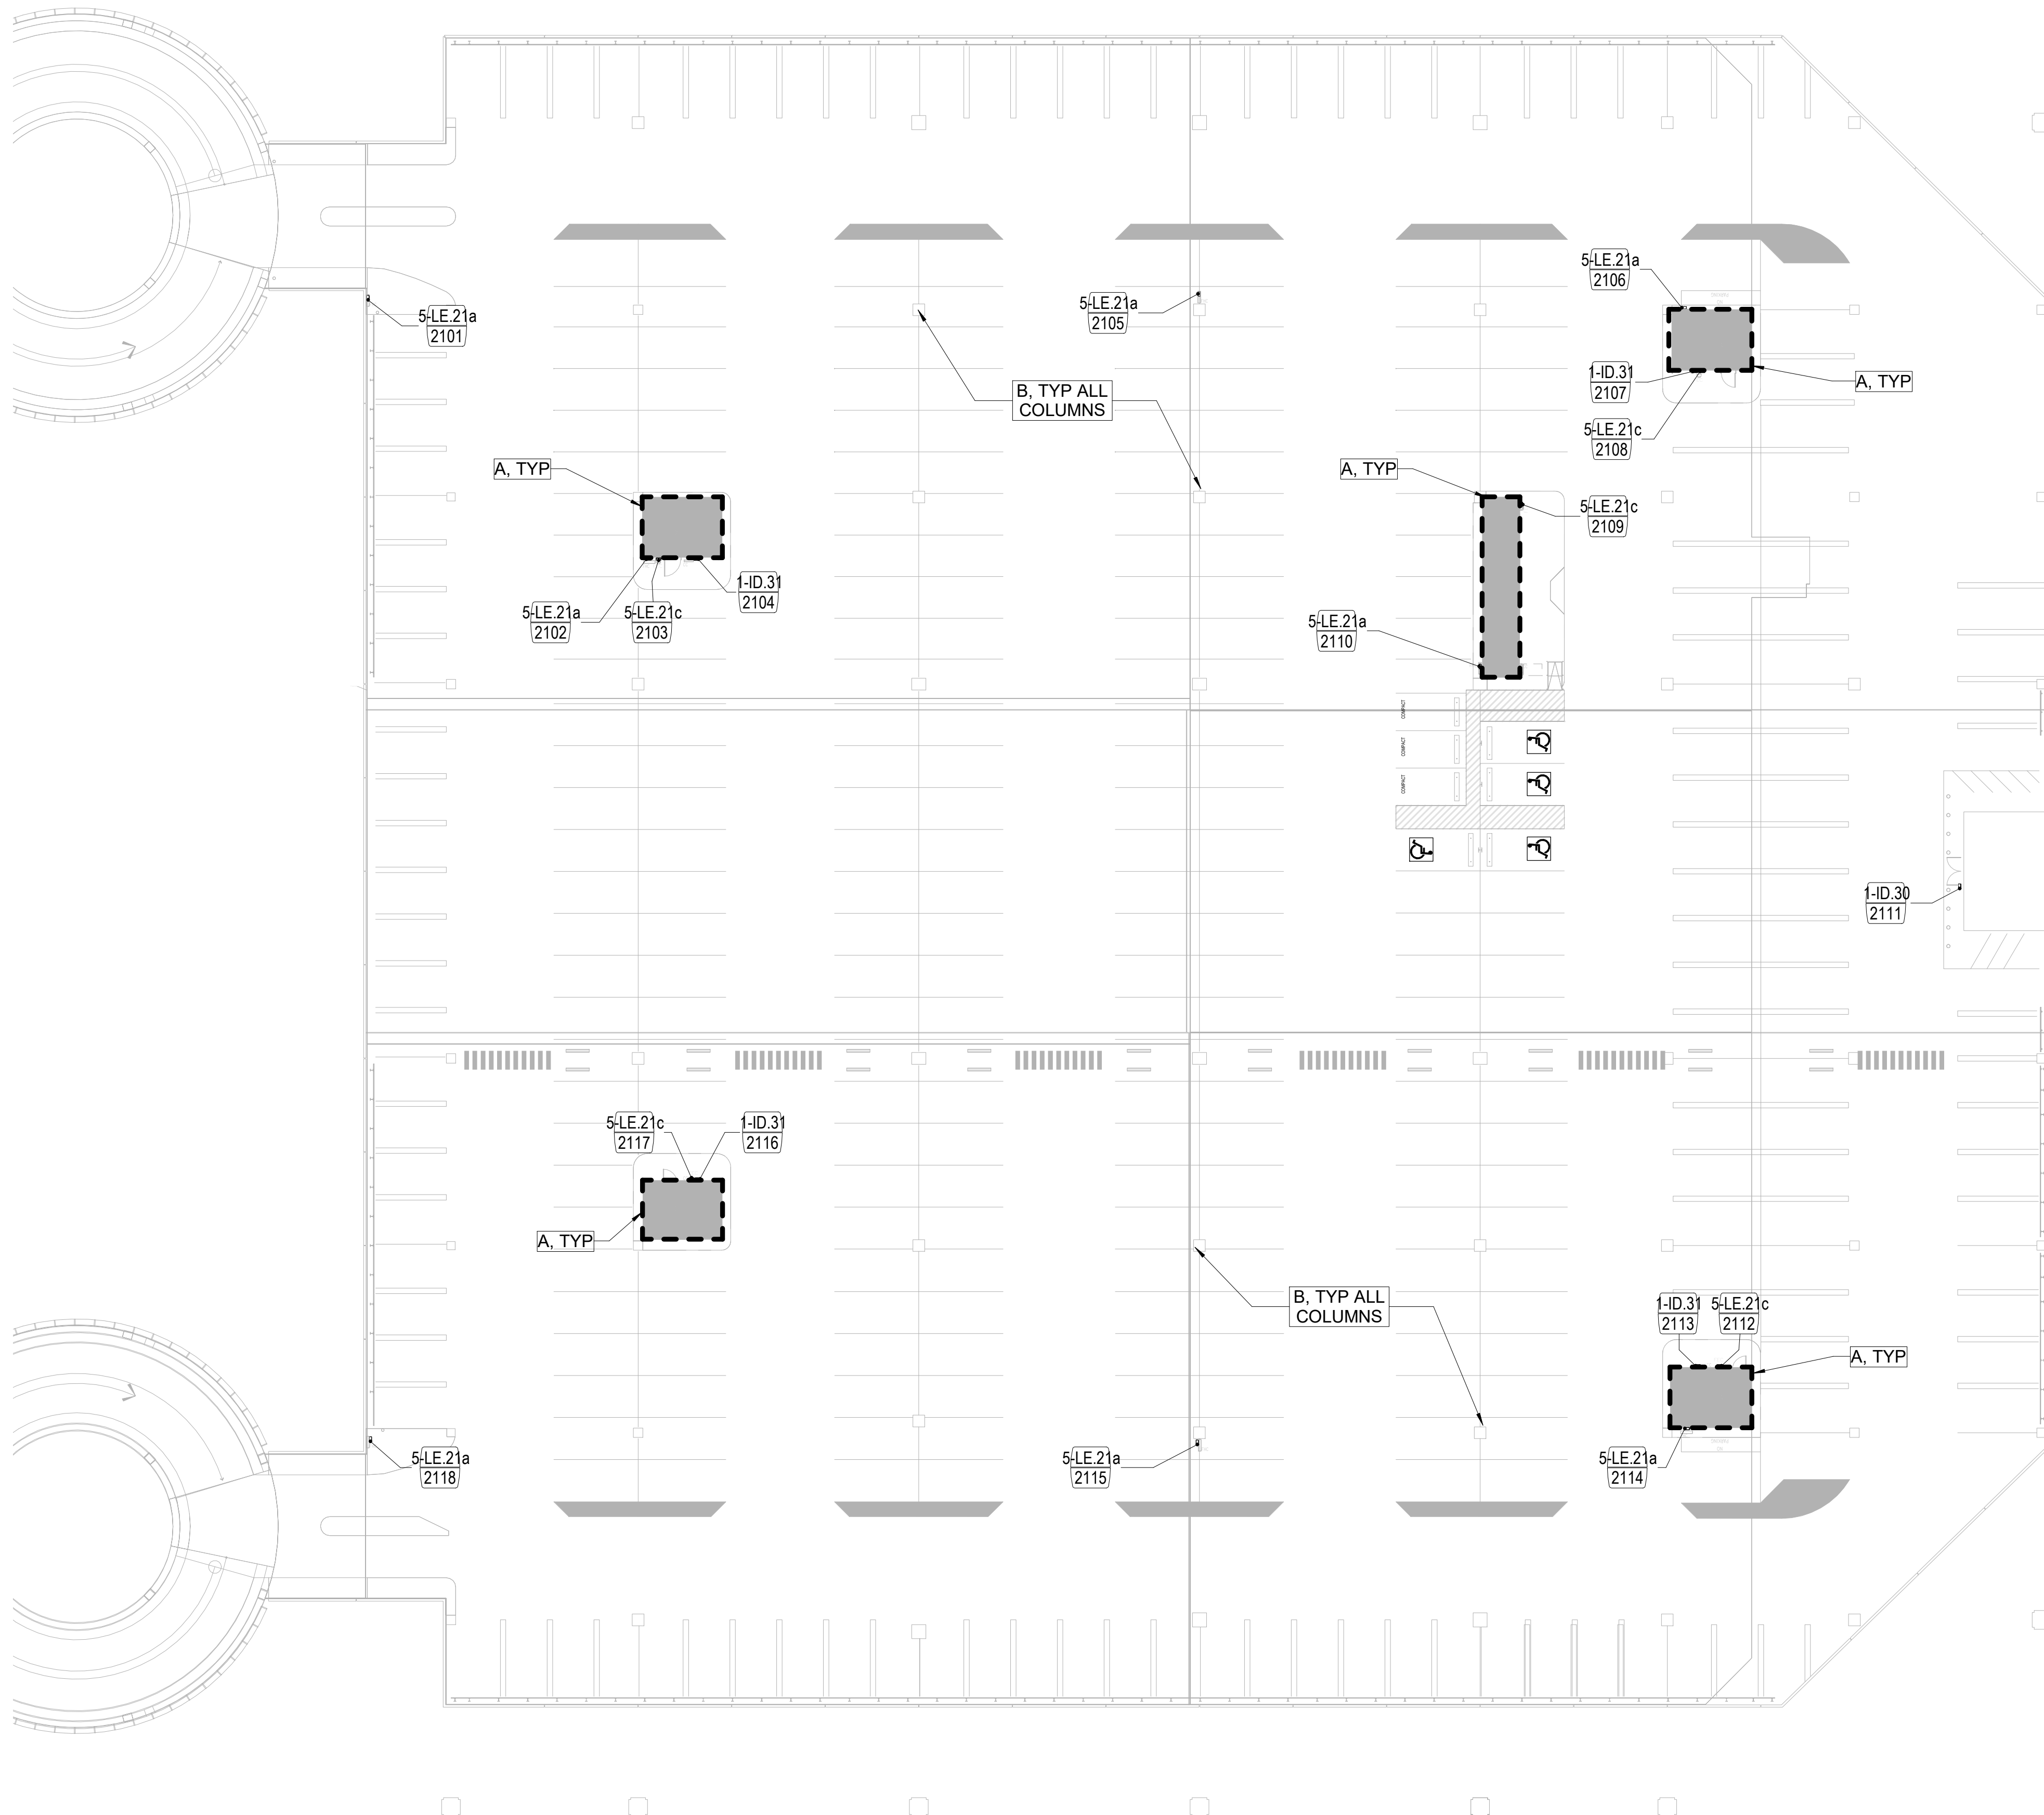FILE NAME: C:\Revit\Locals\TERM C SIGNAGE GARAGE\_DBhatti@pgal.com.rvt  
DATE/TIME: 8/23/2024 4:39:25 PM





SIGNAGE SCHEDULE - LEVEL 02 - SECTOR A						
SIGN NUMBER	SIGN TYPE	HAS SYMBOL	TEXT LINE 1	TEXT LINE 2	TEXT LINE 3	REFERENCE PLAN
2101	5-LE.21a	FIRE HOSE REEL				2-37
2102	5-LE.21a	FIRE HOSE REEL				2-37
2103	5-LE.21c	FIRE EXTINGUISHER				2-37
2104	1-ID.31	STAIR	STAIR 10	LEVEL 2	NO RE-ENTRY	2-30
2105	5-LE.21a	FIRE HOSE REEL				2-37
2106	5-LE.21a	FIRE HOSE REEL				2-37
2107	1-ID.31	STAIR	STAIR 8	LEVEL 2	NO RE-ENTRY	2-30
2108	5-LE.21c	FIRE EXTINGUISHER				2-37
2109	5-LE.21c	FIRE EXTINGUISHER				2-37
2110	5-LE.21a	FIRE HOSE REEL				2-37
2111	1-ID.30					2-29
2112	5-LE.21c	FIRE EXTINGUISHER				2-37
2113	1-ID.31	STAIR	STAIR 9	LEVEL 2	NO RE-ENTRY	2-30
2114	5-LE.21a	FIRE HOSE REEL				2-37
2115	5-LE.21a	FIRE HOSE REEL				2-37
2116	1-ID.31	STAIR	STAIR 11	LEVEL 2	NO RE-ENTRY	2-30
2117	5-LE.21c	FIRE EXTINGUISHER				2-37
2118	5-LE.21a	FIRE HOSE REEL				2-37



Client Name

ARCHITECT



PGAL  
3131 BRIARPARK DR.  
SUITE 200  
HOUSTON, TX 77042  
[T] 713 622 1444  
[F] 713 968 9333  
www.pgal.com

BSG PRJCT#  
BSG-2024-111-IAH

DEPARTMENT OF AVIATION  
RECOMMENDED:  
HOUSTON AIRPORT SYSTEM  
DIRECTOR OR DESIGN REPRESENTATIVE  
HAS TIP # 24-103 - IAH

REGISTRATION  
Copyright © 2024



DRAWING HISTORY

NO.	DATE	DESCRIPTION
01	04/10/2024	ISSUE FOR PERMIT
02	08/23/2024	ISSUE FOR BID

PROJECT NAME  
IAH TERMINAL C  
GARAGE  
SIGNAGE &  
WAYFINDING

PROJECT LOCATION  
TERMINAL C  
3500 NORTH  
TERMINAL RD.  
HOUSTON, TX 77032

PROJECT NUMBER  
1004395

SHEET TITLE  
LEVEL 02A FLOOR  
PLAN

SHEET NUMBER



A2.02A

### FLOOR PLAN KEYNOTES

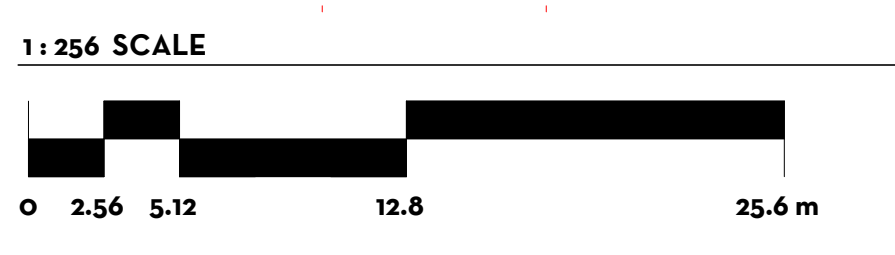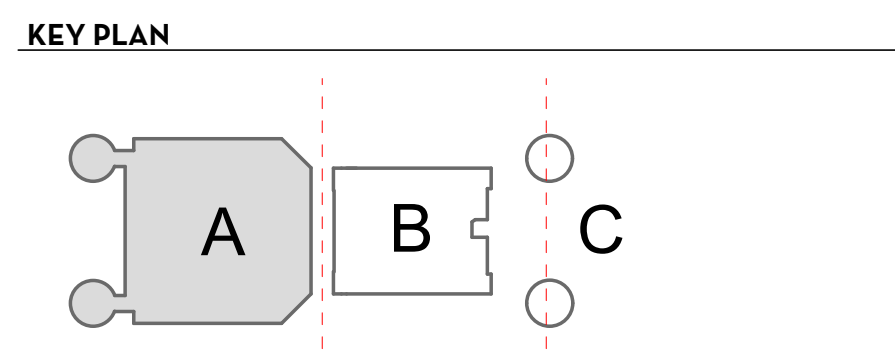- A SKIM COAT WITH SIKA QUICK SMOOTH FINISH AT EXTERIOR WALL PERIMETER AT ELEVATOR AND STAIR CORES. TO BE PRIMED AND PAINTED.
- B SKIM COAT WITH SIKA QUICK SMOOTH FINISH AT ALL GARAGE COLUMNS ONLY. TO BE PRIMED AND PAINTED. REFER TO \*\* IN REGARDS TO APPROXIMATE COLUMN QUANTITY.

### GENERAL NOTES

- REFER TO SHEETS 1-1 THROUGH 10-24 FOR ADDITIONAL INFORMATION, INCLUDING NEW SIGN LOCATIONS, SIGN TYPES, AND MOUNTING DETAILS
- REFER TO SHEET AG3.000 FOR ADDITIONAL SIGN TYPES
- REFER TO SHEET 1-17 FOR HAS WAYFINDING SYMBOLS




\*\* 48 +/- COLUMNS TO BE PAINTED IN THIS SECTOR, V.I.F.

### LEVEL 02 - FLOOR PLAN - SECTOR A 3/64" = 1'-0"

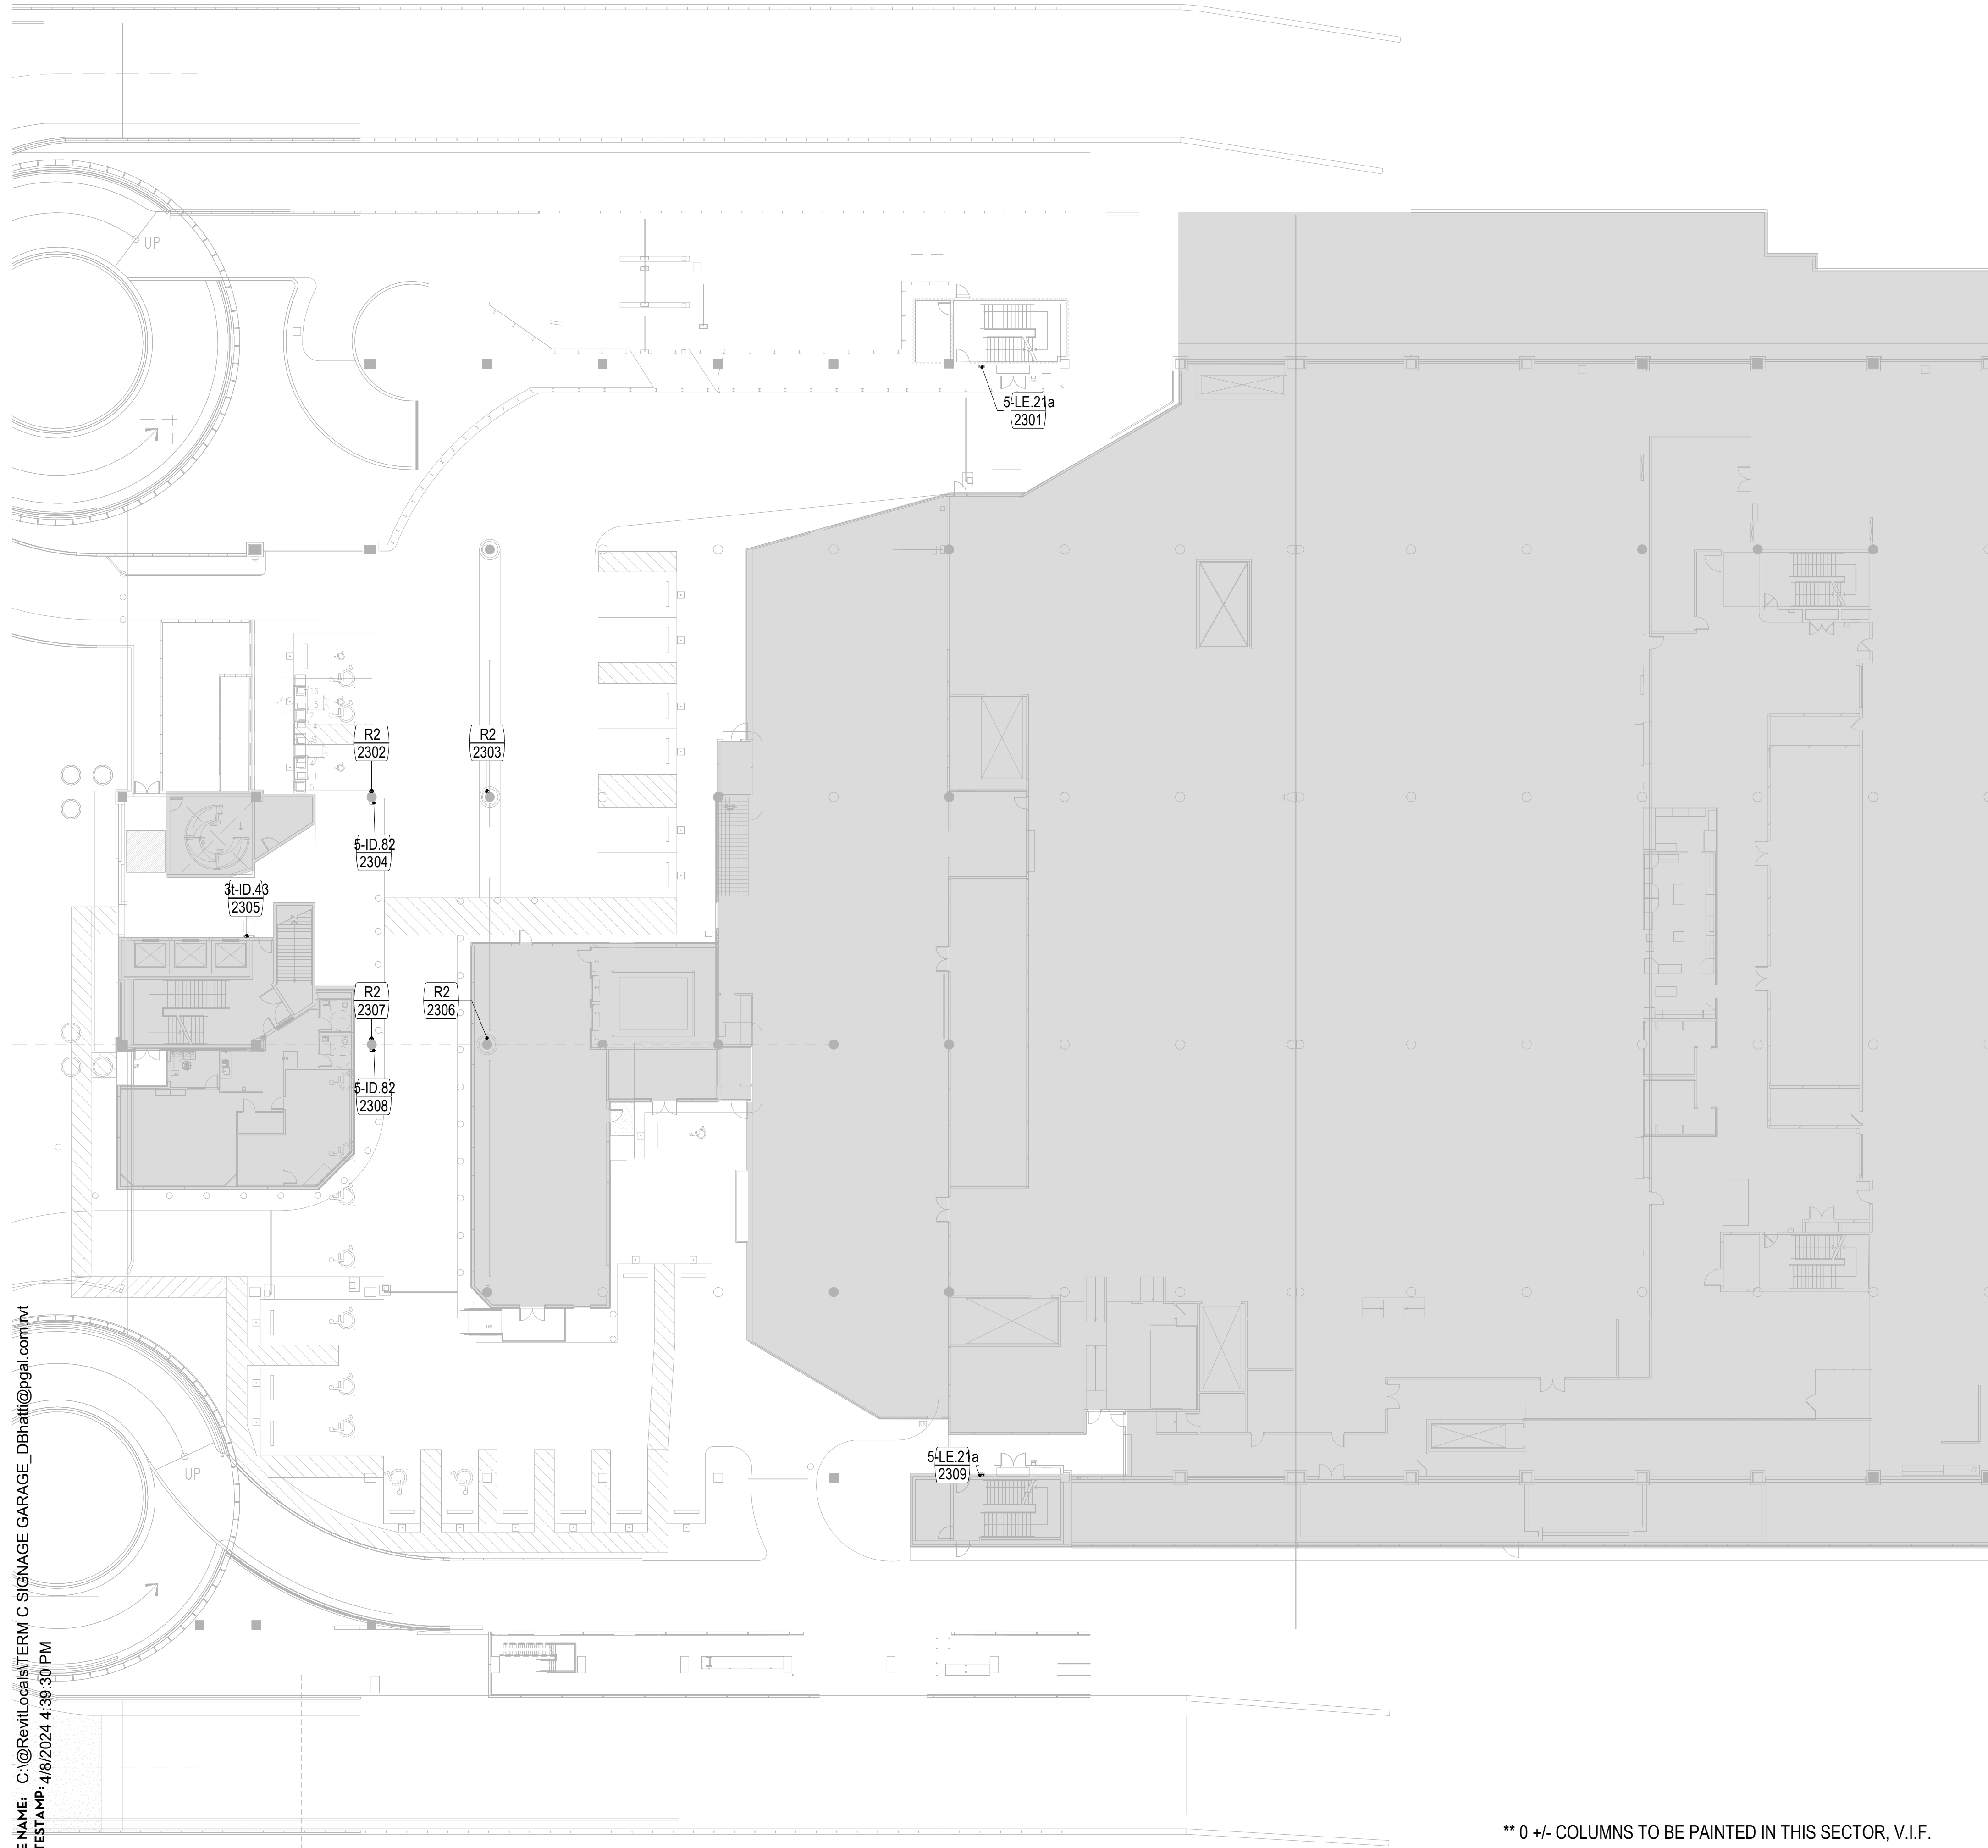FILE NAME: C:\Revit\Locals\TERM C SIGNAGE GARAGE\_DBhatti@pgal.com.rvt  
DATESTAMP: 4/8/2024 4:39:28 PM

FILE NAME: C:\Revit\local\TERM C SIGNAGE GARAGE\_DBhatti@pgal.com.rvt  
 DATE/TIME: 4/8/2024 4:39:30 PM



\*\* 0 +/- COLUMNS TO BE PAINTED IN THIS SECTOR, V.I.F.

**LEVEL 02 - FLOOR PLAN - SECTOR C** 3/164" = 1'-0" 1

**SIGNAGE SCHEDULE - LEVEL 02 - SECTOR C**

SIGN NUMBER	SIGN TYPE	HAS SYMBOL	TEXT LINE 1	TEXT LINE 2	TEXT LINE 3	REFERENCE PLAN
2301	5-LE.21a	FIRE HOSE REEL				2-37
2302	R2					AG3.000
2303	R2					AG3.000
2304	5-ID.82		UNITED	PARKING	ONLY	2-36
2305	3t-ID.43					2-32
2306	R2					AG3.000
2307	R2					AG3.000
2308	5-ID.82		UNITED	PARKING	ONLY	2-36
2309	5-LE.21a	FIRE HOSE REEL				2-37

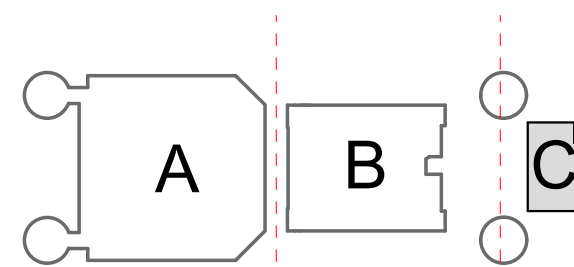
**FLOOR PLAN KEYNOTES**

- A SKIM COAT WITH SIKA QUICK SMOOTH FINISH AT EXTERIOR WALL PERIMETER AT ELEVATOR AND STAIR CORES. TO BE PRIMED AND PAINTED.
- B SKIM COAT WITH SIKA QUICK SMOOTH FINISH AT ALL GARAGE COLUMNS ONLY. TO BE PRIMED AND PAINTED. REFER TO \*\* IN REGARDS TO APPROXIMATE COLUMN QUANTITY.

**GENERAL NOTES**

1. REFER TO SHEETS 1-1 THROUGH 10-24 FOR ADDITIONAL INFORMATION, INCLUDING NEW SIGN LOCATIONS, SIGN TYPES, AND MOUNTING DETAILS
2. REFER TO SHEET AG3.000 FOR ADDITIONAL SIGN TYPES
3. REFER TO SHEET 1-17 FOR HAS WAYFINDING SYMBOLS


**KEY PLAN**




1: 25.6 SCALE



**LEGEND**

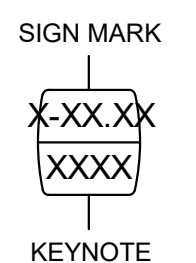

**PLAN NORTH**

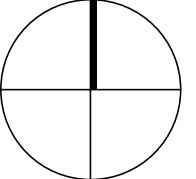

CLIENT



Client Name

ARCHITECT

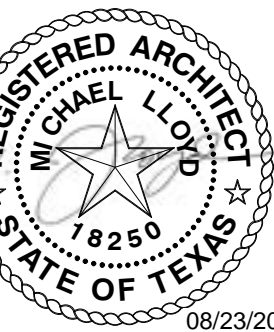


PGAL  
 3131 BRIARPARK DR.  
 SUITE 200  
 HOUSTON, TX 77042  
 [T] 713 622 1444  
 [F] 713 968 9333  
 www.pgal.com

BSG PRJCT#  
 BSG-2024-111-IAH

DEPARTMENT OF AVIATION  
 RECOMMENDED:  
 HOUSTON AIRPORT SYSTEM  
 DIRECTOR OR DESIGN REPRESENTATIVE  
 HAS TIP # 24-103 - IAH

REGISTRATION  
 Copyright © 2024



**DRAWING HISTORY**

NO.	DATE	DESCRIPTION
01	04/10/2024	ISSUE FOR PERMIT
02	08/23/2024	ISSUE FOR BID

PROJECT NAME  
 IAH TERMINAL C  
 GARAGE  
 SIGNAGE &  
 WAYFINDING

PROJECT LOCATION  
 TERMINAL C  
 3500 NORTH  
 TERMINAL RD.  
 HOUSTON, TX 77032

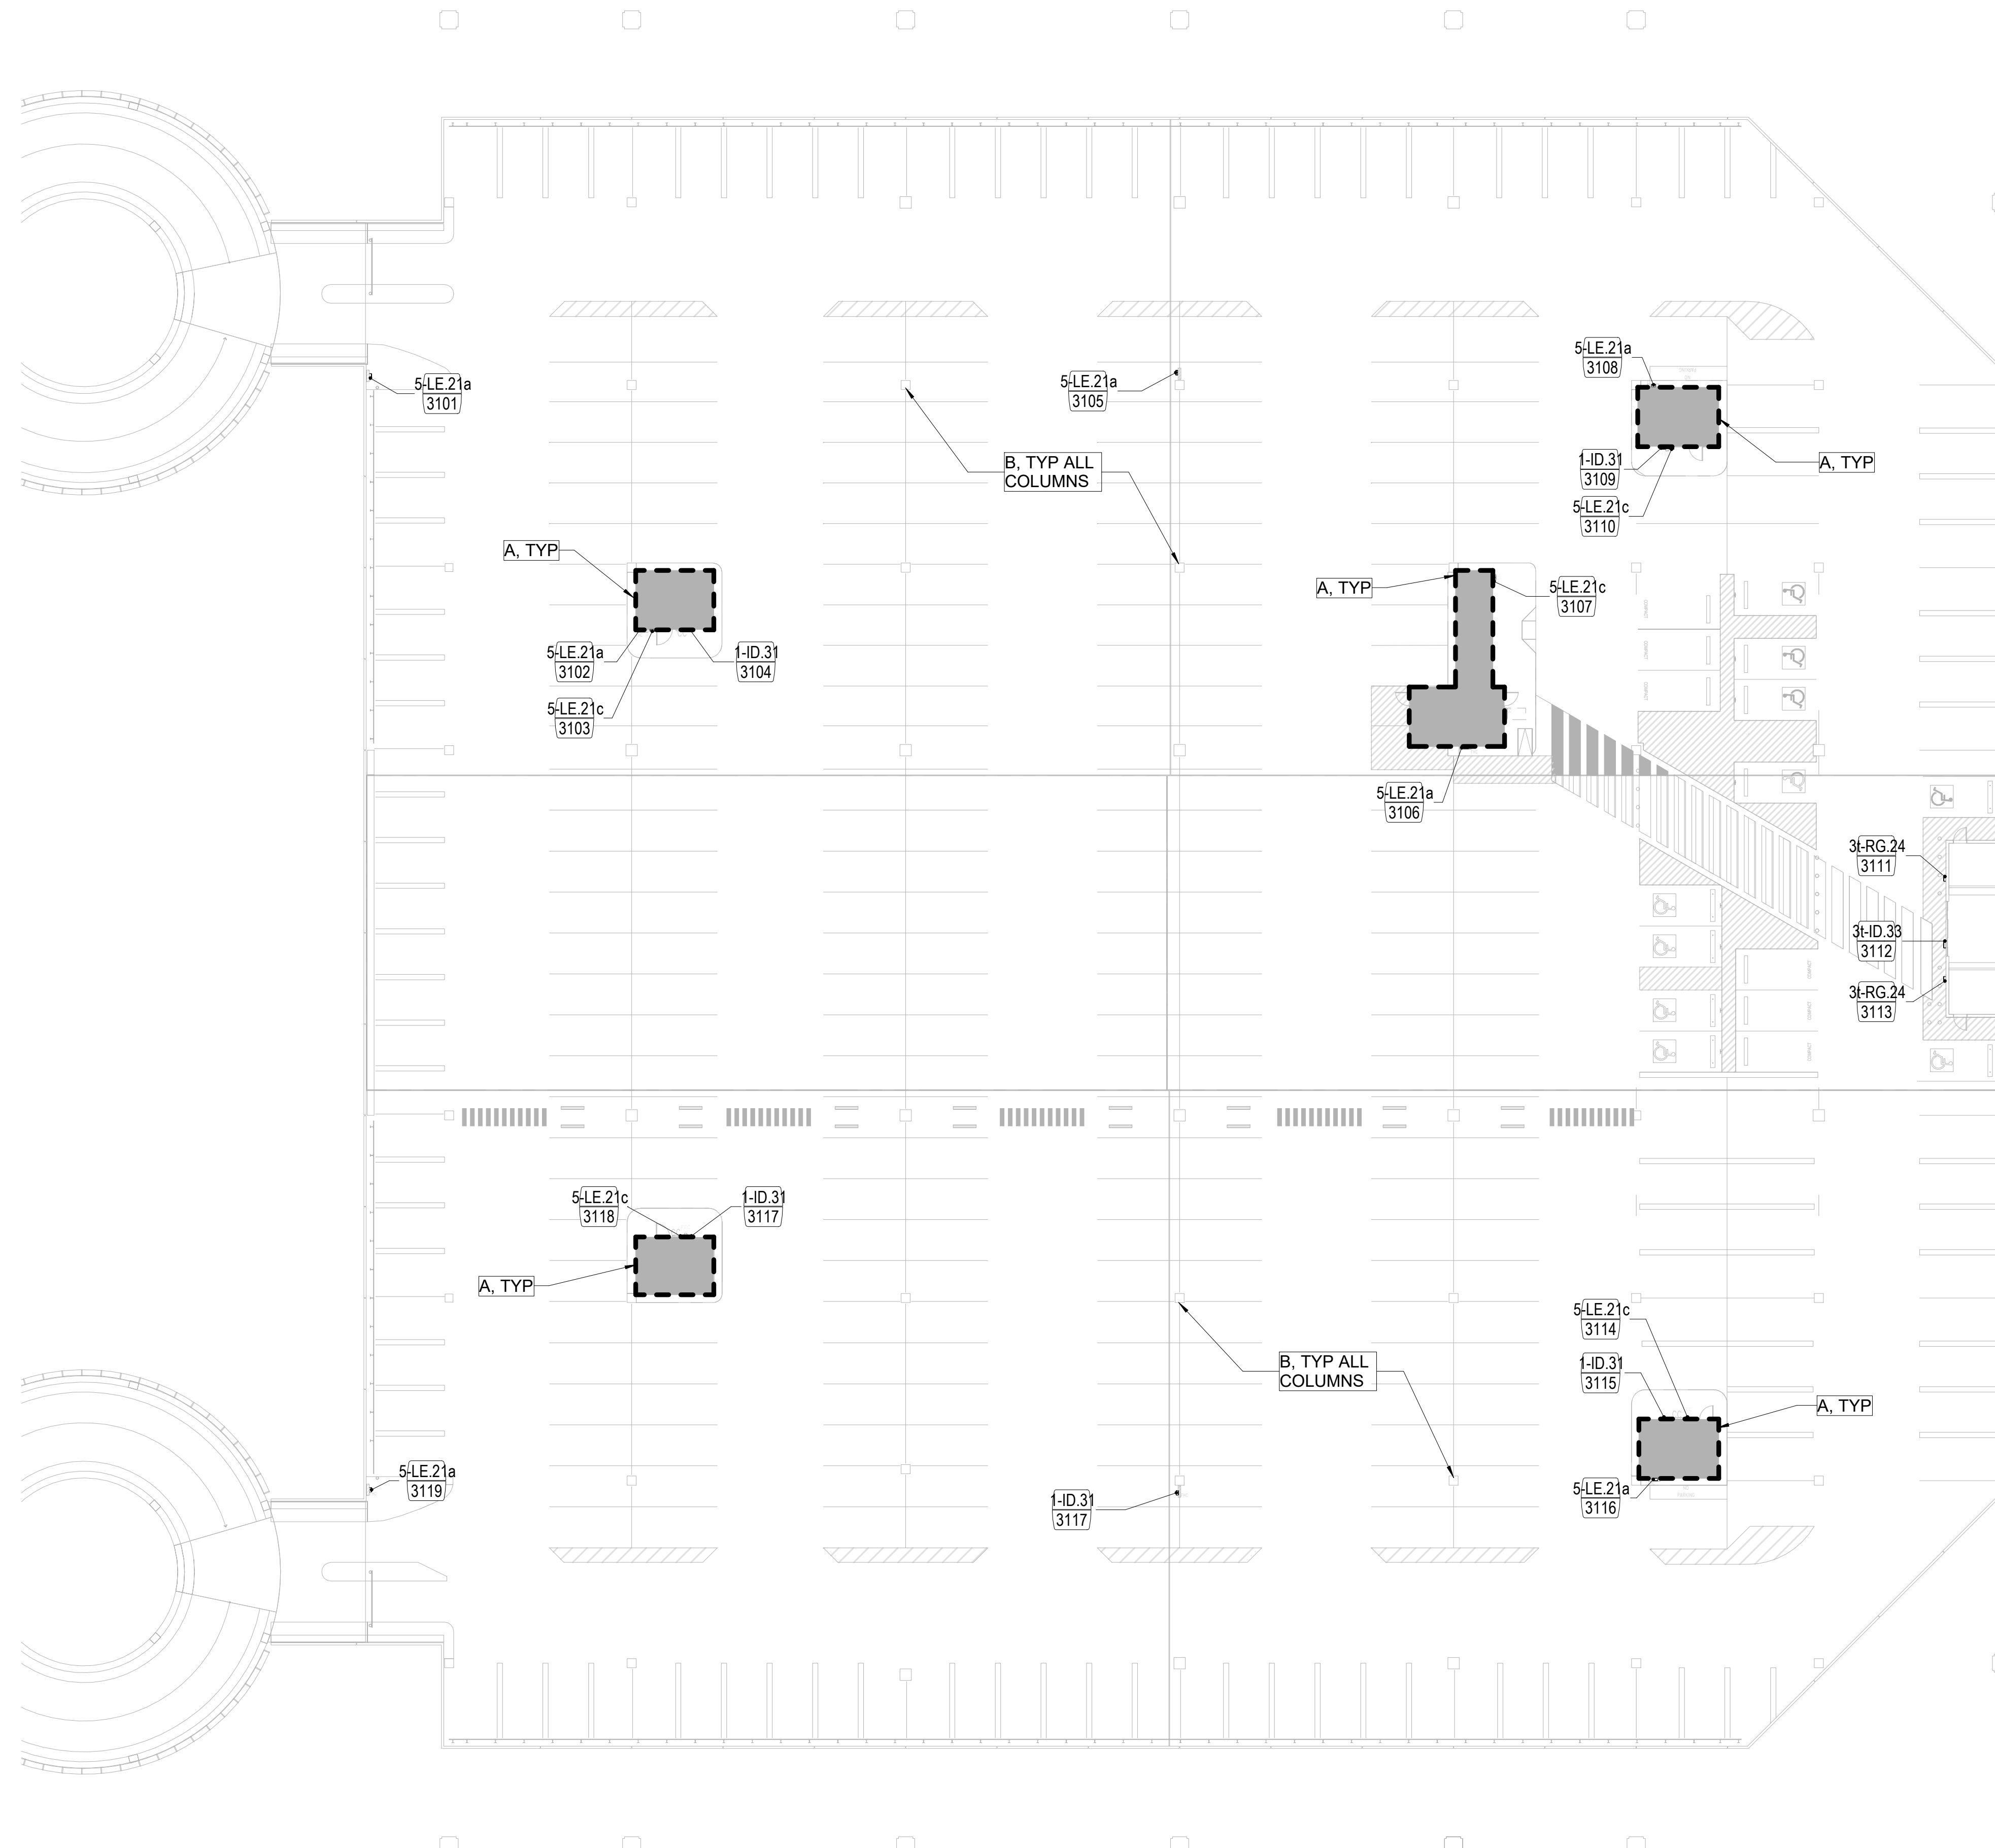
PROJECT NUMBER  
 1004395

SHEET TITLE  
 LEVEL 02C FLOOR  
 PLAN

SHEET NUMBER

**A2.02C**

FILE NAME: C:\Revit\Locals\TERM C SIGNAGE GARAGE\_DBhatti@pgal.com.rvt  
 DATE/TIME: 4/8/2024 4:39:32 PM



\*\* 62 +/- COLUMNS TO BE PAINTED IN THIS SECTOR, V.I.F.

**LEVEL 03 - FLOOR PLAN - SECTOR A** 3/64" = 1'-0" 1

**SIGNAGE SCHEDULE - LEVEL 03 - SECTOR A**

SIGN NUMBER	SIGN TYPE	HAS SYMBOL	TEXT LINE 1	TEXT LINE 2	TEXT LINE 3	REFERENCE PLAN
3101	5-LE.21a	FIRE HOSE REEL				2-37
3102	5-LE.21a	FIRE HOSE REEL				2-37
3103	5-LE.21c	FIRE EXTINGUISHER				2-37
3104	1-ID.31	STAIR	STAIR 10	LEVEL 3	NO RE-ENTRY	2-30
3105	5-LE.21a	FIRE HOSE REEL				2-37
3106	5-LE.21a	FIRE HOSE REEL				2-37
3107	5-LE.21c	FIRE EXTINGUISHER				2-37
3108	5-LE.21a	FIRE HOSE REEL				2-37
3109	1-ID.31	STAIR	STAIR 8	LEVEL 3	NO RE-ENTRY	2-30
3110	5-LE.21c	FIRE EXTINGUISHER				2-37
3111	3-LE.21a	TERMINAL C				2-34
3112	3-ID.33	TERMINAL C				2-31
3113	3-LE.21a	FIRE EXTINGUISHER				2-34
3114	5-LE.21c	FIRE EXTINGUISHER				2-37
3115	1-ID.31	STAIR	STAIR 9	LEVEL 3	NO RE-ENTRY	2-30
3116	5-LE.21a	FIRE HOSE REEL				2-37
3117	1-ID.31	STAIR	STAIR 11	LEVEL 3	NO RE-ENTRY	2-30
3118	5-LE.21c	FIRE EXTINGUISHER				2-37
3119	5-LE.21a	FIRE HOSE REEL				2-37

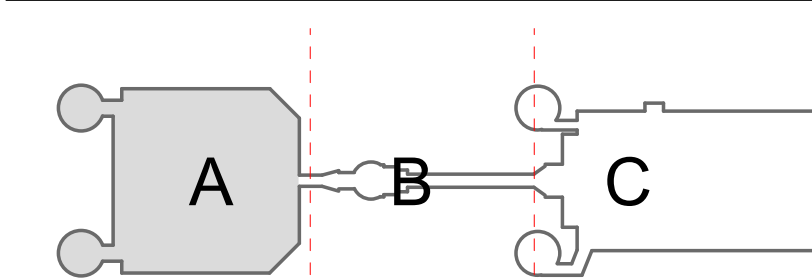
**FLOOR PLAN KEYNOTES**

- A SKIM COAT WITH SIKA QUICK SMOOTH FINISH AT EXTERIOR WALL PERIMETER AT ELEVATOR AND STAIR CORES. TO BE PRIMED AND PAINTED.
- B SKIM COAT WITH SIKA QUICK SMOOTH FINISH AT ALL GARAGE COLUMNS ONLY. TO BE PRIMED AND PAINTED. REFER TO \*\* IN REGARDS TO APPROXIMATE COLUMN QUANTITY.

**GENERAL NOTES**

1. REFER TO SHEETS 1-1 THROUGH 10-24 FOR ADDITIONAL INFORMATION, INCLUDING NEW SIGN LOCATIONS, SIGN TYPES, AND MOUNTING DETAILS.
2. REFER TO SHEET AG3.000 FOR ADDITIONAL SIGN TYPES.
3. REFER TO SHEET 1-17 FOR HAS WAYFINDING SYMBOLS.


**KEY PLAN**




1: 256 SCALE



**LEGEND**

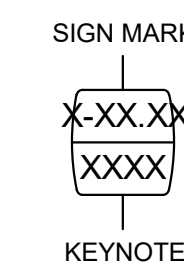

**PLAN NORTH**

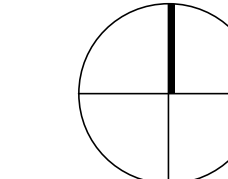

CLIENT



Client Name

ARCHITECT



PGAL  
 3131 BRIARPARK DR.  
 SUITE 200  
 HOUSTON, TX 77042  
 [T] 713 622 1444  
 [F] 713 968 9333  
 www.pgal.com

BSG PRJCT#  
 BSG-2024-111-IAH

DEPARTMENT OF AVIATION  
 RECOMMENDED:  
 HOUSTON AIRPORT SYSTEM  
 DIRECTOR OR DESIGN REPRESENTATIVE  
 HAS TIP # 24-103 - IAH

REGISTRATION  
 Copyright © 2024



**DRAWING HISTORY**

NO.	DATE	DESCRIPTION
01	04/10/2024	ISSUE FOR PERMIT
02	08/23/2024	ISSUE FOR BID

PROJECT NAME  
 IAH TERMINAL C  
 GARAGE  
 SIGNAGE &  
 WAYFINDING

PROJECT LOCATION  
 TERMINAL C  
 3500 NORTH  
 TERMINAL RD.  
 HOUSTON, TX 77032

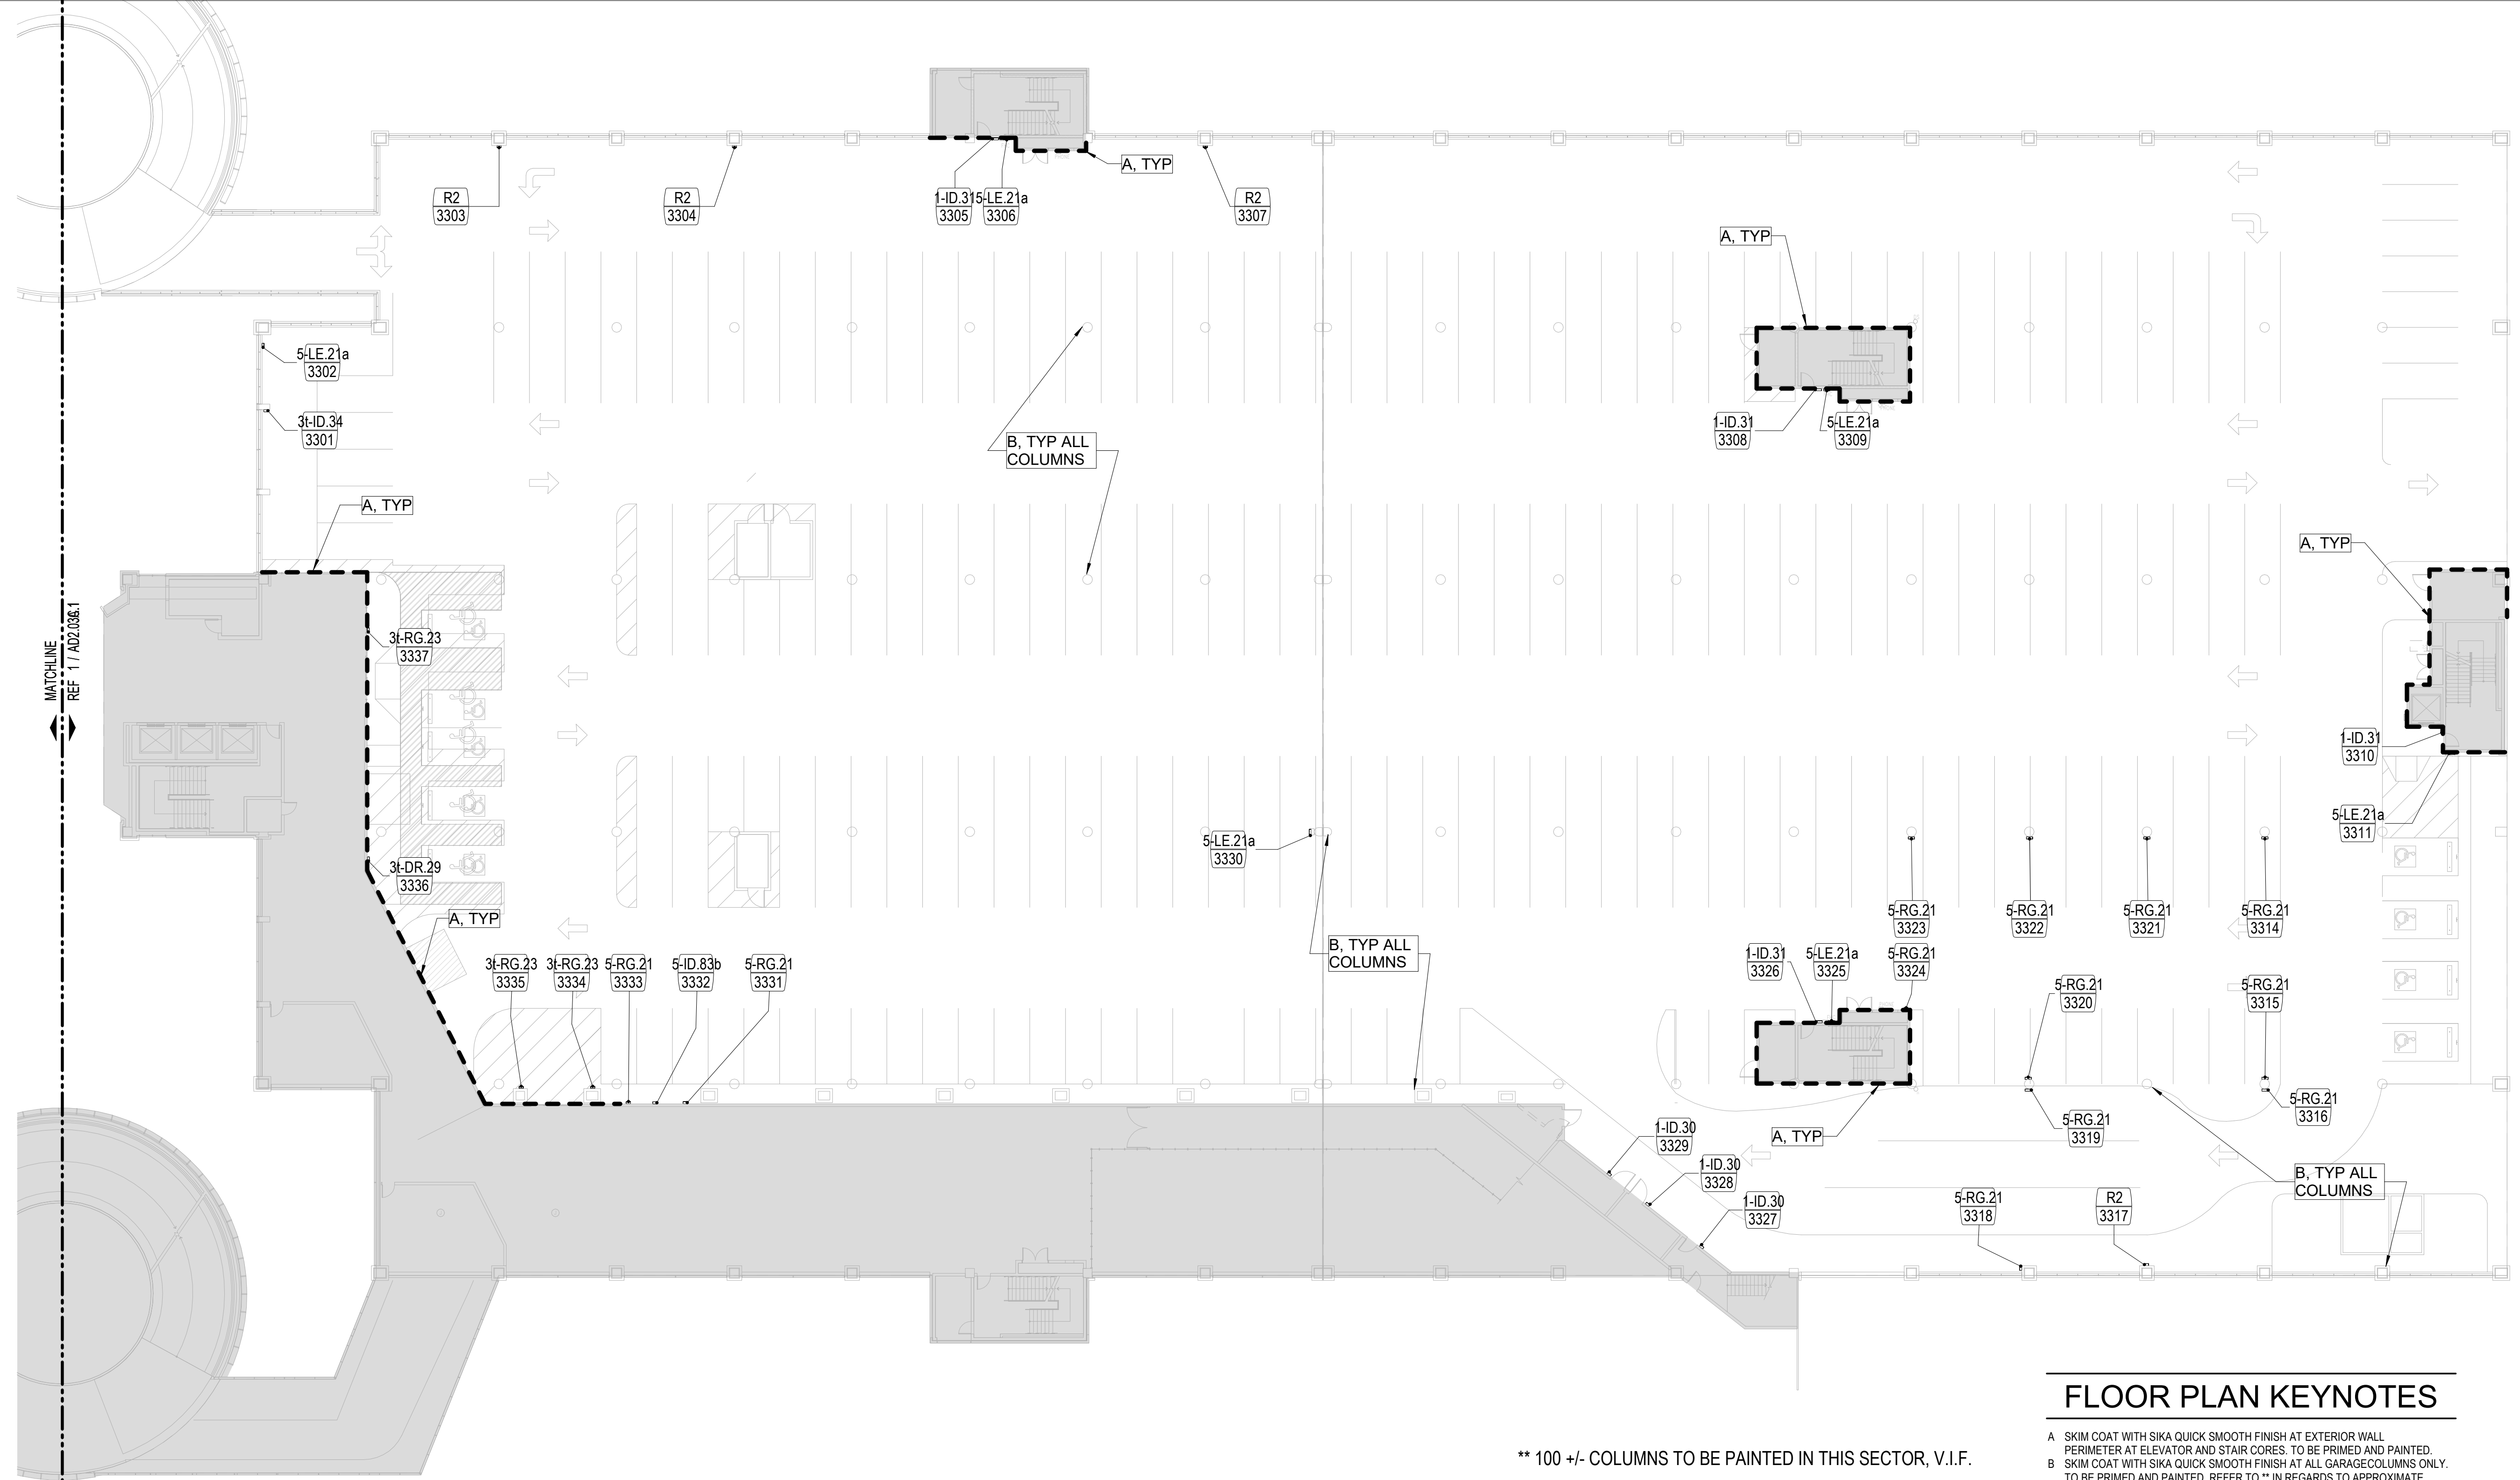
PROJECT NUMBER  
 1004395

SHEET TITLE  
 LEVEL 03A FLOOR  
 PLAN

SHEET NUMBER

A2.03A

FILE NAME: C:\Revit\Localis\TERM C SIGNAGE GARAGE\_DBhatti@pgal.com.rvt  
 DATE/TIME: 4/8/2024 4:39:34 PM



\*\* 100 +/- COLUMNS TO BE PAINTED IN THIS SECTOR, V.I.F.

**LEVEL 03 - FLOOR PLAN - SECTOR C** 3/64" = 1'-0" 1

SIGNAGE SCHEDULE - LEVEL 03 - SECTOR C						
SIGN NUMBER	SIGN TYPE	HAS SYMBOL	TEXT LINE 1	TEXT LINE 2	TEXT LINE 3	REFERENCE PLAN
3301	3t-ID.34					2-31
3302	5-LE.21a	FIRE HOSE REEL				2-37
3303	R2					AG3.000
3304	R2					AG3.000
3305	1-ID.31	STAIR	STAIR 2	LEVEL 3	NO RE-ENTRY	2-30
3306	5-LE.21a	FIRE HOSE REEL				2-37
3307	R2					AG3.000
3308	1-ID.31	STAIR	STAIR 4	LEVEL 3	NO RE-ENTRY	2-30
3309	5-LE.21a	FIRE HOSE REEL				2-37
3310	1-ID.31	STAIR	STAIR 6	LEVEL 3	NO RE-ENTRY	2-30

SIGNAGE SCHEDULE - LEVEL 03 - SECTOR C						
SIGN NUMBER	SIGN TYPE	HAS SYMBOL	TEXT LINE 1	TEXT LINE 2	TEXT LINE 3	REFERENCE PLAN
3311	5-LE.21a	FIRE HOSE REEL				2-37
3314	5-RG.21					2-38
3315	5-RG.21					2-38
3316	5-RG.21					2-38
3317	R2					AG3.000
3318	5-RG.21					2-38
3319	5-RG.21					2-38
3320	5-RG.21					2-38
3321	5-RG.21					2-38
3322	5-RG.21					2-38
3323	5-RG.21					2-38
3324	5-RG.21					2-38
3325	5-LE.21a	FIRE HOSE REEL				2-37

SIGNAGE SCHEDULE - LEVEL 03 - SECTOR C						
SIGN NUMBER	SIGN TYPE	HAS SYMBOL	TEXT LINE 1	TEXT LINE 2	TEXT LINE 3	REFERENCE PLAN
3326	1-ID.31	STAIR	STAIR 5	LEVEL 3	NO RE-ENTRY	2-30
3327	1-ID.30	STAIR	STAIR 14	C.C3.ST14		2-29
3328	1-ID.30		C.C303.13	INTERMEDIATE DENSITY FRAME	333	2-29
3329	1-ID.30		C.C303.12	ELECTRICAL 334		2-29
3330	5-LE.21a	FIRE HOSE REEL				2-37
3331	5-RG.21					2-38
3332	5-ID.83b					2-36
3333	5-RG.21					2-38
3334	3t-RG.23					2-34
3335	3t-RG.23					2-34
3336	3t-DR.29					2-35
3337	3t-RG.23					2-34


**FLOOR PLAN KEYNOTES**

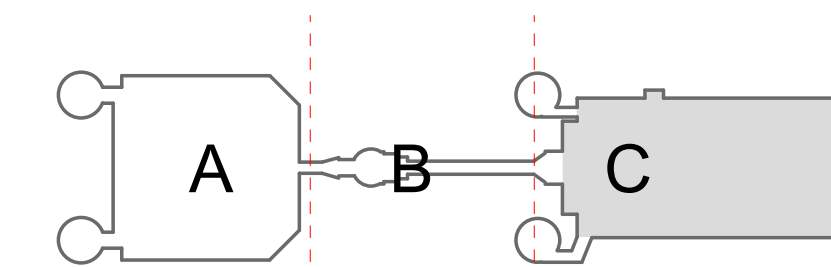- A SKIM COAT WITH SIKA QUICK SMOOTH FINISH AT EXTERIOR WALL PERIMETER AT ELEVATOR AND STAIR CORES. TO BE PRIMED AND PAINTED.
- B SKIM COAT WITH SIKA QUICK SMOOTH FINISH AT ALL GARAGE COLUMNS ONLY. TO BE PRIMED AND PAINTED. REFER TO \*\* IN REGARDS TO APPROXIMATE COLUMN QUANTITY.

**GENERAL NOTES**

- REFER TO SHEETS 1-1 THROUGH 10-24 FOR ADDITIONAL INFORMATION, INCLUDING NEW SIGN LOCATIONS, SIGN TYPES, AND MOUNTING DETAILS
- REFER TO SHEET AG3.000 FOR ADDITIONAL SIGN TYPES
- REFER TO SHEET 1-17 FOR HAS WAYFINDING SYMBOLS


**KEY PLAN**




1:256 SCALE



**LEGEND**

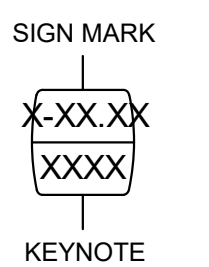

**PLAN NORTH**

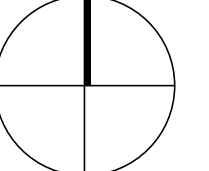

CLIENT



Client Name

ARCHITECT



PGAL  
 3131 BRIARPARK DR.  
 SUITE 200  
 HOUSTON, TX 77042  
 [T] 713 622 1444  
 [F] 713 968 9333  
 www.pgal.com

BSG PRJCT#  
 BSG-2024-111-IAH

DEPARTMENT OF AVIATION  
 RECOMMENDED:  
 HOUSTON AIRPORT SYSTEM  
 DIRECTOR OR DESIGN REPRESENTATIVE

HAS TIP # 24-103 - IAH

REGISTRATION  
 Copyright © 2024



**DRAWING HISTORY**

NO.	DATE	DESCRIPTION
01	04/10/2024	ISSUE FOR PERMIT
02	08/23/2024	ISSUE FOR BID

PROJECT NAME  
**IAH TERMINAL C  
 GARAGE  
 SIGNAGE &  
 WAYFINDING**

PROJECT LOCATION  
 TERMINAL C  
 3500 NORTH  
 TERMINAL RD.  
 HOUSTON, TX 77032

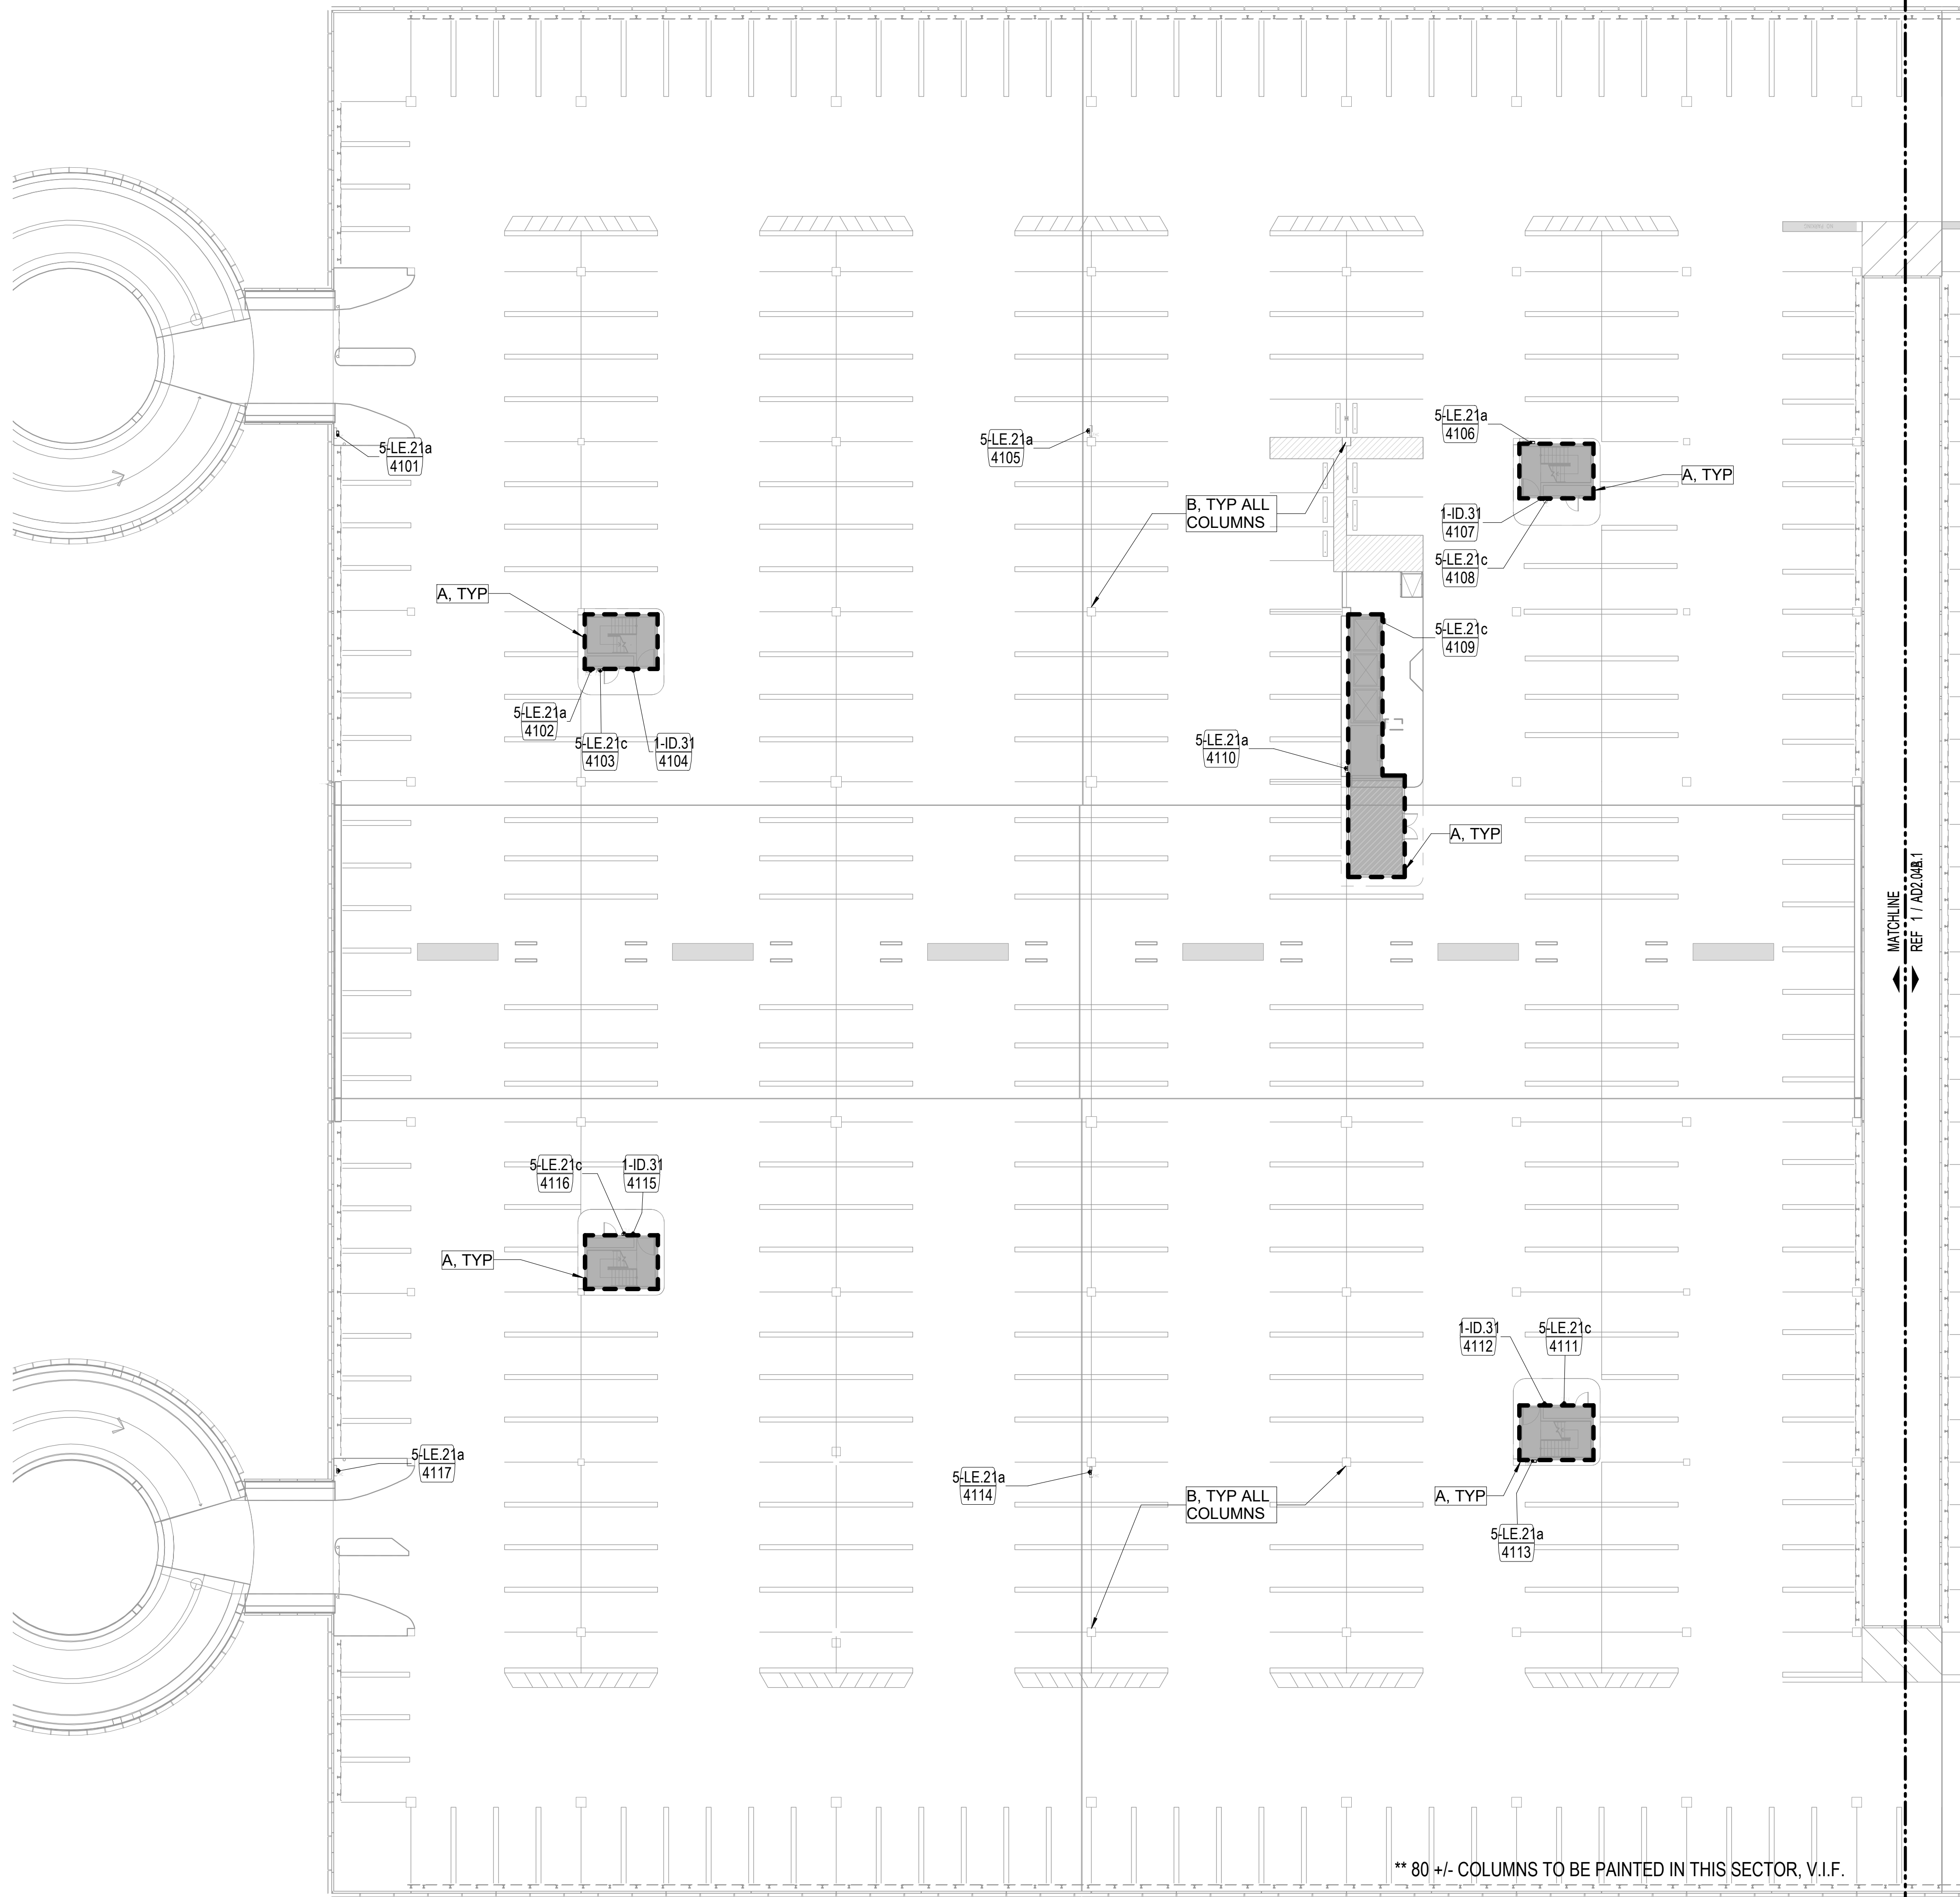
PROJECT NUMBER  
 1004395

SHEET TITLE  
 LEVEL 03C FLOOR  
 PLAN

SHEET NUMBER

**A2.03C**

FILE NAME: C:\Revit\Locals\TERM C SIGNAGE GARAGE\_DBhatti@pgal.com.rvt  
 DATE/TIME: 4/8/2024 4:39:35 PM



\*\* 80 +/- COLUMNS TO BE PAINTED IN THIS SECTOR, V.I.F.

LEVEL 04 - FLOOR PLAN - SECTOR A 3/64" = 1'-0" 1

**SIGNAGE SCHEDULE - LEVEL 04 - SECTOR A**

SIGN NUMBER	SIGN TYPE	HAS SYMBOL	TEXT LINE 1	TEXT LINE 2	TEXT LINE 3	REFERENCE PLAN
4101	5-LE.21a	FIRE HOSE REEL				2-37
4102	5-LE.21a	FIRE HOSE REEL				2-37
4103	5-LE.21c	FIRE EXTINGUISHER				2-37
4104	1-ID.31	STAIR	STAIR 10	LEVEL 4	NO RE-ENTRY	2-30
4105	5-LE.21a	FIRE HOSE REEL				2-37
4106	5-LE.21a	FIRE HOSE REEL				2-37
4107	1-ID.31	STAIR	STAIR 8	LEVEL 4	NO RE-ENTRY	2-30
4108	5-LE.21c	FIRE EXTINGUISHER				2-37
4109	5-LE.21c	FIRE EXTINGUISHER				2-37
4110	5-LE.21a	FIRE HOSE REEL				2-37
4111	5-LE.21c	FIRE EXTINGUISHER				2-37
4112	1-ID.31	STAIR	STAIR 9	LEVEL 4	NO RE-ENTRY	2-30
4113	5-LE.21a	FIRE HOSE REEL				2-37
4114	5-LE.21a	FIRE HOSE REEL				2-37
4115	1-ID.31	STAIR	STAIR 11	LEVEL 4	NO RE-ENTRY	2-30
4116	5-LE.21c	FIRE EXTINGUISHER				2-37
4117	5-LE.21a	FIRE HOSE REEL				2-37

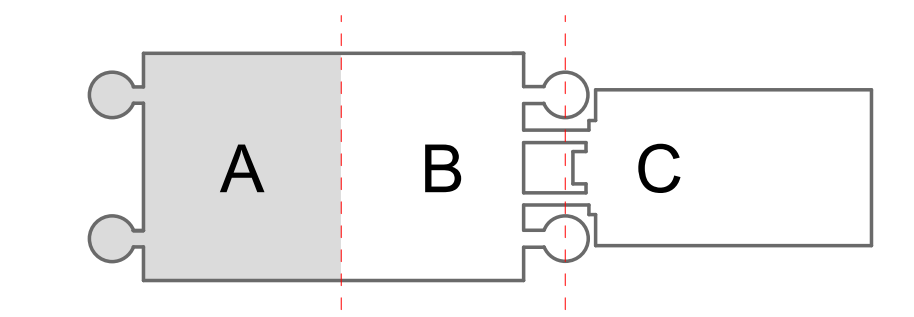
**FLOOR PLAN KEYNOTES**

- A SKIM COAT WITH SIKA QUICK SMOOTH FINISH AT EXTERIOR WALL PERIMETER AT ELEVATOR AND STAIR CORES. TO BE PRIMED AND PAINTED.
- B SKIM COAT WITH SIKA QUICK SMOOTH FINISH AT ALL GARAGE COLUMNS ONLY. TO BE PRIMED AND PAINTED. REFER TO \*\* IN REGARDS TO APPROXIMATE COLUMN QUANTITY.

**GENERAL NOTES**

- REFER TO SHEETS 1-1 THROUGH 10-24 FOR ADDITIONAL INFORMATION, INCLUDING NEW SIGN LOCATIONS, SIGN TYPES, AND MOUNTING DETAILS
- REFER TO SHEET AG3.000 FOR ADDITIONAL SIGN TYPES
- REFER TO SHEET 1-17 FOR HAS WAYFINDING SYMBOLS


**KEY PLAN**




1:256 SCALE



**LEGEND**

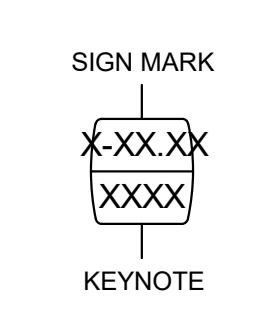

**PLAN NORTH**

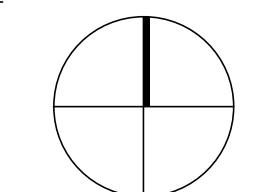

CLIENT  
  
 Client Name

ARCHITECT  


PGAL  
 3131 BRIARPARK DR.  
 SUITE 200  
 HOUSTON, TX 77042  
 [T] 713 622 1444  
 [F] 713 968 9333  
 www.pgal.com

BSG PRJCT#  
 BSG-2024-111-IAH

DEPARTMENT OF AVIATION  
 RECOMMENDED:  
 HOUSTON AIRPORT SYSTEM  
 DIRECTOR OR DESIGN REPRESENTATIVE  
 HAS TIP # 24-103 - IAH

REGISTRATION  
 Copyright © 2024



**DRAWING HISTORY**

NO.	DATE	DESCRIPTION
01	04/10/2024	ISSUE FOR PERMIT
02	08/23/2024	ISSUE FOR BID

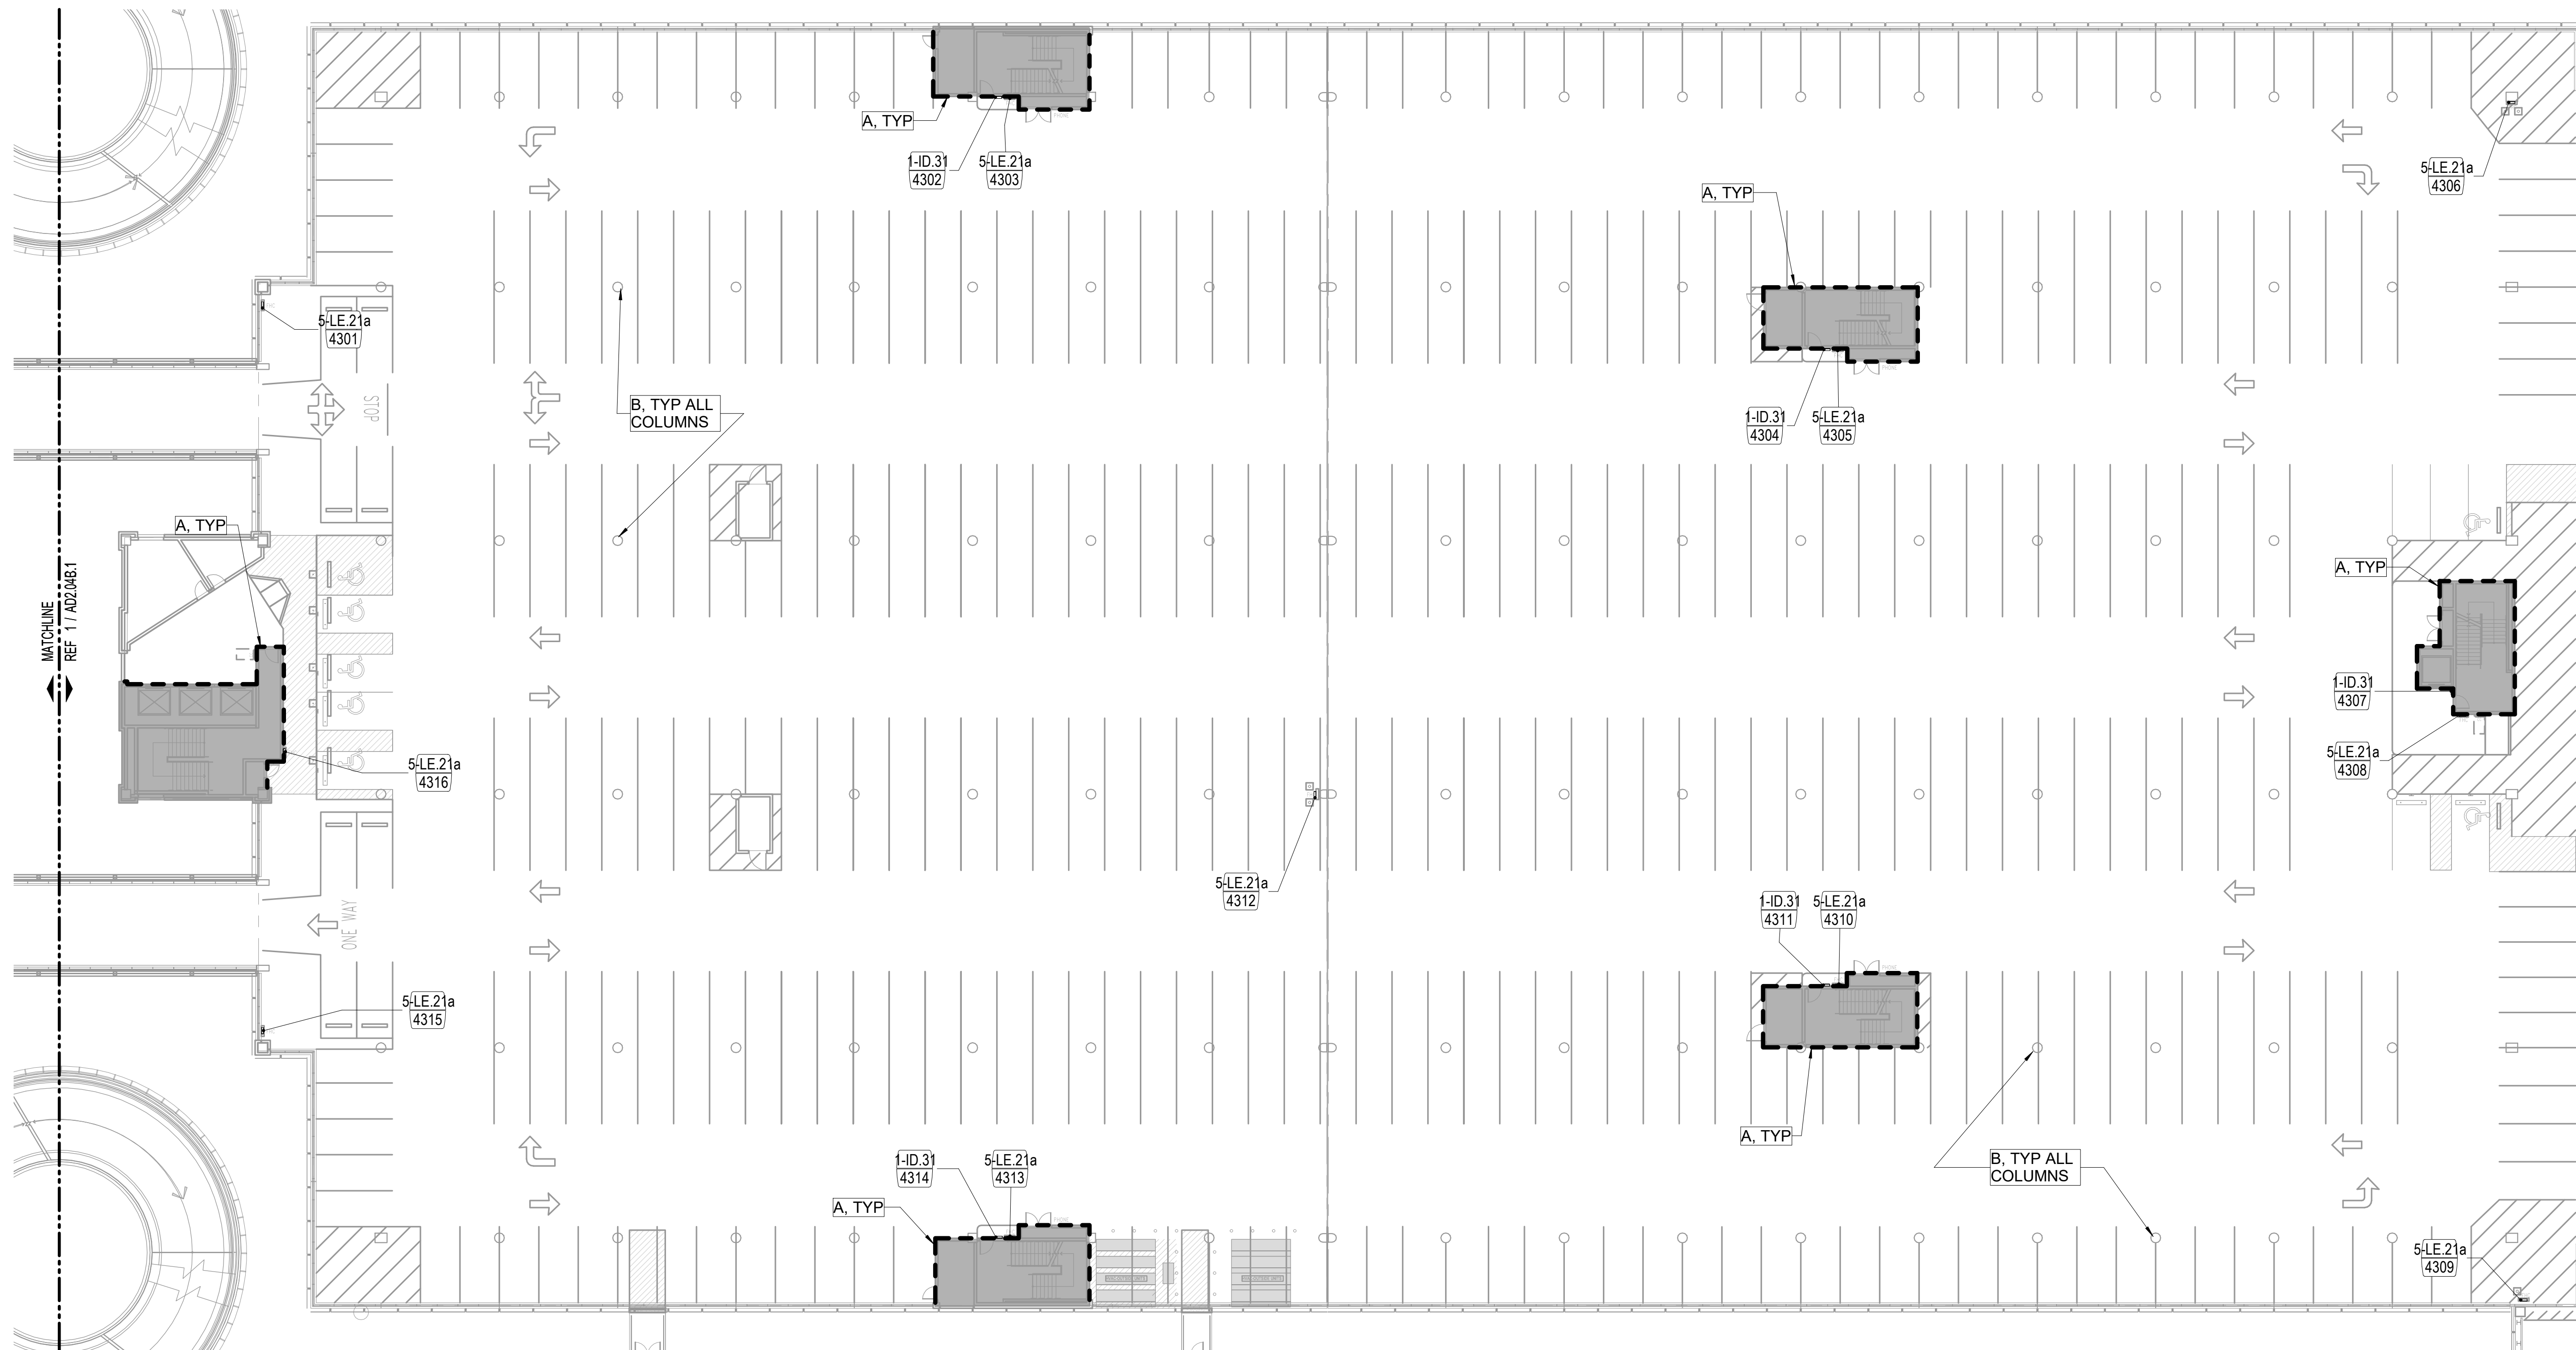
PROJECT NAME  
 IAH TERMINAL C  
 GARAGE  
 SIGNAGE &  
 WAYFINDING  
 PROJECT LOCATION  
 TERMINAL C  
 3500 NORTH  
 TERMINAL RD.  
 HOUSTON, TX 77032

PROJECT NUMBER  
 1004395

SHEET TITLE  
 LEVEL 04A FLOOR  
 PLAN

SHEET NUMBER

A2.04A



\*\* 114 +/- COLUMNS TO BE PAINTED IN THIS SECTOR, V.I.F.  
**LEVEL 04 - FLOOR PLAN - SECTOR C** 3/64" = 1'-0" 1

SIGNAGE SCHEDULE - LEVEL 04 - SECTOR C						
SIGN NUMBER	SIGN TYPE	HAS SYMBOL	TEXT LINE 1	TEXT LINE 2	TEXT LINE 3	REFERENCE PLAN
4301	5-LE.21a	FIRE HOSE REEL				2-37
4302	1-ID.31	STAIR	STAIR 3	LEVEL 4	NO RE-ENTRY	2-30
4303	5-LE.21a	FIRE HOSE REEL				2-37
4304	1-ID.31		STAIR 4	LEVEL 4	NO RE-ENTRY	2-30
4305	5-LE.21a	FIRE HOSE REEL				2-37
4306	5-LE.21a	FIRE HOSE REEL				2-37
4307	1-ID.31		STAIR 6	LEVEL 4	NO RE-ENTRY	2-30
4308	5-LE.21a	FIRE HOSE REEL				2-37
4309	5-LE.21a	FIRE HOSE REEL				2-37
4310	5-LE.21a	FIRE HOSE REEL				2-37
4311	1-ID.31		STAIR 5	LEVEL 4	NO RE-ENTRY	2-30
4312	5-LE.21a	FIRE HOSE REEL				2-37
4313	5-LE.21a	FIRE HOSE REEL				2-37
4314	1-ID.31		STAIR 2	LEVEL 4	NO RE-ENTRY	2-30
4315	5-LE.21a	FIRE HOSE REEL				2-37
4316	5-LE.21a	FIRE HOSE REEL				2-37


**FLOOR PLAN KEYNOTES**

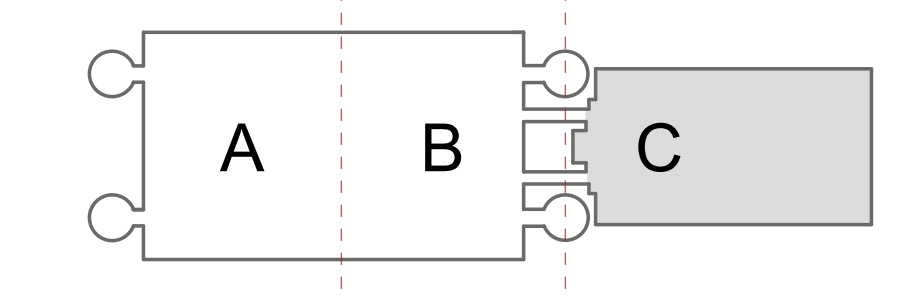- A SKIM COAT WITH SIKA QUICK SMOOTH FINISH AT EXTERIOR WALL PERIMETER AT ELEVATOR AND STAIR CORES. TO BE PRIMED AND PAINTED.
- B SKIM COAT WITH SIKA QUICK SMOOTH FINISH AT ALL GARAGE COLUMNS ONLY. TO BE PRIMED AND PAINTED. REFER TO \*\* IN REGARDS TO APPROXIMATE COLUMN QUANTITY.

**GENERAL NOTES**

- REFER TO SHEETS 1-1 THROUGH 10-24 FOR ADDITIONAL INFORMATION, INCLUDING NEW SIGN LOCATIONS, SIGN TYPES, AND MOUNTING DETAILS
- REFER TO SHEET AG3.000 FOR ADDITIONAL SIGN TYPES
- REFER TO SHEET 1-17 FOR HAS WAYFINDING SYMBOLS


**KEY PLAN**




1:256 SCALE



**LEGEND**

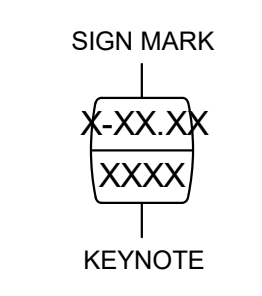


**PLAN NORTH**

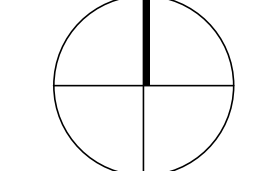

**DRAWING HISTORY**

NO.	DATE	DESCRIPTION
01	04/10/2024	ISSUE FOR PERMIT
02	08/23/2024	ISSUE FOR BID

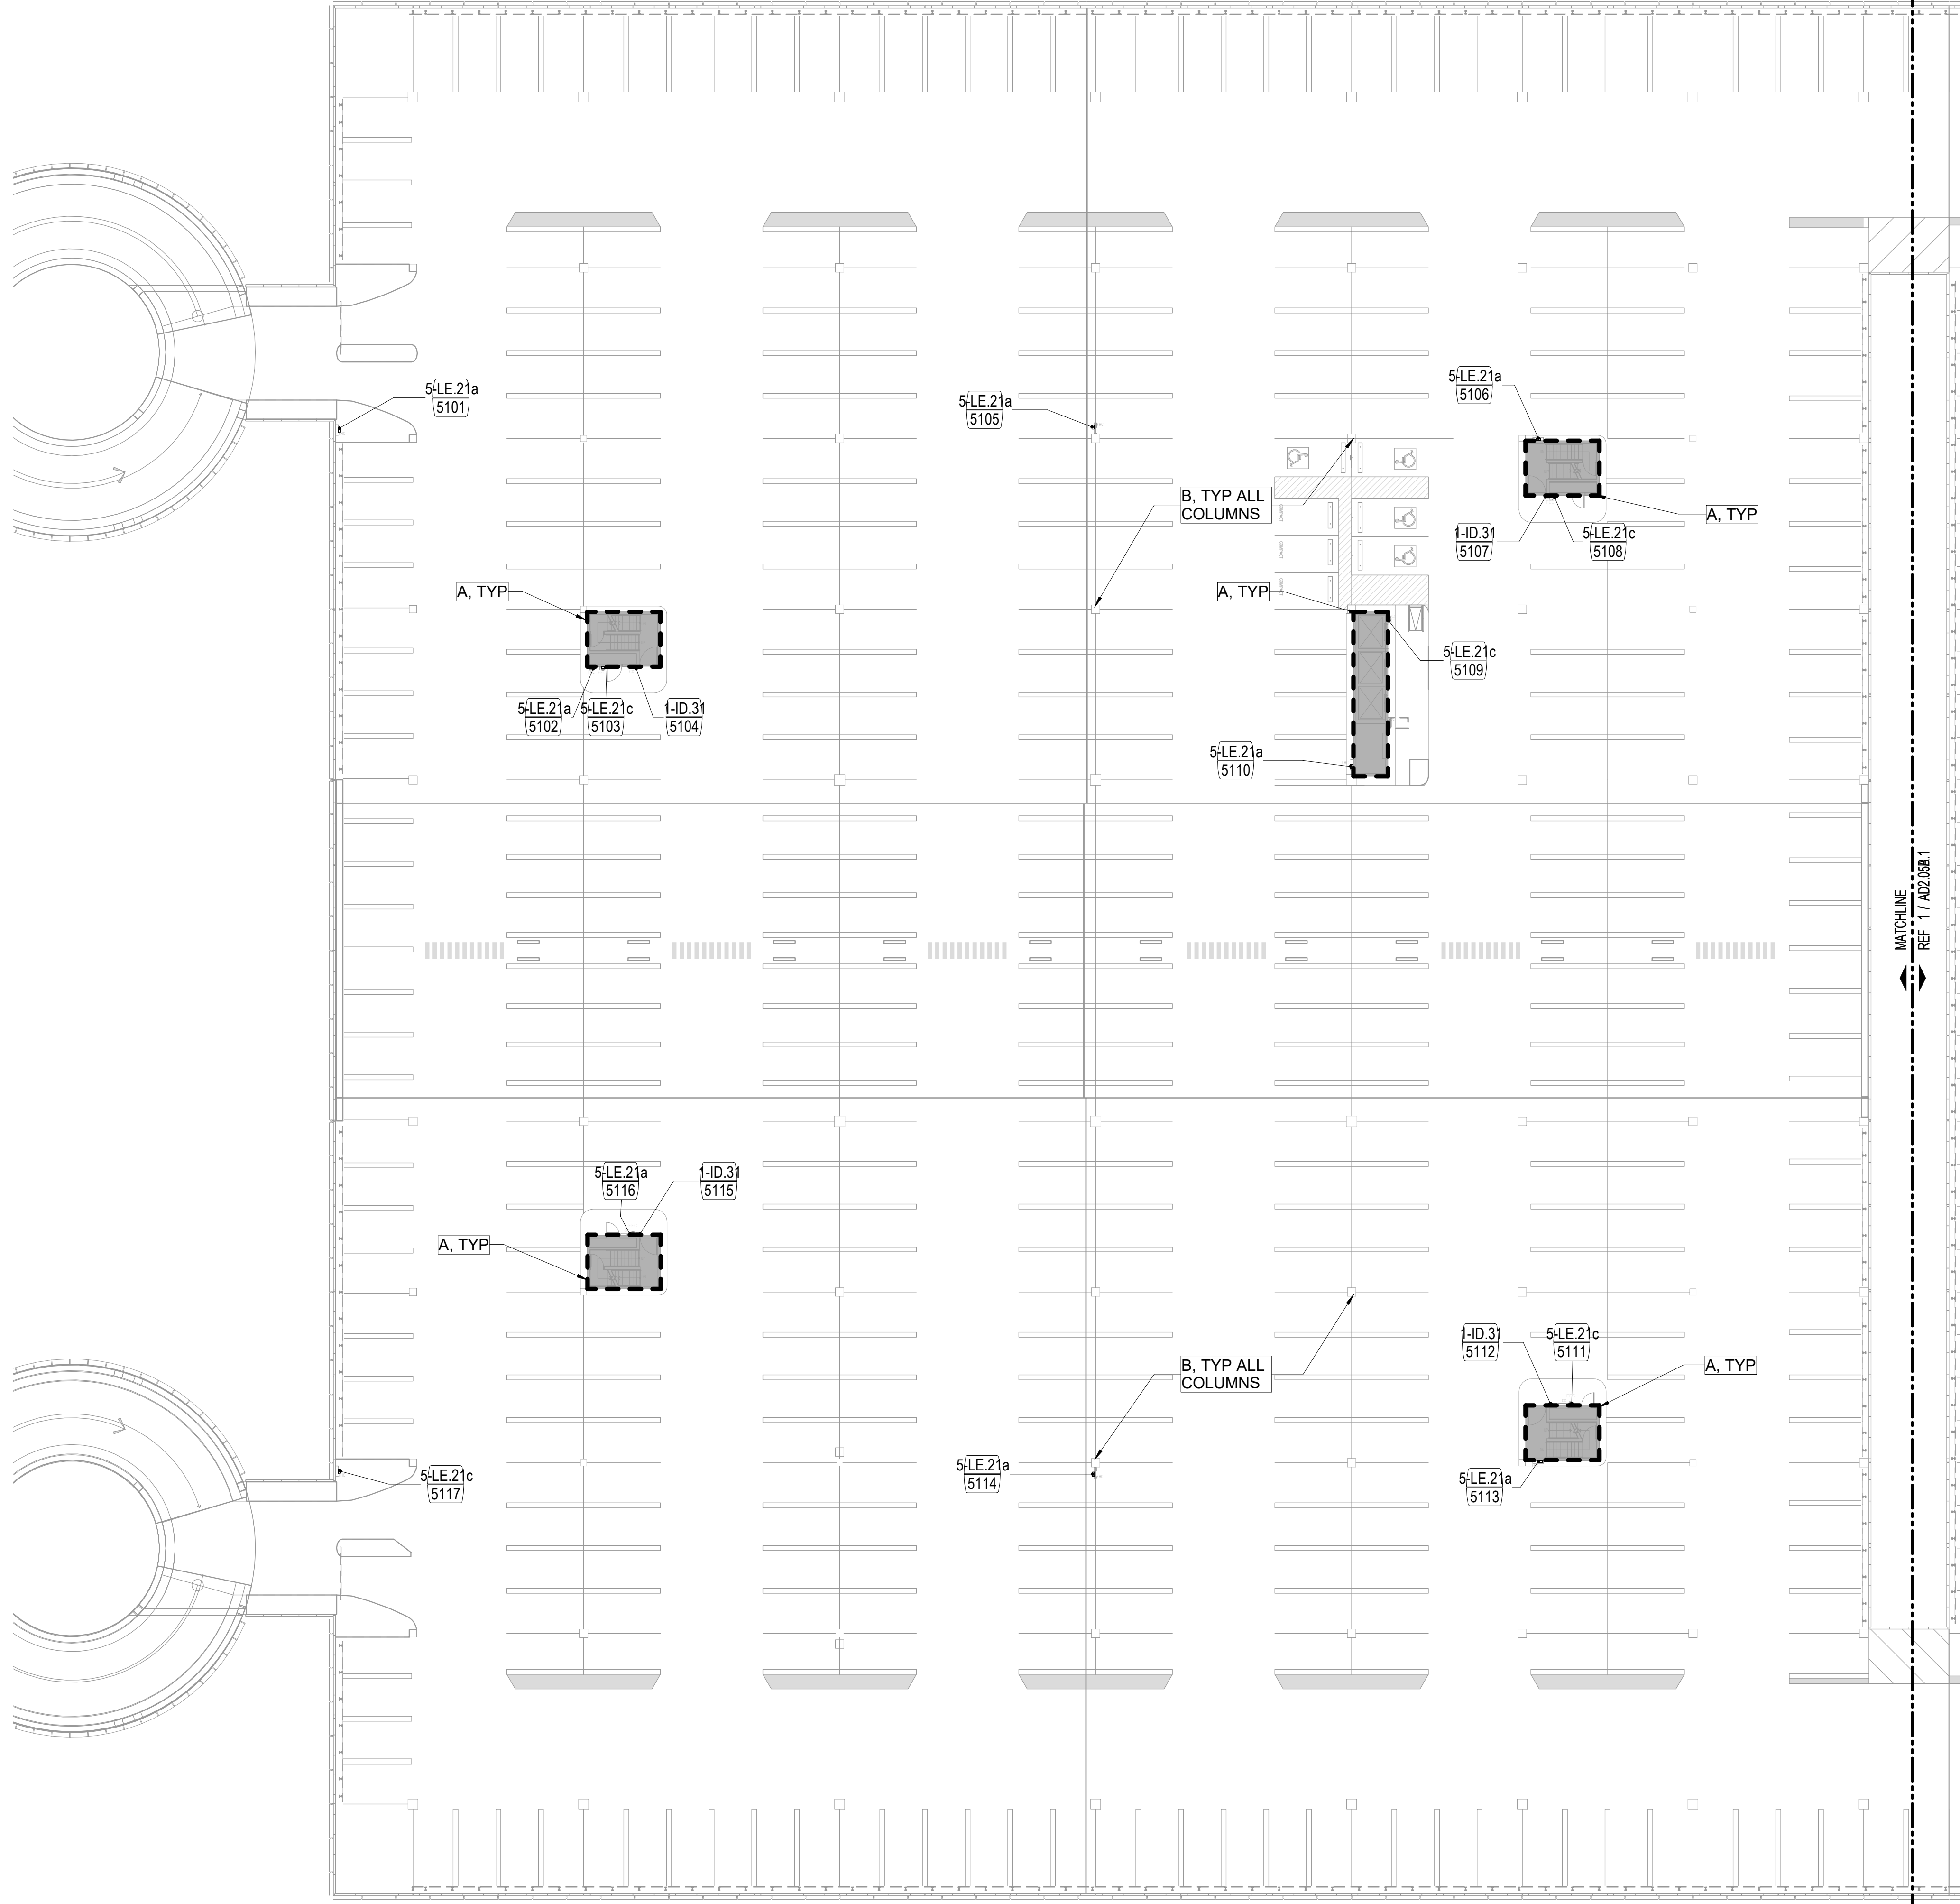FILE NAME: C:\Revit\Locals\TERM C SIGNAGE GARAGE\_DBhatti@pgal.com.rvt  
 DATE/TIME: 4/8/2024 4:39:39 PM





SIGNAGE SCHEDULE - LEVEL 05 - SECTOR A						
SIGN NUMBER	SIGN TYPE	HAS SYMBOL	TEXT LINE 1	TEXT LINE 2	TEXT LINE 3	REFERENCE PLAN
5101	5-LE.21a	FIRE HOSE REEL				2-37
5102	5-LE.21a	FIRE HOSE REEL				2-37
5103	5-LE.21c	FIRE EXTINGUISHER				2-37
5104	1-ID.31	STAIR	STAIR 10	LEVEL 5	NO RE-ENTRY	2-30
5105	5-LE.21a	FIRE HOSE REEL				2-37
5106	5-LE.21a	FIRE HOSE REEL				2-37
5107	1-ID.31	STAIR	STAIR 8	LEVEL 5	NO RE-ENTRY	2-30
5108	5-LE.21c	FIRE EXTINGUISHER				2-37
5109	5-LE.21c	FIRE EXTINGUISHER				2-37
5110	5-LE.21a	FIRE HOSE REEL				2-37
5111	5-LE.21c	FIRE EXTINGUISHER				2-37
5112	1-ID.31	STAIR	STAIR 9	LEVEL 5	NO RE-ENTRY	2-30
5113	5-LE.21a	FIRE HOSE REEL				2-37
5114	5-LE.21a	FIRE HOSE REEL				2-37
5115	1-ID.31	STAIR	STAIR 11	LEVEL 5	NO RE-ENTRY	2-30
5116	5-LE.21a	FIRE EXTINGUISHER				2-37
5117	5-LE.21c	FIRE HOSE REEL				2-37

**FLOOR PLAN KEYNOTES**

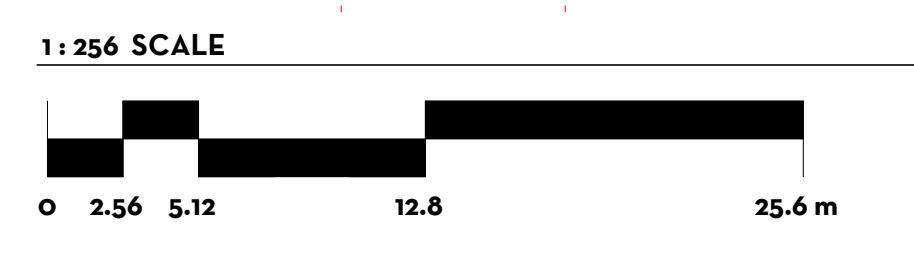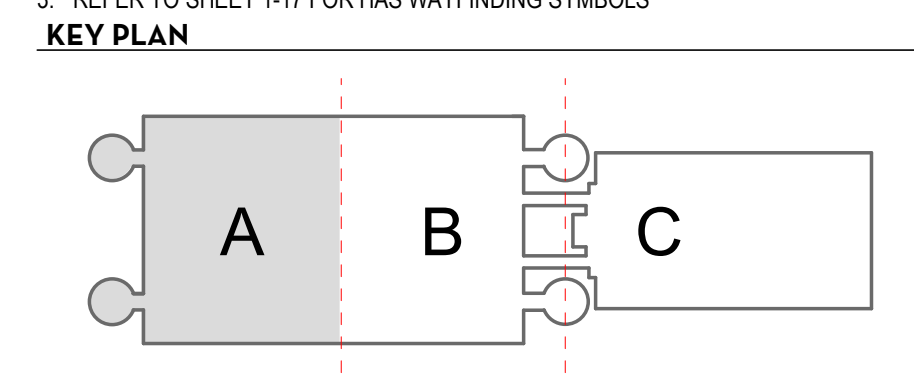- A SKIM COAT WITH SIKA QUICK SMOOTH FINISH AT EXTERIOR WALL PERIMETER AT ELEVATOR AND STAIR CORES. TO BE PRIMED AND PAINTED.
- B SKIM COAT WITH SIKA QUICK SMOOTH FINISH AT ALL GARAGE COLUMNS ONLY. TO BE PRIMED AND PAINTED. REFER TO \*\* IN REGARDS TO APPROXIMATE COLUMN QUANTITY.

**GENERAL NOTES**

1. REFER TO SHEETS 1-1 THROUGH 10-24 FOR ADDITIONAL INFORMATION, INCLUDING NEW SIGN LOCATIONS, SIGN TYPES, AND MOUNTING DETAILS
2. REFER TO SHEET AG3.000 FOR ADDITIONAL SIGN TYPES
3. REFER TO SHEET 1-17 FOR HAS WAYFINDING SYMBOLS



**LEGEND**

SIGN MARK  
 X-XX.XX  
 XXXX  
 KEYNOTE

**PLAN NORTH**

\*\* 80 +/- COLUMNS TO BE PAINTED IN THIS SECTOR. V.I.F.  
**LEVEL 05 - FLOOR PLAN - SECTOR A** 3/64" = 1'-0" 1

CLIENT  
  
 Client Name

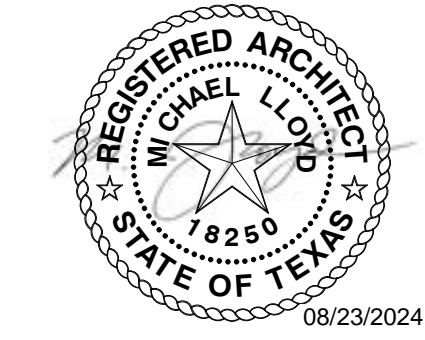
ARCHITECT  
  
 PGAL

PGAL  
 3131 BRIARPARK DR.  
 SUITE 200  
 HOUSTON, TX 77042  
 [T] 713 622 1444  
 [F] 713 968 9333  
 www.pgal.com

BSG PRJCT#  
 BSG-2024-111-IAH

DEPARTMENT OF AVIATION  
 RECOMMENDED:  
 HOUSTON AIRPORT SYSTEM  
 DIRECTOR OR DESIGN REPRESENTATIVE  
 HAS TIP # 24-103 - IAH

REGISTRATION  
 Copyright © 2024



**DRAWING HISTORY**

NO.	DATE	DESCRIPTION
01	04/10/2024	ISSUE FOR PERMIT
02	08/23/2024	ISSUE FOR BID

PROJECT NAME  
**IAH TERMINAL C GARAGE SIGNAGE & WAYFINDING**

PROJECT LOCATION  
 TERMINAL C  
 3500 NORTH TERMINAL RD.  
 HOUSTON, TX 77032

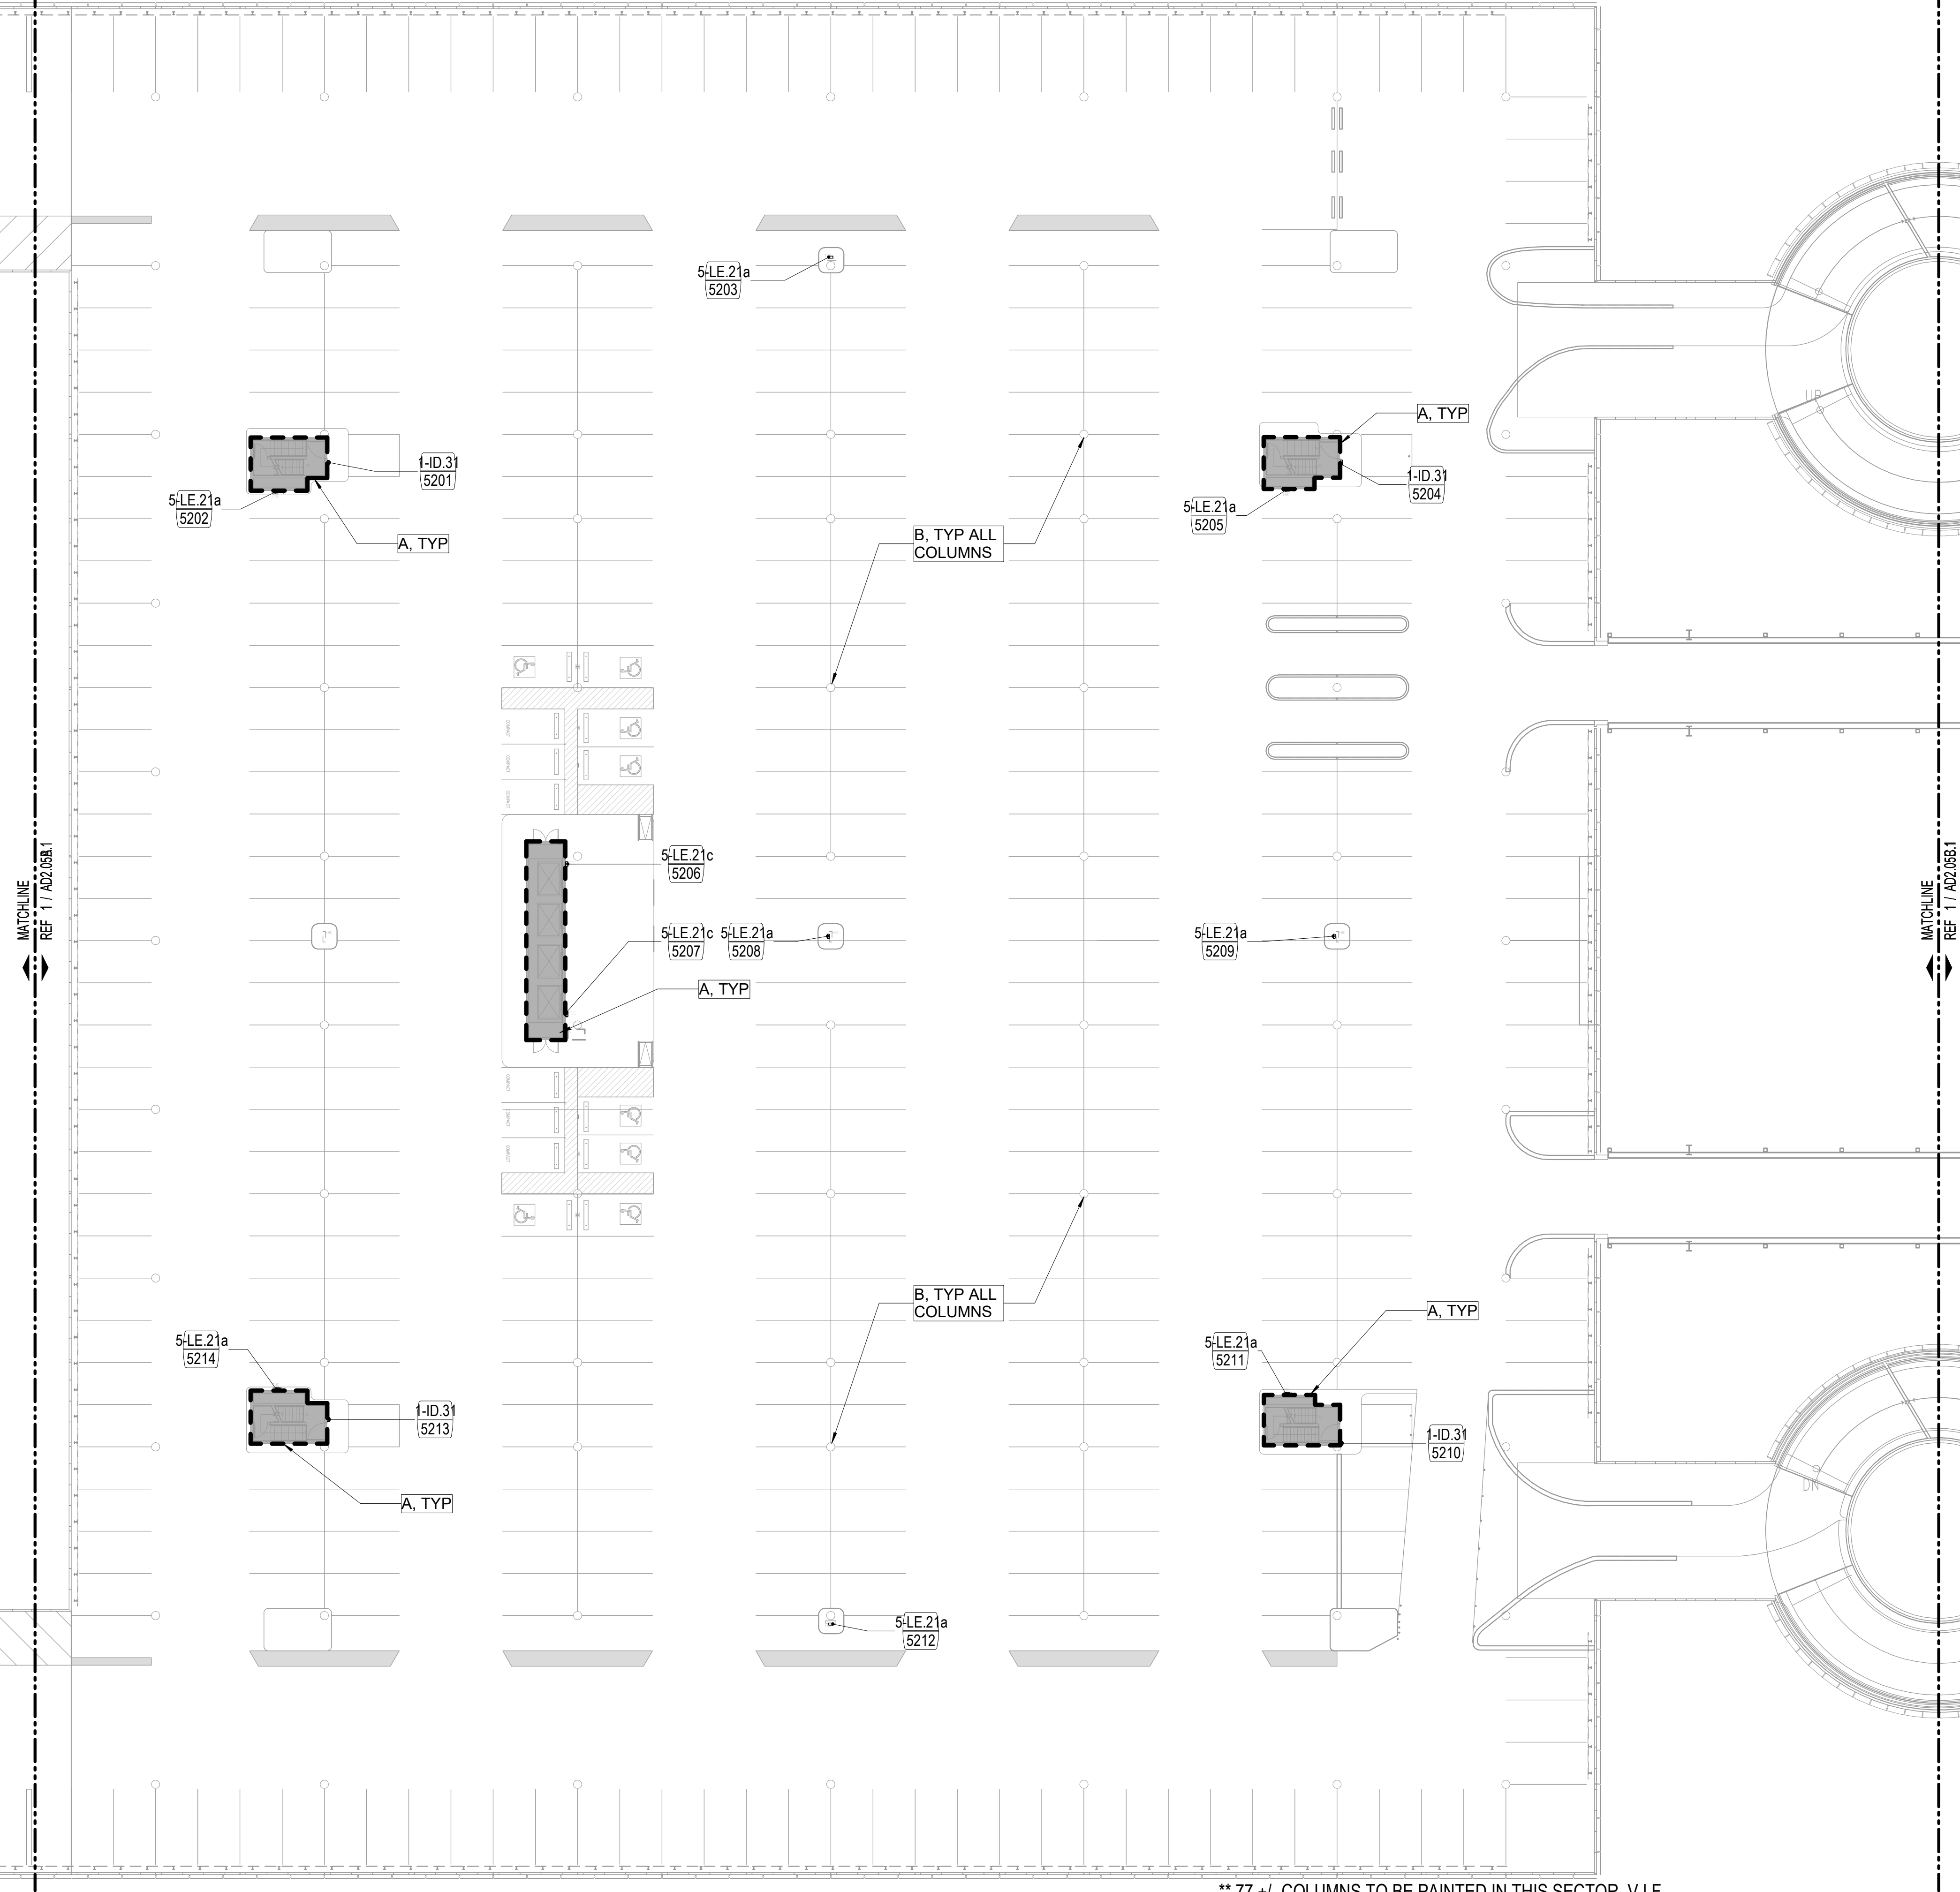
PROJECT NUMBER  
 1004395

SHEET TITLE  
 LEVEL 05A FLOOR PLAN

SHEET NUMBER

**A2.05A**

FILE NAME: C:\Revit\Locals\TERM C SIGNAGE GARAGE\_DBhatti@pgal.com.rvt  
 DATE/TIME: 4/8/2024 4:39:41 PM



\*\* 77 +/- COLUMNS TO BE PAINTED IN THIS SECTOR, V.I.F.

**LEVEL 05 - FLOOR PLAN - SECTOR B** 3/64" = 1'-0" 1

**SIGNAGE SCHEDULE - LEVEL 05 - SECTOR B**

SIGN NUMBER	SIGN TYPE	HAS SYMBOL	TEXT LINE 1	TEXT LINE 2	TEXT LINE 3	REFERENCE PLAN
5201	1-ID.31	STAIR	STAIR 4	LEVEL 5	NO RE-ENTRY	2-30
5202	5-LE.21a	FIRE HOSE REEL				2-37
5203	5-LE.21a	FIRE HOSE REEL				2-37
5204	1-ID.31	STAIR	STAIR 6	LEVEL 5	NO RE-ENTRY	2-30
5205	5-LE.21a	FIRE HOSE REEL				2-37
5206	5-LE.21c	FIRE EXTINGUISHER				2-37
5207	5-LE.21c	FIRE EXTINGUISHER				2-37
5208	5-LE.21a	FIRE HOSE REEL				2-37
5209	5-LE.21a	FIRE HOSE REEL				2-37
5210	1-ID.31	STAIR	STAIR 7	LEVEL 5	NO RE-ENTRY	2-30
5211	5-LE.21a	FIRE HOSE REEL				2-37
5212	5-LE.21a	FIRE HOSE REEL				2-37
5213	1-ID.31	STAIR	STAIR 5	LEVEL 5	NO RE-ENTRY	2-30
5214	5-LE.21a	FIRE HOSE REEL				2-37



Client Name

ARCHITECT



PGAL  
 3131 BRIARPARK DR.  
 SUITE 200  
 HOUSTON, TX 77042  
 [T] 713 622 1444  
 [F] 713 968 9333  
 www.pgal.com

BSG PRJCT#  
 BSG-2024-111-IAH

DEPARTMENT OF AVIATION  
 RECOMMENDED:  
 HOUSTON AIRPORT SYSTEM  
 DIRECTOR OR DESIGN REPRESENTATIVE  
 HAS TIP # 24-103 - IAH

REGISTRATION  
 Copyright © 2024



**DRAWING HISTORY**

NO.	DATE	DESCRIPTION
01	04/10/2024	ISSUE FOR PERMIT
02	08/23/2024	ISSUE FOR BID

**PROJECT NAME**  
 IAH TERMINAL C  
 GARAGE  
 SIGNAGE &  
 WAYFINDING

**PROJECT LOCATION**  
 TERMINAL C  
 3500 NORTH  
 TERMINAL RD.  
 HOUSTON, TX 77032

**PROJECT NUMBER**  
 1004395

**SHEET TITLE**  
 LEVEL 05B FLOOR  
 PLAN

**SHEET NUMBER**

**A2.05B**

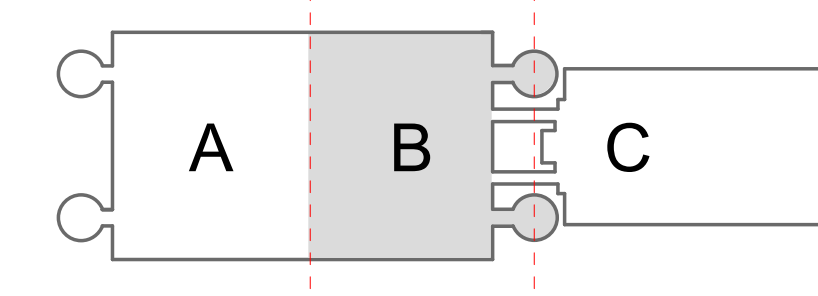
**FLOOR PLAN KEYNOTES**

- A SKIM COAT WITH SIKA QUICK SMOOTH FINISH AT EXTERIOR WALL PERIMETER AT ELEVATOR AND STAIR CORES. TO BE PRIMED AND PAINTED.
- B SKIM COAT WITH SIKA QUICK SMOOTH FINISH AT ALL GARAGE COLUMNS ONLY. TO BE PRIMED AND PAINTED. REFER TO \*\* IN REGARDS TO APPROXIMATE COLUMN QUANTITY.

**GENERAL NOTES**

- REFER TO SHEETS 1-1 THROUGH 10-24 FOR ADDITIONAL INFORMATION, INCLUDING NEW SIGN LOCATIONS, SIGN TYPES, AND MOUNTING DETAILS
- REFER TO SHEET AG3.000 FOR ADDITIONAL SIGN TYPES
- REFER TO SHEET 1-17 FOR HAS WAYFINDING SYMBOLS


**KEY PLAN**




1:256 SCALE



**LEGEND**

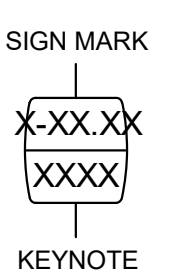


**PLAN NORTH**

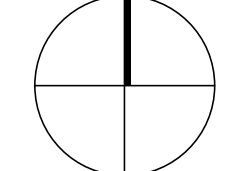



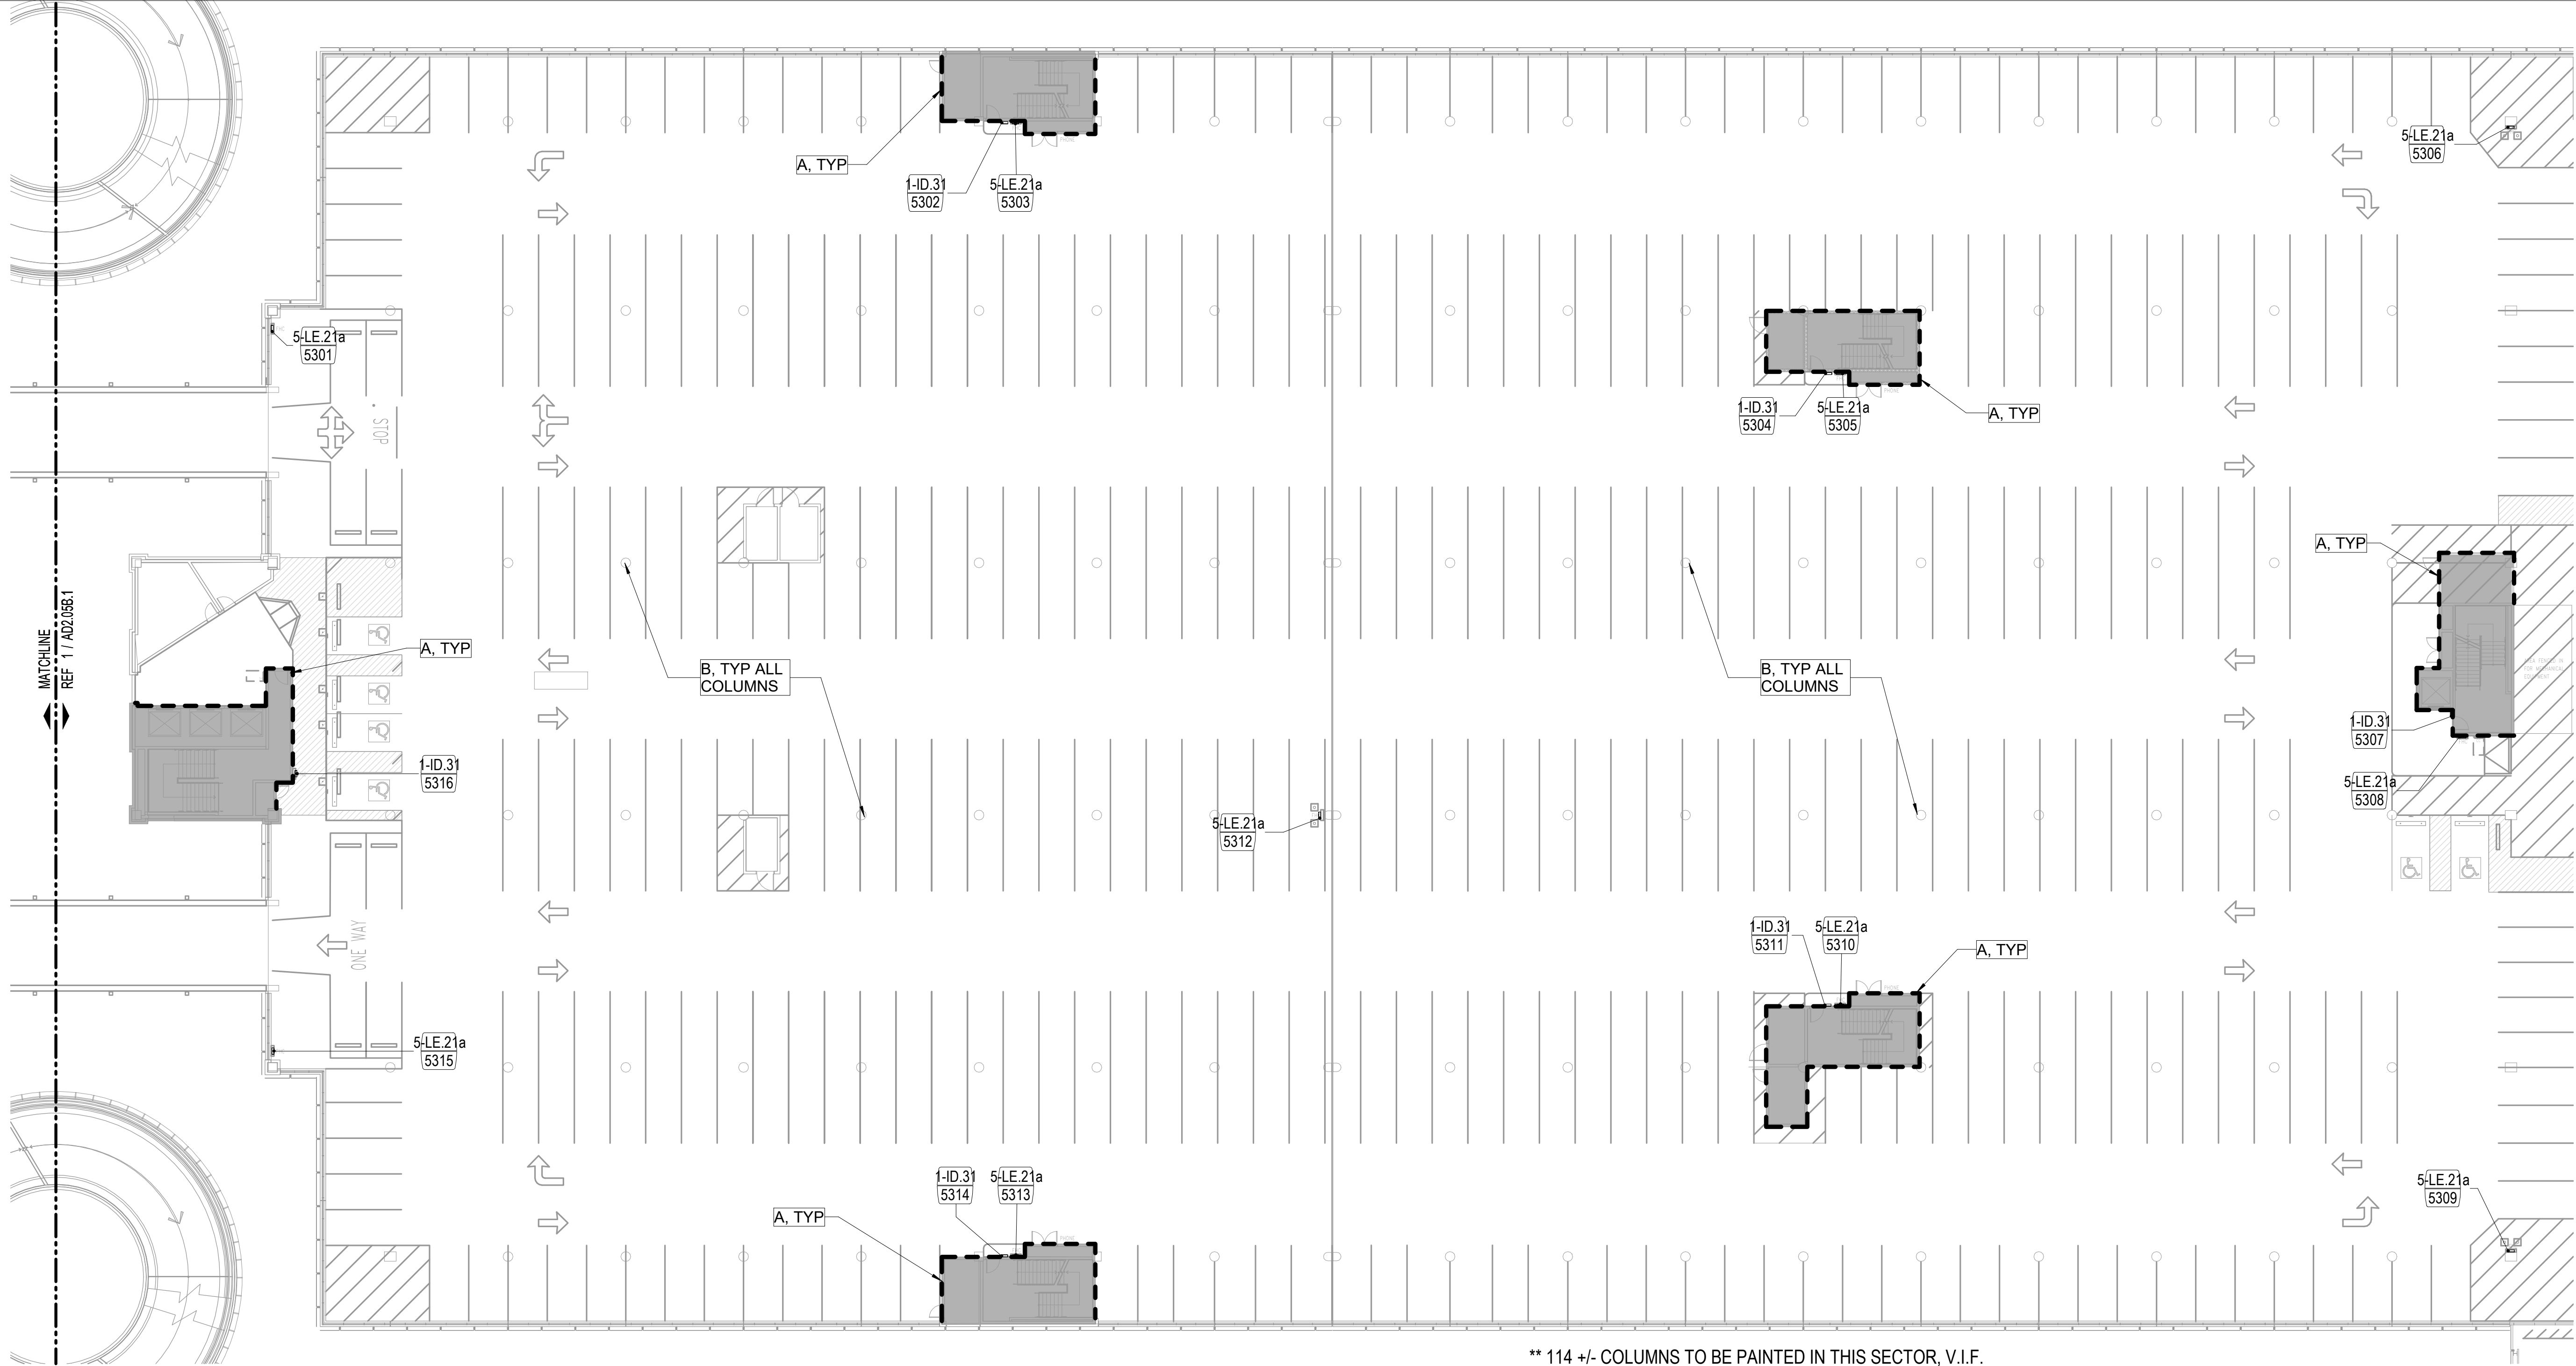FILE NAME: C:\Revit\Locals\TERM C SIGNAGE GARAGE\_DBhatti@pgal.com.rvt  
 DATE/TIME: 4/8/2024 4:39:42 PM



\*\* 114 +/- COLUMNS TO BE PAINTED IN THIS SECTOR, V.I.F.  
**LEVEL 05 - FLOOR PLAN - SECTOR C** 3/64" = 1'-0" 1





SIGNAGE SCHEDULE - LEVEL 05 - SECTOR C						
SIGN NUMBER	SIGN TYPE	HAS SYMBOL	TEXT LINE 1	TEXT LINE 2	TEXT LINE 3	REFERENCE PLAN
5301	5-LE.21a	FIRE HOSE REEL				2-37
5302	1-ID.31	STAIR	STAIR 2	LEVEL 5	NO RE-ENTRY	2-30
5303	5-LE.21a	FIRE HOSE REEL				2-37
5304	1-ID.31	STAIR	STAIR 4	LEVEL 5	NO RE-ENTRY	2-30
5305	5-LE.21a	FIRE HOSE REEL				2-37
5306	5-LE.21a	FIRE HOSE REEL				2-37
5307	1-ID.31	STAIR	STAIR 6	LEVEL 5	NO RE-ENTRY	2-30
5308	5-LE.21a	FIRE HOSE REEL				2-37
5309	5-LE.21a	FIRE HOSE REEL				2-37
5310	5-LE.21a	FIRE HOSE REEL				2-37
5311	1-ID.31	STAIR	STAIR 5	LEVEL 5	NO RE-ENTRY	2-30
5312	5-LE.21a	FIRE HOSE REEL				2-37
5313	5-LE.21a	FIRE HOSE REEL				2-37
5314	1-ID.31	STAIR	STAIR 3	LEVEL 5	NO RE-ENTRY	2-30
5315	5-LE.21a	FIRE HOSE REEL				2-37

**FLOOR PLAN KEYNOTES**

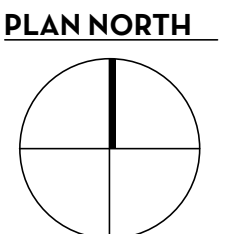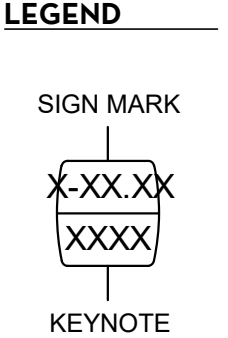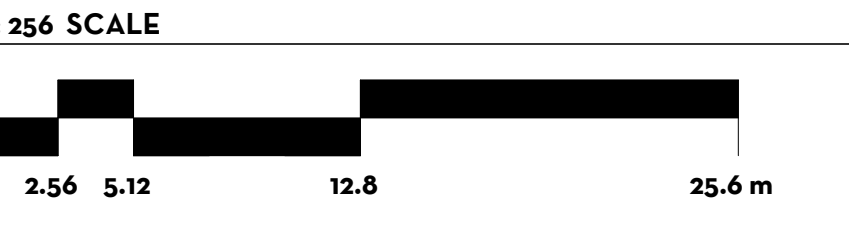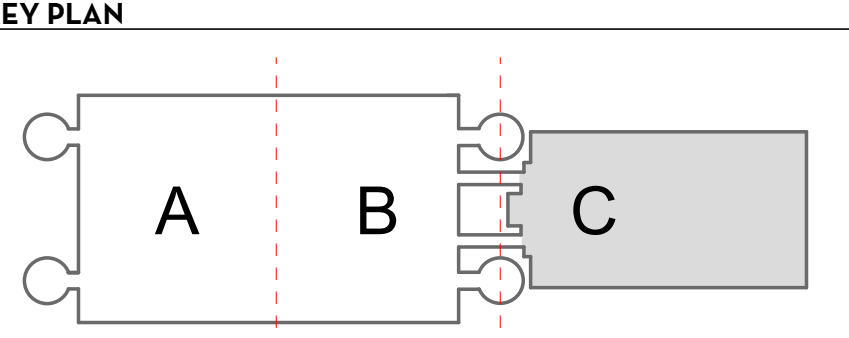- A SKIM COAT WITH SIKA QUICK SMOOTH FINISH AT EXTERIOR WALL PERIMETER AT ELEVATOR AND STAIR CORES. TO BE PRIMED AND PAINTED.
- B SKIM COAT WITH SIKA QUICK SMOOTH FINISH AT ALL GARAGE COLUMNS ONLY. TO BE PRIMED AND PAINTED. REFER TO \*\* IN REGARDS TO APPROXIMATE COLUMN QUANTITY.

**GENERAL NOTES**

- REFER TO SHEETS 1-1 THROUGH 10-24 FOR ADDITIONAL INFORMATION, INCLUDING NEW SIGN LOCATIONS, SIGN TYPES, AND MOUNTING DETAILS
- REFER TO SHEET AG3.000 FOR ADDITIONAL SIGN TYPES
- REFER TO SHEET 1-17 FOR HAS WAYFINDING SYMBOLS



Client Name

ARCHITECT



PGAL  
 3131 BRIARPARK DR.  
 SUITE 200  
 HOUSTON, TX 77042  
 [T] 713 622 1444  
 [F] 713 968 9333  
 www.pgal.com

BSG PRJCT#  
 BSG-2024-111-IAH

DEPARTMENT OF AVIATION  
 RECOMMENDED:  
 HOUSTON AIRPORT SYSTEM  
 DIRECTOR OR DESIGN REPRESENTATIVE  
 HAS TIP # 24-103 - IAH

REGISTRATION  
 Copyright © 2024



**DRAWING HISTORY**

NO.	DATE	DESCRIPTION
01	04/10/2024	ISSUE FOR PERMIT
02	08/23/2024	ISSUE FOR BID

PROJECT NAME  
**IAH TERMINAL C  
 GARAGE  
 SIGNAGE &  
 WAYFINDING**

PROJECT LOCATION  
 TERMINAL C  
 3500 NORTH  
 TERMINAL RD.  
 HOUSTON, TX 77032

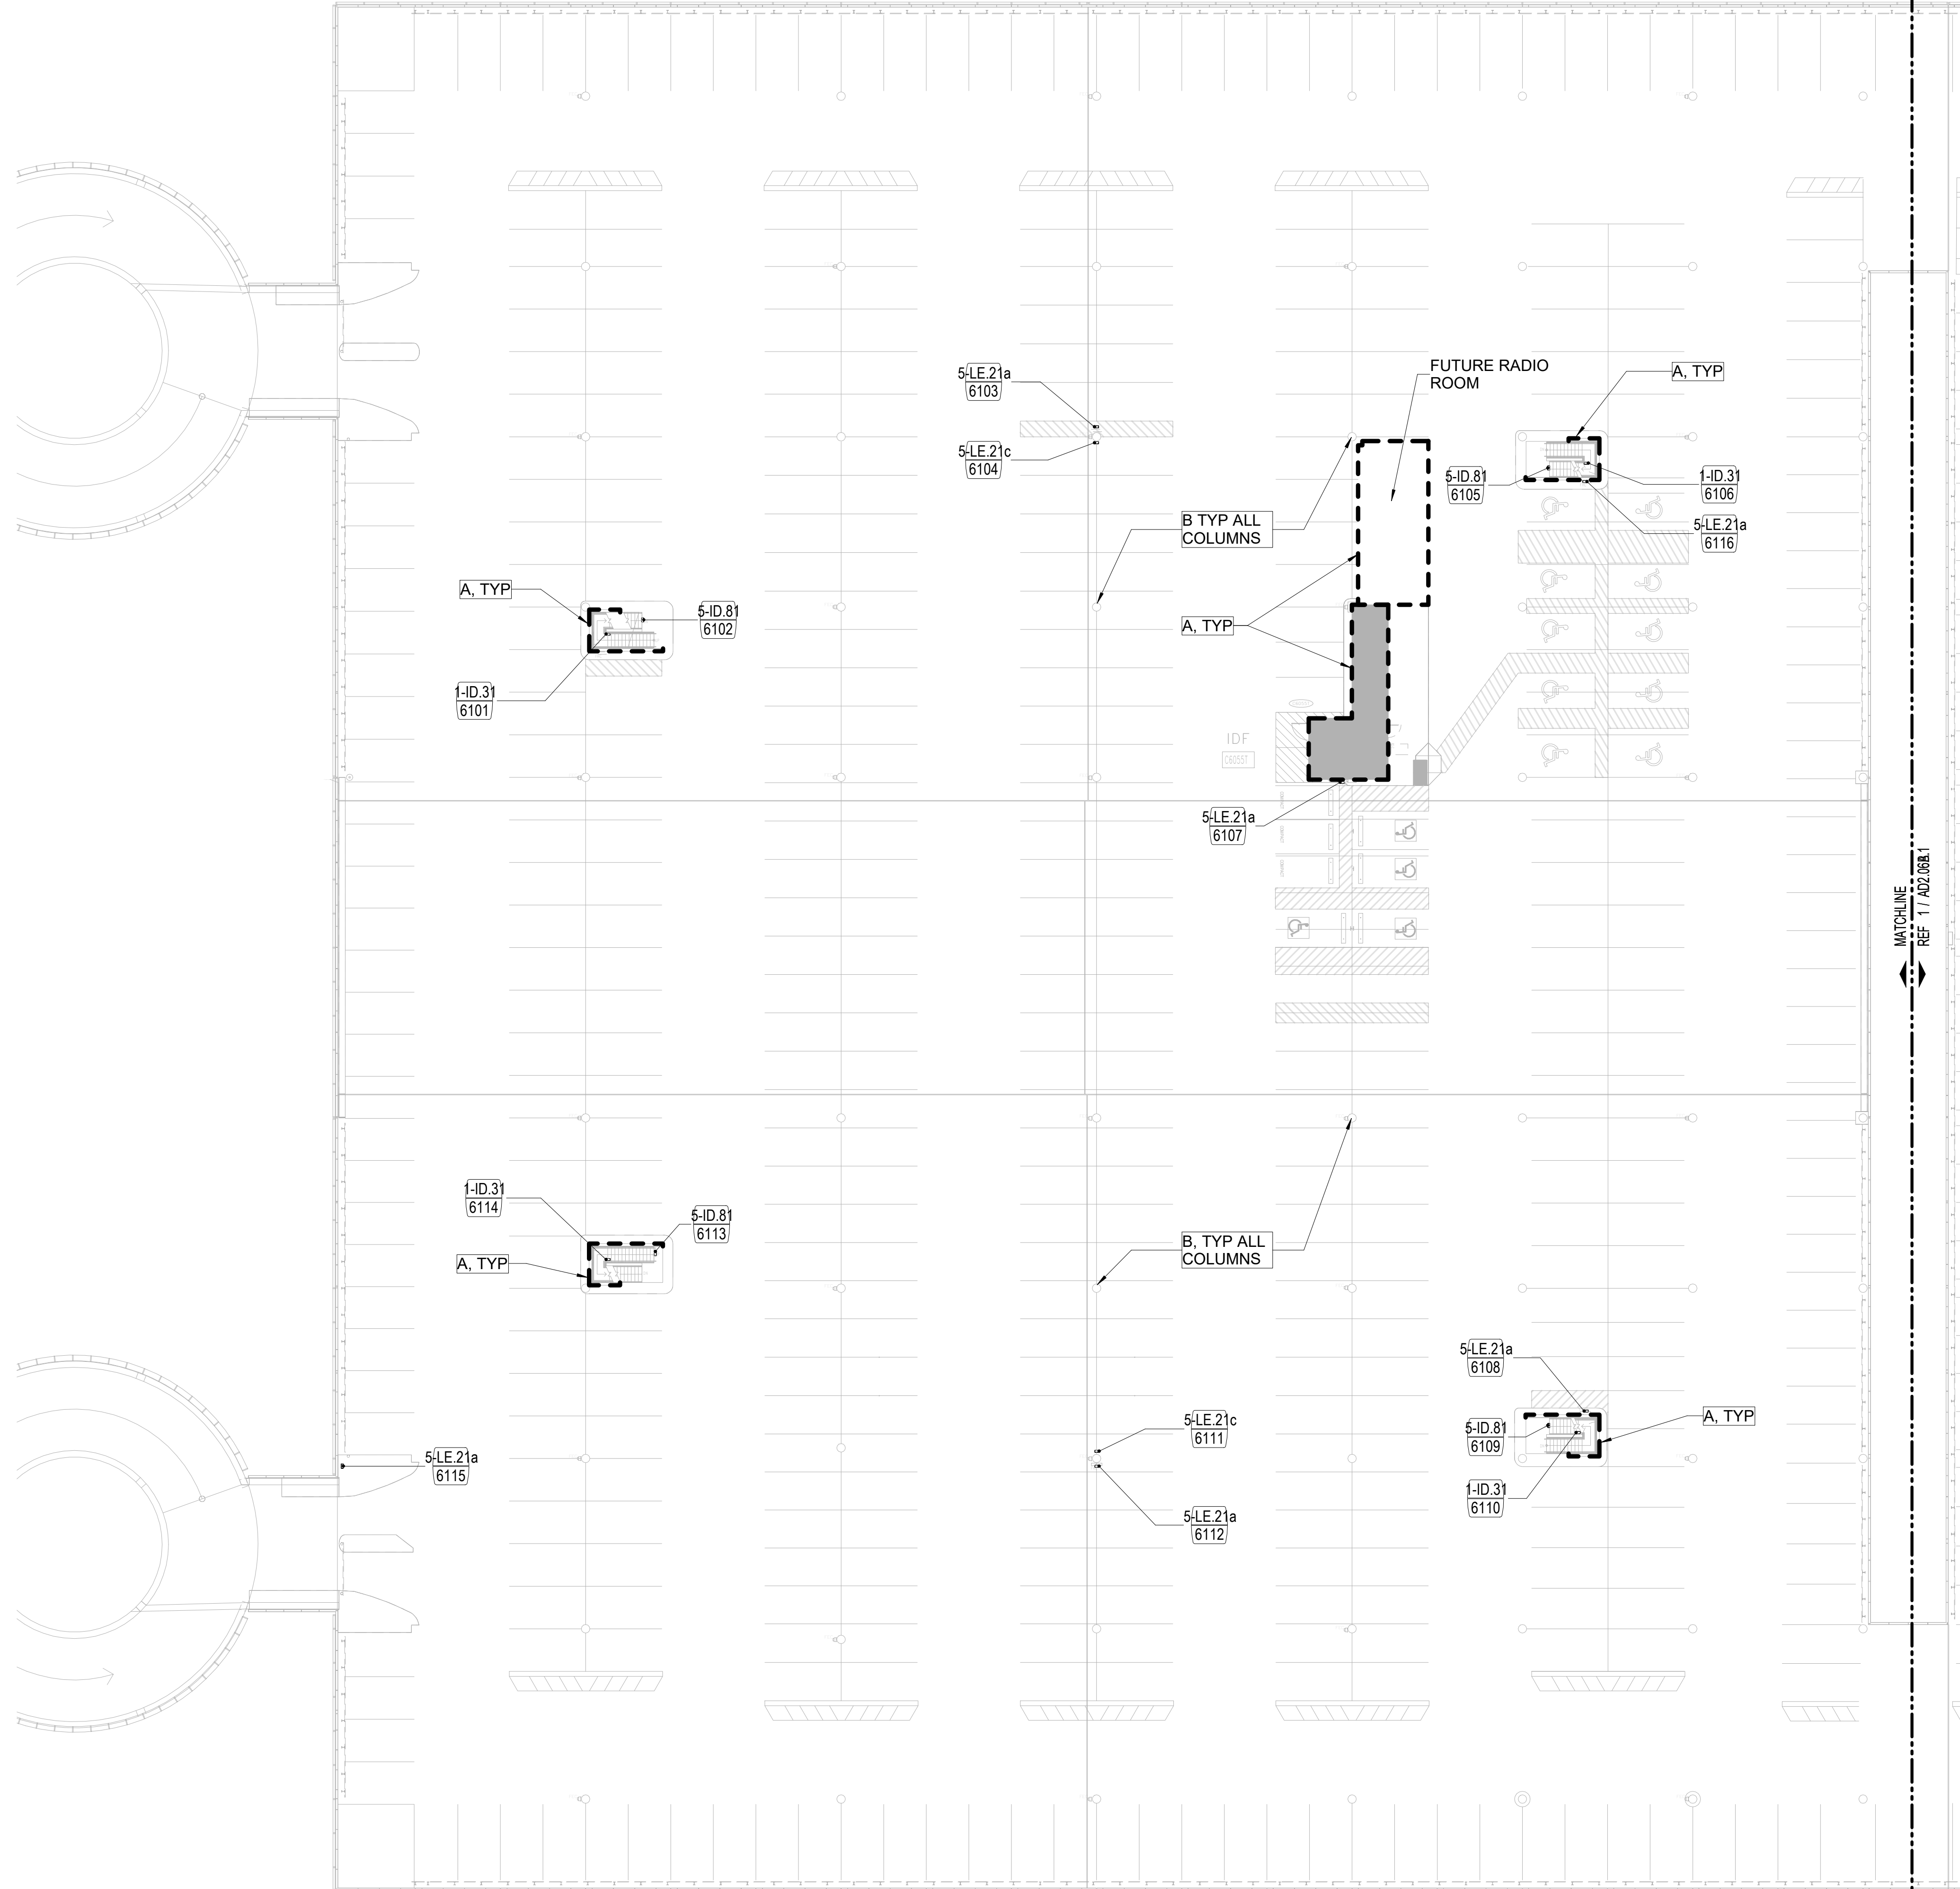
PROJECT NUMBER  
 1004395

SHEET TITLE  
**LEVEL 05C FLOOR  
 PLAN**

SHEET NUMBER

**A2.05C**

FILE NAME: C:\Revit\Locals\TERM C SIGNAGE GARAGE\_DBhatti@pgal.com.rvt  
 DATE/TIME: 8/23/2024 4:39:43 PM



\*\* 70 +/- COLUMNS TO BE PAINTED IN THIS SECTOR, V.I.F.

LEVEL 06 - FLOOR PLAN - SECTOR A 3/64" = 1'-0" 1

SIGNAGE SCHEDULE - LEVEL 06 - SECTOR A						
SIGN NUMBER	SIGN TYPE	HAS SYMBOL	TEXT LINE 1	TEXT LINE 2	TEXT LINE 3	REFERENCE PLAN
6101	1-ID.31		STAIR	STAIR 10	LEVEL 6	NO RE-ENTRY 2-30
6102	5-ID.81					2-36
6103	5-LE.21a		FIRE HOSE REEL			2-37
6104	5-LE.21c		FIRE EXTINGUISHER			2-37
6105	5-ID.81					2-36
6106	1-ID.31		STAIR	STAIR 8	LEVEL 6	NO RE-ENTRY 2-30
6107	5-LE.21a		FIRE HOSE REEL			2-37
6108	5-LE.21a		FIRE HOSE REEL			2-37
6109	5-ID.81					2-36
6110	1-ID.31		STAIR	STAIR 9	LEVEL 6	NO RE-ENTRY 2-30
6111	5-LE.21c		FIRE EXTINGUISHER			2-37
6112	5-LE.21a		FIRE HOSE REEL			2-37
6113	5-ID.81					2-36
6114	1-ID.31		STAIR	STAIR 11	LEVEL 6	NO RE-ENTRY 2-30
6115	5-LE.21a		FIRE HOSE REEL			2-37
6116	5-LE.21a		FIRE HOSE REEL			2-37

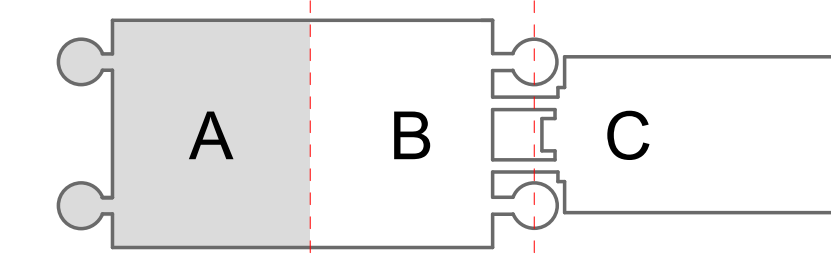
FLOOR PLAN KEYNOTES

- A SKIM COAT WITH SIKA QUICK SMOOTH FINISH AT EXTERIOR WALL PERIMETER AT ELEVATOR AND STAIR CORES. TO BE PRIMED AND PAINTED.
- B SKIM COAT WITH SIKA QUICK SMOOTH FINISH AT ALL GARAGE COLUMNS ONLY. TO BE PRIMED AND PAINTED. REFER TO \*\* IN REGARDS TO APPROXIMATE COLUMN QUANTITY.


GENERAL NOTES

- REFER TO SHEETS 1-1 THROUGH 10-24 FOR ADDITIONAL INFORMATION, INCLUDING NEW SIGN LOCATIONS, SIGN TYPES, AND MOUNTING DETAILS
- REFER TO SHEET AG3.000 FOR ADDITIONAL SIGN TYPES
- REFER TO SHEET 1-17 FOR HAS WAYFINDING SYMBOLS


KEY PLAN




1:256 SCALE

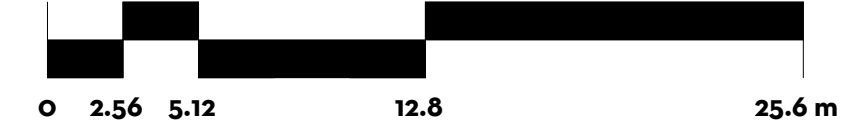

LEGEND

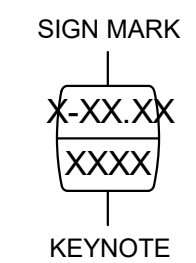

PLAN NORTH

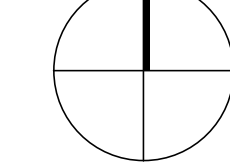

CLIENT



Client Name

ARCHITECT



PGAL  
 3131 BRIARPARK DR.  
 SUITE 200  
 HOUSTON, TX 77042  
 [T] 713 622 1444  
 [F] 713 968 9333  
 www.pgal.com

BSG PRJCT#  
 BSG-2024-111-IAH

DEPARTMENT OF AVIATION  
 RECOMMENDED:  
 HOUSTON AIRPORT SYSTEM  
 DIRECTOR OR DESIGN REPRESENTATIVE  
 HAS TIP # 24-103 - IAH

REGISTRATION  
 Copyright © 2024



DRAWING HISTORY

NO.	DATE	DESCRIPTION
01	04/10/2024	ISSUE FOR PERMIT
02	08/23/2024	ISSUE FOR BID

PROJECT NAME  
 IAH TERMINAL C  
 GARAGE  
 SIGNAGE &  
 WAYFINDING

PROJECT LOCATION  
 TERMINAL C  
 3500 NORTH  
 TERMINAL RD.  
 HOUSTON, TX 77032

PROJECT NUMBER  
 1004395

SHEET TITLE  
 LEVEL 06A FLOOR  
 PLAN

SHEET NUMBER

A2.06A

FILE NAME: R:\1003300-1004999\1004395.00\04\_DOCUMENTS\MODEL\TERM C SIGNAGE GARAGE RVT22.rvt  
 DATE/TIME: 4/9/2024 10:56:16 AM

MATCHLINE  
 REF 17 ADJ.048.1

MATCHLINE  
 REF 17 ADJ.048.1

\*\* 77 +/- COLUMNS TO BE PAINTED IN THIS SECTOR. V.I.F.

LEVEL 04 - FLOOR PLAN - SECTOR B

3/64" = 1'-0" 1

SIGNAGE SCHEDULE - LEVEL 04 - SECTOR B						
SIGN NUMBER	SIGN TYPE	HAS SYMBOL	TEXT LINE 1	TEXT LINE 2	TEXT LINE 3	REFERENCE PLAN
4201	5-LE.21a	FIRE HOSE REEL				2-37
4202	1-ID.31	STAIR	STAIR 4	LEVEL 4	NO RE-ENTRY	2-30
4203	5-LE.21a	FIRE HOSE REEL				2-37
4204	1-ID.31	STAIR	STAIR 6	LEVEL 4	NO RE-ENTRY	2-30
4205	5-LE.21a	FIRE HOSE REEL				2-37
4206	1t-RG.24					2-33
4207	5-LE.21c	FIRE EXTINGUISHER				2-37
4208	5-LE.21a	FIRE HOSE REEL				2-37
4209	1t-RG.24					2-33
4210	5-LE.21c	FIRE EXTINGUISHER				2-37
4211	5-LE.21a	FIRE HOSE REEL				2-37
4212	1-ID.31	STAIR	STAIR 7	LEVEL 4	NO RE-ENTRY	2-30
4213	5-LE.21a	FIRE HOSE REEL				2-37
4214	1-ID.31	STAIR	STAIR 5	LEVEL 4	NO RE-ENTRY	2-30
4215	5-LE.21a	FIRE HOSE REEL				2-37

CLIENT



Client Name

ARCHITECT



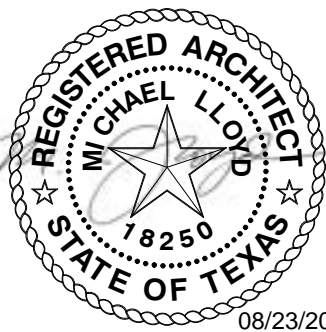
PGAL  
 3131 BRIARPARK DR.  
 SUITE 200  
 HOUSTON, TX 77042  
 [T] 713 622 1444  
 [F] 713 968 9333  
 www.pgal.com

BSG PRJCT#  
 BSG-2024-111-IAH

DEPARTMENT OF AVIATION  
 RECOMMENDED:

HAS TIP # 24-103 - IAH

REGISTRATION  
 Copyright © 2024



DRAWING HISTORY

NO.	DATE	DESCRIPTION
01	04/10/2024	ISSUE FOR PERMIT
02	08/23/2024	ISSUE FOR BID

PROJECT NAME  
 IAH TERMINAL C  
 GARAGE  
 SIGNAGE &  
 WAYFINDING

PROJECT LOCATION  
 TERMINAL C  
 3500 NORTH  
 TERMINAL RD.  
 HOUSTON, TX 77032

PROJECT NUMBER  
 1004395

SHEET TITLE  
 LEVEL 04B FLOOR  
 PLAN

SHEET NUMBER

A2.04B

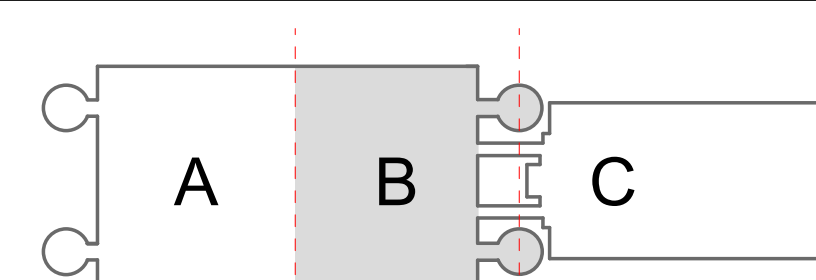
FLOOR PLAN KEYNOTES

- A SKIM COAT WITH SIKA QUICK SMOOTH FINISH AT EXTERIOR WALL PERIMETER AT ELEVATOR AND STAIR CORES. TO BE PRIMED AND PAINTED.
- B SKIM COAT WITH SIKA QUICK SMOOTH FINISH AT ALL GARAGE COLUMNS ONLY. TO BE PRIMED AND PAINTED. REFER TO \*\* IN REGARDS TO APPROXIMATE COLUMN QUANTITY.


GENERAL NOTES

- REFER TO SHEETS 1-1 THROUGH 10-24 FOR ADDITIONAL INFORMATION, INCLUDING NEW SIGN LOCATIONS, SIGN TYPES, AND MOUNTING DETAILS.
- REFER TO SHEET AG3.000 FOR ADDITIONAL SIGN TYPES.
- REFER TO SHEET 1-17 FOR HAS WAYFINDING SYMBOLS.


KEY PLAN




1: 256 SCALE

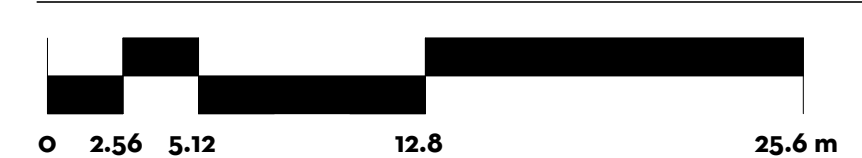


LEGEND

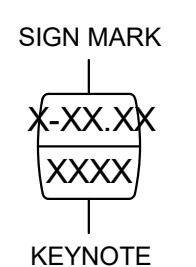

PLAN NORTH

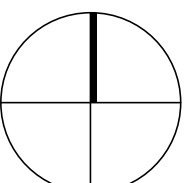

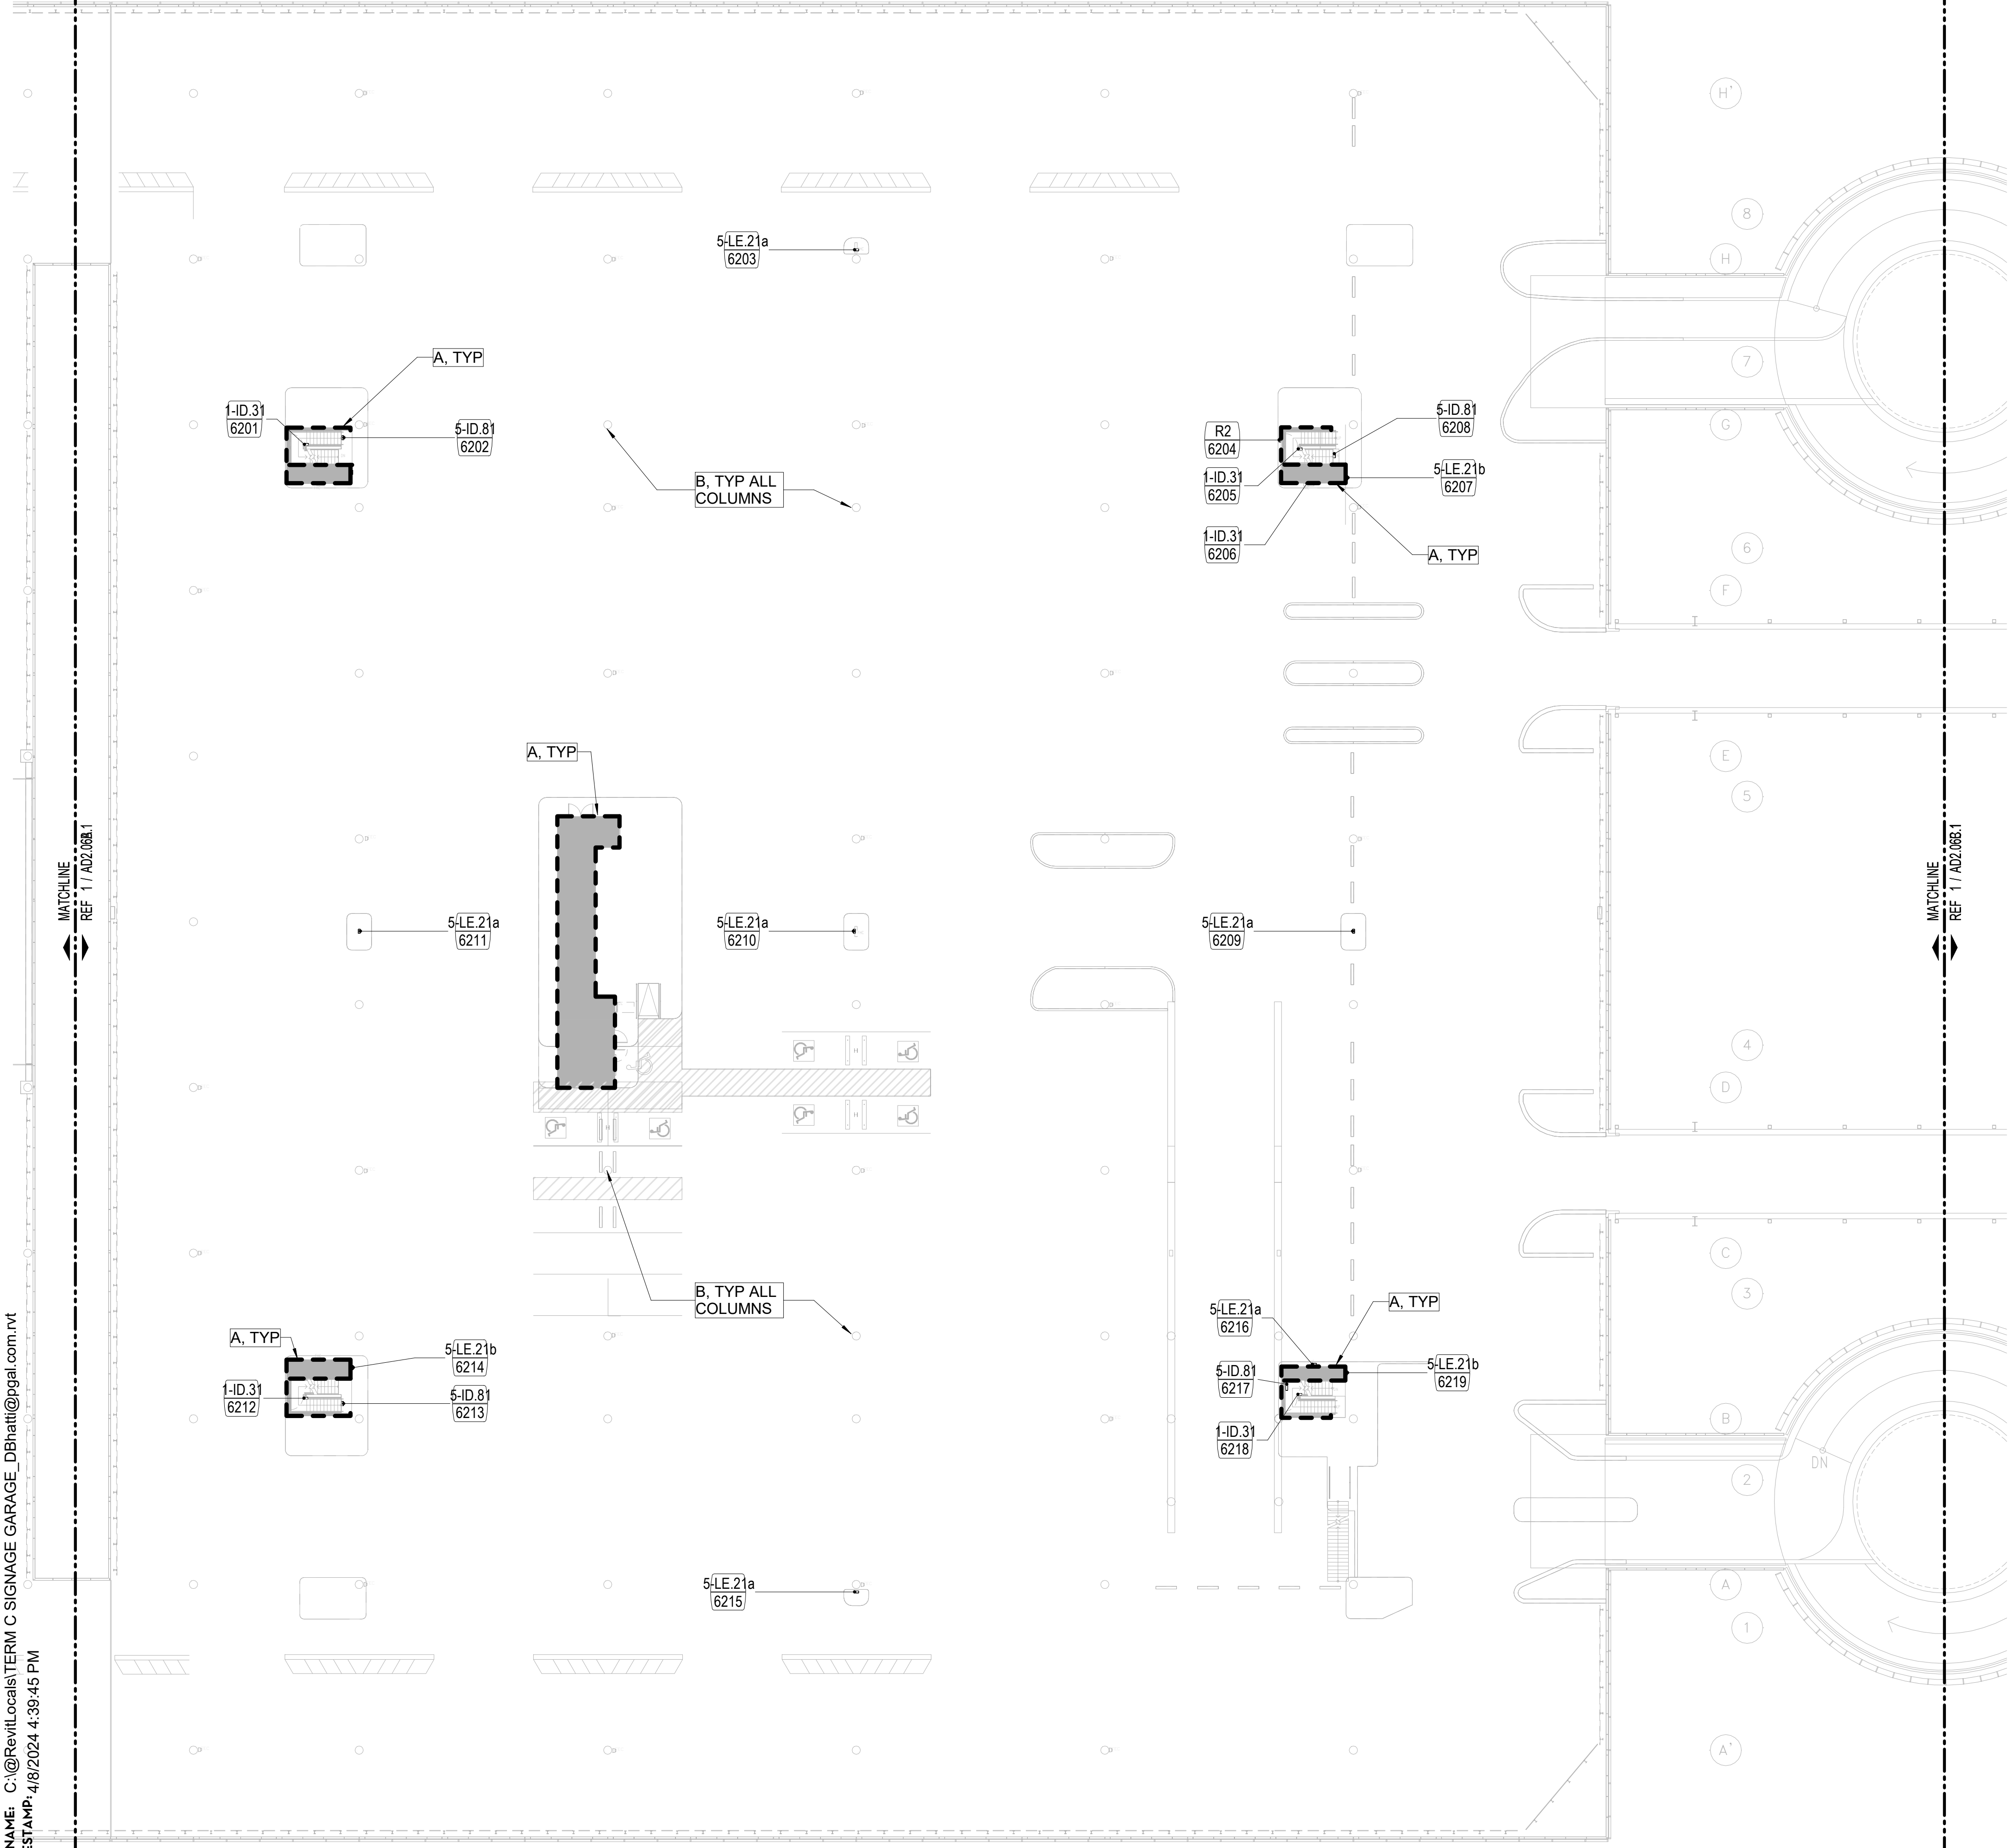

SIGNAGE SCHEDULE - LEVEL 06 - SECTOR B						
SIGN NUMBER	SIGN TYPE	HAS SYMBOL	TEXT LINE 1	TEXT LINE 2	TEXT LINE 3	REFERENCE PLAN
6201	1-ID.31		STAIR	STAIR 4	LEVEL 6	NO RE-ENTRY 2-30
6202	5-ID.81					2-36
6203	5-LE.21a		FIRE HOSE REEL			2-37
6204	R2					AG3.000
6205	1-ID.31		STAIR	STAIR 6	LEVEL 6	NO RE-ENTRY 2-30
6206	1-ID.31		FIRE HOSE REEL			2-30
6207	5-LE.21b		FIRE ALARM			2-37
6208	5-ID.81					2-36
6209	5-LE.21a		FIRE HOSE REEL			2-37
6210	5-LE.21a		FIRE HOSE REEL			2-37
6211	5-LE.21a		FIRE HOSE REEL			2-37
6212	1-ID.31		STAIR	STAIR 5	LEVEL 6	NO RE-ENTRY 2-30
6213	5-ID.81					2-36
6214	5-LE.21b		FIRE ALARM			2-37
6215	5-LE.21a		FIRE HOSE REEL			2-37
6216	5-LE.21a		FIRE HOSE REEL			2-37
6217	5-ID.81					2-36
6218	1-ID.31		STAIR	STAIR 7	LEVEL 6	NO RE-ENTRY 2-30
6219	5-LE.21b		FIRE ALARM			2-37



DRAWING HISTORY

NO.	DATE	DESCRIPTION
01	04/10/2024	ISSUE FOR PERMIT
02	08/23/2024	ISSUE FOR BID

PROJECT NAME  
**IAH TERMINAL C GARAGE SIGNAGE & WAYFINDING**

PROJECT LOCATION  
 TERMINAL C  
 3500 NORTH TERMINAL RD.  
 HOUSTON, TX 77032

PROJECT NUMBER  
 1004395

SHEET TITLE  
 LEVEL 06B FLOOR PLAN



SHEET NUMBER  
**A2.06B**

### FLOOR PLAN KEYNOTES

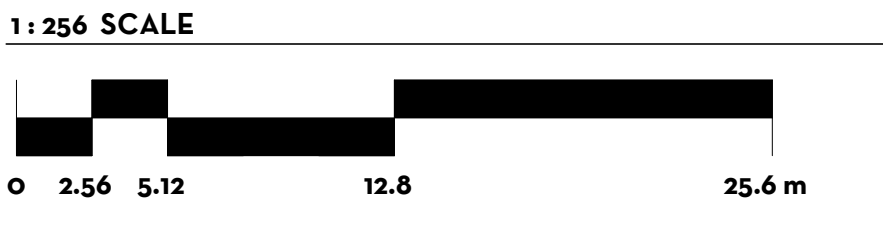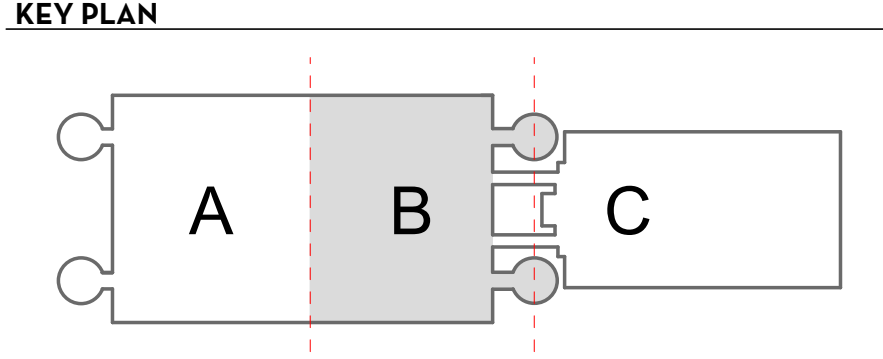
- A SKIM COAT WITH SIKA QUICK SMOOTH FINISH AT EXTERIOR WALL PERIMETER AT ELEVATOR AND STAIR CORES. TO BE PRIMED AND PAINTED.
- B SKIM COAT WITH SIKA QUICK SMOOTH FINISH AT ALL GARAGE COLUMNS ONLY. TO BE PRIMED AND PAINTED. REFER TO \*\* IN REGARDS TO APPROXIMATE COLUMN QUANTITY.

### GENERAL NOTES

- REFER TO SHEETS 1-1 THROUGH 10-24 FOR ADDITIONAL INFORMATION, INCLUDING NEW SIGN LOCATIONS, SIGN TYPES, AND MOUNTING DETAILS
- REFER TO SHEET AG3.000 FOR ADDITIONAL SIGN TYPES
- REFER TO SHEET 1-17 FOR HAS WAYFINDING SYMBOLS



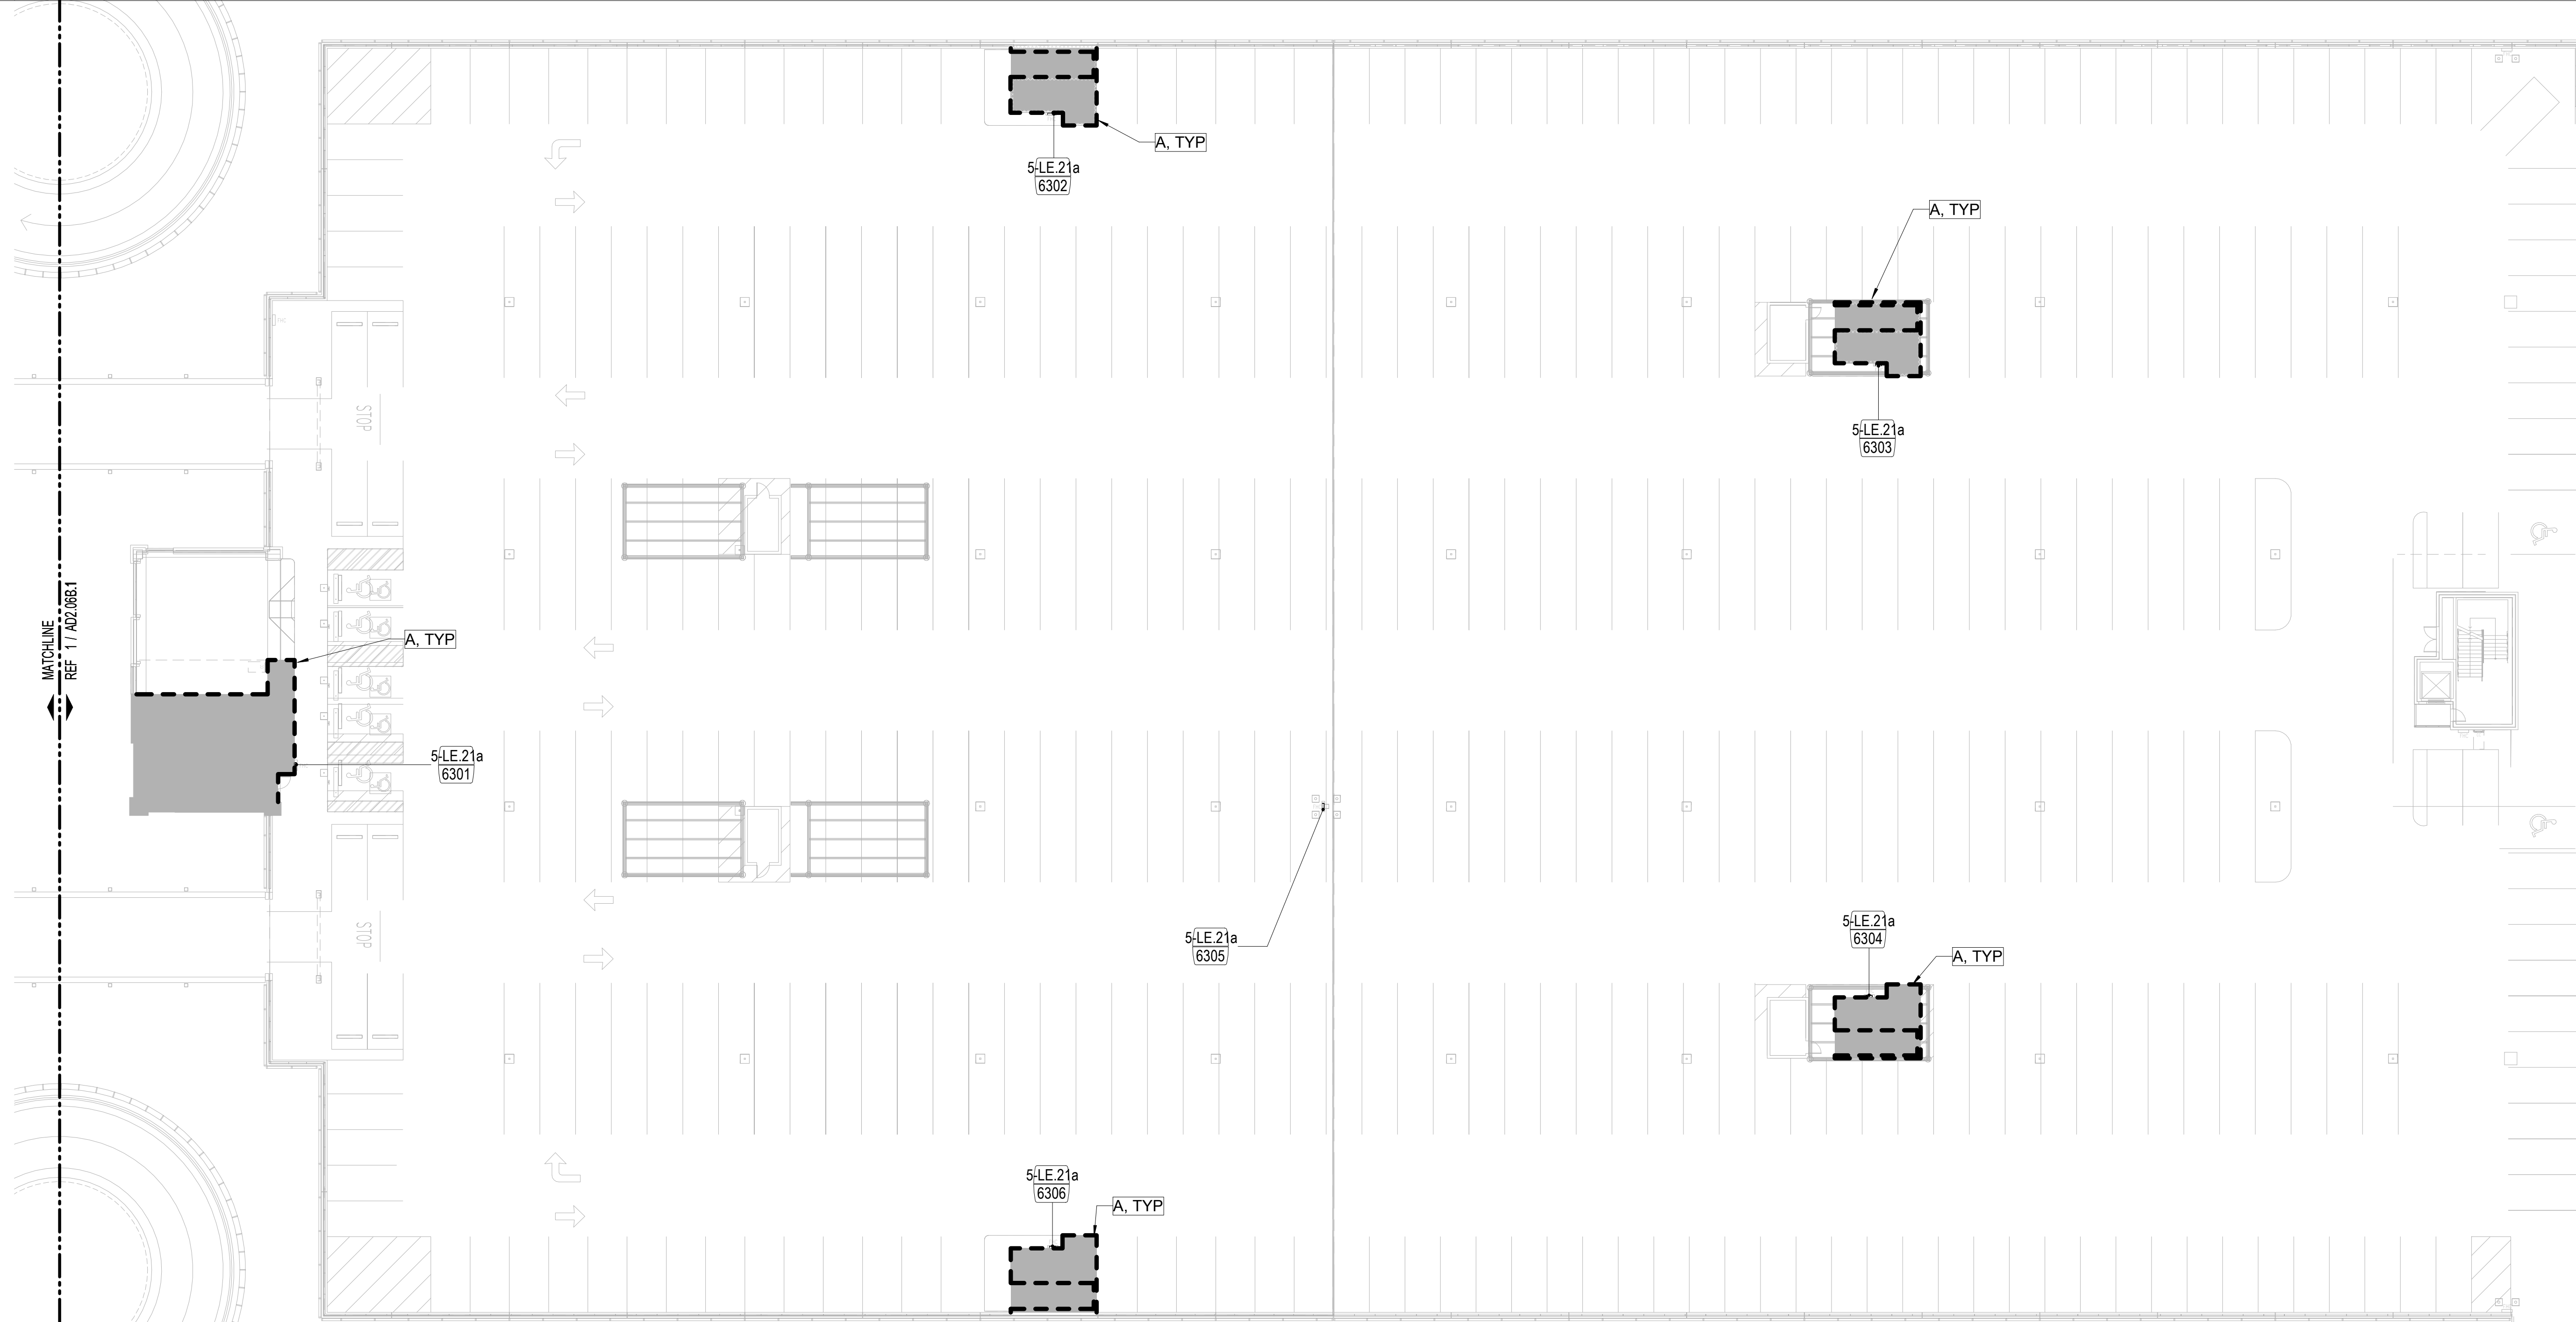FILE NAME: C:\Revit\Locals\TERM C SIGNAGE GARAGE\_DBhatti@pgal.com.rvt  
 DATE/TIME: 8/2024 4:39:46 PM



\*\* 0 +/- COLUMNS TO BE PAINTED IN THIS SECTOR, V.I.F.

**LEVEL 06 - FLOOR PLAN - SECTOR C** 3/64" = 1'-0" 1

SIGNAGE SCHEDULE - LEVEL 06 - SECTOR C						
SIGN NUMBER	SIGN TYPE	HAS SYMBOL	TEXT LINE 1	TEXT LINE 2	TEXT LINE 3	REFERENCE PLAN
6301	5-LE.21a	FIRE HOSE REEL				2-37
6302	5-LE.21a	FIRE HOSE REEL				2-37
6303	5-LE.21a	FIRE HOSE REEL				2-37
6304	5-LE.21a	FIRE HOSE REEL				2-37
6305	5-LE.21a	FIRE HOSE REEL				2-37
6306	5-LE.21a	FIRE HOSE REEL				2-37


**FLOOR PLAN KEYNOTES**

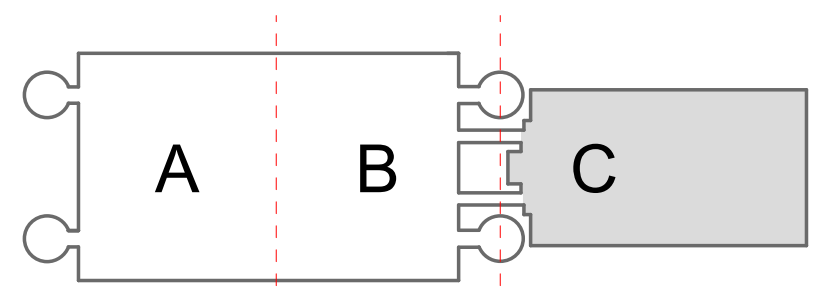- A SKIM COAT WITH SIKA QUICK SMOOTH FINISH AT EXTERIOR WALL PERIMETER AT ELEVATOR AND STAIR CORES. TO BE PRIMED AND PAINTED.
- B SKIM COAT WITH SIKA QUICK SMOOTH FINISH AT ALL GARAGE COLUMNS ONLY. TO BE PRIMED AND PAINTED. REFER TO \*\* IN REGARDS TO APPROXIMATE COLUMN QUANTITY.


**GENERAL NOTES**

1. REFER TO SHEETS 1-1 THROUGH 10-24 FOR ADDITIONAL INFORMATION, INCLUDING NEW SIGN LOCATIONS, SIGN TYPES, AND MOUNTING DETAILS
2. REFER TO SHEET AG3000 FOR ADDITIONAL SIGN TYPES
3. REFER TO SHEET 1-17 FOR HAS WAYFINDING SYMBOLS


**KEY PLAN**




1:256 SCALE

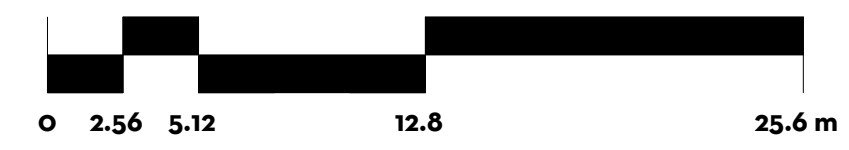

**LEGEND**

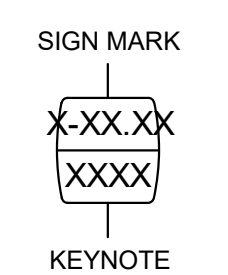

**PLAN NORTH**

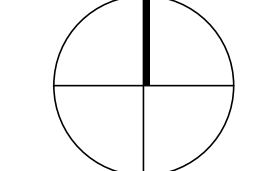

Client Name

ARCHITECT



PGAL  
 3131 BRIARPARK DR.  
 SUITE 200  
 HOUSTON, TX 77042  
 [T] 713 622 1444  
 [F] 713 968 9333  
 www.pgal.com

BSG PRJCT#  
 BSG-2024-111-IAH

DEPARTMENT OF AVIATION  
 RECOMMENDED:  
 HOUSTON AIRPORT SYSTEM  
 DIRECTOR OR DESIGN REPRESENTATIVE  
 HAS TIP # 24-103 - IAH

REGISTRATION  
 Copyright © 2024



**DRAWING HISTORY**

NO.	DATE	DESCRIPTION
01	04/10/2024	ISSUE FOR PERMIT
02	08/23/2024	ISSUE FOR BID

PROJECT NAME  
**IAH TERMINAL C  
 GARAGE  
 SIGNAGE &  
 WAYFINDING**

PROJECT LOCATION  
 TERMINAL C  
 3500 NORTH  
 TERMINAL RD.  
 HOUSTON, TX 77032

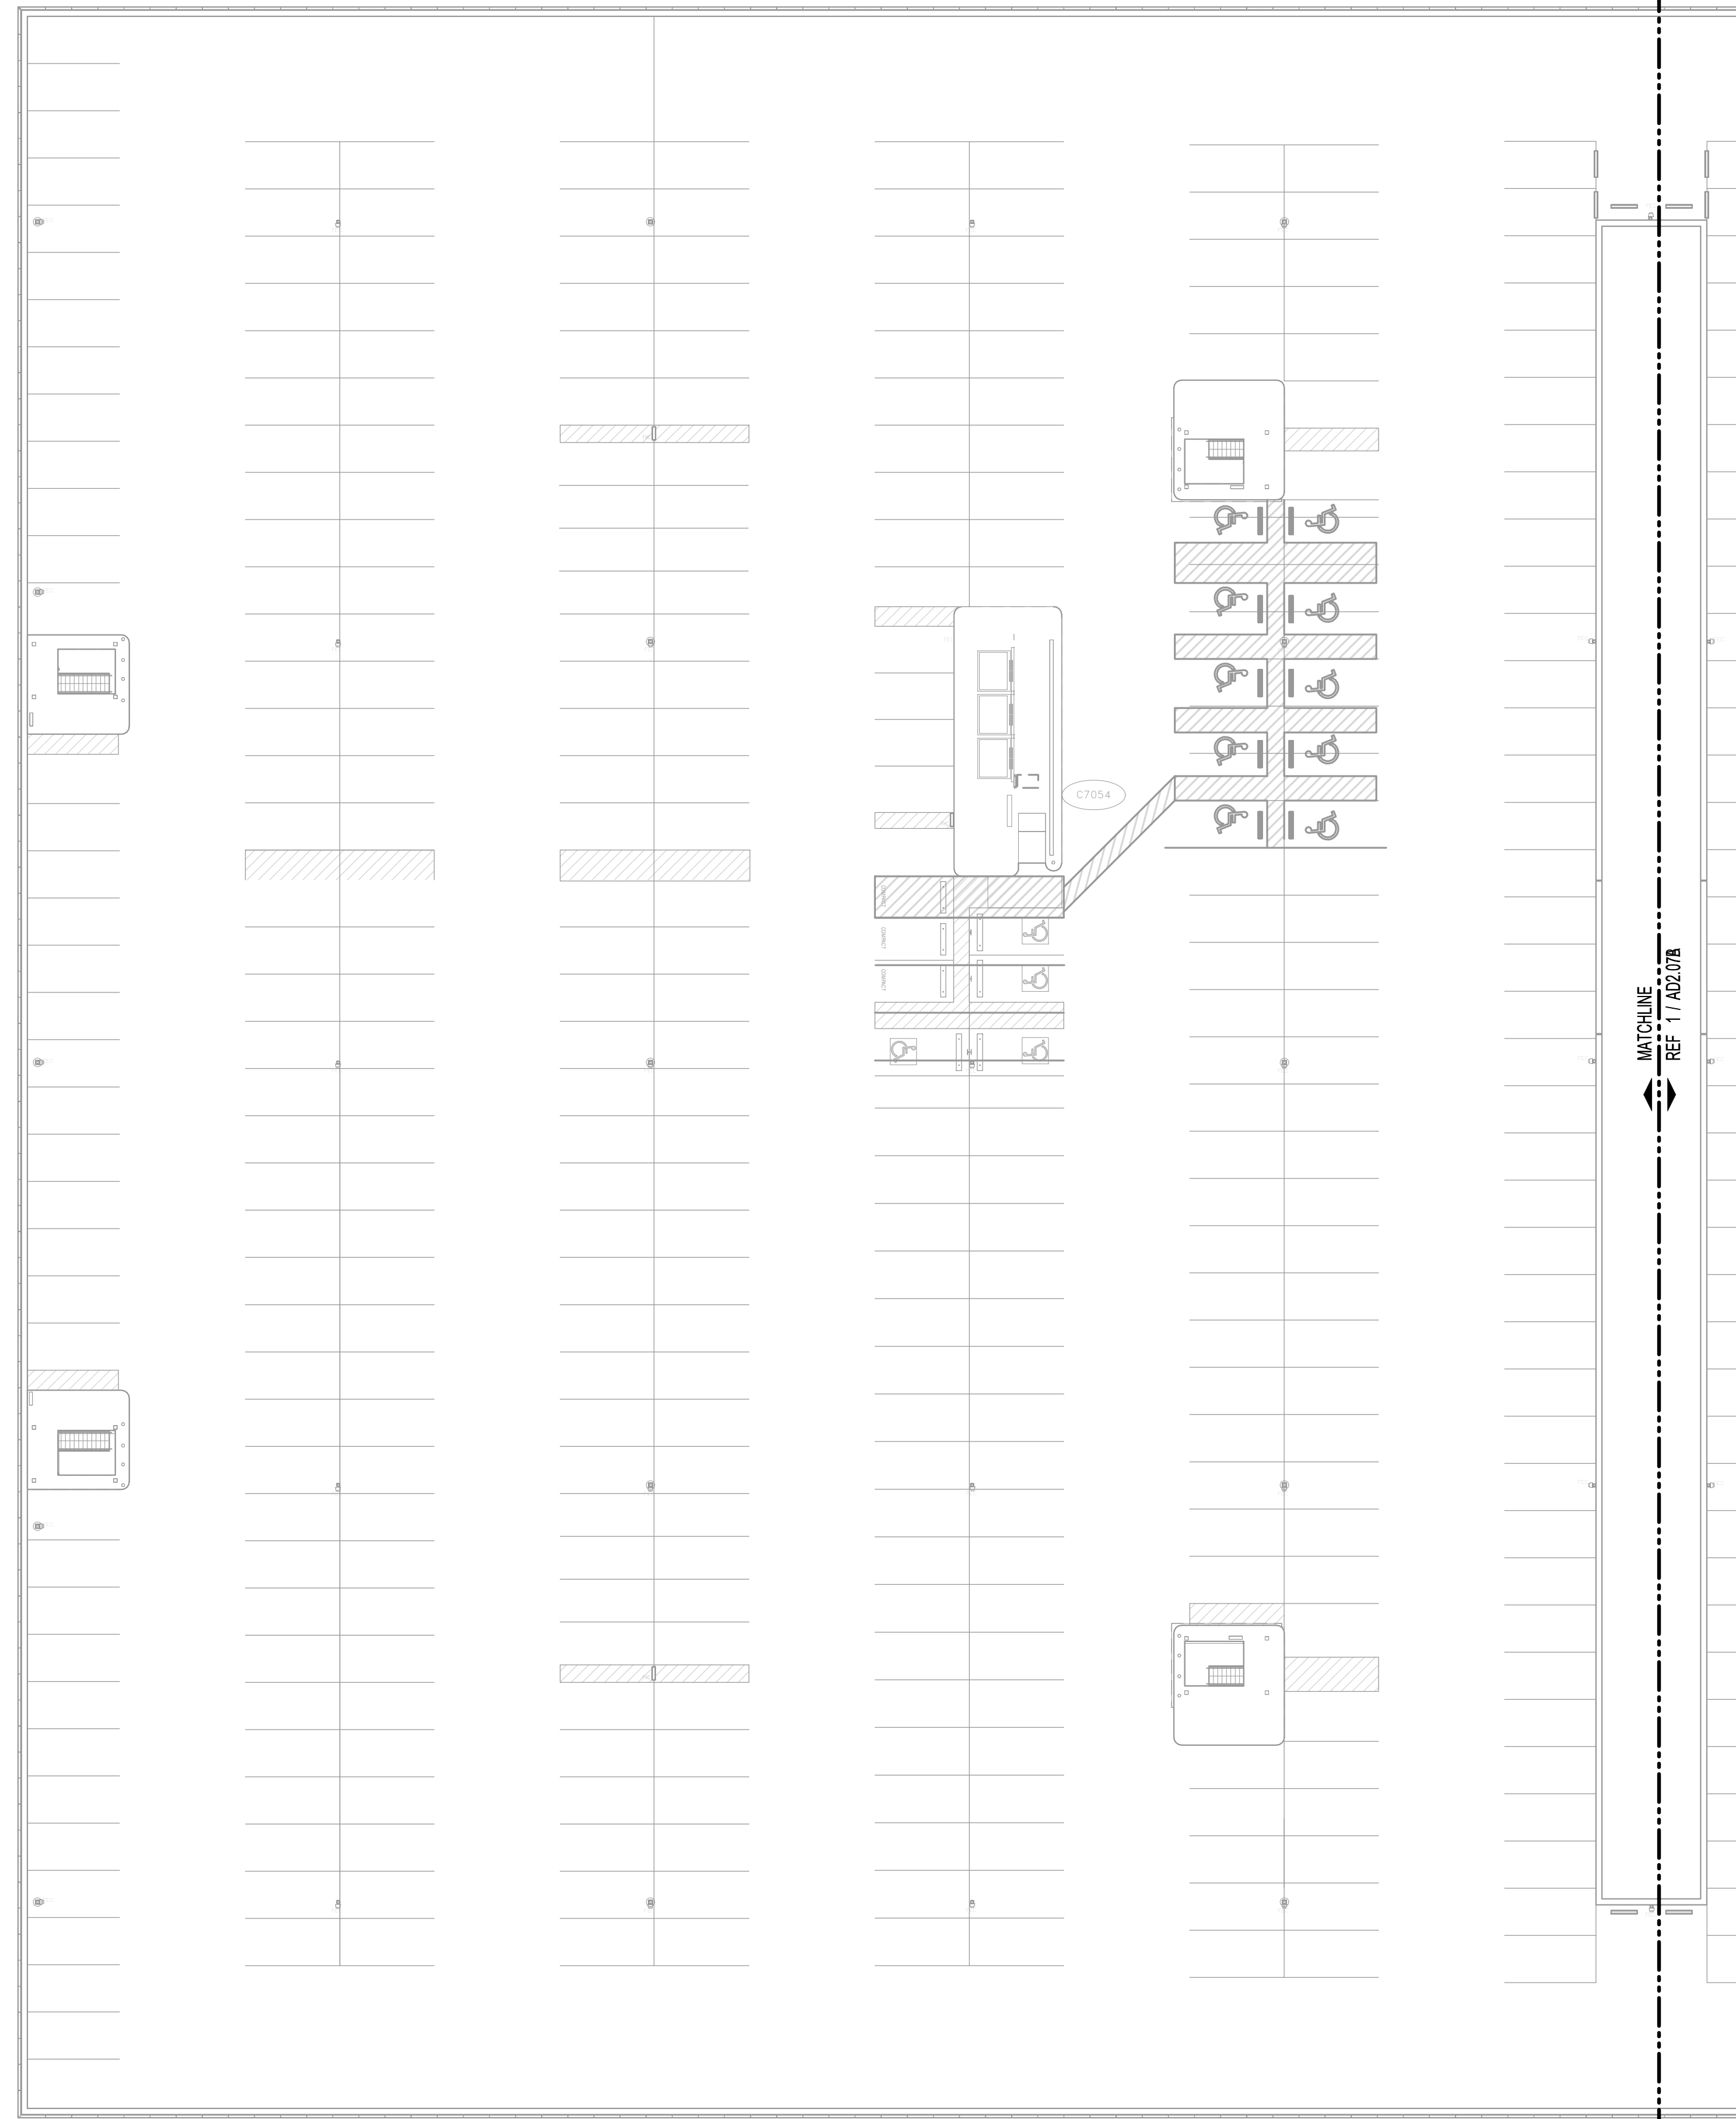
PROJECT NUMBER  
 1004395

SHEET TITLE  
 LEVEL 06C FLOOR  
 PLAN

SHEET NUMBER

**A2.06C**

FILE NAME: C:\Revit\Locals\TERM C SIGNAGE GARAGE\_DBhatti@pgal.com.rvt  
 DATE/TIME: 4/8/2024 4:39:47 PM



SIGNAGE SCHEDULE - LEVEL 07 - SECTOR A						
SIGN NUMBER	SIGN TYPE	HAS SYMBOL	TEXT LINE 1	TEXT LINE 2	TEXT LINE 3	REFERENCE PLAN
NO ADDITIONAL SIGNS IN THIS SECTOR						



Client Name

ARCHITECT



PGAL  
 3131 BRIARPARK DR.  
 SUITE 200  
 HOUSTON, TX 77042  
 [T] 713 622 1444  
 [F] 713 968 9333  
 www.pgal.com

BSG PRJCT#  
 BSG-2024-111-IAH

DEPARTMENT OF AVIATION  
 RECOMMENDED:  
 HOUSTON AIRPORT SYSTEM  
 DIRECTOR OR DESIGN REPRESENTATIVE  
 HAS TIP # 24-103 - IAH

REGISTRATION  
 Copyright © 2024



DRAWING HISTORY

NO.	DATE	DESCRIPTION
01	04/10/2024	ISSUE FOR PERMIT
02	08/23/2024	ISSUE FOR BID

PROJECT NAME  
 IAH TERMINAL C  
 GARAGE  
 SIGNAGE &  
 WAYFINDING

PROJECT LOCATION  
 TERMINAL C  
 3500 NORTH  
 TERMINAL RD.  
 HOUSTON, TX 77032

PROJECT NUMBER  
 1004395

SHEET TITLE  
 LEVEL 07A FLOOR  
 PLAN

SHEET NUMBER

A2.07A


### FLOOR PLAN KEYNOTES

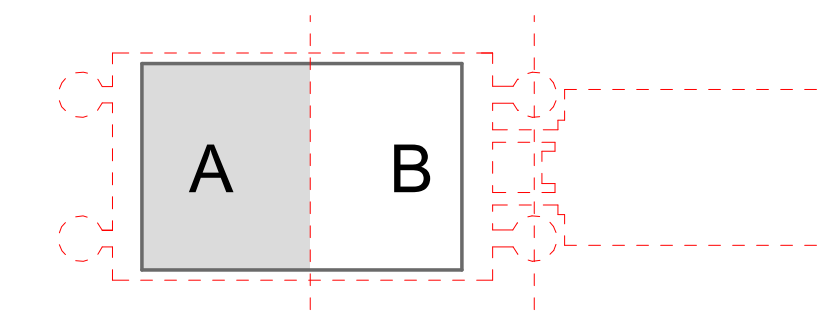- A SKIM COAT WITH SIKA QUICK SMOOTH FINISH AT EXTERIOR WALL PERIMETER AT ELEVATOR AND STAIR CORES. TO BE PRIMED AND PAINTED.
- B SKIM COAT WITH SIKA QUICK SMOOTH FINISH AT ALL GARAGE COLUMNS ONLY. TO BE PRIMED AND PAINTED. REFER TO \*\* IN REGARDS TO APPROXIMATE COLUMN QUANTITY.


### GENERAL NOTES

1. REFER TO SHEETS 1-1 THROUGH 10-24 FOR ADDITIONAL INFORMATION, INCLUDING NEW SIGN LOCATIONS, SIGN TYPES, AND MOUNTING DETAILS
2. REFER TO SHEET AG3.000 FOR ADDITIONAL SIGN TYPES
3. REFER TO SHEET 1-17 FOR HAS WAYFINDING SYMBOLS


#### KEY PLAN




1:256 SCALE

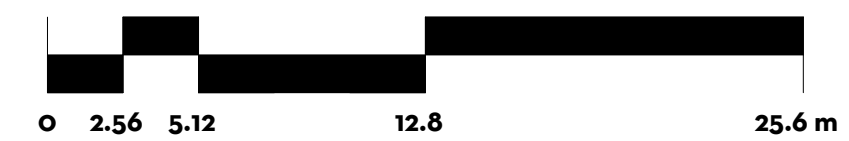

#### LEGEND

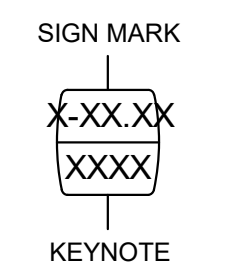

#### PLAN NORTH

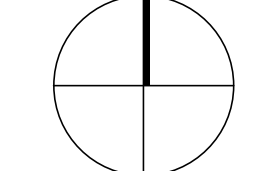

\*\* 0 +/- COLUMNS TO BE PAINTED IN THIS SECTOR, V.I.F.

LEVEL 07 - FLOOR PLAN - SECTOR A 3/64" = 1'-0" 1

FILE NAME: C:\Revit\Locals\TERM C SIGNAGE GARAGE\_DBhatti@pgal.com.rvt  
 DATE/TIME: 4/8/2024 4:39:48 PM



\*\* 0 +/- COLUMNS TO BE PAINTED IN THIS SECTOR, V.I.F.

**LEVEL 07 - FLOOR PLAN - SECTOR B** 3/16" = 1'-0" 1

SIGNAGE SCHEDULE - LEVEL 07 - SECTOR B						
SIGN NUMBER	SIGN TYPE	HAS SYMBOL	TEXT LINE 1	TEXT LINE 2	TEXT LINE 3	REFERENCE PLAN
NO ADDITIONAL SIGNS IN THIS SECTOR						

CLIENT



Client Name

ARCHITECT

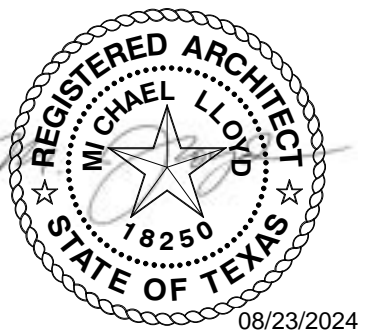


PGAL  
 3131 BRIARPARK DR.  
 SUITE 200  
 HOUSTON, TX 77042  
 [T] 713 622 1444  
 [F] 713 968 9333  
 www.pgal.com

BSG PRJCT#  
 BSG-2024-111-IAH

DEPARTMENT OF AVIATION  
 RECOMMENDED:  
 HOUSTON AIRPORT SYSTEM  
 DIRECTOR OR DESIGN REPRESENTATIVE  
 HAS TIP # 24-103 - IAH

REGISTRATION  
 Copyright © 2024



**DRAWING HISTORY**

NO.	DATE	DESCRIPTION
01	04/10/2024	ISSUE FOR PERMIT
02	08/23/2024	ISSUE FOR BID

PROJECT NAME  
**IAH TERMINAL C  
 GARAGE  
 SIGNAGE &  
 WAYFINDING**

PROJECT LOCATION  
 TERMINAL C  
 3500 NORTH  
 TERMINAL RD.  
 HOUSTON, TX 77032

PROJECT NUMBER  
 1004395

SHEET TITLE  
 LEVEL 07B FLOOR  
 PLAN

SHEET NUMBER

**A2.07B**

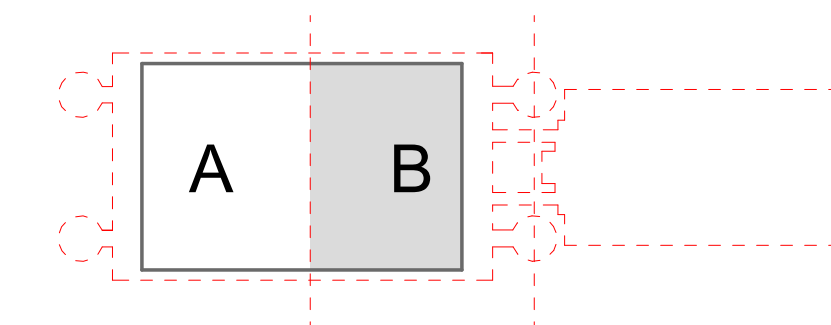
**FLOOR PLAN KEYNOTES**

- A SKIM COAT WITH SIKA QUICK SMOOTH FINISH AT EXTERIOR WALL PERIMETER AT ELEVATOR AND STAIR CORES. TO BE PRIMED AND PAINTED.
- B SKIM COAT WITH SIKA QUICK SMOOTH FINISH AT ALL GARAGE COLUMNS ONLY. TO BE PRIMED AND PAINTED. REFER TO \*\* IN REGARDS TO APPROXIMATE COLUMN QUANTITY.


**GENERAL NOTES**

1. REFER TO SHEETS 1-1 THROUGH 10-24 FOR ADDITIONAL INFORMATION, INCLUDING NEW SIGN LOCATIONS, SIGN TYPES, AND MOUNTING DETAILS
2. REFER TO SHEET AG3.000 FOR ADDITIONAL SIGN TYPES
3. REFER TO SHEET 1-17 FOR HAS WAYFINDING SYMBOLS


**KEY PLAN**




1:256 SCALE

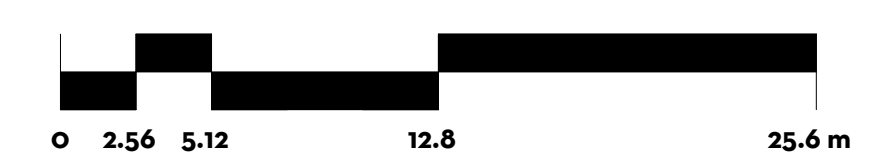


**LEGEND**

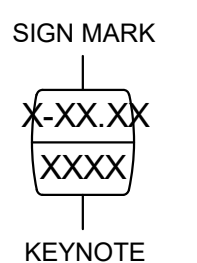

**PLAN NORTH**

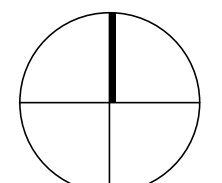


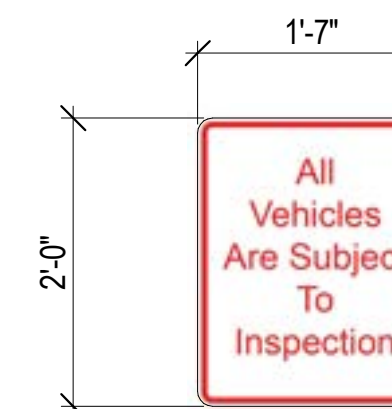

SIGN TYPE R3 - SUBJECT TO INSPECTION

NOTES:

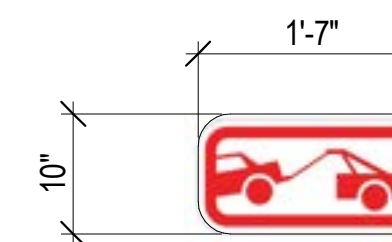
1. SIGN SHALL COMPLY WITH ALL TXDOT STANDARDS
2. SIGN TO BE CONSTRUCTED OF 80 MIL ALUMINUM PLATE
3. SIGN FACE SHALL HAVE DIAMOND GRADE REFLECTIVE FINISH
4. SIGN BACKGROUND SHALL BE WHITE
5. SIGN TEXT SHALL BE RED
6. SIGN SHALL REPLACE EXISTING SIGN TO BE REMOVED PER DEMO PLANS



SIGN TYPE R2 - TOW AWAY ZONE

NOTES:

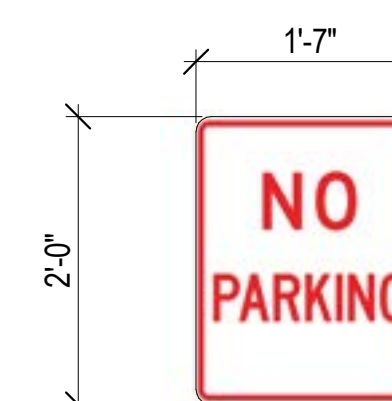1. SIGN SHALL COMPLY WITH ALL TXDOT STANDARDS
2. SIGN TO BE CONSTRUCTED OF 80 MIL ALUMINUM PLATE
3. SIGN FACE SHALL HAVE DIAMOND GRADE REFLECTIVE FINISH
4. SIGN BACKGROUND SHALL BE WHITE
5. SIGN TEXT SHALL BE WHITE
6. SIGN SHALL REPLACE EXISTING SIGN TO BE REMOVED PER DEMO PLANS



SIGN TYPE R1 - NO PARKING

NOTES:

1. SIGN SHALL COMPLY WITH ALL TXDOT STANDARDS
2. SIGN TO BE CONSTRUCTED OF 80 MIL ALUMINUM PLATE
3. SIGN FACE SHALL HAVE DIAMOND GRADE REFLECTIVE FINISH
4. SIGN BACKGROUND SHALL BE WHITE
5. SIGN TEXT SHALL BE RED
6. SIGN SHALL REPLACE EXISTING SIGN TO BE REMOVED PER DEMO PLANS

CLIENT



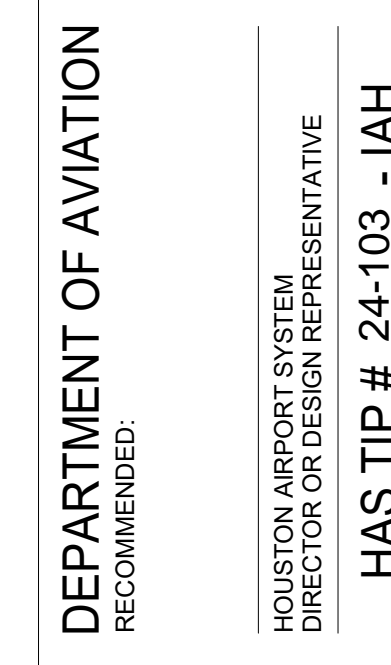
Client Name

ARCHITECT



PGAL  
 3131 BRIARPARK DR.  
 SUITE 200  
 HOUSTON, TX 77042  
 [T] 713 622 1444  
 [F] 713 968 9333  
 www.pgal.com

BSG PRJCT#  
 BSG-2024-111-IAH



REGISTRATION  
 Copyright © 2024



DRAWING HISTORY

NO.	DATE	DESCRIPTION
01	04/10/2024	ISSUE FOR PERMIT
02	08/23/2024	ISSUE FOR BID

PROJECT NAME  
 IAH TERMINAL C  
 GARAGE  
 SIGNAGE &  
 WAYFINDING

PROJECT LOCATION  
 TERMINAL C  
 3500 NORTH  
 TERMINAL RD.  
 HOUSTON, TX 77032

PROJECT NUMBER  
 1004395

SHEET TITLE  
 SIGNAGE DETAILS  
 & REGULATORY  
 SIGNS

SHEET NUMBER

AG3.000



FILENAME: \\EgnyteDrive\Projects\HRSE\Projects\H+R\2019 Jobs\1-IAH Terminal C Curbside Wayfinding\3-CAD\Revit Structure\19002\_TERMINAL C GARAGE\_R23.rvt  
 STAMP: 6/26/2024 11:37:49 AM

GENERAL STRUCTURAL NOTES

**PART I - DESIGN CRITERIA**

- A. GENERAL BUILDING CODE  
 1. The Construction Documents are based on the requirements of the International Building Code 2021 with City of Houston Amendments to International Building Code 2021.
- B. WIND LOADS  
 1. Wind pressures are based on the provisions of ASCE 7-22 and the following criteria:  
 a. Ultimate Design Wind Speed: 135 MPH (3-second gust)  
 b. Building Risk Category: III  
 c. Wind Exposure Category: C

**PART II - REINFORCED CONCRETE**

- A. CLASSES OF CONCRETE  
 All concrete shall conform to the requirements as noted below unless noted otherwise on the drawings:  
 Location: 28 Days Comp Strength (f'c) Conc Type  
 ALL CONCRETE 3,500 PSI NWT
- B. HORIZONTAL CONSTRUCTION JOINTS IN CONCRETE POURS  
 1. There shall be no horizontal construction joints in any concrete pours unless shown on the drawings. The Architect/Engineer shall approve all deviations or additional joints in writing.
- C. REINFORCING STEEL  
 1. All Reinforcing Steel shall be ASTM A 615 Grade 60 unless noted otherwise on the drawings or in these notes.
- D. REINFORCING STEEL COVERAGE  
 1. Cover specified shall be considered minimums that may require increasing where reinforcing steel intersects for different member types. Cover in structural members not specified in the details shall conform to the requirements of ACI 318 unless specified otherwise on the drawings. The reinforcing steel detailer shall adjust reinforcing steel cage sizes at intersecting structural members as required to allow clearance for intersecting reinforcing bar layers with minimum specified cover.

**PART III - STRUCTURAL STEEL**

- A. MATERIAL  
 1. Hot Rolled Structural Members: All hot rolled steel plates, shapes, sheet piling, and bars shall be new steel conforming to ASTM Specification A 6.  
 2. ASTM Specification and Grade: Clearly mark the grade of steel on each piece, with a distinguishing mark visible from floor surfaces, for the purpose of field inspection of proper grade of steel. Unless noted otherwise on the drawings, structural steel shall be as follows:  
 a. W- and WT-Shapes: ASTM A 992  
 b. M- and S-Shapes: ASTM A 36  
 c. C-Shapes: ASTM A 36  
 d. L-Shapes: ASTM A 36  
 e. Round HSS: ASTM A 500, Grade B (Fy=42 ksi)  
 f. Rectangular HSS: ASTM A 500, Grade B (Fy=46 ksi)  
 g. Steel Pipes: ASTM A 53 (Types E or S), Grade B  
 h. Base Plates:  
 • All base plates shall conform to ASTM A 36 unless noted otherwise on the drawings  
 i. Edge Angles, Bent Plates, Angle Hangers, and Angle Kickers: ASTM A 36.
- B. CONNECTIONS  
 1. Connection details not completely detailed on the drawings including material grade and sizes, weld sizes, and number of bolts shall be designed by the Contractor per the specifications. Conceptual connection details with the required member design forces are shown on the drawings and are applicable to all connections not designed and fully detailed on the drawings. The conceptual details are provided only to indicate the connection type required and may not fully represent the complexity of the connection as required by the final connection design for the forces they must resist. Additional connection elements may not be specifically shown in the conceptual details but may be required by the final connection design, such as stiffener plates, doubler plates, supplement reinforcing plates or other connection material. The fabricator is responsible for engaging the services of a connection specialty engineer to prepare a final connection design for submission that meets the requirements of the conceptual connection details and resists the indicated design forces.  
 2. For non-composite beams, the end reaction of the connected beam shall be determined from AISC "STEEL CONSTRUCTION MANUAL," Fourteenth Edition, Part 3, TABLE 3-6, "MAXIMUM TOTAL UNIFORM LOAD," unless a design reaction is indicated on the plans. In no case shall the end reaction be taken as less than 12.0 KIPS. If alternate beam connection designs are used and for all other connections not detailed on the drawings, the fabricator shall have a registered professional engineer prepare the connection designs in accordance with AISC "STEEL CONSTRUCTION MANUAL," Part 14 and AISC "DESIGN GUIDE 24 - HOLLOW STRUCTURAL SECTION CONNECTIONS." Such designs shall be submitted prior to preparation of the shop drawings and shall bear the seal of this responsible professional engineer.  
 3. Structural steel detailing, fabrication and erection shall conform to the latest version of the AISC "SPECIFICATION FOR STRUCTURAL STEEL BUILDINGS" and the latest version of the AISC "CODE OF STANDARD PRACTICE FOR STEEL BUILDINGS AND BRIDGES."
- C. STRUCTURAL BOLTS AND THREADED FASTENERS  
 1. A 325 bolts: All bolts in structural connections shall conform to ASTM A 325 Type 1, unless indicated otherwise on the drawings.
- D. WELDING  
 1. Unless noted otherwise, electrodes for welding shall conform to E70XX (SMAW), F7XX-EXXX (SAW), ER70S-X (GMAW), or E7XT-X (FCAW).
- E. ANCHOR RODS  
 1. Unless indicated otherwise in the Column Schedule or on the drawings, Anchor rods shall conform to ASTM F 1554 Grade 36 (with Supplementary Requirement S1).
- F. GROUT  
 1. Grout below structural steel base plates shall be non-metallic, non-shrink grout conforming to ASTM C827 with a minimum strength of 6,000 psi when bearing on 3,000 psi concrete or less, a strength of 8,000 psi when bearing on concrete between 3,000 and 4,000 psi, and, unless noted otherwise on the drawings, a strength of 8,000 psi when bearing on concrete greater than 4,000 psi. Base plate pregrouting is not permitted.

**PART IV - STRUCTURAL OBSERVATION**

- A. Structural observation is the visual observation of the structural system, for general conformance to the approved plans and specifications, at significant construction stages and at completion of the structural system, which includes the lateral and gravity load paths.
- B. Structural observation shall be performed by the engineer responsible for the structural design, or a licensed engineer or architect designated by the said engineer.
- C. Structural observation does not include or waive the responsibility for the inspection required by the building code.

**PART V - SPECIAL INSPECTIONS**

- A. The Owner's testing laboratory shall provide inspection services in accordance with the international building code for the following items:  
 1. Steel Construction:  
 a. All field welding  
 b. High-strength bolting  
 c. Welding of structural steel  
 2. Concrete Construction  
 a. Bolts installed in concrete  
 b. Concrete work  
 c. Continuous inspection of reinforcing steel placing  
 d. Epoxy bolts  
 e. Reinforcing steel placement  
 f. Concrete strength
- B. STATEMENT OF SPECIAL INSPECTIONS  
 1. Special inspection is required for the items listed above. Refer to international building code for type and extent of each special inspection and each test.

**PART VI - SUBMITTALS**

- A. SUBMITTAL LIST AND SCHEDULE  
 1. The General Contractor shall prepare a detailed list and schedule of all submittal items to be sent to the Structural Engineer prior to the start of construction. This list shall be updated and revised and kept current as the job progresses. The submittal list shall be organized as shown below:  
 a. Shop Drawings  
 b. Design Calculations  
 c. Product Data, Certificates, Reports, and Other Literature
- B. SUBMITTALS TO BE PROVIDED TO STRUCTURAL ENGINEER  
 1. Structural Submittals: In addition to the submittals required by the structural specifications, the following submittals shall be provided:  
 a. Layout of Embedded Items (Plates, Angles, Bolts, etc.) or Items Attached to the Structural Frame for Building Cladding Attachment or for Attachment of Other Items.  
 b. Structural steel  
 c. Reinforcement  
 d. Concrete products and mix design
2. Submittal Requirements:  
 a. All shop drawings must be reviewed and electronically stamped by the General Contractor prior to submittal.  
 b. Contractor shall submit three sets of prints for all shop drawings specified to be returned by the Engineer.  
 c. Contractor shall provide the submittal in electronic portable document format (PDF) per the Specifications.  
 d. The omission from the shop drawings of any materials required by the Contract Documents to be furnished shall not relieve the Contractor of the responsibility of furnishing and installing such materials, regardless of whether the shop drawings have been reviewed and approved.
- C. REPRODUCTION  
 1. The use of electronic files or reproductions of these contract documents by any contractor, subcontractor, erector, fabricator, or material supplier in lieu of preparation of shop drawings signifies their acceptance of all information shown herein as correct, and obligates themselves to any job expense, real or implied, arising due to any errors that may occur hereon.

**PART VII - MISCELLANEOUS**


- A. CONTRACT DOCUMENTS  
 1. It is the responsibility of the General Contractor to obtain all Contract Documents and latest addenda and to submit such documents to all subcontractors and material suppliers prior to the submittal of shop drawings, fabrication of any structural members, and erection in the field.  
 2. The contract structural drawings and specifications represent the finished structure, and, except where specifically shown, do not indicate the method or means of construction. The Contractor shall supervise and direct the work and shall be solely responsible for all construction means, methods, procedures, techniques, and sequence.  
 3. Openings through floors, roofs, and walls for ducts, piping, and/or conduit shall be coordinated by the contractor. Contractor shall verify sizes and locations of holes and openings with the Mechanical, Electrical, Plumbing, and Fire Protection Drawings and the respective subcontractors.  
 4. Refer to drawings other than Structural for complete information including: Types of floor slab finishes and their locations, floor slab depressions and curbs, openings in structural walls, roofs and floors required by Architectural and MEP features, stairs, ramps, etc.  
 5. Where member locations are not specifically dimensioned, members are either located on columns lines or are equally spaced between located members.  
 6. If certain features are not fully shown or specified on the drawings or in the specifications, their construction shall be of the same character as shown or specified in similar conditions.
- B. DRAWING CONFLICTS  
 1. The General Contractor shall compare the Architectural and Structural drawings and report any discrepancy between each set of drawings and within each set of drawings to the Architect and Engineer prior to the fabrication and installation of any structural members.
- C. CONFLICTS IN STRUCTURAL REQUIREMENTS  
 1. Where conflict exists among the various parts of the structural contract documents, structural drawings, general notes, and specifications, the strictest requirements, as indicated by the Engineer, shall govern.
- D. EXISTING CONDITIONS  
 1. The General Contractor shall verify all dimensions and conditions of the existing building at the job site and report any discrepancies from assumed conditions shown on the drawings to the Architect and Engineer prior to the fabrication and erection of any members.  
 2. Work shown on the drawings is New, unless noted as Existing.  
 3. Existing construction shown on the drawings was obtained from existing construction documents and limited site observation. These drawings of existing construction are available for contractor use. However, the available drawings of existing construction are not necessarily complete. The contractor shall field verify all pertinent information.  
 4. Demolition, cutting, drilling, etc. of existing work shall be performed with great care so as not to jeopardize the structural integrity of the existing building or the baggage handling system. If any architectural, structural, or MEP members not designated for removal interfere with the new work, the Architect shall be notified immediately and approval obtained prior to removal of those members.  
 5. The contractor shall safely shore existing construction wherever existing supports are removed to allow the installation of new work. All shoring methods and sequencing of demolition shall be the responsibility of the contractor and his engineer.  
 6. The contractor shall verify the location of existing utilities prior to the start of construction and take care to protect existing utilities that are to remain in service.  
 7. The contractor shall repair all damage caused during construction with similar materials and workmanship to restore conditions to levels acceptable to the Architect.
- E. ADJACENT BUILDINGS AND PROPERTY  
 1. The General Contractor shall ensure that all construction methods used will not cause damage to the adjacent buildings, equipment, and property. This shall include all foundation installation.

**PART VII - MISCELLANEOUS (CONTINUED)**

- F. RESPONSIBILITY OF THE CONTRACTOR FOR STABILITY OF THE STRUCTURE DURING CONSTRUCTION  
 1. All structural elements of the project have been designed by the Structural Engineer to resist the required code vertical and lateral forces that could occur in the final completed structure only. The ability of the structural frame to resist the required code forces derives from the complete installation of the lateral force resisting systems and diaphragms described below. It is the responsibility of the Contractor to provide all required bracing during construction to maintain the stability and safety of all structural elements during the construction process until the lateral-load resisting or stability-providing system is completely installed and all designated concrete elements (if any) have reached a minimum of 75% of their design strength. The required structural elements are:
- G. RESPONSIBILITY OF THE CONTRACTOR FOR CONSTRUCTION LOADS  
 1. The structure has been designed for the loads identified within these structural drawings that are anticipated to be applied to the final structure once completed and occupied. The Contractor shall not overload the structure during construction. The Contractor shall be responsible for checking the adequacy of the structure to support any applied construction loads, including those due to construction vehicles or equipment, material handling or storage, shoring or reshoring, or any other construction activity. The Contractor shall submit calculations signed and sealed by an engineer licensed in the state where the project is located verifying the adequacy of the structure for any proposed construction loads that are in excess of the stated design loads. The Structural Engineer is not responsible to design or check the structure for loads applied to the structure for any construction activity.
- H. CONTRACTOR SUBSTITUTIONS  
 1. Any materials or products submitted for approval that are different from the material or products specified in the contract documents will be approved only if the following criteria are satisfied:  
 a. A cost savings to the Owner is documented and submitted with the request.  
 b. The material or product has been approved by the International Code Council (ICC) and the ICC report is submitted with the request.  
 • The ICC ESR that is submitted must reference the building code under which the project is permitted.  
 • ICC reports that have been discontinued at the time of product installation will not be accepted.  
 2. Submittals not satisfying the above criteria will not be considered.
- I. THE STRUCTURAL ENGINEER'S ROLE DURING CONSTRUCTION  
 1. The Engineer shall not have control nor charge of, and shall not be responsible for, construction means, methods, techniques, sequences, or procedures, for safety precautions and programs in connection with the work, for the acts or omission of the Contractor, Subcontractor, or any other persons performing any of the work, or for the failure of any of them to carry out the work in accordance with the contract documents.  
 2. Periodic site observation by field representatives of Henderson Rogers Structural Engineers is solely for the purpose of becoming generally familiar with the progress and quality of the Work completed and determining, in general, if the Work observed is being performed in a manner indicating that the Work, when fully completed, will be in accordance with the structural contract documents. This limited site observation should not be construed as exhaustive or continuous to check the quality or quantity of the work, but rather periodic in an effort to keep the Owner reasonably informed about the progress and quality of the portion of the structure completed.
- J. MAINTENANCE STATEMENT  
 1. All structures require periodic maintenance to extend lifespan and to ensure structural integrity from exposure to the environment. A planned program of maintenance shall be established by the owner. This program shall include such items such as but not limited to painting of structural steel, protective coating for concrete, sealants, caulked joints, expansion joints, control joints, spalls and cracks in concrete, and pressure washing of exposed structural elements exposed to a salt environment or other harsh chemicals.

**ASCE Hazards Report**

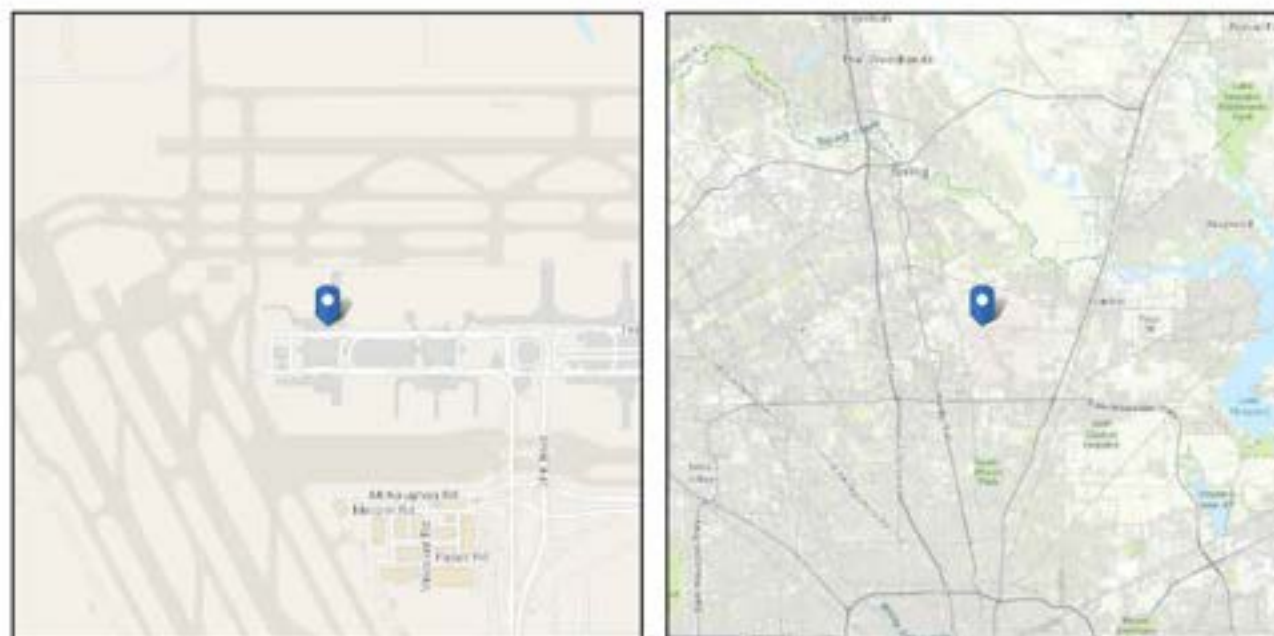Standard: ASCE/SEI 7-22    Latitude: 29.987533  
 Risk Category: III    Longitude: -95.349793  
 Soil Class: Default    Elevation: 92.95757346020656 ft (NAVD 88)



**Wind**

Results:

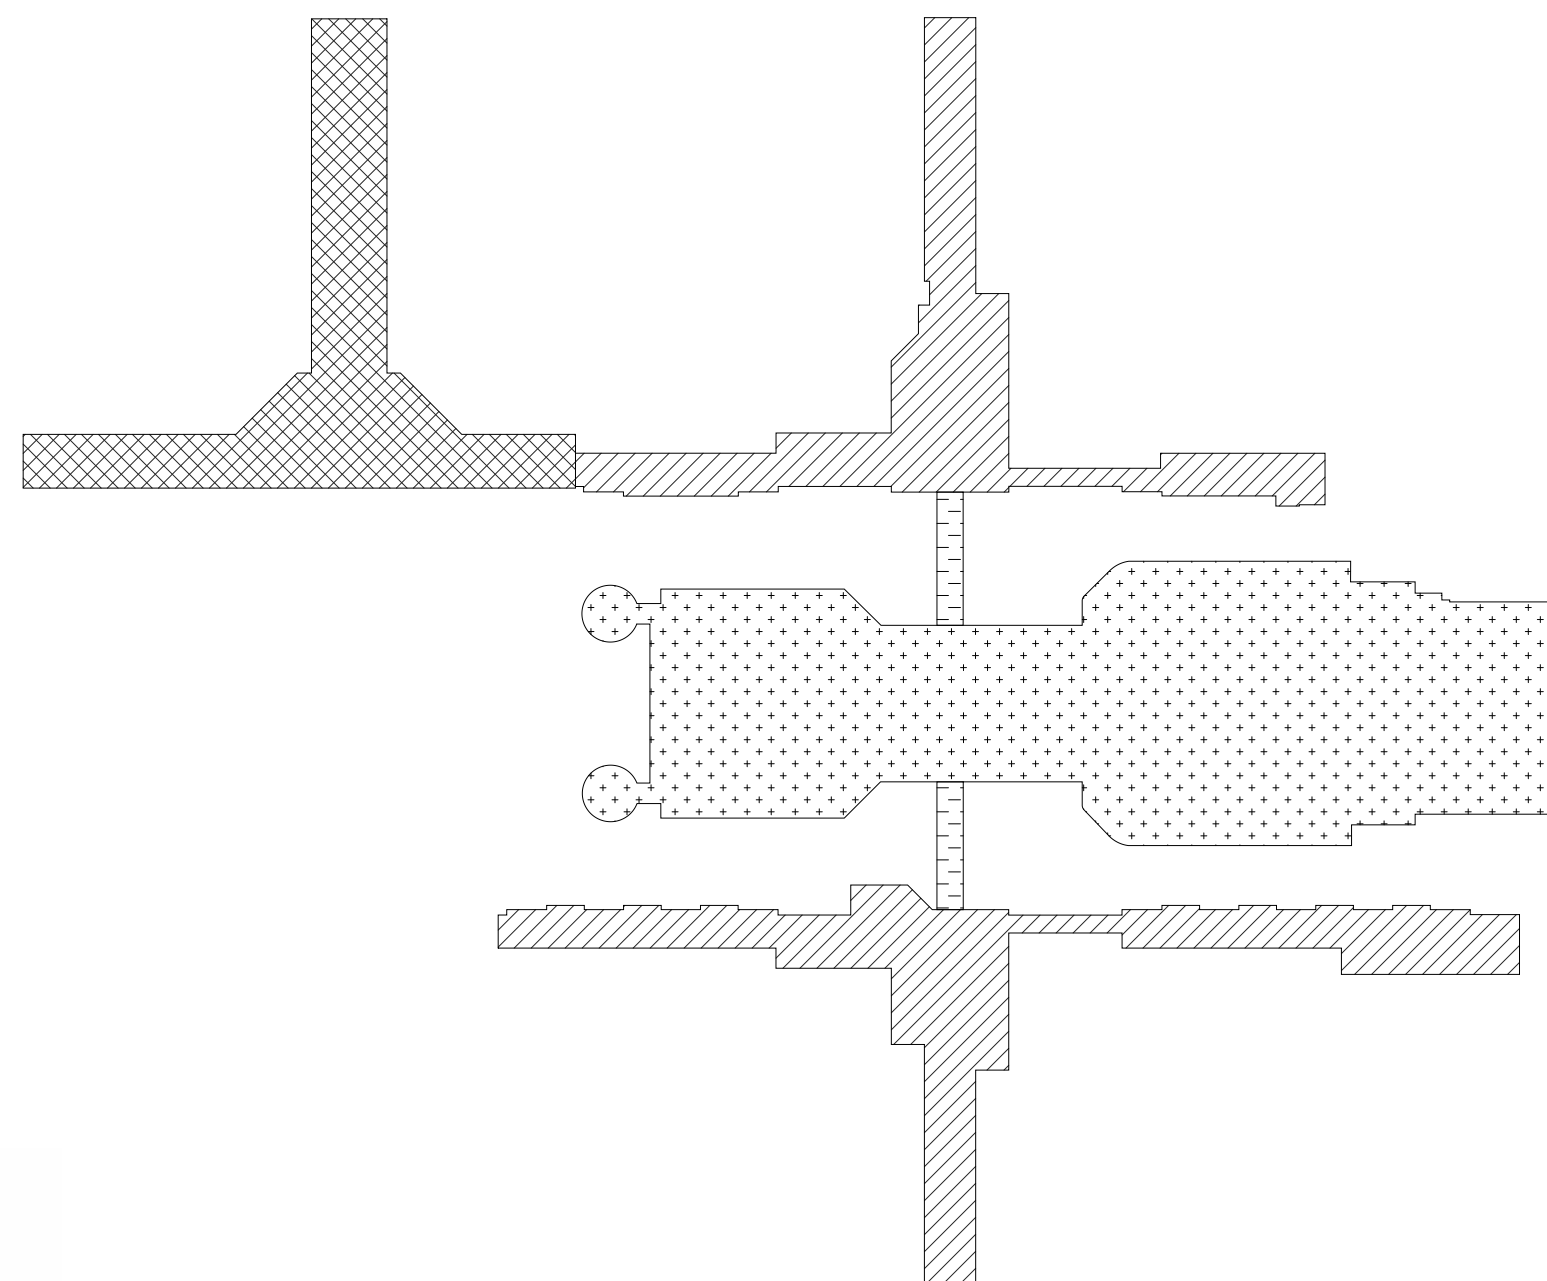
Wind Speed	135 Vmph
10-year MRI	76 Vmph
25-year MRI	88 Vmph
50-year MRI	99 Vmph
100-year MRI	109 Vmph
300-year MRI	120 Vmph
700-year MRI	128 Vmph
1,700-year MRI	135 Vmph
3,000-year MRI	139 Vmph
10,000-year MRI	148 Vmph
100,000-year MRI	159 Vmph
1,000,000-year MRI	173 Vmph

Data Source: ASCE/SEI 7-22, Fig. 26.5-1C and Figs. CC.2-1-CC.2-4, and Section 26.5.2  
 Date Accessed: Tue Jun 25 2024

Value provided is 3-second gust wind speeds at 33 ft above ground for Exposure C Category, based on linear interpolation between contours. Wind speeds are interpolated in accordance with the 7-22 Standard. Wind speeds correspond to approximately a 3% probability of exceedance in 50 years (annual exceedance probability = 0.000588, MRI = 1,700 years). Values for 10-year MRI, 25-year MRI, 50-year MRI and 100-year MRI are Service Level wind speeds, all other wind speeds are Ultimate wind speeds.

Site is in a hurricane-prone region as defined in ASCE/SEI 7-22 Section 26.2. Glazed openings need not be protected against wind-borne debris.

STRUCTURE TYPE KEY LEGEND		
PATTERN	CONSTRUCTION TYPE	REMARKS
	CONC W/ STEEL	CAST IN PLACE PAN SYSTEM WITH STEEL ROOF
	CONC	ONE WAY SLAB W/ PT REINF
	CONC	REINF SYSTEM VARIES PER LEVEL (PT REINF ON SOME LEVELS)
	STEEL	STEEL STRUCTURE W/ COMPOSITE DECK



- NOTES:
- WHERE SIGN SUPPORT IS TO BE ANCHORED TO CONC. (SEE PLAN KEY), CONTRACTOR TO COORDINATE WITH STRUCTURAL ENGINEER TO DETERMINE METHOD OF CONC. REINFORCEMENT. IF CONC. IS UTILIZING P.T. REINFORCEMENT, GPR TESTING IS REQUIRED PRIOR TO DRILLING TO AVOID CONFLICT WITH P.T. TENDONS.
  - G.C. TO REFERENCE ARCH DRAWINGS FOR ALL INFORMATION REGARDING SIGN LOCATION, SIGN TYPE, ETC
  - REFERENCE SHEET S310 FOR TYP. STRUCTURAL DETAILS AND REFERENCE SIGN MANUFACTURER'S DRAWINGS FOR ALL OTHER, SIGN SPECIFIC, CONDITIONS.
  - G.C. TO COORDINATE DESIGN RESPONSIBILITY OF SIGNAGE MANUFACTURER AND NOTIFY ALL PARTIES IF THERE ARE GAPS IN DESIGN OF SIGN SUPPORT ELEMENTS.

**1 TERMINAL C - GENERAL SITE PLAN**  
 1" = 300'-0"

CLIENT



HAS AVIATION DEPT.  
 16930 JOHN F. KENNEDY BLVD.  
 HOUSTON TX 77032  
 [T] 281 233 1757  
 [F] 281 233 1800

ARCHITECT



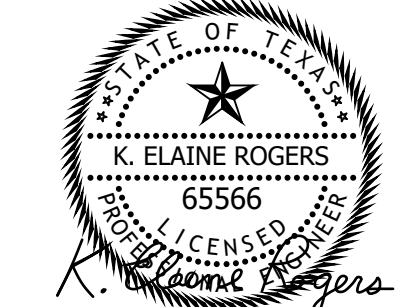
PGAL  
 3131 BRIARPARK DR.  
 SUITE 200  
 HOUSTON, TX 77042  
 [T] 713 622 1444  
 [F] 713 968 9333  
 www.pgal.com

DEPARTMENT OF AVIATION  
 RECOMMENDED:

HENDERSON ROGERS STRUCTURAL ENGINEERS  
 DIRECTOR OR DESIGN REPRESENTATIVE

HAS TIP # XXXX - IAH

REGISTRATION  
 Copyright © 2024  
 Henderson + Rogers, Inc.  
 TBPE Firm Registration No. 2194



08/23/24

DRAWING HISTORY

No.	DATE	DESCRIPTION
1	04/10/2024	ISSUE FOR PERMIT
2	06/26/2024	PERMIT REVISIONS
3	08/23/2024	ISSUE FOR BID

PROJECT NAME  
**IAH TERMINAL C GARAGE SIGNAGE & WAYFINDING**

PROJECT LOCATION  
 TERMINAL C  
 3500 NORTH TERMINAL RD.  
 HOUSTON, TX 77032


PROJECT NUMBER  
 1004395

SHEET TITLE  
**GENERAL NOTES & OVERALL SITE PLAN**


SHEET NUMBER

**S100**

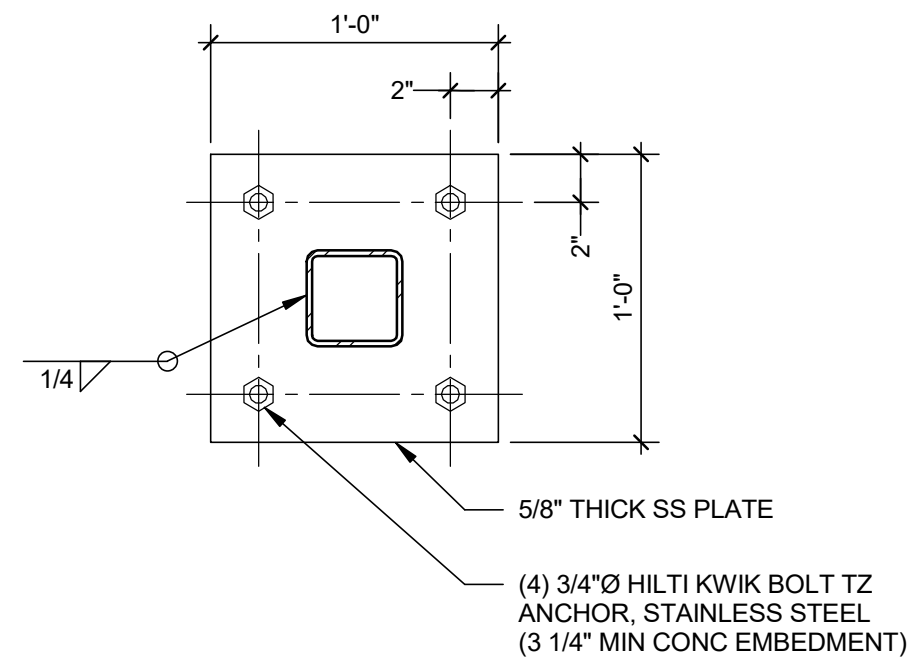
B:\Egnyte\Drive\Projects\HRS\Projects\H+R\2019 Jobs\19002 - IAH Terminal C Curbside Wayfinding\3-CAD\Revit Structure\19002\_TERMINAL C GARAGE\_R19.rvt  
 4/9/2024 12:12:21 PM




**4** SECTION  
1 1/2" = 1'-0"

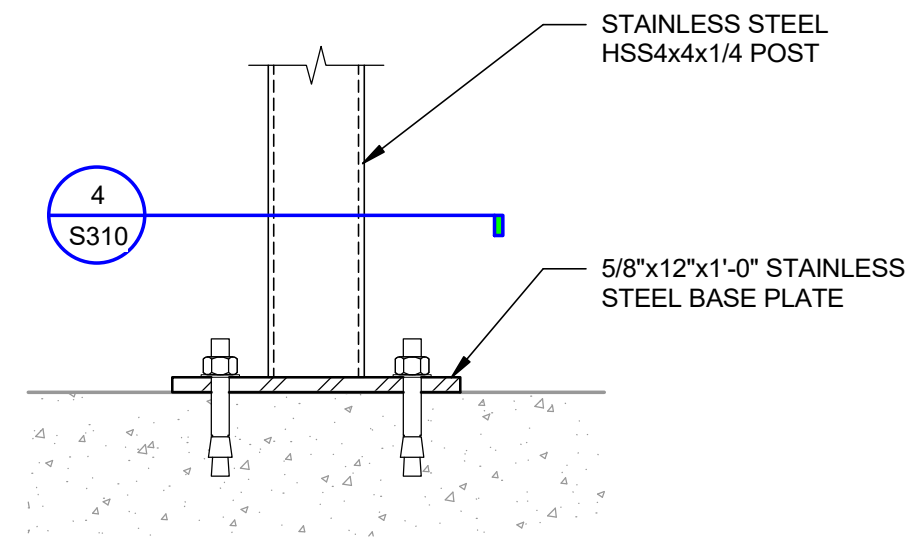

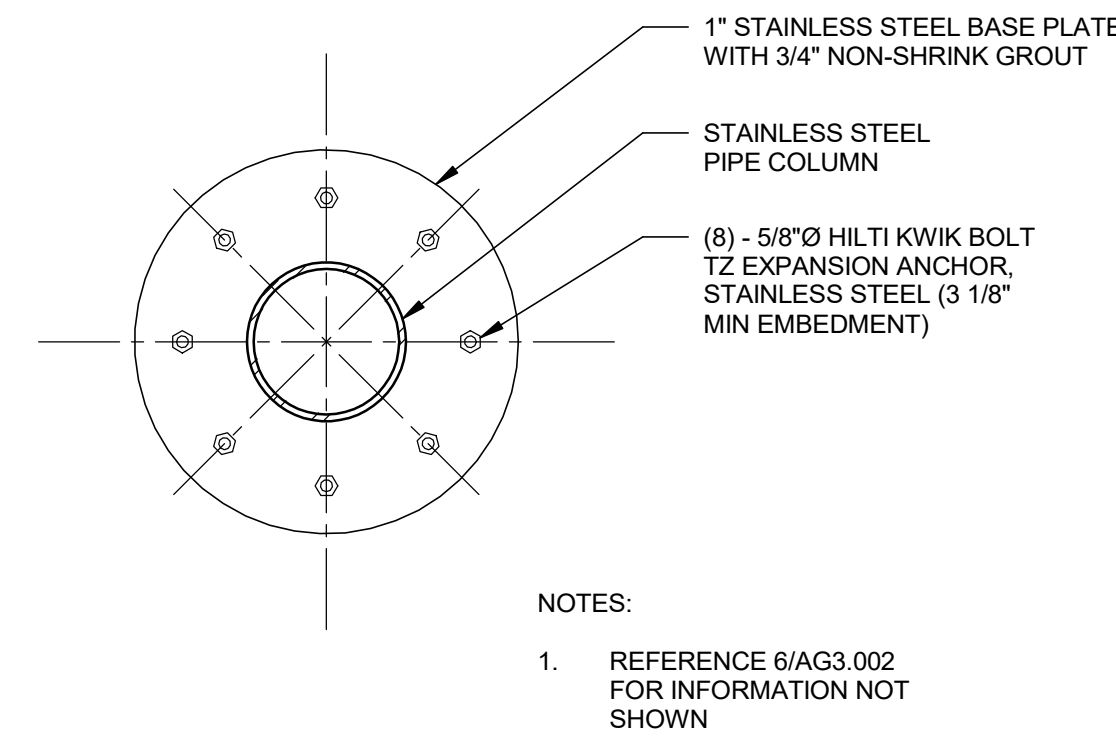**3** FLOOR MOUNTED FREE-STANDING GARAGE SIGN  
REF 5-DL.53 & 5-ID.42  
1 1/2" = 1'-0"




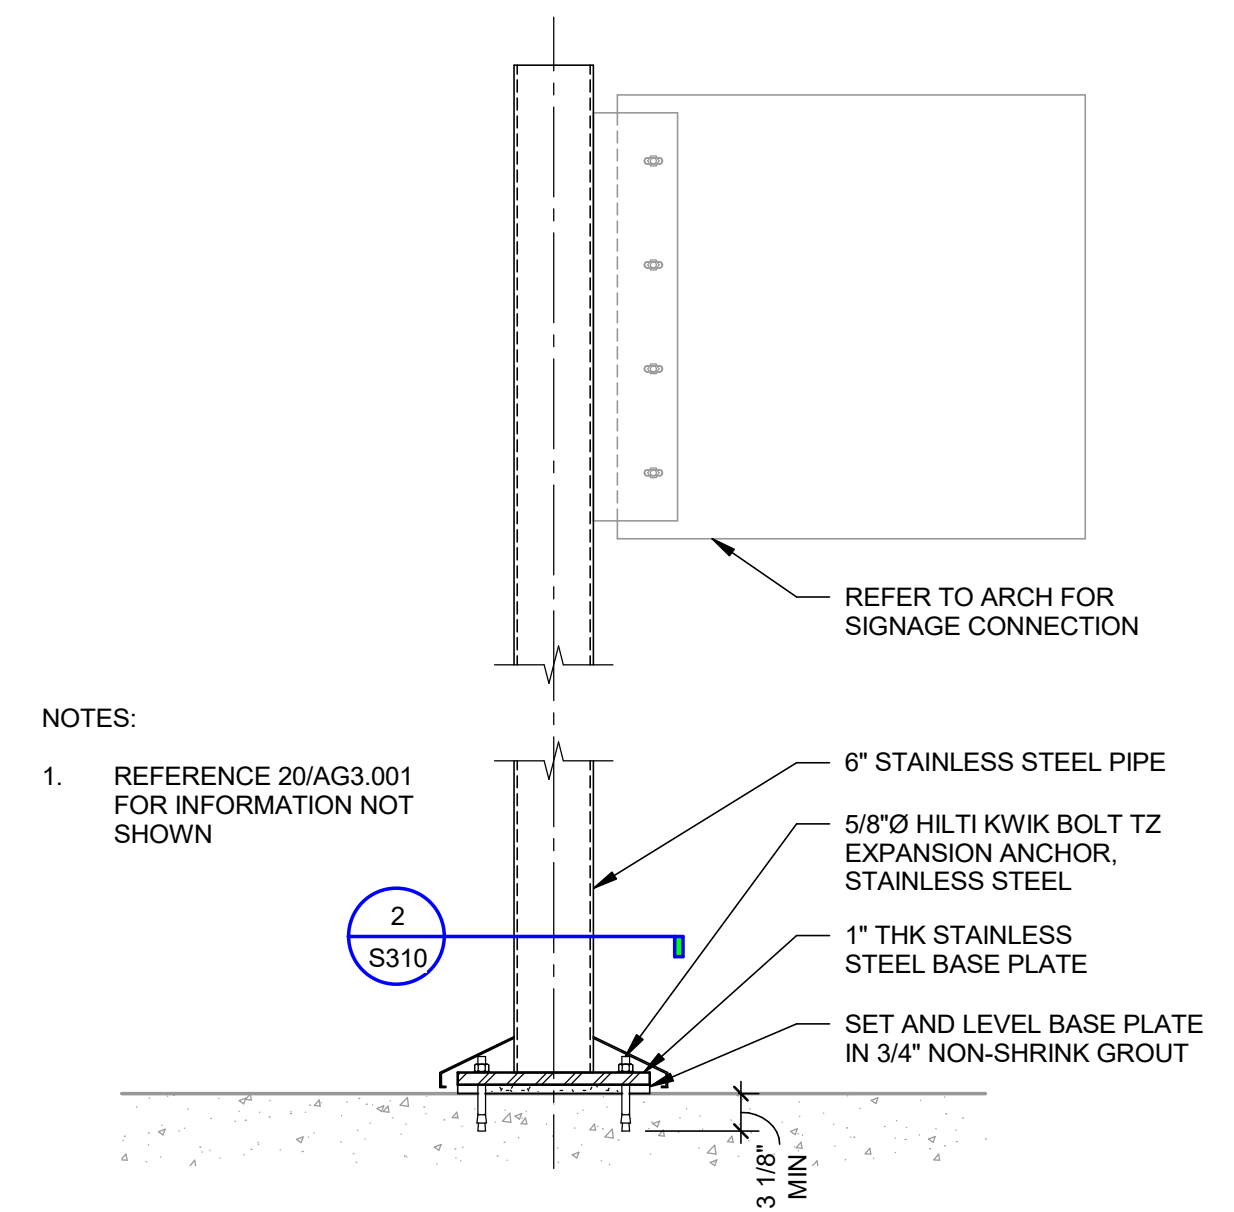**2** EXTERIOR POLE BASE PLATE  
1 1/2" = 1'-0"



**1** EXTERIOR POLE MOUNTED SIGN ANCHORAGE  
3/4" = 1'-0"

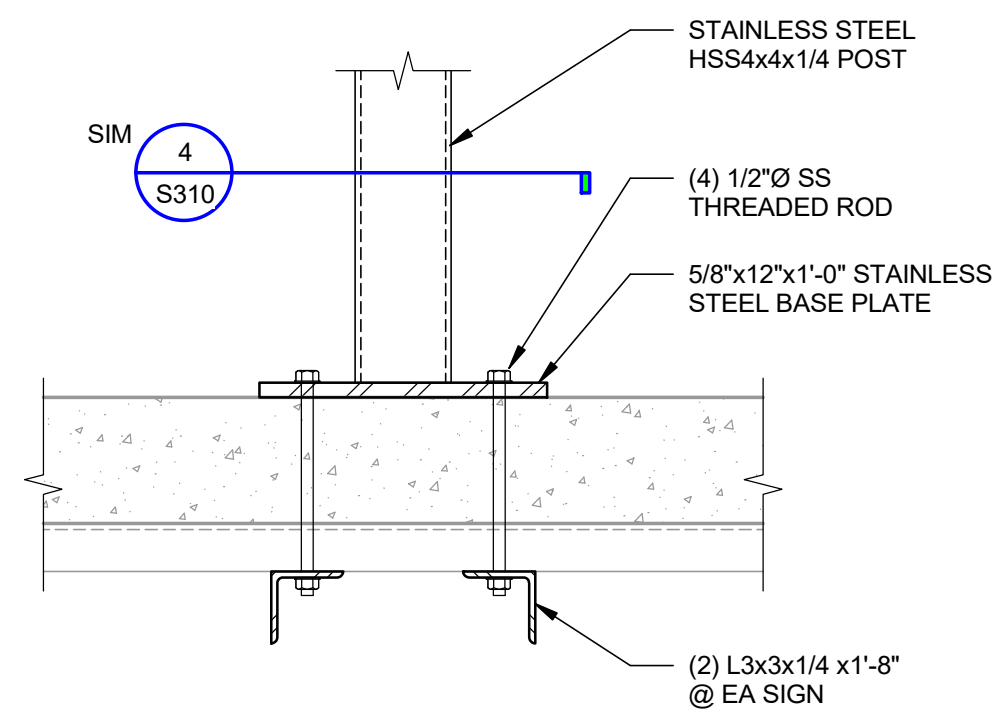
GC TO COORDINATE WATERPROOFING OF SLAB PENETRATION WITH ARCH



**8** FLOOR MOUNTED FREE-STANDING GARAGE SIGN  
REF 5-DL.53 & 5-ID.43  
1 1/2" = 1'-0"


GC TO FIELD VERIFY BOLLARD DIMENSIONS, MATCH EXISTING

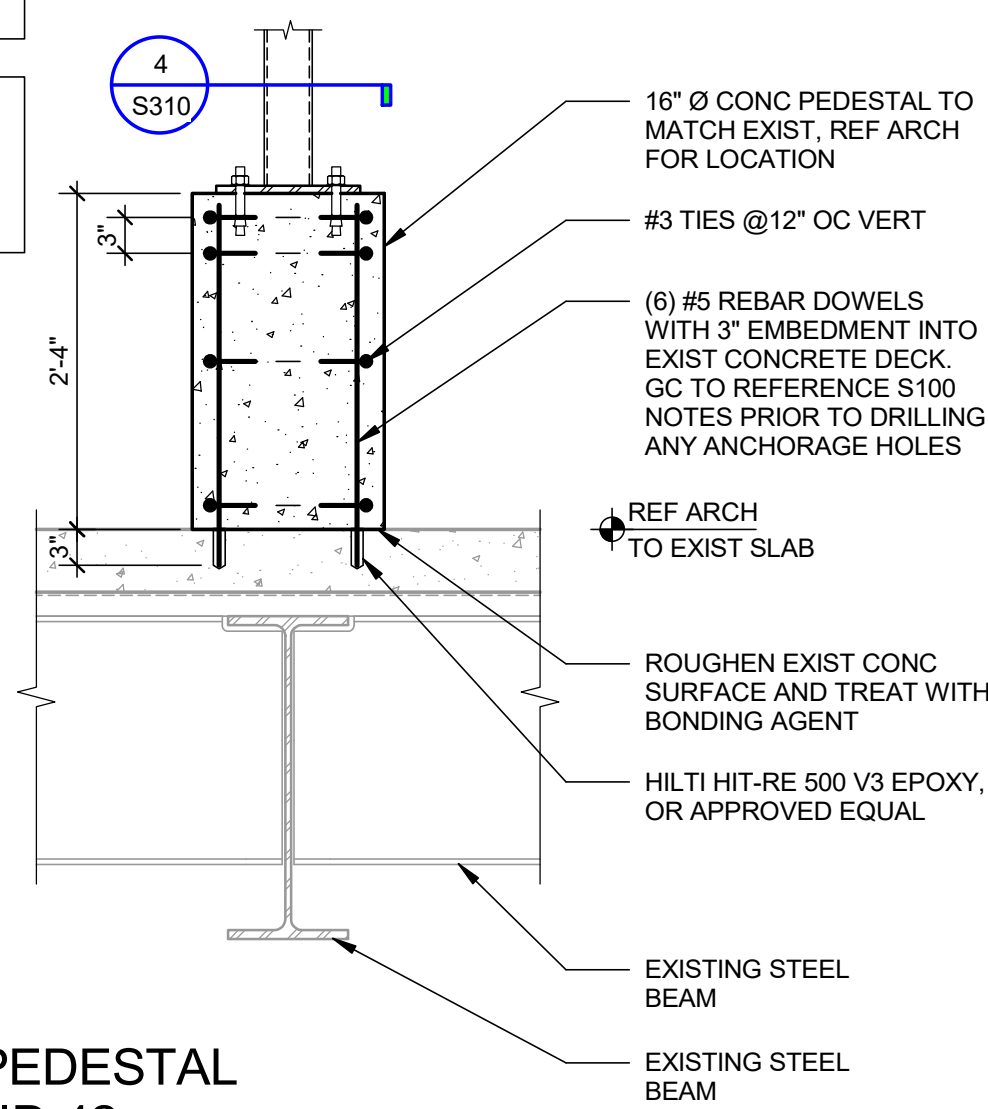GC TO FIELD VERIFY ADEQUATE CONC THICKNESS PRIOR TO DRILLING ANCHORS, 3 1/4" MIN




**7** SIGN PEDESTAL  
REF 5-ID.42  
3/4" = 1'-0"

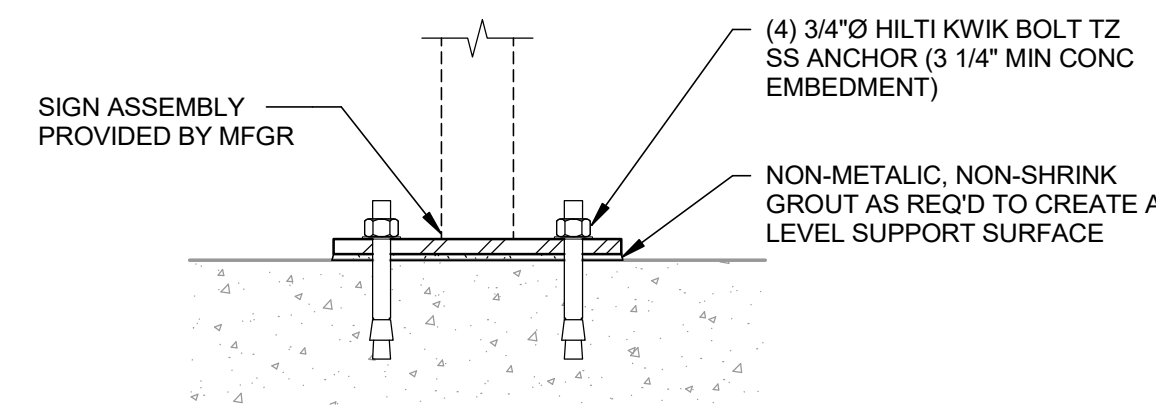GC TO LOCATE PT TENDONS PRIOR TO DRILLING ANCHORS, REF S100 NOTES



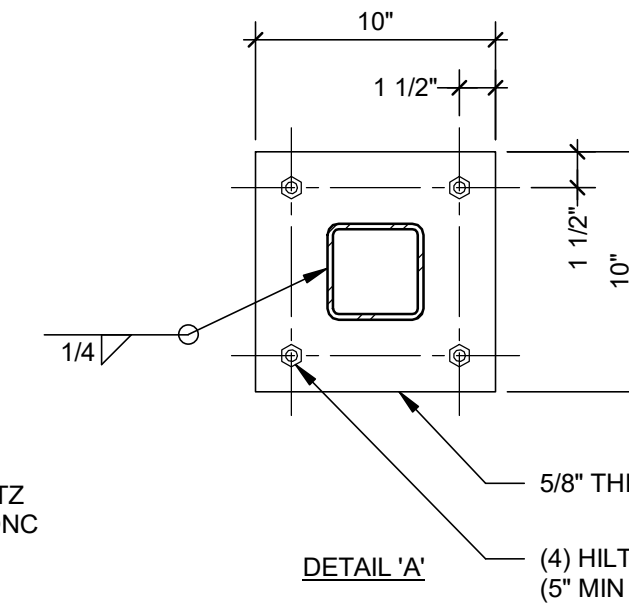**6** FLOOR MOUNTED DIRECTORY KIOSK ANCHORAGE  
1 1/2" = 1'-0"



**5** EXTERIOR HANGING SIGN ANCHORAGE  
REF 3-ID.16  
1 1/2" = 1'-0"



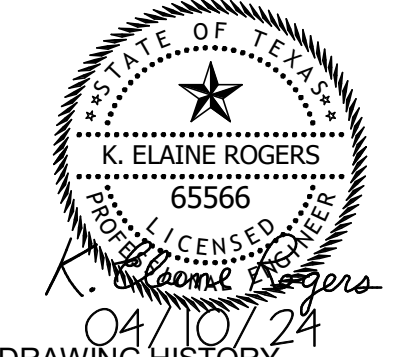
CLIENT  
**HAS AVIATION DEPT.**  
 16930 JOHN F. KENNEDY BLVD.  
 HOUSTON TX 77032  
 [T] 281 233 1757  
 [F] 281 233 1800



ARCHITECT  
**PGAL**  
 3131 BRIARPARK DR.  
 SUITE 200  
 HOUSTON, TX 77042  
 [T] 713 622 1444  
 [F] 713 968 9333  
 www.pgal.com

DEPARTMENT OF AVIATION  
 RECOMMENDED:  
 HOUSTON AIRPORT SYSTEM  
 DIRECTOR OR DESIGN REPRESENTATIVE  
**HAS TIP # 24-103 - IAH**

REGISTRATION  
 Copyright © 2024  
 Henderson + Rogers, Inc.  
 TBPE Firm Registration No. 2194



04/10/24

DRAWING HISTORY

No.	DATE	DESCRIPTION
1	04/10/2024	ISSUE FOR PERMIT
2	08/23/2024	ISSUE FOR BID

PROJECT NAME  
**IAH TERMINAL C GARAGE SIGNAGE & WAYFINDING**

PROJECT LOCATION  
 TERMINAL C  
 3500 NORTH TERMINAL RD.  
 HOUSTON, TX 77032

PROJECT NUMBER  
 1004395

SHEET TITLE  
**DETAILS**

SHEET NUMBER

**S310**

BSG PRJCT#BSG-2024-111-IAH