

CITY OF HOUSTON
HOUSTON AIRPORTS SYSTEM
Recommended: _____ DATE: 01/27/2022
Houston Airports System
Director or Designated Representative

REVIEWED / NO EXCEPTIONS TAKEN
The drawings & supporting documents submitted to permit review meet the design intent, and to the best of our knowledge appear to be in compliance with current H&M approved standards.
Performance and approval of this review does not constitute an approval of the design or the design team. Our review is limited to the information provided and does not constitute a warranty, endorsement, or representation of any kind. Authority Having Jurisdiction (AHJ).



7800 AIRPORT BLVD
HOUSTON, TEXAS 77061

**HOU INFORMATION COUNTER
RENOVATION**

C.I.P. No. _____ A.I.P. No. _____
C.O.H. No. _____ D.O.A No. _____



**ENGLISH + ASSOCIATES
Architects, Inc**

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www.english-architects.com

DESIGNER PROJECT No.: 20011.07
PROJECT STATUS:
100% PERMIT, BID CONSTRUCTION

REVISIONS

No.	DESCRIPTION	DATE	BY
1	SCHEMATIC DESIGN	10.23.20	
2	DESIGN DEVELOPMENT	12.04.20	
3	95% OWNER REVIEW	09.24.21	
4	100% PERMIT, BID AND CONSTRUCTION	11/08/21	

DESIGNER: _____ Designer
DRAWN BY: _____ MD
CHECKED BY: _____ ACM
ISSUE DATE: 11/08/2021
APPROVED BY: _____ Approver
APPROVAL DATE: _____

DIRECTOR
of
HOUSTON AIRPORT SYSTEM

Review/ Approval Category: _____
Approved For Construction: _____

PN # 941

TIP NO. # TIP-21-128-HOU

SHEET NAME: COVER

SHEET No. G000 SCALE: _____

SHEET SIZE: 22"x34" ANSI-D

HOUSTON AIRPORT SYSTEM

HOU INFORMATION COUNTER RENOVATION

MAYOR
SYLVESTER TURNER

CONTROLLER
CHRIS B. BROWN

CITY COUNCIL MEMBERS

- AMY PECK - DISTRICT A
- JERRY DAVIS - DISTRICT B
- ABBIE KAMIN - DISTRICT C
- CAROLYN EVANS-SHABAZZ - DISTRICT D
- DAVE MARTIN - DISTRICT E
- TIFFANY THOMAS - DISTRICT F
- GREG TRAVIS - DISTRICT G
- KARLA CISNEROS - DISTRICT H
- ROBERT GALLEGOS - DISTRICT I
- EDWARD POLLARD - DISTRICT J
- MARTHA CASTEX-TATUM - DISTRICT K

COUNCIL MEMBERS AT LARGE

- MIKE KNOX - AT LARGE 1
- DAVID ROBINSON - AT LARGE 2
- MICHAEL KUBOSH - AT LARGE 3
- LETITIA PLUMMER - AT LARGE 4
- SALLIE ALCORN - AT LARGE 5

WILLIAM P. HOBBY AIRPORT (HOU)
100% PERMIT, BID
CONSTRUCTION

PROJECT TEAM

OWNER
HOUSTON
AIRPORT SYSTEM

7800 AIRPORT BLVD
HOUSTON, TX 77061
713.640.3000 (P)

ARCHITECT
ENGLISH + ASSOCIATES
ARCHITECTS, INC.


1919 DECATUR ST.
HOUSTON, TX 77007
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MEP
E&C ENGINEERS &
CONSULTANTS, INC.


1010 LAMAR ST, STE 650
HOUSTON, TX 77002
713.580.8800 (P)

IT
PGA ENGINEERS, INC.

3838 N. SAM HOUSTON PKWY E.,
STE. 550
HOUSTON, TX 77032
346.570.2418 (P)

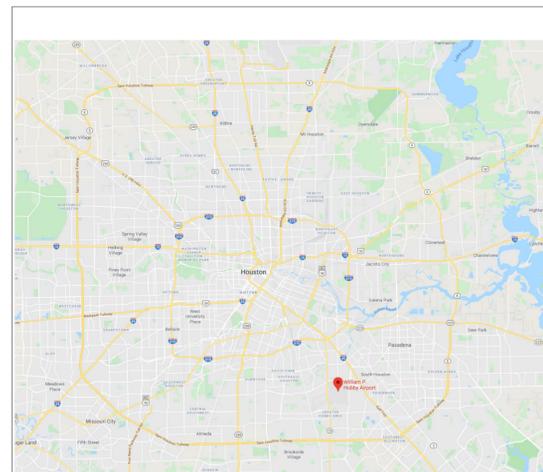

AREA MAP
N.T.S.

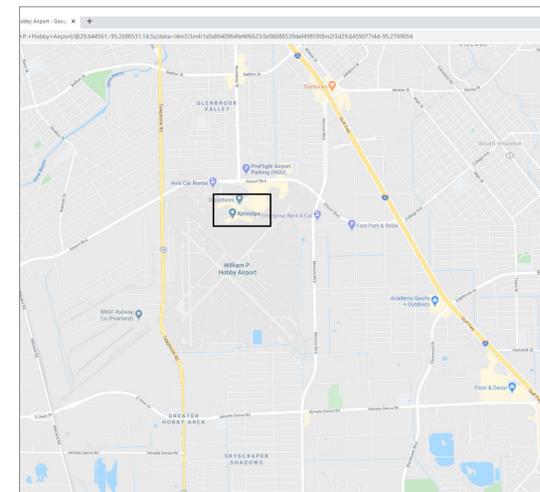

VICINITY MAP
N.T.S.

FILE PATH:

HAS FILE:

PLOT DATE:
DOA DWG FILE:
OLD DOA No.:

1/A101 Ref

ENLARGED PLAN / DETAIL REFERENCE

SPOT ELEVATION

BREAK LINE

REVISION / ADDENDUM CLOUD

CENTERLINE

BUILDING SECTION

SECTION

NORTH ARROW

LEVEL ANNOTATION

STRUCTURAL GRID ANNOTATION

WINDOW TAG

EQUIPMENT / KEYED TAG

ROOM TAG

1/A101

1/A101

NORTH

Name Elevation

0

1t

1i

Room name 101

MATERIAL SYMBOL D3

WOOD

ALUMINUM

STEEL

EARTH

GYPSUM - PLASTER

CONCRETE BLOCK

RIGID INSULATION

BATT INSULATION

CONCRETE

MASONRY

SITE CONTEXT MAP B2

PROJECT SITE

GENERAL NOTES C4

- 1 THE CONTRACTOR SHALL THOROUGHLY EXAMINE THE PREMISES AND BASE HIS BID ON THE EXISTING CONDITIONS. THE CONTRACTOR SHALL NOTIFY THE ARCHITECT PROMPTLY OF ANY DISCREPANCIES IN THE FIELD CONDITIONS OR DIMENSIONS PRIOR TO SUBMITTING HIS BID.
- 2 THE ARCHITECT SHALL BE THE PRIMARY SOURCE FOR INFORMATION REGARDING EACH DISCIPLINE, IE: ARCHITECTURAL, MECHANICAL, PLUMBING, ELECTRICAL, STRUCTURAL, ETC.
- 3 THE CONTRACTOR SHALL BE RESPONSIBLE FOR PROVIDING ALL MATERIALS AND WORKMANSHIP IN ACCORDANCE WITH ALL APPLICABLE HEALTH AND SAFETY REQUIREMENTS, BUILDING CODES, AND ORDINANCES.
- 4 ALL EQUIPMENT, FIXTURES, ETC. SHOWN ON THE PLAN SHALL BE PROVIDED AND INSTALLED BY THE CONTRACTOR UNLESS NOTED OTHERWISE.
- 5 THE CONTRACTOR SHALL SUBMIT SHOP DRAWINGS AND SAMPLES OF ALL FOUNDATIONS, STEEL WORK, SITE WORK, MILLWORK, SPECIAL CONSTRUCTION, ETC. IN A TIMELY MANNER FOR THE ARCHITECT'S REVIEW PRIOR TO ORDERING, FABRICATING, OR INSTALLING.
- 6 DIMENSIONS ARE SHOWN ON THE PLANS. DO NOT SCALE OFF OF THE DRAWINGS. ALL DIMENSIONS ARE FROM FACE TO FACE OF PARTITIONS UNLESS NOTED OTHERWISE.
- 7 ALL HEIGHTS ARE DIMENSIONED FROM THE TOP OF CONCRETE SLAB UNLESS NOTED OTHERWISE.
- 8 ALL WORK SHALL CONFORM TO THE APPLICABLE PORTIONS OF THE SPECIFICATIONS, UNLESS NOTED OTHERWISE. THE CONTRACTOR SHALL NOTIFY THE ARCHITECT OF DISCREPANCIES BETWEEN THE DRAWINGS AND THE SPECIFICATIONS PRIOR TO PROCEEDING WITH CONSTRUCTION.
- 9 ALL FINISH & CONSTRUCTION MATERIALS USED SHALL MEET MINIMUM REQUIRED FIRE CLASS & SMOKE DEVELOPED RATINGS, IE. CLASS A, S.D. 0.
- 10 MANUFACTURED MATERIALS, EQUIPMENT, ETC. SPECIFIED FOR THIS CONTRACT SHALL BE INSTALLED ACCORDING TO THE MANUFACTURER'S INSTRUCTIONS AND RECOMMENDATIONS UNLESS NOTED OTHERWISE.
- 11 ALL REQUESTS FOR SUBSTITUTIONS OF ANY ITEMS SPECIFIED SHALL BE SUBMITTED IN WRITING TO THE ARCHITECT AND SHALL BE CONSIDERED ONLY IF BETTER SERVICE FACILITIES, MORE ADVANTAGEOUS DELIVERY DATE, OR A LESSER PRICE WITH A CREDIT TO THE OWNER WILL BE PROVIDED WITHOUT SACRIFICING QUALITY, APPEARANCE, AND FUNCTION. UNDER NO CIRCUMSTANCES WILL THE ARCHITECT BE REQUIRED TO PROVE THAT A PRODUCT PROPOSED FOR SUBSTITUTION IS OR IS NOT OF EQUAL QUALITY TO THE PRODUCT SPECIFIED.
- 12 "TYPICAL" MEANS TYPICAL FOR ALL SIMILAR CONDITIONS UNLESS NOTED OTHERWISE.
- 13 ALL MATERIALS USED FOR NEW CONSTRUCTION INCLUDING, BUT NOT LIMITED TO: INSULATION, ADHESIVES, COATINGS, ETCETERA; SHALL BE ENTIRELY FREE FROM ASBESTOS.
- 14 CONTRACTOR SHALL BE RESPONSIBLE FOR ALL PERMITS AND FEES.
- 15 ALL NEW GYPSUM BOARD CONSTRUCTION SHOWN ALIGNED WITH EXISTING CONSTRUCTION SHALL BE INSTALLED IN THE SAME PLANE AS THE EXISTING WITH NO VISIBLE JOINT. ALL DAMAGED GYPSUM BOARD FROM EXISTING OR RESULTING FROM NEW CONSTRUCTION SHALL BE REPAIRED TO REMOVE ANY VISIBLE MARKS OR DISCOLORATIONS.
- 16 ALL WORK WITH NOISE PRODUCING, OR DISRUPTIVE EQUIPMENT NEAR OCCUPIED AREAS OF THE BUILDING IS SUBJECT TO COORDINATION WITH THE OWNER'S PROJECT MANAGER ON SITE.
- 17 ANY FLOOR PENETRATION WILL NEED TO BE X-RAY SCANNED WITH A GPR REPORT TO IDENTIFY EXISTING REINFORCING BARS AND/OR UTILITIES THROUGHOUT THE EXISTING SLAB/FLOOR PRIOR TO DRILLING/CORING FOR ANY PENETRATIONS. THIS INCLUDES BUT NOT LIMITED TO FLOOR ANCHORS, CORES, ELECTRICAL POKE-THRU'S, ETC. ALL SCANS ARE TO BE SUBMITTED TO HAS/EOR FOR REVIEW BEFORE WORK CAN BE PERFORMED.
- 18 THIS PROJECT SHALL FOLLOW HOUSTON AIRPORT SYSTEM (HAS) STANDARDS FOR ALL DISCIPLINES. ANY CONFLICTS BETWEEN HAS STANDARDS AND BID/CONSTRUCTION DOCUMENTS ARE TO BE BROUGHT TO THE ARCHITECT'S ATTENTION VIA RFI IMMEDIATELY.

PROJECT DESCRIPTION D

REPLACEMENT OF SEVERAL INFORMATION COUNTERS IN FOUR SEPARATE PARTS OF THE AIRPORT

PROJECT LOCATION

7800 AIRPORT BLVD
HOUSTON, TEXAS 77061

MODEL CODES FOR THE RENOVATION

BUILDING CODE	2012 INTERNATIONAL BUILDING CODE
FIRE CODE	2012 INTERNATIONAL FIRE CODE
MECHANICAL CODE	2012 UNIFORM MECHANICAL CODE
ELECTRICAL CODE	2017 NATIONAL ELECTRICAL CODE
PLUMBING CODE	2012 UNIFORM PLUMBING CODE
ENERGY CODE	2015 IECC
ACCESSIBILITY CODE	2012 TEXAS ACCESSIBILITY CODE

ORIGINAL BUILDING CONSTRUCTED

UNKNOWN

MODEL CODES FOR ORIGINAL CONST.

UNKNOWN

CURRENT BUILDING SIZE PER FLOOR

VARIES

NUMBER OF STORIES

3

AREA MODIFIED BY PROJECT

650 ft²

CONSTRUCTION TYPE

IA

OCCUPANCY TYPE

A-3

OCCUPANCY LOAD PER FLOOR

+/- VARIES

SPRINKLERED

YES

TYPICAL CEILING HEIGHT

VARIES

HOUSTON AIRPORTS

HOUSTON INFORMATION COUNTER RENOVATION

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GENERAL PROJECT DESCRIPTION D

SHEET NUMBER	SHEET NAME	SCHEMATIC DESIGN	DESIGN DEVELOPMENT	CONSTRUCTION DOCUMENTS
GENERAL				
G000	COVER	X	X	X
G001	INDEX, PROJECT INFO & NOTES	X	X	X
G002	REFERENCE PLAN - BAGGAGE CLAIM	X	X	X
G003	REFERENCE PLAN - LEVEL 1	X	X	X
ARCHITECTURAL				
AD101	DEMOLITION PLAN - BAGGAGE CLAIM - AREA A	X	X	X
AD102	DEMOLITION PLAN - LEVEL 1 - AREA B & C	X	X	X
A101	ARCHITECTURAL FLOOR PLAN - BAGGAGE CLAIM - AREA A	X	X	X
A102	ARCHITECTURAL FLOOR PLAN - LEVEL 1 - AREAS B AND C	X	X	X
A103	ARCHITECTURAL FLOOR PLAN - LEVEL 1 - AREA D	X	X	X
AE101	DATA, ELEC, EQUIPT. LOCATION PLAN - BAGGAGE CLAIM - AREA A	X	X	X
AE102	DATA, ELEC, EQUIPT. LOCATION PLAN - LEVEL 1 - AREAS B AND C	X	X	X
AE103	DATA, ELEC, EQUIPT. LOCATION PLAN - LEVEL 1 - AREA D	X	X	X
A350	WALL SECTIONS	X	X	X
A351	WALL SECTIONS	X	X	X
A401	ENLARGED "VIEWS"	X	X	X
A402	IT, DATA, & ELECTRICAL ELEVATIONS	X	X	X
A850	MILLWORK SECTIONS AND DETAILS	X	X	X
ELECTRICAL				
E000	ELECTRICAL SYMBOLS AND ABBREVIATIONS	X	X	X
E002	ELECTRICAL OVERALL PLAN - BAGGAGE CLAIM	X	X	X
E003	ELECTRICAL OVERALL PLAN - TICKETING	X	X	X
E100	ELECTRICAL PLAN - AREA A	X	X	X
E101	ELECTRICAL PLAN AREA B & C	X	X	X
E102	ELECTRICAL PLAN AREA D	X	X	X
E200	ELECTRICAL SCHEDULES AND RISERS	X	X	X
TECHNOLOGY				
T-001	TECHNOLOGY - INDEX SYMBOLS & NOTES	X	X	X
T-002	TECHNOLOGY - GENERAL NOTES	X	X	X
T-101	TECHNOLOGY - REFERENCE PLAN - BAGGAGE CLAIM	X	X	X
T-102	TECHNOLOGY - REFERENCE PLAN - LEVEL 1	X	X	X
T-103	TECHNOLOGY - DEMOLITION PLAN - BAGGAGE CLAIM - AREA A	X	X	X
T-104	TECHNOLOGY - DEMOLITION PLAN - LEVEL 1 - AREA B & C	X	X	X
T-106	TECHNOLOGY - FLOOR PLAN - BAGGAGE CLAIM - AREA A	X	X	X
T-107	TECHNOLOGY - FLOOR PLAN - LEVEL 1 AREA B & C	X	X	X
T-108	TECHNOLOGY - FLOOR PLAN - LEVEL 1 AREA D	X	X	X
T-401	TECHNOLOGY - IDF 100.14 ENLARGED PLAN	X	X	X
T-402	TECHNOLOGY - IDF 101.40 ENLARGED PLAN	X	X	X
T-403	TECHNOLOGY - IDF 313.10 ENLARGED PLAN	X	X	X
T-404	TECHNOLOGY - IDF 313.10 ENLARGED PLAN	X	X	X
T-501	TECHNOLOGY - EQUIPMENT DETAILS	X	X	X
T-601	TECHNOLOGY - EQUIPMENT SCHEDULES	X	X	X

DESIGNER: Designer

DRAWN BY: MD

CHECKED BY: 07.08.21

ISSUE DATE: 09/24/2021

APPROVED BY: Approver

APPROVAL DATE:

DIRECTOR of HOUSTON AIRPORT SYSTEM

Review Approval Category

Approved For Construction

REGISTERED ARCHITECT
KATHLEEN A. ENGLISH
12622
11/08/2021

SYMBOLS LEGEND A2

APPROXIMATE LOCATION BASED ON USER INPUT AND DOES NOT REPRESENT AN AUTHORITY PROPERTY LOCATION

SELECTED FLOODMAP BOUNDARY

DIGITAL DATA AVAILABLE

NO DIGITAL DATA AVAILABLE

UNMAPPED

AREA OF MINIMAL FLOOD HAZARD ZONE X

EFFECTIVE LOMRS

AREA OF UNDETERMINED FLOOD HAZARD ZONE D

OTHERWISE PROTECTED AREA

COASTAL BARRIER RESOURCE SYSTEM AREA

WITHOUT BASE FLOOD ELEVATION (BFE) ZONE A, V, A99

WITH BFE OR DEPTH

REGULATORY FLOODWAY ZONE AE, AD, AH, VE, AR

0.2% ANNUAL CHANCE FLOOD HAZARD, AREAS OF 1% ANNUAL CHANCE FLOOD WITH AVERAGE DEPTH LESS THAN ONE FOOT OR WITH DRAINAGE AREAS OF LESS THAN ONE SQUARE MILE ZONE X

FUTURE CONDITIONS 1% ANNUAL CHANCE FLOOD HAZARD ZONE X

AREA WITH REDUCED FLOOD RISK DUE TO LEVEE. SEE NOTES, ZONE X

AREA WITH FLOOD RISK DUE TO LEVEE ZONE D

CROSS SECTIONS WITH 1% ANNUAL CHANCE WATER SURFACE ELEVATION

COASTAL TRANSECT

BASE FLOOD ELEVATION LINE (BFE)

LIMIT OF STUDY

JURISDICTION BOUNDARY

COASTAL TRANSECT BASELINE

PROFILE BASELINE

HYDROGRAPHIC FEATURE

CHANNEL, CULVERT, OR STORM SEWER

LEVEE, DIKE, OR FLOODWALL

VICINITY MAP WITH FLOOD PLAIN B

NO PORTION OF THE SITE IS IN A FLOOD ZONE

DRAWING LIST D1

SHEET No.	SCALE:	As indicated
G001		

PN # 941

TIP NO. # TIP-21-128-HOU

SHEET NAME: INDEX, PROJECT INFO & NOTES

SHEET No.: G001

SCALE: As indicated

SHEET SIZE: 22"x34" ANSI-D

FILE PATH:

HAS FILE:

PLOT DATE:

DOA DWG FILE:

OLD DOA No. :

A

B

C

D

CITY OF HOUSTON
HOUSTON AIRPORTS SYSTEM

Recommended: _____ DATE: 01/27/2022
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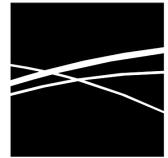
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DRAWN BY: _____ MD
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ISSUE DATE: _____ 09/24/2021
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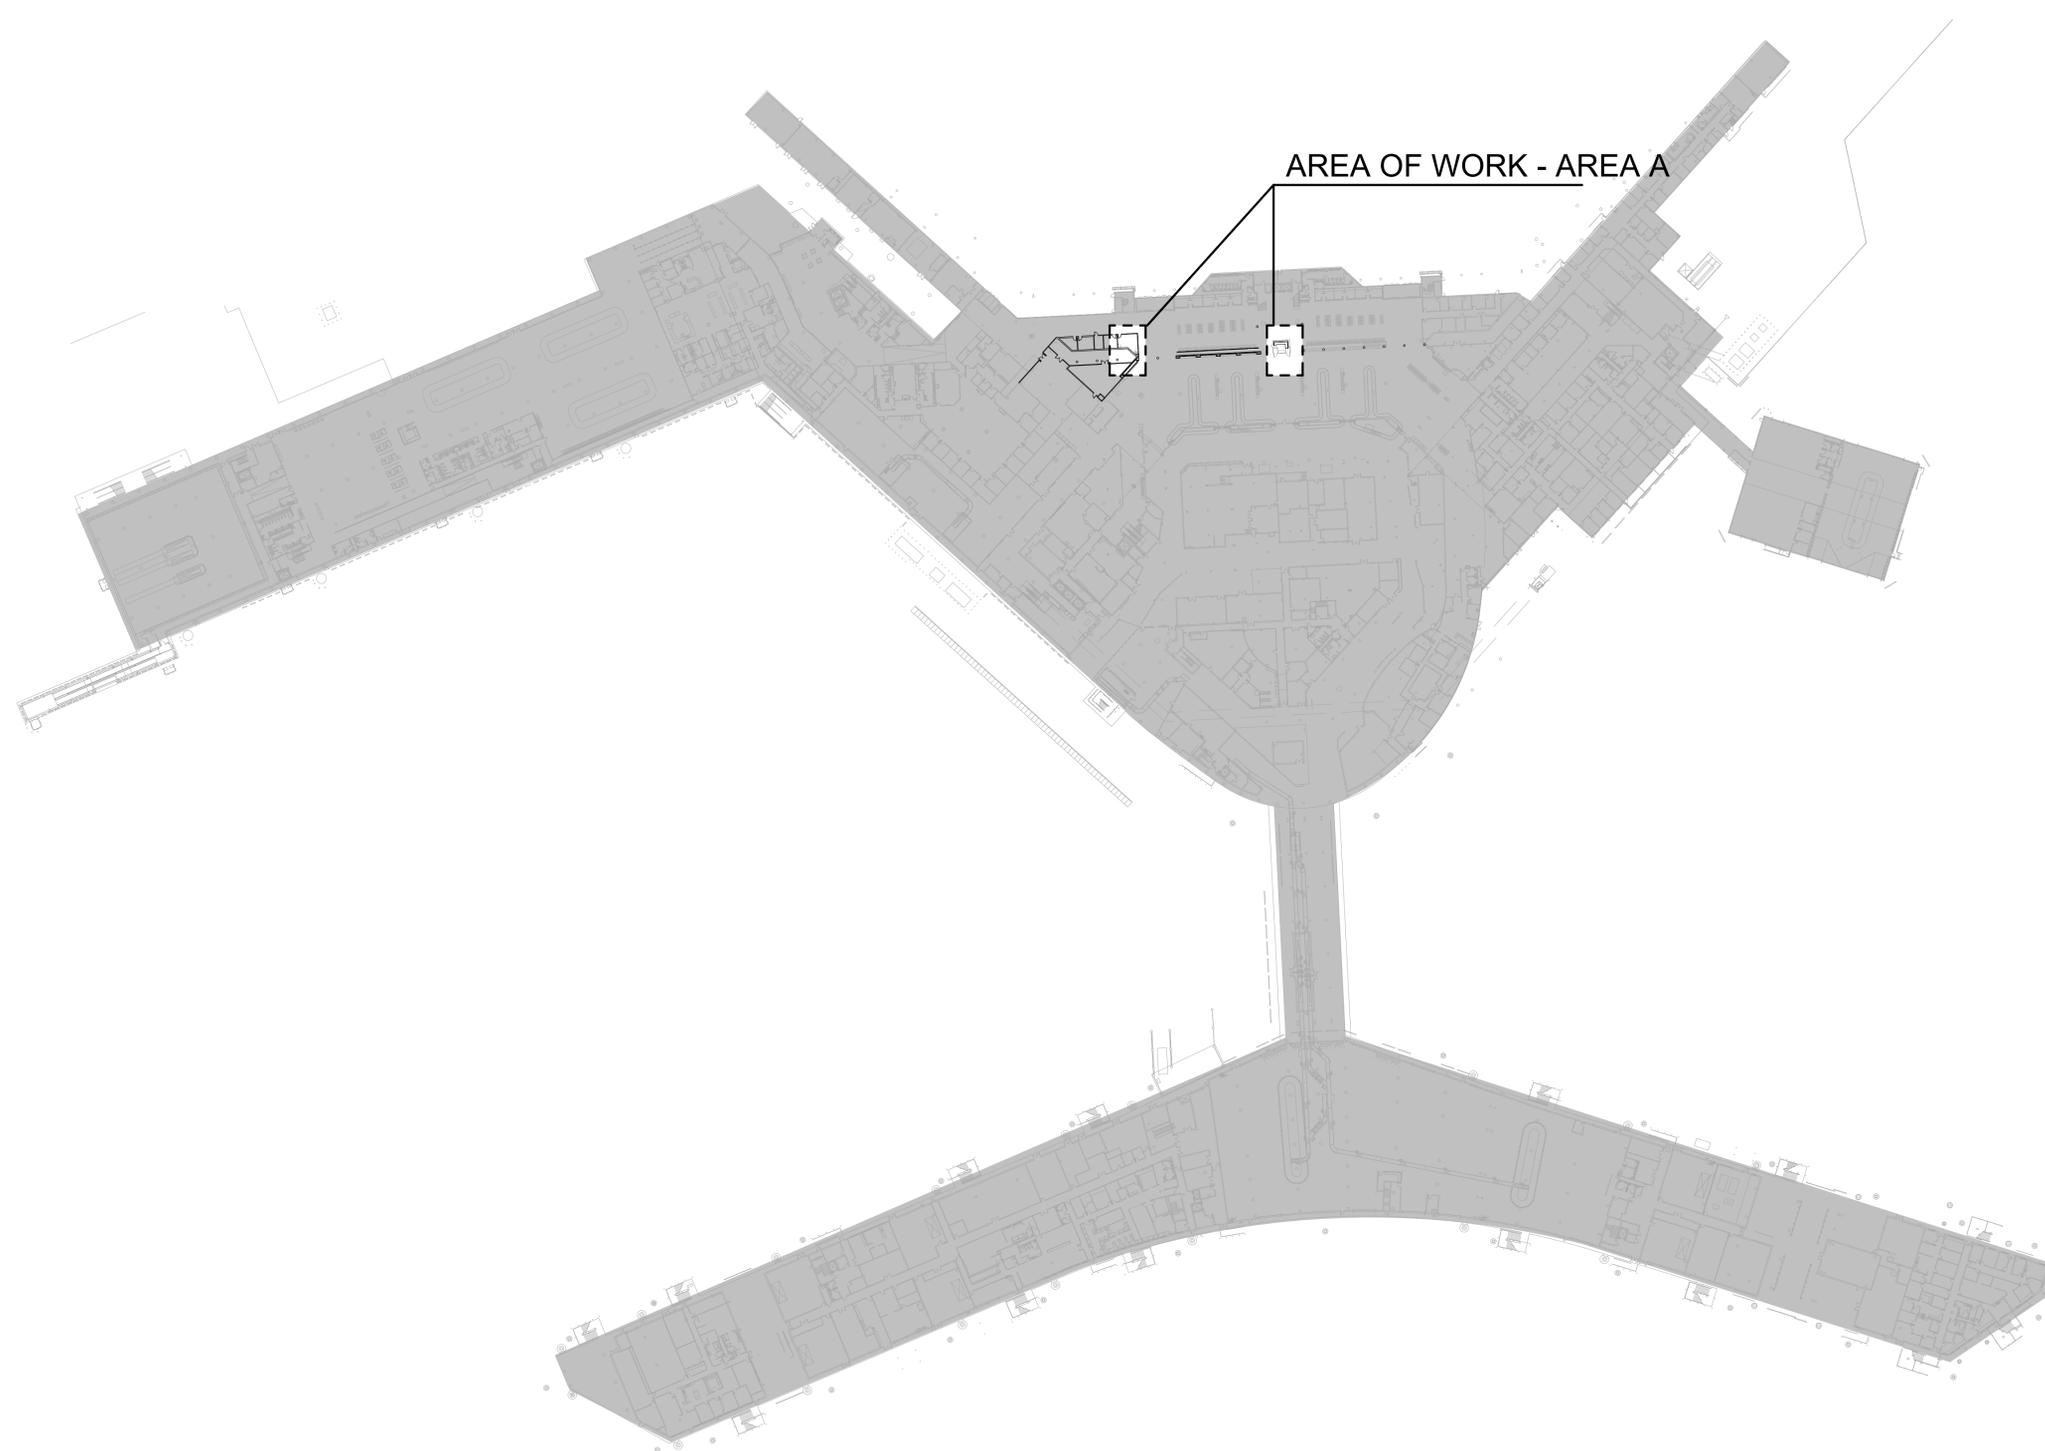
PN # 941

TIP NO. # TIP-21-128-HOU

SHEET NAME: REFERENCE PLAN - BAGGAGE CLAIM

SHEET No. G002 SCALE: 1" = 80'-0"

SHEET SIZE: 22"x34" ANSI-D



OVERALL PLAN - BAGGAGE CLAIM SCAL 1" = 80'-0"

D1

- G002 -

A

B

C

D

FILE PATH:

HAS FILE:

PLOT DATE:
DOA DWG FILE:
OLD DOA No.:

A B C D

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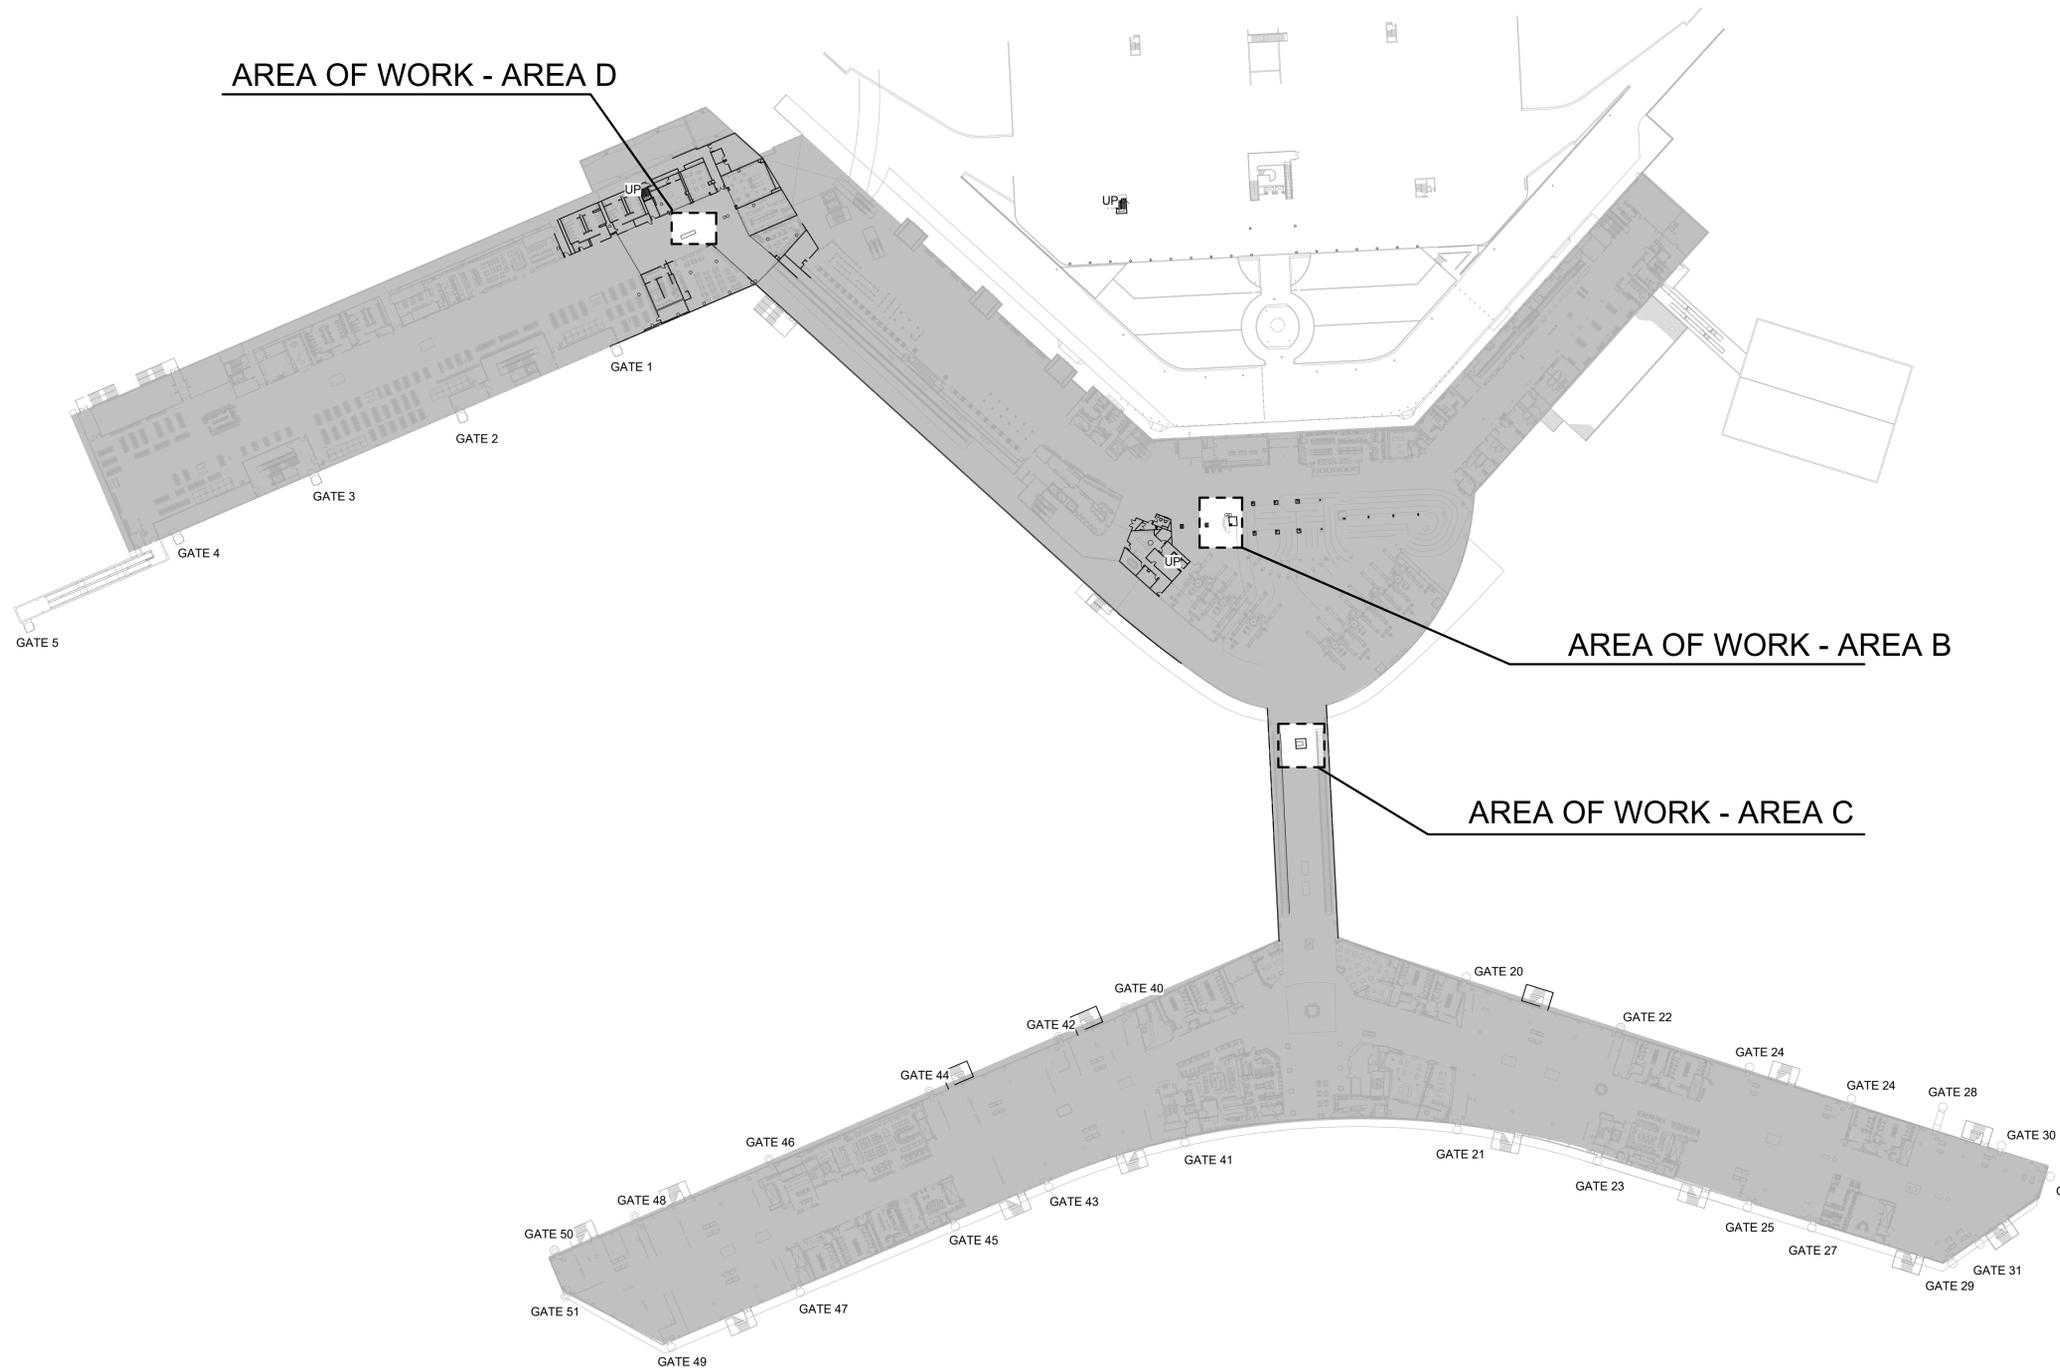
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3
2
1
PLOT DATE: DOA DWG FILE: OLD DOA No. :
FILE PATH:
HAS FILE:

A B C D OVERALL PLAN - LEVEL 1 (TICKETING) SCAL 1" = 80'-0" D1

PN # 941
TIP NO. # TIP-21-128-HOU
SHEET NAME: REFERENCE PLAN - LEVEL 1
SHEET No. G003 SCALE: 1" = 80'-0"
SHEET SIZE: 22"x34" ANSI-D

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HOUSTON AIRPORTS SYSTEM
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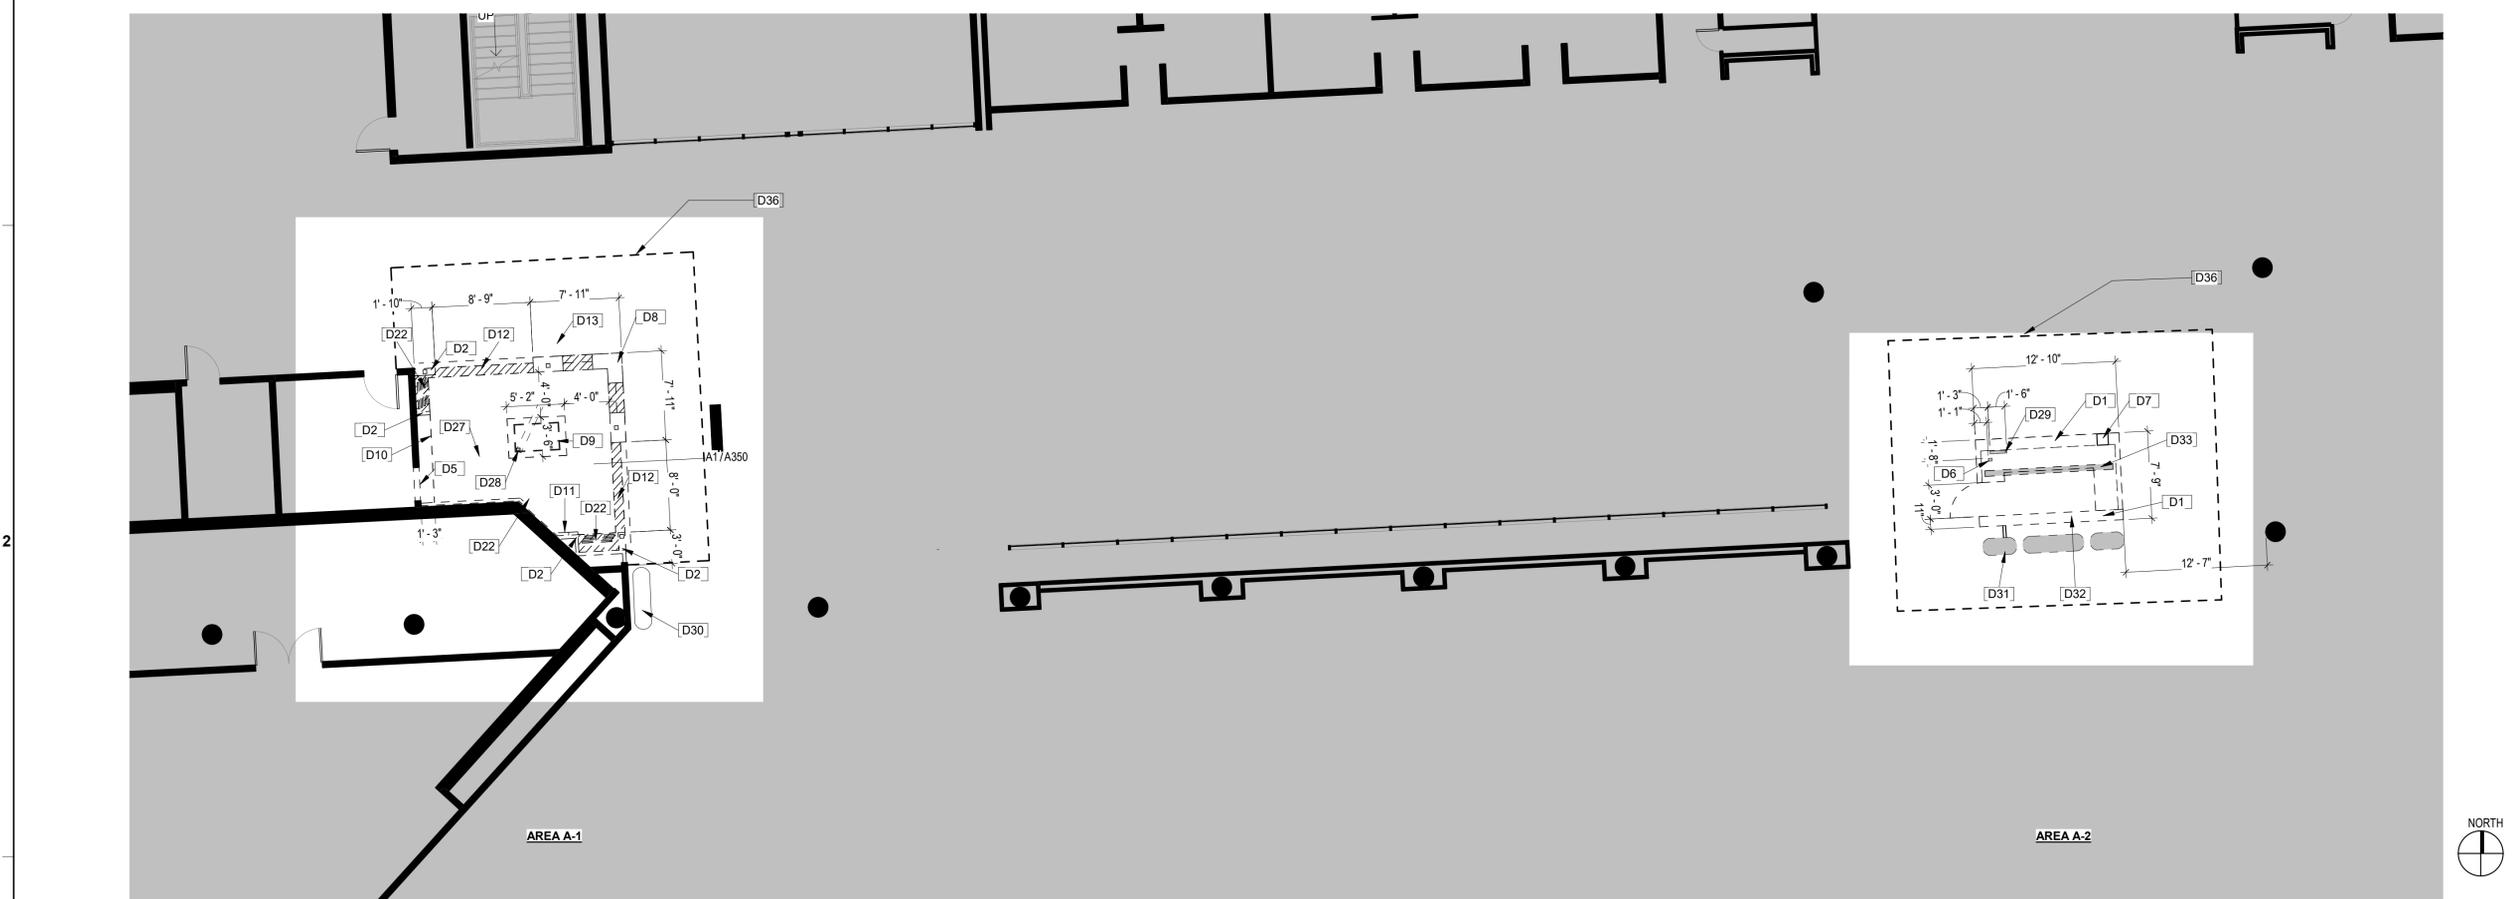
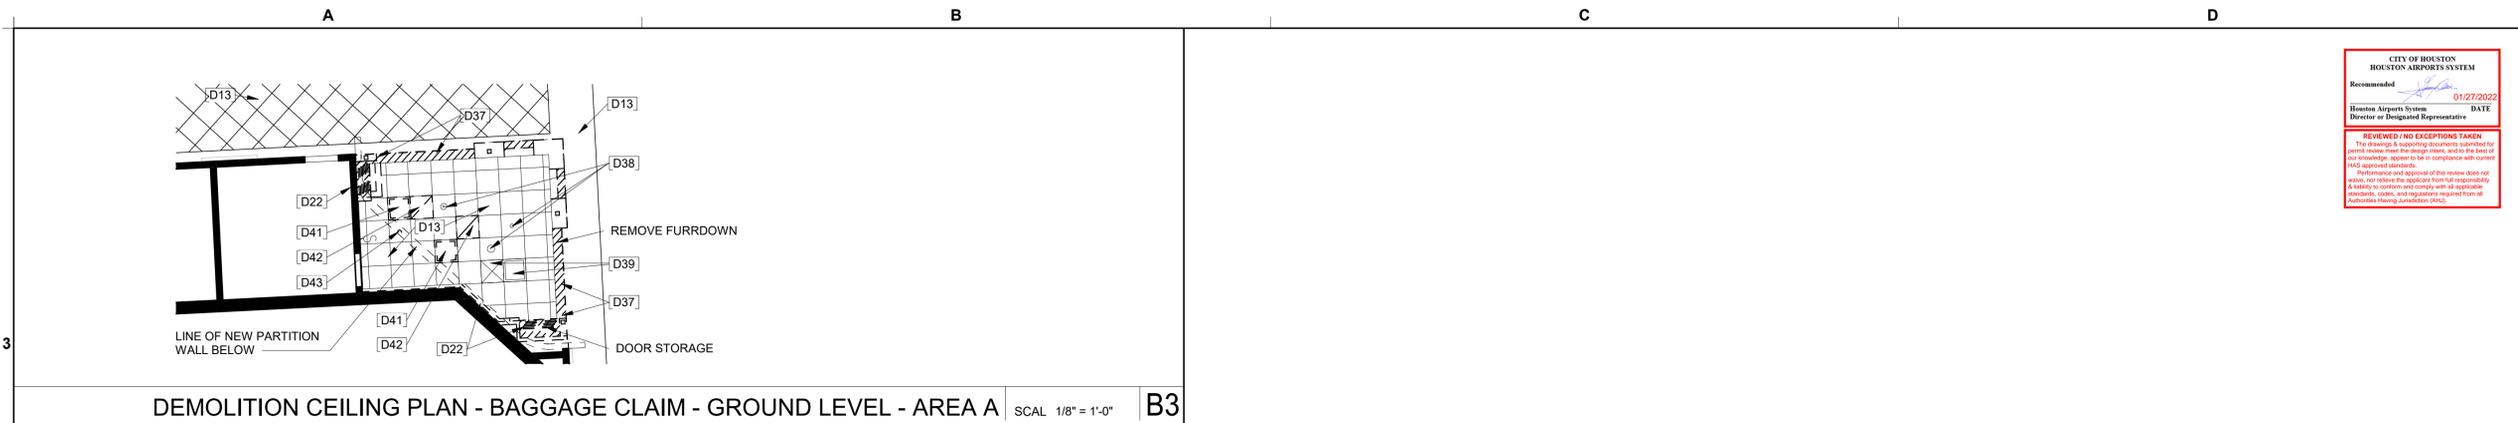
PN # 941

TIP NO. # TIP-21-128-HOU

SHEET NAME: DEMOLITION PLAN - BAGGAGE CLAIM - AREA A

SHEET No. AD101 SCALE: As indicated

SHEET SIZE: 22"x34" ANSI-D



GENERAL NOTES		KEYED NOTES		SYMBOLS LEGEND	
11	THERMOSTATS LOCATED ON WALLS TO BE REMOVED, SHALL BE PROTECTED AND SECURED ABOVE THE CEILING AND TAGGED WITH THE ZONE NUMBER.	D1	CAREFULLY DEMO EXISTING INFORMATION DESK COUNTER, CABINETS AND BACK WALL.	D37	CAREFULLY REMOVE EXISTING DOOR COMPONENTS, "H" LIGHTS, AND ALL OTHER OBSTRUCTIONS ALONG BOTTOM EDGE OF EXISTING ROOM EDGE FURRDOWN TO REMAIN RE: DETAIL A1/350. EXTEND EXTERIOR FURRDOWN TO ENCLOSE SPACE AS SHOWN IN NEW REFLECTED CEILING PLAN D3/A101. EXTEND ALL CELING GRID. PATCH, PAINT AND REPAIR AS NEEDED.
12	ALL EXISTING FLOORS MOUNTED OUTLETS DESIGNATED TO BE REMOVED, CONTRACTOR SHALL FILL CORES WITH CONCRETE OR EPOXY AND FIRE SEALED AS PER CODE.	D2	CAREFULLY DEMO EXISTING WALL.	D38	PROTECT EXISTING SPEAKER, SPRINKLER HEAD AND FIRE ALARM. TEST AND REPAIR TO REMAIN FUNCTIONAL AFTER CONSTRUCTION AS SHOWN IN NEW DESIGN. RE: MEP
13	CONTRACTOR SHALL BE RESPONSIBLE FOR THE COMPLETE REMOVAL AND DISCARDING OF ALL DEMOLITION WASTE.	D5	CAREFULLY DEMO PORTION OF EXISTING WALL IN PREPARATION FOR NEW DOOR. RE: ARCH.	D39	EXISTING RETURN AC REGISTER AND LIGHT TO REMAIN. PROTECT DURING CONSTRUCTION. PAINT PATCH AND REPAIR AS NEEDED. RE: MEP.
14	ALL DEMO OR PENETRATIONS THROUGH THE FLOOR MUST HAVE A FLOOR PENETRATING RADAR (GPR) TEST PRIOR TO START OF ANY WORK	D6	EXISTING JUNCTION BOX BELOW COUNTER TO BE RELOCATED TO ELECTRICAL/ COMMUNICATIONS BOX.	D41	RELOCATE EXISTING LIGHT. EXTEND ALL POWER FOR LIGHT TO BE FULLY FUNCTIONAL AFTER CONSTRUCTION. CLEAN, PAINT AND REPAIR AS NEEDED. RE:MEP.
		D7	DEMO EXISTING DATA AND ELECTRICAL BELOW COUNTER PULL BACK TO SOURCE. CUT/CAP CONDUITS BELOW FLOOR. RE: ARCH. FOR FLOOR REPAIRS	D42	RELOCATE EXISTING AC SUPPLY REGISTER. EXTEND ANY DUCTWORK AS NEEDED. CLEAN, PAINT AND REPAIR AS NEEDED. RE:MEP.
		D8	DEMO EXISTING LARGE FORMAT "H" IN ITS ENTIRETY. ALL PART AND PIECES	D43	RELOCATE EXISTING FIRE SPRINKLER HEAD. EXTEND ITS LINE AS NEEDED TO ALLOW FOR ADDED SPRINKLER HEAD INSIDE NEW STORAGE ROOM. CLEAN, PAINT AND REPAIR AS NEEDED. RE:MEP.
		D9	RELOCATE EXISTING INTERACTIVE COMPUTER TABLE PER OWNER'S DIRECTIONS.		
		D10	DEMO EXISTING MILLWORK CABINET		
		D11	DEMO EXISTING BUILT IN MILLWORK BOOKSHELF		
		D12	DEMO EXISTING GLASS PARTITION		
		D13	PROTECT CEILING TILES, FURRDOWN, LIGHTS AND GRID TO REMAIN DURING PROJECT. REPAIR CEILING GRID AND NEW CEILING TILES FOR NEW CONSTRUCTION AFTER FURRDOWNS REMOVAL		
		D22	CAREFULLY DEMO EXISTING FURROUT AND CEILING FURRDOWN WITH EXISTING ALUMINUM DOOR TRACKS. ONLY DEMO TO THE EXTENT OF EXISTING EXTERIOR EDGE FURRDOWN HOLDING DOORS TO REMAIN. SEE: D37. PATCH AND REPAIR FOR NEW CONSTRUCTION		
		D27	REMOVE EXISTING CARPET AND PREPARE FLOORING FOR NEW CARPET		
		D28	EXISTING DATA/ELECTRICAL ON FLOOR TO BE EXTENDED TO NEW LOCATION UNDER NEW BUILT IN DESK. CORE FLOOR AS REQUIRED RE:ARCH. FOR REPAIRS. RE: ELECT. FOR ADDITIONAL INFORMATION		
		D29	EXISTING ELECTRICAL BOX TO REMAIN. PROTECT AND PREPARE FOR NEW FINISHES		
		D30	EXISTING JC DECAUX DISPLAY TO REMAIN. PROTECT DURING DEMO AND CONSTRUCTION		
		D31	EXISTING JC DECAUX DISPLAYS. CAREFULLY DISCONNECT DATA/ELECTRICAL AND PREP FOR RELOCATION AND REINSTALLATION RE: ARCH/ELEC/IT		
		D32	EXISTING DATA AND ELECTRICAL TO BE PULLED BACK TO COMMUNICATIONS BOX. CONDUIT REMOVE BELOW FLOOR LINE. RE: ARCH FOR PATCHING		
		D33	CAREFULLY DEMO 6" WIDE TRENCH IN TERRAZZO FLOOR FOR NEW DATA AND ELECTRICAL CONDUIT FOR RELOCATED JC DECAUX DISPLAYS		
		D36	PROVIDE AND INSTALL TEMPORARY BARRICADES AND SIGNAGE. COORDINATE WITH HAS REPRESENTATIVE. MATCH AIRPORT STANDARD TEMPORARY BARRICADE. BEFORE BARRICADE IS REMOVED THOROUGHLY CLEAN AREA AND REMOVE ALL DEBRIS, ONCE BARRICADE IS REMOVED COMPLETE FINAL CLEAN.		


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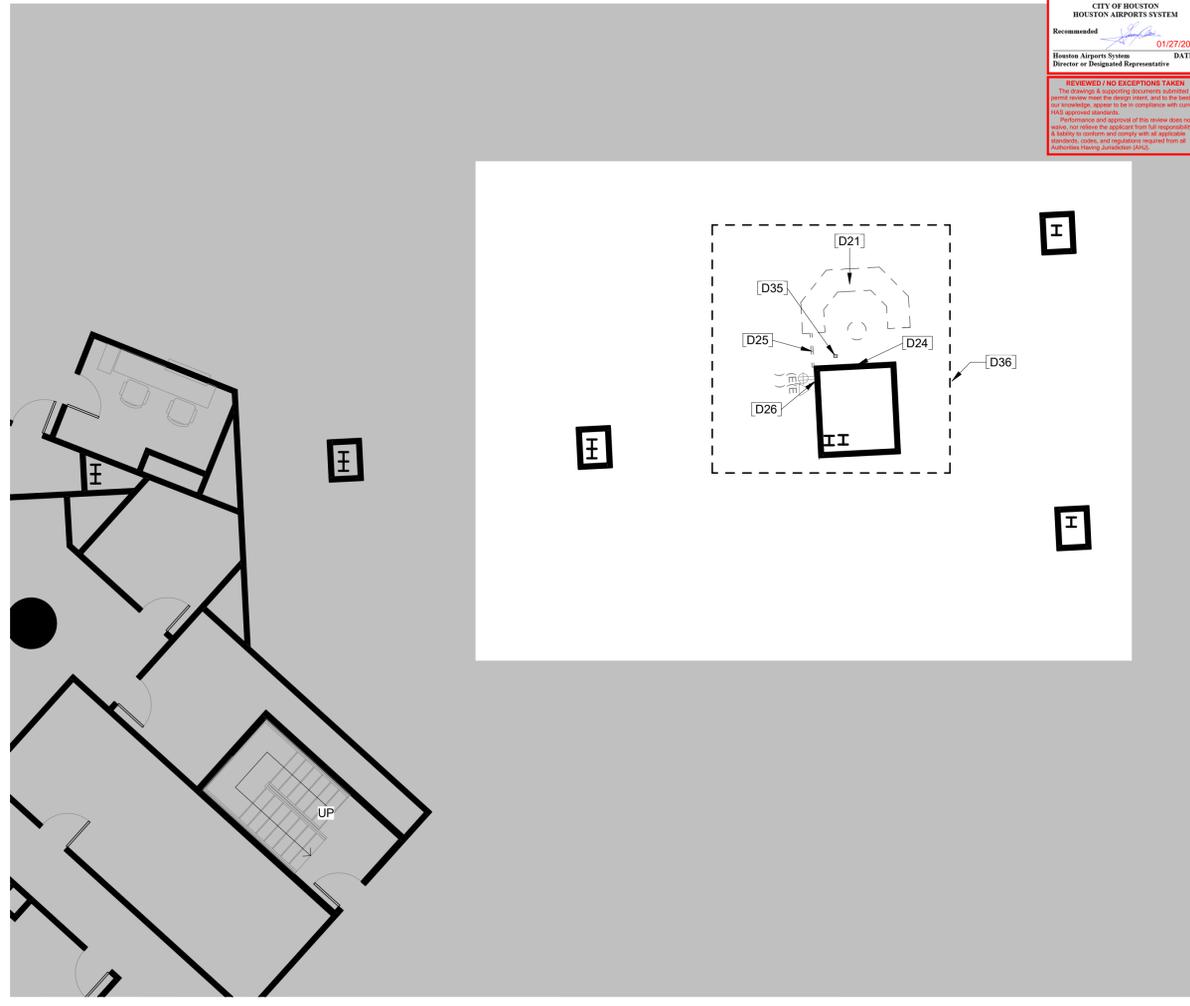
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C

D



CITY OF HOUSTON
HOUSTON AIRPORTS SYSTEM
Recommended: 01/27/2022 DATE
Houston Airports System Director or Designated Representative

REVIEWED / NO EXCEPTIONS TAKEN:
The drawings & supporting documents submitted to permit review meet the design intent, and to the best of our knowledge appear to be in compliance with current code approval standards.
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DESIGNER PROJECT No.: 20011.07
PROJECT STATUS: 100% PERMIT, BID CONSTRUCTION

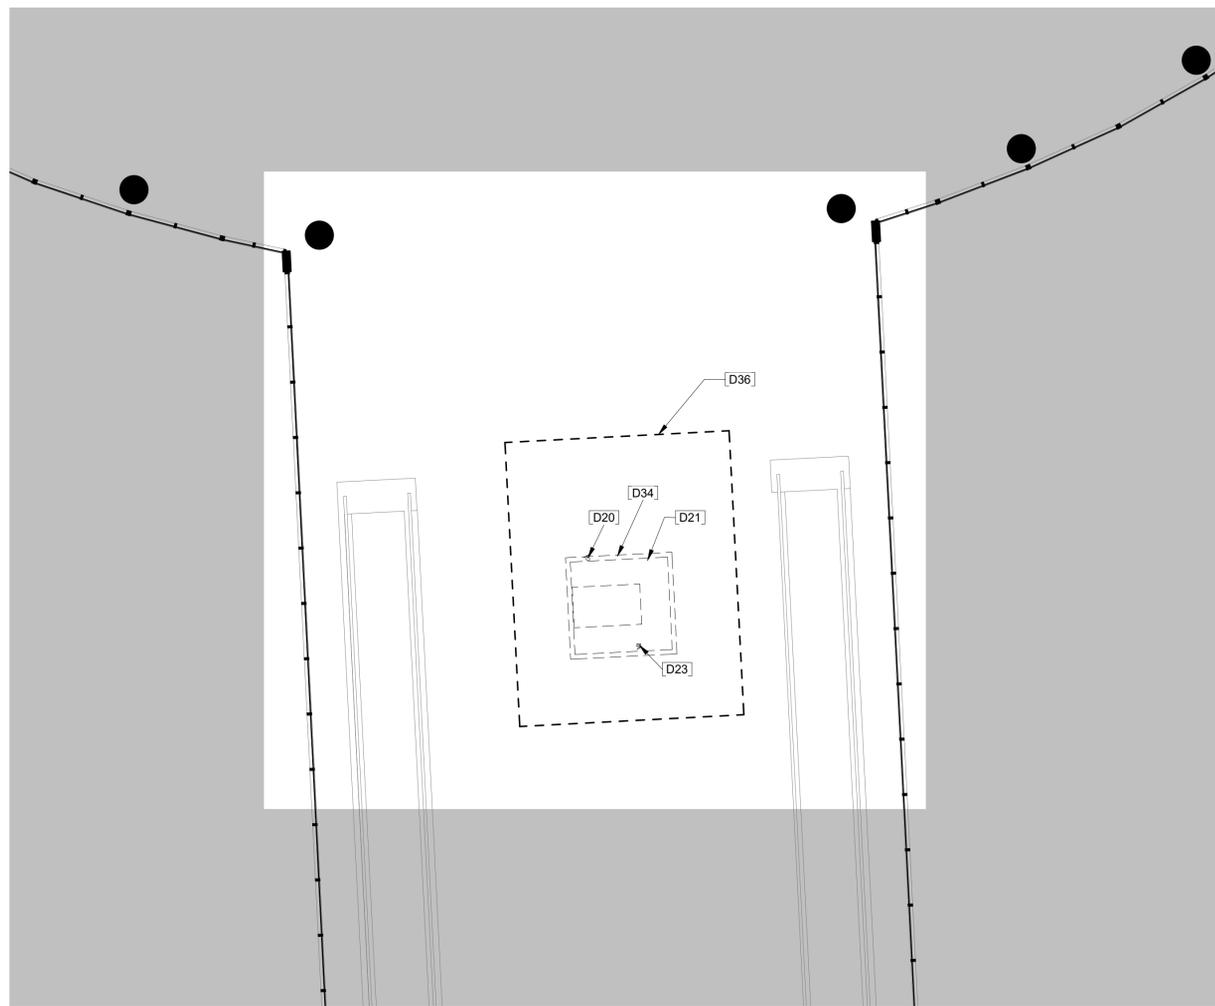REVISIONS

No.	DESCRIPTION	DATE	BY
1	SCHEMATIC DESIGN	10.23.20	
2	DESIGN DEVELOPMENT	12.04.20	
3	95% OWNER REVIEW	09.24.21	
4	100% PERMIT, BID AND CONSTRUCTION	11/08/21	

DESIGNER: Designer
DRAWN BY: RS
CHECKED BY: AM
ISSUE DATE: 11/08/2021
APPROVED BY: Approver
APPROVAL DATE:

DIRECTOR
of
HOUSTON AIRPORT SYSTEM

Review/Approval Category

Approved For Construction

PN # 941
TIP NO. # TIP-21-128-HOU
SHEET NAME: DEMOLITION PLAN - LEVEL 1 - AREA B & C
SHEET No. AD102 SCALE: As indicated
SHEET SIZE: 22"x34" ANSI-D

DEMOLITION PLAN - LEVEL 1 - AREA C SCAL 1/8" = 1'-0" **B2**

- | | |
|---|--|
| <p>11 THERMOSTATS LOCATED ON WALLS TO BE REMOVED, SHALL BE PROTECTED AND SECURED ABOVE THE CEILING AND TAGGED WITH THE ZONE NUMBER.</p> <p>12 ALL EXISTING FLOORS MOUNTED OUTLETS DESIGNATED TO BE REMOVED. CONTRACTOR SHALL FILL CORES WITH CONCRETE OR EPOXY AND FIRE SEALED AS PER CODE.</p> <p>13 CONTRACTOR SHALL BE RESPONSIBLE FOR THE COMPLETE REMOVAL AND DISCARDING OF ALL DEMOLITION WASTE.</p> <p>14 ALL DEMO OR PENETRATIONS THROUGH THE FLOOR MUST HAVE A FLOOR PENETRATING RADAR (GPR) TEST PRIOR TO START OF ANY WORK</p> | <p>1 REFER TO SHEET G0-01 INDEX FOR GENERAL NOTES, SYMBOL LEGEND AND OTHER IMPORTANT INFORMATION.</p> <p>2 FIELD VERIFY ALL EXISTING CONDITIONS AND REPORT ANY DIRCREPANCIES IN PLAN TO THE ARCHITECT/ ENGINEER BEFORE ANY WORK COMMENCES.</p> <p>3 ALL DEMOLITION SHALL BE EXECUTED NEATLY AND WITHOUT ANY DAMAGE TO REMAINING CONSTRUCTION INCLUDING ALL EXISTING EQUIPMENT AND FINISHES. CONTRACTOR SHALL BE RESPONSIBLE FOR ANY DAMAGE.</p> <p>4 ALL REMAINING PARTITIONS AND COLUMN COVERS SHALL BE PATCHED, TAPED AND FLOATED, READY TO RECEIVE PAINT OR WALL COVERING.</p> <p>5 ALL EXISTING WINDOW COVERINGS SHALL REMAIN, UNLESS NOTED OTHERWISE. PROTECT (RAISE OR REMOVE) DURING DEMOLITION/ CONSTRUCTION.</p> <p>6 CONTRACTOR SHALL PROTECT ELEVATOR CAB WALLS AND FLOOR AS DIRECTED BY BUILDING MANAGEMENT. CONTRACTOR SHALL BE RESPONSIBLE FOR ANY DAMAGE TO ELEVATOR CABS.</p> <p>7 EXISTING SECURITY SYSTEM, FIRE HOSE CABINETS, SMOKE AND FIRE ALARM DEVICES, FIRE ALARM SYSTEM, MOTION DETECTORS, SPEAKERS, STROBE LIGHTS, EXIT SIGNS AND ETC. SHALL REMAIN UNLESS NOTED OTHERWISE. CONTRACTOR SHALL PROTECT THESE DEVICES DURING DEMOLITION/ CONSTRUCTION.</p> <p>8 ALL REMOVED DOORS, FRAMES AND HARDWARE SHALL BE STORED FOR REUSE, UNLESS NOTED OTHERWISE.</p> <p>9 EXISTING CEILING GRID AND TILES SHALL REMAIN, UNLESS NOTED OTHERWISE.</p> <p>10 AT AREAS WHERE FLOOR COVER IS TO BE REMOVED, ALL EXISTING GROUT, CARPET PAD, NAILS AND REMNANTS SHALL BE REMOVED. CONTRACTOR SHALL PREPARE SLAB AS REQUIRED TO RECEIVE NEW FINISHES. EXISTING SLAB SHALL BE LEVELED AS NECESSARY THROUGHOUT THE SPACE.</p> |
|---|--|

GENERAL NOTES **B1**

DEMOLITION PLAN - LEVEL 1 - AREA B SCAL 1/8" = 1'-0" **D2**

- | | |
|---|-------------------------------------|
| <p>D20 EXISTING POKE-THRU IN FLOOR TO BE REMOVED. REMOVE ALL EXISTING DATA AND ELECTRICAL BACK TO THEIR SOURCES AND THEN REMOVE POKE-THRU PARTS AND PIECES IN PREPARATION FOR TERRAZZO INFILL. PROVIDE SAMPLE OF TERRAZZO FOR REVIEW AND ACCEPTANCE PRIOR TO PATCHING THE POKE-THRU HOLE.</p> <p>D21 CAREFULLY DEMO EXISTING KIOSK COUNTER IN PREPARATION FOR NEW KIOSK.</p> <p>D23 CORE FLOOR FOR NEW POKE-THRU TO ALIGN WITH NEW INFORMATION DESK AND VIDEO WALL. LAYOUT VIDEO WALL AND MARK EXACT CORE LOCATION. SCAN FLOOR TO ENSURE NO CONFLICTS. COORDINATE LOCATION WITH VIDEO WALL AND INFO DESK SHOP DRAWINGS. CONFIRM DESIGN INTENT LOCATION PRIOR TO CORING FLOOR.</p> <p>D24 CAREFULLY DEMO EXISTING INFORMATION WALL SIGNAGE.</p> <p>D25 DEMO POWER/DATA STRIP ANCHORED TO FLOOR</p> <p>D26 EXISTING DATA/ELECTRICAL ON EXISTING WALL. DEMO DATA BACK TO SOURCE. RE: ELECT. FOR ADDITIONAL INFORMATION</p> <p>D34 DEMO AND PATCH EXISTING FLOOR</p> <p>D35 CORE FLOOR FOR NEW POKE-THRU TO ALIGN WITH NEW INFORMATION DESK AND VIDEO WALL. LAYOUT VIDEO WALL AND MARK EXACT CORE LOCATION. SCAN FLOOR TO ENSURE NO CONFLICTS. COORDINATE LOCATION WITH VIDEO WALL AND INFO DESK SHOP DRAWINGS. CONFIRM DESIGN INTENT LOCATION PRIOR TO CORING FLOOR. RE: MEP</p> <p>D36 PROVIDE AND INSTALL TEMPORARY BARRICADES AND SIGNAGE. COORDINATE WITH HAS REPRESENTATIVE. MATCH AIRPORT STANDARD TEMPORARY BARRICADE. BEFORE BARRICADE IS REMOVED THOROUGHLY CLEAN AREA AND REMOVE ALL DEBRIS, ONCE BARRICADE IS REMOVED COMPLETE FINAL CLEAN.</p> | <p>KEYED NOTES C1</p> |
|---|-------------------------------------|

KEYED NOTES **C1**

DEMOLITION PLAN - LEVEL 1 - AREA B SCAL 1/8" = 1'-0" **D2**

- | | |
|---|--|
| <p>— EXISTING PARTITION TO REMAIN</p> <p>- - - - - EXISTING PARTITION TO BE REMOVED</p> <p>— — EXISTING DOOR TO REMAIN / NEW DOOR</p> <p>- — EXISTING DOOR TO BE DEMOLISHED</p> <p>⊕ REMOVED DUPLEX OUTLET</p> <p>⊕ REMOVED QUADRAPLEX OUTLET</p> <p>⊕ REMOVED FLOOR MOUNTED DUPLEX OUTLET</p> <p>⊕ REMOVED COMMUNICATION OUTLET</p> <p>⊕ REMOVED FLOOR MOUNTED PHONE/DATA OUTLET</p> <p>⊕ REMOVED THERMOSTAT</p> | <p>SYMBOLS LEGEND D1</p> |
|---|--|

SYMBOLS LEGEND **D1**

FILE PATH:

HAS FILE:

PLOT DATE:
DOA DWG FILE:
OLD DOA No.:

A

B

C

D

CITY OF HOUSTON
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Recommended: _____ DATE: 01/27/2022
Houston Airports System Director or Designated Representative

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DESIGNER PROJECT No.: 20011.07
PROJECT STATUS: 100% PERMIT, BID CONSTRUCTION

REVISIONS

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	DESIGN DEVELOPMENT	12.04.20	
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A	ADDENDUM A	01-11-2022	

DESIGNER: _____ Designer
DRAWN BY: _____ MD
CHECKED BY: _____ ACM
ISSUE DATE: 01/11/2022
APPROVED BY: _____ Approver
APPROVAL DATE: _____

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HOUSTON AIRPORT SYSTEM

Review Approval Category

Approved For Construction


PN # 941

TIP NO. # TIP-21-128-HOU


SHEET NAME: ARCHITECTURAL FLOOR PLAN - LEVEL 1 - AREAS B AND C

SHEET No. A102 SCALE: As indicated


SHEET SIZE: 22"x34" ANSI-D

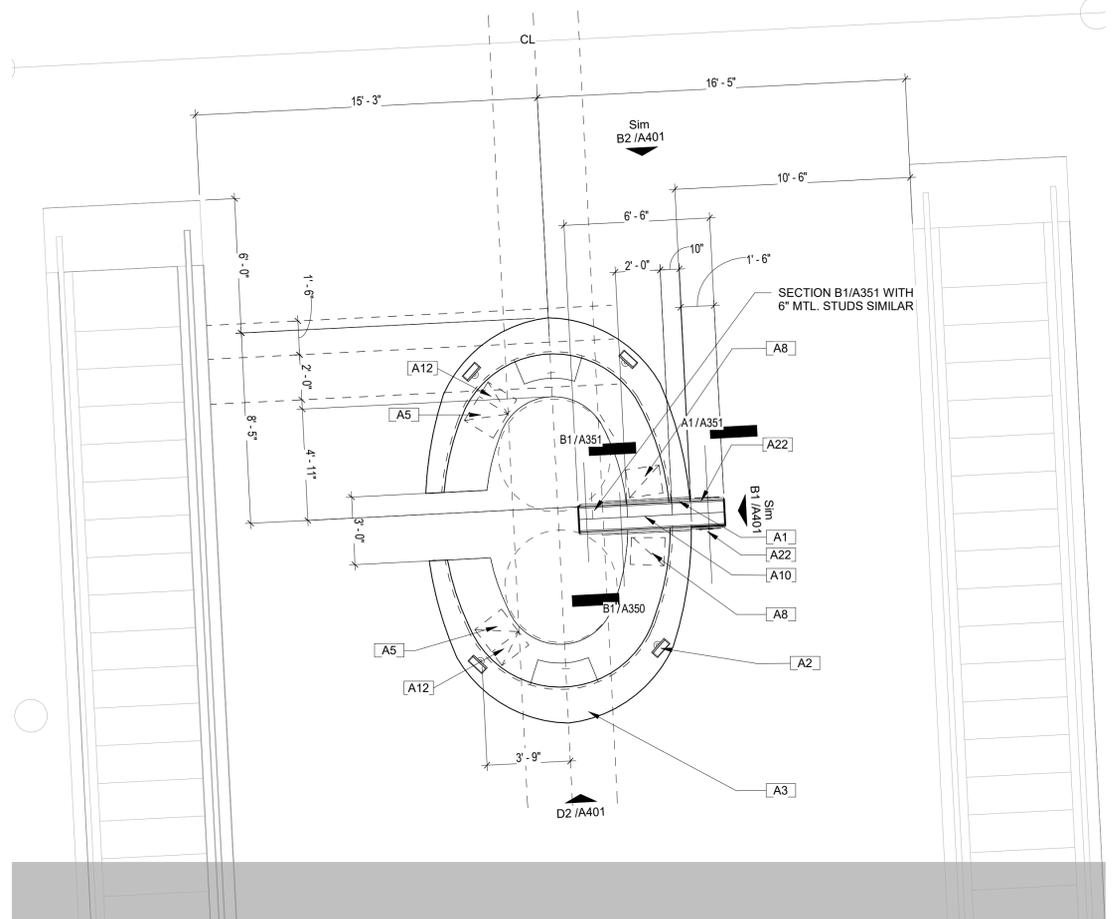

ARCHITECTURAL FLOOR PLAN - LEVEL 1 - AREA C SCAL 1/4" = 1'-0" B2

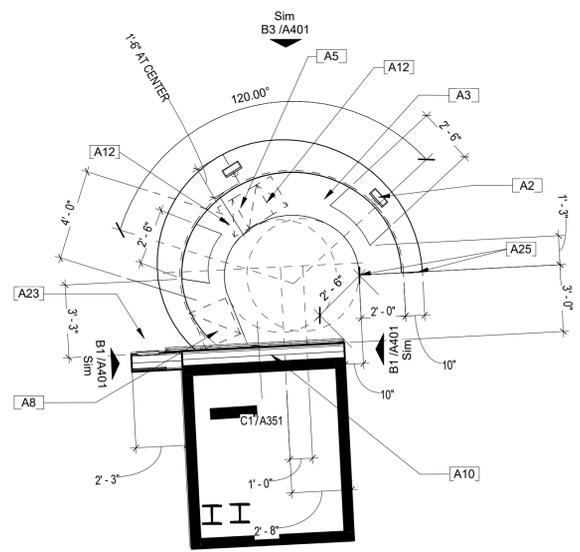

ARCHITECTURAL FLOOR PLAN - LEVEL 1 - AREA B SCAL 1/4" = 1'-0" D2

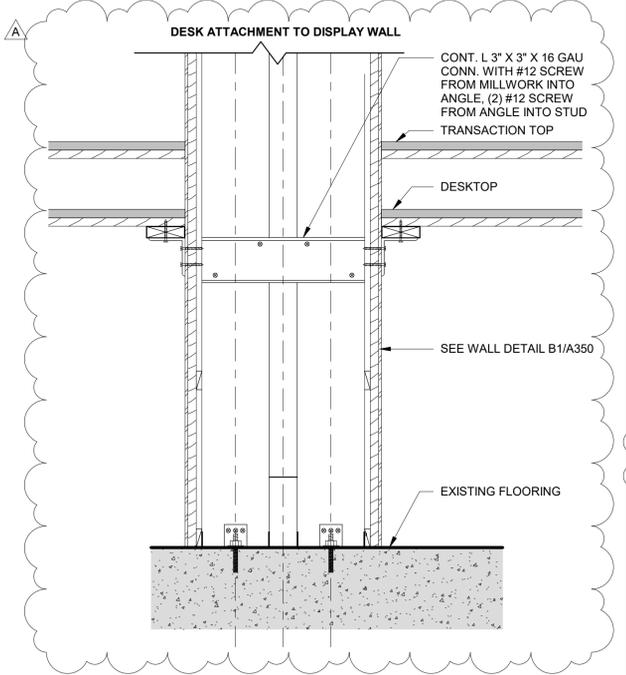

MILLWORK DESK DETAIL SCAL 1 1/2" = 1'-0" A1

- REFER TO SHEET G0-01 INDEX FOR GENERAL NOTES, SYMBOLS LEGEND AND OTHER IMPORTANT INFORMATION.
- FIELD VERIFY ALL EXISTING CONDITIONS AND REPORT ANY DISCREPANCIES IN PLAN TO THE ARCHITECT/ENGINEER BEFORE ANY WORK COMMENCES.
- ALL DOORS ARE TYPE (A) WITH HARDWARE TYPE (0), UNLESS NOTED OTHERWISE. NEW DOORS AND FRAMES SHALL BE BUILDING STANDARD UNLESS NOTED OTHERWISE. NEW FRAMES SHALL BE BUILDING STANDARD UNLESS NOTED OTHERWISE. NEW FRAMES SHALL BE FINISHED TO MATCH EXISTING FRAMES ON FLOOR.
- REFER TO G003 FOR TYPICAL MOUNTING HEIGHTS.
- ALL NEW DOOR HARDWARE SHALL BE A.D.A. AND T.A.S. COMPLIANT.
- ALL WOOD BLOCKING AND COMPONENTS WITHIN PARTITIONS AND CEILING PLENUM SHALL BE FIRE TREATED.
- "ALIGN" MEANS THAT SIMILAR COMPONENTS OF CONSTRUCTION SUCH AS WALLS, JAMBS, ETC. SHALL ALIGN ACROSS VOIDS OR ADJACENT TO EXISTING CONSTRUCTION.
- ALL PARTITIONS SHALL BE PARTITION TYPE "A" UNLESS NOTED OTHERWISE. GYPSUM BOARD ON ALL PLUMBING AND WET WALLS SHALL BE WATER RESISTANT GYPSUM BOARD.
- ALL DOORS ARE EXISTING TO REMAIN UNLESS NOTED OTHERWISE.
- PATCH CARPET, AS REQUIRED, TO MATCH EXISTING.
- IF POST-INSTALLED ANCHORS OR PENETRATIONS ARE TO BE INSTALLED/ATTACHED TO THE EXISTING FLOOR, WALL, OR CEILING, A NON-DESTRUCTIVE TEST SUCH AS GPR OR EQUIVALENT SHALL BE PERFORMED TO IDENTIFY EXISTING OBJECTS IN THEM SUCH AS UTILITIES AND/OR REINFORCEMENT BARS. ALL TEST RESULTS TO BE SUBMITTED TO ARCHITECT AND OWNER PRIOR TO ANY WORK.

GENERAL NOTES B1

- A1 NEC LCD DISPLAY VIDEO WALL. DISPLAYS PROVIDED AND INSTALLED BY CONTRACTOR. RE: ELEVATION B2/ A401 AND B2/ A402 AND A2/ T107.
- A2 SURFACE MOUNTED TABLET RE: IT AND MOUNTING ARM RE: ARCH SPECIFICATIONS. PROVIDED AND INSTALLED BY CONTRACTOR. COORDINATE INSTALLATION, POWER AND DATA REQUIREMENTS.
- A3 SOLID SURFACE COUNTER.
- A5 BUILT-IN BOX/FILE PEDESTAL DRAWER UNIT. PROVIDED AND INSTALLED BY CONTRACTOR RE: ARCH. SPECIFICATIONS AND DETAIL B1/A850.
- A8 UNDER COUNTER LOCKABLE COMPUTER CABINET. PROVIDED AND INSTALLED BY CONTRACTOR RE: ARCH. SPECIFICATIONS.
- A10 REFER TO WALL SECTIONS. RE: B1/ A350 AND C1/ A351.
- A12 UNDER CABINET CPU HOLDER. PROVIDED AND INSTALLED BY CONTRACTOR. RE: ARCH. SPECIFICATIONS AND DETAIL D1/850.
- A22 (2 SIDED) LED BACKLIT "INFORMATION" TEXT FONT "CLEARVIEW-MEDIUM" 9" HIGH LASER CUT INTO STEEL CLADDING, ACRYLIC SHEET BACKING RE:A350
- A23 (1 SIDED) LED BACKLIT "INFORMATION" TEXT FONT "CLEARVIEW-MEDIUM" 9" HIGH LASER CUT INTO STEEL CLADDING, ACRYLIC SHEET BACKING RE:A350
- A25 CORNER GUARD

NOTE:
-REFER TO SHEET AE101 FOR ADDITIONAL INFORMATION ON EQUIPMENT AND FURNITURE PROVIDED AND INSTALLED BY CONTRACTOR.

AREA "B" LOCATION TO BE UTILIZED AS MOCKUP. NO OTHER AREAS TO BE PRODUCED UNTIL THIS MOCKUP IS APPROVED.

-CONTRACTOR TO PROVIDE A FULL MOCKUP OF ALL COUNTER COMPONENTS INCLUDING BUT NOT LIMITED TO: STAINLESS STEEL ACCENT REVEAL, CORIAN SURFACE, 3FORM LIGHT DIFFUSING PANELS, LED INTEGRATED LIGHT, SOLID SURFACE COUNTERTOP. MOCKUP SIZE AND LOCATION AT CONTRACTORS DISCRETION. IF MOCKUP IS APPROVED, MOCKUP BE USED AS FINAL PRODUCT.

-CONTRACTOR TO PROVIDE A FULL MOCKUP OF ALL VIDEO WALL COMPONENTS INCLUDING BUT NOT LIMITED TO: PURE-FREEFORM METAL PANEL CLADDING, LED BACKLIT ACRYLIC SHEET, LED LIGHTS, STEEL CLADDING, AND REVEAL. MOCKUP SIZE AND LOCATION AT CONTRACTORS DISCRETION. IF MOCKUP IS APPROVED, MOCKUP BE USED AS FINAL PRODUCT.

KEYED NOTES C1

EXISTING PARTITION TO REMAIN X' - X' DIMENSION LINE

NEW PARTITION

EXISTING DOOR TO REMAIN / NEW DOOR 1/A101 INTERIOR SECTION

101 DOOR NUMBER TAG

11 PARTITION TYPE

11 WINDOW TYPE

1/A101 Ref INTERIOR ELEVATION

1/A101 Ref

SYMBOLS LEGEND D1

FILE PATH:
HAS FILE:
PLOT DATE:
DOA DWG FILE:
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A B C D


CITY OF HOUSTON
HOUSTON AIRPORTS SYSTEM
Recommended: 01/27/2022 DATE
Houston Airports System Director or Designated Representative

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Autodesk Planning Automation (APA)



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DESIGNER PROJECT No.: 20011.07
PROJECT STATUS: 100% PERMIT, BID CONSTRUCTION

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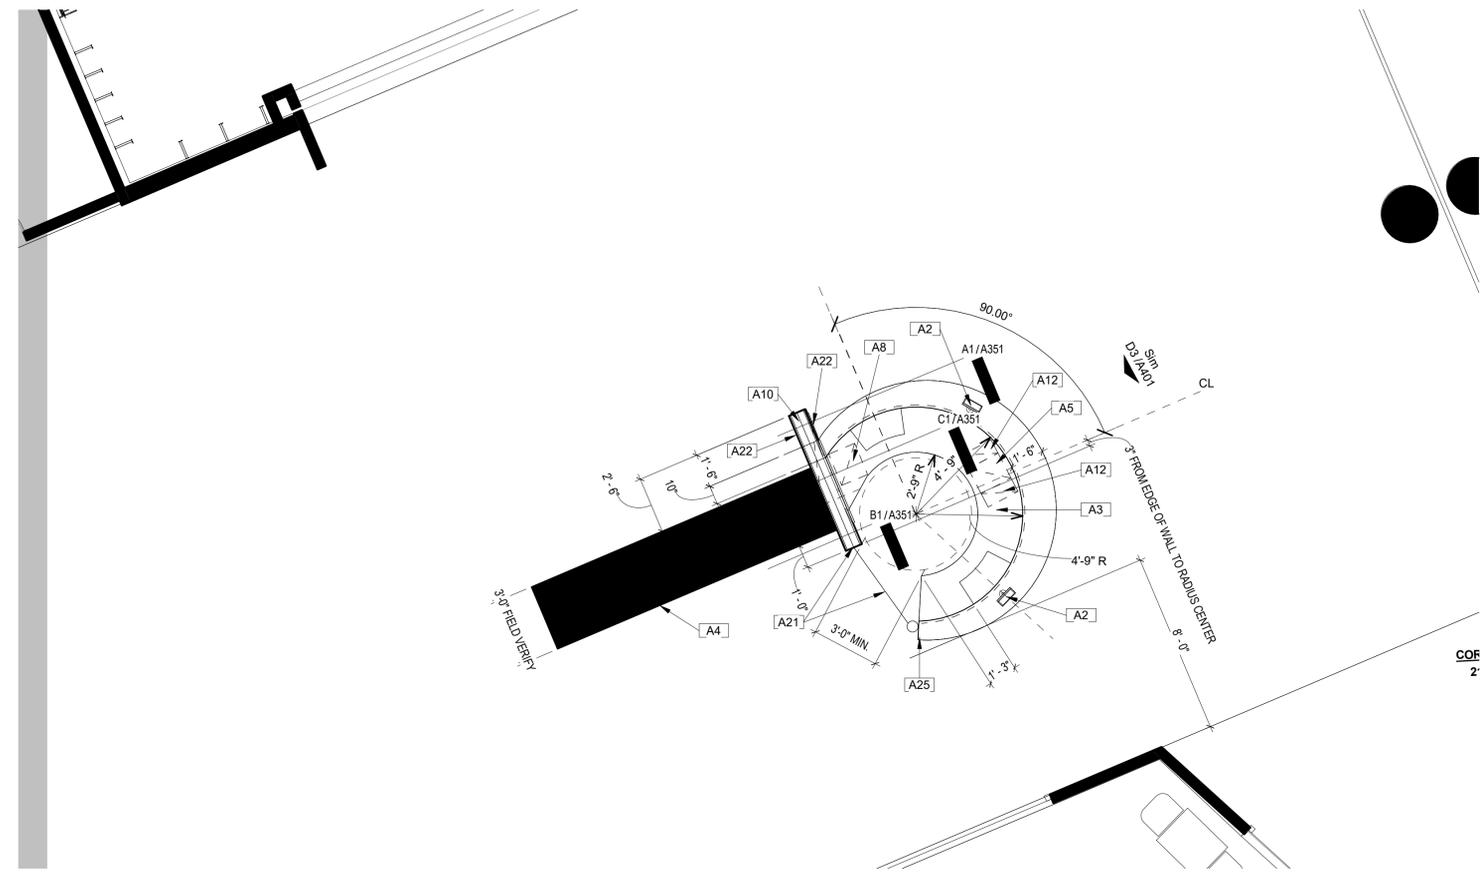
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ARCHITECTURAL FLOOR PLAN - LEVEL 1 - AREA D SCAL: 1/4" = 1'-0" **D2**

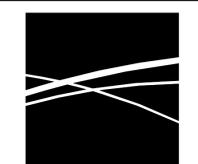- GENERAL NOTES**
- REFER TO SHEET G0-01 INDEX FOR GENERAL NOTES, SYMBOLS LEGEND AND OTHER IMPORANT INFORMATION.
 - FIELD VERIFY ALL EXISTING CONDITIONS AND REPORT ANY DISCREPANCIES IN PLAN TO THE ARCHITECT/ ENGINEER BEFORE ANY WORK COMMENCES.
 - ALL DOORS ARE TYPE (A) WITH HARDWARE TYPE (I), UNLESS NOTED OTHERWISE. NEW DOORS AND FRAMES SHALL BE BUILDING STANDARD UNLESS NOTED OTHERWISE. NEW FRAMES SHALL BE BUILDING STANDARD UNLESS NOTED OTHERWISE. NEW FRAMES SHALL BE FINISHED TO MATCH EXISTING FRAMES ON FLOOR.
 - REFER TO G003 FOR TYPICAL MOUNTING HEIGHTS.
 - ALL NEW DOOR HARDWARE SHALL BE A.D.A. AND T.A.S. COMPLIANT.
 - ALL WOOD BLOCKING AND COMPONENTS WITHIN PARTITIONS AND CEILING PLENUM SHALL BE FIRE TREATED.
 - "ALIGN" MEANS THAT SIMILAR COMPONENTS OF CONSTRUCTION SUCH AS WALLS, JAMBS, ETC. SHALL ALIGN ACROSS VOIDS OR ADJACENT TO EXISTING CONSTRUCTION.
 - ALL PARTITIONS SHALL BE PARTITION TYPE "A" UNLESS NOTED OTHERWISE. GYPSUM BOARD ON ALL PLUMBING AND WET WALLS SHALL BE WATER RESISTANT GYPSUM BOARD.
 - ALL DOORS ARE EXISTING TO REMAIN UNLESS NOTED OTHERWISE.
 - PATCH CARPET, AS REQUIRED, TO MATCH EXISTING.
 - IF POST-INSTALLED ANCHORS OR PENETRATIONS ARE TO BE INSTALLED/ATTACHED TO THE EXISTING FLOOR, WALL, OR CEILING, A NON-DESTRUCTIVE TEST SUCH AS GPR OR EQUIVALENT SHALL BE PERFORMED TO IDENTIFY EXISTING OBJECTS IN THEM SUCH AS UTILITIES AND/OR REINFORCEMENT BARS. ALL TEST RESULTS TO BE SUBMITTED TO ARCHITECT AND OWNER PRIOR TO ANY WORK.

- KEYED NOTES**
- A2 SURFACE MOUNTED TABLE RE: IT AND MOUNTING ARM RE: ARCH SPECIFICATIONS . PROVIDED AND INSTALLED BY CONTRACTOR. COORDINATE INSTALLATION, POWER AND DATA REQUIREMENTS.
- A3 SOLID SURFACE COUNTER.
- A4 EXISTING FLIGHT INFORMATION DISPLAY TO REMAIN & BE PROTECTED DURING CONSTRUCTION.
- A5 BUILT-IN BOX/FILE PEDESTAL DRAWER UNIT. PROVIDED AND INSTALLED BY CONTRACTOR RE: ARCH. SPECIFICATIONS AND DETAIL B1/A850.
- A8 UNDER COUNTER LOCKABLE COMPUTER CABINET. PROVIDED AND INSTALLED BY CONTRACTOR RE: ARCH. SPECIFICATIONS
- A10 REFER TO WALL SECTIONS. RE: B1/ A350 AND C1/ A351.
- A12 UNDER CABINET CPU HOLDER. PROVIDED AND INSTALLED BY CONTRACTOR. RE: ARCH. SPECIFICATIONS AND DETAIL D1/850.
- A21 TYPICAL VISIOTRON AIRLINES MOVABLE STANTION WITH RETRACTABLE BELT PROVIDED BY HAS. CONTRACTOR TO FIX RETRACTABLE BELT COMPONENT TO WALL WHERE INDICATED FOLLOWING MANUFACTURER'S RECOMMENDATIONS
- A22 (2 SIDED) LED BACKLIT "INFORMATION" TEXT FONT "CLEARVIEW-MEDIUM" 9" HIGH LASER CUT INTO STEEL CLADDING, ACRYLIC SHEET BACKING RE:A350
- A25 CORNER GUARD
- NOTE:
-REFER TO SHEET AE101 FOR ADDITIONAL INFORMATION ON EQUIPMENT AND FURNITURE PROVIDED AND INSTALLED BY CONTRACTOR.

SYMBOLS LEGEND

EXISTING PARTITION TO REMAIN X'-X" DIMENSION LINE

NEW PARTITION

EXISTING DOOR TO REMAIN / NEW DOOR 1/A101 INTERIOR SECTION

DOOR NUMBER TAG 101

PARTITION TYPE 1i DETAIL CALL OUT

WINDOW TYPE 1t

INTERIOR ELEVATION 1/A101 Ref

PN # 941

TIP NO. # TIP-21-128-HOU

SHEET NAME: ARCHITECTURAL FLOOR PLAN - LEVEL 1 - AREA D

SHEET No. A103 SCALE: As indicated

SHEET SIZE: 22"x34" ANSI-D

FILE PATH:
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OLD DOA No. :

CITY OF HOUSTON
HOUSTON AIRPORTS SYSTEM

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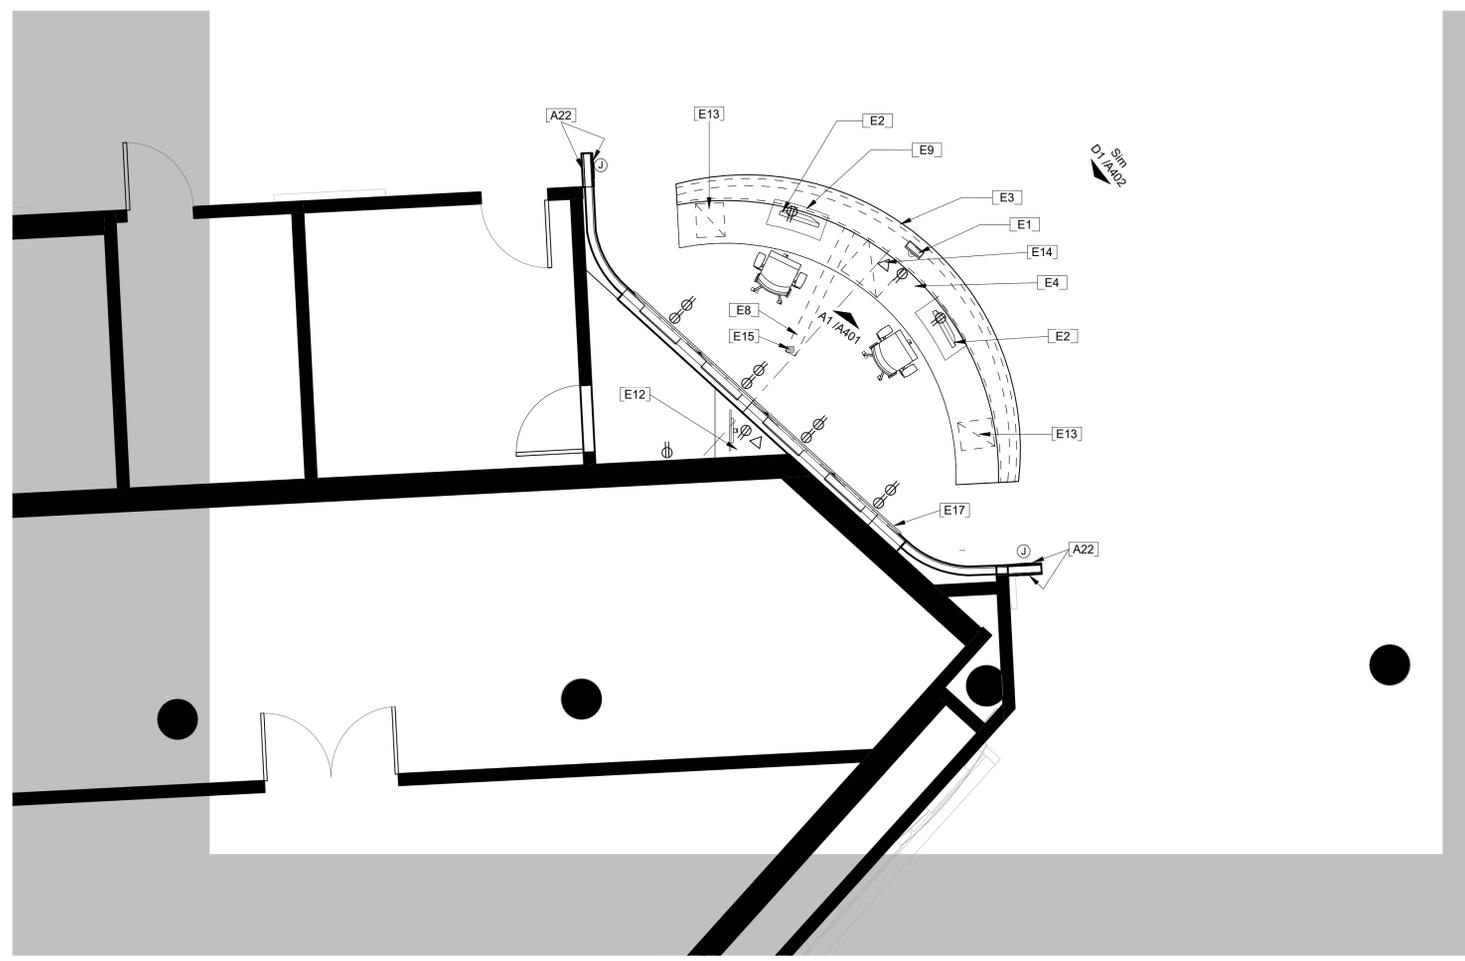
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DRAWN BY: _____ RS
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ISSUE DATE: 11/08/2021
APPROVED BY: _____ Approver
APPROVAL DATE: _____

DIRECTOR
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DATA, ELEC., EQUIPT. PLAN - BAGGAGE CLAIM - AREA A SCAL 1/4" = 1'-0" D2

- GENERAL NOTES**
- ALL ELECTRICAL OUTLETS, SWITCHES OR OTHER ELECTRICAL DEVICES SHALL BE WHITE WITH WHITE FACE PLATES. WITH THE FOLLOWING EXCEPTIONS:
ALL DEDICATED OUTLETS SHALL HAVE AN ORANGE OUTLET WITH WHITE FACE PLATE
ALL DEDICATED CIRCUITS SHALL HAVE A GREY OUTLET WITH WHITE FACE PLATE
ALL EMERGENCY POWER/UPS OUTLETS SHALL HAVE A RED OUTLET WITH A WHITE FACE PLATE.
a- ALL DEDICATED OUTLETS SHALL HAVE AN ORANGE OUTLET WITH WHITE FACE PLATE
b- ALL DEDICATED CIRCUITS SHALL HAVE A GREY OUTLET WITH WHITE FACE PLATE
c- ALL EMERGENCY POWER/UPS OUTLETS SHALL HAVE A RED OUTLET WITH A WHITE FACE PLATE.
 - ALL GANGED OUTLETS, SWITCHES OR OTHER ELECTRICAL DEVICES SHALL RECEIVE A COMMON FACE PLATE.
 - RELOCATE ALL EXISTING OUTLETS WHICH ARE NOT CURRENTLY MOUNTED AT THE SPECIFIED HEIGHT TO THE REQUIRED ADA/TAS MOUNTING HEIGHT. PATCH AND PAINT PARTITION AT ABANDONED OUTLETS.
 - CONTRACTOR SHALL PROVIDE PULL STRINGS FOR DATA AND VOICE CABLING WHERE INDICATED ON LOCATION PLAN. DATA AND VOICE CABLING, COVER PLATES AND TERMINATION SHALL BE PROVIDED BY VOICE / DATA CONTRACTOR. CONTRACTOR SHALL COORDINATE DATA AND VOICE INSTALLATIONS WITH TENANT'S REPRESENTATIVE.
 - CONTRACTOR SHALL COORDINATE INSTALLATION OF FURNITURE SYSTEM WITH THE FURNITURE SYSTEM INSTALLER. COORDINATE LOCATION OF ALL JUNCTION BOXES. ALL HARDWARE CONNECTIONS TO FURNITURE SYSTEM SHALL BE DONE BY GENERAL CONTRACTOR'S ELECTRICAL SUB-CONTRACTOR.
 - OUTLETS SHOWN ON THE ELECTRICAL AND TELEPHONE LOCATION PLAN ARE THE ARCHITECT'S UNDERSTANDING OF GENERAL PURPOSE AND SPECIFIC USE REQUIREMENTS. ADDITIONAL OUTLETS, JUNCTION BOXES OR OTHER ELECTRICAL DEVICES MAY BE SHOWN ON THE ELECTRICAL PLANS. CONTRACTOR SHALL BASE THEIR BID ON THE ARCHITECTURAL AND MEP PLANS COMBINED.
 - RE: B1/AE101 FOR TYPICAL MOUNTING HEIGHTS OF ALL ELECTRICAL TELEPHONE AND/OR DATA RECEPTACLES, THERMOSTATS AND SWITCHES UNLESS NOTED OTHERWISE.
 - ALL ELECTRICAL, TELEPHONE AND/OR DATA OUTLETS EXPOSED ABOVE COUNTERTOP HEIGHT SHALL BE MOUNTED HORIZONTALLY, UNLESS NOTED OTHERWISE.
 - CONFIRM EXACT LOCATION OF ALL CORE DRILLS (IF ANY) WITH ARCHITECT PRIOR TO PERFORMING WORK.
 - PROVIDE AND INSTALL NEW OUTLETS AND COVER PLATES AT EXISTING RECEPTACLES AS NECESSARY THROUGHOUT TO MATCH SPECIFIED COLOR. REPLACE BROKEN, DAMAGED OR DISCOLORED COVER PLATES.
 - FIRE PROOF AND SEAL AS REQUIRED BY CODE ALL NEW AND ABANDONED PENETRATIONS.
 - ALL OUTLETS NOT KEY NOTED ON THE PLAN ARE FOR GENERAL PURPOSE.
 - ANY FLOOR PENETRATION WILL NEED TO BE X-RAY SCANNED WITH A GPR REPORT TO IDENTIFY EXISTING REINFORCING BARS AND/OR UTILITIES THROUGHOUT THE EXISTING SLAB/FLOOR PRIOR TO DRILLING/CORING FOR ANY PENETRATIONS. THIS INCLUDES BUT NOT LIMITED TO FLOOR ANCHORS, CORES, ELECTRICAL POKE-THRU'S, ETC.
 - FAST CHARGE USB AT OUTLETS ON DESK TOP.
 - SALVAGE ALL OLD TECHNOLOGY AT ALL LOCATIONS. PROVIDE BACK TO HAS IT.
 - ALL VIDEO EQUIPMENT, IPADS AND DESK COMPUTERS PROVIDED AND INSTALLED BY CONTRACTOR.

- KEYED NOTES**
- A22 (2 SIDED) LED BACKLIT "INFORMATION" TEXT FONT "CLEARVIEW-MEDIUM" 9" HIGH LASER CUT INTO STEEL CLADDING, ACRYLIC SHEET BACKING RE:A350
 - E1 SURFACE MOUNTED 10.5" SCREEN TABLET AND HOLDER SPECIFIED. PROVIDED AND INSTALLED BY CONTRACTOR. COORDINATE INSTALLATION AND POWER AND DATA REQUIREMENTS.
 - E2 24" FLAT SCREEN MONITORS AND PCU BY CONTRACTOR. COORDINATE POWER AND DATA REQUIREMENTS.
 - E3 CONTINUOUS LED STRIP ACCENT LIGHTING.
 - E4 OWNER PROVIDED PHONE VOICE OVER IP TO NEAREST COMPUTER. COORDINATE WITH HAS IT.
 - E8 NEW FLOOR CORE
 - E9 PROVIDE BEHIND COUNTER CONDUIT FOR ALL ELECTRICAL AND DATA. RE: MEP AND IT DRAWINGS.
 - E12 VIDEO WALL CONTROL TOWER ON SHELF. RE: DETAIL B2/ A850.
 - E13 PROVIDE UNDER COUNTER CPU HOLDER LOCKABLE CABINET AS SPECIFIED RE:D1/A850. BASIS OF DESIGN: 3M ADJUSTABLE UNDER DESK CPU HOLDER WITH 360 DGREE SWIVEL CS200MD WITH TOP MOUNTING AND LOCKING CAPABILITY
 - E14 DATA FOR GENERAL USE COMPUTER
 - E15 EXISTING DATA/POWER BOX
 - E17 VIDEO WALL MODEL #UN552S/ SHARP NEC

- SYMBOLS LEGEND**
- (E) EXISTING FIXTURE
 - § LIGHT SWITCH
 - ◊ RECESSED WALL WASHER
 - ⊕ DUPLEX OUTLET
 - ⊕ QUADRAPLEX OUTLET
 - ⊕ JUNCTION BOX
 - ⊕ BASE FEED (WHIP)
 - UNDERCABINET FLUORESCENT LIGHTING
 - ⊕ FLOOR MOUNTED POKE-THRU DEVICE FOR POWER/DATA CABLE MANAGEMENT
 - EXISTING FLOOR MOUNTED DUPLEX OUTLET
 - ▽ DATA PULL STRING
 - ▽ TELEPHONE PULL STRING
 - ▽ TV PULL STRING
 - ⊗ FLOOR MOUNTED PHONE/DATA OUTLET
 - ⊖ THERMOSTAT
 - ⊕PP POWER POLE
 - ⊕ ELECTRIC DOOR CLOSER

PN # 941
TIP NO. # TIP-21-128-HOU

SHEET NAME: DATA, ELEC, EQUIPT. LOCATION PLAN - BAGGAGE CLAIM - AREA A

SHEET No. AE101 SCALE: As indicated
SHEET SIZE: 22"x34" ANSI-D

FILE PATH:
HAS FILE:
PLOT DATE:
DOA DWG FILE:
OLD DOA No. :

A

B

C

D

CITY OF HOUSTON
HOUSTON AIRPORTS SYSTEM

Recommended: _____ DATE: 01/27/2022
Houston Airports System Director or Designated Representative

REVIEWED / NO EXCEPTIONS TAKEN
The drawings & supporting documents submitted to permit review meet the design intent, and to the best of our knowledge, appear to be in compliance with current code approval standards.
Performance and approval of this review does not constitute an endorsement of the design or the quality of the work. Our review is limited to the design and does not include, but is not limited to, the following:
- Structural, geotechnical, and foundation requirements
- Fire, life, and safety requirements
- Environmental and other requirements
- Other applicable laws, rules, and regulations
- Authority Having Jurisdiction (AHJ)



7800 AIRPORT BLVD
HOUSTON, TEXAS 77061

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C.O.H. No.	D.O.A No.



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DESIGNER PROJECT No.: 20011.07

PROJECT STATUS: 100% PERMIT, BID CONSTRUCTION

REVISIONS

No.	DESCRIPTION	DATE	BY
1	SCHEMATIC DESIGN	10.23.20	
2	DESIGN DEVELOPMENT	12.04.20	
3	95% OWNER REVIEW	09.24.21	
4	100% PERMIT, BID AND CONSTRUCTION	11/08/21	

DESIGNER: _____ Designer

DRAWN BY: _____ RS

CHECKED BY: _____ ACM

ISSUE DATE: 11/08/2021

APPROVED BY: _____ Approver

APPROVAL DATE:

**DIRECTOR
of
HOUSTON AIRPORT SYSTEM**

Review/Approval Category

Approved For Construction


PN # 941

TIP NO. # TIP-21-128-HOU


SHEET NAME: DATA, ELEC, EQUIPT. LOCATION PLAN - LEVEL 1 - AREAS B AND C

SHEET No. AE102 SCALE: As indicated

SHEET SIZE: 22"x34" ANSI-D

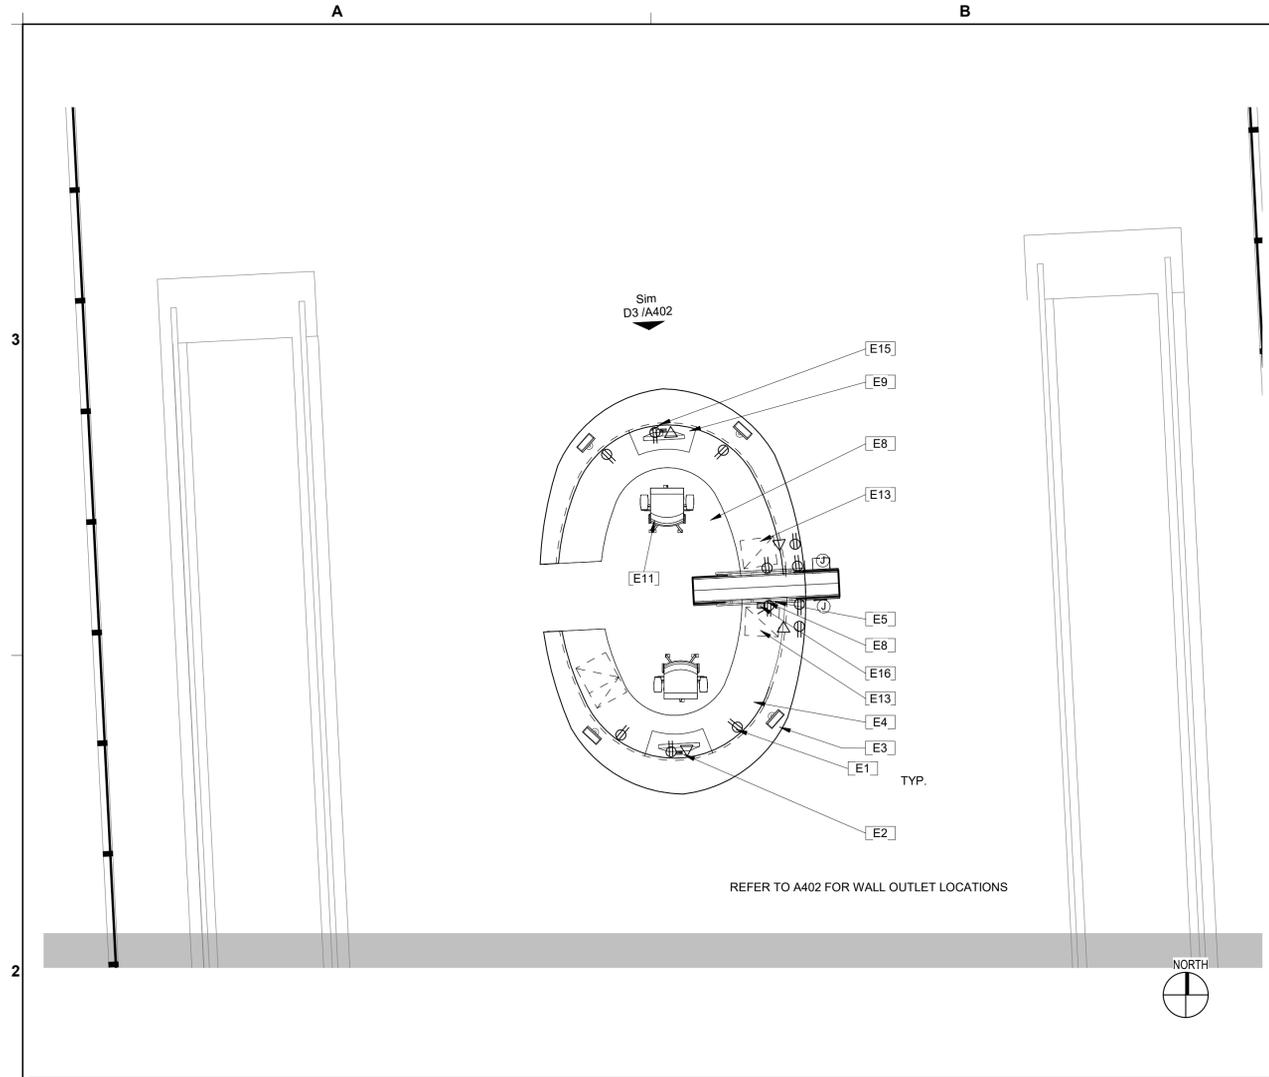


DATA, ELEC., EQUIPT. PLAN - LEVEL 1 - AREA C SCAL 1/4" = 1'-0" B2

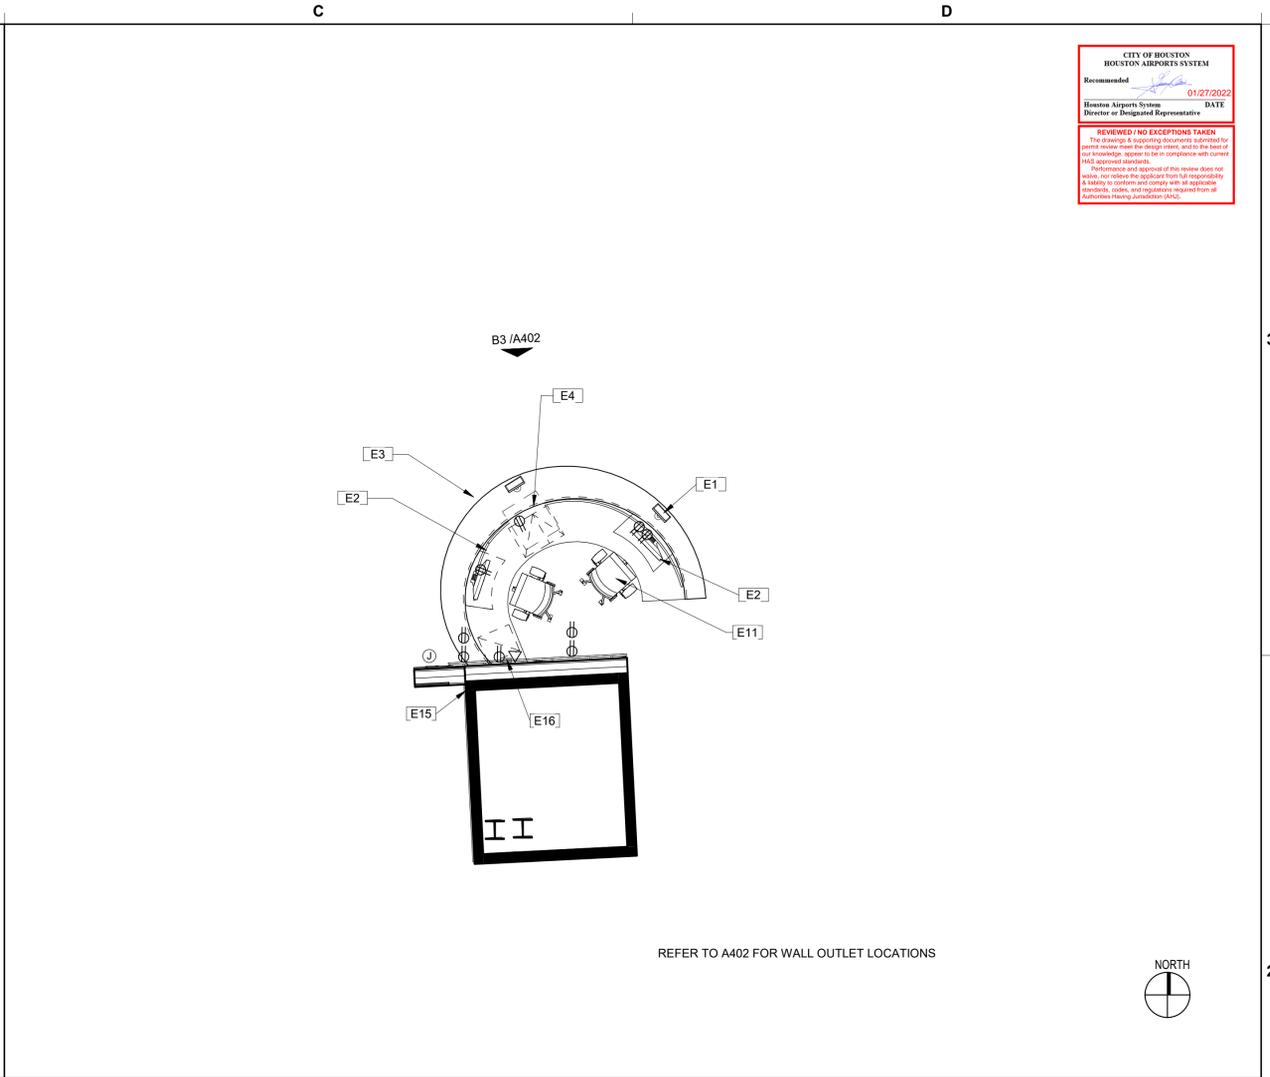

ARCHITECTURAL FLOOR PLAN - LEVEL 1 - AREA B SCAL 1/4" = 1'-0" D2

- ALL ELECTRICAL OUTLETS, SWITCHES OR OTHER ELECTRICAL DEVICES SHALL BE WHITE WITH WHITE FACE PLATES. WITH THE FOLLOWING EXCEPTIONS:
ALL DEDICATED OUTLETS SHALL HAVE AN ORANGE OUTLET WITH WHITE FACE PLATE
ALL DEDICATED CIRCUITS SHALL HAVE A GREY OUTLET WITH WHITE FACE PLATE
ALL EMERGENCY POWER/UPS OUTLETS SHALL HAVE A RED OUTLET WITH A WHITE FACE PLATE.
a- ALL DEDICATED OUTLETS SHALL HAVE AN ORANGE OUTLET WITH WHITE FACE PLATE
b- ALL DEDICATED CIRCUITS SHALL HAVE A GREY OUTLET WITH WHITE FACE PLATE
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- ALL GANGED OUTLETS, SWITCHES OR OTHER ELECTRICAL DEVICES SHALL RECEIVE A COMMON FACE PLATE.
- RELOCATE ALL EXISTING OUTLETS WHICH ARE NOT CURRENTLY MOUNTED AT THE SPECIFIED HEIGHT TO THE REQUIRED ADA/TAS MOUNTING HEIGHT. PATCH AND PAINT PARTITION AT ABANDONED OUTLETS.
- CONTRACTOR SHALL PROVIDE PULL STRINGS FOR DATA AND VOICE CABLING WHERE INDICATED ON LOCATION PLAN. DATA AND VOICE CABLING, COVER PLATES AND TERMINATION SHALL BE PROVIDED BY VOICE/ DATA CONTRACTOR. CONTRACTOR SHALL COORDINATE DATA AND VOICE INSTALLATIONS WITH TENANT'S REPRESENTATIVE.
- CONTRACTOR SHALL COORDINATE INSTALLATION OF FURNITURE SYSTEM WITH THE FURNITURE SYSTEM INSTALLER. COORDINATE LOCATION OF ALL JUNCTION BOXES. ALL HARDWIRE CONNECTIONS TO FURNITURE SYSTEM SHALL BE DONE BY GENERAL CONTRACTOR'S ELECTRICAL SUB-CONTRACTOR.
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- RE: B1/AE101 FOR TYPICAL MOUNTING HEIGHTS OF ALL ELECTRICAL TELEPHONE AND/OR DATA RECEPTACLES, THERMOSTATS AND SWITCHES UNLESS NOTED OTHERWISE.
- ALL ELECTRICAL, TELEPHONE AND/OR DATA OUTLETS EXPOSED ABOVE COUNTERTOP HEIGHT SHALL BE MOUNTED HORIZONTALLY, UNLESS NOTED OTHERWISE.
- CONFIRM EXACT LOCATION OF ALL CORE DRILLS (IF ANY) WITH ARCHITECT PRIOR TO PERFORMING WORK.
- PROVIDE AND INSTALL NEW OUTLETS AND COVER PLATES AT EXISTING RECEPTACLES AS NECESSARY THROUGHOUT TO MATCH SPECIFIED COLOR. REPLACE BROKEN, DAMAGED OR DISCOLORED COVER PLATES.
- FIRE PROOF AND SEAL AS REQUIRED BY CODE ALL NEW AND ABANDONED PENETRATIONS.
- ALL OUTLETS NOT KEY NOTED ON THE PLAN ARE FOR GENERAL PURPOSE.
- ANY FLOOR PENETRATION WILL NEED TO BE X-RAY SCANNED WITH A GPR REPORT TO IDENTIFY EXISTING REINFORCING BARS AND/OR UTILITIES THROUGHOUT THE EXISTING SLAB/FLOOR PRIOR TO DRILLING/CORING FOR ANY PENETRATIONS, THIS INCLUDES BUT NOT LIMITED TO FLOOR ANCHORS, CORES, ELECTRICAL POKE-THRU, ETC.
- FAST CHARGE USB AT OUTLETS ON DESK TOP.
- SALVAGE ALL OLD TECHNOLOGY AT ALL LOCATIONS. PROVIDE BACK TO HAS IT.
- ALL VIDEO EQUIPMENT, IPADS AND DESK COMPUTERS PROVIDED AND INSTALLED BY CONTRACTOR.

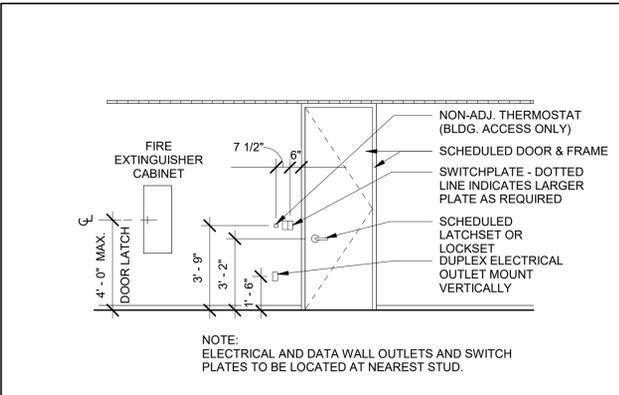

TYPICAL MOUNTING HEIGHTS SCAL 1/4" = 1'-0" B1

- E1 SURFACE MOUNTED 10.5" SCREEN TABLET AND HOLDER SPECIFIED. PROVIDED AND INSTALLED BY CONTRACTOR. COORDINATE INSTALLATION AND POWER AND DATA REQUIREMENTS.
- E2 24" FLAT SCREEN MONITORS AND PCU BY CONTRACTOR. COORDINATE POWER AND DATA REQUIREMENTS.
- E3 CONTINUOUS LED STRIP ACCENT LIGHTING.
- E4 OWNER PROVIDED PHONE VOICE OVER IP TO NEAREST COMPUTER. COORDINATE WITH HAS IT.
- E5 BASIS-OF-DESIGN: NEC VIDEO WALL.
- E8 NEW FLOOR CORE
- E9 PROVIDE BEHIND COUNTER CONDUIT FOR ALL ELECTRICAL AND DATA. RE: MEP AND IT DRAWINGS.
- E11 CONTRACTOR PROVIDED DESK CHAIRS. COORDINATE WITH ARCHITECT AND OWNER REQUIREMENT STANDARDS AND SELECTIONS
- E13 PROVIDE UNDER COUNTER CPU HOLDER LOCKABLE CABINET AS SPECIFIED RE-D1/A850. BASIS OF DESIGN: 3M ADJUSTABLE UNDER DESK CPU HOLDER WITH 360 DGREE SWIVEL CS200MD WITH TOP MOUNTING AND LOCKING CAPABILITY
- E15 EXISTING DATA/POWER BOX
- E16 NEW DATA/POWER BOX

- (E) EXISTING FIXTURE
- § LIGHT SWITCH
- ◊ RECESSED WALL WASHER
- ⊕ DUPLEX OUTLET
- ⊕ QUADRAPLEX OUTLET
- ⊕ JUNCTION BOX
- ⊕ BASE FEED (WHIP)
- UNDERCABINET FLUORESCENT LIGHTING
- ⊕ FLOOR MOUNTED POKE-THRU DEVICE FOR POWER/DATA CABLE MANAGEMENT
- EXISTING FLOOR MOUNTED DUPLEX OUTLET
- ▽ DATA PULL STRING
- ▽ TELEPHONE PULL STRING
- ▽ TV PULL STRING
- ⊕ FLOOR MOUNTED PHONE/DATA OUTLET
- ⊕ THERMOSTAT
- ⊕ POWER POLE
- ⊕ ELECTRIC DOOR CLOSER

KEYED NOTES C1

SYMBOLS LEGEND D1

FILE PATH:

HAS FILE:

PLOT DATE:
DOA DWG FILE:
OLD DOA No. :

A

B

C

D

CITY OF HOUSTON
HOUSTON AIRPORTS SYSTEM

Recommended: *[Signature]* DATE: 01/27/2022
Houston Airports System Director or Designated Representative

REVIEWED / NO EXCEPTIONS TAKEN
The drawings & supporting documents submitted to permit review meet the design intent, and to the best of our knowledge, appear to be in compliance with current code, applicable standards, and applicable regulatory requirements. Our review and approval of this review does not constitute a warranty, and we assume no liability for any errors, omissions, or omissions that may occur. Authority Having Jurisdiction (AHJ).



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DESIGNER PROJECT No.: 20011.07
PROJECT STATUS: 100% PERMIT, BID CONSTRUCTION

REVISIONS


No.	DESCRIPTION	DATE	BY
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2	DESIGN DEVELOPMENT	12.04.20	
3	95% OWNER REVIEW	09.24.21	
4	100% PERMIT, BID AND CONSTRUCTION	11/08/21	

DESIGNER:	Designer
DRAWN BY:	RS
CHECKED BY:	ACM
ISSUE DATE:	11/08/2021
APPROVED BY:	Approver
APPROVAL DATE:	

DIRECTOR
of
HOUSTON AIRPORT SYSTEM

Review/ Approval Category

Approved For Construction

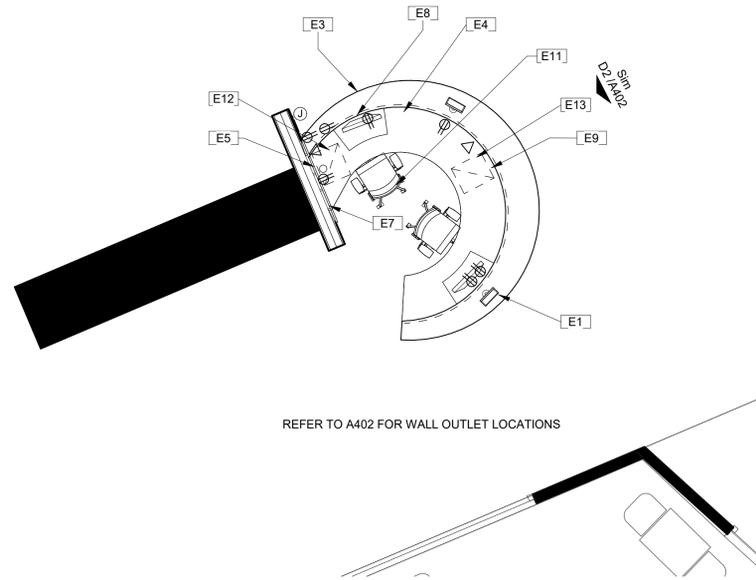

REFER TO A402 FOR WALL OUTLET LOCATIONS

ARCHITECTURAL FLOOR PLAN - LEVEL 1 - AREA D SCAL 1/4" = 1'-0"

D2

- | | | | |
|----|---|----|--|
| 1 | ALL ELECTRICAL OUTLETS, SWITCHES OR OTHER ELECTRICAL DEVICES SHALL BE WHITE WITH WHITE FACE PLATES, WITH THE FOLLOWING EXCEPTIONS:
ALL DEDICATED OUTLETS SHALL HAVE AN ORANGE OUTLET WITH WHITE FACE PLATE
ALL DEDICATED CIRCUITS SHALL HAVE A GREY OUTLET WITH WHITE FACE PLATE
ALL EMERGENCY POWER/UPS OUTLETS SHALL HAVE A RED OUTLET WITH A WHITE FACE PLATE.
a- ALL DEDICATED OUTLETS SHALL HAVE AN ORANGE OUTLET WITH WHITE FACE PLATE
b- ALL DEDICATED CIRCUITS SHALL HAVE A GREY OUTLET WITH WHITE FACE PLATE
c- ALL EMERGENCY POWER/UPS OUTLETS SHALL HAVE A RED OUTLET WITH A WHITE FACE PLATE. | 11 | FIRE PROOF AND SEAL AS REQUIRED BY CODE ALL NEW AND ABANDONED PENETRATIONS. |
| 2 | ALL GANGED OUTLETS, SWITCHES OR OTHER ELECTRICAL DEVICES SHALL RECEIVE A COMMON FACE PLATE. | 12 | ALL OUTLETS NOT KEY NOTED ON THE PLAN ARE FOR GENERAL PURPOSE. |
| 3 | RELOCATE ALL EXISTING OUTLETS WHICH ARE NOT CURRENTLY MOUNTED AT THE SPECIFIED HEIGHT TO THE REQUIRED ADA/TAS MOUNTING HEIGHT. PATCH AND PAINT PARTITION AT ABANDONED OUTLETS. | 13 | ANY FLOOR PENETRATION WILL NEED TO BE X-RAY SCANNED WITH A GPR REPORT TO IDENTIFY EXISTING REINFORCING BARS AND/OR UTILITIES THROUGHOUT THE EXISTING SLAB/FLOOR PRIOR TO DRILLING/CORING FOR ANY PENETRATIONS. THIS INCLUDES BUT NOT LIMITED TO FLOOR ANCHORS, CORES, ELECTRICAL POKE-THRU, ETC. |
| 4 | CONTRACTOR SHALL PROVIDE PULL STRINGS FOR DATA AND VOICE CABLING WHERE INDICATED ON LOCATION PLAN. DATA AND VOICE CABLING, COVER PLATES AND TERMINATION SHALL BE PROVIDED BY VOICE / DATA CONTRACTOR. CONTRACTOR SHALL COORDINATE DATA AND VOICE INSTALLATIONS WITH TENANT'S REPRESENTATIVE. | 14 | FAST CHARGE USB AT OUTLETS ON DESK TOP. |
| 5 | CONTRACTOR SHALL COORDINATE INSTALLATION OF FURNITURE SYSTEM WITH THE FURNITURE SYSTEM INSTALLER. COORDINATE LOCATION OF ALL JUNCTION BOXES. ALL HARDWIRE CONNECTIONS TO FURNITURE SYSTEM SHALL BE DONE BY GENERAL CONTRACTOR'S ELECTRICAL SUB-CONTRACTOR. | 15 | SALVAGE ALL OLD TECHNOLOGY AT ALL LOCATIONS. PROVIDE BACK TO HAS IT. |
| 6 | OUTLETS SHOWN ON THE ELECTRICAL AND TELEPHONE LOCATION PLAN ARE THE ARCHITECT'S UNDERSTANDING OF GENERAL PURPOSE AND SPECIFIC USE REQUIREMENTS. ADDITIONAL OUTLETS, JUNCTION BOXES OR OTHER ELECTRICAL DEVICES MAY BE SHOWN ON THE ELECTRICAL PLANS. CONTRACTOR SHALL BASE THEIR BID ON THE ARCHITECTURAL AND MEP PLANS COMBINED. | 16 | ALL VIDEO EQUIPMENT, IPADS AND DESK COMPUTERS PROVIDED AND INSTALLED BY CONTRACTOR. |
| 7 | RE: B1/AE101 FOR TYPICAL MOUNTING HEIGHTS OF ALL ELECTRICAL TELEPHONE AND/OR DATA RECEPTACLES, THERMOSTATS AND SWITCHES UNLESS NOTED OTHERWISE. | | |
| 8 | ALL ELECTRICAL, TELEPHONE AND/OR DATA OUTLETS EXPOSED ABOVE COUNTERTOP HEIGHT SHALL BE MOUNTED HORIZONTALLY, UNLESS NOTED OTHERWISE. | | |
| 9 | CONFIRM EXACT LOCATION OF ALL CORE DRILLS (IF ANY) WITH ARCHITECT PRIOR TO PERFORMING WORK. | | |
| 10 | PROVIDE AND INSTALL NEW OUTLETS AND COVER PLATES AT EXISTING RECEPTACLES AS NECESSARY THROUGHOUT TO MATCH SPECIFIED COLOR. REPLACE BROKEN, DAMAGED OR DISCOLORED COVER PLATES. | | |

- | | |
|-----|--|
| E1 | SURFACE MOUNTED 10.5" SCREEN TABLET AND HOLDER SPECIFIED. PROVIDED AND INSTALLED BY CONTRACTOR. COORDINATE INSTALLATION AND POWER AND DATA REQUIREMENTS. |
| E3 | CONTINUOUS LED STRIP ACCENT LIGHTING. |
| E4 | OWNER PROVIDED PHONE VOICE OVER IP TO NEAREST COMPUTER. COORDINATE WITH HAS IT. |
| E5 | BASIS-OF-DESIGN: NEC VIDEO WALL. |
| E7 | PROVIDE DATA FOR DISPLAY WALL. |
| E8 | NEW FLOOR CORE |
| E9 | PROVIDE BEHIND COUNTER CONDUIT FOR ALL ELECTRICAL AND DATA. RE: MEP AND IT DRAWINGS |
| E11 | CONTRACTOR PROVIDED DESK CHAIRS. COORDINATE WITH ARCHITECT AND OWNER REQUIREMENT STANDARDS AND SELECTIONS |
| E12 | VIDEO WALL CONTROL TOWER ON SHELF. RE: DETAIL B2/ A850. |
| E13 | PROVIDE UNDER COUNTER CPU HOLDER LOCKABLE CABINET AS SPECIFIED RE-D1/A850. BASIS OF DESIGN: 3M ADJUSTABLE UNDER DESK CPU HOLDER WITH 360 DGREE SWIVEL CS200MD WITH TOP MOUNTING AND LOCKING CAPABILITY |

- | | | | |
|-----|--|-----|---------------------------------|
| (E) | EXISTING FIXTURE | ▽ | DATA PULL STRING |
| § | LIGHT SWITCH | ▽T | TELEPHONE PULL STRING |
| ○ | RECESSED WALL WASHER | ▽T | TV PULL STRING |
| ⊕ | DUPLEX OUTLET | ⊗ | FLOOR MOUNTED PHONE/DATA OUTLET |
| ⊕ | QUADRAPLEX OUTLET | ⊖ | THERMOSTAT |
| ⊕ | JUNCTION BOX | ⊕PP | POWER POLE |
| ⊕ | BASE FEED (WHIP) | ⊖ | ELECTRIC DOOR CLOSER |
| --- | UNDERCABINET FLUORESCENT LIGHTING | | |
| ⊕ | FLOOR MOUNTED POKE-THRU DEVICE FOR POWER/DATA CABLE MANAGEMENT | | |
| ● | EXISTING FLOOR MOUNTED DUPLEX OUTLET | | |

GENERAL NOTES

B1

KEYED NOTES

C1

SYMBOLS LEGEND

D1

PN # 941

TIP NO. # TIP-21-128-HOU

SHEET NAME: DATA, ELEC, EQUIPT. LOCATION PLAN - LEVEL 1 - AREA D

SHEET No. AE103 SCALE: As indicated

SHEET SIZE: 22"x34" ANSI-D

FILE PATH:

HAS FILE:

PLOT DATE:
DOA DWG FILE:
OLD DOA No. :

A

B

C

D

NOTE:
ALL PLYWOOD, SHEATHING,
BACKING AND BLOCKING UTILIZED IN
THE MILLWORK TO BE FIRE
RETARDANT TREATED AND LABELED.
CONTRACTOR TO COORDINATE
VISIBLE LABEL REVIEW FOR
INSPECTIONS.

NOTE:
ALL PLYWOOD, SHEATHING,
BACKING AND BLOCKING UTILIZED IN
THE MILLWORK TO BE FIRE
RETARDANT TREATED AND LABELED.
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NOTE:
ALL PLYWOOD, SHEATHING,
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CONTRACTOR TO COORDINATE
VISIBLE LABEL REVIEW FOR
INSPECTIONS.

CITY OF HOUSTON
HOUSTON AIRPORTS SYSTEM
Recommended
Houston Airports System
Director or Designated Representative
01/27/2022
DATE



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C.O.H. No. D.O.A No.



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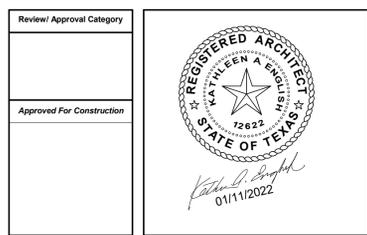
DESIGNER PROJECT No.: 20011.07
PROJECT STATUS: 100% PERMIT, BID CONSTRUCTION

REVISIONS

No.	DESCRIPTION	DATE	BY
	SCHEMATIC DESIGN	10.23.20	
	DESIGN DEVELOPMENT	12.04.20	
	95% OWNER REVIEW	09.24.21	
	100% PERMIT, BID AND CONSTRUCTION	11/08/21	
A	ADDENDUM A	01-11-2022	

DESIGNER: Designer
DRAWN BY: Author
CHECKED BY: Checker
ISSUE DATE: 01/11/2022
APPROVED BY: Approver
APPROVAL DATE:





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PN # 941
TIP NO. # TIP-21-128-HOU

SHEET NAME: WALL SECTIONS

SHEET No. A351 SCALE: 1 1/2" = 1'-0"
SHEET SIZE: 22"x34" ANSI-D



FILE PATH:

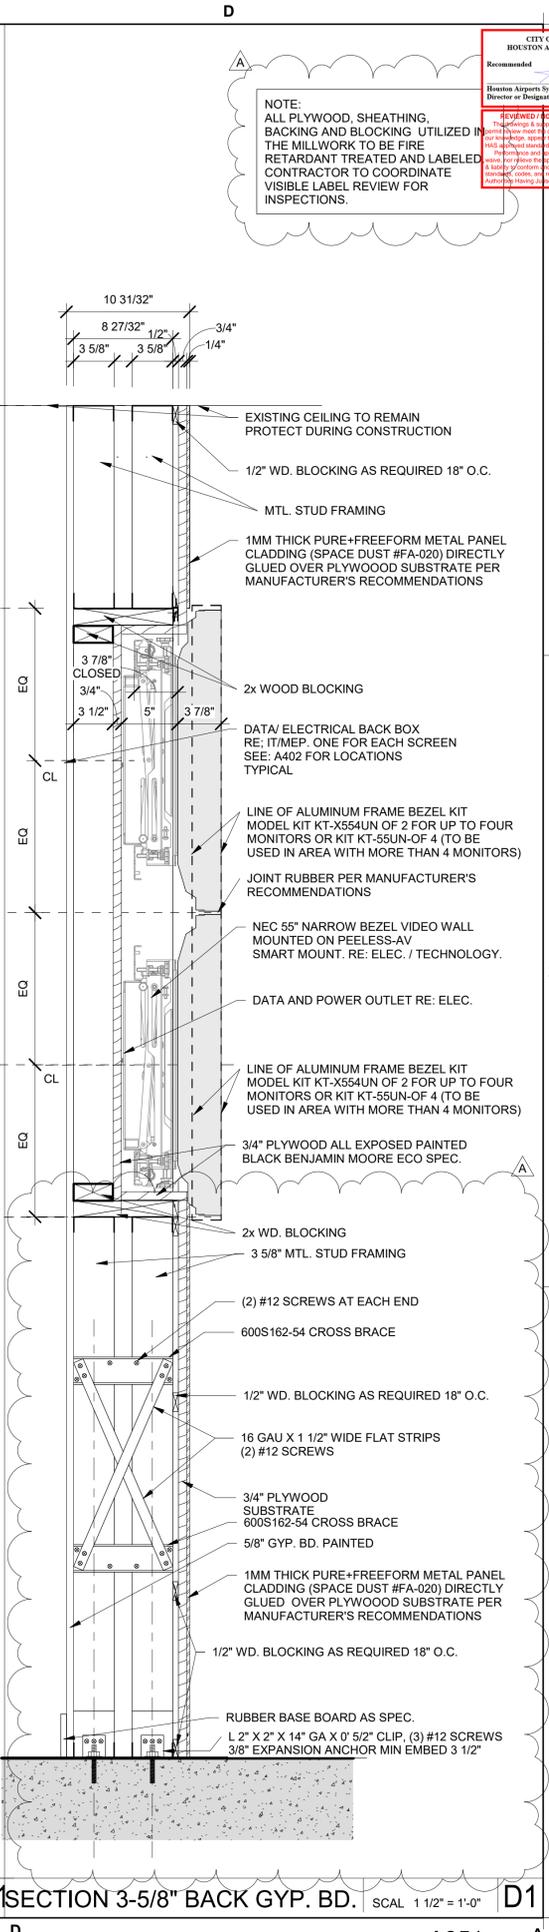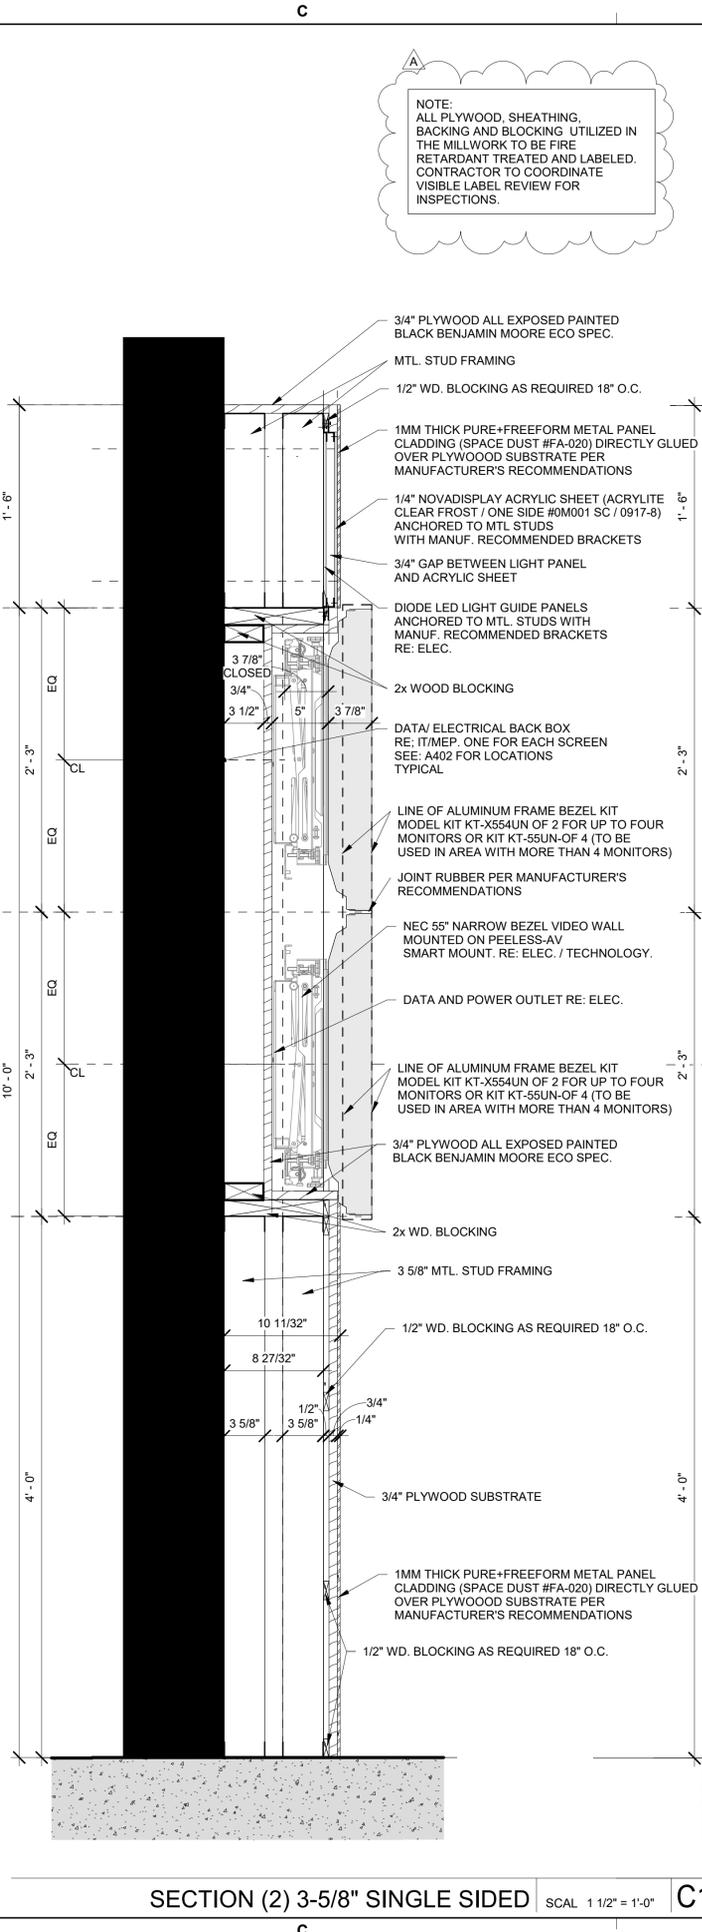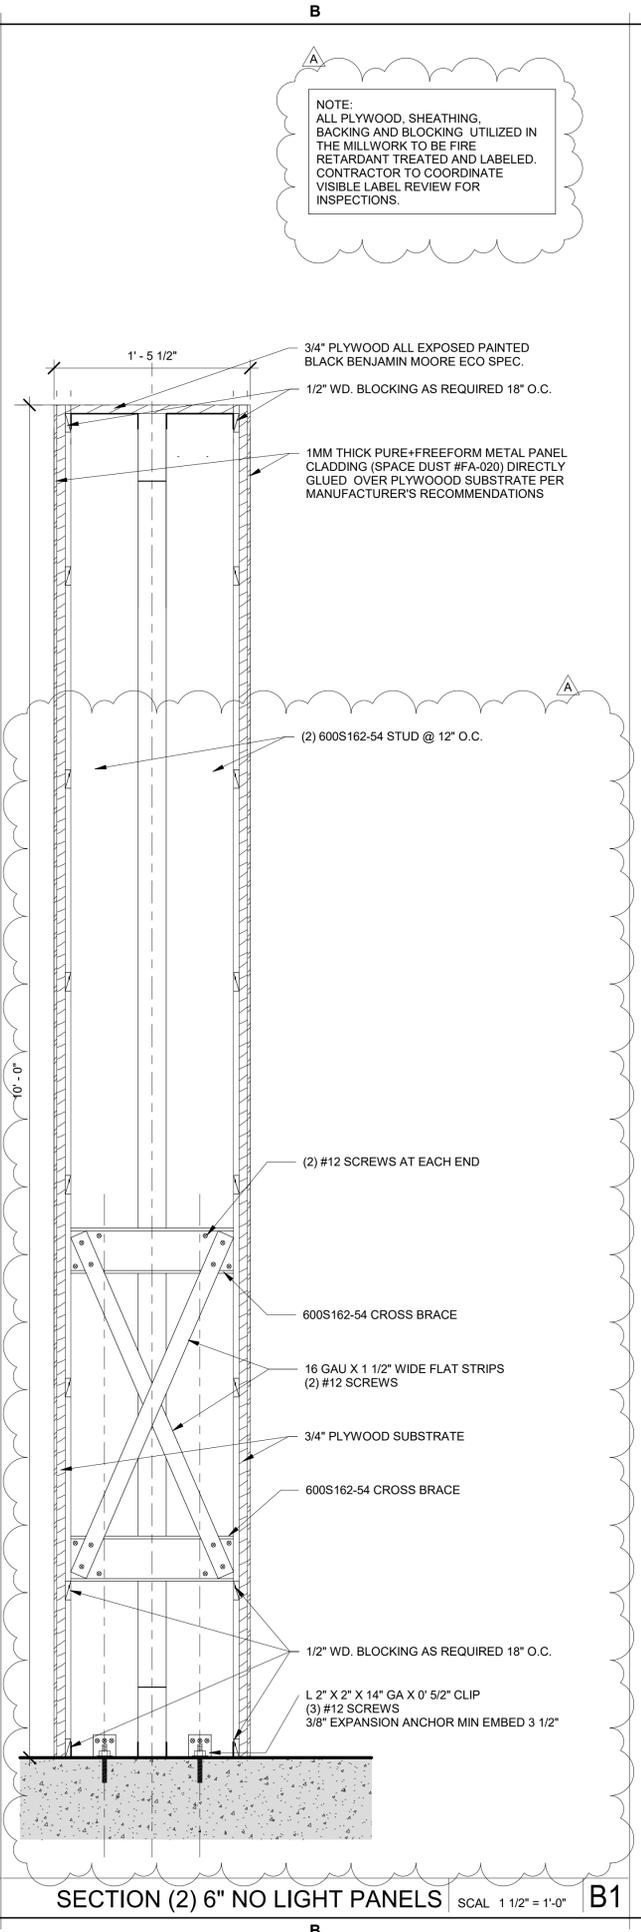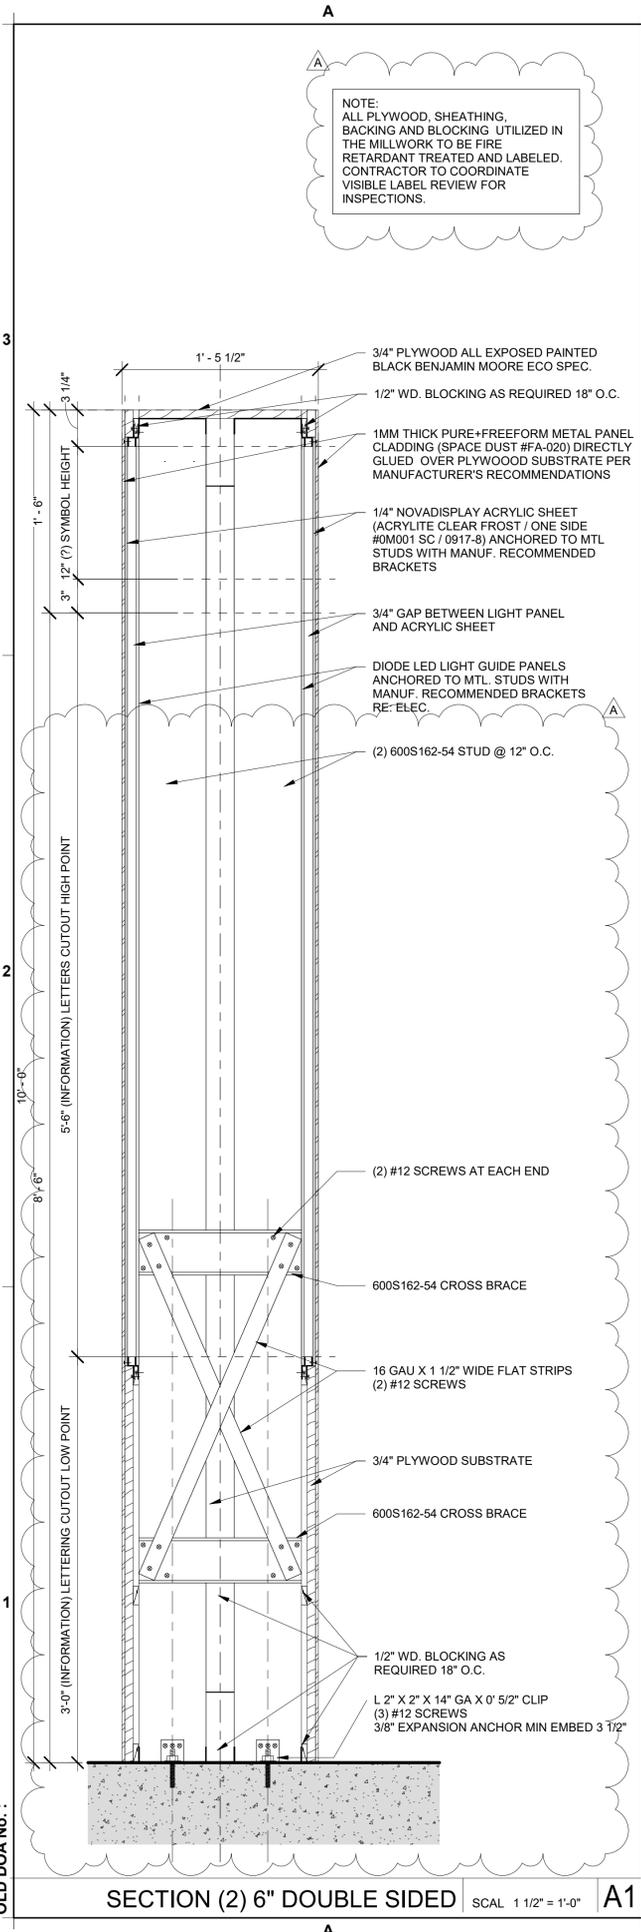HAS FILE:

PLOT DATE:
DOA DWG FILE:
OLD DOA No.:


CITY OF HOUSTON
HOUSTON AIRPORTS SYSTEM
Recommended
01/27/2022
DATE
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Director or Designated Representative



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REVISIONS

No.	DESCRIPTION	DATE	BY
1	SCHEMATIC DESIGN	10.23.20	
2	DESIGN DEVELOPMENT	12.04.20	
3	95% OWNER REVIEW	09.24.21	
4	100% PERMIT, BID AND CONSTRUCTION	11/08/21	


DESIGNER: Designer
DRAWN BY: RS
CHECKED BY: ACM
ISSUE DATE: 11/08/2021
APPROVED BY: Approver
APPROVAL DATE:

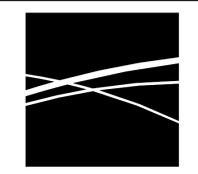DIRECTOR
of
HOUSTON AIRPORT SYSTEM


Review Approval Category

Approved For Construction


PN # 941
TIP NO. # TIP-21-128-HOU
SHEET NAME: ENLARGED "VIEWS"
SHEET No. A401 SCALE: 1/2" = 1'-0"
SHEET SIZE: 22"x34" ANSI-D

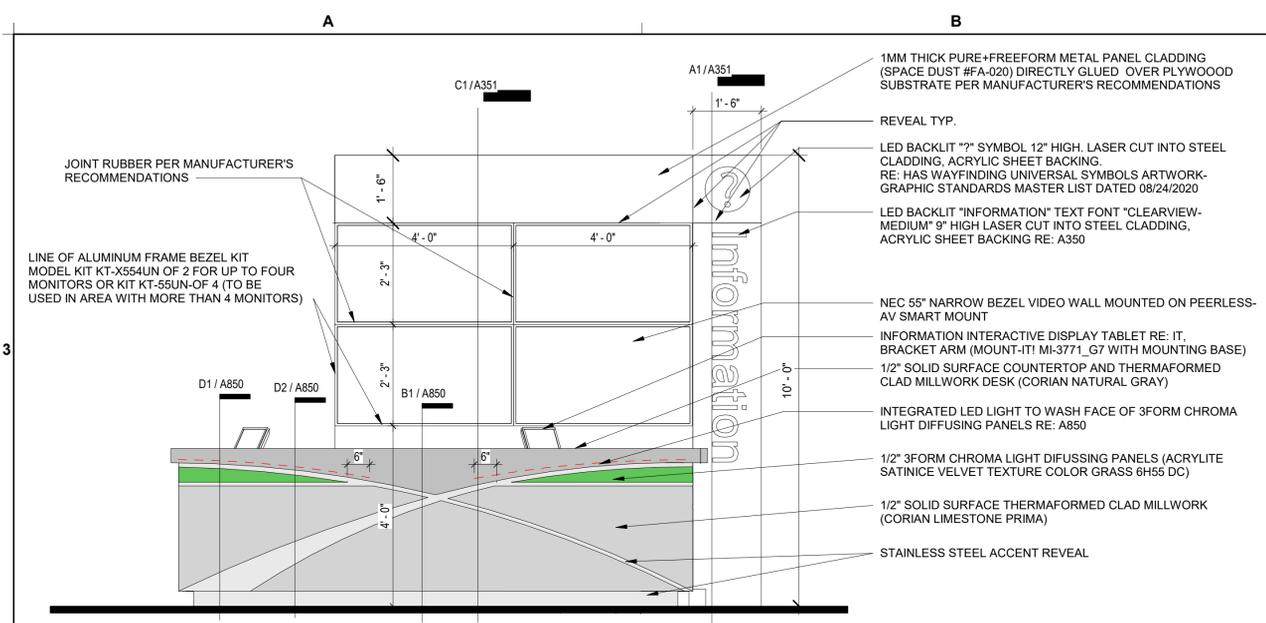


KIOSK ELEVATION @ AREA B SCAL 1/2" = 1'-0" B3

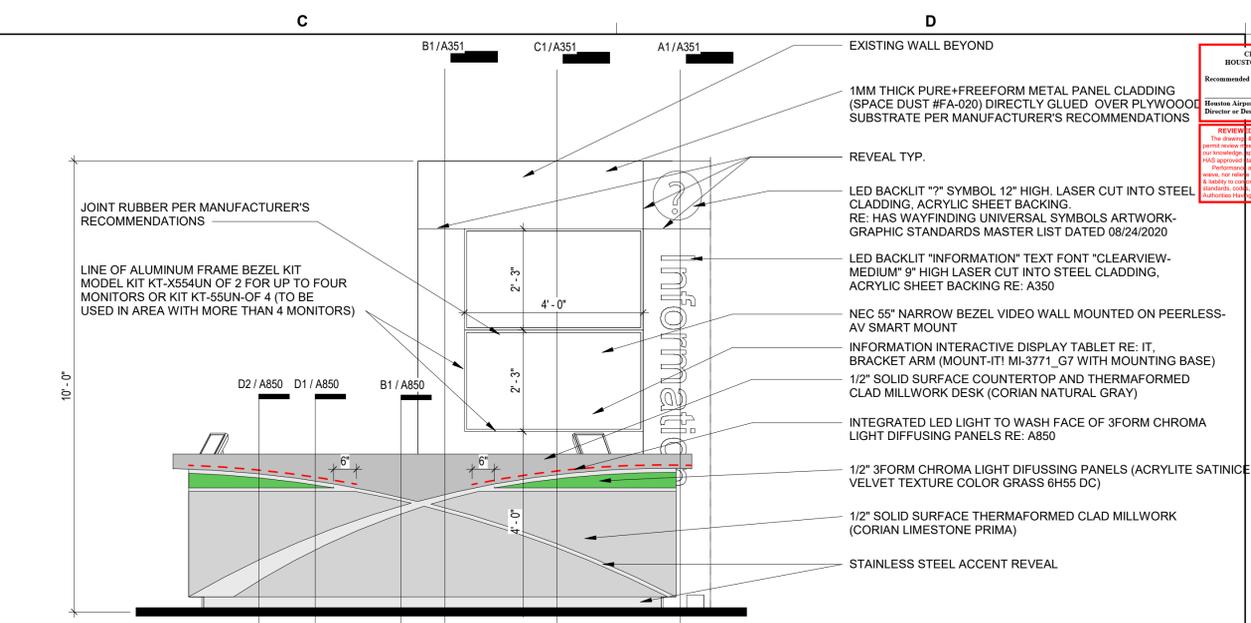


EAST KIOSK ELEVATION @ AREA D SCAL 1/2" = 1'-0" D3

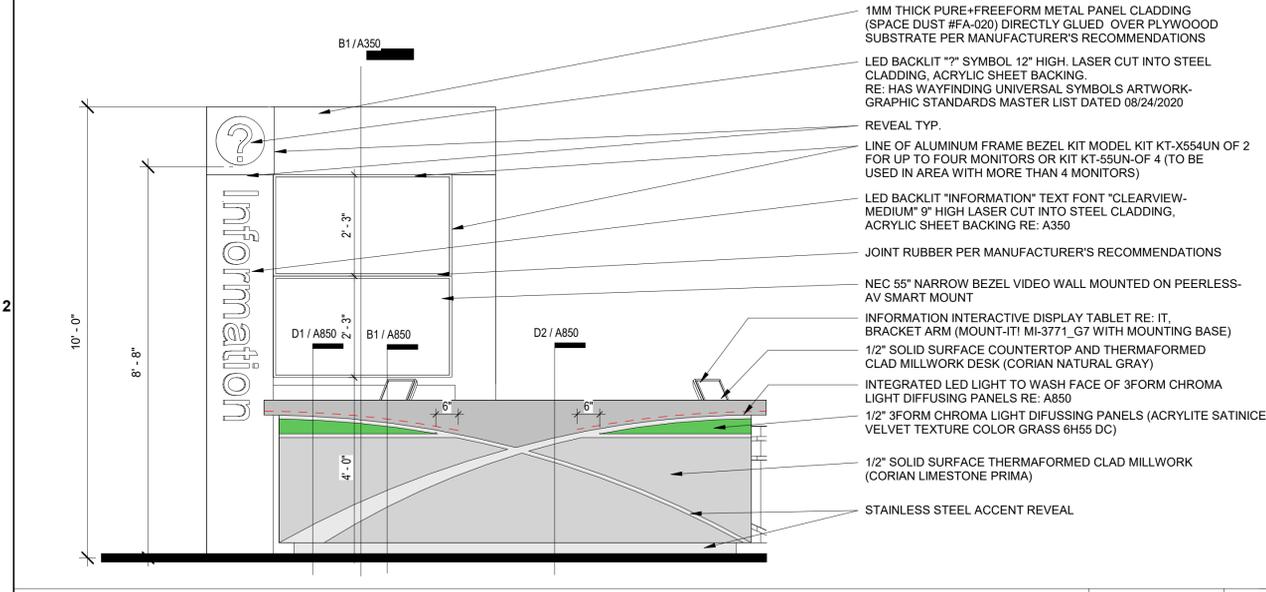


NORTH KIOSK ELEVATION @ AREA C SCAL 1/2" = 1'-0" B2

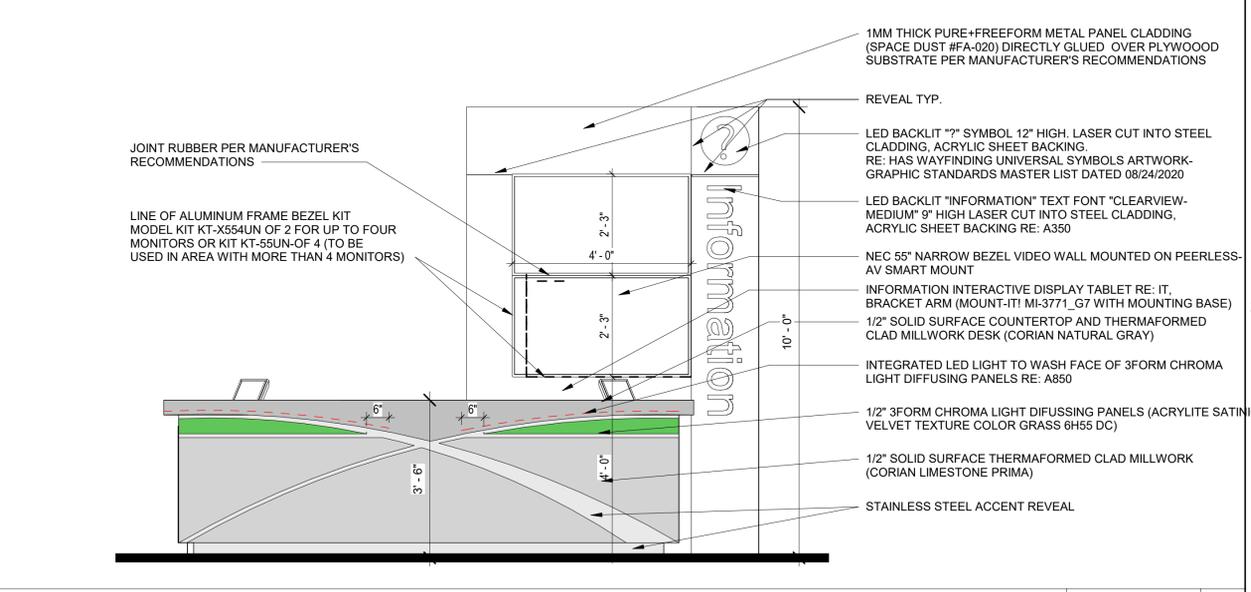

SOUTH KIOSK ELEVATION @ AREA C SCAL 1/2" = 1'-0" D2

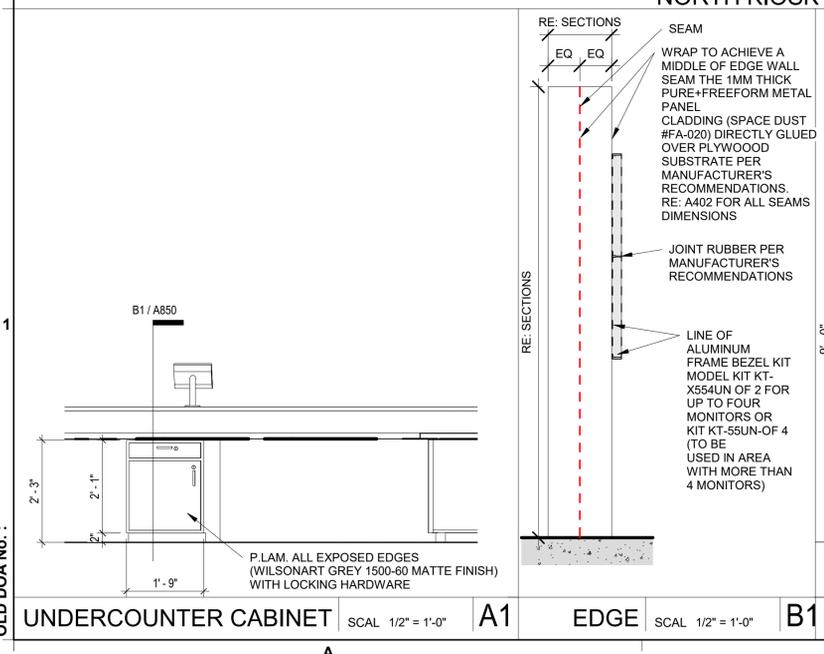

UNDERCOUNTER CABINET SCAL 1/2" = 1'-0" A1 EDGE SCAL 1/2" = 1'-0" B1

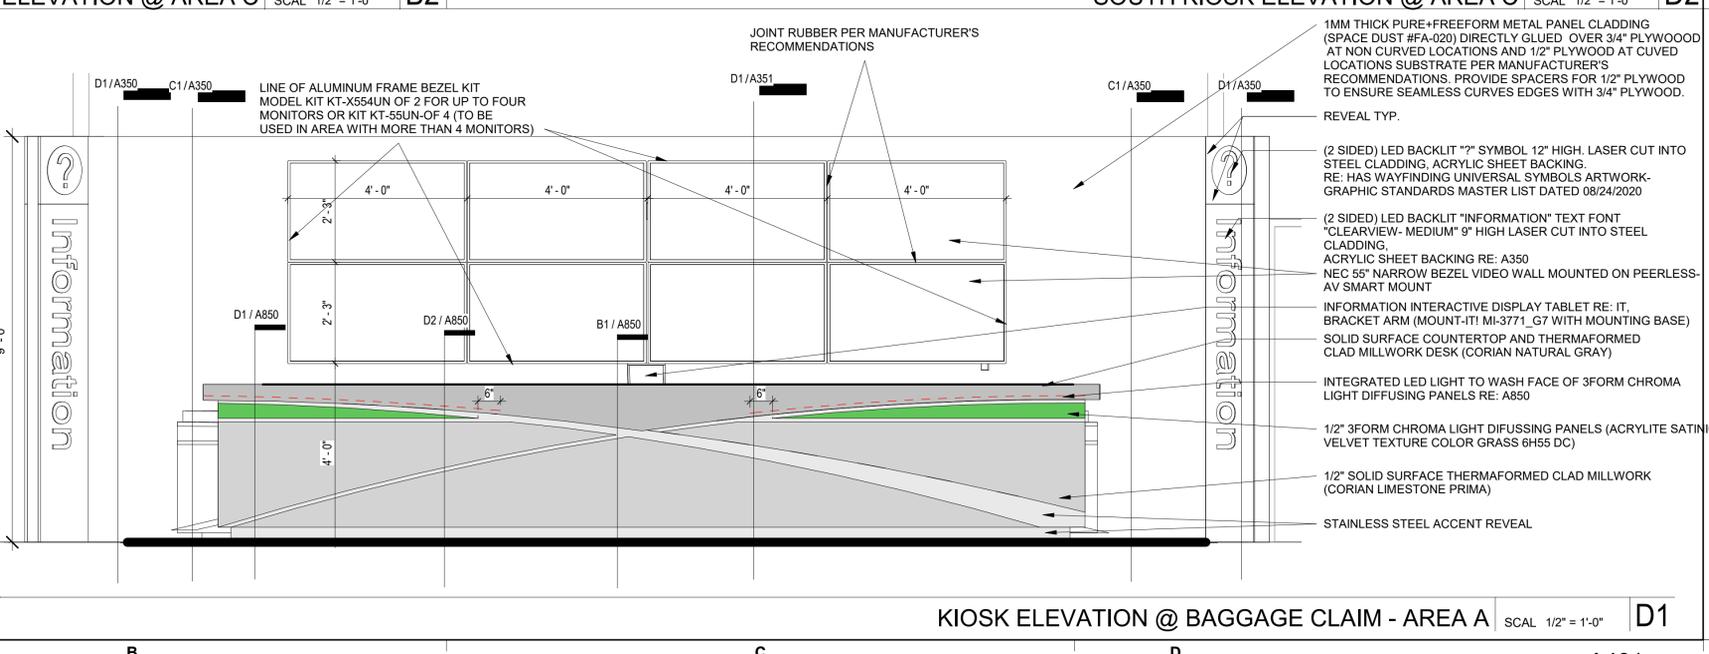


KIOSK ELEVATION @ BAGGAGE CLAIM - AREA A SCAL 1/2" = 1'-0" D1

FILE PATH:
HAS FILE:
PLOT DATE:
DOA DWG FILE:
OLD DOA No.:


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HAS FILE:


PLOT DATE:
DOA DWG FILE:
OLD DOA No.:

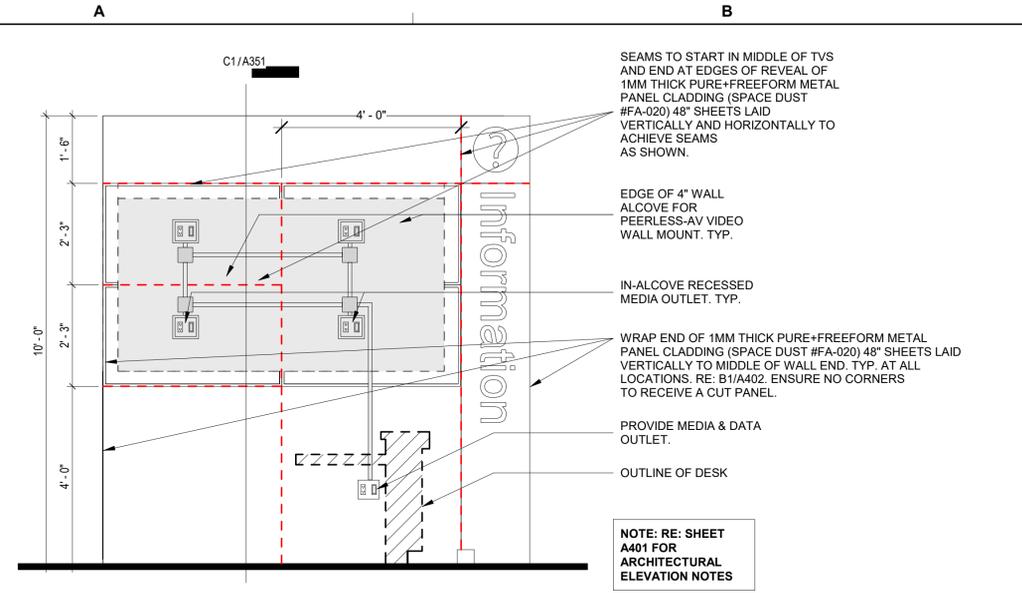


IT, DATA, & ELECTRICAL KIOSK ELEVATION @ AREA B SCAL 1/2" = 1'-0" B3

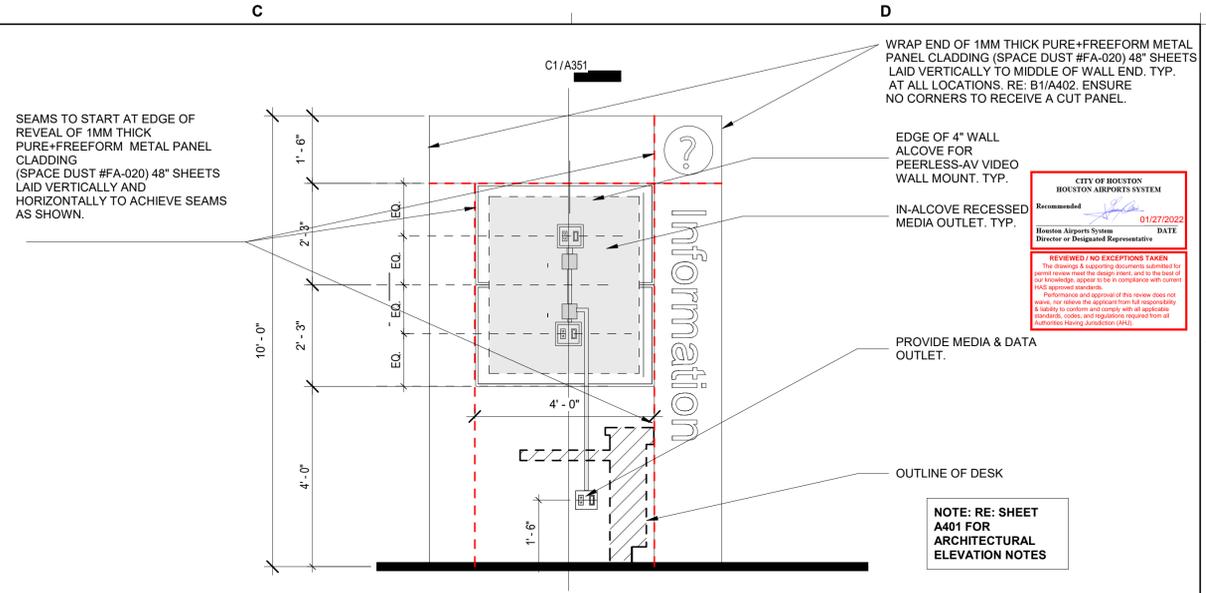


IT, DATA, & ELECTRICAL KIOSK ELEVATION @ AREA D SCAL 1/2" = 1'-0" D3

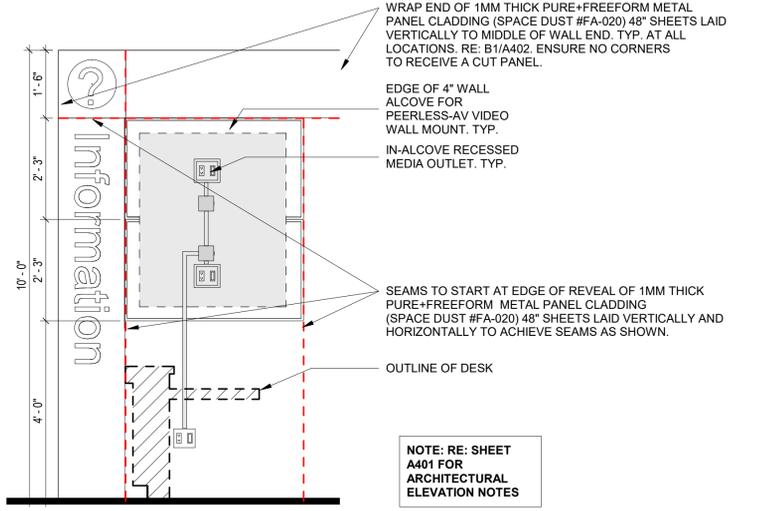

IT, DATA, & ELECTRICAL KIOSK ELEVATION @ AREA C SCAL 1/2" = 1'-0" B2

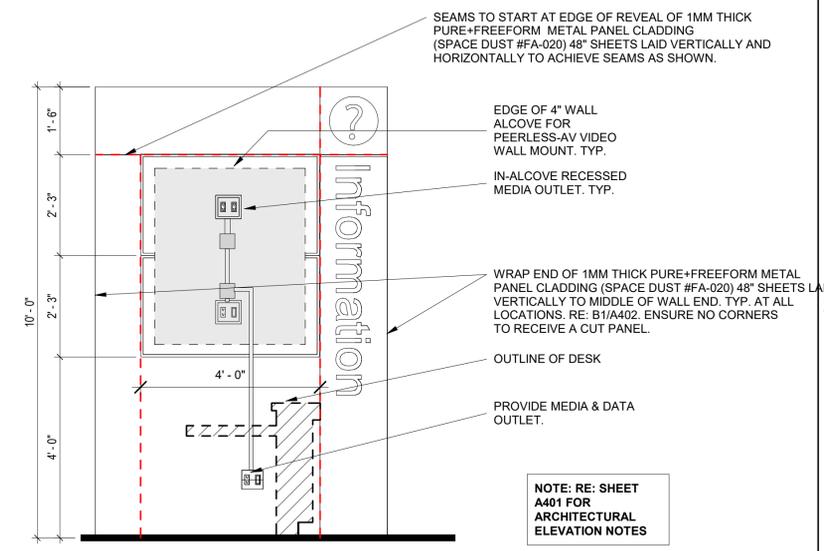

IT, DATA, & ELECTRICAL KIOSK ELEVATION @ AREA C1 SCAL 1/2" = 1'-0" D2

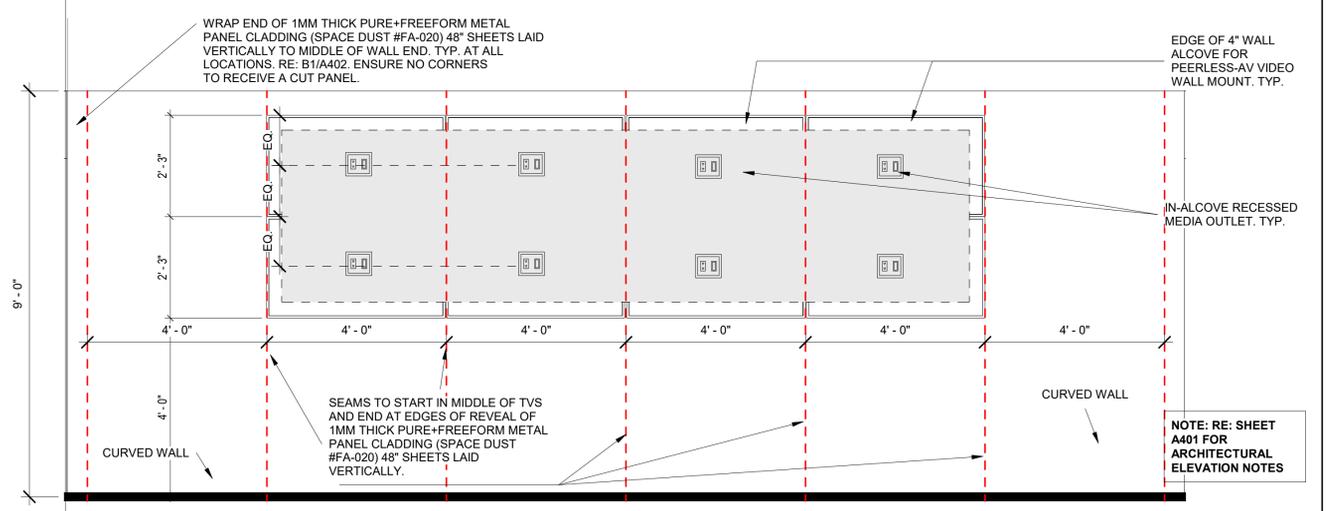

IT, DATA, & ELECTRICAL KIOSK ELEVATION @ AREA A SCAL 1/2" = 1'-0" D1



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www.english-architects.com

DESIGNER PROJECT No.: 20011.07
PROJECT STATUS: 100% PERMIT, BID CONSTRUCTION

REVISIONS

No.	DESCRIPTION	DATE	BY
1	SCHEMATIC DESIGN	10.23.20	
2	DESIGN DEVELOPMENT	12.04.20	
3	95% OWNER REVIEW	09.24.21	
4	100% PERMIT, BID AND CONSTRUCTION	11/08/21	

DESIGNER: _____ Designer
DRAWN BY: _____ Author
CHECKED BY: _____ Checker
ISSUE DATE: 11/08/2021
APPROVED BY: _____ Approver
APPROVAL DATE: _____

DIRECTOR
of
HOUSTON AIRPORT SYSTEM

Review/Approval Category

Approved For Construction

PN # 941

TIP NO. # TIP-21-128-HOU

SHEET NAME: IT, DATA, & ELECTRICAL ELEVATIONS

SHEET No. A402 SCALE: 1/2" = 1'-0"

SHEET SIZE: 22"x34" ANSI-D

A

B


C

D

CITY OF HOUSTON
HOUSTON AIRPORTS SYSTEM
Recommended: _____ DATE: 01/27/2022
Houston Airports System Director or Designated Representative

REVIEWED / NO EXCEPTIONS TAKEN
The drawings and supporting documents submitted to permit review meet the design intent, and to the best of our knowledge, appear to be in compliance with current code approval standards.
Performance and approval of this review does not constitute an endorsement of the products or materials used, nor does it constitute a warranty of any kind. The contractor is responsible for ensuring that all applicable codes, rules, and regulations are followed from all applicable governing jurisdiction (AGC).


NOTE:
ALL PLYWOOD, SHEATHING, BACKING AND BLOCKING UTILIZED IN THE MILLWORK TO BE FIRE RETARDANT TREATED AND LABELED. CONTRACTOR TO COORDINATE VISIBLE LABEL REVIEW FOR INSPECTIONS.

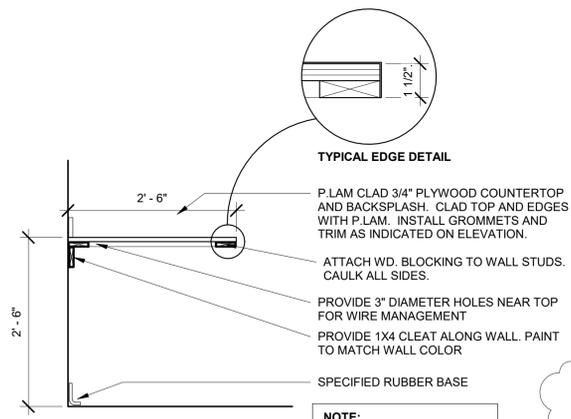

NOTE:
PLASTIC LAMINATE AT ALL EXPOSED AND SEMI-EXPOSED SURFACES.

NOTE:
ALL PLYWOOD, SHEATHING, BACKING AND BLOCKING UTILIZED IN THE MILLWORK TO BE FIRE RETARDANT TREATED AND LABELED. CONTRACTOR TO COORDINATE VISIBLE LABEL REVIEW FOR INSPECTIONS.

NO PARTICLE BOARD PERMITTED

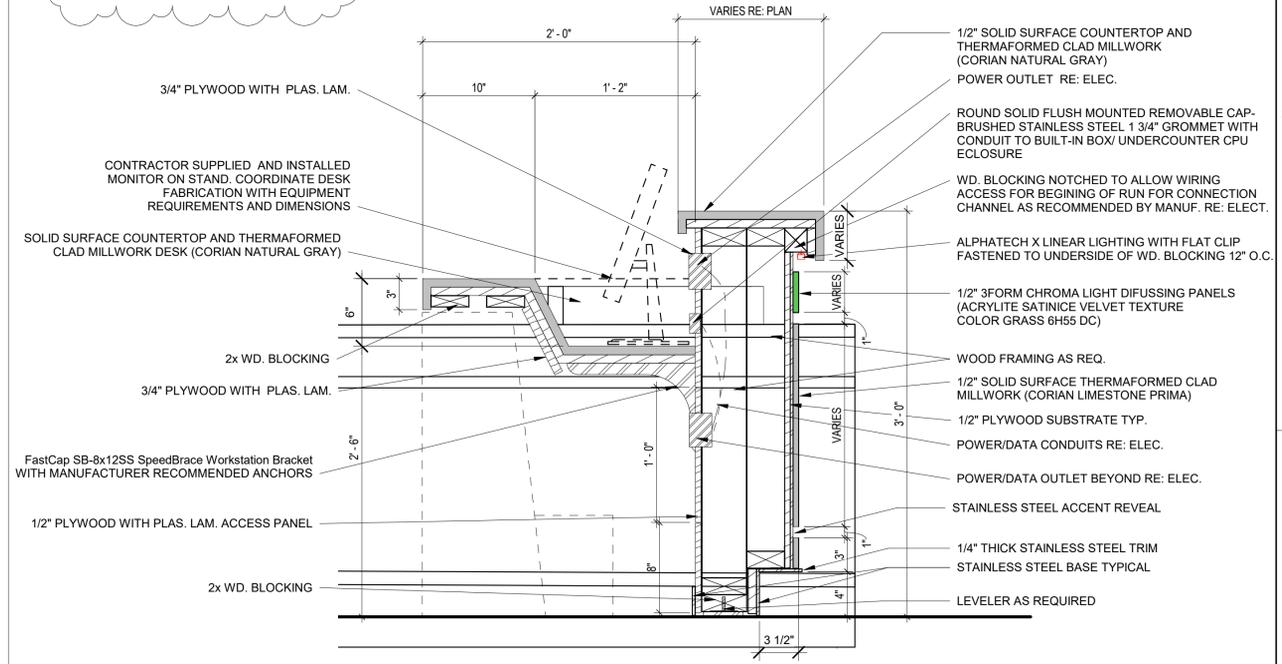


MILLWORK DETAIL SCAL 3/4" = 1'-0" B2

8-10 SECTION @ KIOSK RECESSED MONITOR SCAL 1 1/2" = 1'-0" D2

FILE PATH:

HAS FILE:


PLOT DATE: DOA DWG FILE: OLD DOA No. :

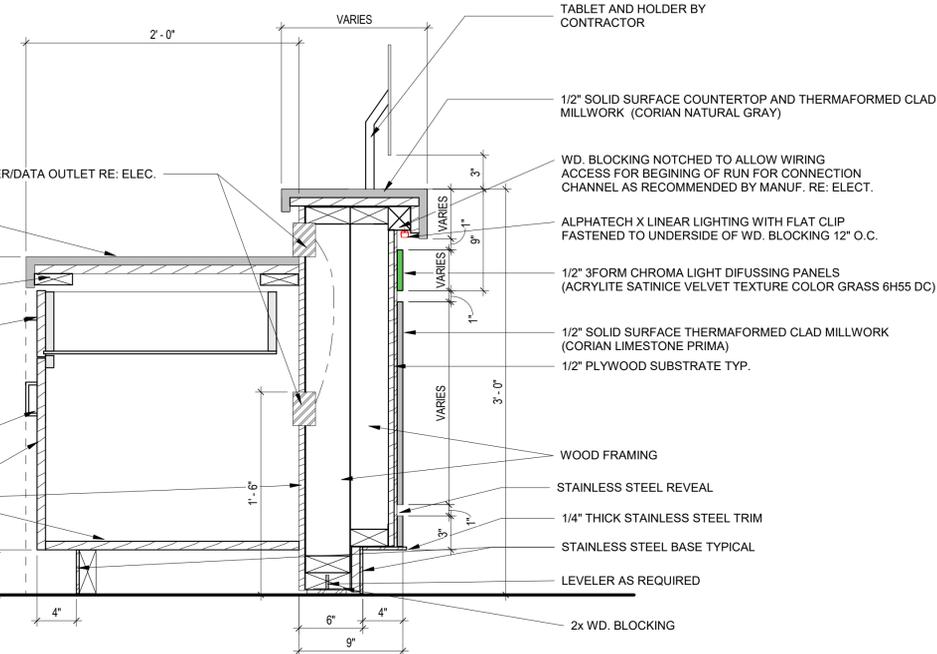

NOTE:
ALL PLYWOOD, SHEATHING, BACKING AND BLOCKING UTILIZED IN THE MILLWORK TO BE FIRE RETARDANT TREATED AND LABELED. CONTRACTOR TO COORDINATE VISIBLE LABEL REVIEW FOR INSPECTIONS.

NOTE:
ALL VERTICAL PLYWOOD SUBSTRATE TO RECEIVE THERMAFORMED CLAD MILLWORK TO BE 1/2" IN THICKNESS. ALL OTHER VERTICAL PLYWOOD WHICH DOES NOT RECEIVE THERMAFORMED CLAD MILLWORK AND HORIZONTAL PLYWOOD SUBSTRATE TO BE 3/4" IN THICKNESS.

8-10 SECTION @ KIOSK WITH TABLET DETAIL SCAL 1 1/2" = 1'-0" B1

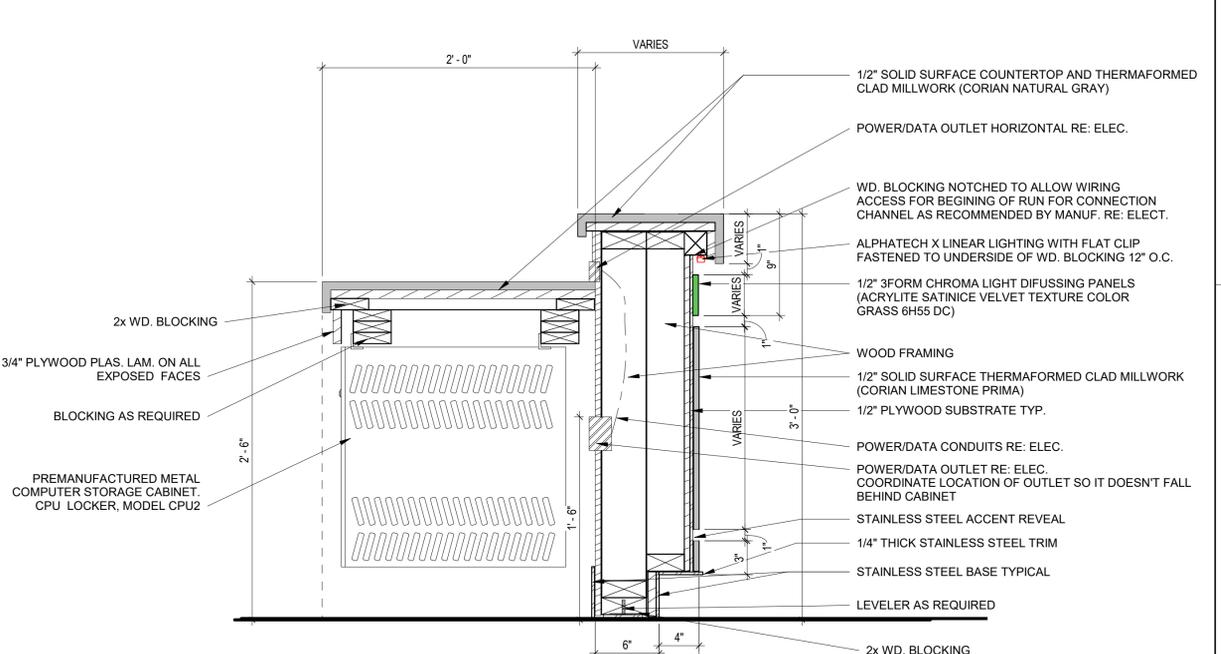

NOTE:
ALL PLYWOOD, SHEATHING, BACKING AND BLOCKING UTILIZED IN THE MILLWORK TO BE FIRE RETARDANT TREATED AND LABELED. CONTRACTOR TO COORDINATE VISIBLE LABEL REVIEW FOR INSPECTIONS.

NOTE:
COORDINATE LOCATION SO IT DOES NOT FALL BEHIND CABINETS.

8-10 SECTION @ KIOSK WITH STORAGE BOX SCAL 1 1/2" = 1'-0" D1



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HOU INFORMATION COUNTER RENOVATION

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DESIGNER PROJECT No.: 20011.07
PROJECT STATUS: 100% PERMIT, BID CONSTRUCTION

REVISIONS

No.	DESCRIPTION	DATE	BY
	SCHEMATIC DESIGN	10.23.20	
	DESIGN DEVELOPMENT	12.04.20	
	95% OWNER REVIEW	09.24.21	
	100% PERMIT, BID AND CONSTRUCTION	11/08/21	
A	ADDENDUM A	01-11-2022	

DESIGNER: _____ Designer
DRAWN BY: _____ RS
CHECKED BY: _____ ACM
ISSUE DATE: 01/11/2022
APPROVED BY: _____ Approver
APPROVAL DATE:

DIRECTOR
of
HOUSTON AIRPORT SYSTEM

Review Approval Category

Approved For Construction

PN # 941
TIP NO. # TIP-21-128-HOU

SHEET NAME: MILLWORK SECTIONS AND DETAILS

SHEET No. A850 SCALE: As indicated

SHEET SIZE: 22"x34" ANSI-D

A

B

C



D

3

2

3

2

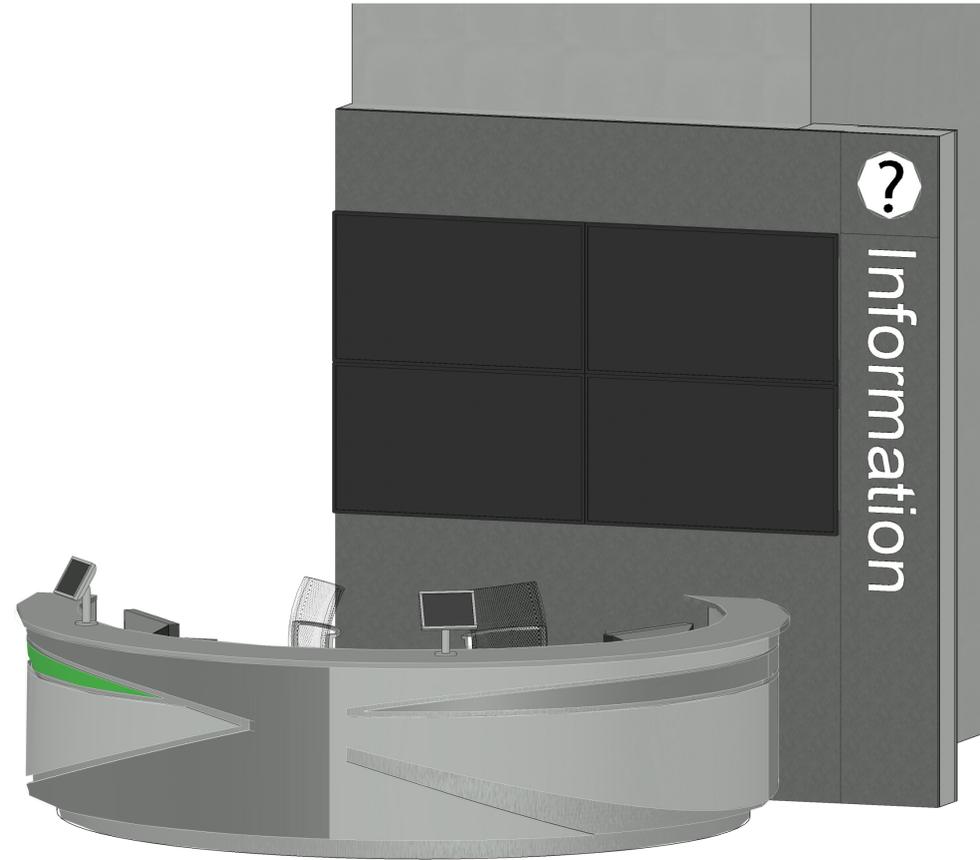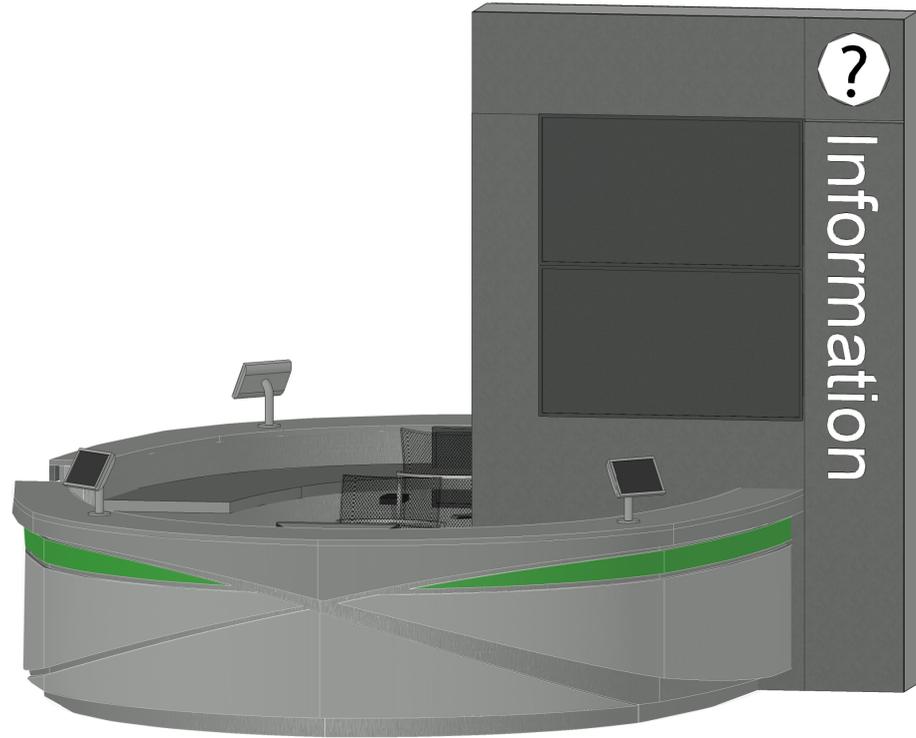

KIOSK 3D VIEW @ AREA C B2

KIOSK 3D VIEW @ AREA B D2

A



B

C

D

1

1

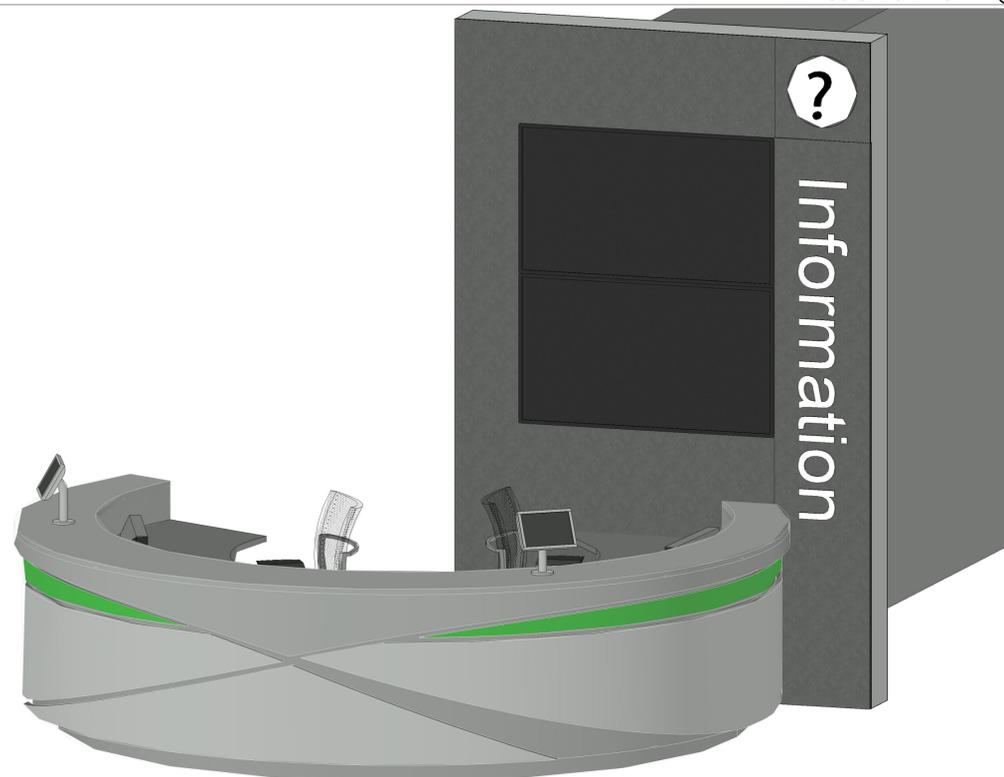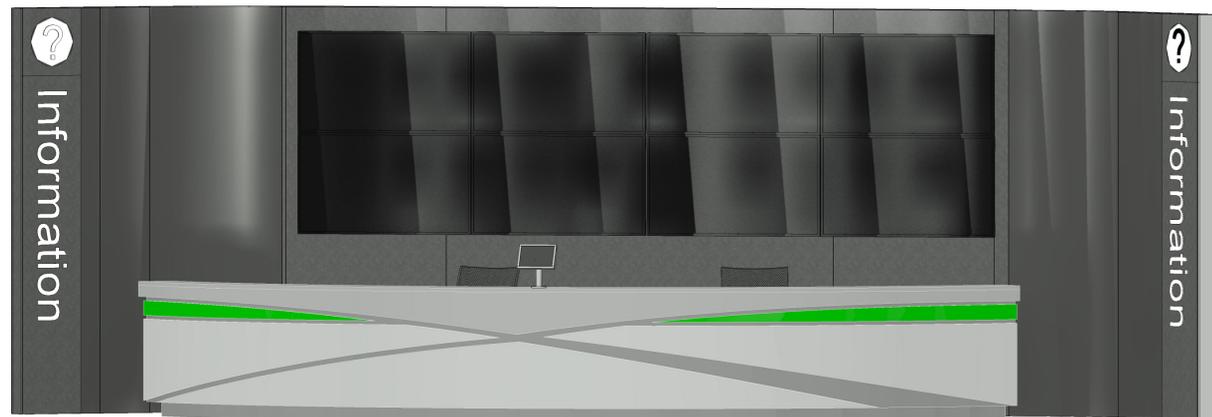

KIOSK 3D VIEW @ BAGGAGE CLAIM B1

KIOSK 3D VIEW @ AREA D D1

CITY OF HOUSTON
HOUSTON AIRPORTS SYSTEM
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Houston Airports System
Director or Designated Representative
DATE 01/27/2022

REVIEWED/NO EXCEPTIONS TAKEN
The drawings & supporting documents submitted for permit review meet the design and code requirements of the City of Houston and are in compliance with current code requirements.
Performance and approval of the review does not constitute a warranty of any kind, and the reviewer does not assume any liability for any errors or omissions, and the reviewer is not responsible for any errors or omissions, and the reviewer is not responsible for any errors or omissions, and the reviewer is not responsible for any errors or omissions.



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DESIGNER PROJECT No.: 20011.07
PROJECT STATUS: 100% PERMIT, BID CONSTRUCTION

REVISIONS

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DESIGNER: Designer
DRAWN BY: RS
CHECKED BY: ACM
ISSUE DATE: 11/08/2021
APPROVED BY: Approver
APPROVAL DATE:


DIRECTOR
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Review Approval Category

Approved For Construction

PN # 941
TIP NO. # TIP-21-128-HOU
SHEET NAME: 3D VIEWS
SHEET No. A900 SCALE:
SHEET SIZE: 22"x34" ANSI-D

FILE PATH:
HAS FILE:
PLOT DATE:
DOA DWG FILE:
OLD DOA No.:

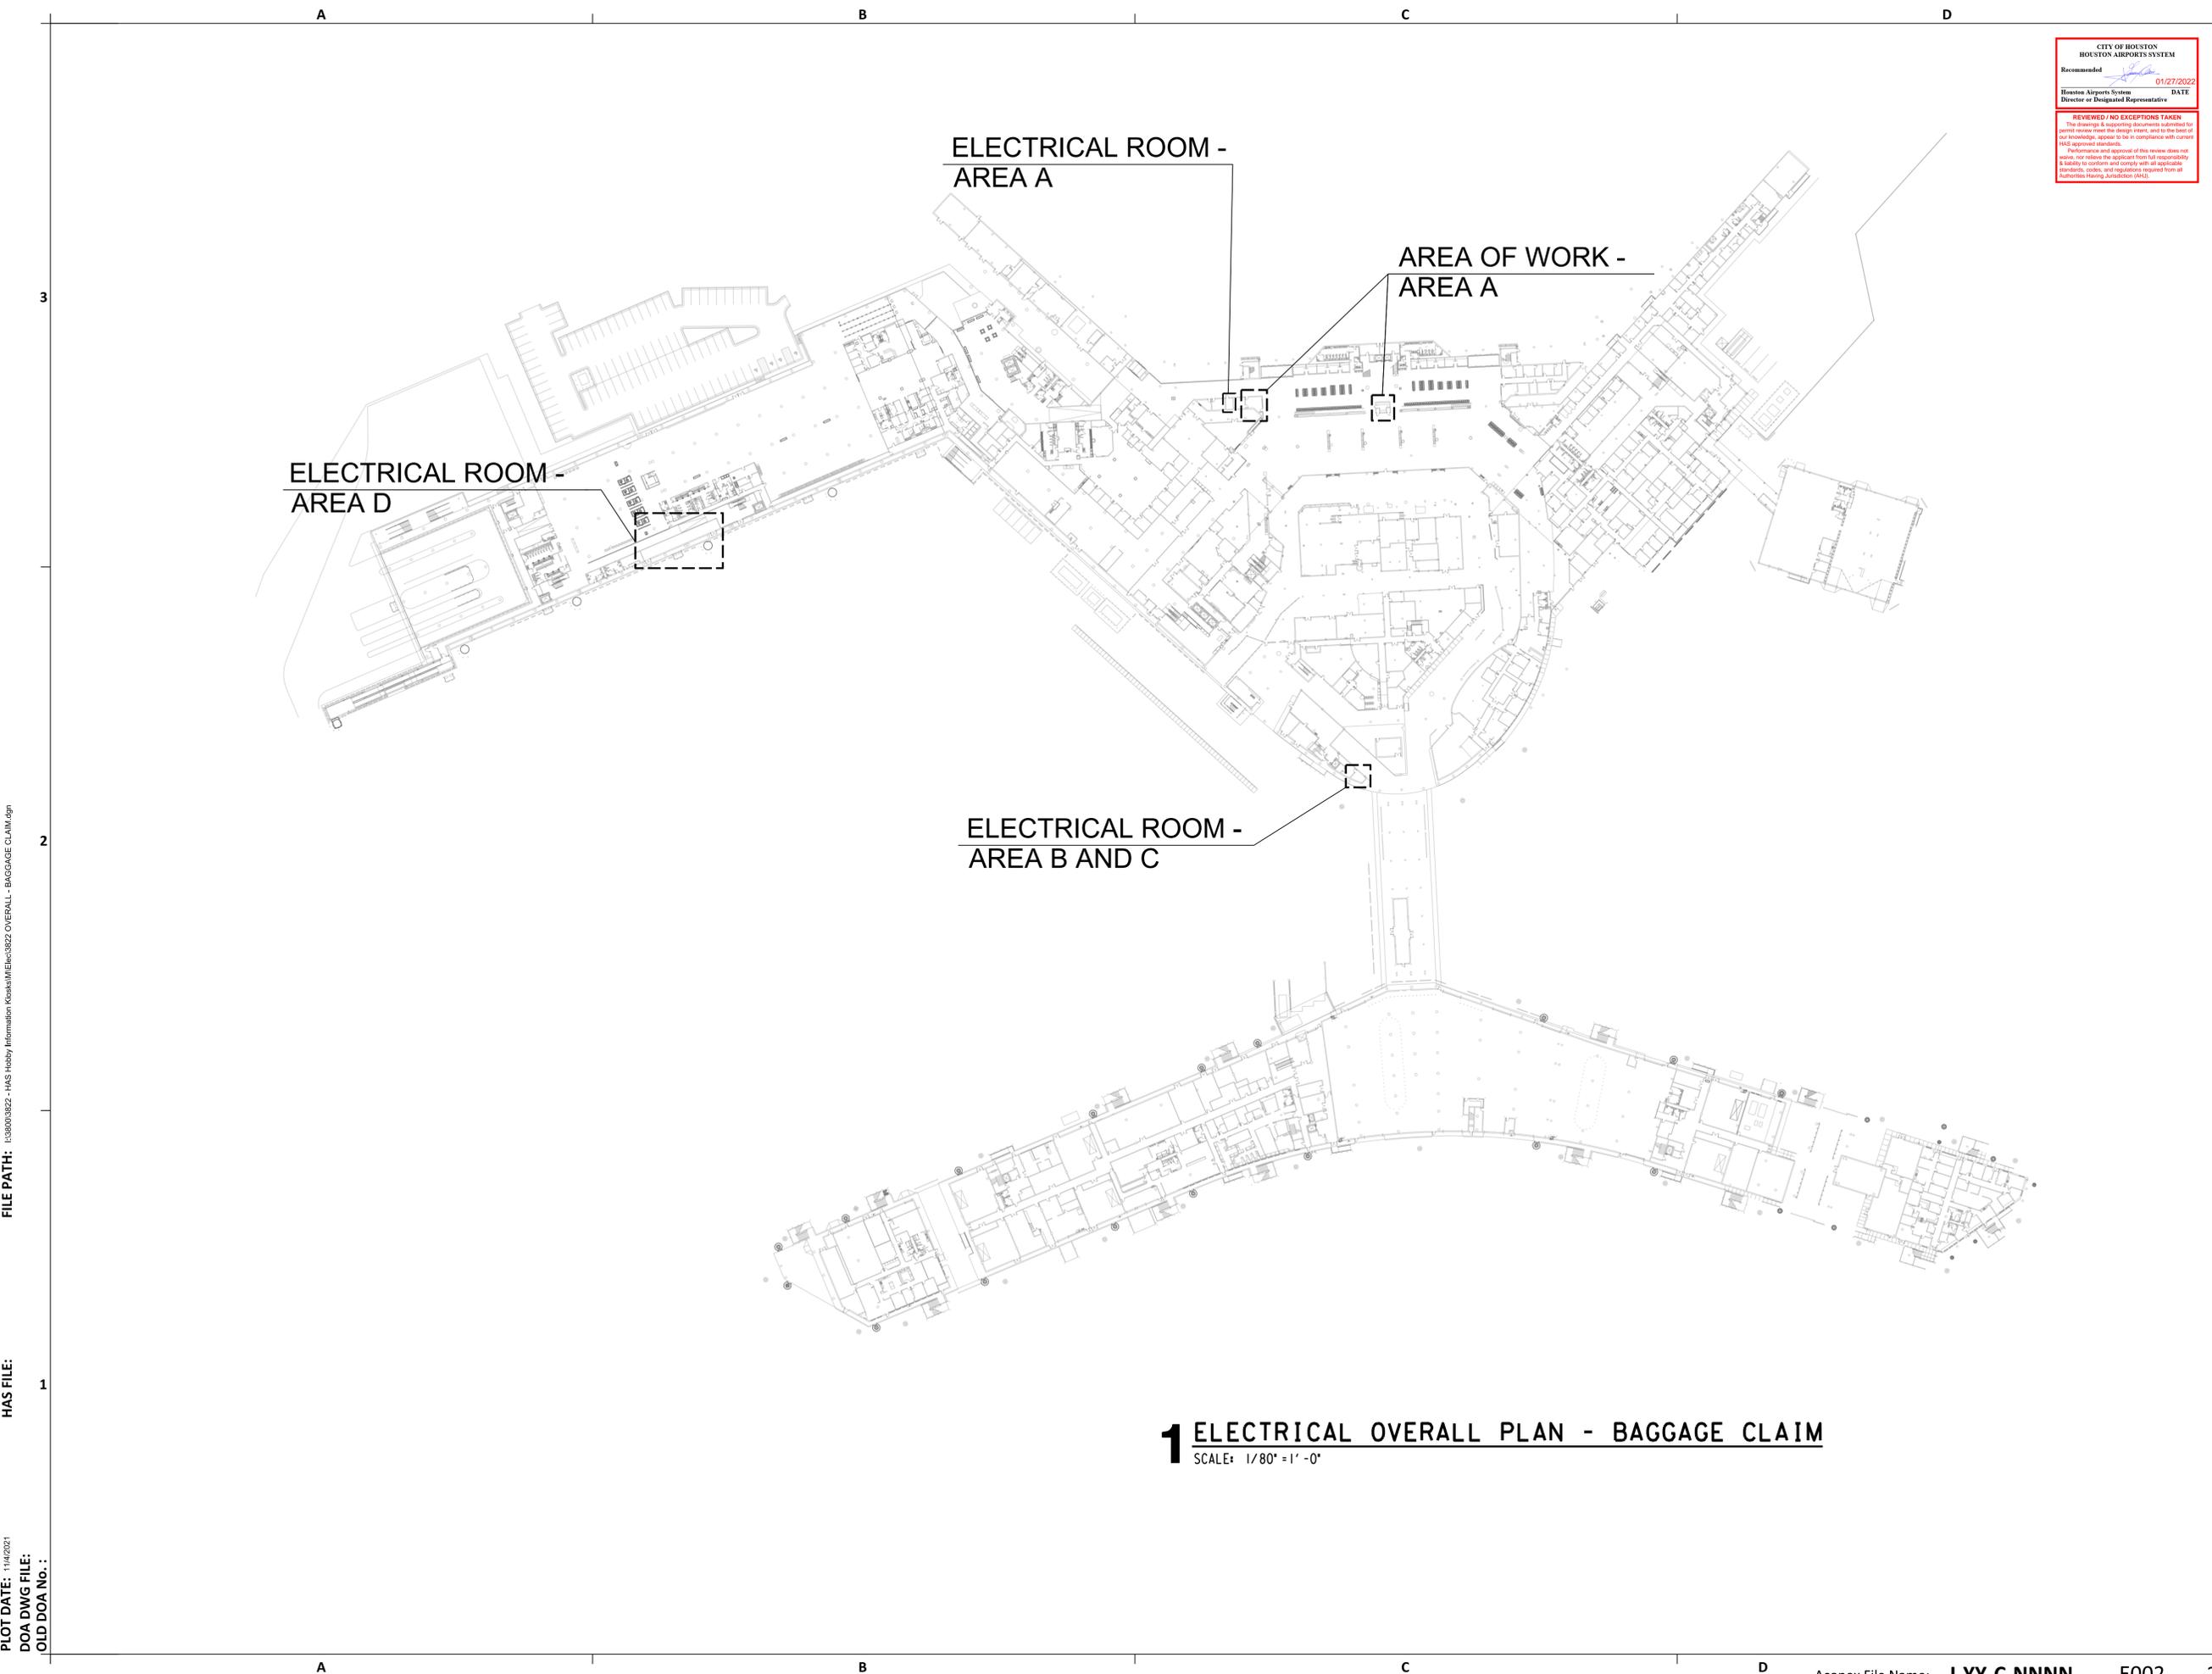

CITY OF HOUSTON
HOUSTON AIRPORTS SYSTEM
Recommended
Houston Airport System
Director or Designated Representative
DATE
01/27/2022

REVIEWED / NO EXCEPTIONS TAKEN
The drawings & supporting documents submitted for permit review meet the design intent, and to the best of our knowledge, appear to be in compliance with current H&S approved standards.
Performance and approval of this review does not relieve the applicant from full responsibility & liability to conform and comply with all applicable standards, codes, and regulations required from all Authorities Having Jurisdiction (AHJ).

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C.O.H. No.	D.O.A No.



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DESIGNER PROJECT No.: 20011.07
PROJECT STATUS: 100% PERMIT, BID CONSTRUCTION

REVISIONS

No.	DESCRIPTION	DATE	BY
	DESIGN DEVELOPMENT	12.04.20	
	95% OWNER REVIEW	09.24.21	
	100% PERMIT, BID AND CONSTRUCTION	11.08.21	

DESIGNER: RLG
DRAWN BY: RLG
CHECKED BY: RLG
ISSUE DATE: 11/08/21
APPROVED BY: RLG
APPROVAL DATE:


**DIRECTOR
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HOUSTON AIRPORT SYSTEM**

Review/ Approval Category	 E&C Engineers & Consultants Inc Texas Firm Registration No: 140006 <i>Larkin Gentry</i> Larkin Gentry 2021.11.04 14:24:10-05'00"
Approved For Construction	

SHEET NAME: ELECTRICAL OVERALL PLAN - BAGGAGE CLAIM
SHEET No. E002 **SCALE:** As Indicated

SHEET SIZE: 22"x34" ANSI-D

PLOT DATE: 1/14/2021
 DOA DWG FILE:
 OLD DOA No.:
 FILE PATH: I:\3800\3822 - HAS Hobby Information\Kishia\MElec\3822 OVERALL - BAGGAGE CLAIM.dgn
 HAS FILE:

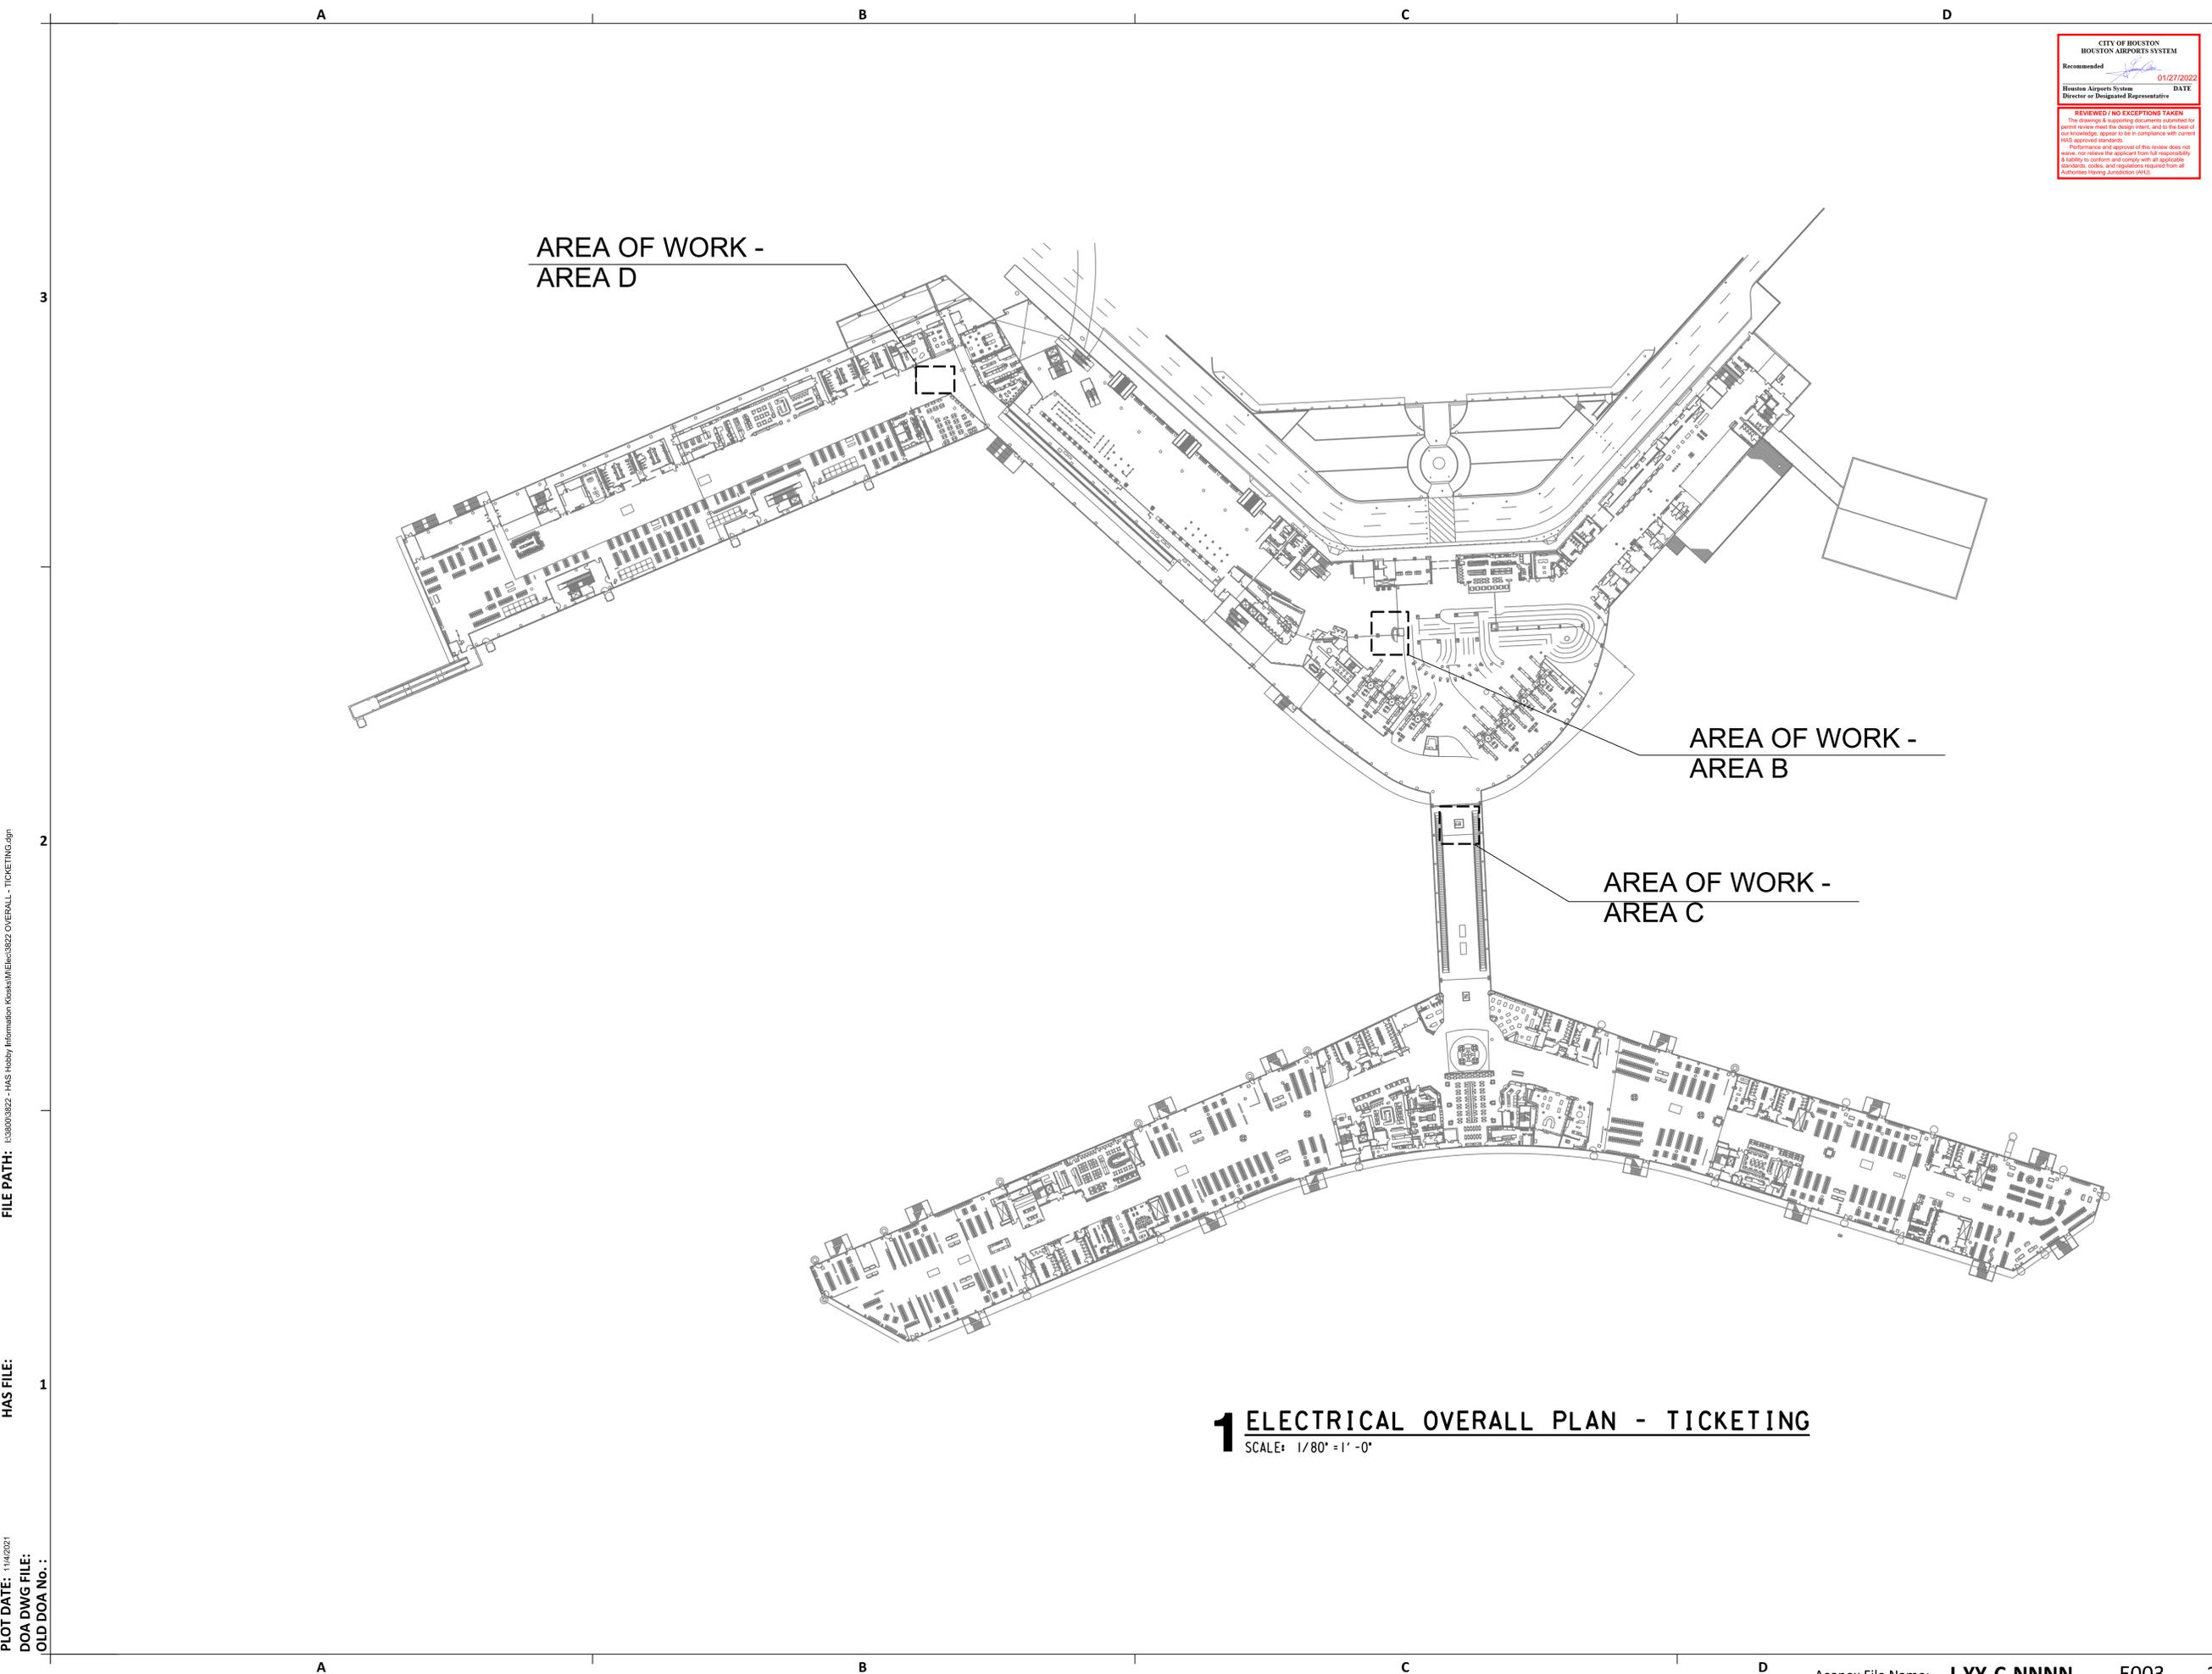

CITY OF HOUSTON
HOUSTON AIRPORTS SYSTEM
Recommended: 01/27/2022
DATE
Houston Airports System
Director or Designated Representative

REVIEWED / NO EXCEPTIONS TAKEN
The drawings & supporting documents submitted in permit review are for design review, and to the best of our knowledge, appear to be in compliance with current HAS approved standards.
Performance and approval of this review does not waive, nor relieve the applicant from full responsibility & liability to conform and comply with all applicable standards, codes, and regulations required from all authorities having jurisdiction (AHJ).



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C.O.H. No.	D.O.A No.



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DESIGNER PROJECT No.: 20011.07
PROJECT STATUS: 100% PERMIT, BID CONSTRUCTION

REVISIONS

No.	DESCRIPTION	DATE	BY
1	DESIGN DEVELOPMENT	12.04.20	
2	95% OWNER REVIEW	09.24.21	
3	100% PERMIT, BID AND CONSTRUCTION	11.08.21	

DESIGNER: RLG
DRAWN BY: RLG
CHECKED BY: RLG
ISSUE DATE: 11/08/21
APPROVED BY: RLG
APPROVAL DATE:

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Review/ Approval Category	 LARKIN GENTRY 97304 LICENSED PROFESSIONAL ENGINEER E&C Engineers & Consultants Inc. Texas Firm Registration No: 140006 <i>Larkin Gentry</i> Larkin Gentry 2021.11.04 14:24:10-05:00
Approved For Construction	

1 ELECTRICAL OVERALL PLAN - TICKETING
SCALE: 1/80" = 1' - 0"

PLOT DATE: 11/14/2021
 DOA DWG FILE:
 OLD DOA No.:
 HAS FILE:
 FILE PATH: I:\3800\3822 - HAS Hobby Information\Kishka\MElec\3822 OVERALL - TICKETING.dgn


PLOT DATE: 11/14/2021
 DOA DWG FILE:
 OLD DOA No.:
 FILE PATH: I:\3800\3822 - HAS Hobby Information Kiosks\MElec\3822 ELECTRICAL AREA A.dgn
 HAS FILE:
 1
 2
 3

GENERAL NOTES:


- A. RE: E000 FOR MORE GENERAL NOTES, SYMBOLS, AND ABBREVIATIONS.
- B. REMOVE ALL ABANDONED BRANCH CIRCUITING BACK TO NEAREST JUNCTION BOX TO REMAIN OR BACK TO PANEL SERVING. IF CIRCUIT IS NOT REUSED TURN BREAKER OFF AND LABEL SPARE.
- C. ALL CIRCUIT INFORMATION IS BASED OF EXISTING DRAWINGS. FIELD CONFIRM ALL CIRCUITING PRIOR TO STARTING WORK.
- D. ALL LIGHTING IS EXISTING TO REMAIN UNLESS NOTED OTHERWISE.
- E. ALL WIRING IS #12 AWG UNLESS NOTED OTHERWISE.
- F. ALL RECEPTACLES ARE AT 18" A.F.F. UNLESS NOTED OTHERWISE.
- G. REFER TO APPLICABLE SERIES DRAWINGS FOR ALL REQUIRED DIVISION 26 RELATED WORK PERTAINING TO THE TELECOMMUNICATIONS, AUDIO/VIDEO, AND SECURITY SYSTEMS. REFER TO APPLICABLE SPECIFICATIONS AS NOTED ON THESE DRAWINGS FOR ADDITIONAL REQUIRED DIVISION 26 RELATED WORK. REQUIRED DIVISION 26 WORK SHALL INCLUDE, BUT IS NOT LIMITED TO, THE INSTALLATION OF BACK BOXES, SPECIALTY BACK BOXES, VOICE/DATA OUTLET ROUGH-INS, CONDUITS, CABLE TRAYS, CONDUIT SLEEVES, FLOOR BOXES, GROUNDING SYSTEM COMPONENTS, CARD READER ROUGH-INS, DOOR POSITION SWITCH ROUGH-INS, ELECTRIC POWER TRANSFER ROUGH-INS, CAMERA ROUGH-INS, ETC. THE EXACT LOCATIONS AND REQUIREMENTS OF SUCH WORK SHALL BE COORDINATED WITH THE APPLICABLE DIVISION.
- H. RE: ARCHITECTURAL DRAWINGS FOR ALL MOUNTING HEIGHTS.

DRAWING NOTES:

- ① REMOVE ALL EXISTING RECEPTACLES, DATA OUTLETS, AND OTHER WALL OR FLOOR MOUNTED POWER. DISPOSE OF AS DIRECTED BY OWNER. UNLESS NOTED OTHERWISE.
- ② EXISTING ELECTRICAL CONNECTION TO JC DECAUX DISPLAY TO REMAIN AND BE PROTECTED.
- ③ EXISTING JUNCTION BOX BELOW COUNTER TO REMAIN AND BE PROTECTED. RE: ARCH FOR NEW ENCLOSURE BOX.
- ④ DEMO EXISTING DATA AND ELECTRICAL BELOW COUNTER PULL BACK TO SOURCE. CUT/CAP CONDUITS BELOW FLOOR. RE: ARCH. FOR FLOOR REPAIRS.
- ⑤ POWER AND DATA FOR NEW WALL MOUNTED TV. ROUGH-IN RECEPTACLE AND DATA OUTLET AT HEIGHT SPECIFIED BY ARCHITECT AND AV/IT CONSULTANT. FOR DATA OUTLET PROVIDE ROUGH-IN AS SPECIFIED BY AV/IT CONSULTANT.
- ⑥ DATA OUTLET. REFER TO TELECOMMUNICATIONS CONSULTANTS DRAWINGS FOR ROUGH-IN.
- ⑦ DUPLEX RECEPTACLE. PROVIDE 3/4" C FOR POWER FROM NEAREST ACCESSIBLE CEILING, DOWN IN WALL, UNDERSLAB, AND TURNED UP AS SHOWN AT FIRST RECEPTACLE. CONDUIT ABOVE CEILING SHALL BE EMT, CONDUIT IN SLAB OR BELOW GRADE SHALL BE RIGID STEEL, CONDUIT IN INFORMATION KIOSK SHALL BE EMT OR FLEXIBLE METAL CONDUIT. ALL CONDUIT SHALL HAVE INSULATED THROATS.
- ⑧ NEW CONDUIT STUB UP INTO NEW MILLWORK. ROUTE CONDUIT THROUGH MILLWORK TO POWER, DATA, AND LIGHTING OUTLETS AS REQUIRED.
- ⑨ PHONE OUTLET. REFER TO TELECOMMUNICATIONS CONSULTANTS DRAWINGS FOR ROUGH-IN.
- ⑩ COUNTERTOP USB OUTLET FOR TABLET. MOUNT ABOVE COUNTERTOP IN MILLWORK. USB CHARGER DUPLEX RECEPTACLE, 20A, 125V, 2-POLE, 3-WIRE GROUNDING, 5-20R, ONE 3.1 AMP TYPE "C" USB AND ONE USB TYPE "A" PORT, WHITE COLOR OR EQUAL BY OTHERS.
- ⑪ CONTINUOUS LED STRIP ACCENT LIGHTING.
- ⑫ POWER FOR LED LOGO.
- ⑬ LIGHT SWITCH TO CONTROL ACCENT STRIP LIGHT AND LIGHTED SIGNAGE. 120V, 20A, SINGLE POLE.

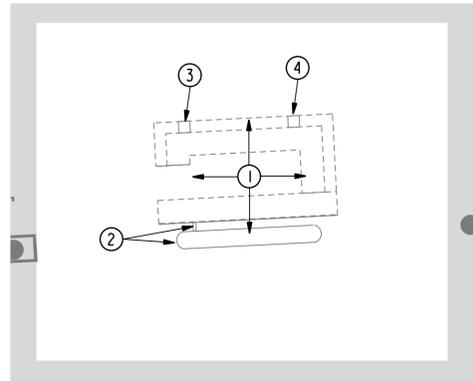

3 ELECTRICAL DEMOLITION - INFORMATION KIOSK
 SCALE: 1/8" = 1' - 0"

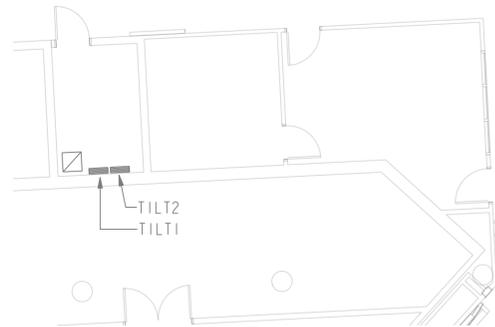


4 AREA A ELECTRICAL ROOM
 SCALE: 1/8" = 1' - 0"

RE: E002 FOR ELECTRICAL ROOM LOCATION AND AREA A SCOPE OF WORK


CITY OF HOUSTON
HOUSTON AIRPORTS SYSTEM

Recommended _____ DATE 01/27/2022
Houston Airports System Director or Designated Representative

REVIEWED / NO EXCEPTIONS TAKEN
The drawings & supporting documents submitted for permit review meet the design intent, and to the best of the reviewer's knowledge, appear to be in compliance with current HHS approved standards.
The contractor and approval of this review does not constitute an approval of the design or the contractor's ability to conform and comply with all applicable standards, codes, and regulations required from all Authorities Having Jurisdiction (AHJ).

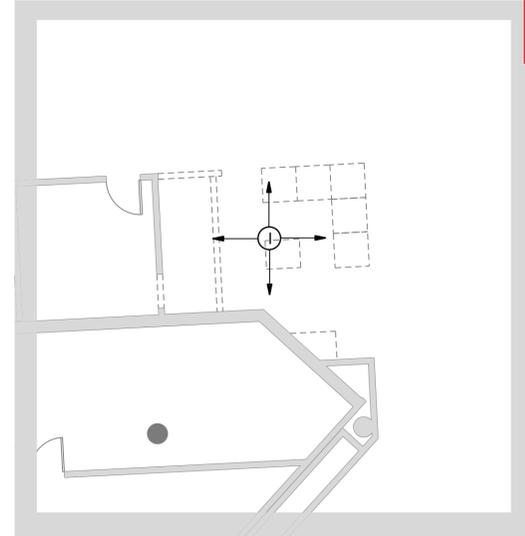

1 ELECTRICAL DEMOLITION - H TOWN AREA
 SCALE: 1/8" = 1' - 0"

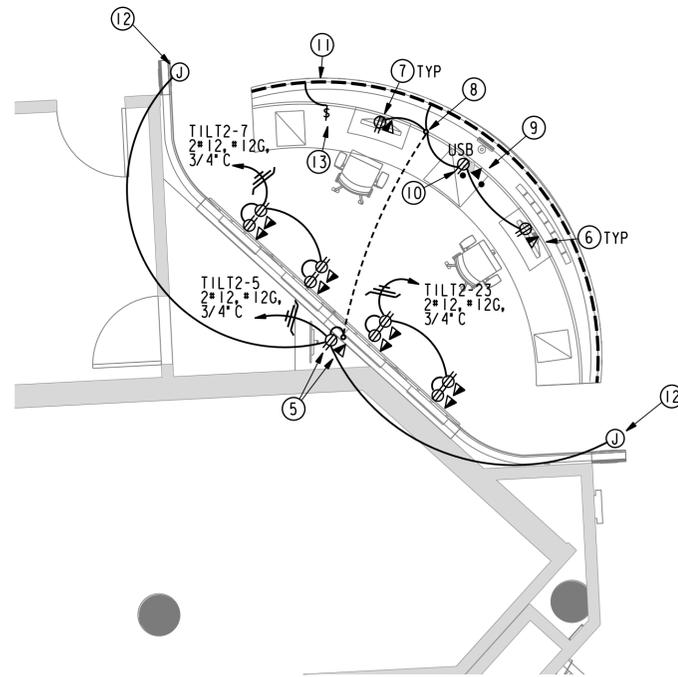

2 ELECTRICAL RENOVATION - H TOWN AREA
 SCALE: 1/4" = 1' - 0"

HOUSTON AIRPORTS

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HOUSTON, TEXAS 77061

**HOU INFORMATION COUNTER
RENOVATION**

C.I.P. No.	A.I.P. No.
C.O.H. No.	D.O.A No.

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www.english-architects.com

DESIGNER PROJECT No.: 20011.07
PROJECT STATUS: 100% PERMIT, BID CONSTRUCTION

REVISIONS			
No.	DESCRIPTION	DATE	BY
	DESIGN DEVELOPMENT	12.04.20	
	95% OWNER REVIEW	09.24.21	
	100% PERMIT, BID AND CONSTRUCTION	11.08.21	

DESIGNER: RLG
DRAWN BY: RLG
CHECKED BY: RLG
ISSUE DATE: 11/08/21
APPROVED BY: RLG
APPROVAL DATE:

DIRECTOR
of
HOUSTON AIRPORT SYSTEM

Review/ Approval Category	<p style="font-size: x-small;">LARKIN GENTRY 97304 LICENSED PROFESSIONAL ENGINEER E&C Engineers & Consultants Inc. Texas Firm Registration No: 140006 Larkin Gentry 2021.11.04 14:24:10-05:00</p>
Approved For Construction	

SHEET NAME: ELECTRICAL PLAN - AREA A

SHEET No. E100 **SCALE:** As Indicated


SHEET SIZE: 22"x34" ANSI-D

GENERAL NOTES:


- A. RE: E000 FOR MORE GENERAL NOTES, SYMBOLS, AND ABBREVIATIONS.
- B. REMOVE ALL ABANDONED BRANCH CIRCUITING BACK TO NEAREST JUNCTION BOX TO REMAIN OR BACK TO PANEL SERVING. IF CIRCUIT IS NOT REUSED TURN BREAKER OFF AND LABEL SPARE.
- C. ALL CIRCUIT INFORMATION IS BASED OF EXISTING DRAWNIGS. FIELD CONFIRM ALL CIRCUITING PRIOR TO STARTING WORK.
- D. ALL LIGHTING IS EXISTING TO REMAIN UNLESS NOTED OTHERWISE.
- E. ALL WIRING IS #12 AWG UNLESS NOTED OTHERWISE.
- F. ALL RECEPTACLES ARE AT 18" A.F.F. UNLESS NOTED OTHERWISE.
- G. REFER TO APPLICABLE SERIES DRAWINGS FOR ALL REQUIRED DIVISION 26 RELATED WORK PERTAINING TO THE TELECOMMUNICATIONS, AUDIO/VIDEO, AND SECURITY SYSTEM SYSTEMS. REFER TO APPLICABLE SPECIFICATIONS AS NOTED ON THESE DRAWINGS FOR ADDITIONAL REQUIRED DIVISION 26 RELATED WORK. REQUIRED DIVISION 26 WORK SHALL INCLUDE, BUT IS NOT LIMITED TO, THE INSTALLATION OF BACK BOXES, SPECIALTY BACK BOXES, VOICE/DATA OUTLET ROUGH-INS, CONDUITS, CABLE TRAYS, CONDUIT SLEEVES, FLOOR BOXES, GROUNDING SYSTEM COMPONENTS, CARD READER ROUGH-INS, DOOR POSITION SWITCH ROUGH-INS, ELECTRIC POWER TRANSFER ROUGH-INS, CAMERA ROUGH- INS, ETC. THE EXACT LOCATIONS AND REQUIREMENTS OF SUCH WORK SHALL BE COORDINATED WITH THE APPLICABLE DIVISION.
- H. RE: ARCHITECTURAL DRAWINGS FOR ALL MOUNTING HEIGHTS.

DRAWING NOTES:


- ① REMOVE ALL EXISTING RECEPTACLES, DATA OUTLETS, AND OTHER WALL OR FLOOR MOUNTED POWER. DISPOSE OF AS DIRECTED BY OWNER.
- ② EXISTING DATA/ELECTRICAL ON EXISTING WALL. DEMO DATA BACK TO SOURCE.
- ③ DEMO POWER/DATA STRIP ANCHORED TO FLOOR.
- ④ POWER FOR LED LOGO.
- ⑤ ALL CABLING UNDER COUNTER SHALL BE IN RACEWAY. ELECTRICAL POWER SHALL BE IN EMT OR FLEXIBLE METAL CONDUIT BOTH WITH INSULATED THROATS.
- ⑥ POWER AND DATA FOR DISPLAY WALL. COORDINATE DATA ROUGH-IN WITH AV/IT DRAWINGS. POWER SHALL BE DUPLEX RECEPTACLE MOUNTED BEHIND WALL. COORDINATE FINAL LOCATION WITH WALL AND AV/IT DRAWINGS.
- ⑦ DATA OUTLET. REFER TO TELECOMMUNICATIONS CONSULTANTS DRAWINGS FOR ROUGH-IN.
- ⑧ DUPLEX RECEPTACLE. PROVIDE 3/4" C FOR POWER FROM NEAREST ACCESSIBLE CEILING, DOWN IN WALL, UNDERSLAB, AND TURNED UP AS SHOWN AT FIRST RECEPTACLE. CONDUIT ABOVE CEILING SHALL BE EMT, CONDUIT IN SLAB OR BELOW GRADE SHALL BE RIGID STEEL, CONDUIT IN INFORMATION KIOSK SHALL BE EMT OR FLEXIBLE METAL CONDUIT. ALL CONDUIT SHALL HAVE INSULATED THROATS.
- ⑨ NEW CONDUIT STUB UP INTO NEW MILLWORK. ROUTE CONDUIT THROUGH MILLWORK TO POWER, DATA, AND LIGHTING OUTLETS AS REQUIRED.
- ⑩ PHONE OUTLET. REFER TO TELECOMMUNICATIONS CONSULTANTS DRAWINGS FOR ROUGH-IN.
- ⑪ COUNTERTOP USB OUTLET FOR TABLET. MOUNT ABOVE COUNTERTOP IN MILLWORK. USB CHARGER DUPLEX RECEPTACLE, 20A, 125V, 2-POLE, 3-WIRE GROUNDING, 5-20R, ONE 3.1 AMP TYPE 'C' USB AND ONE USB TYPE 'A' PORT, WHITE COLOR OR EQUAL BY OTHERS.
- ⑫ CONTINUOUS LED STRIP ACCENT LIGHTING.
- ⑬ LIGHT SWITCH TO CONTROL ACCENT STRIP LIGHT AND LIGHTED SIGNAGE. 120V, 20A, SINGLE POLE.
- ⑭ CONVERT CONDUCTORS TO 4#12, #12G, 3/4" C AT FIRST JUNCTION BOX.

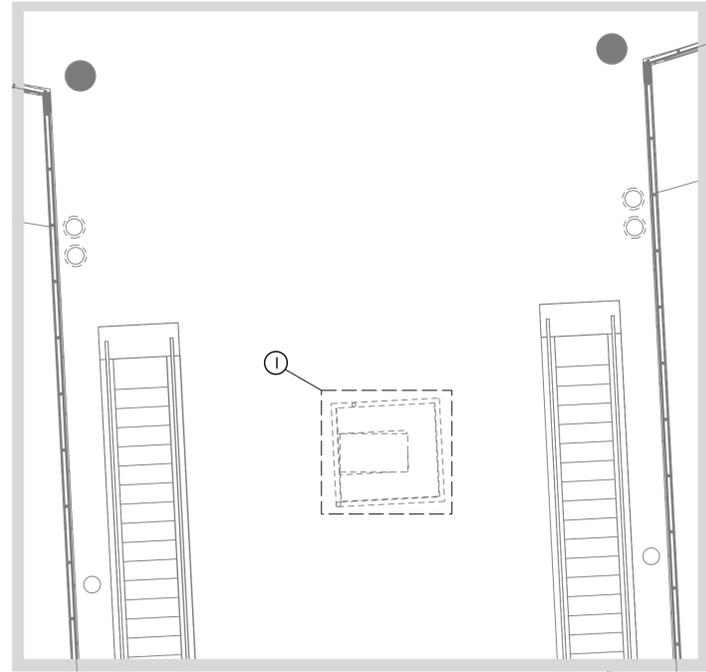


2 ELECTRICAL DEMOLITION PLAN - AREA C
SCALE: 1/8" = 1' - 0"

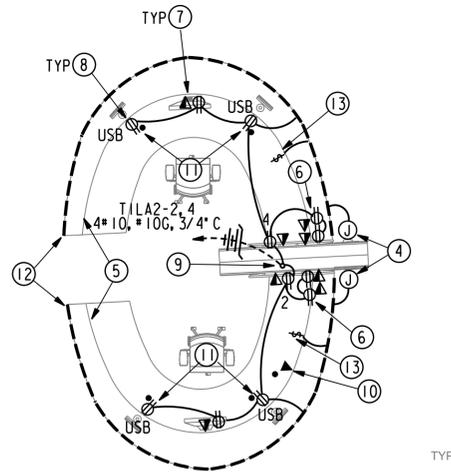


4 ELECTRICAL RENOVATION PLAN - AREA C
SCALE: 1/4" = 1' - 0"

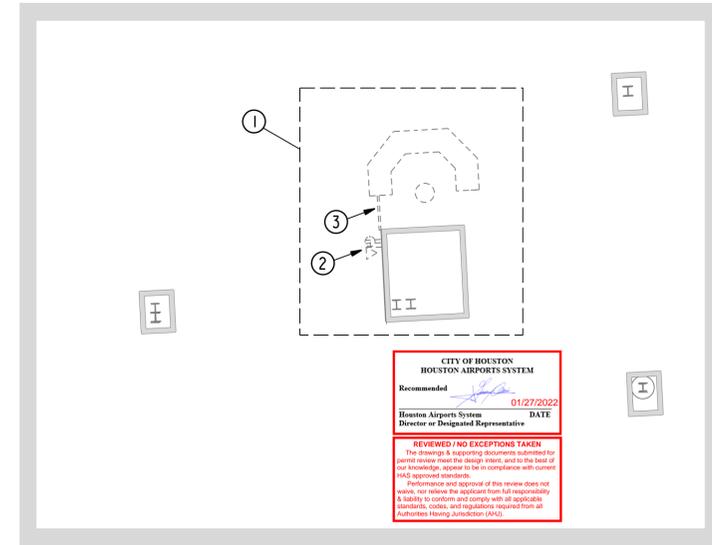

1 ELECTRICAL DEMOLITION PLAN - AREA B
SCALE: 1/8" = 1' - 0"

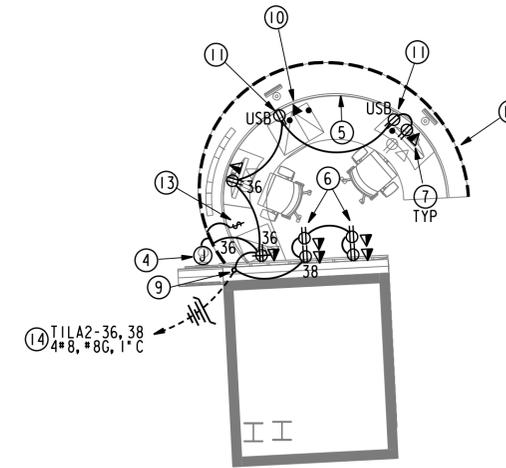

3 ELECTRICAL RENOVATION PLAN - AREA B
SCALE: 1/4" = 1' - 0"

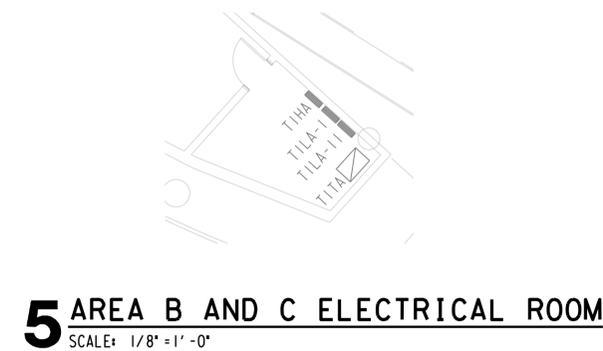

5 AREA B AND C ELECTRICAL ROOM
SCALE: 1/8" = 1' - 0"

RE: E002 FOR ELECTRICAL ROOM LOCATION AND E003 FOR AREA B AND C SCOPE OF WORK



7800 AIRPORT BLVD
HOUSTON, TEXAS 77061
**HOU INFORMATION COUNTER
RENOVATION**

C.I.P. No.	A.I.P. No.
C.O.H. No.	D.O.A. No.

**ENGLISH + ASSOCIATES
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DESIGNER PROJECT No.: 20011.07
PROJECT STATUS: 100% PERMIT, BID CONSTRUCTION

REVISIONS			
No.	DESCRIPTION	DATE	BY
DESIGN DEVELOPMENT		12.04.20	
95% OWNER REVIEW		09.24.21	
100% PERMIT, BID AND CONSTRUCTION		11.08.21	

DESIGNER:	RLG
DRAWN BY:	RLG
CHECKED BY:	RLG
ISSUE DATE:	11/08/21
APPROVED BY:	RLG
APPROVAL DATE:	

DIRECTOR
of
HOUSTON AIRPORT SYSTEM

Review/ Approval Category

Approved For Construction

EAC Engineers & Consultants Inc.
Texas Firm Registration No: 140006
Larkin Gentry
2021.11.04
14:24:10-05'00"

SHEET NAME: ELECTRICAL PLAN - AREA B AND C

SHEET No. E101 SCALE: As Indicated

SHEET SIZE: 22"x34" ANSI-D


FILE PATH: I:\3800\3822 - HAS Hobby Information\Kishka\MElec\3822 ELECTRICAL AREA D.dgn
 HAS FILE:
 PLOT DATE: 11/14/2021
 DOA DWG FILE:
 OLD DOA No.:

GENERAL NOTES:


- A. RE: E000 FOR MORE GENERAL NOTES, SYMBOLS, AND ABBREVIATIONS.
- B. REMOVE ALL ABANDONED BRANCH CIRCUITING BACK TO NEAREST JUNCTION BOX TO REMAIN OR BACK TO PANEL SERVING. IF CIRCUIT IS NOT REUSED TURN BREAKER OFF AND LABEL SPARE.
- C. ALL CIRCUIT INFORMATION IS BASED OF EXISTING DRAWINGS. FIELD CONFIRM ALL CIRCUITING PRIOR TO STARTING WORK.
- D. ALL LIGHTING IS EXISTING TO REMAIN UNLESS NOTED OTHERWISE.
- E. ALL WIRING IS #12 AWG UNLESS NOTED OTHERWISE.
- F. ALL RECEPTACLES ARE AT 18" A.F.F. UNLESS NOTED OTHERWISE.
- G. REFER TO APPLICABLE SERIES DRAWINGS FOR ALL REQUIRED DIVISION 26 RELATED WORK PERTAINING TO THE TELECOMMUNICATIONS, AUDIO/VIDEO, AND SECURITY SYSTEM SYSTEMS. REFER TO APPLICABLE SPECIFICATIONS AS NOTED ON THESE DRAWINGS FOR ADDITIONAL REQUIRED DIVISION 26 RELATED WORK. REQUIRED DIVISION 26 WORK SHALL INCLUDE, BUT IS NOT LIMITED TO, THE INSTALLATION OF BACK BOXES, SPECIALTY BACK BOXES, VOICE/DATA OUTLET ROUGH-INS, CONDUITS, CABLE TRAYS, CONDUIT SLEEVES, FLOOR BOXES, GROUNDING SYSTEM COMPONENTS, CARD READER ROUGH-INS, DOOR POSITION SWITCH ROUGH-INS, ELECTRIC POWER TRANSFER ROUGH-INS, CAMERA ROUGH-INS, ETC. THE EXACT LOCATIONS AND REQUIREMENTS OF SUCH WORK SHALL BE COORDINATED WITH THE APPLICABLE DIVISION.
- H. RE: ARCHITECTURAL DRAWINGS FOR ALL MOUNTING HEIGHTS.

DRAWING NOTES:


- ① EXISTING FLIGHT INFORMATION DISPLAY TO REMAIN & BE PROTECTED DURING CONSTRUCTION. ALL POWER AND DATA IS EXISTING TO REMAIN.
- ② PROVIDE POWER J-BOX FOR LED ILLUMINATED SIGNAGE LOGO AND LETTERS. COORDINATE JUNCTION BOX LOCATION WITH SIGNAGE PROVIDED AND MAKE CONNECTION TO ILLUMINATE SIGNAGE AS REQUIRED. PROVIDE ALL PARTS AND PIECES AS REQUIRED FOR A COMPLETE AND WORKING SYSTEM. CIRCUIT SHALL BE ROUTED THROUGH FURNITURE FEED POKE THROUGH.
- ③ ALL CABLING UNDER COUNTER SHALL BE IN RACEWAY. ELECTRICAL POWER SHALL BE IN EMT OR FLEXIBLE METAL CONDUIT BOTH WITH INSULATED THROATS.
- ④ NEW CONDUIT STUB UP INTO NEW MILLWORK. ROUTE CONDUIT THROUGH MILLWORK TO POWER, DATA, AND LIGHTING OUTLETS AS REQUIRED.
- ⑤ POWER AND DATA FOR DISPLAY WALL. COORDINATE DATA ROUGH-IN WITH AV/IT DRAWINGS. POWER SHALL BE DUPLEX RECEPTACLE MOUNTED BEHIND WALL. COORDINATE FINAL LOCATION WITH WALL AND AV/IT DRAWINGS. CIRCUIT FOR WALL SHALL BE ROUTED THROUGH FURNITURE FEED POKE THROUGH.
- ⑥ DATA OUTLET. REFER TO TELECOMMUNICATIONS CONSULTANTS DRAWINGS FOR ROUGH-IN.
- ⑦ COUNTERTOP USB OUTLET FOR TABLET. MOUNT ABOVE COUNTERTOP IN MILLWORK. USB CHARGER DUPLEX RECEPTACLE, 20A, 125V, 2-POLE, 3-WIRE GROUNDING, 5-20R, ONE 3.1 AMP TYPE 'C' USB AND ONE USB TYPE 'A' PORT, WHITE COLOR OR EQUAL BY OTHERS.
- ⑧ CONTINUOUS LED STRIP ACCENT LIGHTING.
- ⑨ CONVERT CONDUCTORS TO 4#12, #12G, 3/4" C AT FIRST JUNCTION BOX.

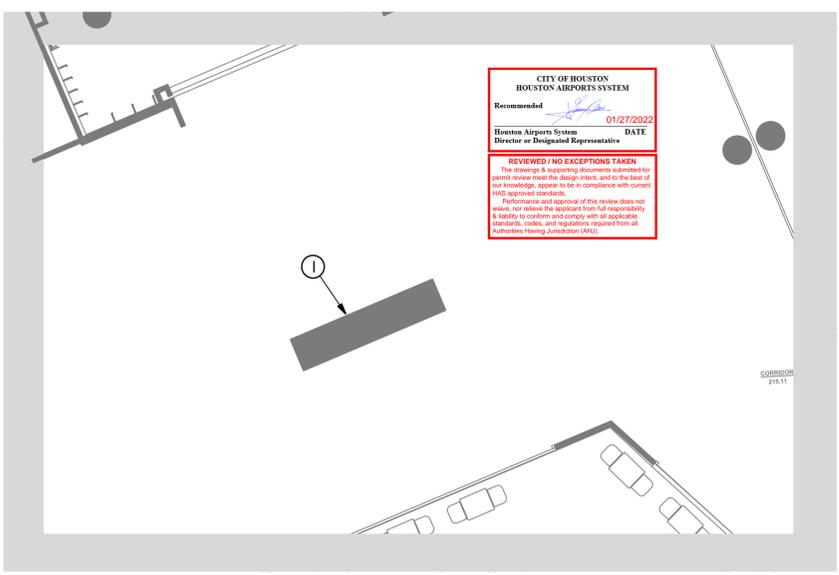

1 ELECTRICAL DEMOLITION PLAN - AREA D
 SCALE: 1/8" = 1' - 0"

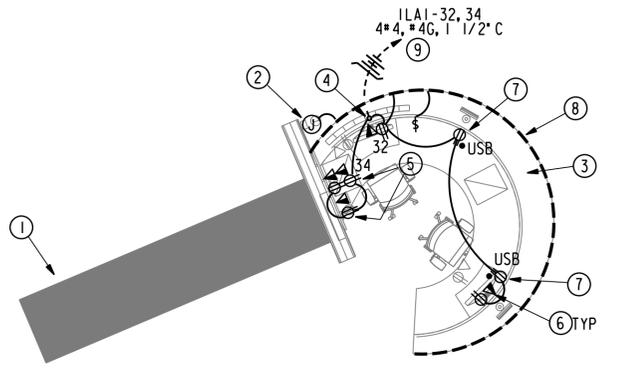

2 ELECTRICAL RENOVATION PLAN - AREA D
 SCALE: 1/4" = 1' - 0"

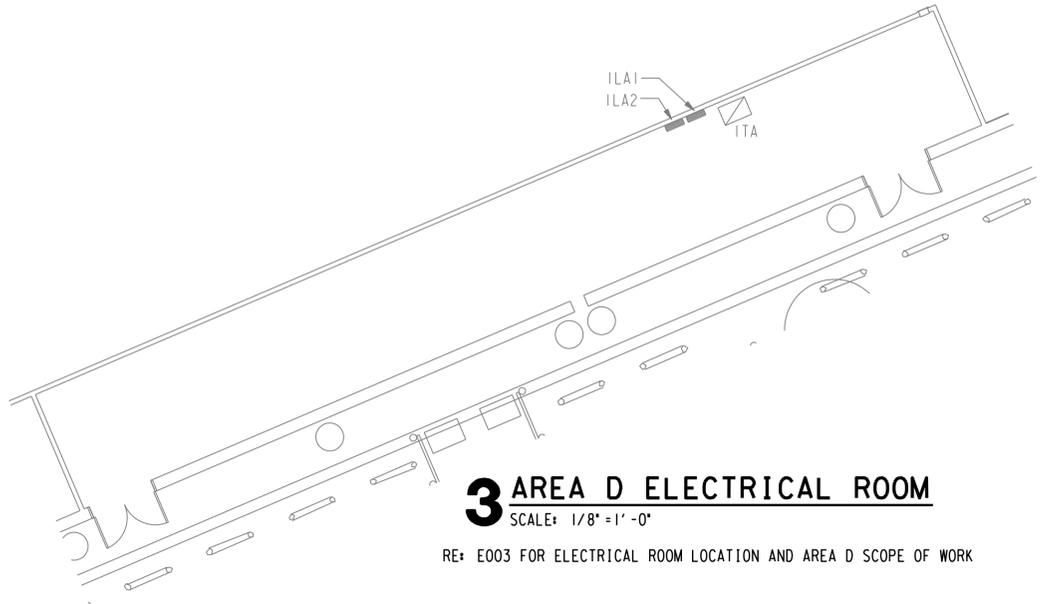

3 AREA D ELECTRICAL ROOM
 SCALE: 1/8" = 1' - 0"
 RE: E003 FOR ELECTRICAL ROOM LOCATION AND AREA D SCOPE OF WORK

HOUSTON AIRPORTS

7800 AIRPORT BLVD
 HOUSTON, TEXAS 77061

**HOU INFORMATION COUNTER
 RENOVATION**

C.I.P. No.	A.I.P. No.
C.O.H. No.	D.O.A No.



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 713.850.0411 F
 www.english-architects.com

DESIGNER PROJECT No.: 20011.07
PROJECT STATUS: 100% PERMIT, BID CONSTRUCTION

REVISIONS

No.	DESCRIPTION	DATE	BY
	DESIGN DEVELOPMENT	12.04.20	
	95% OWNER REVIEW	09.24.21	
	100% PERMIT, BID AND CONSTRUCTION	11.08.21	

DESIGNER: RLG
DRAWN BY: RLG
CHECKED BY: RLG
ISSUE DATE: 11/08/21
APPROVED BY: RLG
APPROVAL DATE:

DIRECTOR
 of
 HOUSTON AIRPORT SYSTEM

Review/ Approval Category	 E&C Engineers & Consultants Inc. Texas Firm Registration No: 140006 Larkin Gentry 2021.11.04 14:24:10-05'00"
Approved For Construction	

SHEET NAME: ELECTRICAL PLAN - AREA D

SHEET No. E102 **SCALE:** As Indicated

SHEET SIZE: 22"x34" ANSI-D

PLOT DATE: 1/14/2021
 DOA DWG FILE:
 OLD DOA No.:
 HAS FILE:
 FILE PATH: I:\3800\3822 - HAS Hobby Information Kiosks\MElec\3822_ER\SEER.dgn

Panel		TILT2 (EXISTING)(NORMAL POWER)		Project -		HOU INFORMATION COUNTER RENOVATION				
Location -		RM 101.39		E&C No.		3822				
Panel Information	Panel Loads	Phase A	Phase B	Phase C	Total					
Voltage	120/208V, 3P, 4W	Panel Lighting VA	0	0	0					
Panel Type	Panelboard	Panel Receptacle VA	0	0	0					
Bus Amps	100A, 100% Neutral	Panel Equipment VA	1020	0	2220	3240				
Bus Type	Copper/10,000AIC	FTL VA	0	0	0	0				
Panel Mains	100/3 MCB	Total Connected VA	1020	0	2220	3240				
Breaker Mtg	Bolt-In	Total Connected Amps	9	0	19	9				
Enclosure	NEMA 1 Surface	NEC VA	1020	0	2220	3240				
Accessories	Ground Bus	NEC Amps	9	0	19	9				
Ckt.	Bkr.	Circuit Use	Load	Type	Ph.	Ckt.	Bkr.	Circuit Use	Load	Type
1	20/1	EXISTING CIRCUIT			A	2	20/1	EXISTING CIRCUIT		
3	15/1	EXISTING CIRCUIT			B	4	20/1	EXISTING CIRCUIT		
5	20/1	HTOWN INFO KIOSK	1200	1	C	6	20/1	EXISTING CIRCUIT		
7	20/1	HTOWN INFO KIOSK	1020	1	A	8		SPACE		
9	20/1	EXISTING CIRCUIT			B	10	20/1	EXISTING CIRCUIT		
11	15/2	EXISTING CIRCUIT			C	12	40/2	EXISTING CIRCUIT		
13	--	--			A	14	--	--		
15	15/2	EXISTING CIRCUIT			B	16		SPACE		
17	--	--			C	18	20/1	EXISTING CIRCUIT		
19	20/1	EXISTING CIRCUIT			A	20	20/1	EXISTING CIRCUIT		
21	20/1	EXISTING CIRCUIT			B	22	20/1	EXISTING CIRCUIT		
23	20/1	HTOWN INFO KIOSK	1020	1	C	24		SPACE		
25	15/1	EXISTING CIRCUIT			A	26	20/1	EXISTING CIRCUIT		
27	20/1	EXISTING CIRCUIT			B	28	20/1	EXISTING CIRCUIT		
29	15/1	EXISTING CIRCUIT			C	30	20/1	EXISTING CIRCUIT		
31	20/1	SPARE			A	32	20/1	EXISTING CIRCUIT		
33	20/1	SPARE			B	34	20/1	EXISTING CIRCUIT		
35	20/1	EXISTING CIRCUIT			C	36	20/1	EXISTING CIRCUIT		
37	--	--			A	38	20/1	EXISTING CIRCUIT		
39	60/3	EXISTING CIRCUIT			B	40		SPACE		
41	--	--			C	42	20/1	EXISTING CIRCUIT		

Load Types: 0 = Recept (per NEC), 1 = Equip. (100%), 2 = Lighting (125%), 3 = A/C (100%), 4 = Heating (100%), 5 = Lght. Motor (125%), 6 = Kitchen Equip. (per NEC)

Notes:

Panel		TILA-II (EXISTING)(NORMAL POWER)		Project -		HOU INFORMATION COUNTER RENOVATION				
Location -				E&C No.		3822				
Panel Information	Panel Loads	Phase A	Phase B	Phase C	Total					
Voltage	120/208V, 3P, 4W	Panel Lighting VA	0	0	0					
Panel Type	Panelboard	Panel Receptacle VA	0	0	0					
Bus Amps	225A, 100% Neutral	Panel Equipment VA	2520	1500	1432	5452				
Bus Type	Copper/10,000AIC	FTL VA	0	0	0	0				
Panel Mains	225A MLO	Total Connected VA	2520	1500	1432	5452				
Breaker Mtg	Bolt-In	Total Connected Amps	21	13	12	15				
Enclosure	NEMA 1 Surface	NEC VA	2520	1500	1432	5452				
Accessories	Ground Bus	NEC Amps	21	13	12	15				
Ckt.	Bkr.	Circuit Use	Load	Type	Ph.	Ckt.	Bkr.	Circuit Use	Load	Type
1	20/1	EXISTING CIRCUIT			A	2	20/1	AREA C INFORMATION KIOSK	1500	1
3	20/1	EXISTING CIRCUIT			B	4	20/1	AREA C INFORMATION KIOSK	1500	1
5	20/1	EXISTING CIRCUIT			C	6	20/1	SPARE		
7	20/1	EXISTING CIRCUIT			A	8	20/1	SPARE		
9	20/1	EXISTING CIRCUIT			B	10	20/1	EXISTING CIRCUIT		
11	20/1	EXISTING CIRCUIT			C	12	20/1	EXISTING CIRCUIT		
13	20/1	EXISTING CIRCUIT			A	14	20/1	EXISTING CIRCUIT		
15	20/1	EXISTING CIRCUIT			B	16	20/1	EXISTING CIRCUIT		
17	20/1	EXISTING CIRCUIT			C	18	20/1	EXISTING CIRCUIT		
19	20/1	EXISTING CIRCUIT			A	20	20/1	EXISTING CIRCUIT		
21	20/1	EXISTING CIRCUIT			B	22	20/1	EXISTING CIRCUIT		
23	20/1	EXISTING CIRCUIT			C	24	20/1	EXISTING CIRCUIT		
25	20/1	EXISTING CIRCUIT			A	26	20/1	EXISTING CIRCUIT		
27	20/1	EXISTING CIRCUIT			B	28	20/1	EXISTING CIRCUIT		
29	20/1	EXISTING CIRCUIT			C	30	20/1	EXISTING CIRCUIT		
31	20/1	EXISTING CIRCUIT			A	32	20/1	EXISTING CIRCUIT		
33	20/1	EXISTING CIRCUIT			B	34	20/1	EXISTING CIRCUIT		
35	20/1	EXISTING CIRCUIT			C	36	20/1	AREA B INFORMATION KIOSK	1432	1
37	20/1	EXISTING CIRCUIT			A	38	20/1	AREA B INFORMATION KIOSK	1020	1
39	20/1	EXISTING CIRCUIT			B	40	20/1	EXISTING CIRCUIT		
41	20/1	EXISTING CIRCUIT			C	42	20/1	EXISTING CIRCUIT		


Load Types: 0 = Recept (per NEC), 1 = Equip. (100%), 2 = Lighting (125%), 3 = A/C (100%), 4 = Heating (100%), 5 = Lght. Motor (125%), 6 = Kitchen Equip. (per NEC)

Notes:


Panel		1LA1 (EXISTING)(NORMAL POWER)		Project -		HOU INFORMATION COUNTER RENOVATION				
Location -		ELECTRICAL ROOM 115.04		E&C No.		3822				
Panel Information	Panel Loads	Phase A	Phase B	Phase C	Total					
Voltage	120/208V, 3P, 4W	Panel Lighting VA	0	0	0					
Panel Type	Panelboard	Panel Receptacle VA	0	0	0					
Bus Amps	225A, 100% Neutral	Panel Equipment VA	1120	690	0	1810				
Bus Type	Copper/10,000AIC	FTL VA	0	0	0	0				
Panel Mains	225/3 MCB	Total Connected VA	1120	690	0	1810				
Breaker Mtg	Bolt-In	Total Connected Amps	9	6	0	5				
Enclosure	NEMA 1 Surface	NEC VA	1120	690	0	1810				
Accessories	Ground Bus	NEC Amps	9	6	0	5				
Ckt.	Bkr.	Circuit Use	Load	Type	Ph.	Ckt.	Bkr.	Circuit Use	Load	Type
1	20/1	EXISTING CIRCUIT			A	2	20/1	EXISTING CIRCUIT		
3	20/1	EXISTING CIRCUIT			B	4	20/1	EXISTING CIRCUIT		
5	20/1	EXISTING CIRCUIT			C	6	20/1	EXISTING CIRCUIT		
7	20/1	EXISTING CIRCUIT			A	8	20/1	EXISTING CIRCUIT		
9	20/1	EXISTING CIRCUIT			B	10	20/1	EXISTING CIRCUIT		
11	20/1	EXISTING CIRCUIT			C	12	20/1	EXISTING CIRCUIT		
13	20/1	EXISTING CIRCUIT			A	14	20/1	EXISTING CIRCUIT		
15	20/1	EXISTING CIRCUIT			B	16	20/1	EXISTING CIRCUIT		
17	20/1	EXISTING CIRCUIT			C	18	20/1	EXISTING CIRCUIT		
19	20/1	EXISTING CIRCUIT			A	20	20/1	EXISTING CIRCUIT		
21	20/1	EXISTING CIRCUIT			B	22	20/1	EXISTING CIRCUIT		
23	20/1	EXISTING CIRCUIT			C	24	20/1	EXISTING CIRCUIT		
25	20/1	EXISTING CIRCUIT			A	26	20/1	EXISTING CIRCUIT		
27	20/1	EXISTING CIRCUIT			B	28	20/1	EXISTING CIRCUIT		
29	20/1	EXISTING CIRCUIT			C	30	20/1	EXISTING CIRCUIT		
31	20/1	EXISTING CIRCUIT			A	32	20/1	AREA D INFORMATION KIOSK	1120	1
33	20/1	EXISTING CIRCUIT			B	34	20/1	AREA D INFORMATION KIOSK	690	1
35	20/1	SPARE			C	36	20/1	SPARE		
37	20/1	SPARE			A	38	20/1	SPARE		
39	20/1	SPARE			B	40	20/1	SPARE		
41	20/1	SPARE			C	42	20/1	SPARE		

Load Types: 0 = Recept (per NEC), 1 = Equip. (100%), 2 = Lighting (125%), 3 = A/C (100%), 4 = Heating (100%), 5 = Lght. Motor (125%), 6 = Kitchen Equip. (per NEC)


Notes:

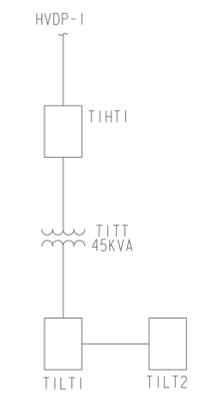

1 AREA A PARTIAL ONE-LINE DIAGRAM
NOT TO SCALE

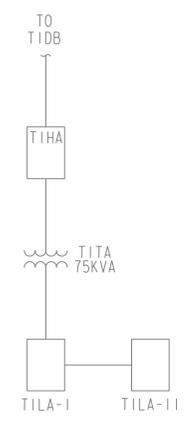

2 AREA B AND C PARTIAL ONE-LINE DIAGRAM
NOT TO SCALE

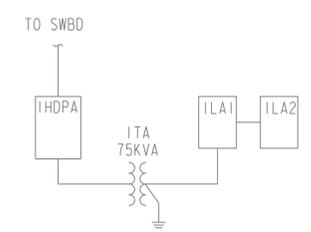

3 AREA D PARTIAL ONE-LINE DIAGRAM
NOT TO SCALE

CITY OF HOUSTON
HOUSTON AIRPORTS SYSTEM
Recommended: 01/27/2022
Houston Airports System
Director or Designated Representative DATE

REVIEWED / NO EXCEPTIONS TAKEN
The drawings & supporting documents submitted for permit review meet the design intent, and to the best of our knowledge, appear to conform with current HAS approved standards.
Performance and approval of this review does not waive, nor release the applicant from full responsibility & liability to conform and comply with all applicable standards, codes, and regulations required from all Authorities Having Jurisdiction (AHJ).

7800 AIRPORT BLVD
HOUSTON, TEXAS 77061

HOU INFORMATION COUNTER RENOVATION

C.I.P. No. A.I.P. No.
C.O.H. No. D.O.A. No.

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DESIGNER PROJECT No.: 20011.07
PROJECT STATUS: 100% PERMIT, BID CONSTRUCTION

REVISIONS

No.	DESCRIPTION	DATE	BY
	DESIGN DEVELOPMENT	12.04.20	
	95% OWNER REVIEW	09.24.21	
	100% PERMIT, BID AND CONSTRUCTION	11.08.21	

DESIGNER: RLG
DRAWN BY: RLG
CHECKED BY: RLG
ISSUE DATE: 11/08/21
APPROVED BY: RLG
APPROVAL DATE:

DIRECTOR of HOUSTON AIRPORT SYSTEM

Review/ Approval Category

Approved For Construction

Larkin Gentry
2021.11.04
14:24:10-05'00"

SHEET NAME: ELECTRICAL SCHEDULES AND RISERS

SHEET No. E200 SCALE: As Indicated

SHEET SIZE: 22"x34" ANSI-D

A

B

C

D

TECHNOLOGY EQUIPMENT SYMBOLS LIST	
SYMBOL	DESCRIPTION
HDMI-R	HDMI RECEIVER
HDMI-T	HDMI TRANSMITTER
FOPP	FIBER OPTIC PATCH PANEL
FOT	FIBER OPTIC TRANSMITTER
FOR	FIBER OPTIC RECEIVER
CPP	COPPER PATCH PANEL
CP	CURTESY PHONE
HH	HAND HOLE
LED	LED DISPLAY PANEL
MATV	MAINTENANCE HOLE
MH	MAINTENANCE HOLE
NS _O	NETWORK SWITCH (OWNER)
NS _T	NETWORK SWITCH (TENANT)
PB	PULL BOX
PC1	TYPE 1 COMPUTER - DELL 3080 SFF
PC2	TYPE 2 COMPUTER
TP1	TYPE 1 TOUCH PANEL - IPAD
X	X-CAT6 TERMINATION JACK WHERE X REPRESENTS QUANTITY OF CAT6 CABLES. FIELD COORDINATE EXACT PLACEMENT WITH OTHER TRADE.
4	EXAMPLE: 4-CAT6 WITH 4-PORT WALL PLATE, 15" A.F.F.
X _Y	CAT 6 TERMINATION JACK. X=CONFIGURATION. Y=QTY OF CAT 6 CABLES. PROVIDE PATCH CORD FOR EACH CONNECTED PORT.
TV	TV OUTLET (1 RG-6 CABLE)
AV	HDMI WITH 2 AUDIO JACKS. INCLUDE PLENUM HDMI AND 2 AUDIO CABLE FROM JACK TO AV SOURCE WITHIN ROOM.
W	1 CAT 6 WITH PLATE FOR WALL MOUNTED PHONE, 45" A.F.F.
B	BLANK WALL PLATE
X	X CAT 6 CABLE (FLOOR OUTLET)
WAP	WIRELESS ACCESS POINT, 2 CAT 6A CABLES
AW	ALL WEATHER OUTDOOR PHONE, 1 CAT 6

TECHNOLOGY EQUIPMENT SYMBOLS LIST	
SYMBOL	DESCRIPTION
○	CONDUIT TURNING UP
●	CONDUIT TURNING DOWN
┌	TERMINATING CONDUIT. PROVIDE GROUND LUG AND INSULATED THROAT BUSHING.
—	EXPOSED CONDUIT
—	CONCEALED CONDUIT
—	ARIEL CABLE
FPC	FLIGHT INFORMATION DISPLAY PC
HCM	HORIZONTAL CABLE MANAGEMENT
JB	JUNCTION BOX
EX	ETHERNET EXTENDER
SP ₁	AV SPEAKER TYPE 1. MODEL JBL CONTROL 25AV-LS OR EQUAL
SP ₂	AV SPEAKER TYPE 2. MODEL JBL CONTROL 64P/T OR EQUAL
REC	REMOTE EQUIPMENT ENCLOSURE

TECHNOLOGY ABBREVIATIONS	
(E)	EXISTING
GC	GENERAL CONTRACTOR
LEC	LOCAL EXCHANGE CARRIER
MMF	MULTIMODE FIBER
(N)	NEW
NIC	NOT IN CONTRACT
PR	PAIR AS IN COPPER PAIR (CATEGORY 5)
R	RADIUS
SMF	SINGLE MODE FIBER
STP	SHIELDED TWISTED PAIR, 22 AWG
UTP	UNSHIELDED TWISTED PAIR

TECHNOLOGY SHEET LIST	
Sheet Number	Sheet Name
T-001	TECHNOLOGY - INDEX, SYMBOLS & SHEET INDEX
T-002	TECHNOLOGY - GENERAL NOTES
T-101	TECHNOLOGY - REFERENCE PLAN - BAGGAGE CLAIM
T-102	TECHNOLOGY - REFERENCE PLAN - LEVEL 1
T-103	TECHNOLOGY - DEMOLITION PLAN - BAGGAGE CLAIM - AREA A
T-104	TECHNOLOGY - DEMOLITION PLAN - LEVEL 1 - AREA B & C
T-105	TECHNOLOGY - DEMOLITION PLAN - LEVEL 1 - AREA D
T-106	TECHNOLOGY - FLOOR PLAN - BAGGAGE CLAIM - AREA A
T-107	TECHNOLOGY - FLOOR PLAN - LEVEL 1 - AREAS B AND C
T-108	TECHNOLOGY - FLOOR PLAN - LEVEL 1 - AREA D
T-401	TECHNOLOGY - IDF 100.14 ENLARGED PLAN
T-402	TECHNOLOGY - IDF 101.40 ENLARGED PLAN
T-403	TECHNOLOGY - IDF 102.44 ENLARGED PLAN
T-404	TECHNOLOGY - IDF 313.10 ENLARGED PLAN
T-501	TECHNOLOGY - EQUIPMENT DETAILS
T-601	TECHNOLOGY - EQUIPMENT SCHEDULE

CITY OF HOUSTON
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HOU INFORMATION COUNTER RENOVATION

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PGA ENGINEERS, INC
3838 N Sam Houston Pkwy E,
Suite 550
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346.570.2418
pgaengineers.com
TBPE FIRM #12493

DESIGNER PROJECT No.: 2020.017
PROJECT STATUS: 100% PERMIT, BID AND CONSTRUCTION

REVISIONS

No.	DESCRIPTION	DATE	BY
	SCHEMATIC DESIGN	10.23.20	
	DESIGN DEVELOPMENT	12.04.20	
	95% OWNER REVIEW	09.24.21	
	100% PERMIT, BID AND CONSTRUCTION	11.08.21	

DESIGNER: PGA
DRAWN BY: AC
CHECKED BY: JG
ISSUE DATE: 11/08/2021
APPROVED BY: Approver
APPROVAL DATE:

DIRECTOR
of
HOUSTON AIRPORT SYSTEM



TIP NO. # TBD

SHEET NAME: TECHNOLOGY - INDEX, SYMBOLS & SHEET INDEX

SHEET No. T-001 SCALE:
SHEET SIZE: 22"x34" ANSI-D

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HAS FILE:

PLOT DATE:
DOA DWG FILE:
OLD DOA No.:

A

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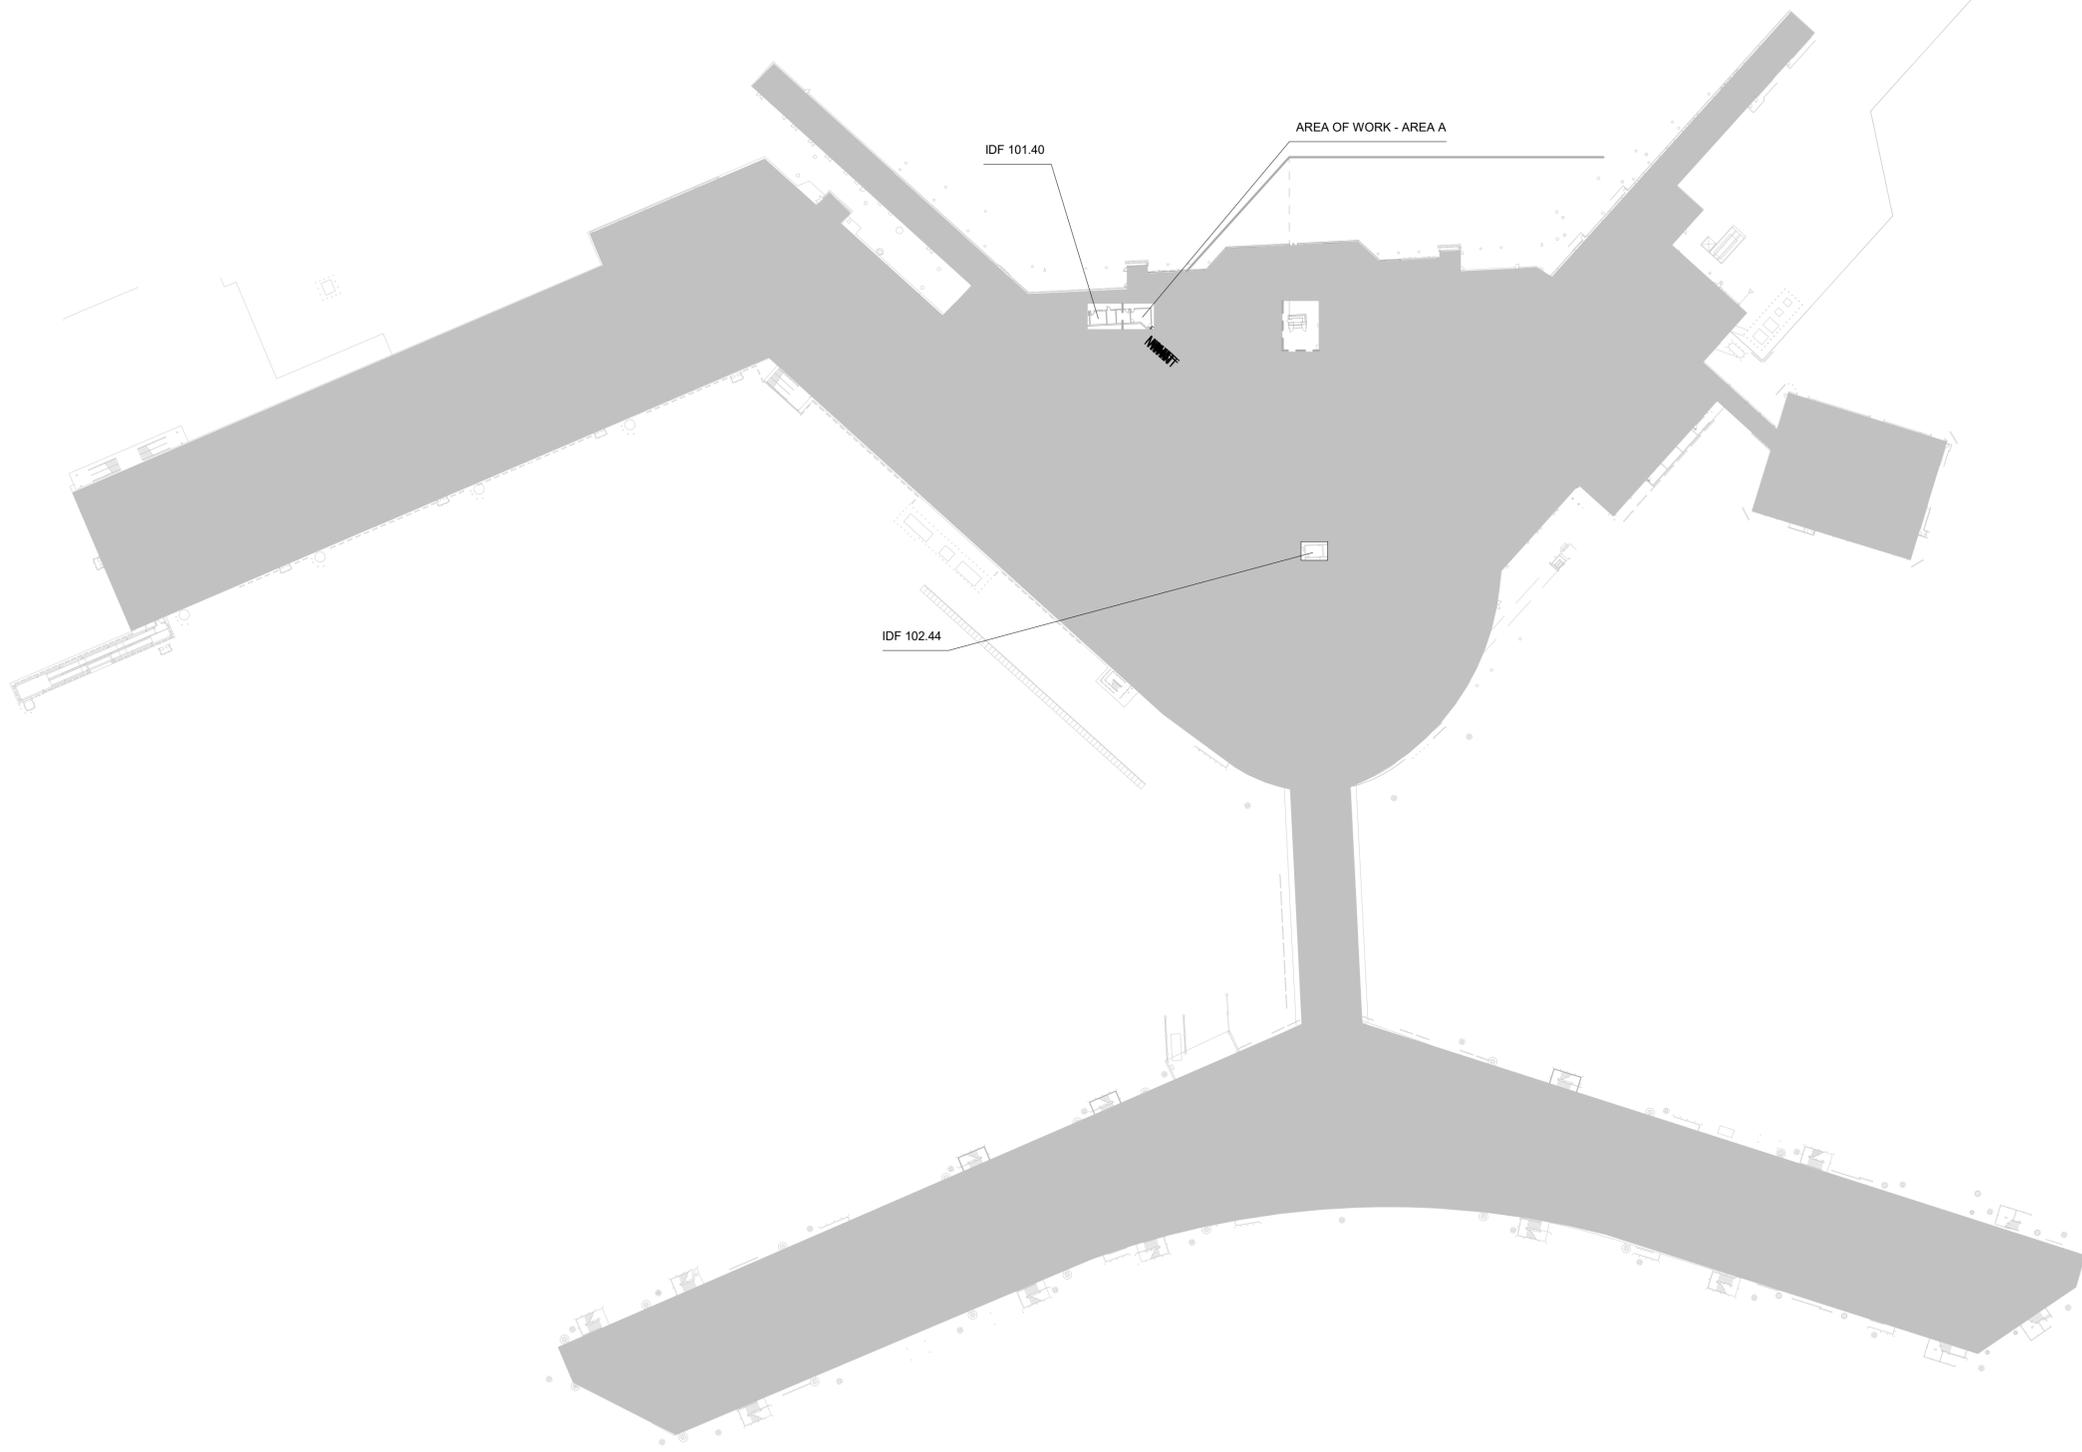
C

D

FILE PATH: C:\Users\acaturana\Desktop\HOU_COUNTER\HOU_COUNTER\HOU_INFO_COUNTER_RENOVATION_acaturana\U75VK_detached.rvt

HAS FILE:

PLOT DATE:
DOA DWG FILE:
OLD DOA No.:



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Director or Designated Representative
01/27/2022
DATE

REVIEWED: NO EXCEPTIONS TAKEN
The drawings & supporting documents submitted for permit review meet the design intent, and to the best of our knowledge, appear to be in compliance with current HAS approved standards.
Performance and approval of this review does not waive, nor relieve the applicant from full responsibility & liability to conform and comply with all applicable standards, codes, and regulations required from all Authorities Having Jurisdiction (AHJ).



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DESIGNER: PGA
DRAWN BY: AC
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ISSUE DATE: 11/08/2021
APPROVED BY: Approver
APPROVAL DATE:

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BAGGAGE CLAIM - REFERENCE PLAN SCALE: 1" = 80'-0" A1 1

1. CONTRACTOR TO COORDINATE ALL TECHNOLOGY DEVICE REMOVALS WITH HAS TECHNOLOGY DIVISION PRIOR TO REMOVAL. SALVAGE ALL EXISTING IT EQUIPMENT AND TURN OVER TO HAS IT.

GENERAL NOTES KEYED NOTES



TIP NO. # TBD
SHEET NAME: TECHNOLOGY - REFERENCE PLAN - BAGGAGE CLAIM
SHEET No. T-101 SCALE: 1" = 80'-0"
SHEET SIZE: 22"x34" ANSI-D


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 HAS FILE:
 PLOT DATE:
 DOA DWG FILE:
 OLD DOA No.:

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CITY OF HOUSTON
HOUSTON AIRPORTS SYSTEM

Recommended
 Houston Airports System Director or Designated Representative

DATE: 01/27/2022

REVIEWED / NO EXCEPTIONS TAKEN
 The drawings & supporting documents submitted for permit review meet the design intent, and to the best of our knowledge, appear to be in compliance with current H&S approved standards.
 Performance and approval of this review does not waive, nor release the applicant from full responsibility & liability to conform and comply with all applicable standards, codes, and regulations required from all Authorities Having Jurisdiction (AHJ).
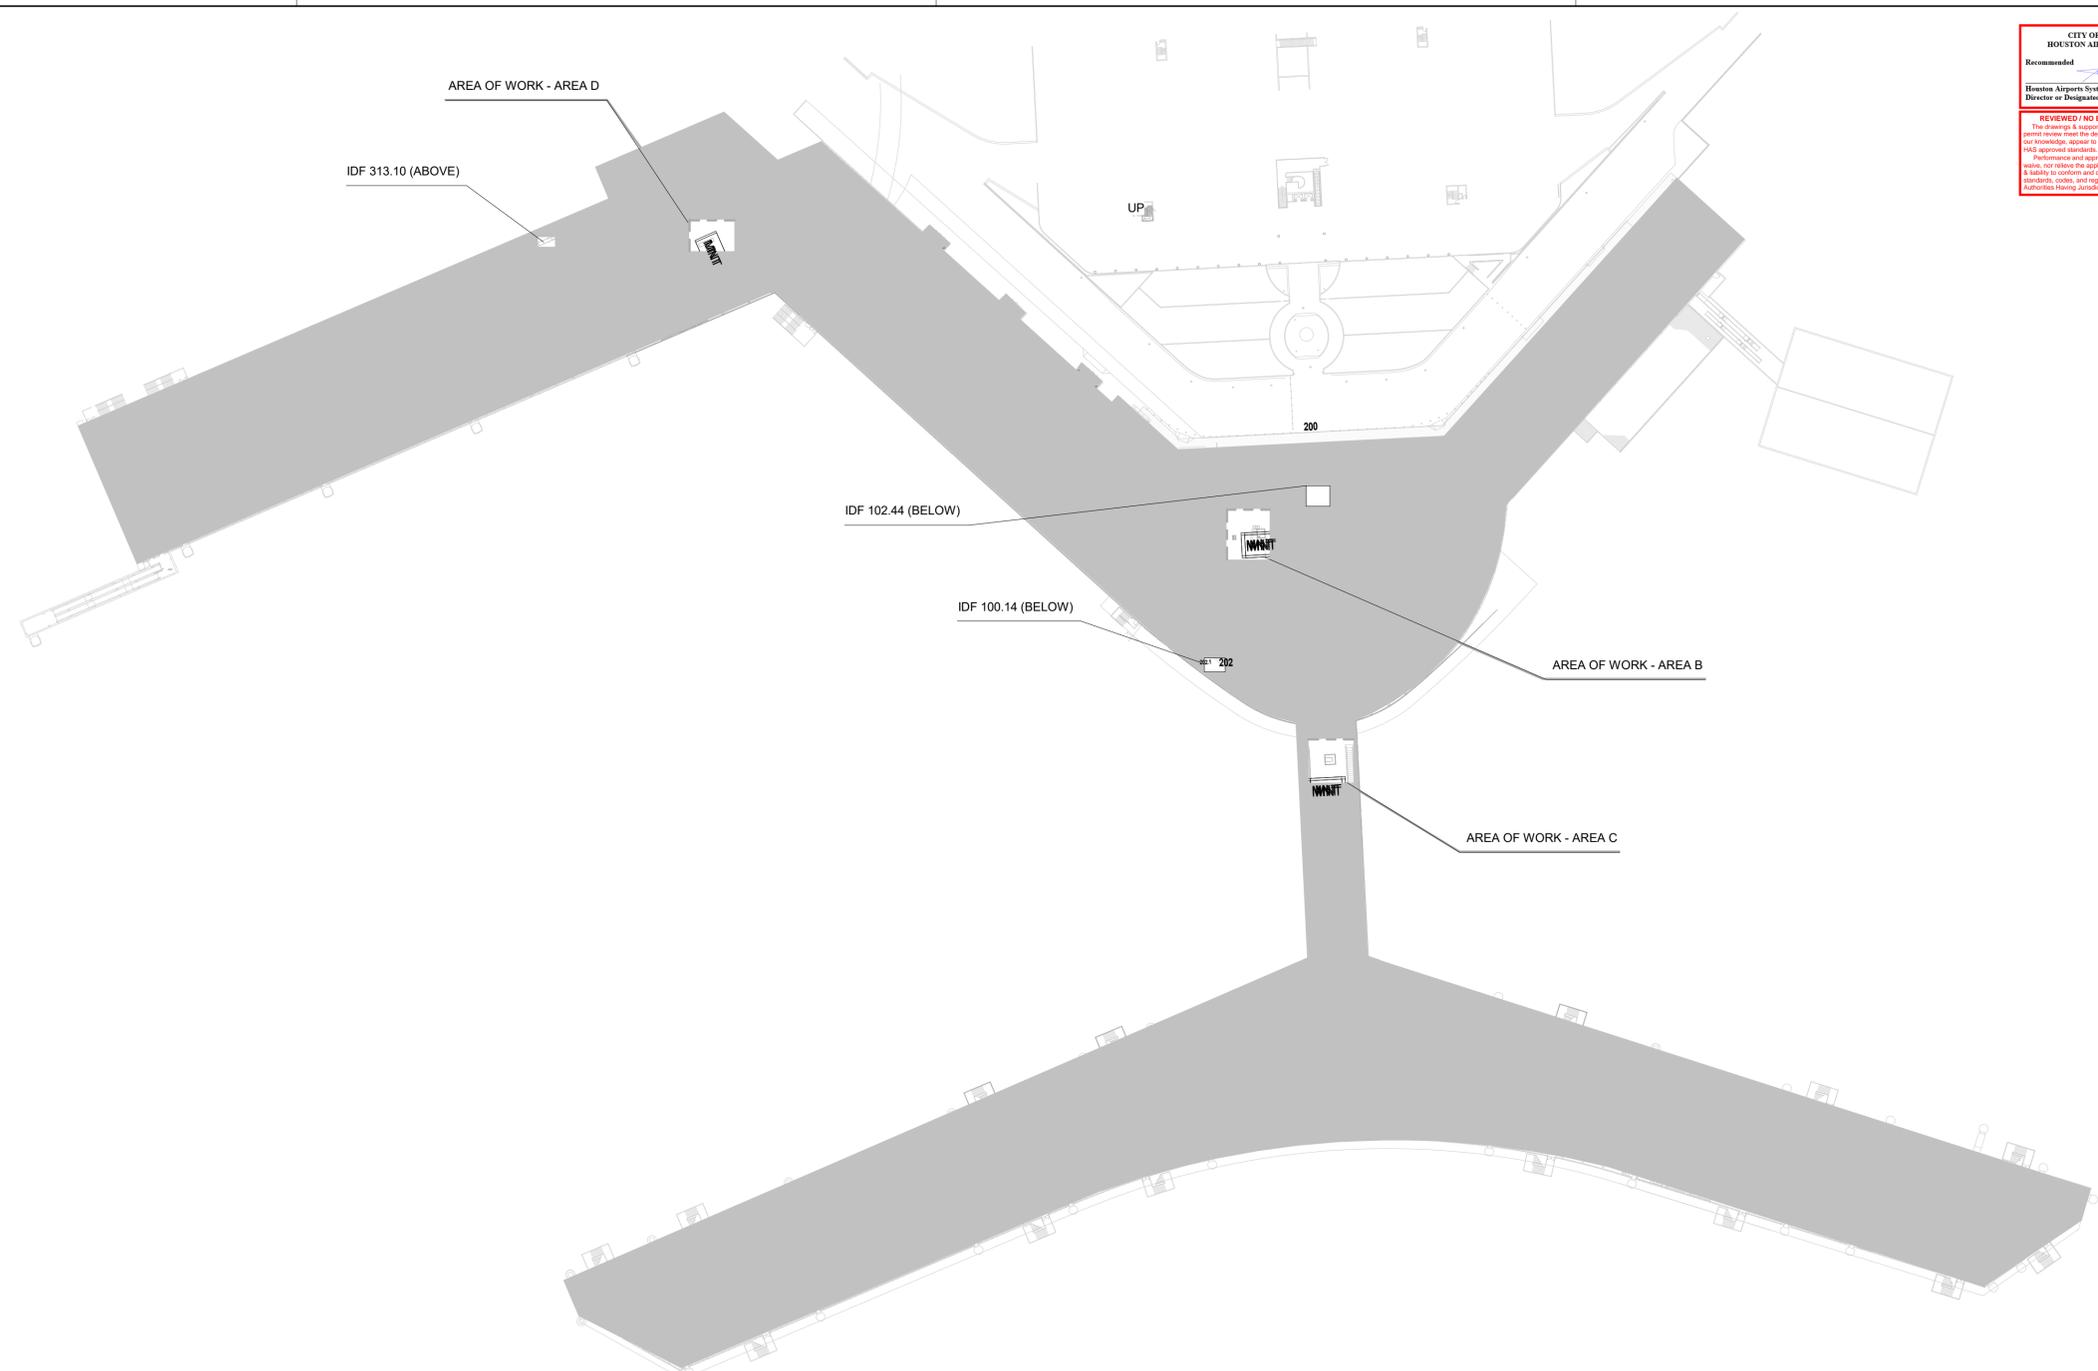
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DESIGNER: PGA
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APPROVAL DATE:

DIRECTOR
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HOUSTON AIRPORT SYSTEM

<p>Review Approval Category</p> <p>IFP</p> <p>ISSUED FOR PERMIT</p> <p>Approved For Construction</p>	
---	--

LVL 1 - FLOOR PLAN REFERENCE SCALE: 1" = 80'-0" A1

1. CONTRACTOR TO COORDINATE ALL TECHNOLOGY DEVICE REMOVALS WITH HAS TECHNOLOGY DIVISION PRIOR TO REMOVAL. SALVAGE ALL EXISTING IT EQUIPMENT AND TURN OVER TO HAS IT.



GENERAL NOTES

KEYED NOTES

A

B

C

D

TIP NO. # TBD

SHEET NAME: TECHNOLOGY - REFERENCE PLAN - LEVEL 1


SHEET No.	T-102	SCALE:	1" = 80'-0"
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SHEET SIZE: 22"x34" ANSI-D


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LVL 1 - DEMO FLOOR PLAN - AREA C SCALE: 1/8" = 1'-0" A2



LVL 1 - DEMO FLOOR PLAN - AREA B SCALE: 1/8" = 1'-0" C2

1. CONTRACTOR TO COORDINATE ALL TECHNOLOGY DEVICE REMOVALS WITH HAS TECHNOLOGY DIVISION PRIOR TO REMOVAL. SALVAGE ALL EXISTING IT EQUIPMENT AND TURN OVER TO HAS IT.

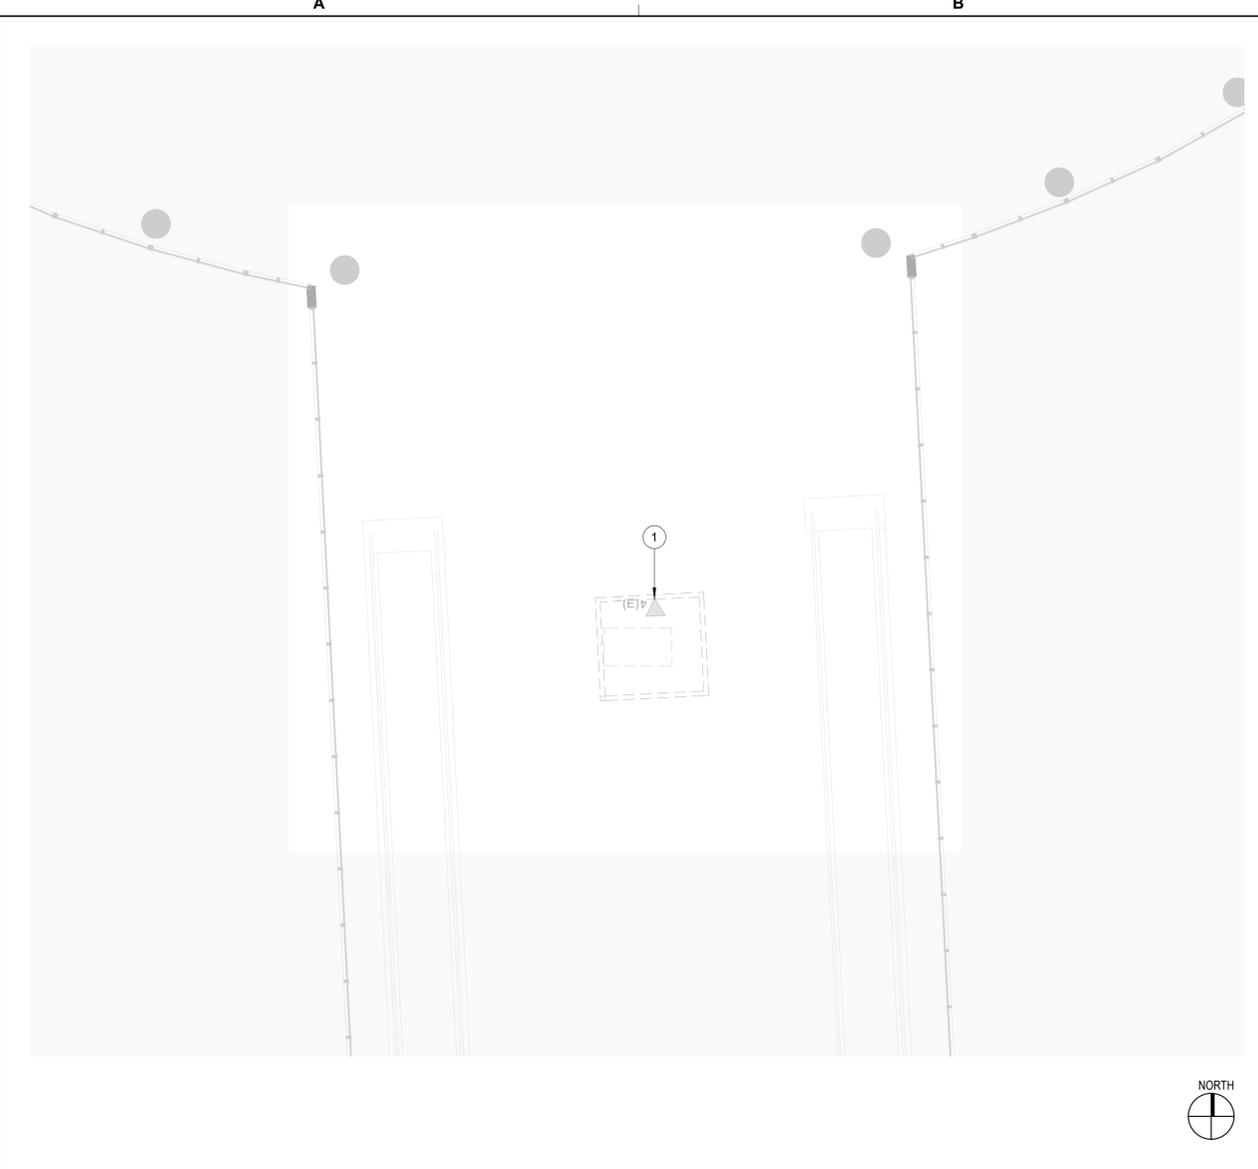GENERAL NOTES

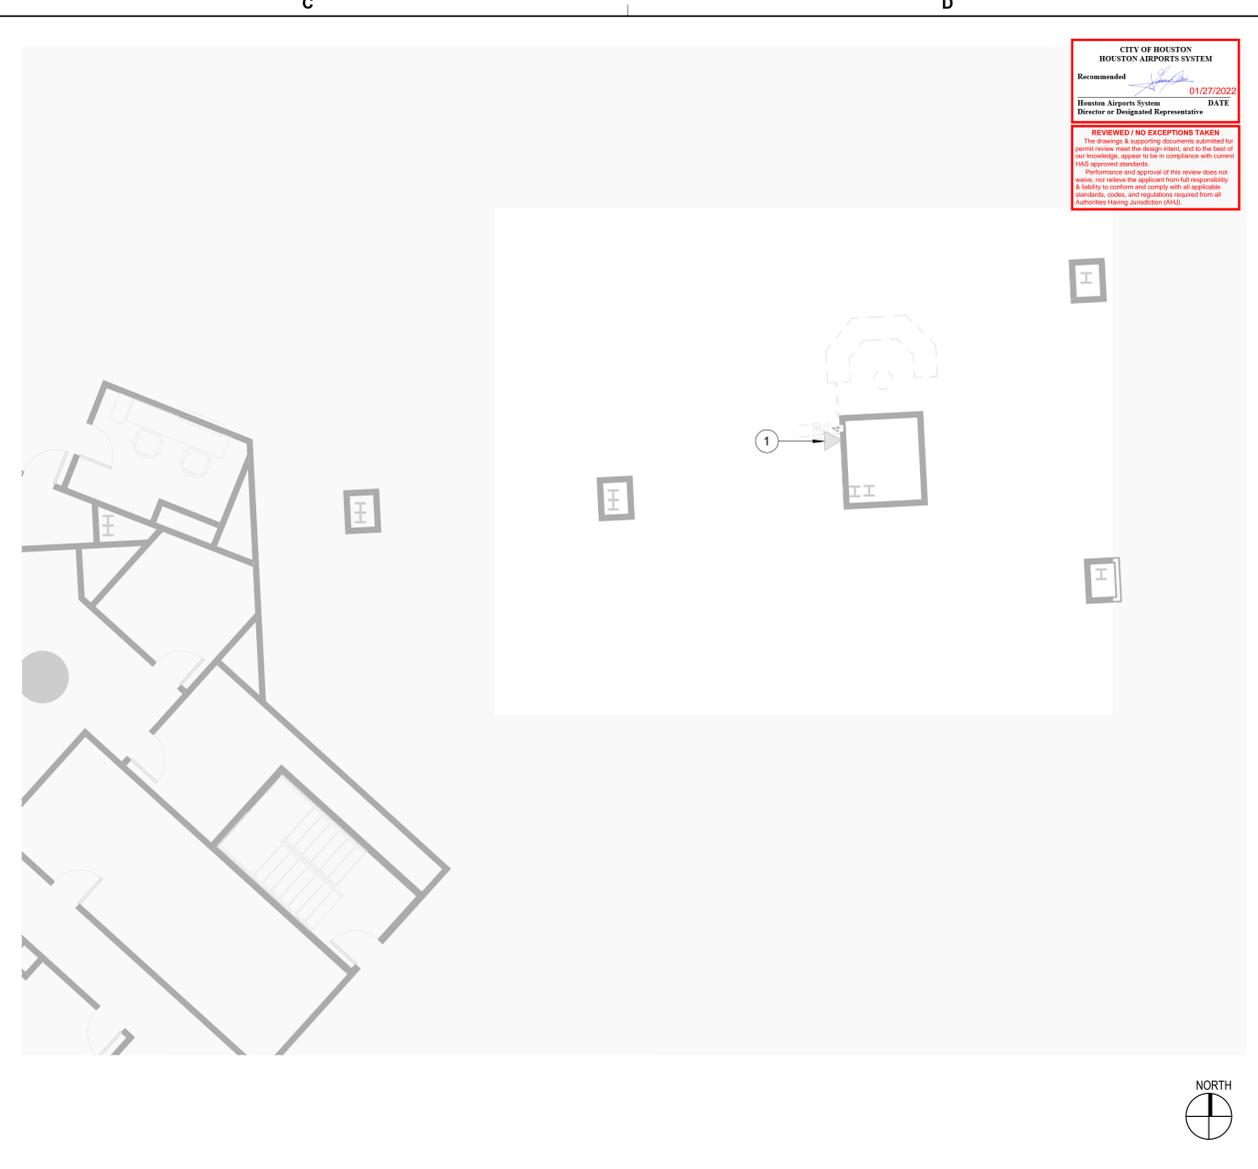1. EXISTING DATA JACK. COORDINATE WITH HAS IT AND REMOVE.

KEYED NOTES

CITY OF HOUSTON
HOUSTON AIRPORTS SYSTEM

Recommended
Houston Airports System
Director or Designated Representative

01/27/2022
DATE

REVIEWED / NO EXCEPTIONS TAKEN
The drawing & supporting documents submitted for permit review meet the design intent, and to the best of my knowledge, appear to be in compliance with current HAAS approved standards.
I, the undersigned, approve of this review and do not assume any liability for the design or construction of the project.
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Houston, TX 77032
346.570.2418
pgaengineers.com
TBPE FIRM #12493

DESIGNER PROJECT No.: 2020.017
PROJECT STATUS: 100% PERMIT, BID AND CONSTRUCTION

REVISIONS

No.	DESCRIPTION	DATE	BY
1	SCHEMATIC DESIGN	10.23.20	
2	DESIGN DEVELOPMENT	12.04.20	
3	95% OWNER REVIEW	09.24.21	
4	100% PERMIT, BID AND CONSTRUCTION	11.08.21	


DESIGNER: PGA
DRAWN BY: AC
CHECKED BY: JG
ISSUE DATE: 11/08/2021
APPROVED BY: Approver
APPROVAL DATE:

DIRECTOR
of
HOUSTON AIRPORT SYSTEM

Review Approval Category

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Approved For Construction

STATE OF TEXAS
JOHN GRUENWALD
100039
LICENSED PROFESSIONAL ENGINEER
11/08/2021

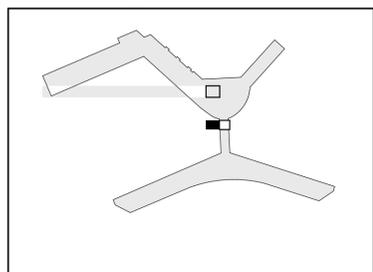

TIP NO. # TBD
SHEET NAME: TECHNOLOGY - DEMOLITION PLAN - LEVEL 1 - AREA B & C

SHEET No. T-104 SCALE: As indicated
SHEET SIZE: 22"x34" ANSI-D

FILE PATH: C:\Users\acaturana\Desktop\HOU_COUNTER\HOU_COUNTER\HOU_INFO_COUNTER_RENOVATION_acaturana\J5VK_detached.rvt
 HAS FILE:
 PLOT DATE:
 DOA DWG FILE:
 OLD DOA No.:



CITY OF HOUSTON
 HOUSTON AIRPORTS SYSTEM
 Recommended
 Houston Airports System
 Director or Designated Representative
 DATE: 01/27/2022
 REVIEWED NO EXCEPTIONS TAKEN
 This drawing & supporting documents submitted for permit review meet the design intent, and to the best of the reviewer's knowledge, appear to comply with current HOU design standards.
 Permit review and approval of this review does not waive the reviewer's responsibility for responsibility & liability to the extent permitted by applicable standards. All other responsibilities remain from all other applicable jurisdictions.



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	SCHEMATIC DESIGN	10.23.20	
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DESIGNER: PGA
 DRAWN BY: AC
 CHECKED BY: JG
 ISSUE DATE: 11/08/2021
 APPROVED BY: Approver
 APPROVAL DATE:

DIRECTOR
 of
 HOUSTON AIRPORT SYSTEM

LVL 1 - DEMO FLOOR PLAN - AREA D SCALE: 1/8" = 1'-0" A2


1. CONTRACTOR TO COORDINATE ALL TECHNOLOGY DEVICE REMOVALS WITH HAS TECHNOLOGY DIVISION PRIOR TO REMOVAL. SALVAGE ALL EXISTING IT EQUIPMENT AND TURN OVER TO HAS IT.

GENERAL NOTES

KEYED NOTES

KEYED NOTES

Review/Approval Category IFP ISSUED FOR PERMIT Approved For Construction	STATE OF TEXAS JOHN GRUENWALD 100039 LICENSED PROFESSIONAL ENGINEER 11/08/2021
--	--

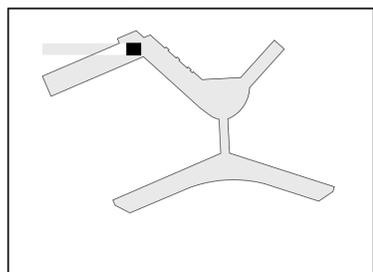

TIP NO. # TBD
 SHEET NAME: TECHNOLOGY - DEMOLITION PLAN - LEVEL 1 - AREA D

SHEET No. T-105 SCALE: As indicated
 SHEET SIZE: 22"x34" ANSI-D



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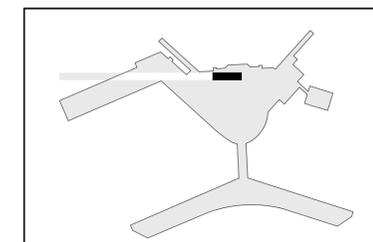
DESIGNER PROJECT No.: 2020.017
PROJECT STATUS: 100% PERMIT, BID AND CONSTRUCTION

REVISIONS			
No.	DESCRIPTION	DATE	BY
	SCHEMATIC DESIGN	10.23.20	
	DESIGN DEVELOPMENT	12.04.20	
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DRAWN BY: AC
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ISSUE DATE: 11/08/2021
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DIRECTOR
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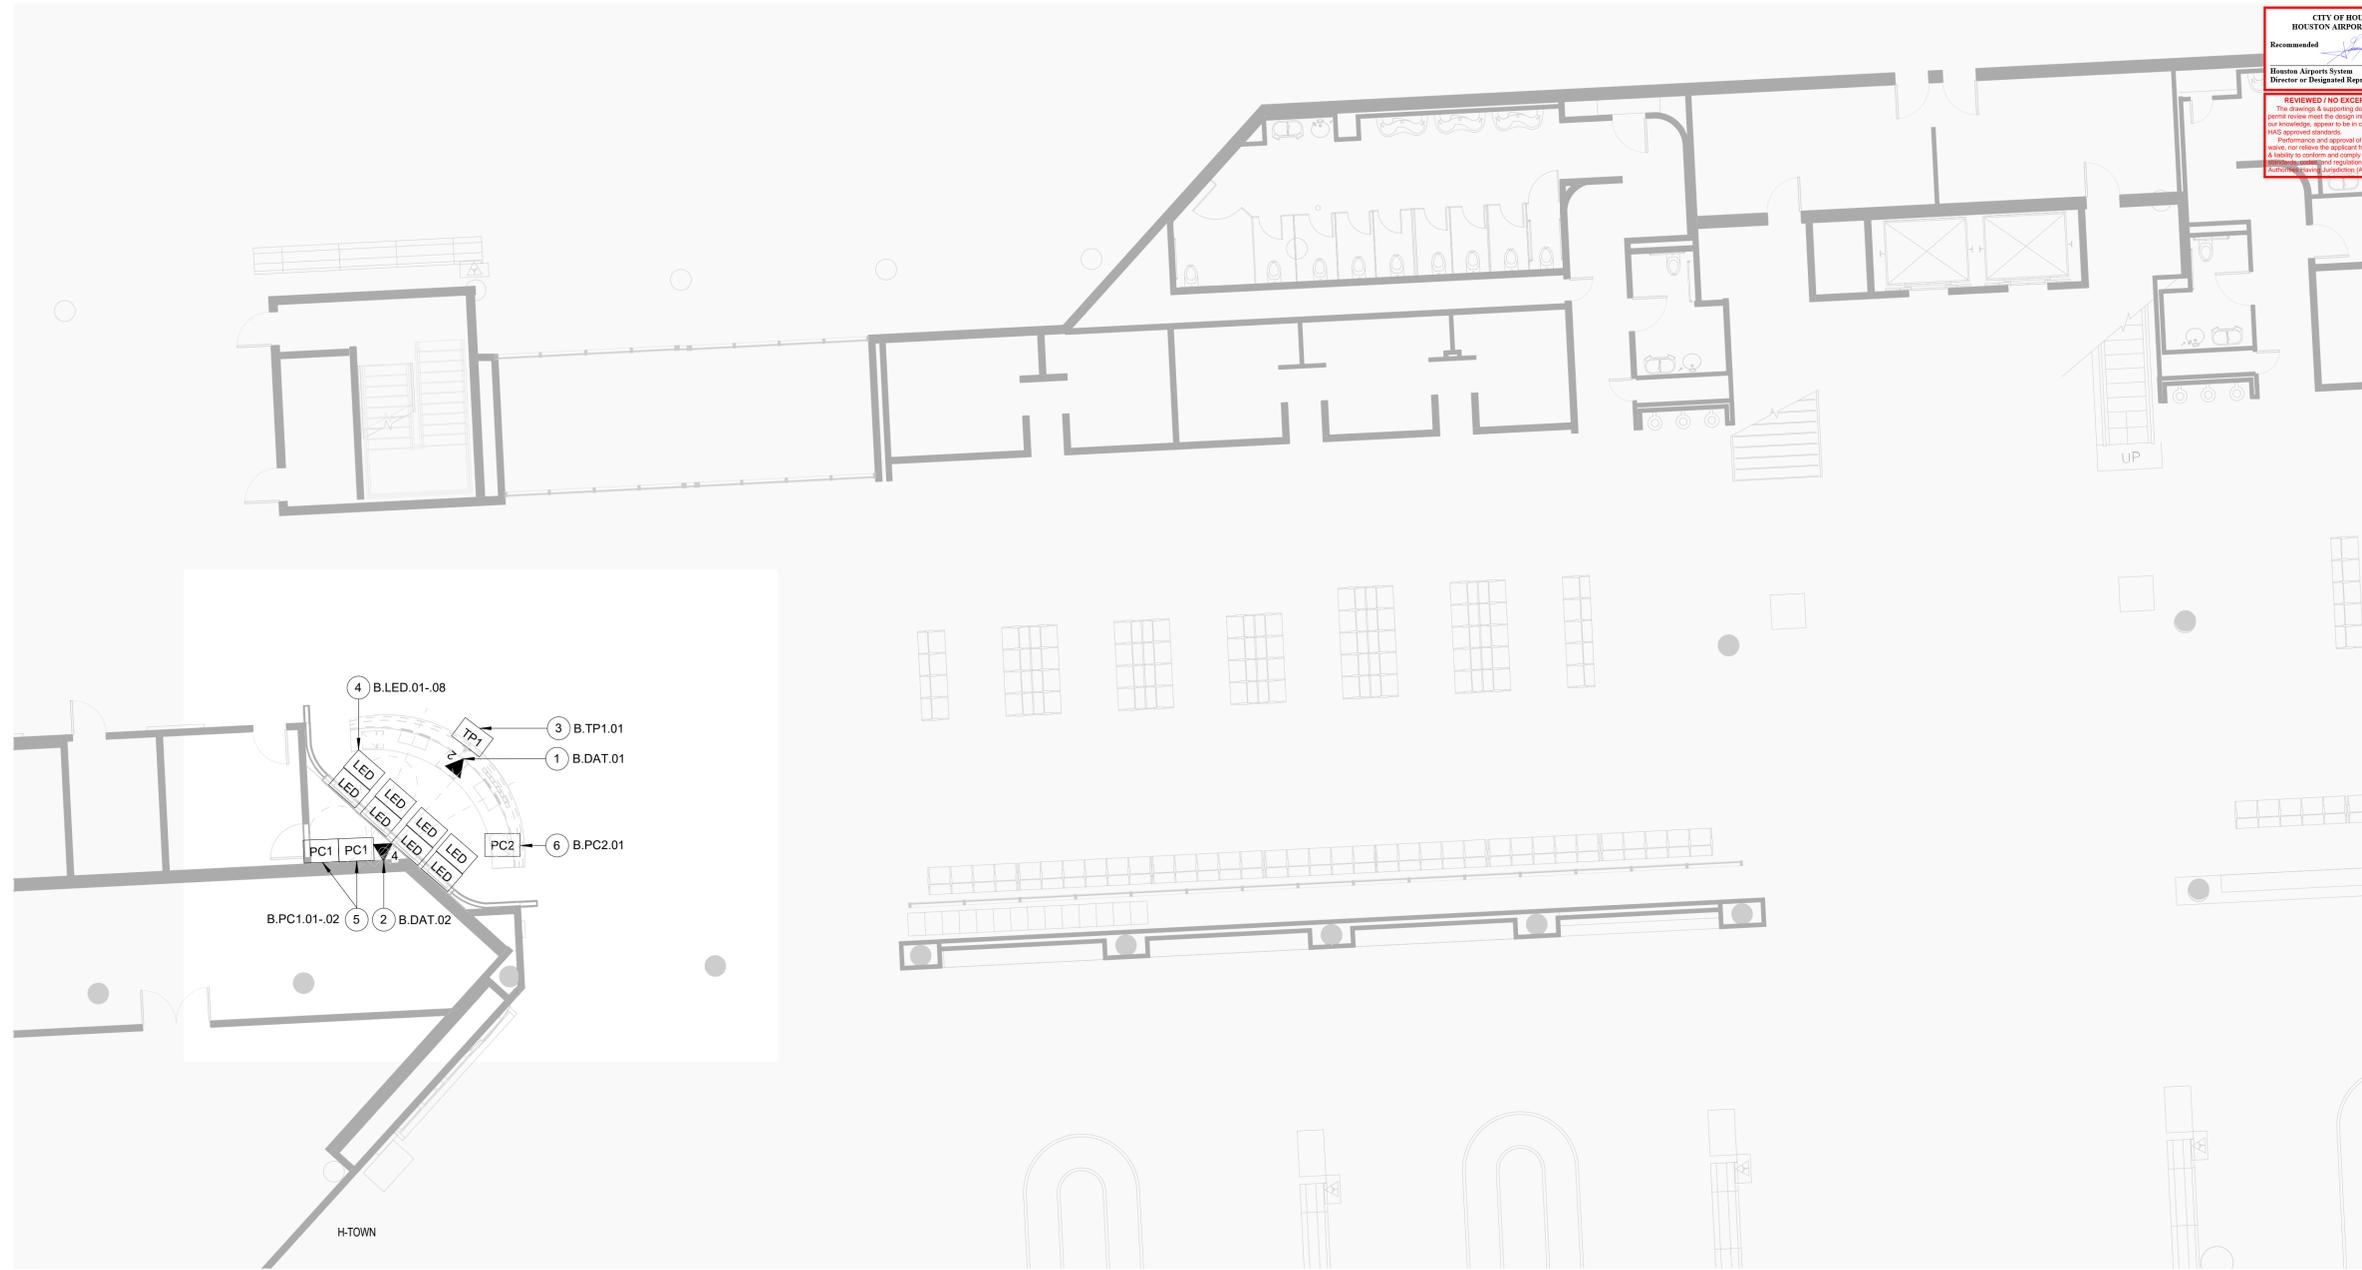


TIP NO. # TBD

SHEET NAME: TECHNOLOGY - FLOOR PLAN - BAGGAGE CLAIM - AREA A
SHEET No. T-106 SCALE: As indicated
SHEET SIZE: 22"x34" ANSI-D

CITY OF HOUSTON
HOUSTON AIRPORTS SYSTEM
Recommended
Houston Airports System
Director or Designated Representative
DATE
01/27/2022

REVIEWED / NO EXCEPTIONS TAKEN
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Performance and approval of this review does not warrant, nor release the applicant from all responsibility & liability to conform and comply with all applicable regulatory codes and regulations required from all applicable regulatory jurisdictions (PH&C).



TECHNOLOGY - FLOOR PLAN - BAGGAGE CLAIM - AREA A SCALE: 1/8" = 1'-0" A2

GENERAL NOTES

- TELECOMMUNICATIONS INFRASTRUCTURE SHALL BE INSTALLED IN ACCORDANCE WITH DIVISION 27.
- SUBMIT DATASHEET FOR ALL EQUIPMENT FOR APPROVAL PRIOR TO INSTALLATION.

KEYED NOTES



- CAT6 ROUTED THROUGH A 1" C. TO IDF 101.40 REFERENCE T-101 FOR IDF LOCATION. QUANTITY AS INDICATED.
- CAT6 ROUTED THROUGH A 1" C. TO IDF 101.40 REFERENCE T-101 FOR IDF LOCATION. QUANTITY AS INDICATED. DEDICATED FOR LED WALL AND ITS PC.
- IPAD AND ARCHITECTURAL SPECIFIED MOUNT. REFERENCE ARCHITECTURAL DRAWINGS. LIGHTING/USB CONNECTOR CONNECTED TO USB POWER HUB. REFERENCE MEP DRAWINGS.
- LED VIDEO WALL. 4 X 2 NEC UN552S DISPLAYS. QUANTITY (8).
- TYPE 1 COMPUTER. DEDICATED LED WALL VIDEO SOURCE. DELL OPTIPLEX 3080 SFF.
- TYPE 2 COMPUTER. DEDICATED FOR HAS PERSONNEL. INCLUDE MONITOR, KEYBOARD, AND MOUSE. DELL OPTIPLEX 3080 SFF. REFERENCE SPECIFICATIONS 272200.

FILE PATH: C:\Users\acaturana\Desktop\HOU_COUNTER\HOU_INFO_COUNTER_RENOVATION_acaturana\J5VK_detached.rvt
HAS FILE:
PLOT DATE:
DOA DWG FILE:
OLD DOA No.:

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01/27/2022
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LVL 1 - FLOOR PLAN - AREA C SCALE: 1/8" = 1'-0" A2

LVL 1 - FLOOR PLAN - AREA B SCALE: 1/8" = 1'-0" C2

1. TELECOMMUNICATIONS INFRASTRUCTURE SHALL BE INSTALLED IN ACCORDANCE WITH DIVISION 27.

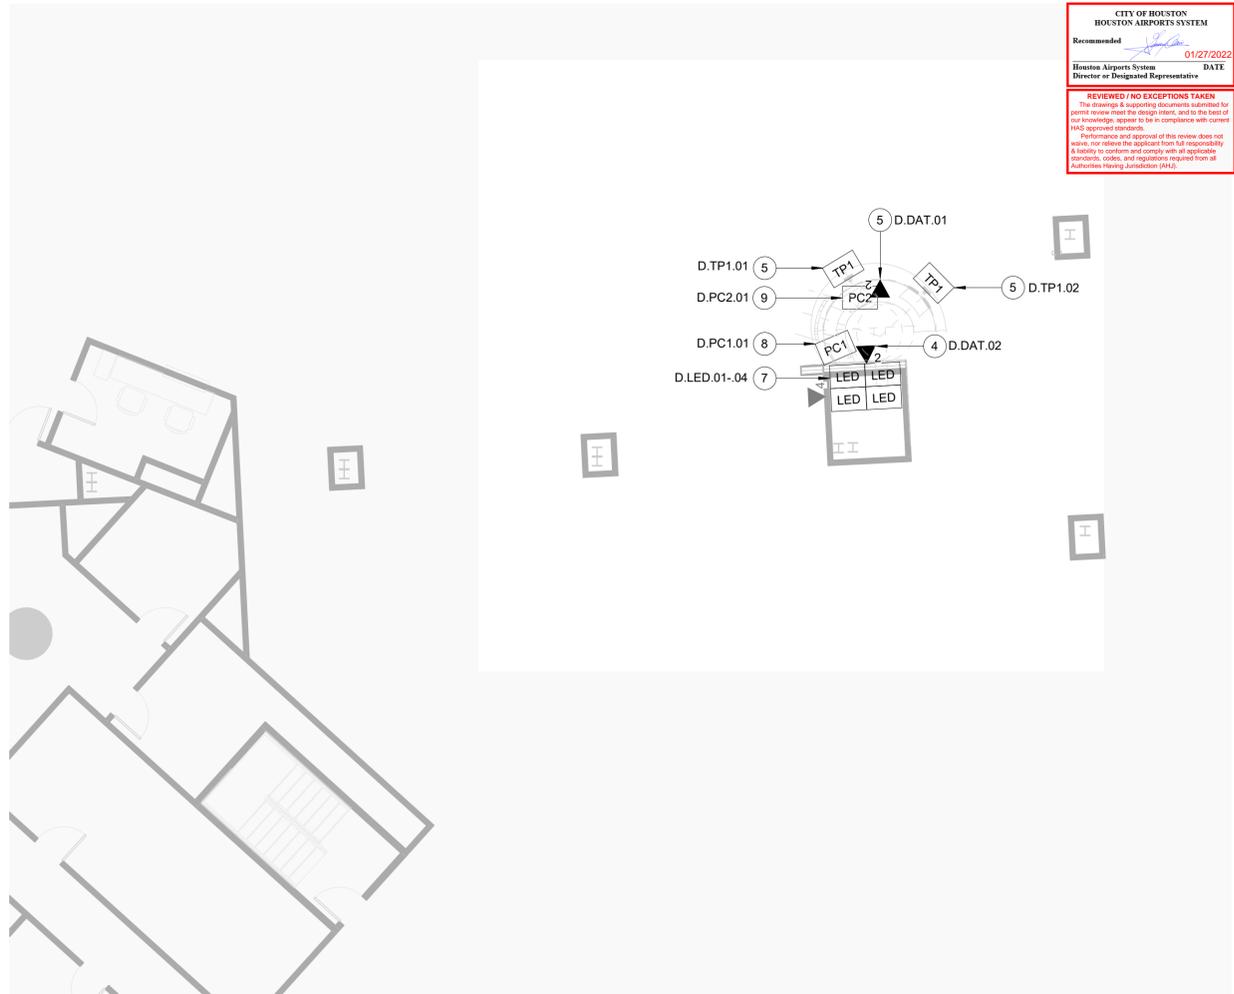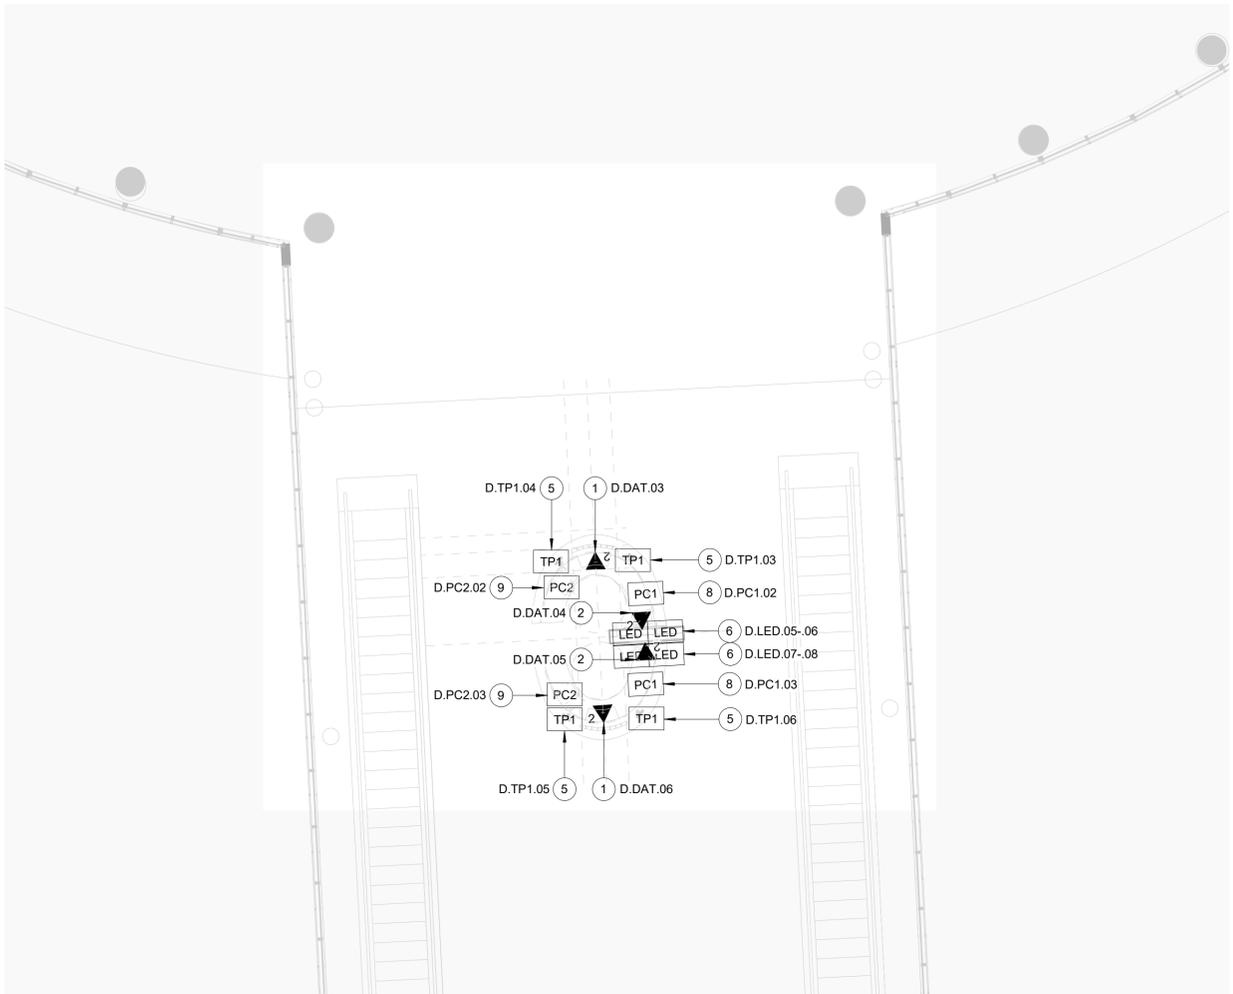2. SUBMIT DATASHEET FOR ALL EQUIPMENT FOR APPROVAL PRIOR TO INSTALLATION.

- 1 CAT6 ROUTED THROUGH A 1" C. TO IDF 100.14. REFERENCE T-102 FOR IDF LOCATION. QUANTITY AS INDICATED.
- 2 CAT6 ROUTED THROUGH A 1" C. TO IDF 100.14. REFERENCE T-102 FOR IDF LOCATION. QUANTITY AS INDICATED. DEDICATED FOR LED WALL.
- 3 CAT6 ROUTED THROUGH A 1" C. TO IDF 102.44. REFERENCE T-102 FOR IDF LOCATION. QUANTITY AS INDICATED.
- 4 CAT6 ROUTED THROUGH A 1" C. TO IDF 102.44. REFERENCE T-102 FOR IDF LOCATION. QUANTITY AS INDICATED. DEDICATED FOR LED WALL.
- 5 IPAD AND OWNER SPECIFIED MOUNT. REFERENCE ARCHITECTURAL DRAWINGS. LIGHTING/USB CONNECTOR CONNECTED TO USB POWER HUB. REFERENCE MEP DRAWINGS.
- 6 LED VIDEO WALL. 1 X 2 NEC UN552S DISPLAYS. QUANTITY (2).
- 7 LED VIDEO WALL. 2 X 2 NEC UN552S DISPLAYS. QUANTITY (4).
- 8 TYPE 1 COMPUTER. DEDICATED LED WALL VIDEO SOURCE. DELL OPTIPLEX 3080 SFF.
- 9 TYPE 2 COMPUTER. DEDICATED FOR HAS PERSONNEL. INCLUDE MONITOR, KEYBOARD, AND MOUSE. DELL OPTIPLEX 3080 SFF. REFERENCE SPECIFICATIONS 272200.



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DESIGNER PROJECT No.: 2020.017
PROJECT STATUS: 100% PERMIT, BID AND CONSTRUCTION


REVISIONS

No.	DESCRIPTION	DATE	BY
	SCHEMATIC DESIGN	10.23.20	
	DESIGN DEVELOPMENT	12.04.20	
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	100% PERMIT, BID AND CONSTRUCTION	11.08.21	

DESIGNER: PGA
DRAWN BY: AC
CHECKED BY: JG
ISSUE DATE: 11/08/2021
APPROVED BY: Approver
APPROVAL DATE:

DIRECTOR
of
HOUSTON AIRPORT SYSTEM

Review Approval Category
IFP
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TIP NO. # TBD

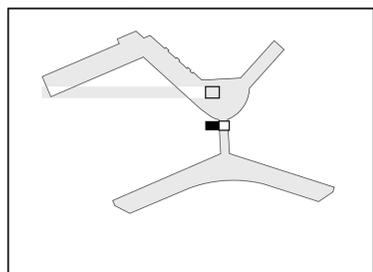SHEET NAME: TECHNOLOGY - FLOOR PLAN - LEVEL 1 - AREAS B AND C

SHEET No. T-107 SCALE: As indicated
SHEET SIZE: 22"x34" ANSI-D



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	100% PERMIT, BID AND CONSTRUCTION	11.08.21	

DESIGNER: PGA
DRAWN BY: AC
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APPROVAL DATE:


DIRECTOR
of
HOUSTON AIRPORT SYSTEM

Review Approval Category IFP ISSUED FOR PERMIT Approved For Construction	STATE OF TEXAS JOHN GRUENWALD 100039 LICENSED PROFESSIONAL ENGINEER 11/08/2021
--	--

TIP NO. # TBD

SHEET NAME: TECHNOLOGY - FLOOR PLAN - LEVEL 1 - AREA D

SHEET No. T-108 SCALE: As indicated
SHEET SIZE: 22"x34" ANSI-D

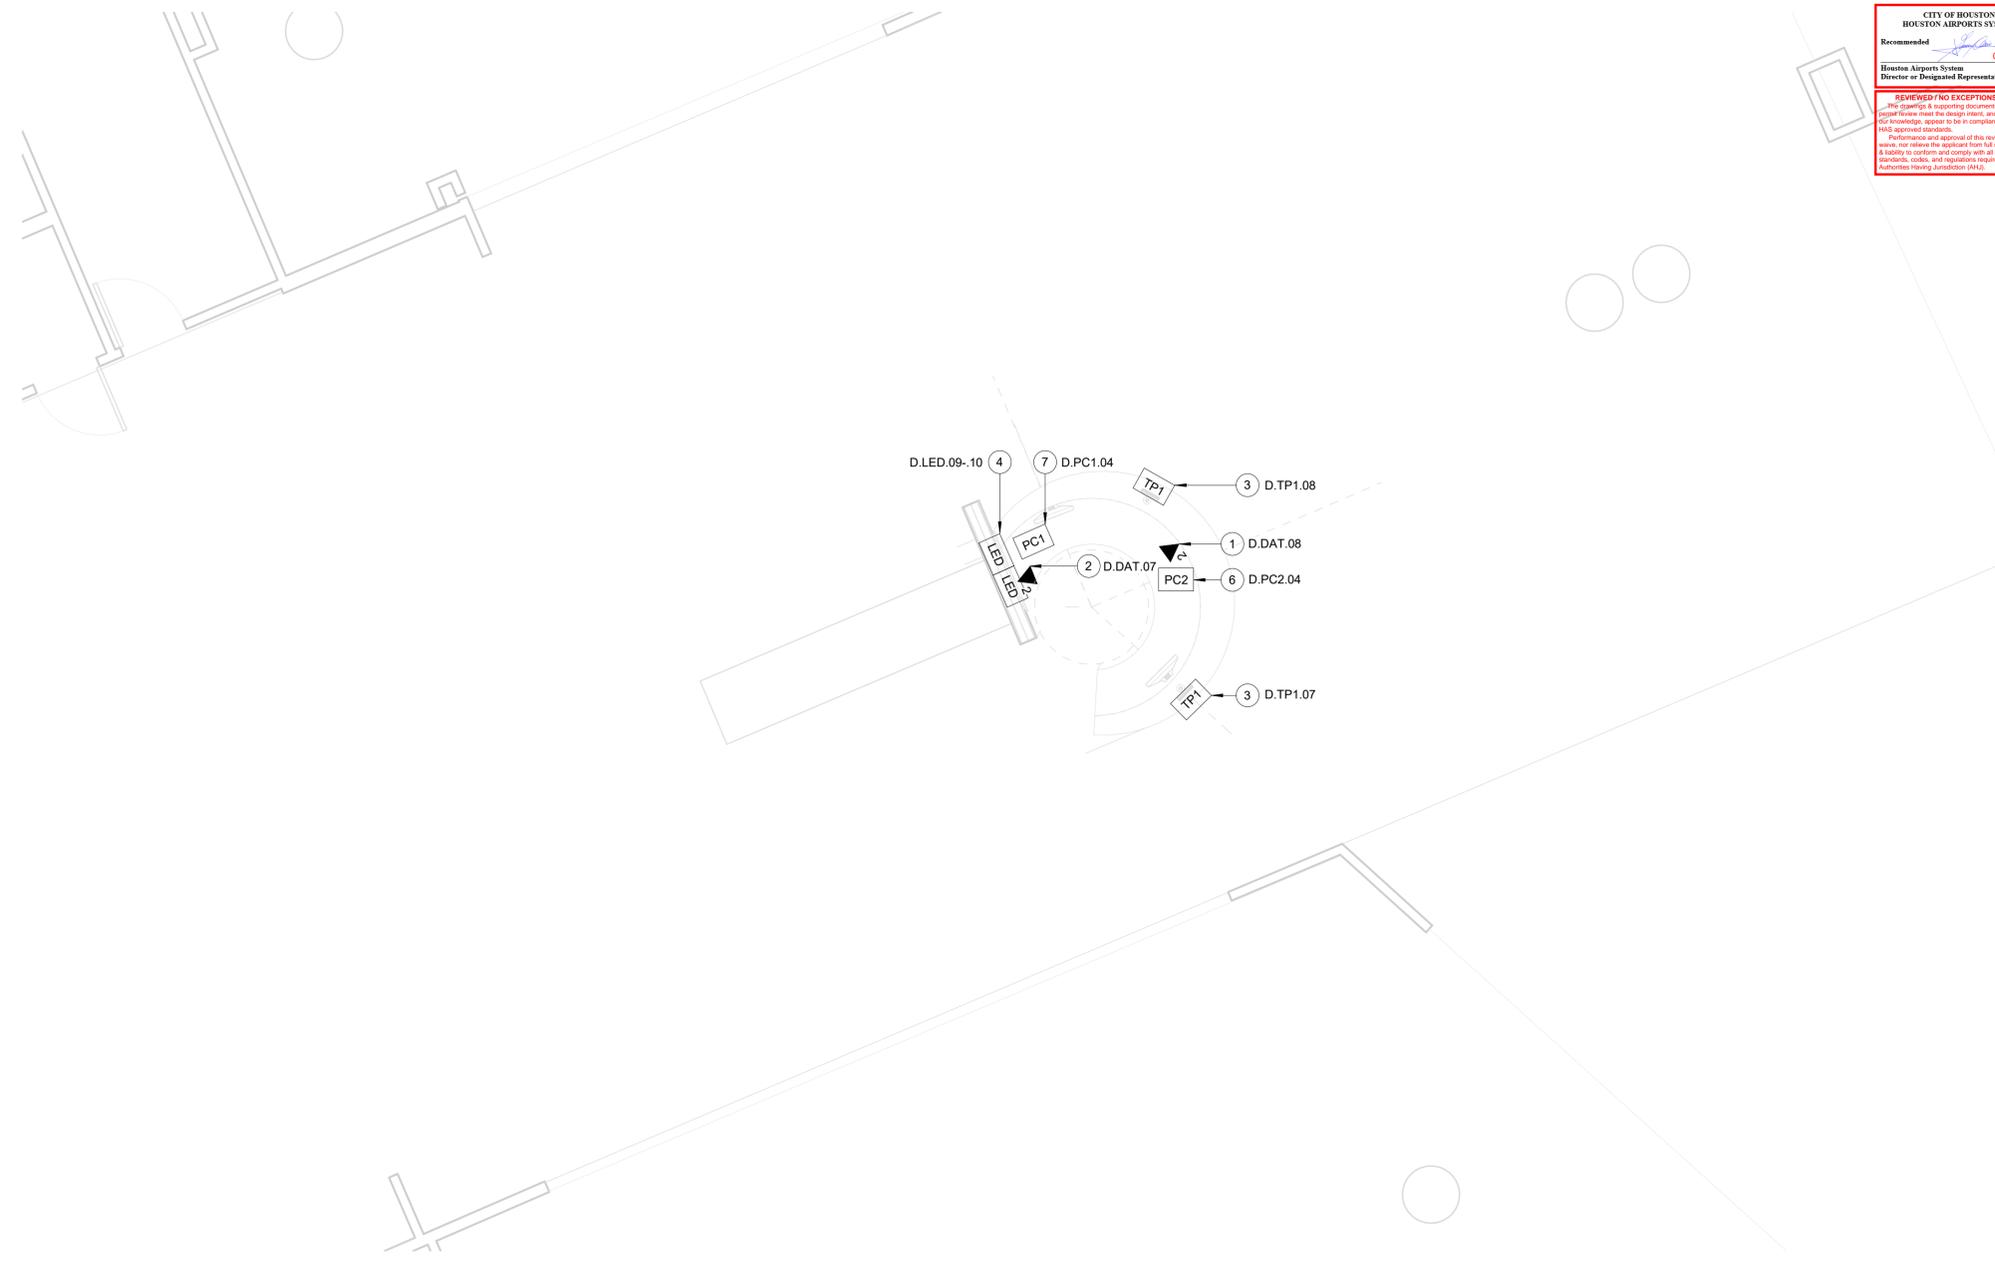

CITY OF HOUSTON
HOUSTON AIRPORTS SYSTEM

Recommended: [Signature] 01/27/2022
Houston Airports System Director or Designated Representative DATE

REVIEWED/NO EXCEPTIONS TAKEN
The drawings & supporting documents submitted for permit review meet the design intent, and to the best of our knowledge, appear to be in compliance with current H&I approved standards.
Performance and approval of this review does not waive our review the applicant from full responsibility & liability to conform and comply with all applicable standards, codes, and regulations required from all Authorities Having Jurisdiction (AHJ).

LVL 1 - FLOOR PLAN - AREA D SCALE: 1/4" = 1'-0" A2

1. TELECOMMUNICATIONS INFRASTRUCTURE SHALL BE INSTALLED IN ACCORDANCE WITH DIVISION 27.
2. SUBMIT DATASHEET FOR ALL EQUIPMENT FOR APPROVAL PRIOR TO INSTALLATION.

1. CAT6 ROUTED THROUGH A 1" C. TO IDF 313.10 REFERENCE T-101 FOR IDF LOCATION. QUANTITY AS INDICATED.
2. CAT6 ROUTED THROUGH A 1" C. TO IDF 313.10 REFERENCE T-101 FOR IDF LOCATION. QUANTITY AS INDICATED. DEDICATED FOR LED WALL AND ITS PC.
3. IPAD AND OWNER SPECIFIED MOUNT. REFERENCE ARCHITECTURAL DRAWINGS. LIGHTING/USB CONNECTOR CONNECTED TO USB POWER HUB. REFERENCE MEP DRAWINGS.
4. LED VIDEO WALL. 1 X 2 NEC UN552S DISPLAYS. QUANTITY (2).
5. TYPE 1 COMPUTER. DEDICATED LED WALL VIDEO SOURCE. DELL OPTIPLEX 3080 SFF.
6. TYPE 2 COMPUTER. DEDICATED FOR HAS PERSONNEL. INCLUDE MONITOR, KEYBOARD, AND MOUSE. DELL OPTIPLEX 3080 SFF. REFERENCE SPECIFICATIONS 272200.

GENERAL NOTES


KEYED NOTES

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 OLD DOA No.:


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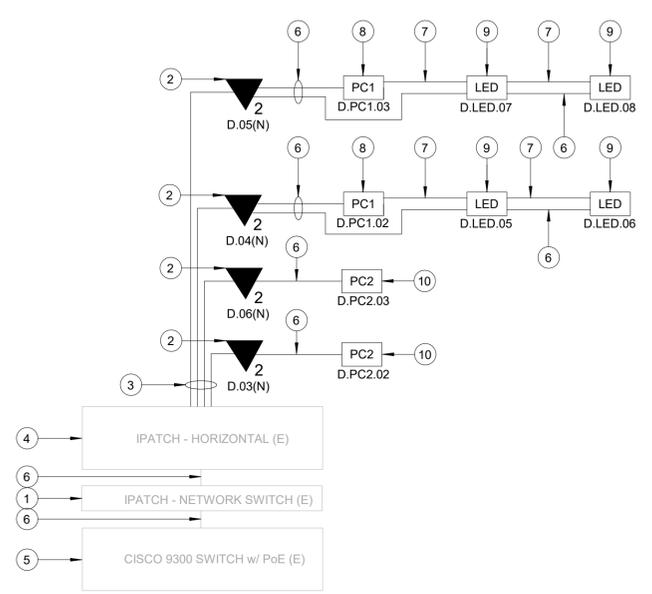
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DOA DWG FILE:
OLD DOA No.:



IDF 100.14 FLOORPLAN SCALE: 1/4" = 1'-0" A2

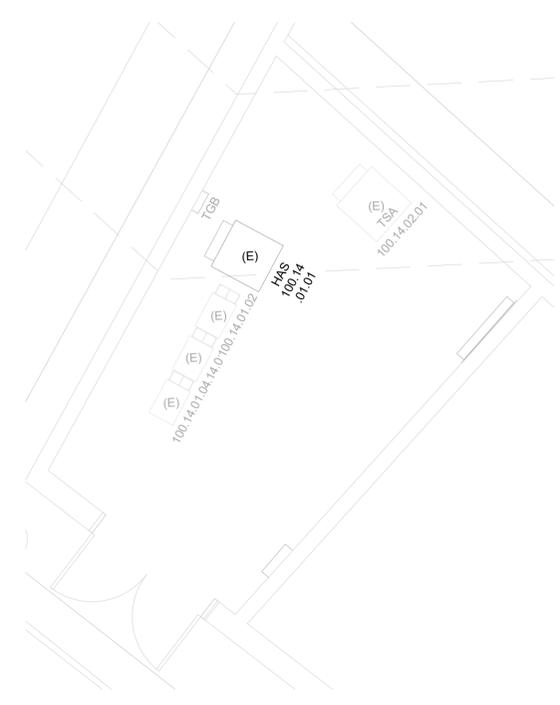

IDF 100.14 RACK SCALE: 1" = 10'-0" B2

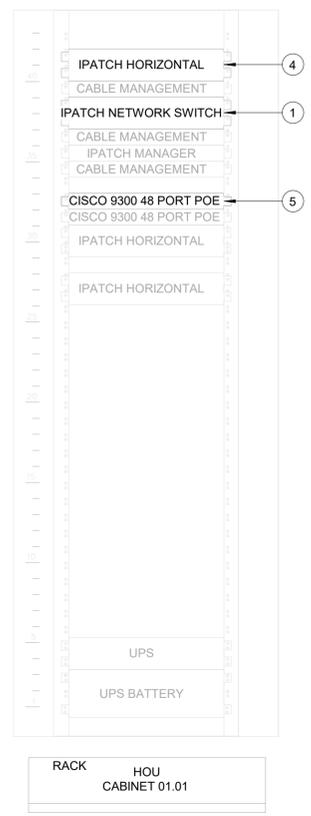

IDF 100.14 ONE LINE DIAGRAM SCALE: NTS C2

1. TELECOMMUNICATIONS INFRASTRUCTURE SHALL BE INSTALLED IN ACCORDANCE WITH DIVISION 27.

- ① IPATCH NETWORK SWITCH. (E) USE PORTS 37-40 UNLESS OTHERWISE DIRECTED BY HAS IT.
- ② CATEGORY 6 DATA RECEPTACLE. DEFINED ON SYMBOLS SHEET. (N)
- ③ CAT6 ROUTED THROUGH A 1". QUANTITY AS INDICATED. (N)
- ④ IPATCH HORIZONTAL. (E) USE PORTS 45-48 UNLESS OTHER DIRECTED BY HAS IT.
- ⑤ CISCO 9300 NETWORK SWITCH, "HOU-W6-9308-2." (E)
- ⑥ CAT6 PATCH CORD. (N)
- ⑦ HDMI CABLE. (N)
- ⑧ DELL 3080 SFF PC. (N)
- ⑨ NEC LED 55" DISPLAY PANEL. (N)
- ⑩ HAS PERSONNEL PC. REFERENCE SPECIFICATIONS 272200. (N)

GENERAL NOTES

KEYED NOTES

CITY OF HOUSTON
HOUSTON AIRPORTS SYSTEM

Recommended: _____ DATE: 01/27/2022

Houston Airports System
Director or Designated Representative

REVIEWED / NO EXCEPTIONS TAKEN
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7800 Airport Blvd
Houston, TX 77061

**HOU INFORMATION COUNTER
RENOVATION**

C.I.P. No. _____ A.I.P. No. _____
C.O.H. No. _____ D.O.A No. _____

PGA
ENGINEERS, INC
3838 N Sam Houston Pkwy E,
Suite 550
Houston, TX 77032
346.570.2418
pgaengineers.com
TBPE FIRM #12493

DESIGNER PROJECT No.: 2020.017
PROJECT STATUS: 100% PERMIT, BID AND CONSTRUCTION

REVISIONS

No.	DESCRIPTION	DATE	BY
	SCHEMATIC DESIGN	10.23.20	
	DESIGN DEVELOPMENT	12.04.20	
	95% OWNER REVIEW	09.24.21	
	100% PERMIT, BID AND CONSTRUCTION	11.08.21	

DESIGNER: PGA
DRAWN BY: AC
CHECKED BY: JG
ISSUE DATE: 11/08/2021
APPROVED BY: Approver
APPROVAL DATE:

DIRECTOR
of
HOUSTON AIRPORT SYSTEM

Review Approval Category
IFP
ISSUED FOR PERMIT
Approved For Construction

TIP NO. # TBD

SHEET NAME: TECHNOLOGY - IDF 100.14 ENLARGED PLAN

SHEET No. T-401 SCALE: As indicated
SHEET SIZE: 22"x34" ANSI-D



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Houston, TX 77061

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C.I.P. No. _____ A.I.P. No. _____
C.O.H. No. _____ D.O.A No. _____

CITY OF HOUSTON
HOUSTON AIRPORTS SYSTEM

Recommended _____ DATE 01/27/2022
Houston Airports System Director or Designated Representative

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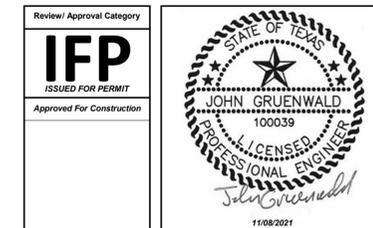
DESIGNER PROJECT No.: 2020.017
PROJECT STATUS: 100% PERMIT, BID AND CONSTRUCTION

REVISIONS

No.	DESCRIPTION	DATE	BY
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	DESIGN DEVELOPMENT	12.04.20	
	95% OWNER REVIEW	09.24.21	
	100% PERMIT, BID AND CONSTRUCTION	11.08.21	

DESIGNER: PGA
DRAWN BY: AC
CHECKED BY: JG
ISSUE DATE: 11/08/2021
APPROVED BY: Approver
APPROVAL DATE:

DIRECTOR
of
HOUSTON AIRPORT SYSTEM




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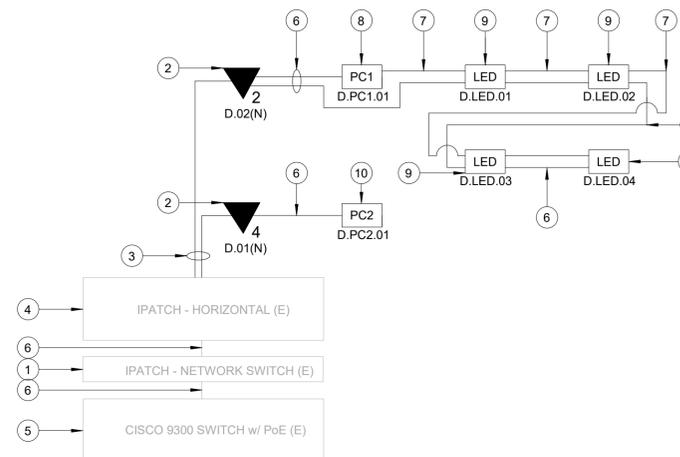
SHEET NAME: TECHNOLOGY - IDF 102.44 ENLARGED PLAN
SHEET No. T-403 SCALE: As indicated
SHEET SIZE: 22"x34" ANSI-D



IDF 102.44 FLOORPLAN SCALE: 1/2"=1'-0" A2

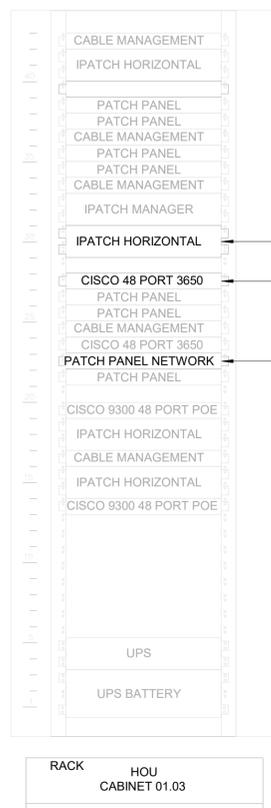

IDF 102.44 RACK SCALE: 1" = 10'-0" B2



IDF 102.44 ONE LINE DIAGRAM SCALE: NTS C2

1. TELECOMMUNICATIONS INFRASTRUCTURE SHALL BE INSTALLED IN ACCORDANCE WITH DIVISION 27.

- ① PATCH PANEL NETWORK SWITCH. (E) USE PORTS 13-16 UNLESS OTHERWISE DIRECTED BY HAS IT.
- ② CATEGORY 6 DATA RECEPTACLE. DEFINED ON SYMBOLS SHEET. (N)
- ③ CAT6 ROUTED THROUGH A 1". QUANTITY AS INDICATED. (N)
- ④ IPATCH HORIZONTAL. (E) USE PORTS 43-46 UNLESS OTHERWISE DIRECTED BY HAS IT.
- ⑤ CISCO 3650 NETWORK SWITCH, "HOU-102.44-3658-1." (E)
- ⑥ CAT6 PATCH CORD. (N)
- ⑦ HDMI CABLE. (N)
- ⑧ DELL 3080 SFF PC. (N)
- ⑨ NEC LED 55" DISPLAY PANEL. (N)
- ⑩ HAS PERSONNEL PC. REFERENCE SPECIFICATIONS 272200. (N)

GENERAL NOTES

KEYED NOTES

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 HAS FILE:
 PLOT DATE:
 DOA DWG FILE:
 OLD DOA No.:

CITY OF HOUSTON
HOUSTON AIRPORTS SYSTEM
Recommended *[Signature]* 01/27/2022
Houston Airports System Director or Designated Representative DATE

REVIEWED / NO EXCEPTIONS TAKEN
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7800 Airport Blvd
Houston, TX 77061
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C.O.H. No. D.O.A No.

PGA
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Suite 550
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346.570.2418
pgaengineers.com
TBPE FIRM #12493

DESIGNER PROJECT No.: 2020.017
PROJECT STATUS: 100% PERMIT, BID AND CONSTRUCTION

REVISIONS


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	DESIGN DEVELOPMENT	12.04.20	
	95% OWNER REVIEW	09.24.21	
	100% PERMIT, BID AND CONSTRUCTION	11.08.21	

DESIGNER: PGA
DRAWN BY: AC
CHECKED BY: JG
ISSUE DATE: 11/08/2021
APPROVED BY: Approver
APPROVAL DATE:


DIRECTOR
of
HOUSTON AIRPORT SYSTEM

Review Approval Category
IFP
ISSUED FOR PERMIT
Approved For Construction


TIP NO. # TBD
SHEET NAME: TECHNOLOGY - IDF 313.10 ENLARGED PLAN
SHEET No. T-404 SCALE: As indicated
SHEET SIZE: 22"x34" ANSI-D

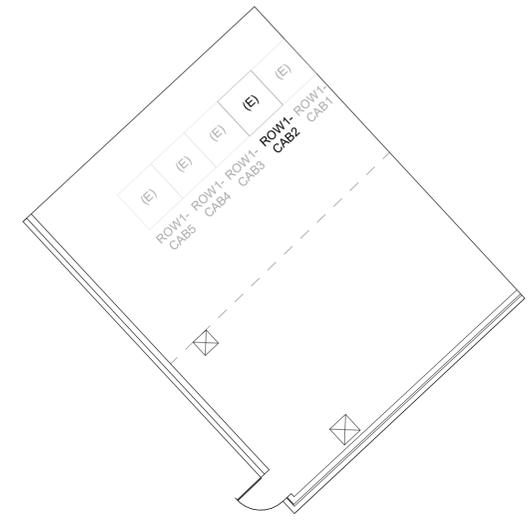

IDF 313.10 FLOORPLAN SCALE: 1/4" = 1'-0" A2

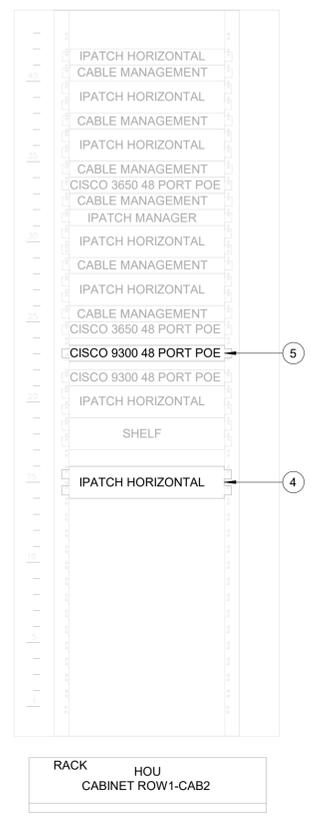

IDF 313.10 RACK SCALE: 1" = 10'-0" 1

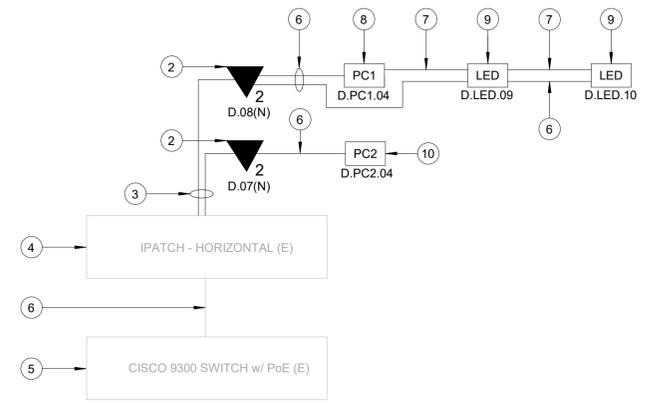

IDF 313.10 ONE LINE DIAGRAM SCALE: NTS C2

1. TELECOMMUNICATIONS INFRASTRUCTURE SHALL BE INSTALLED IN ACCORDANCE WITH DIVISION 27.

- ① IPATCH NETWORK SWITCH. NOT PICTURED, AND NOT USED IN THIS CABINET. EXISTING CABLE IS RUN DIRECTLY TO "HOU-313.10-9308-23." FROM IPATCH HORIZONTAL. UTILIZE THIS METHOD UNLESS OTHERWISE DIRECTED BY HAS IT.
- ② CATEGORY 6 DATA RECEPTACLE. DEFINED ON SYMBOLS SHEET. (N)
- ③ CAT6 ROUTED THROUGH A 1". QUANTITY AS INDICATED. (N)
- ④ IPATCH HORIZONTAL. (E) USE PORTS 1-4 UNLESS OTHERWISE DIRECTED BY HAS IT.
- ⑤ CISCO 9300 NETWORK SWITCH, "HOU-313.10-9308-23." (E) USE PORTS 43-46 UNLESS OTHERWISE DIRECTED BY HAS IT.
- ⑥ CAT6 PATCH CORD. (N)
- ⑦ HDMI CABLE. (N)
- ⑧ DELL 3080 SFF PC. (N)
- ⑨ NEC LED 55" DISPLAY PANEL. (N)
- ⑩ HAS PERSONNEL PC. REFERENCE SPECIFICATIONS 272200. (N)

GENERAL NOTES

KEYED NOTES

FILE PATH: C:\Users\acaturana\Desktop\HOU_COUNTER\HOU_COUNTER\HOU_INFO_COUNTER_RENOVATION_acaturana\J5VK_detached.rvt
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PLOT DATE:
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OLD DOA No.:

CITY OF HOUSTON
HOUSTON AIRPORTS SYSTEM
Recommended
Houston Airports System
Director or Designated Representative
DATE
01/27/2022

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Houston, TX 77061
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C.O.H. No. D.O.A No.

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TBPE FIRM #12493

DESIGNER PROJECT No.: 2020.017
PROJECT STATUS: 100% PERMIT, BID AND CONSTRUCTION

REVISIONS

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	DESIGN DEVELOPMENT	12.04.20	
	95% OWNER REVIEW	09.24.21	
	100% PERMIT, BID AND CONSTRUCTION	11.08.21	

DESIGNER: PGA
DRAWN BY: AC
CHECKED BY: JG
ISSUE DATE: 11/08/2021
APPROVED BY: Approver
APPROVAL DATE:


DIRECTOR
of
HOUSTON AIRPORT SYSTEM

Review Approval Category


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Approved For Construction

STATE OF TEXAS
JOHN GRUENWALD
100039
LICENSED PROFESSIONAL ENGINEER
11/08/2021


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SHEET NAME: TECHNOLOGY - EQUIPMENT DETAILS
SHEET No. T-501 SCALE: As indicated
SHEET SIZE: 22"x34" ANSI-D

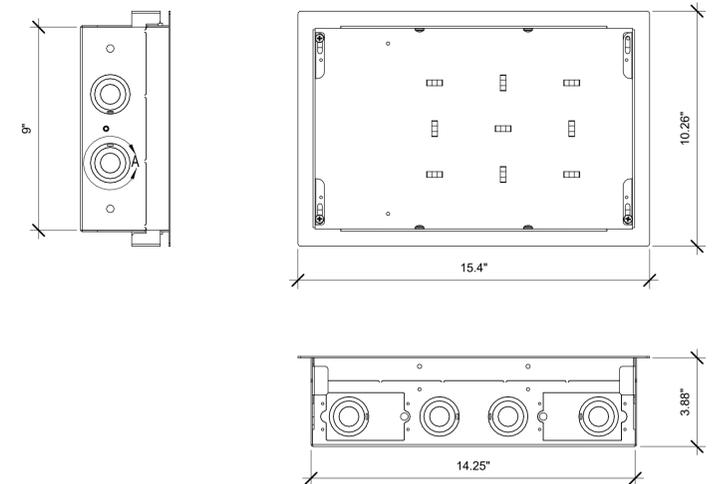


DETAILS - PAC525 WALL BACK BOX SCALE: NTS C3

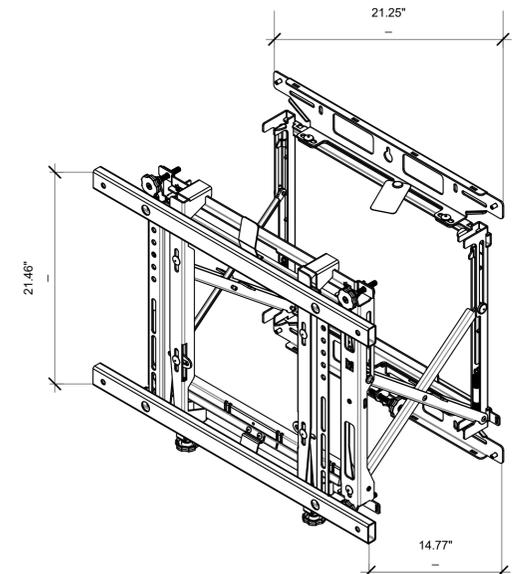

DETAILS - VIDEO WALL DISPLAY MOUNT SCALE: NTS C2

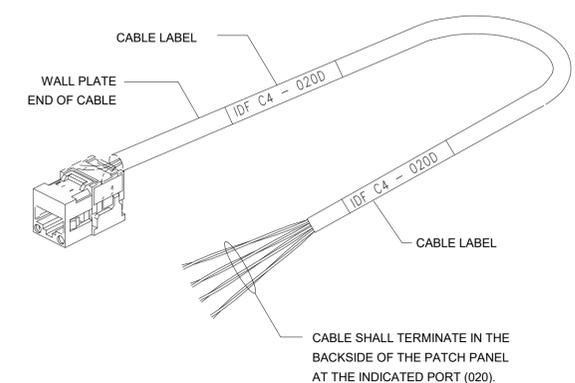


DETAILS - COMMUNICATIONS CABLE LABELING SCALE: 12" = 1'-0" C1

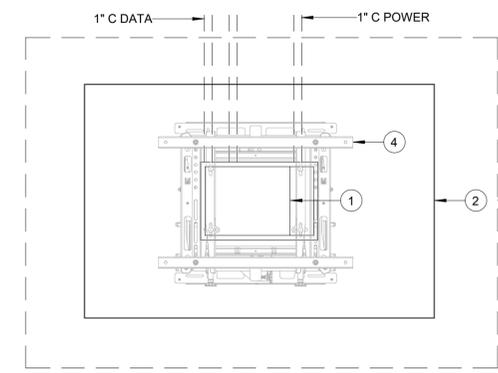


- DETAIL NOTES:**
- 14.25" W x 9" H x 3.88" D (INTERNAL) FLUSH MOUNT WALL BOX WITH 120 VAC AND DATA RECEPTACLES BEHIND FIXED PANEL DISPLAY. CHIEF PAC525. REFERENCE DETAIL C3/T-501.
 - NEC UN552S DISPLAY. DETAIL SHOWS FIRST DISPLAY IN THE CHAIN.
 - 3/4" FIRE-RATED PLYWOOD BLOCKING. REFERENCE ARCHITECTURAL DRAWINGS.
 - 21.25"W X 21.46"H X 3.15" - 14.77"D VIDEO WALL DISPLAY MOUNT. PEERLESS DS-VW775. REFERENCE DETAIL C2/T-501. MUST INCLUDE PEERLESS DS-VWRS090 WALL SPACER WITH EACH MOUNT.

DETAILS - NEC PANEL INSTALLTION SCALE: NTS A3

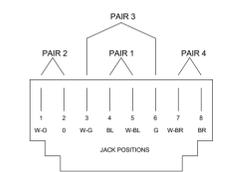

NOTE:
ALL DEVICES WIRED T568B AS SHOWN.

DETAILS - 568B WIRING DIAGRAM SCALE: 6" = 1'-0" A1

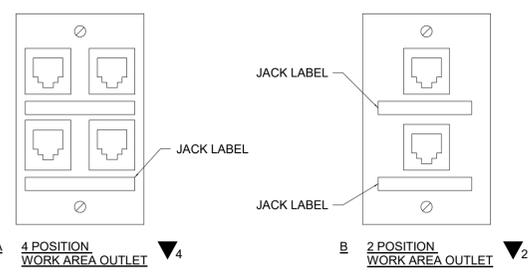

DETAILS - COVERPLATE SCALE: 6" = 1'-0" B1

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