**MAYOR** 

SYLVESTER TURNER

CITY COUNCIL MEMBERS

AMY PECK - DISTRICT A

JERRY DAVIS - DISTRICT B

ABBIE KAMIN - DISTRICT C

CAROLYN EVANS-SHABAZZ - DISTRICT D

DAVE MARTIN - DISCTRICT E

TIFFANY THOMAS - DISTRICT F

GREG TRAVIS - DISTRICT G

KARLA CISNEROS - DISTRICT H

**ROBERT GALLEGOS - DISTRICT I** 

EDWARD POLLARD - DISTRICT J

MARTHA CASTEX-TATUM - DISTRICT K

**AREA MAP** 

N.T.S.



BSG - CODE REVIEW STAMF

**CONTROLLER** 

### COUNCIL MEMBERS AT LARGE

MIKE KNOX - AT LARGE 1 DAVID ROBINSON - AT LARGE 2 MICHAEL KUBOSH - AT LARGE 3 LETITIA PLUMMER - AT LARGE 4 SALLIE ALCORN - AT LARGE 5

### CHRIS B. BROWN

HAS TERMINAL A FIDS & BID LED LIGHTS

INTERCONTINENTAL AIRPORT (IAH) PHASE TWO

TDLR# TABS2023011245

### PROJECT TEAM

### <u>OWNER</u> HOUSTON **AIRPORT SYSTEM**

7800 AIRPORT BLVD HOUSTON, TX 77061 713.640.3000 (P)

### <u>MEP</u>

**E&C ENGINEERS &** CONSULTANTS, INC.

1010 LAMAR ST, STE 650 HOUSTON, TX 77002 713.580.8800 (P)

### **ARCHITECT**


**ENGLISH + ASSOCIATES** ARCHITECTS, INC.

1919 DECATUR ST. HOUSTON, TX 77007 713.850.0400 (P)

### STRUCTURAL ENGINEER

GARZA + MCCLAIN STRUCTURA ENGINEERS,

INC., INC. 13313 SOUTHWEST **FREEWAY** SUITE 163 HOUSTON, TX 77478 713.271.2900 (P)

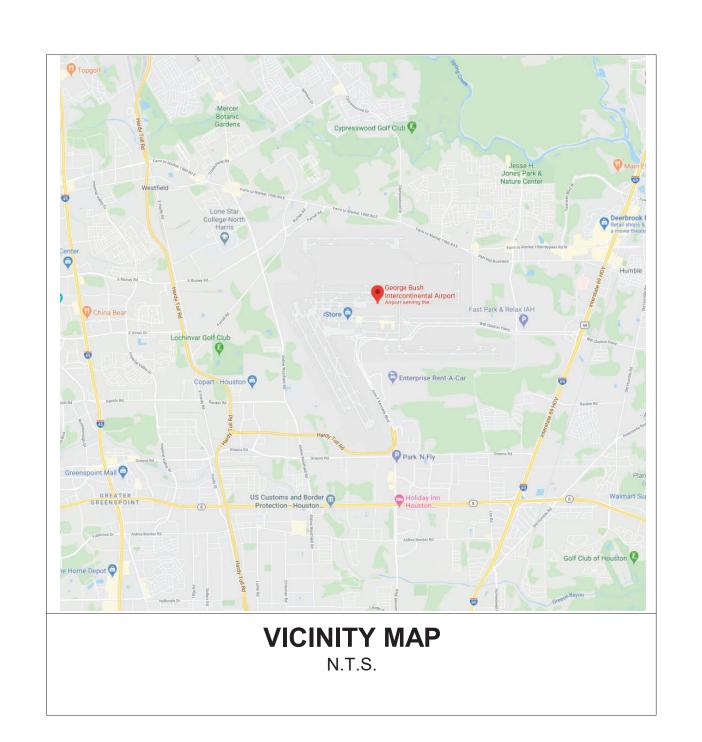



2800 N. TERMINAL RD. HOUSTON, TEXAS 77032 HAS TERMINAL A


FIDS & BID LED LIGHTS




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No.	DESCRIPTION	DATE	BY	
	PERMIT, BID & CONSTRUCTION	01/27/2023		
Α	ADDENDUM A	05/02/2023		


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ISSUE DATE:	01-27-2023
APPROVED BY:	KE
APPROVAL DATE:	


DIRECTOR of HOUSTON AIRPORT SYSTEM

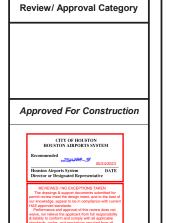

- G0 -

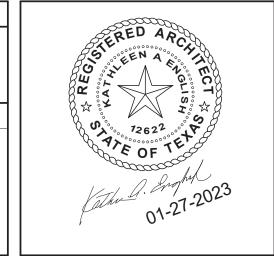

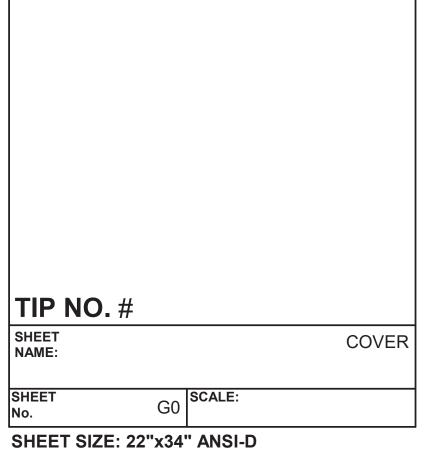

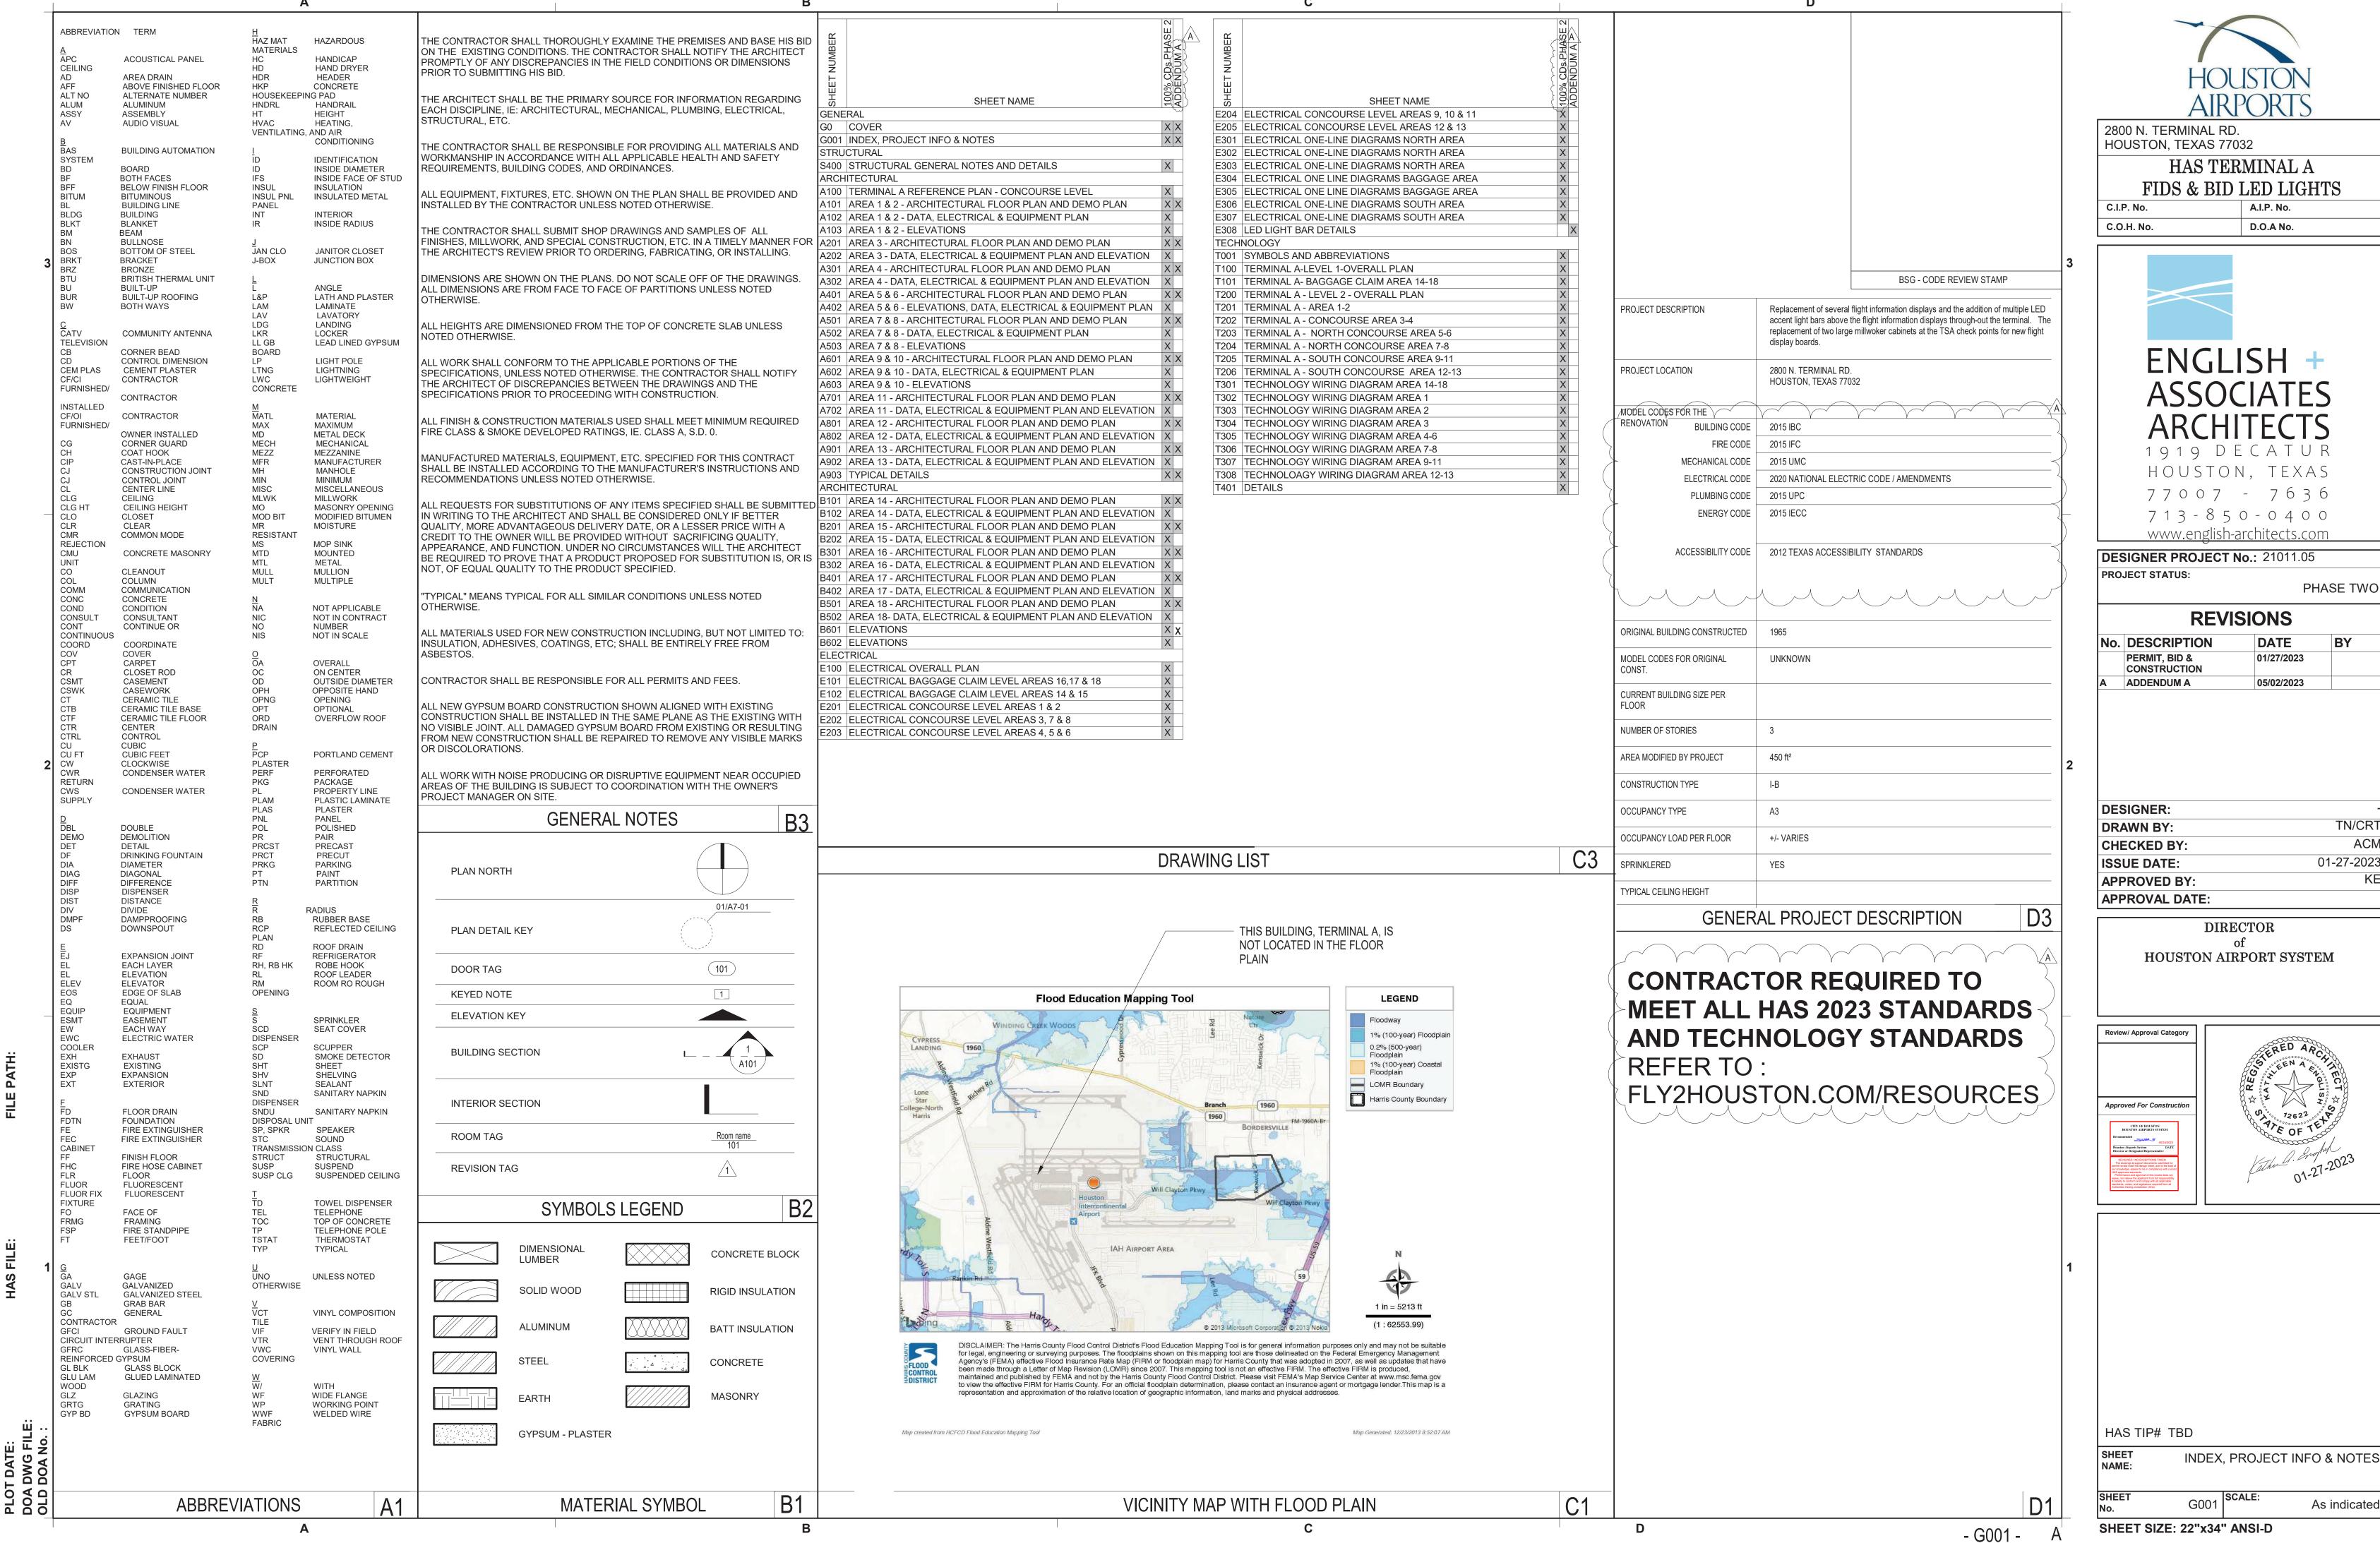

PHASE TWO

TN/CR 01-27-202



INDEX, PROJECT INFO & NOTES

members, and construction.

B. The General Contractor shall compare the Architectural, Structural Mechanical, Electrical, Plumbing, and other series drawings and report any discrepancies between each set of drawings and within each set of drawings prior to fabrication and installation of any structural members.

C. The details designated as "Typical Details" apply generally to the Drawings in all areas where conditions are similar to those described in the details.

D. All structural elements of the project have been designed by the Structural Engineer to resist the required code vertical and lateral forces that could occur in the final completed structure only. It is the responsibility of the Contractor to provide all required bracing during construction to maintain the stability and safety of all structural elements during the construction process.

E. The Contract Structural Drawings and Specifications represent the finished structure, and except where specifically shown, do not indicate the means or methods of construction. The Contractor and their Sub-Contractors shall supervise and direct the Work and shall be solely responsible for all construction means, methods, procedures, techniques, sequences and safety measures including, but not limited to, adherences to all OSHA guidelines. The Engineer shall not have control of, and shall not be responsible for, construction means, methods, techniques, sequences or procedures, for safety precautions and programs in connection with the Work, for the acts or omissions of the Contractor, Subcontractors, or any other person performing any of the Work, or for the failure of any of these persons to carry out the Work in accordance with the Contract Documents.

F. Where conflict exists among the various parts of the structural contract documents, structural drawings, general notes, and specifications, the strictest requirements, as indicated by the Engineer, shall govern.

G. Periodic site observation by field representatives of Garza + McLain Structural Engineers, Inc.is solely for the purpose of determining if the Work is proceeding in accordance with the Structural Contract Documents. This limited site observation is not intended to be a check of the quality or quantity of the Work, but rather a periodic check in an effort to inform the Owner against defects and deficiencies in the work of the Contractor.

#### II. <u>DESIGN LOADS</u>

A. Dead Loads Monitors 55 lbs.

#### III. SUBMITTALS

A. Shop drawings shall be prepared for all structural items and submitted for review by the Engineer. Contract Drawings shall not be reproduced and used as shop drawings. All items deviating from the Contract Drawings or from previously submitted shop drawings shall be clouded.

B. The contractor shall review shop drawings for compliance with the contract documents and shall certify that he has done so by a stamp noting that the drawings have been "Approved" and which bears the signature (or initials) of an authorized representative of the contractor and the date.

C. Corrections or comments on shop drawings do not relieve the contractor from compliance with requirements of the plans and specifications. The engineer's review is for general conformance with the requirements of the contract documents. The contractor is responsible for confirming and correcting all quantities and dimensions, selecting fabrication processes and techniques of construction, and coordinating his work with that of all other contractors.

D. General Contractor shall provide electronic PDF's of all shop drawings for the Engineer to review.

### E. Shop Drawings

1. The General Contractor shall submit for Engineer review shop drawings for the following items: a. Misc. Steel

2. The omission from the shop drawings of any material required by the Contract Documents to be furnished shall not relieve the Contractor of the responsibility of furnishing and installing such materials, regardless of whether the shop drawings have been reviewed and approved.

### V. TESTING LABORATORY SERVICES

A. Work specified herein shall be performed by a qualified Independent Testing Laboratory, selected and paid by the Contractor. The Contractor shall be responsible for notifying the Independent Testing Laboratory at least 24 hours of advance of materials that require testing. The contractor shall pay for all retests of materials not meeting the requirements in the Contract Documents. Reports of each Test shall be prepared by the Independent Testing Laboratory and submitted promptly to the Owner, Contractor, Architect, and Engineer. Items found not to comply with the Construction Documents shall be brought to the immediate attention of the Contractor and Architect/ Engineer for resolution.

### B. Structural Steel or Aluminium Framing

1. Check all members are correct shape

2. Visual inspect all connections

3. Visually inspect all welds 4. Verify all bolted connections that bolts are

### installed correctly

### VI. STRUCTURAL STEEL A. Material

1. All hot drilled steel members shall be new and conform to ASTM

specification A6.

2. ASTM Specification and Grade. Clearly mark the grade on each member. 3. Unless noted otherwise structural steel members shall be:

a. Structural steel plate shall conform to 316 stainless b. Angles shall conform to 316 stainless

### B. Fabrication

1. Fabricate and assemble structural assemblies in shop to greatest extent

2. Dimensional tolerances of fabricated structural steel shall conform to

Section 6.4 of the AISC Code of Standard Practice unless noted otherwise. 3. Splicing of structural steel members is prohibited without prior approval of the Engineer as to location and type of splice to be made. Any member

having splice not shown and detailed on shop drawings will be rejected. 4. All HSS Members Shall have Fitted End Caps.

#### C. Erection

1. Erection tolerances of anchor bolts, embedded items, and all structural steel unless specified otherwise on the drawings shall conform to the AISC Code of Standard Practice.

2. Field cutting of structural steel or any field modifications to structural steel shall not be made without prior approval of the Engineer.

#### D. Welded Connections

1. All welding shall conform to ANSI/AWS D1.1 latest edition.

2. Fillet welds with no size specified shall be 3/16" or minimum size

3. All welding electrodes shall conform to ASTM A743, A744

E. Unless noted otherwise on the drawings, Bolts shall be 3/4" diameter and conform to ASTM A325. Bolts shall be designed using values for bearing type bolts with thread allowed in the shear plane 316 stainless.

1. Bolts shall be tightened to "snug tight" as defined by AISC U.N.O.

#### 13313 Southwest Freeway, Suite 163 Sugar Land, Texas 77478 (281) 494-1230 (voice) (281) 494-1234 (fax) - LED LIGHT, $\neg HSS3x3x1/4 (SS)$ KT.O. HSS \_\_\_ \_ \_ \_ \_ \_ \_ \_ \_ \_ \_ NEW MONITOR, SEE ARCH'L, CONNECT INTO PLATE PER MFR REQUIREMENTS P %"x12"x2'-11" -\_\_\_ \_ \_ \_ \_ \_ \_ \_ \_ \_ \_ \_ \_ \_ \_

Garza + McLain

T.O. BAGGAGE

PLATFORM

FIN FLOOR

BSG - CODE REVIEW STAMP

<u>DETAIL NOTES:</u>
1. FIELD VERIFY EXISTING CONNECTION PRIOR TO

FABRICATING STEEL.

2. NOTATION THUS: (SS) INDICATES STAINLESS STEEL. 3. CONTRACTOR TO ATTACH MONITOR TO PLATE PROVIDED.

(SS) WELDED TO

凡 ½"x9"x0'-9" —

(SS) ATTACHED

(SS) MIN EMBED


WITH (4) ½"ø EXP ANCHORS

2¾" TYP.


HSS POSTS

**MONITOR STAND ELEVATION AREA 14, 15, 16, AND 17** 

SCALE: 1/2" = 1'-0"

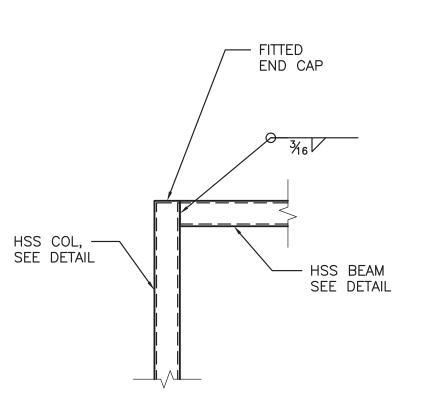

**DETAIL** SCALE: 1" = 1'-0"

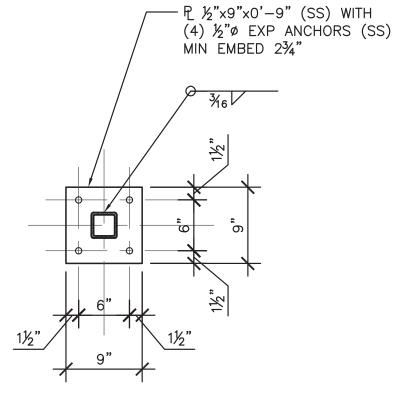


**MONITOR STAND BASE PLATE DETAIL** SCALE: 1" = 1'-0"




2800 N. TERMINAL RD. HOUSTON, TEXAS 77032 HAS TERMINAL A FIDS & BID LED LIGHTS A.I.P. No. C.I.P. No. C.O.H. No. D.O.A No.



	SIGNER PROJECT I JECT STATUS:	<b>NO.:</b> 21011.03	
	PHASE TWO		
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	PERMIT, BID & CONSTRUCTION	01-27-2023	
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ISSUE DATE:			06-30-20
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API	PROVAL DATE:		

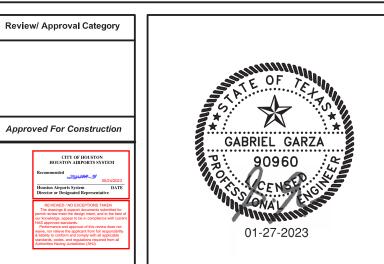


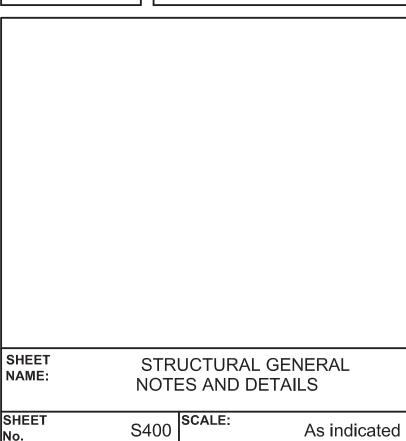

STRUCTURAL GENERAL NOTES

SCALE: NTS

- sheet

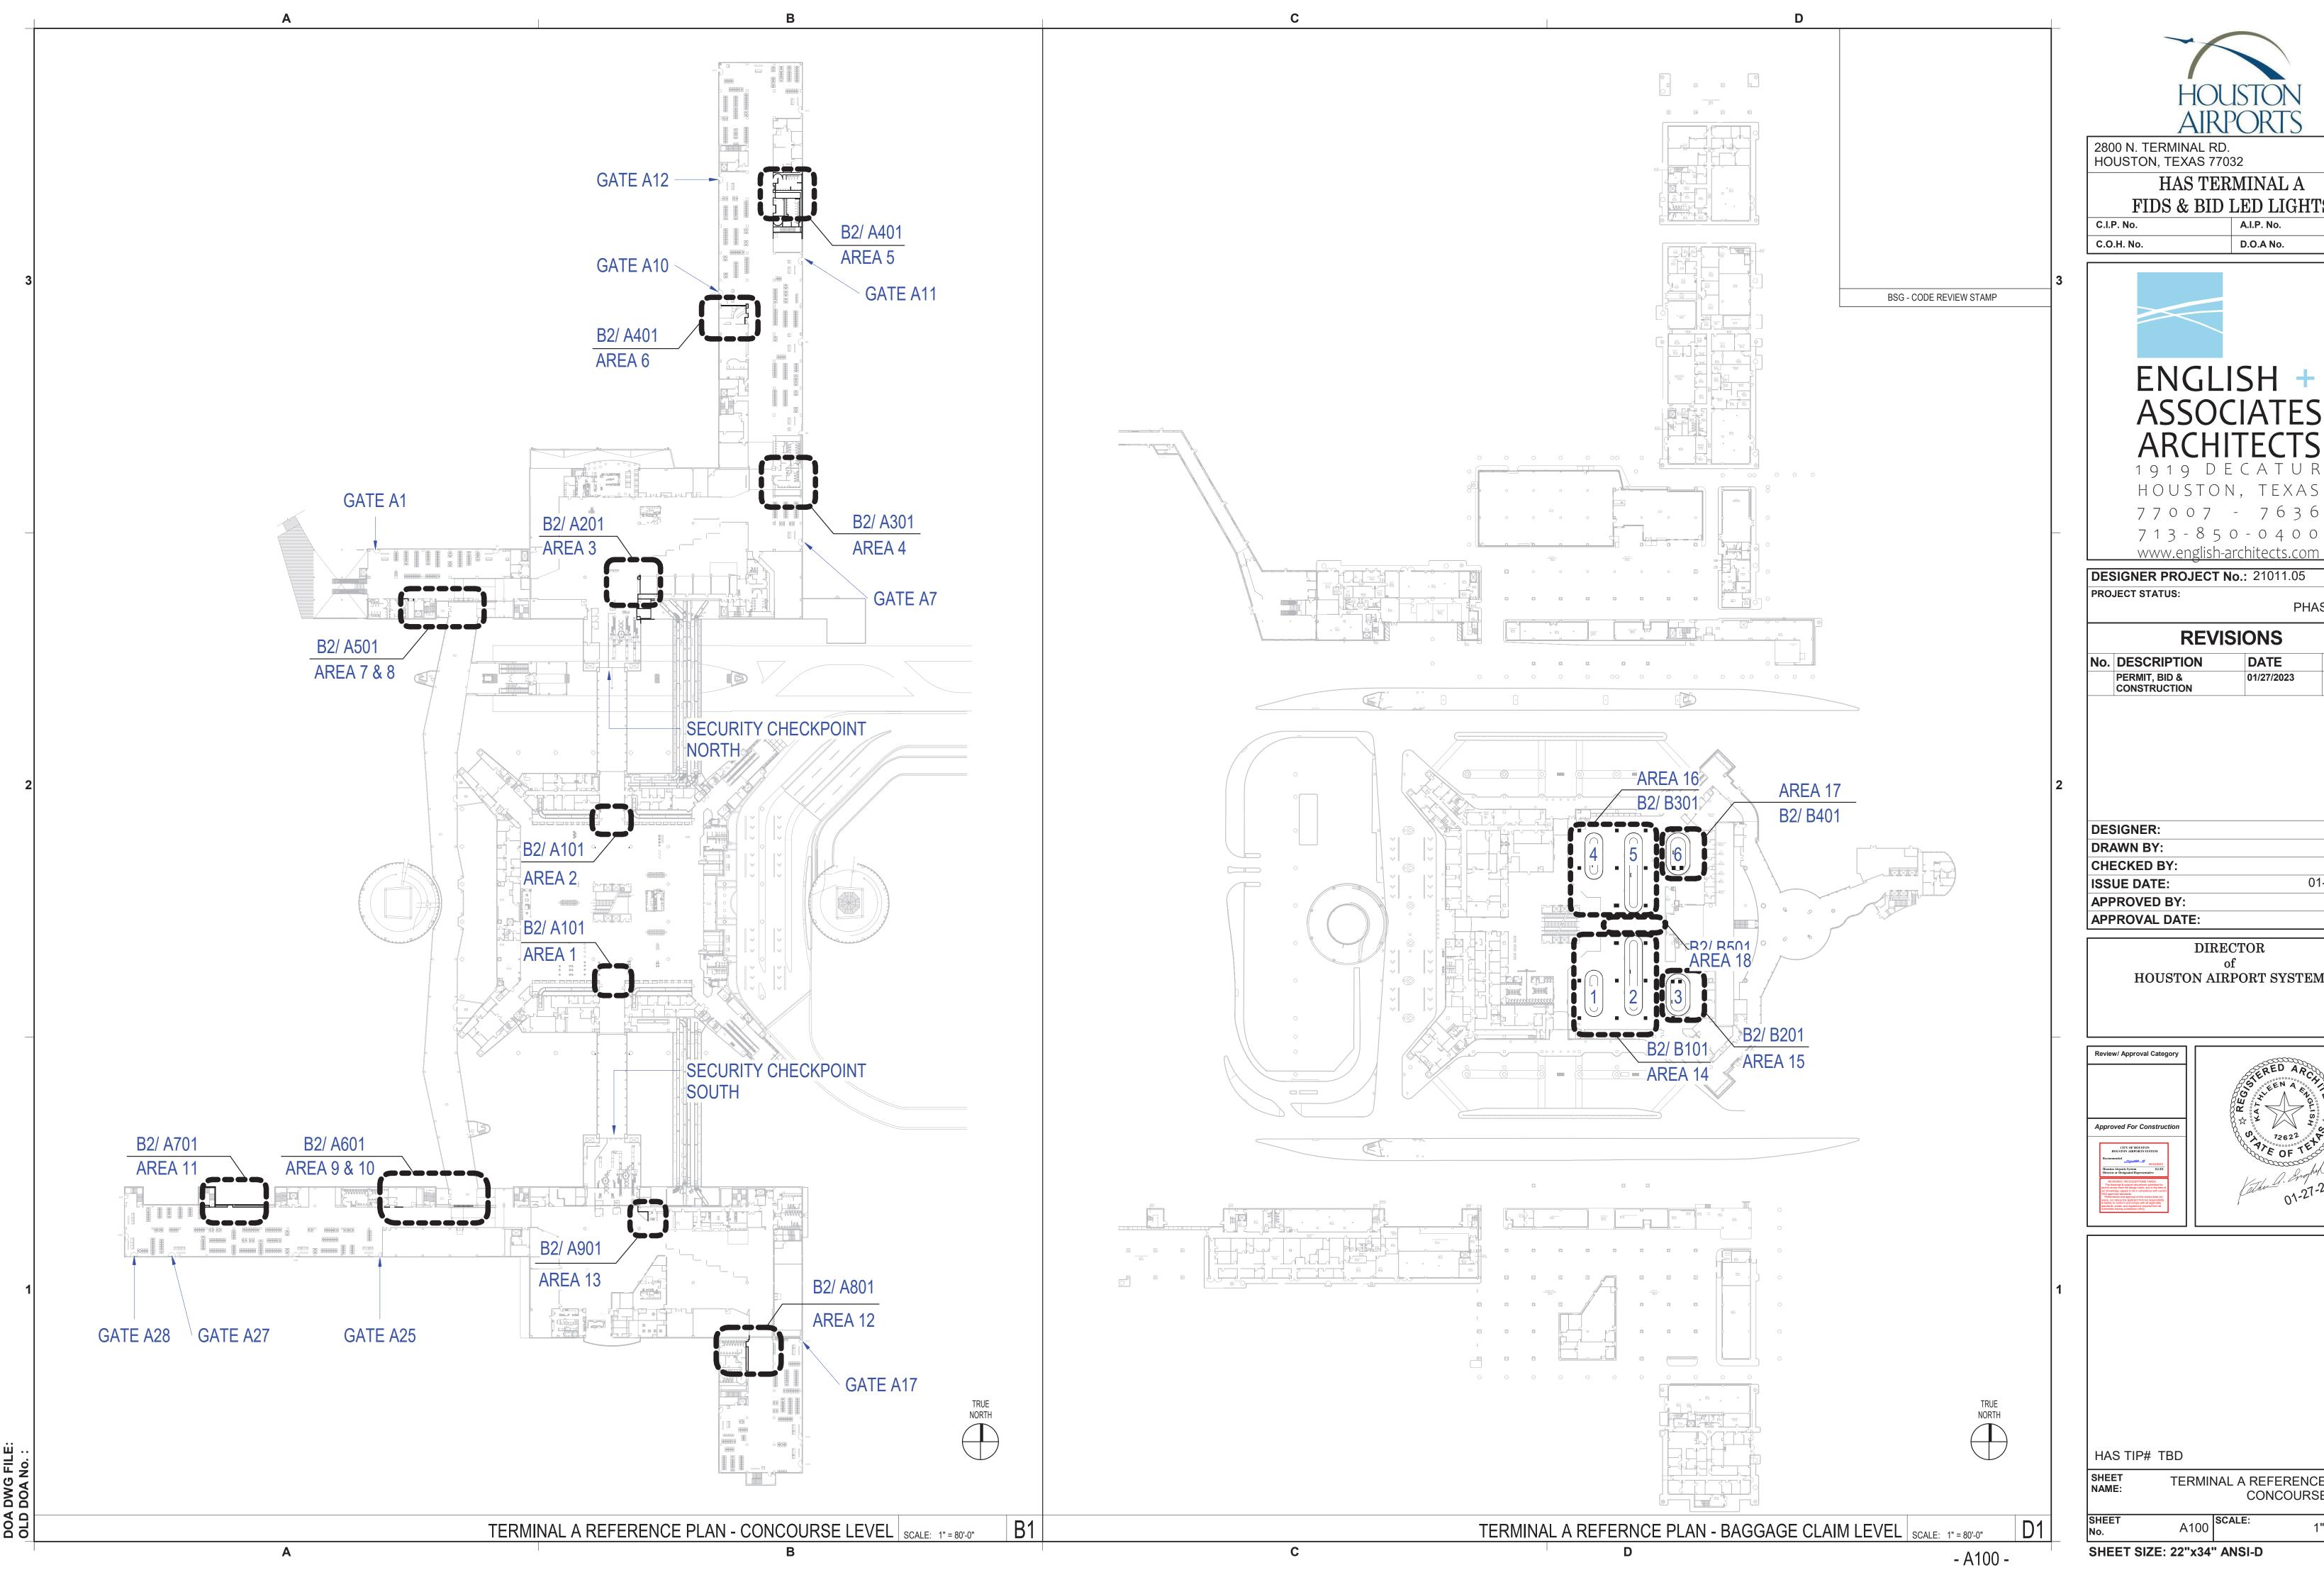



HAS TERMINAL A

FIDS & BID LED LIGHTS



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BY


01-27-2023

TN/CR1

HOUSTON AIRPORT SYSTEM



TERMINAL A REFERENCE PLAN -CONCOURSE LEVEL 1" = 80'-0"

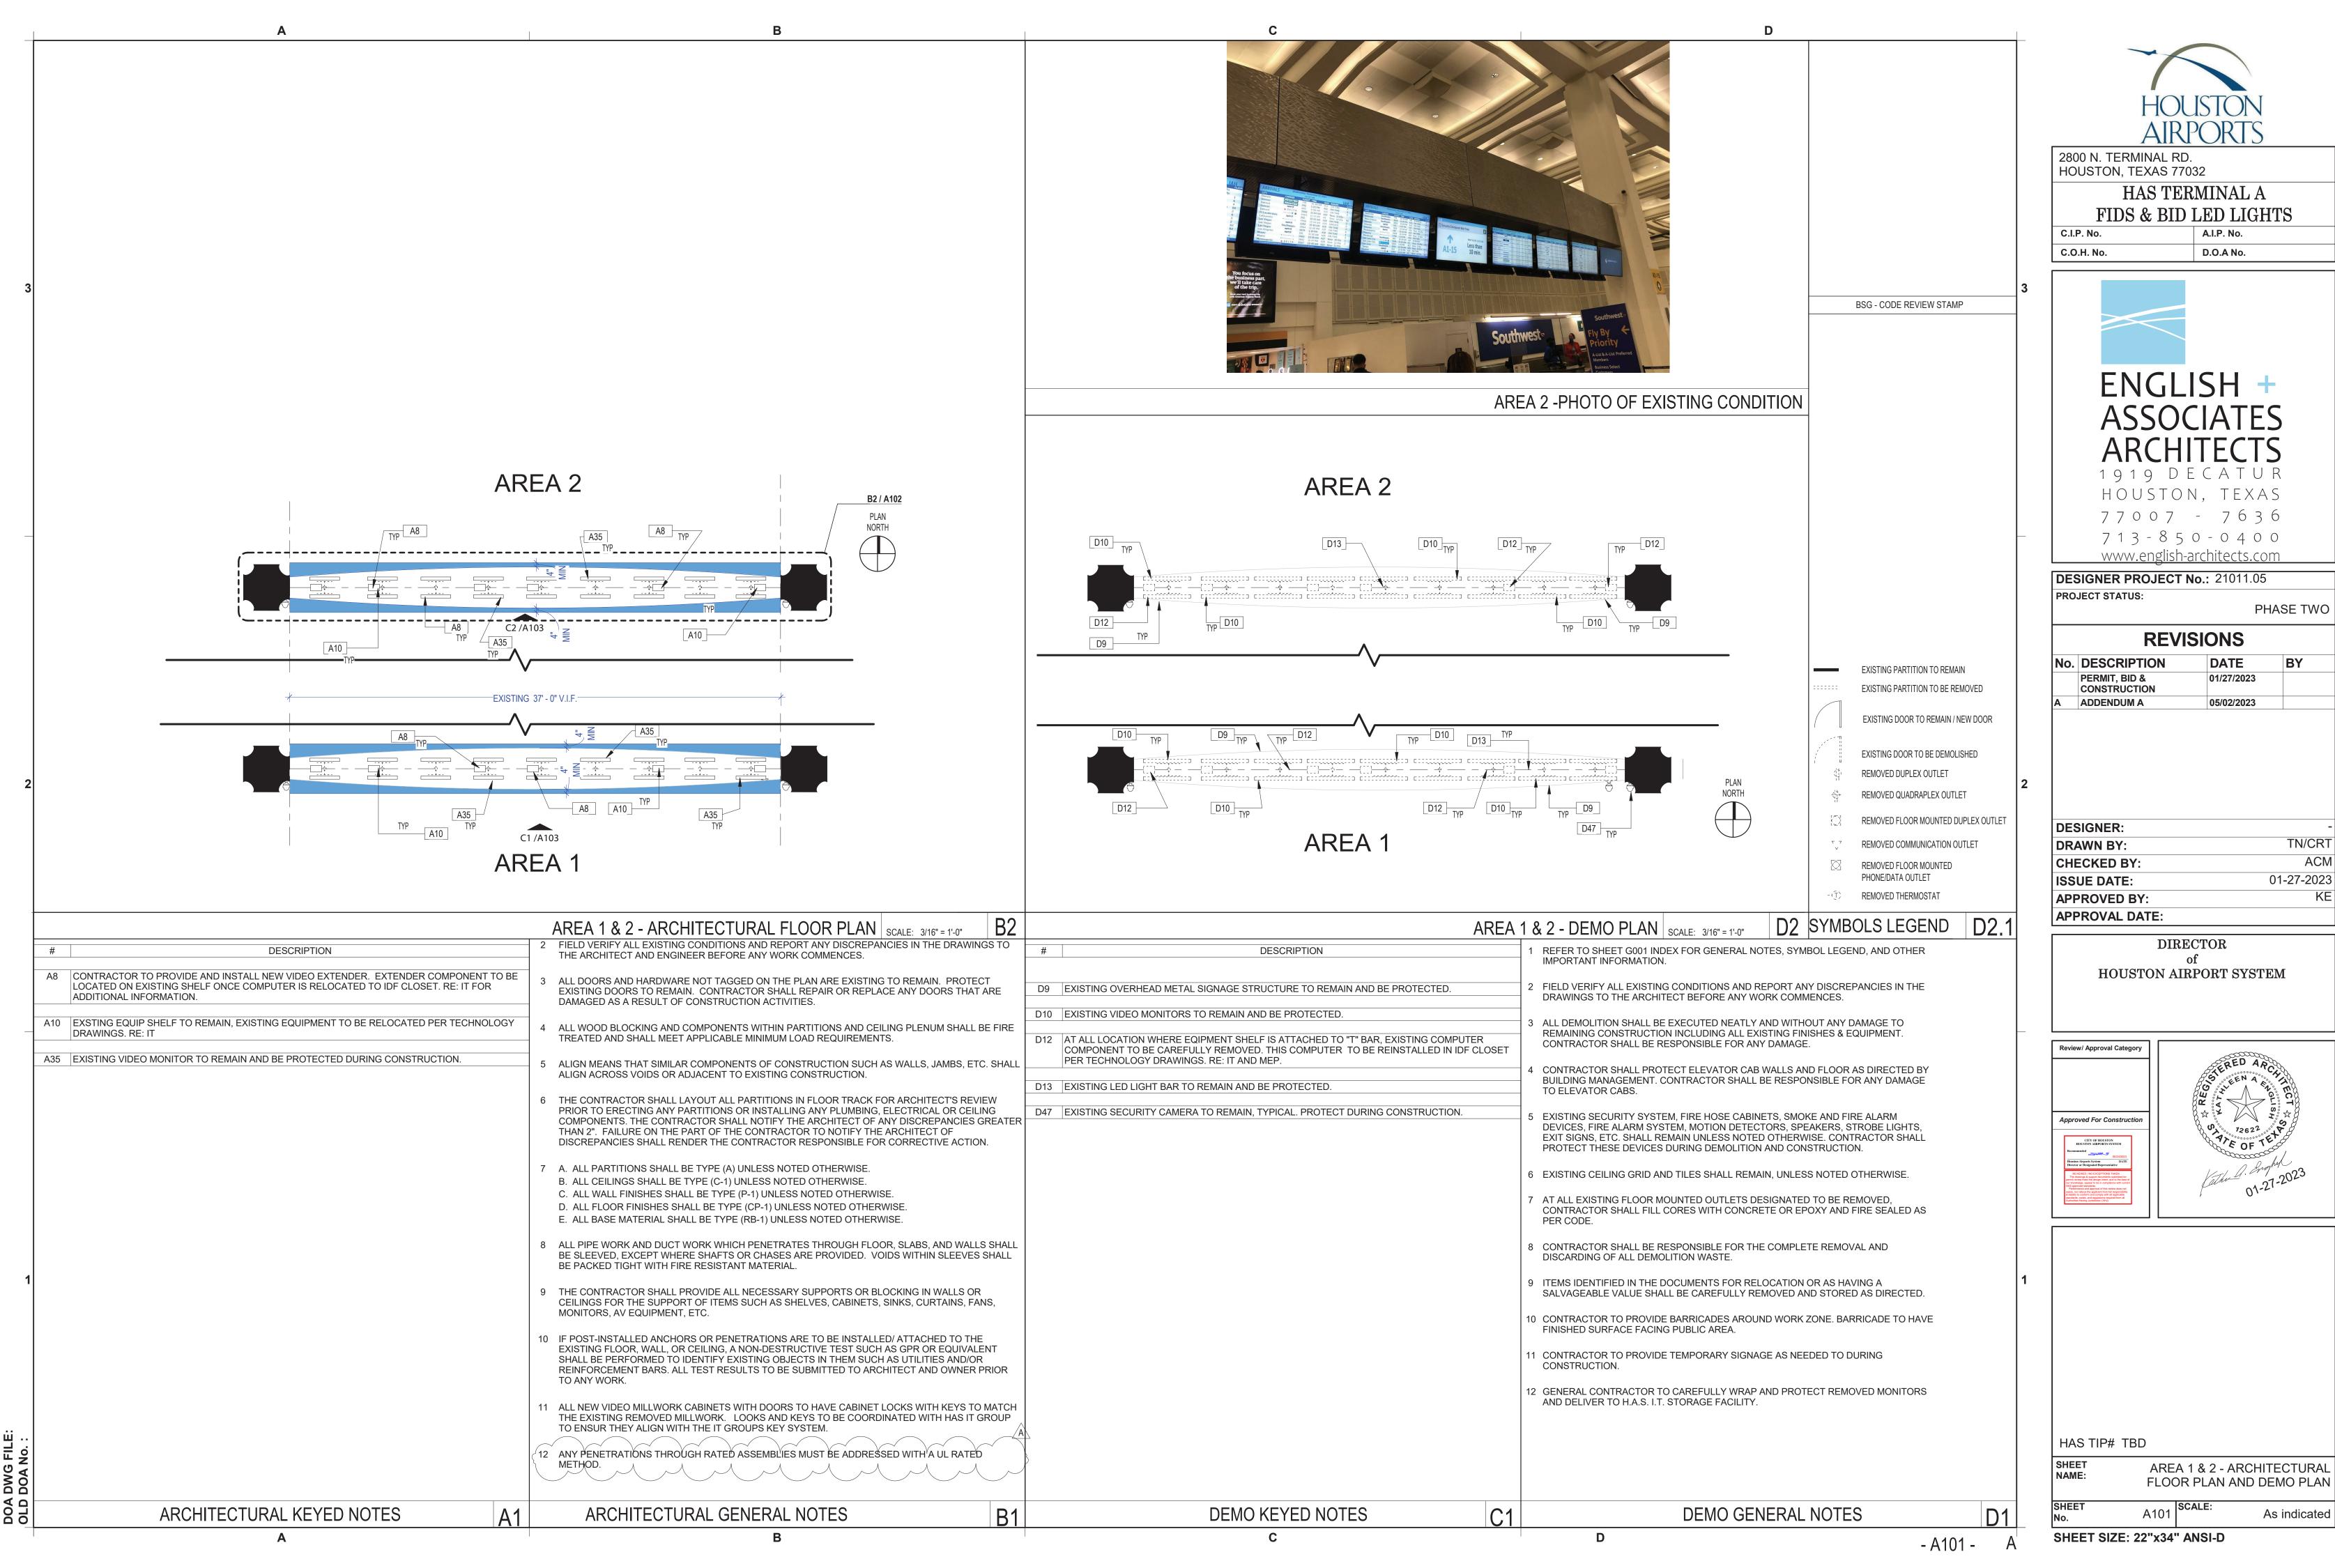



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PHASE TWO


## BY 01/27/2023

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DRAWN BY:	TN/CRT
CHECKED BY:	ACM
ISSUE DATE:	01-27-2023
APPROVED BY:	KE
APPROVAL DATE:	

# HOUSTON AIRPORT SYSTEM



AREA 1 & 2 - ARCHITECTURAL FLOOR PLAN AND DEMO PLAN

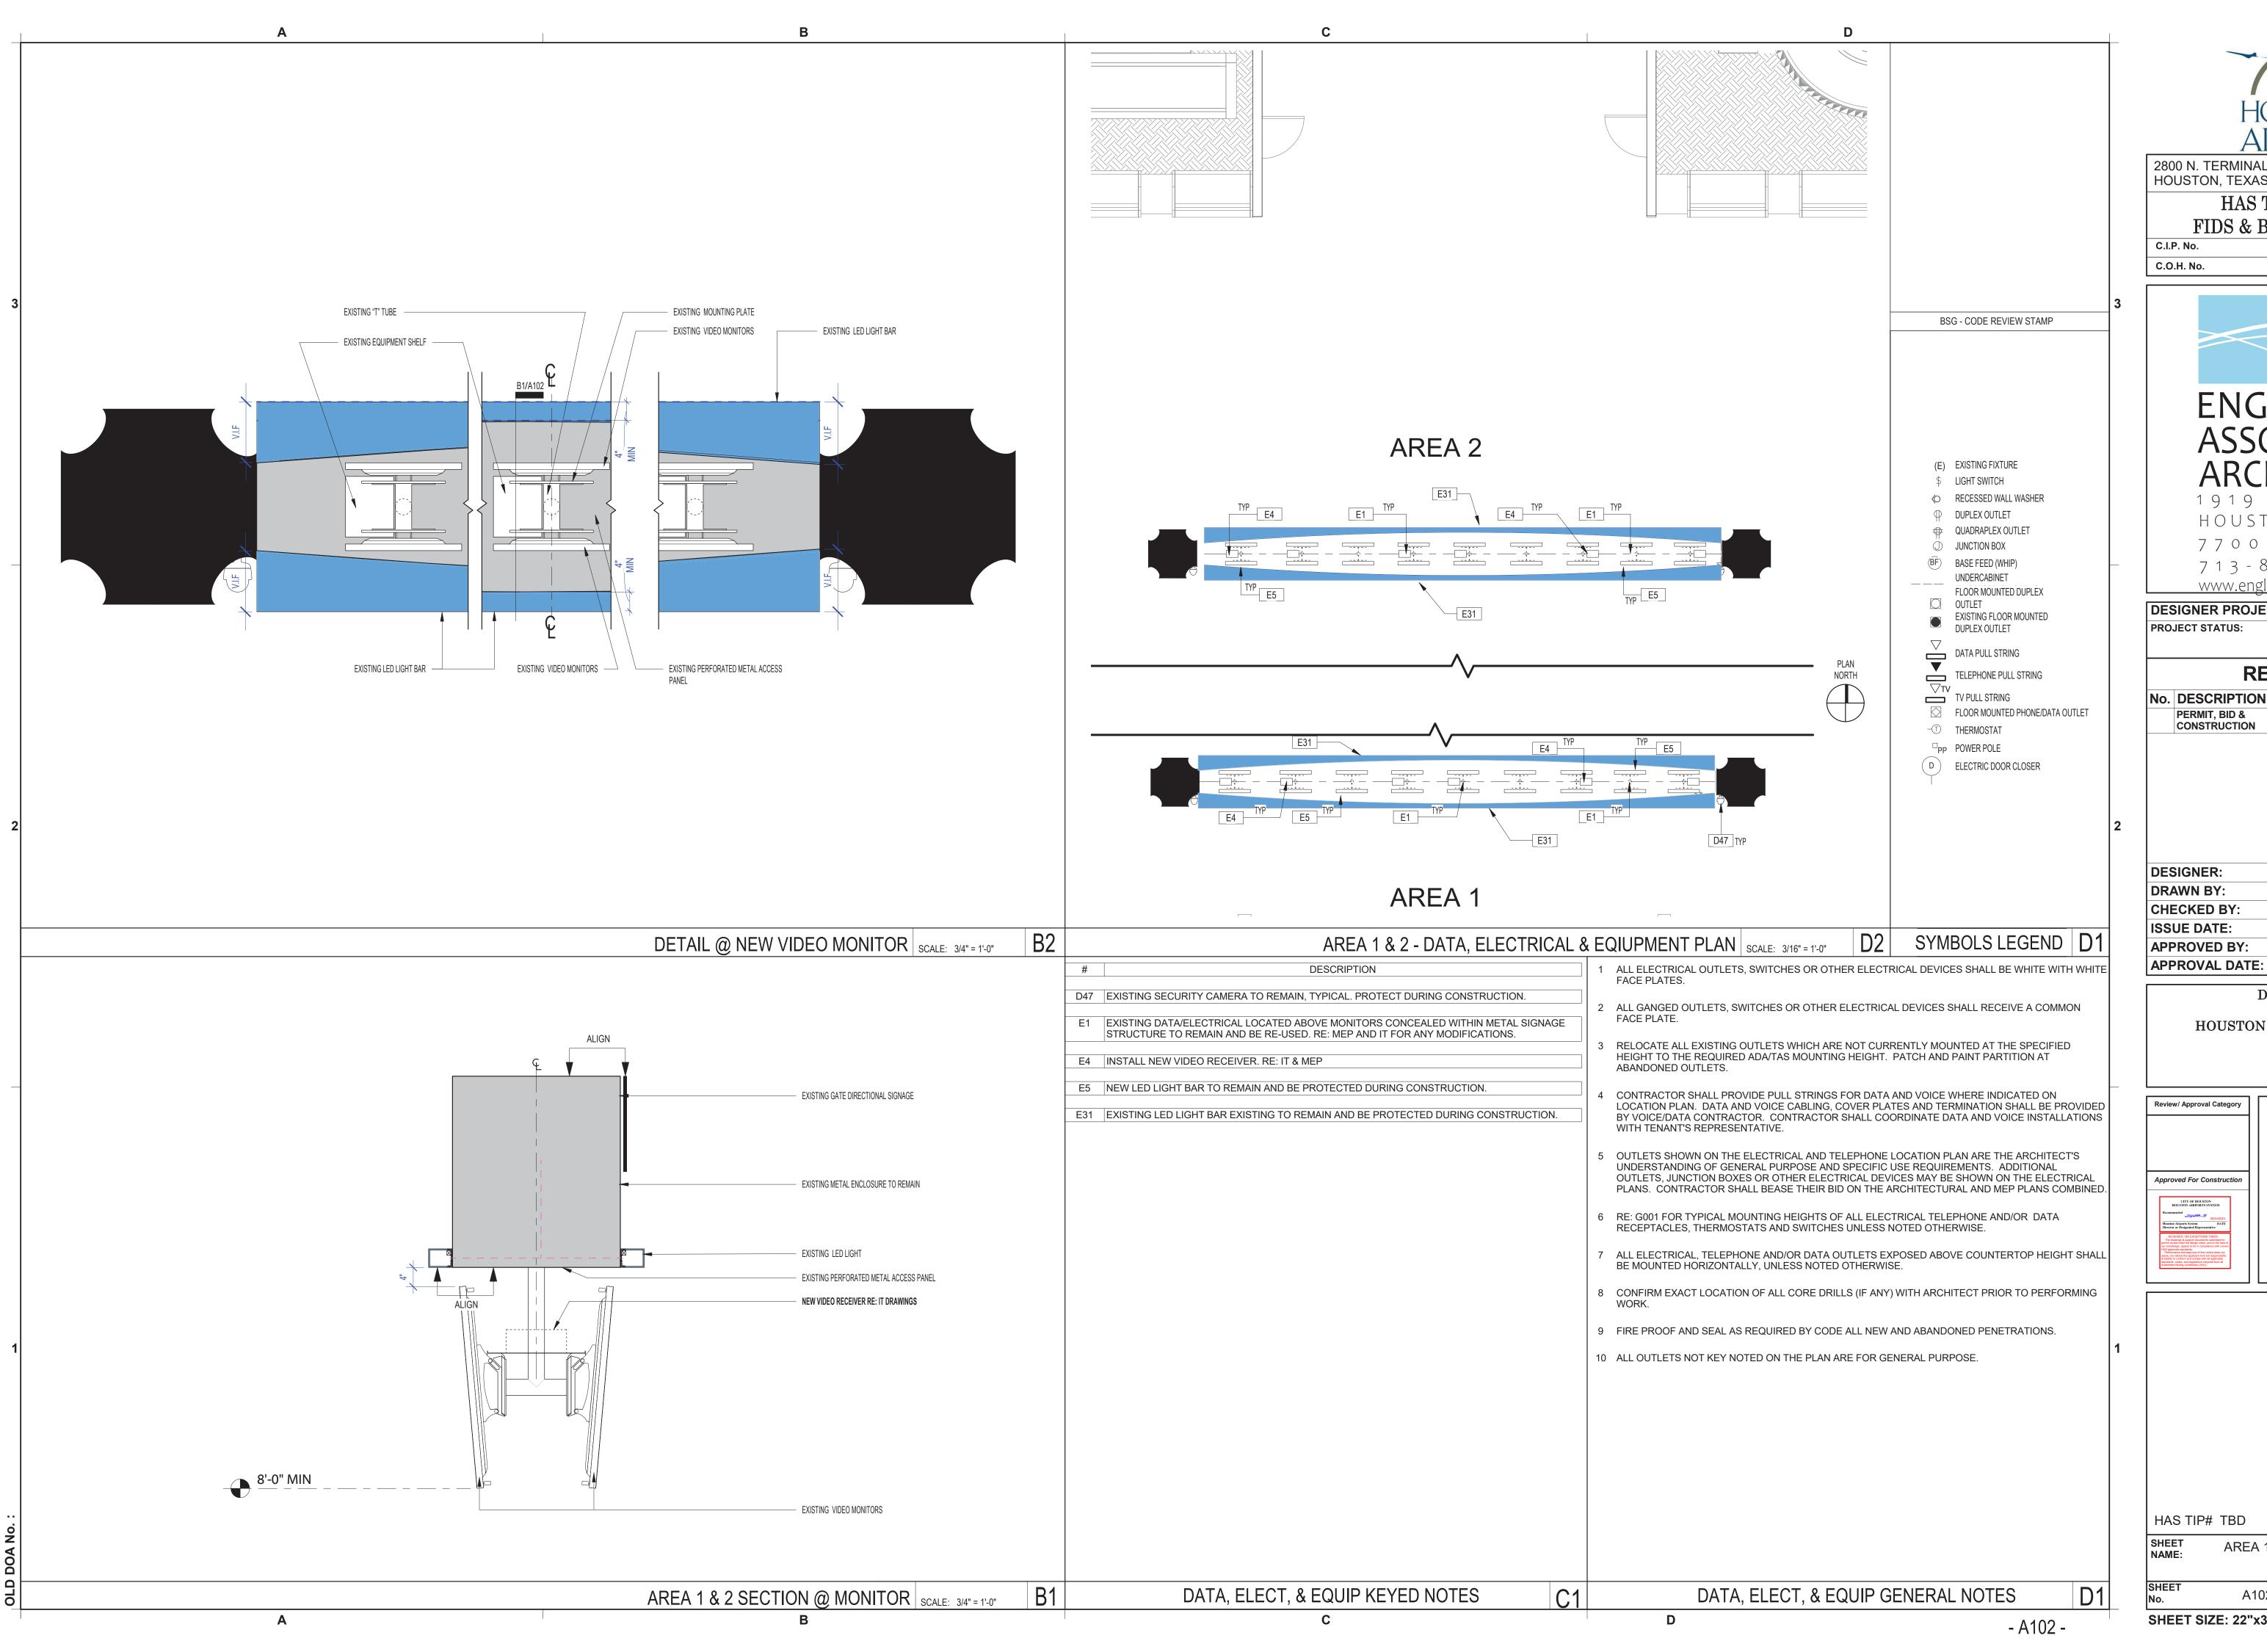



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### HAS TERMINAL A FIDS & BID LED LIGHTS

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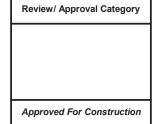
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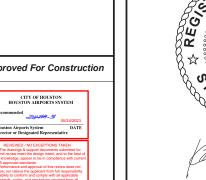
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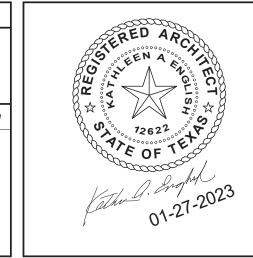
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	PERMIT, BID & CONSTRUCTION	01/27/2023	

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APPROVED BY:	KE
APPROVAL DATE:	

DIRECTOR HOUSTON AIRPORT SYSTEM









HAS TIP# TBD

AREA 1 & 2 - DATA, ELECTRICAL & EQUIPMENT PLAN A102 SCALE:

As indicated

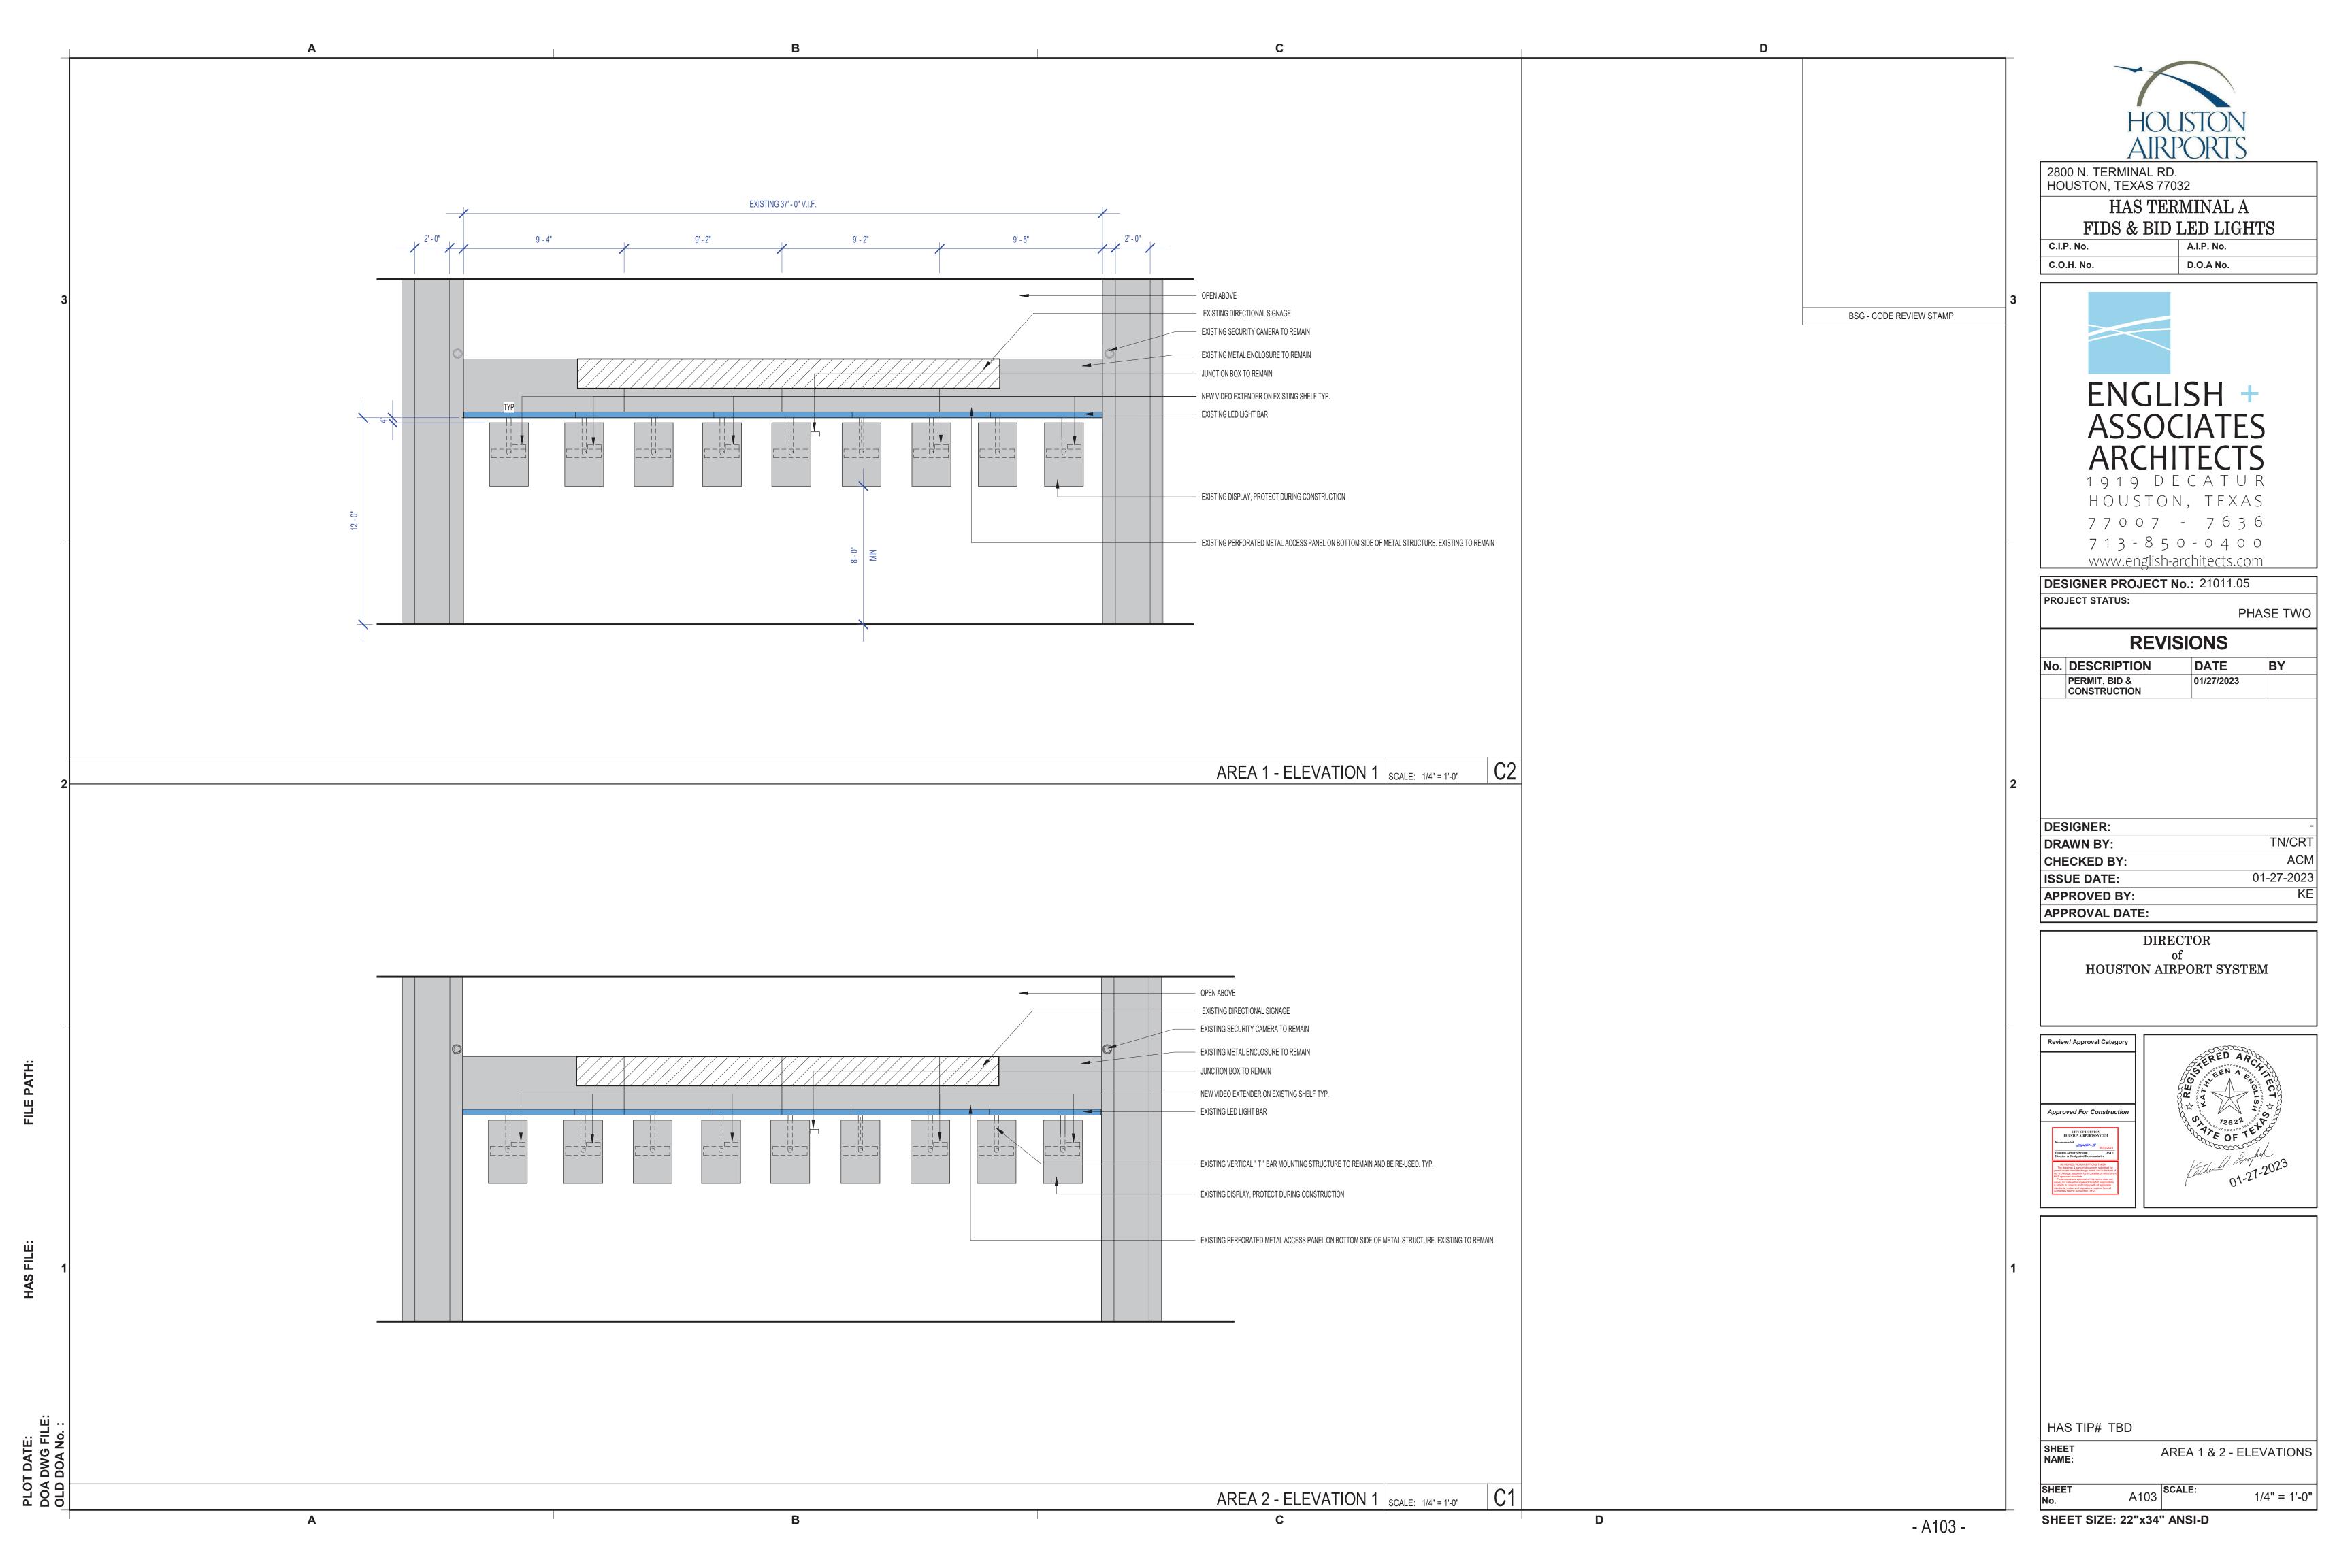


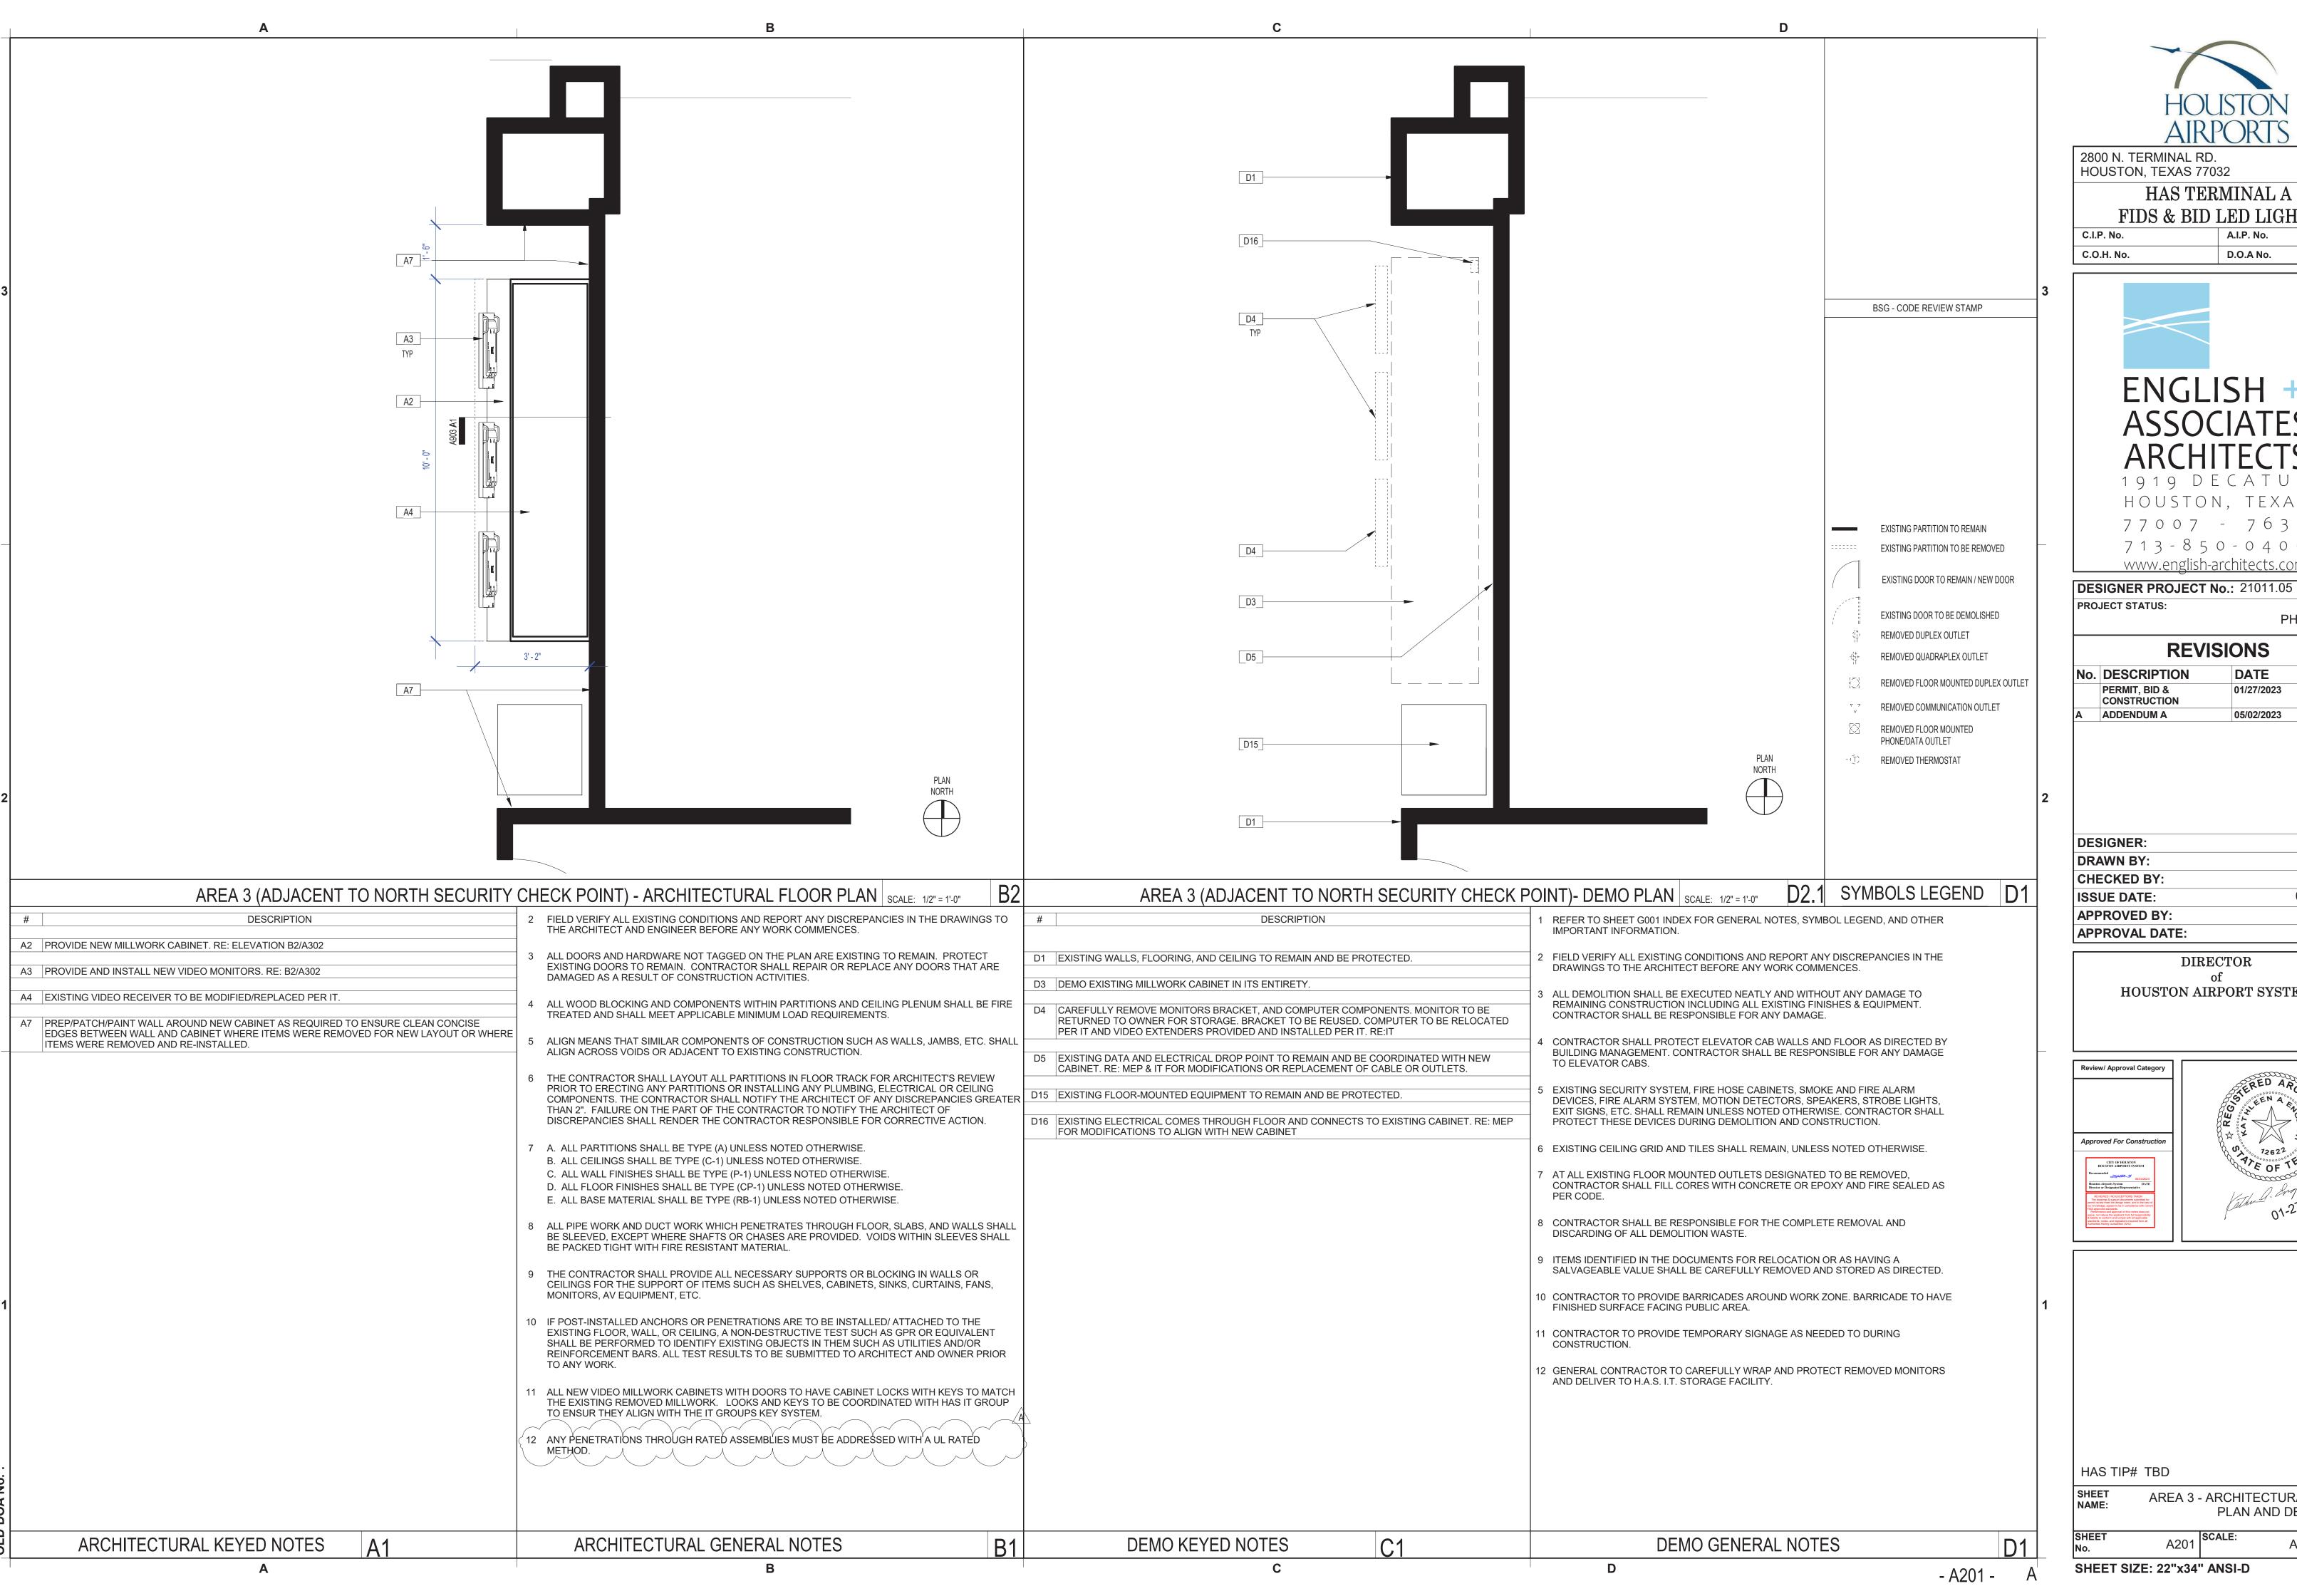



HOUSTON, TEXAS 77032

HAS TERMINAL A FIDS & BID LED LIGHTS

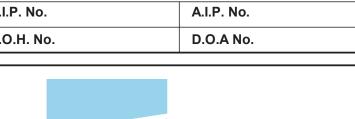



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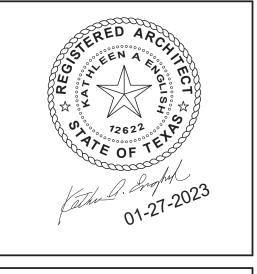
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	PERMIT, BID &	01/27/2023	
	CONSTRUCTION		
A	ADDENDUM A	05/02/2023	

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CHECKED BY:	ACM
ISSUE DATE:	01-27-2023
APPROVED BY:	KE
APPROVAL DATE:	


DIRECTOR HOUSTON AIRPORT SYSTEM





As indicated

AREA 3 - ARCHITECTURAL FLOOR PLAN AND DEMO PLAN

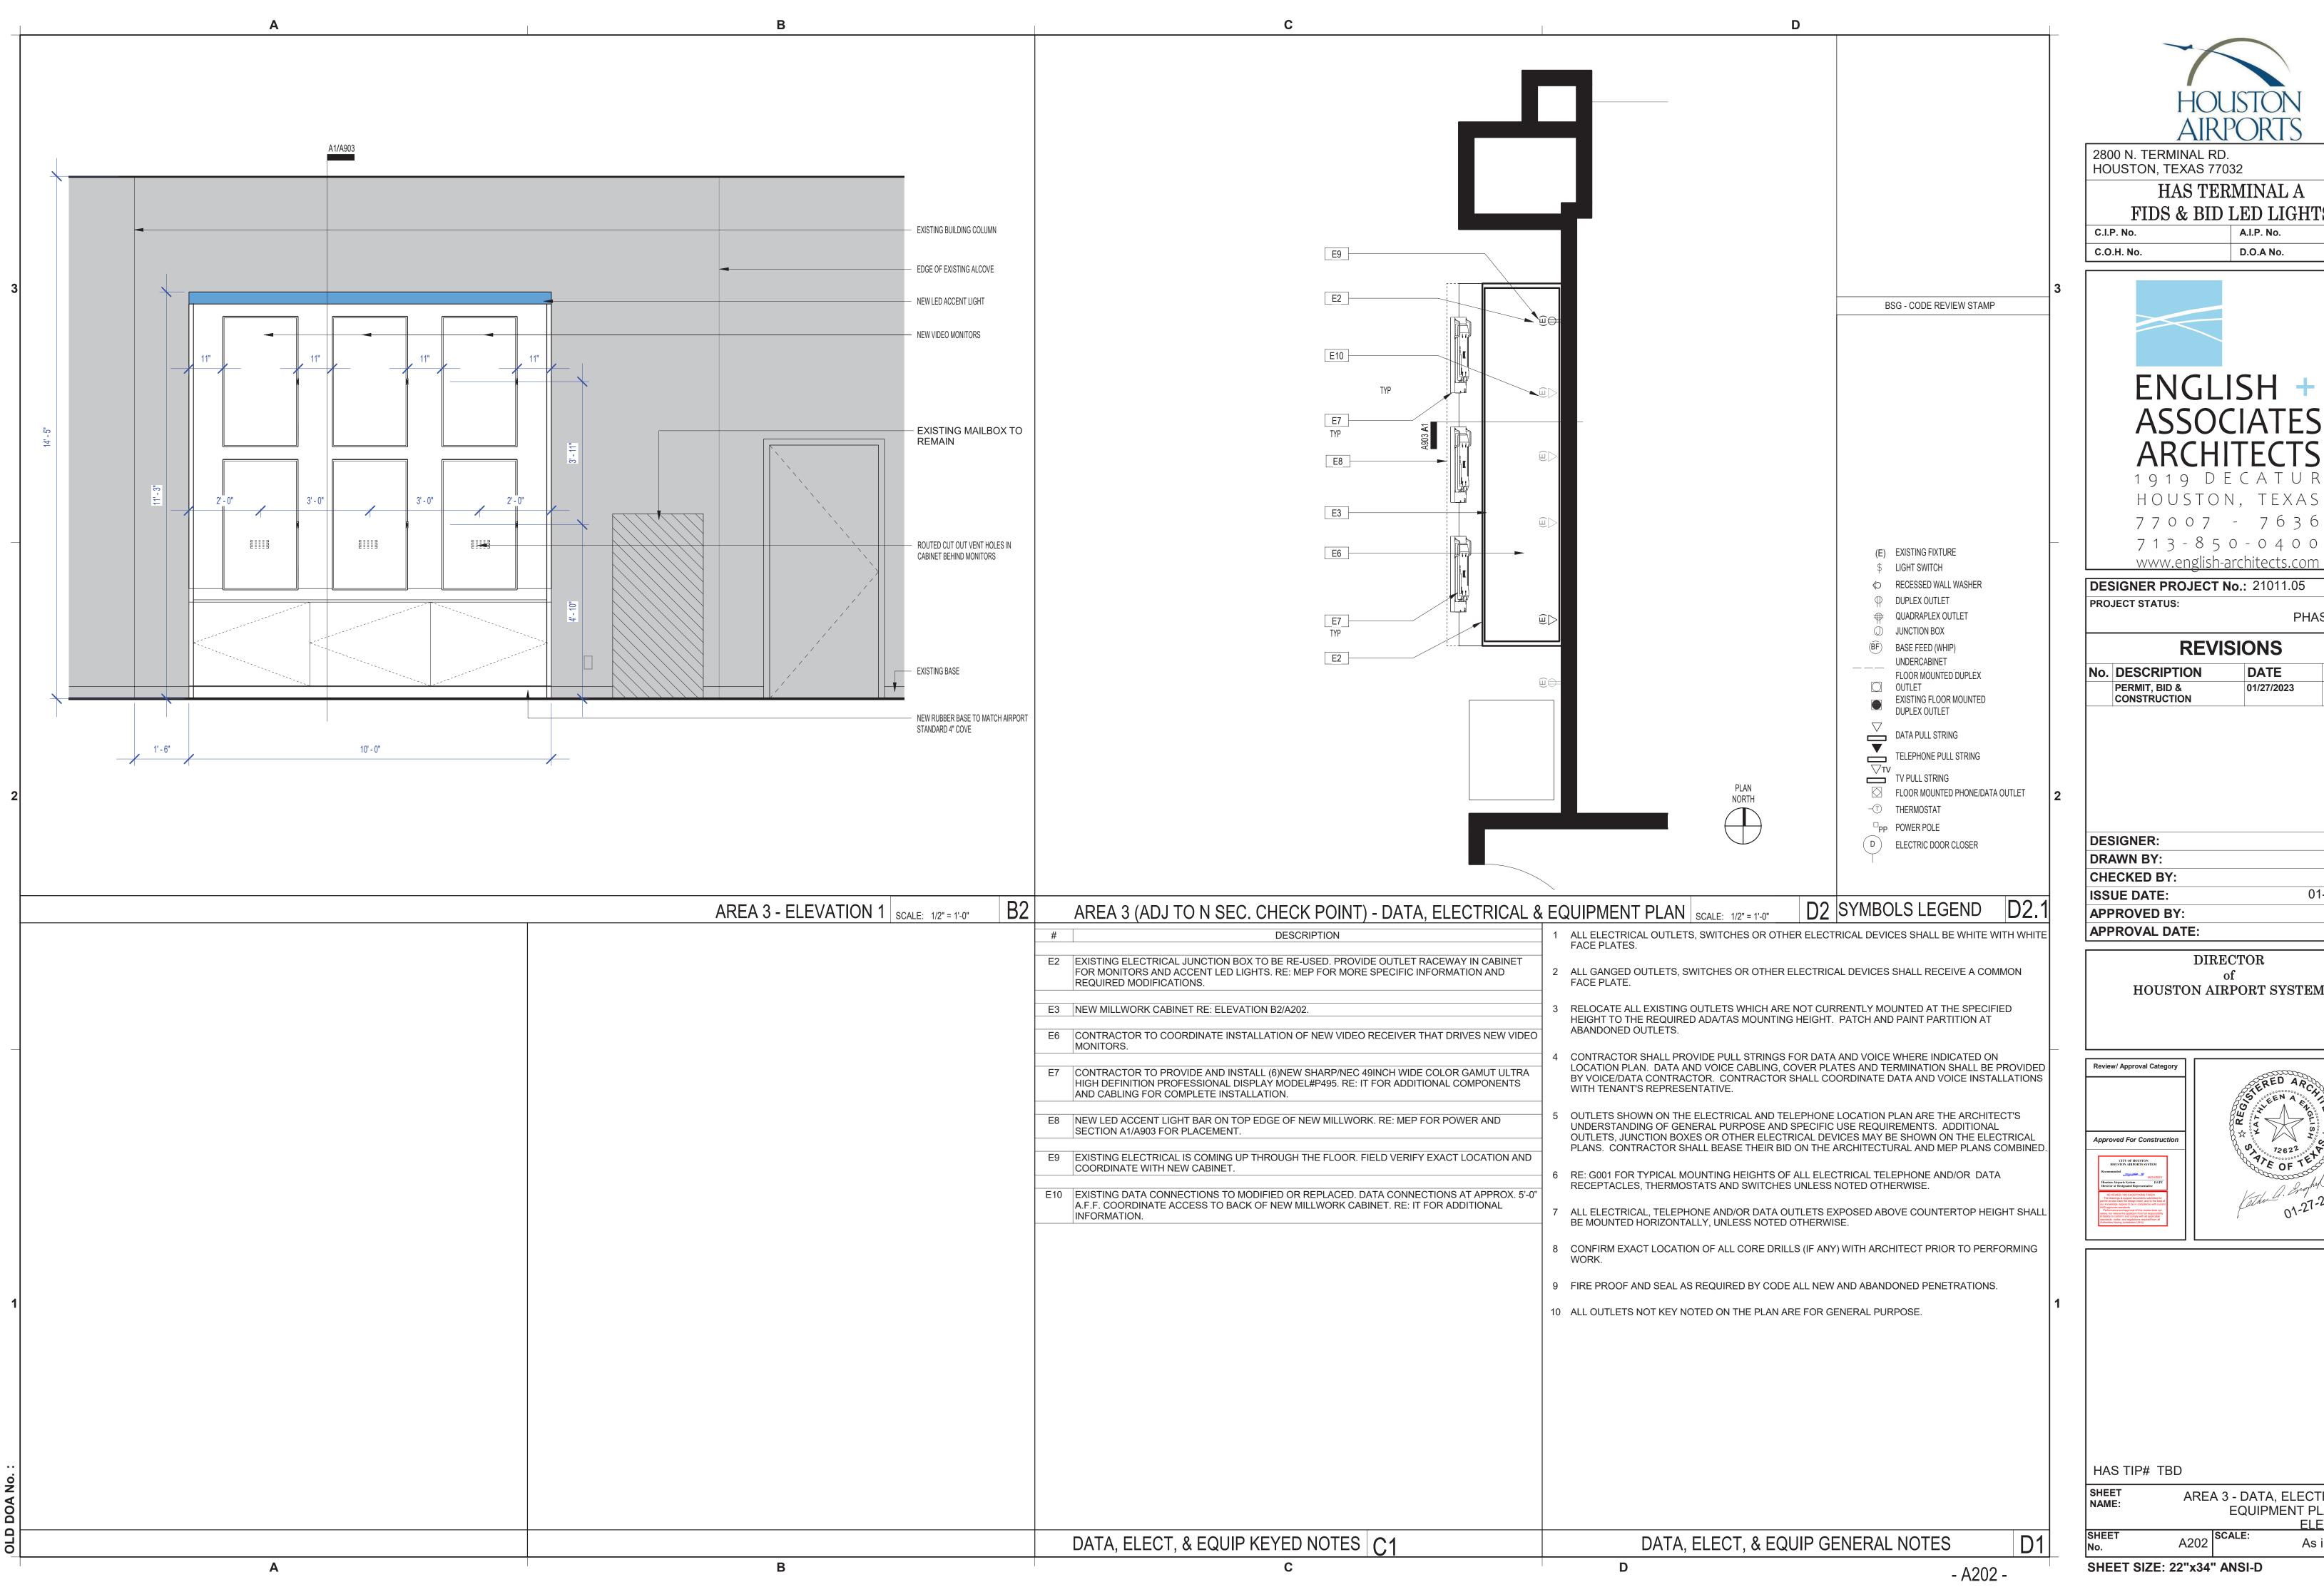



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HAS TERMINAL A FIDS & BID LED LIGHTS

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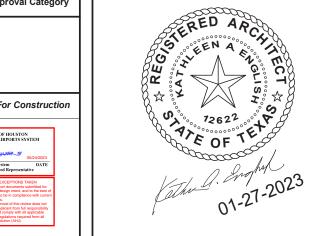
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**REVISIONS** No. DESCRIPTION DATE BY PERMIT, BID & 01/27/2023 CONSTRUCTION

**DESIGNER:** TN/CR1 **DRAWN BY:** ACM **CHECKED BY:** 01-27-2023 **ISSUE DATE:** APPROVED BY: APPROVAL DATE:


> DIRECTOR HOUSTON AIRPORT SYSTEM

Review/ Approval Category Approved For Construction



HAS TIP# TBD AREA 3 - DATA, ELECTRICAL &

EQUIPMENT PLAN AND **ELEVATION** A202 SCALE: As indicated

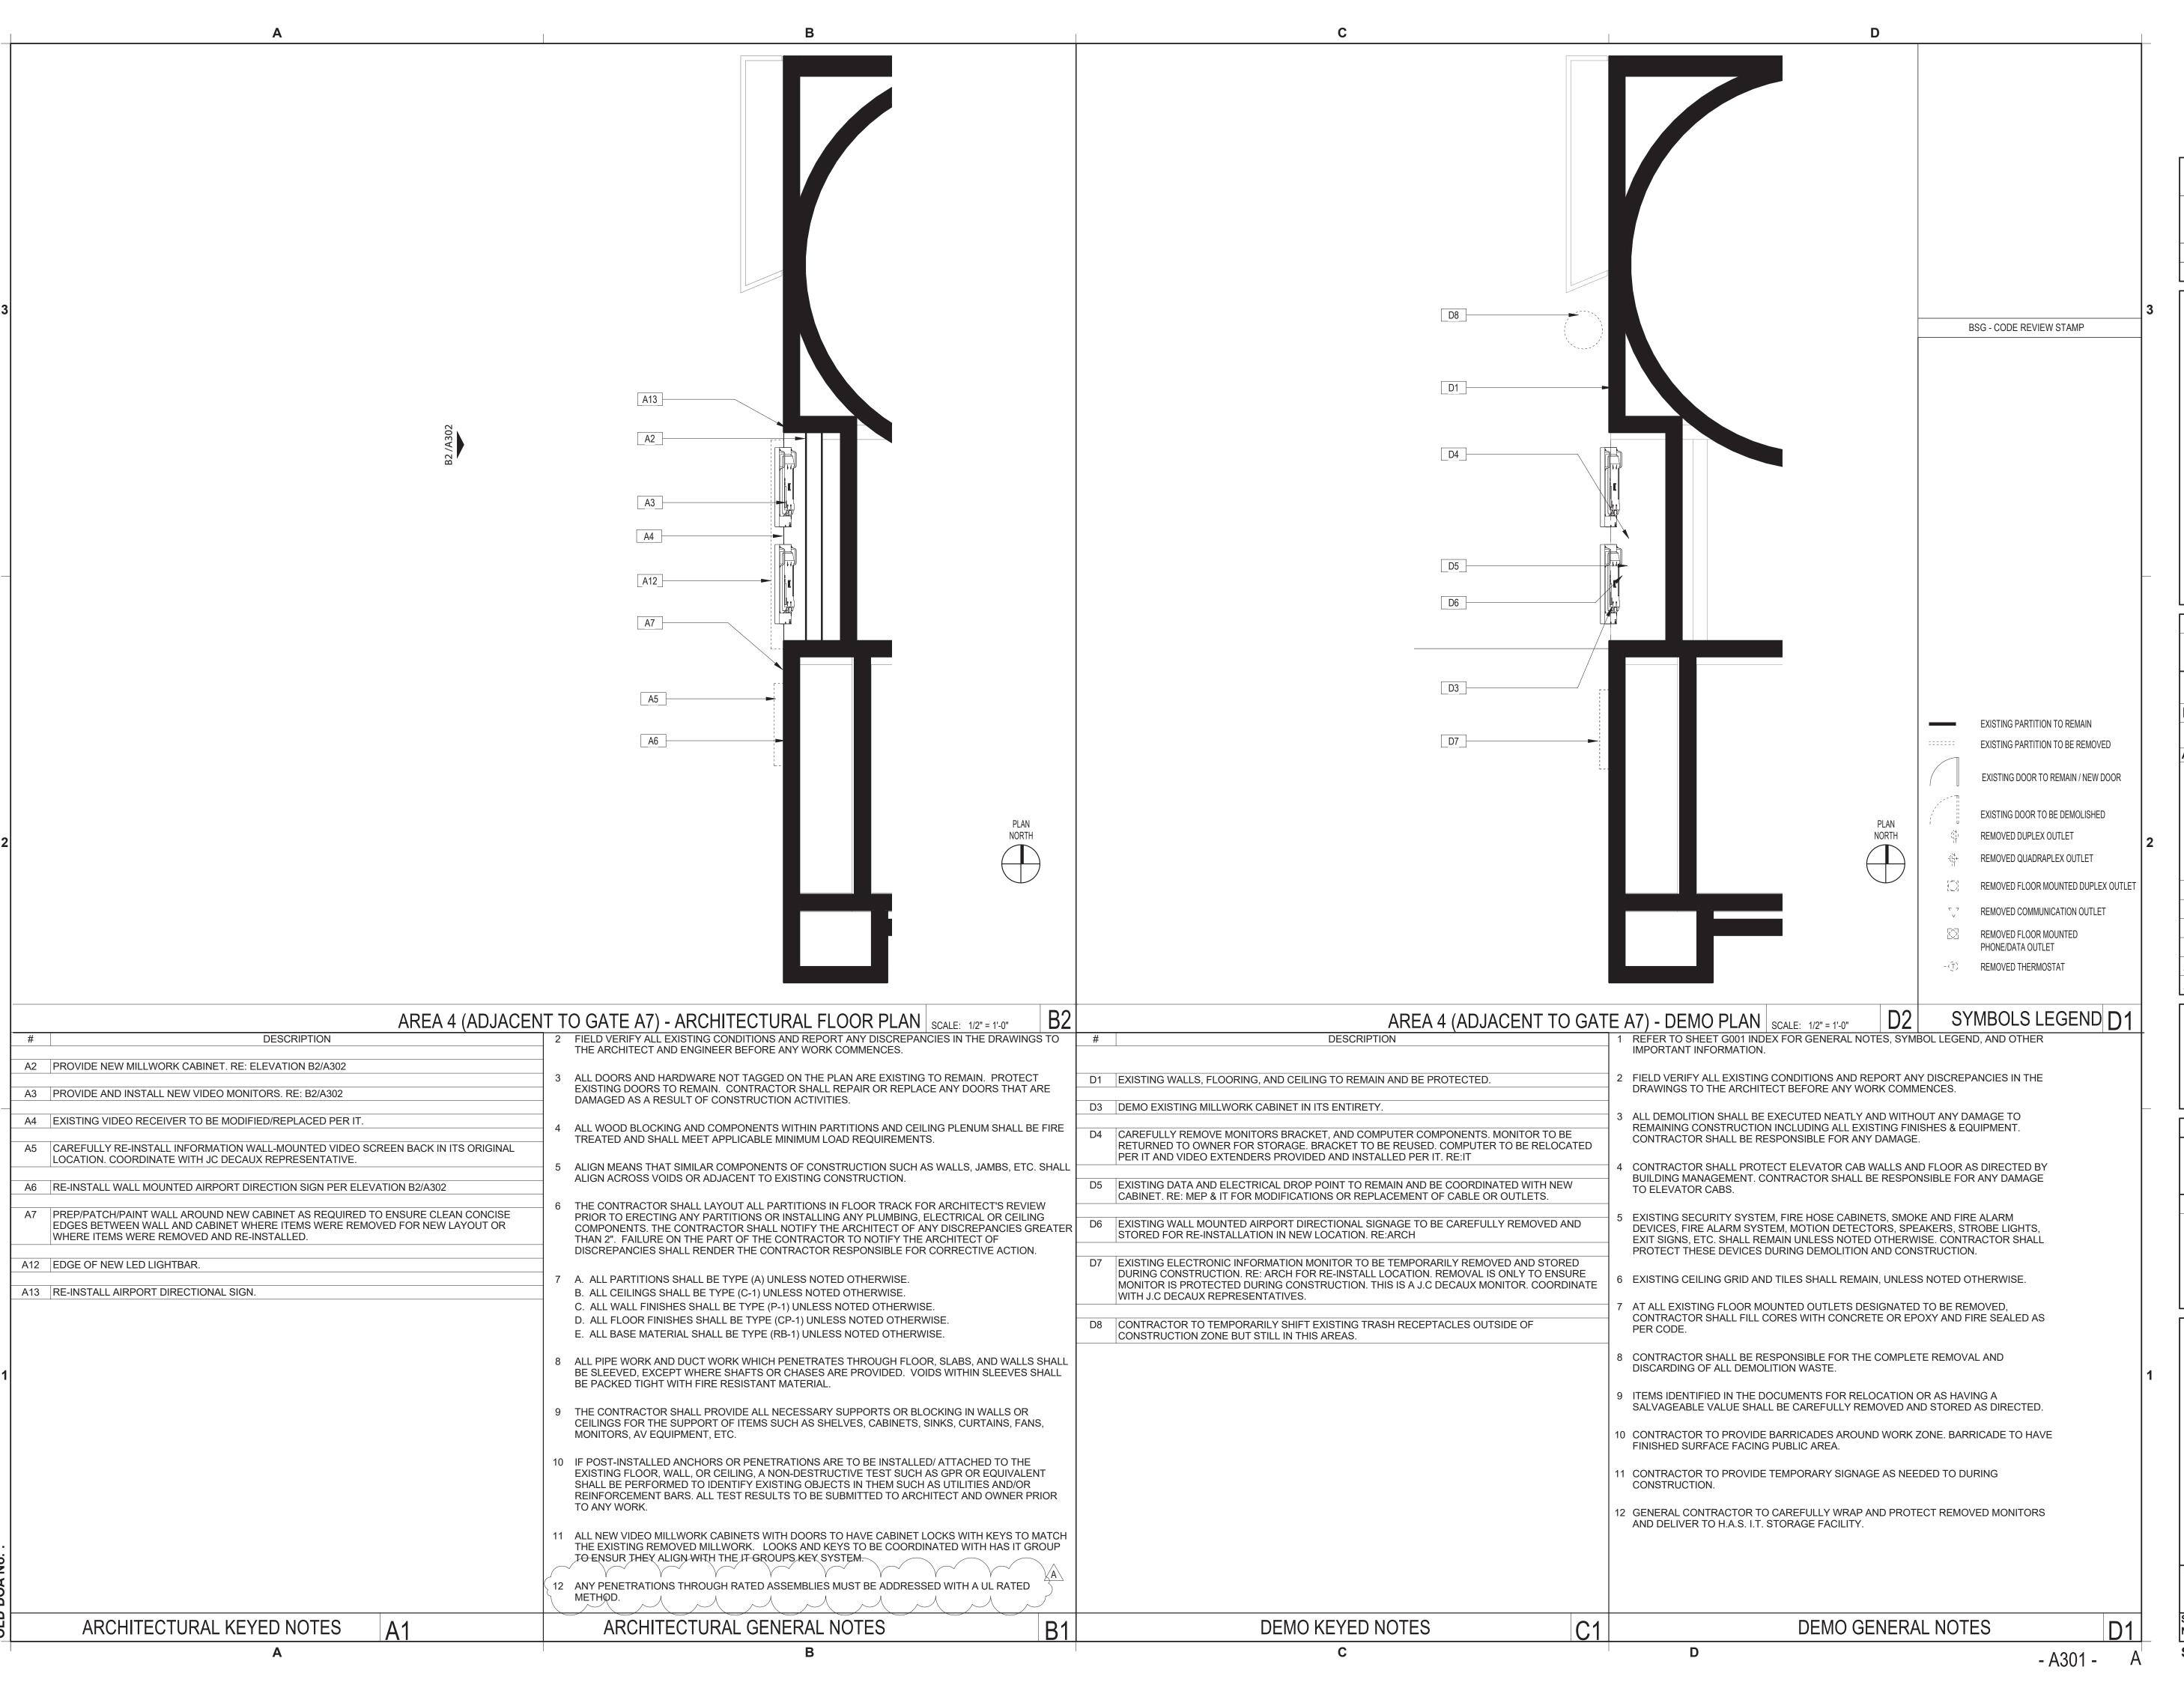



2800 N. TERMINAL RD. HOUSTON, TEXAS 77032

### HAS TERMINAL A FIDS & BID LED LIGHTS

C.I.P. No. A.I.P. No.

C.O.H. No. D.O.A No.



DESIGNER PROJECT No.: 21011.05
PROJECT STATUS:
PHASE TWO

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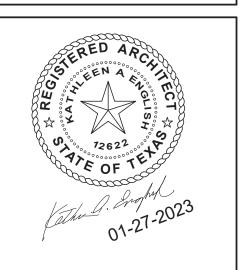
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ISSUE DATE:	01-27-2023
APPROVED BY:	KE
APPROVAL DATE:	

#### DIRECTOR of HOUSTON AIRPORT SYSTEM

Review/ Approval Category






As indicated

HAS TIP# TBD

AREA 4 - ARCHITECTURAL FLOOR
PLAN AND DEMO PLAN

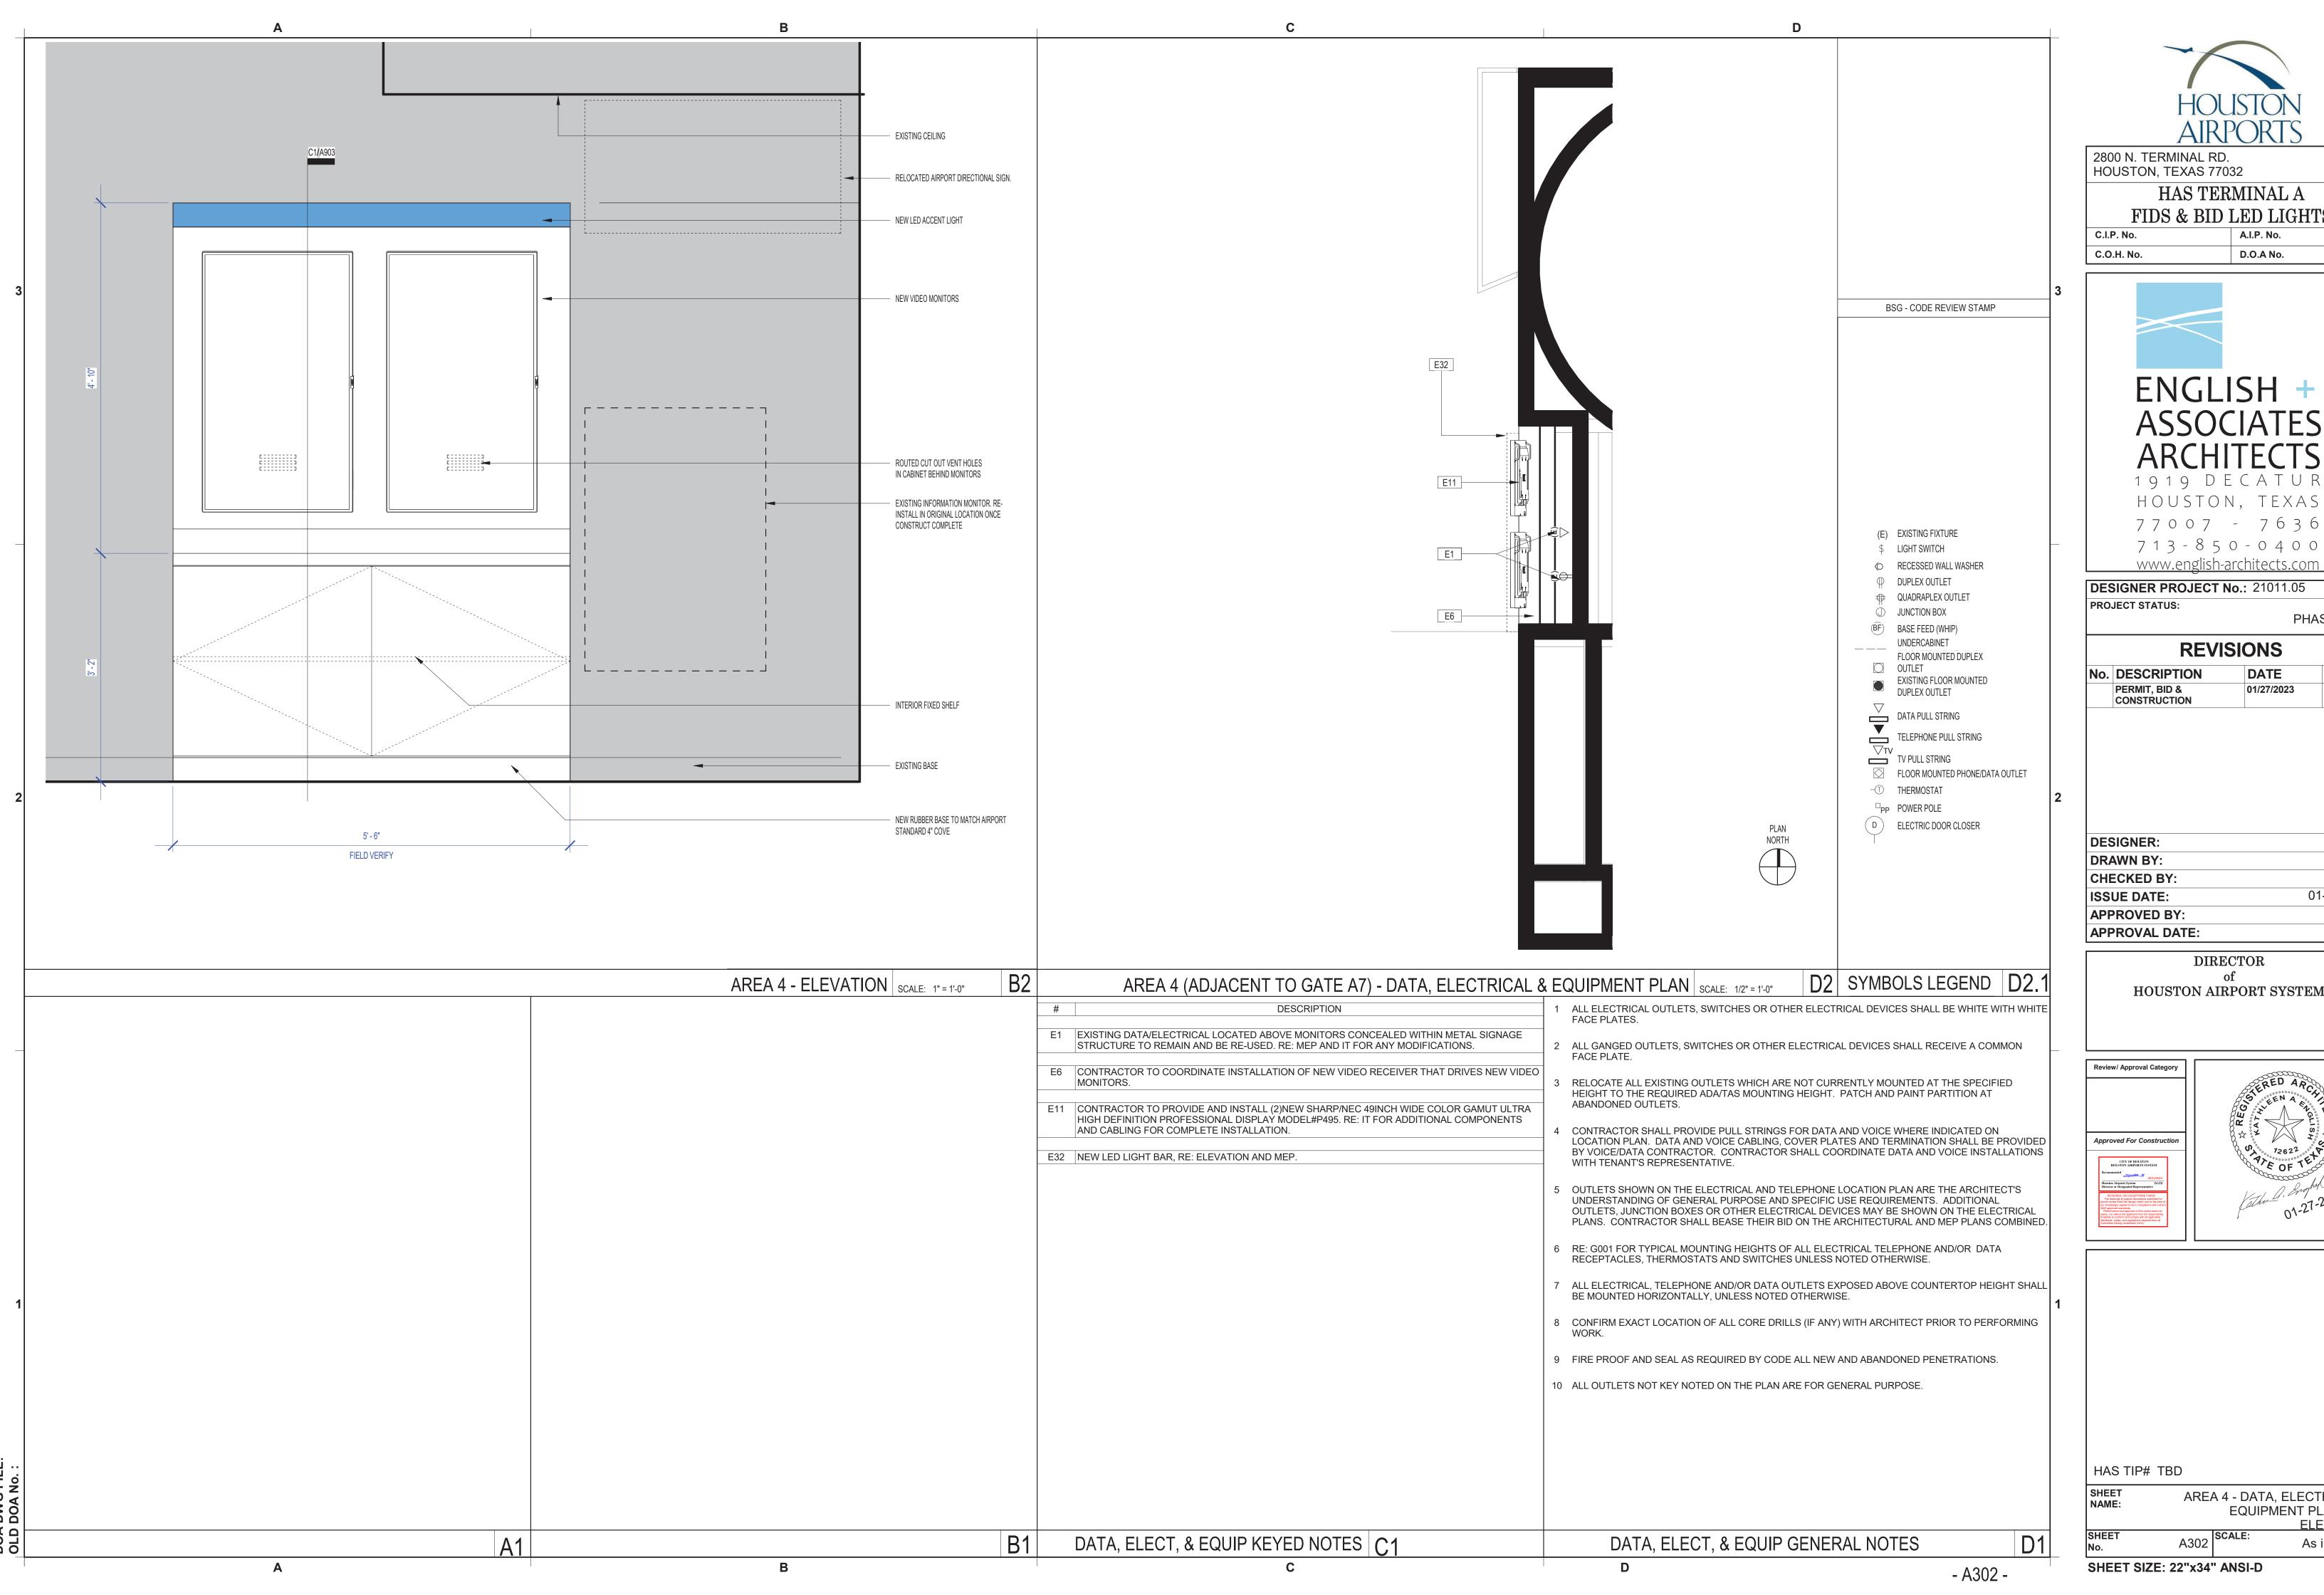

### HAS TERMINAL A FIDS & BID LED LIGHTS

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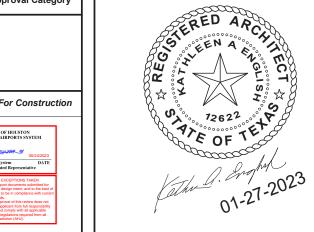


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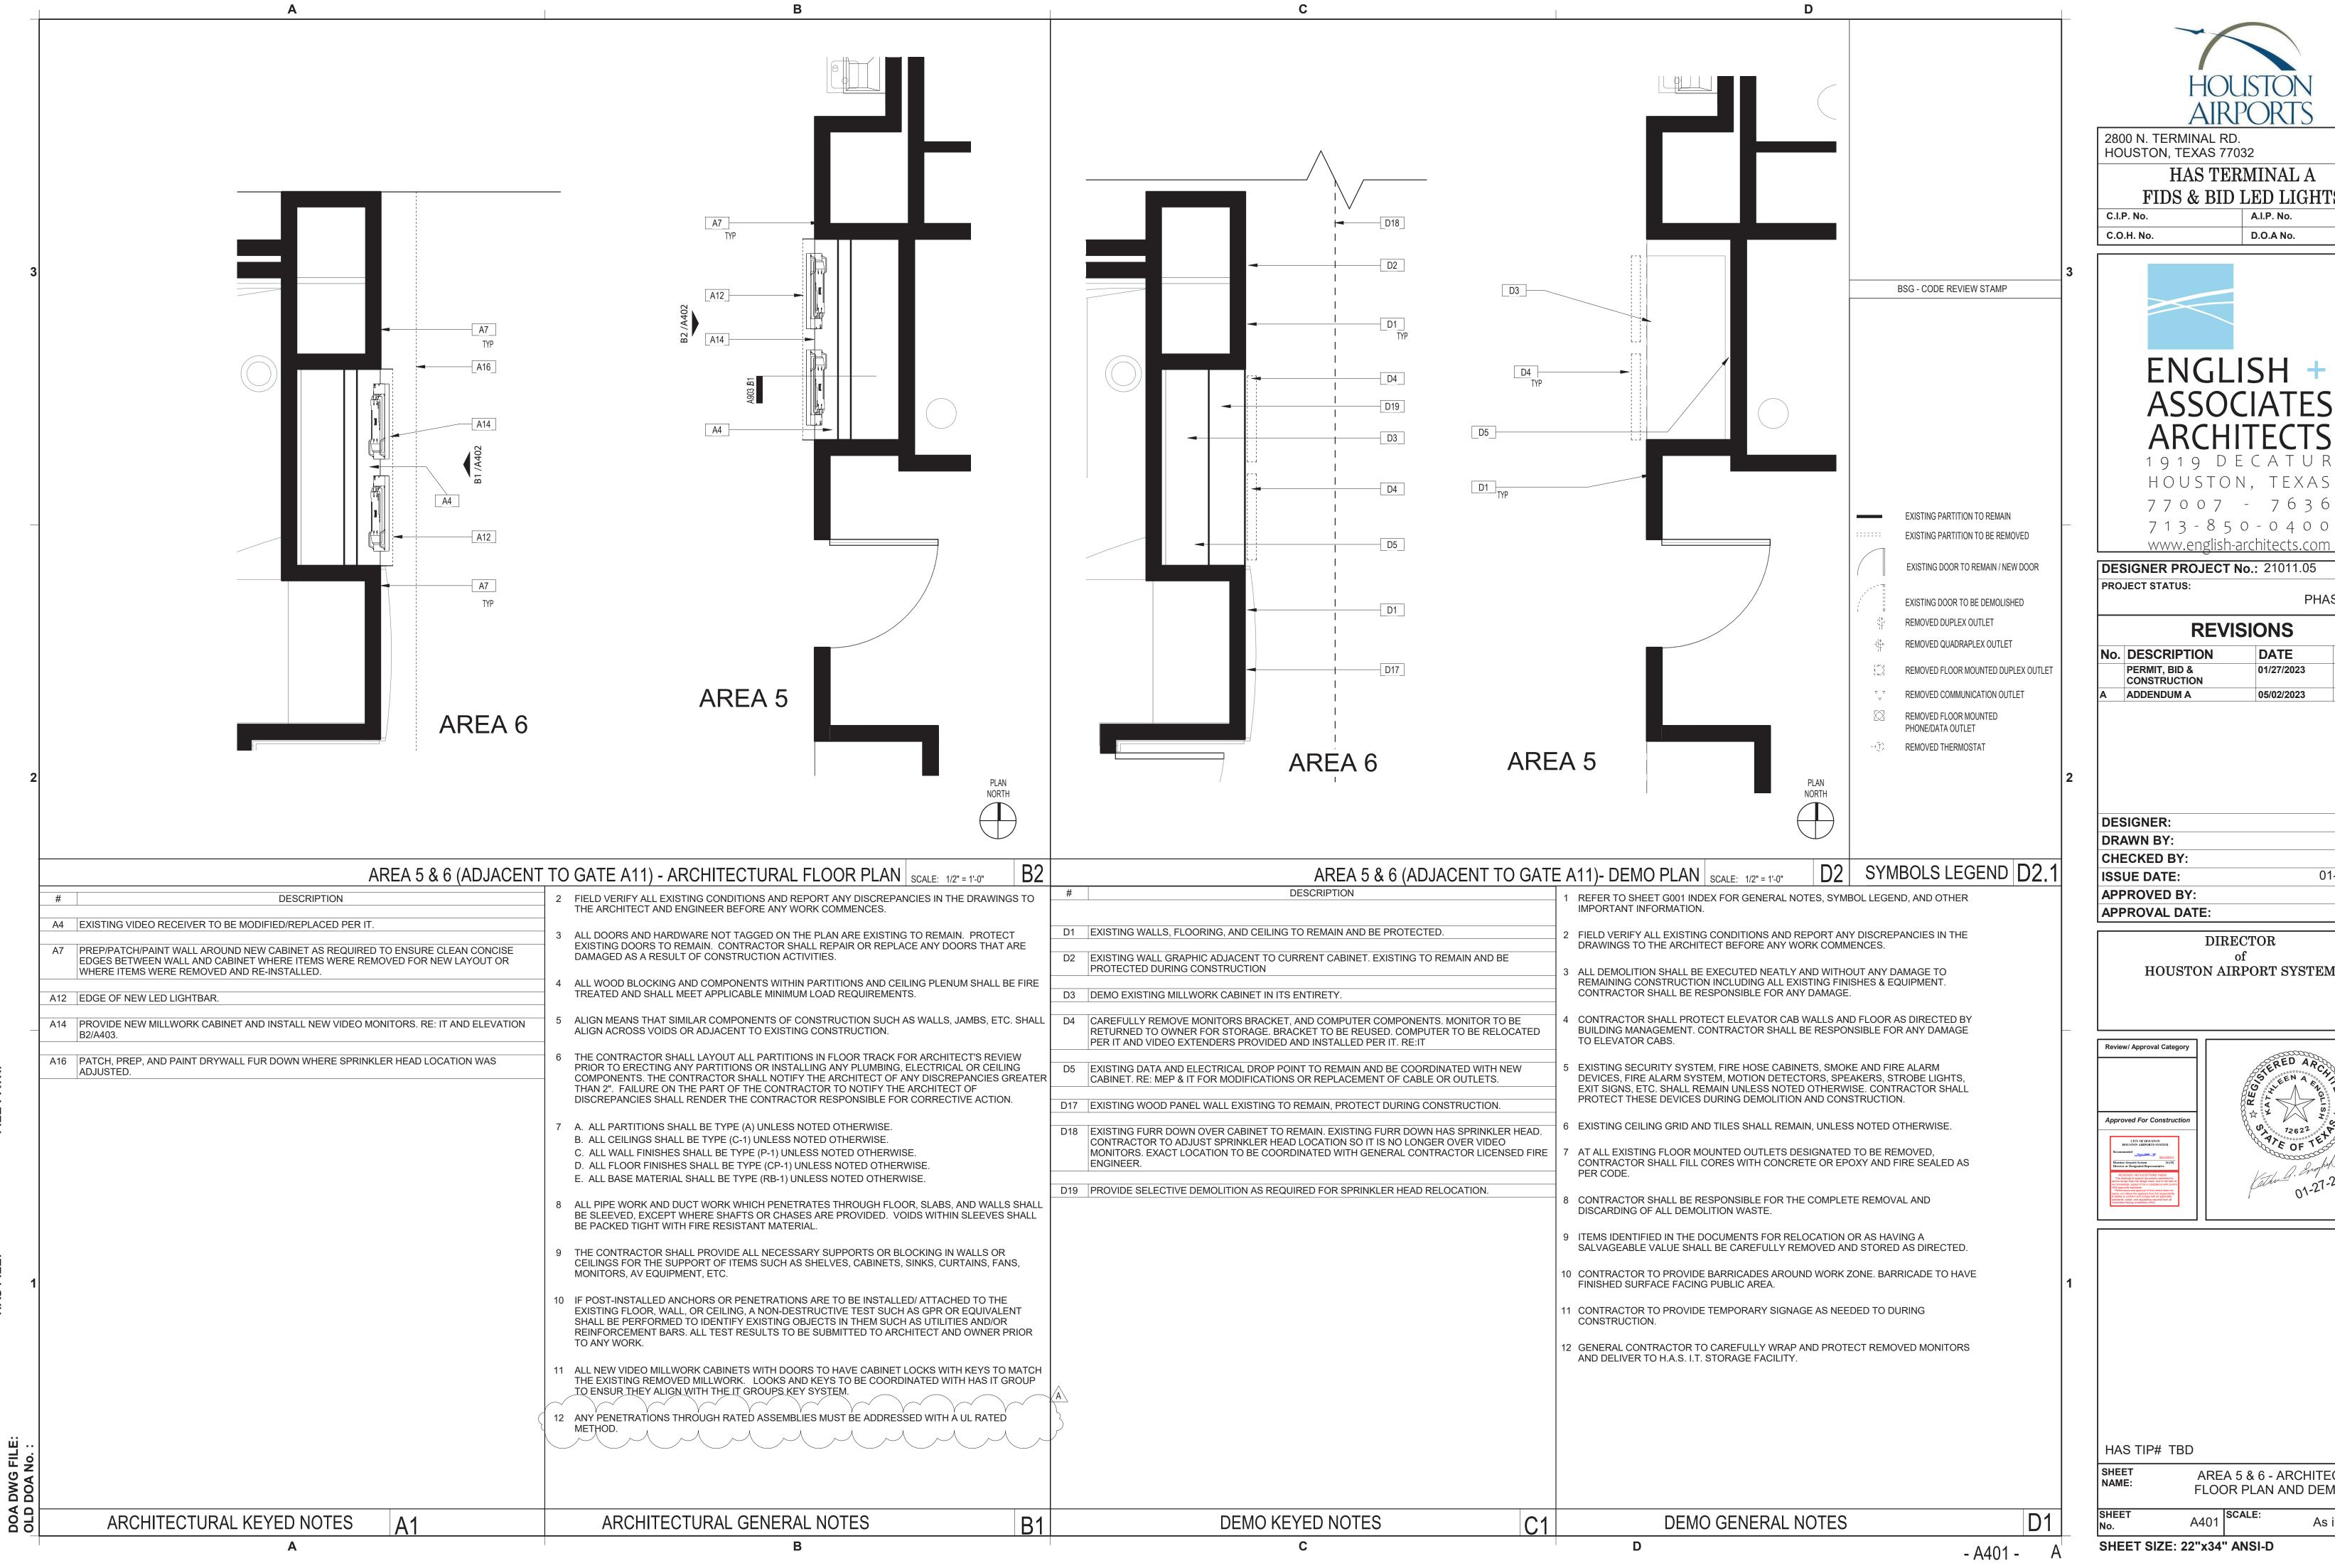
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AREA 4 - DATA, ELECTRICAL & **EQUIPMENT PLAN AND** ELEVATION A302 SCALE: As indicated





## FIDS & BID LED LIGHTS



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No.	DESCRIPTION	DATE	BY
	PERMIT, BID & CONSTRUCTION	01/27/2023	
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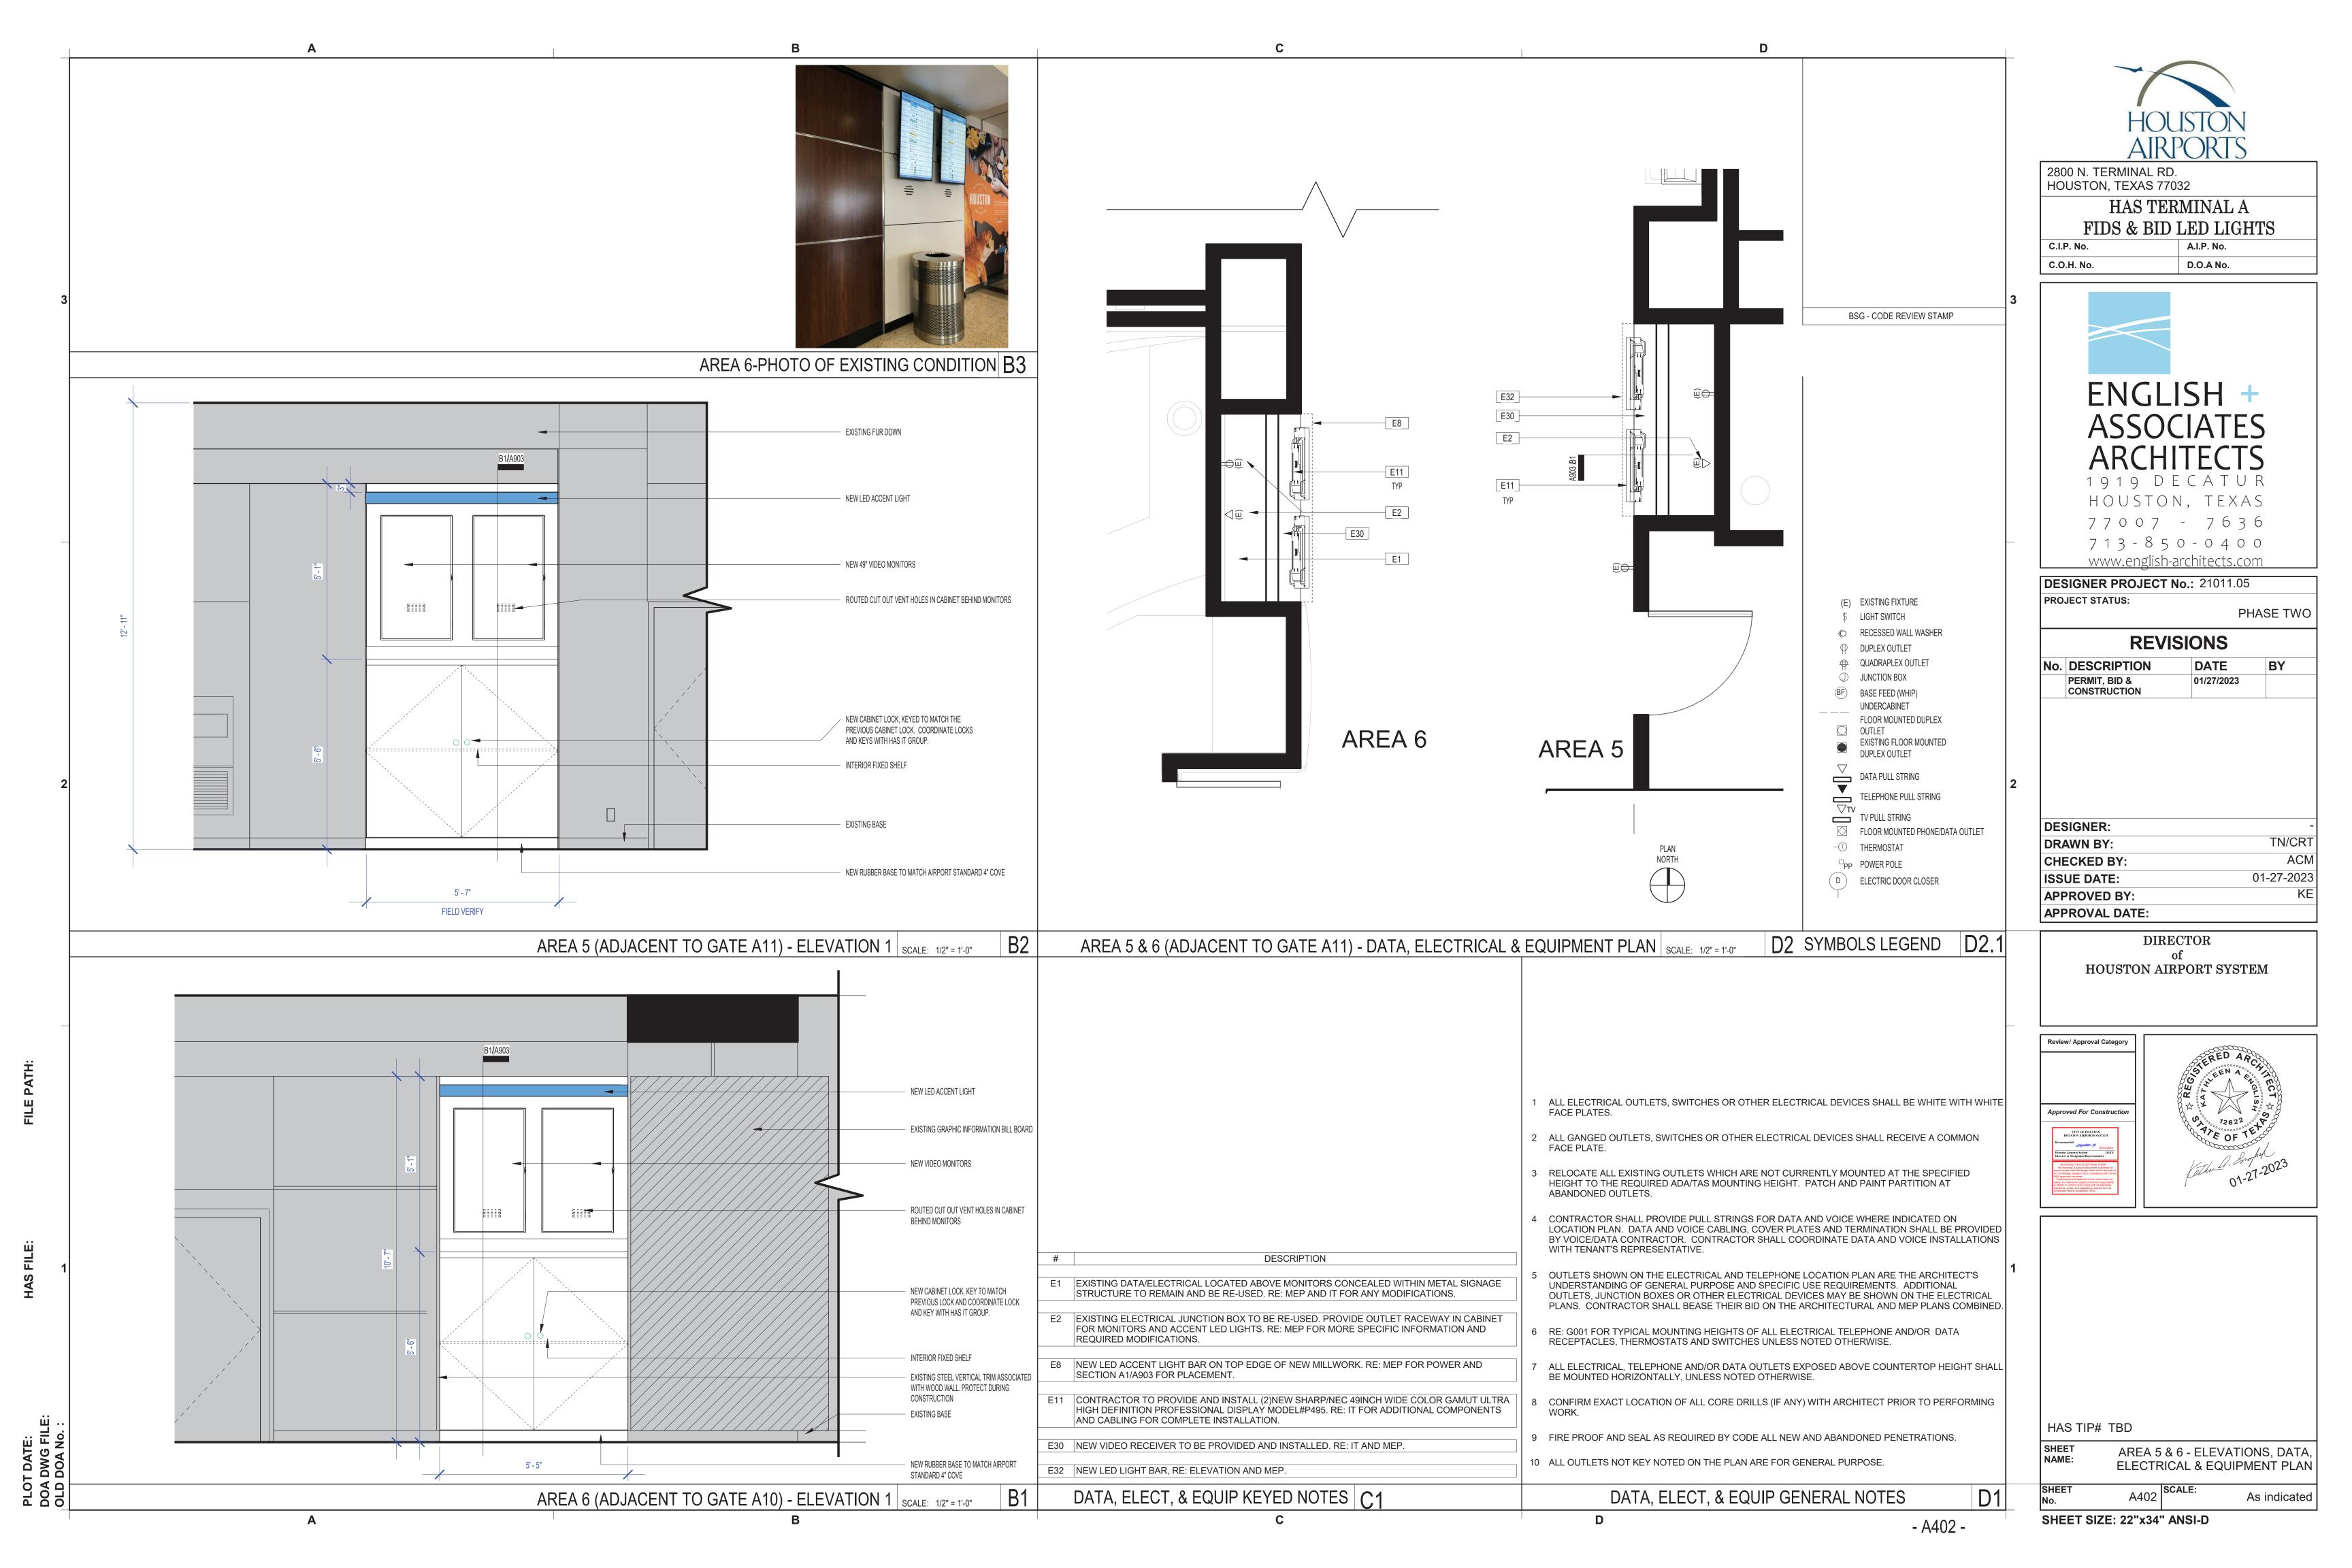
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APPROVED BY:	KE
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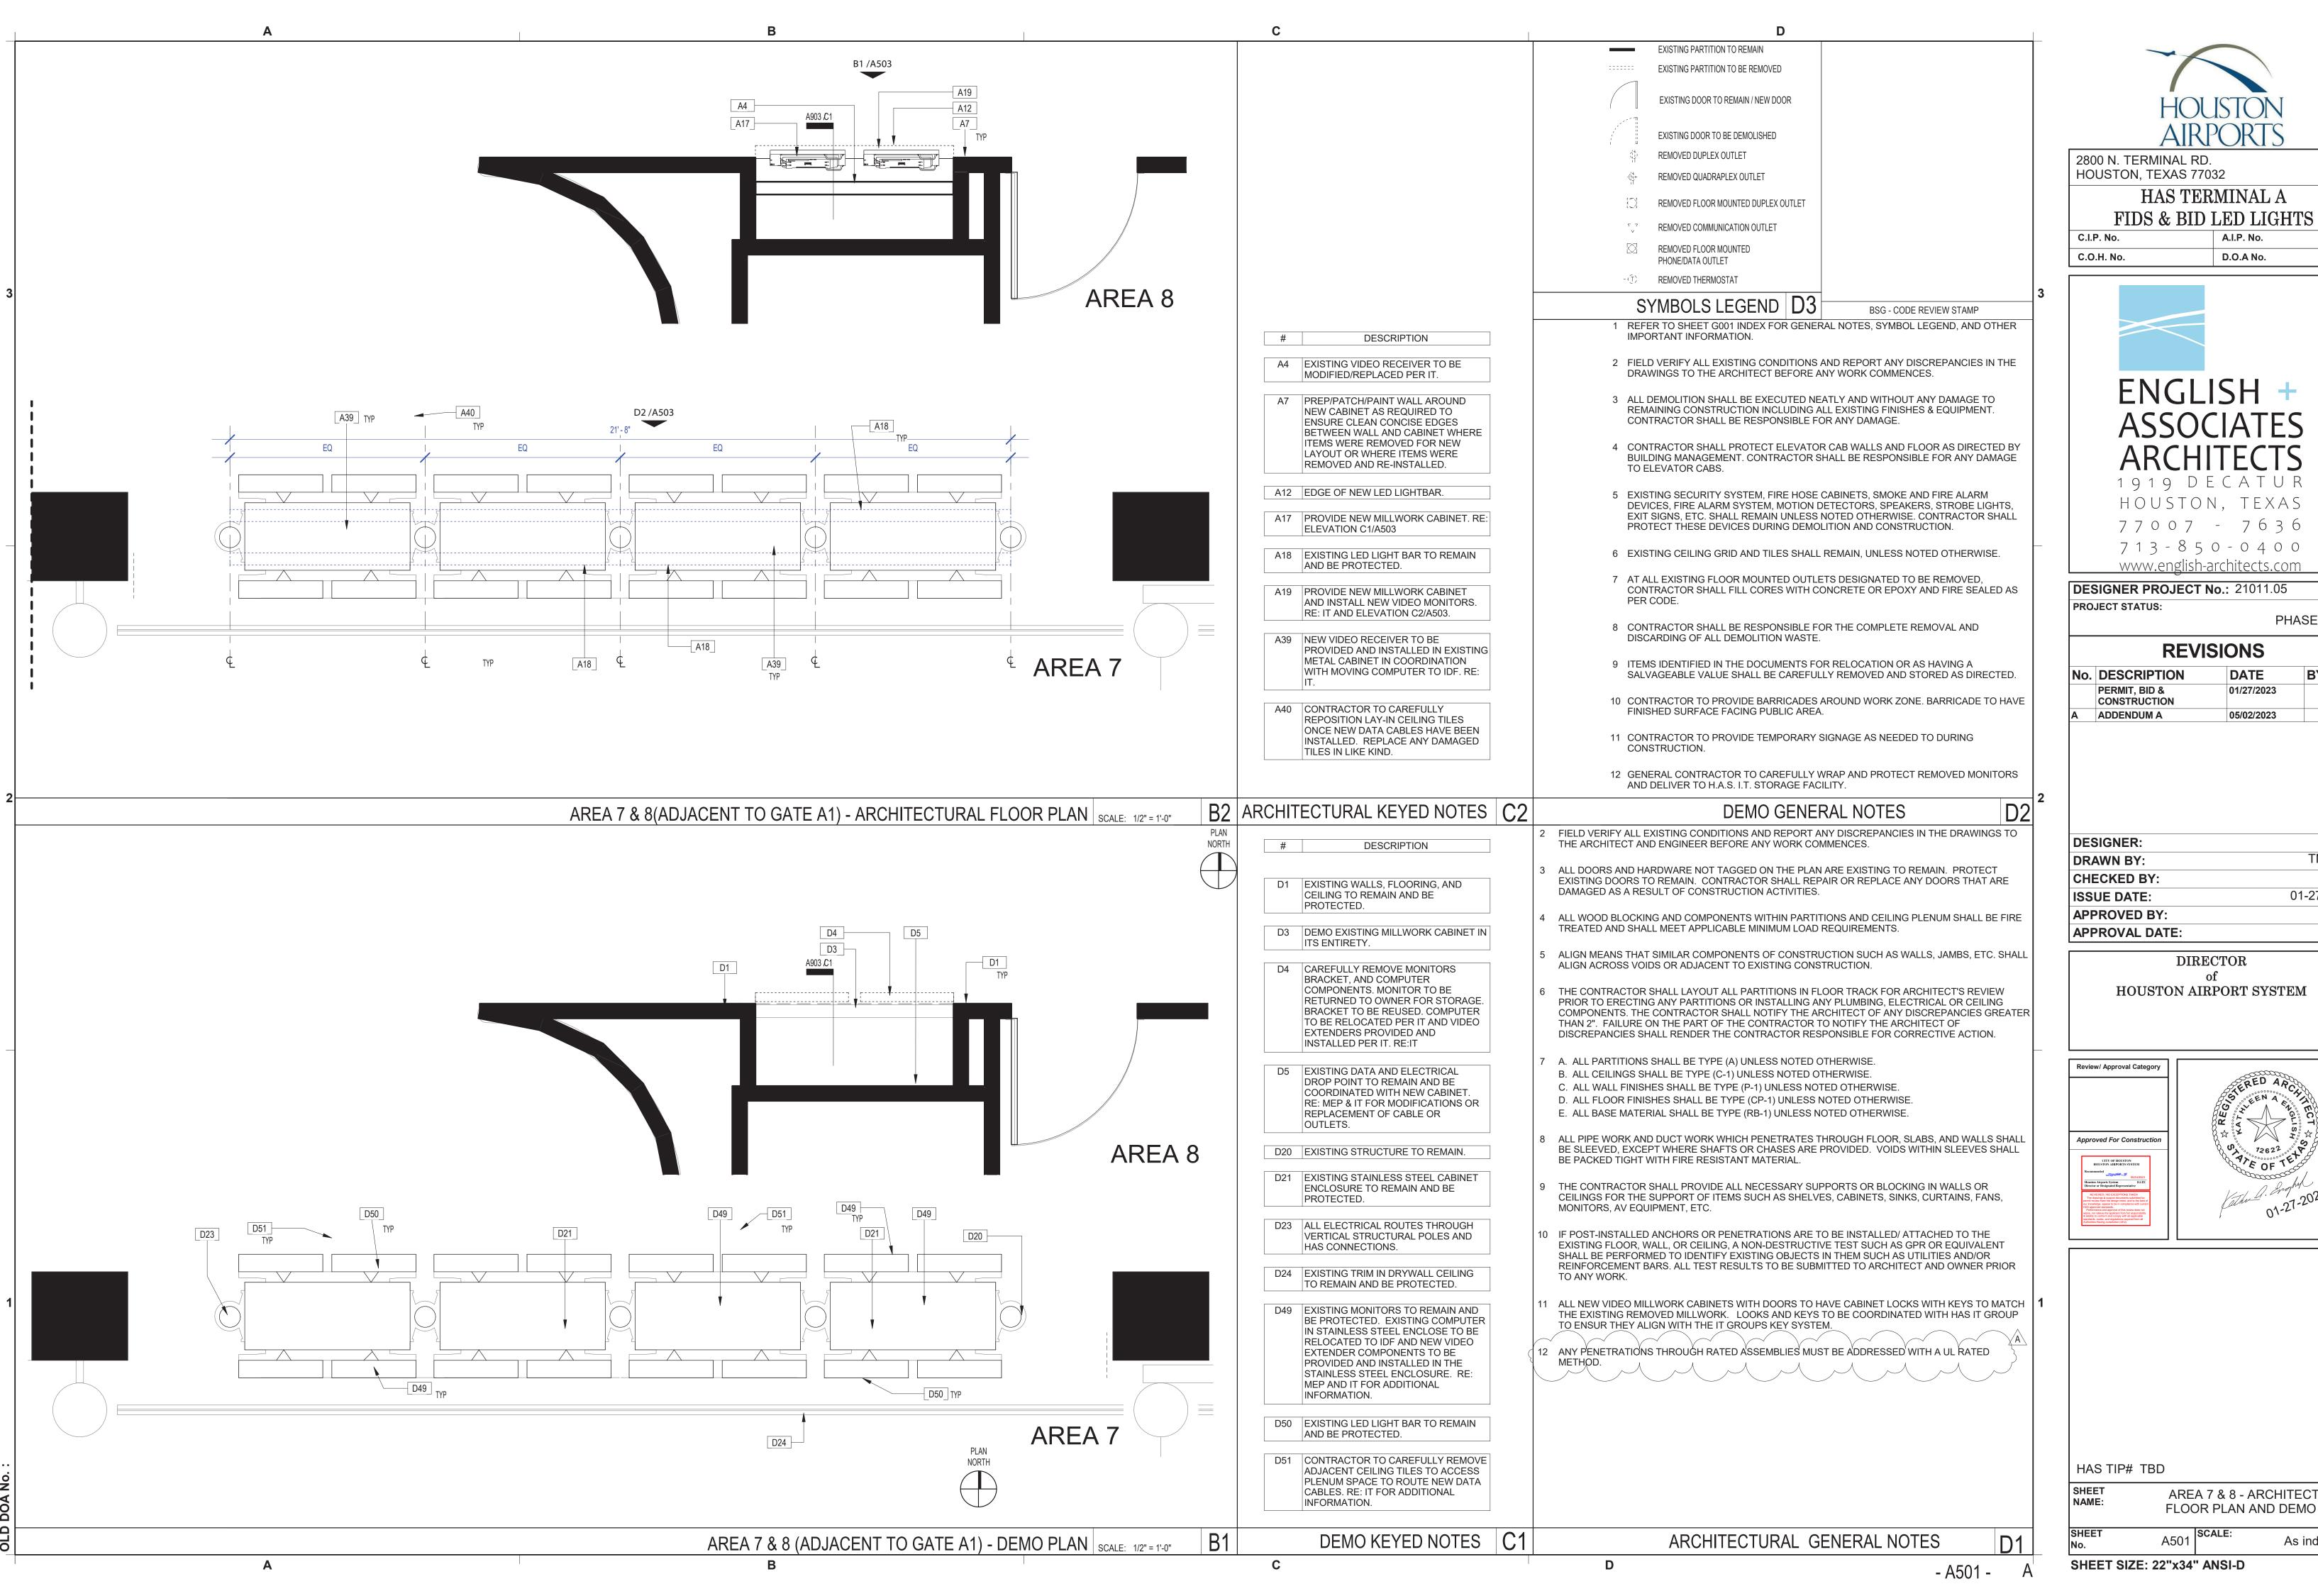
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AREA 5 & 6 - ARCHITECTURAL FLOOR PLAN AND DEMO PLAN

As indicated







### HAS TERMINAL A

D.O.A No.



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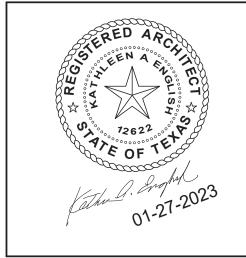
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05/02/2023


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ISSUE DATE:	01-27-2023
APPROVED BY:	KE
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### DIRECTOR HOUSTON AIRPORT SYSTEM



AREA 7 & 8 - ARCHITECTURAL FLOOR PLAN AND DEMO PLAN

As indicated



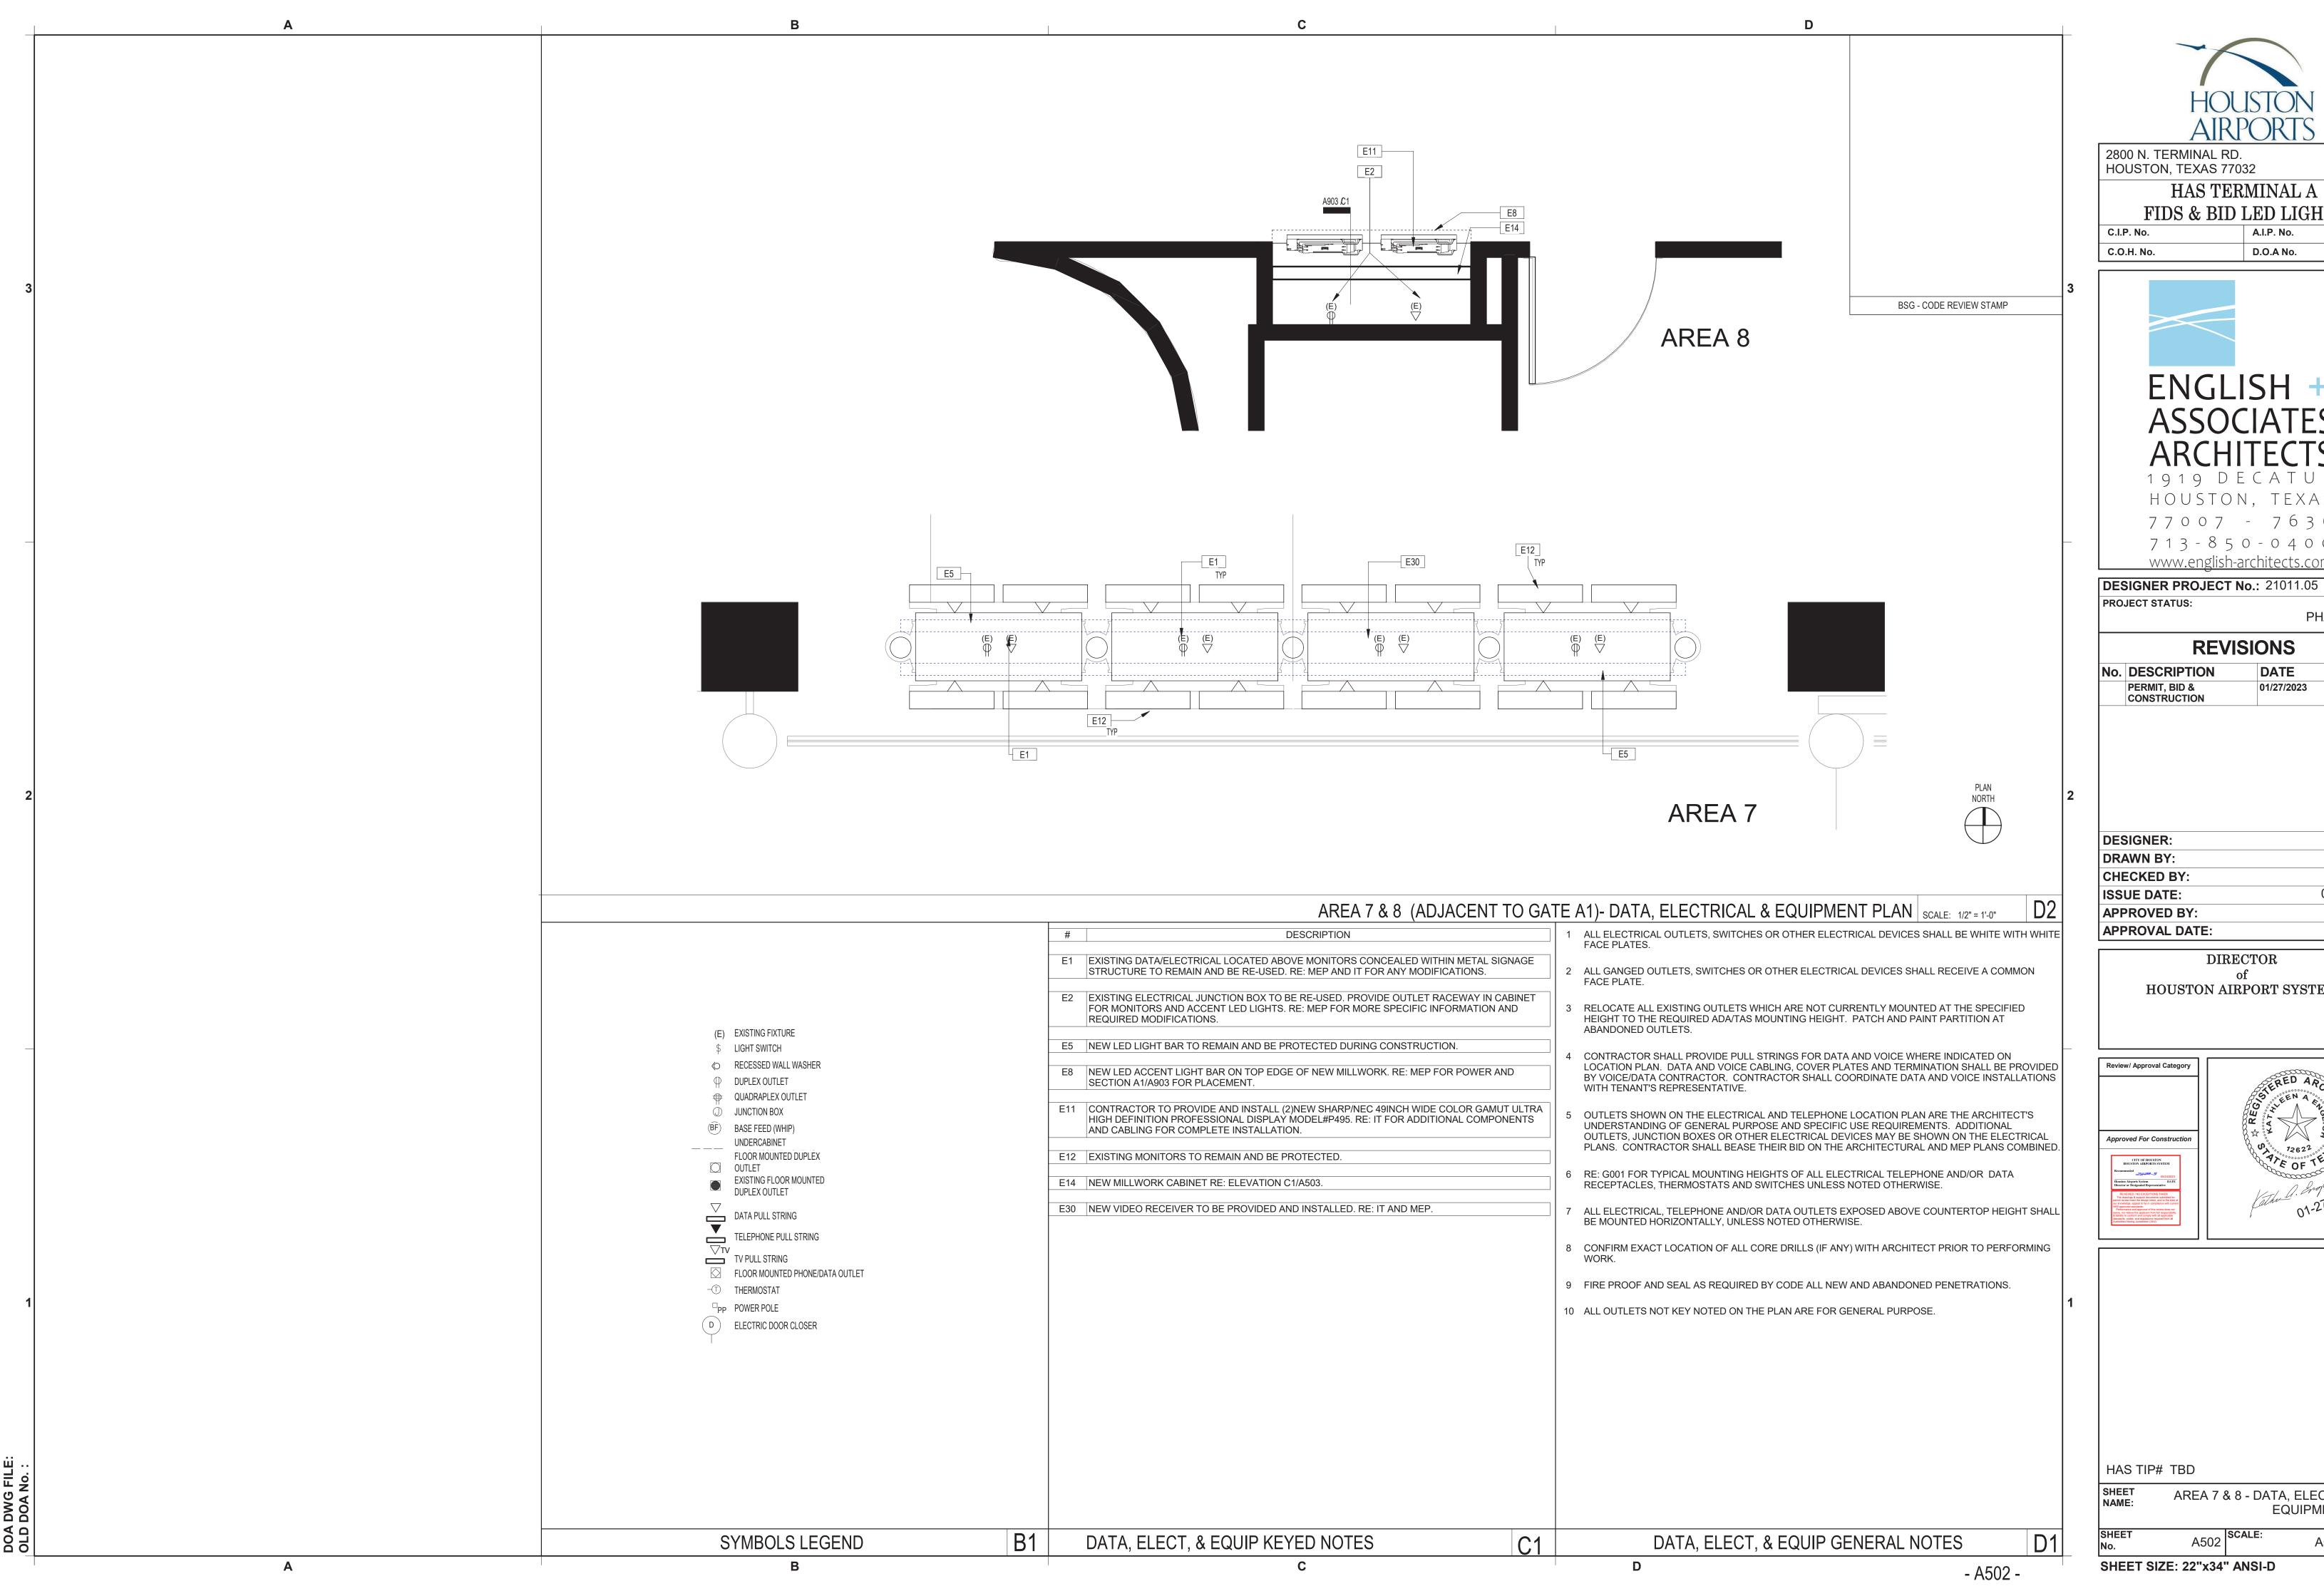

HOUSTON, TEXAS 77032

### HAS TERMINAL A FIDS & BID LED LIGHTS

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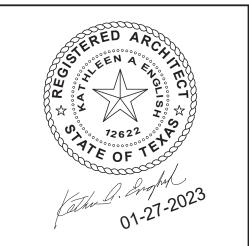
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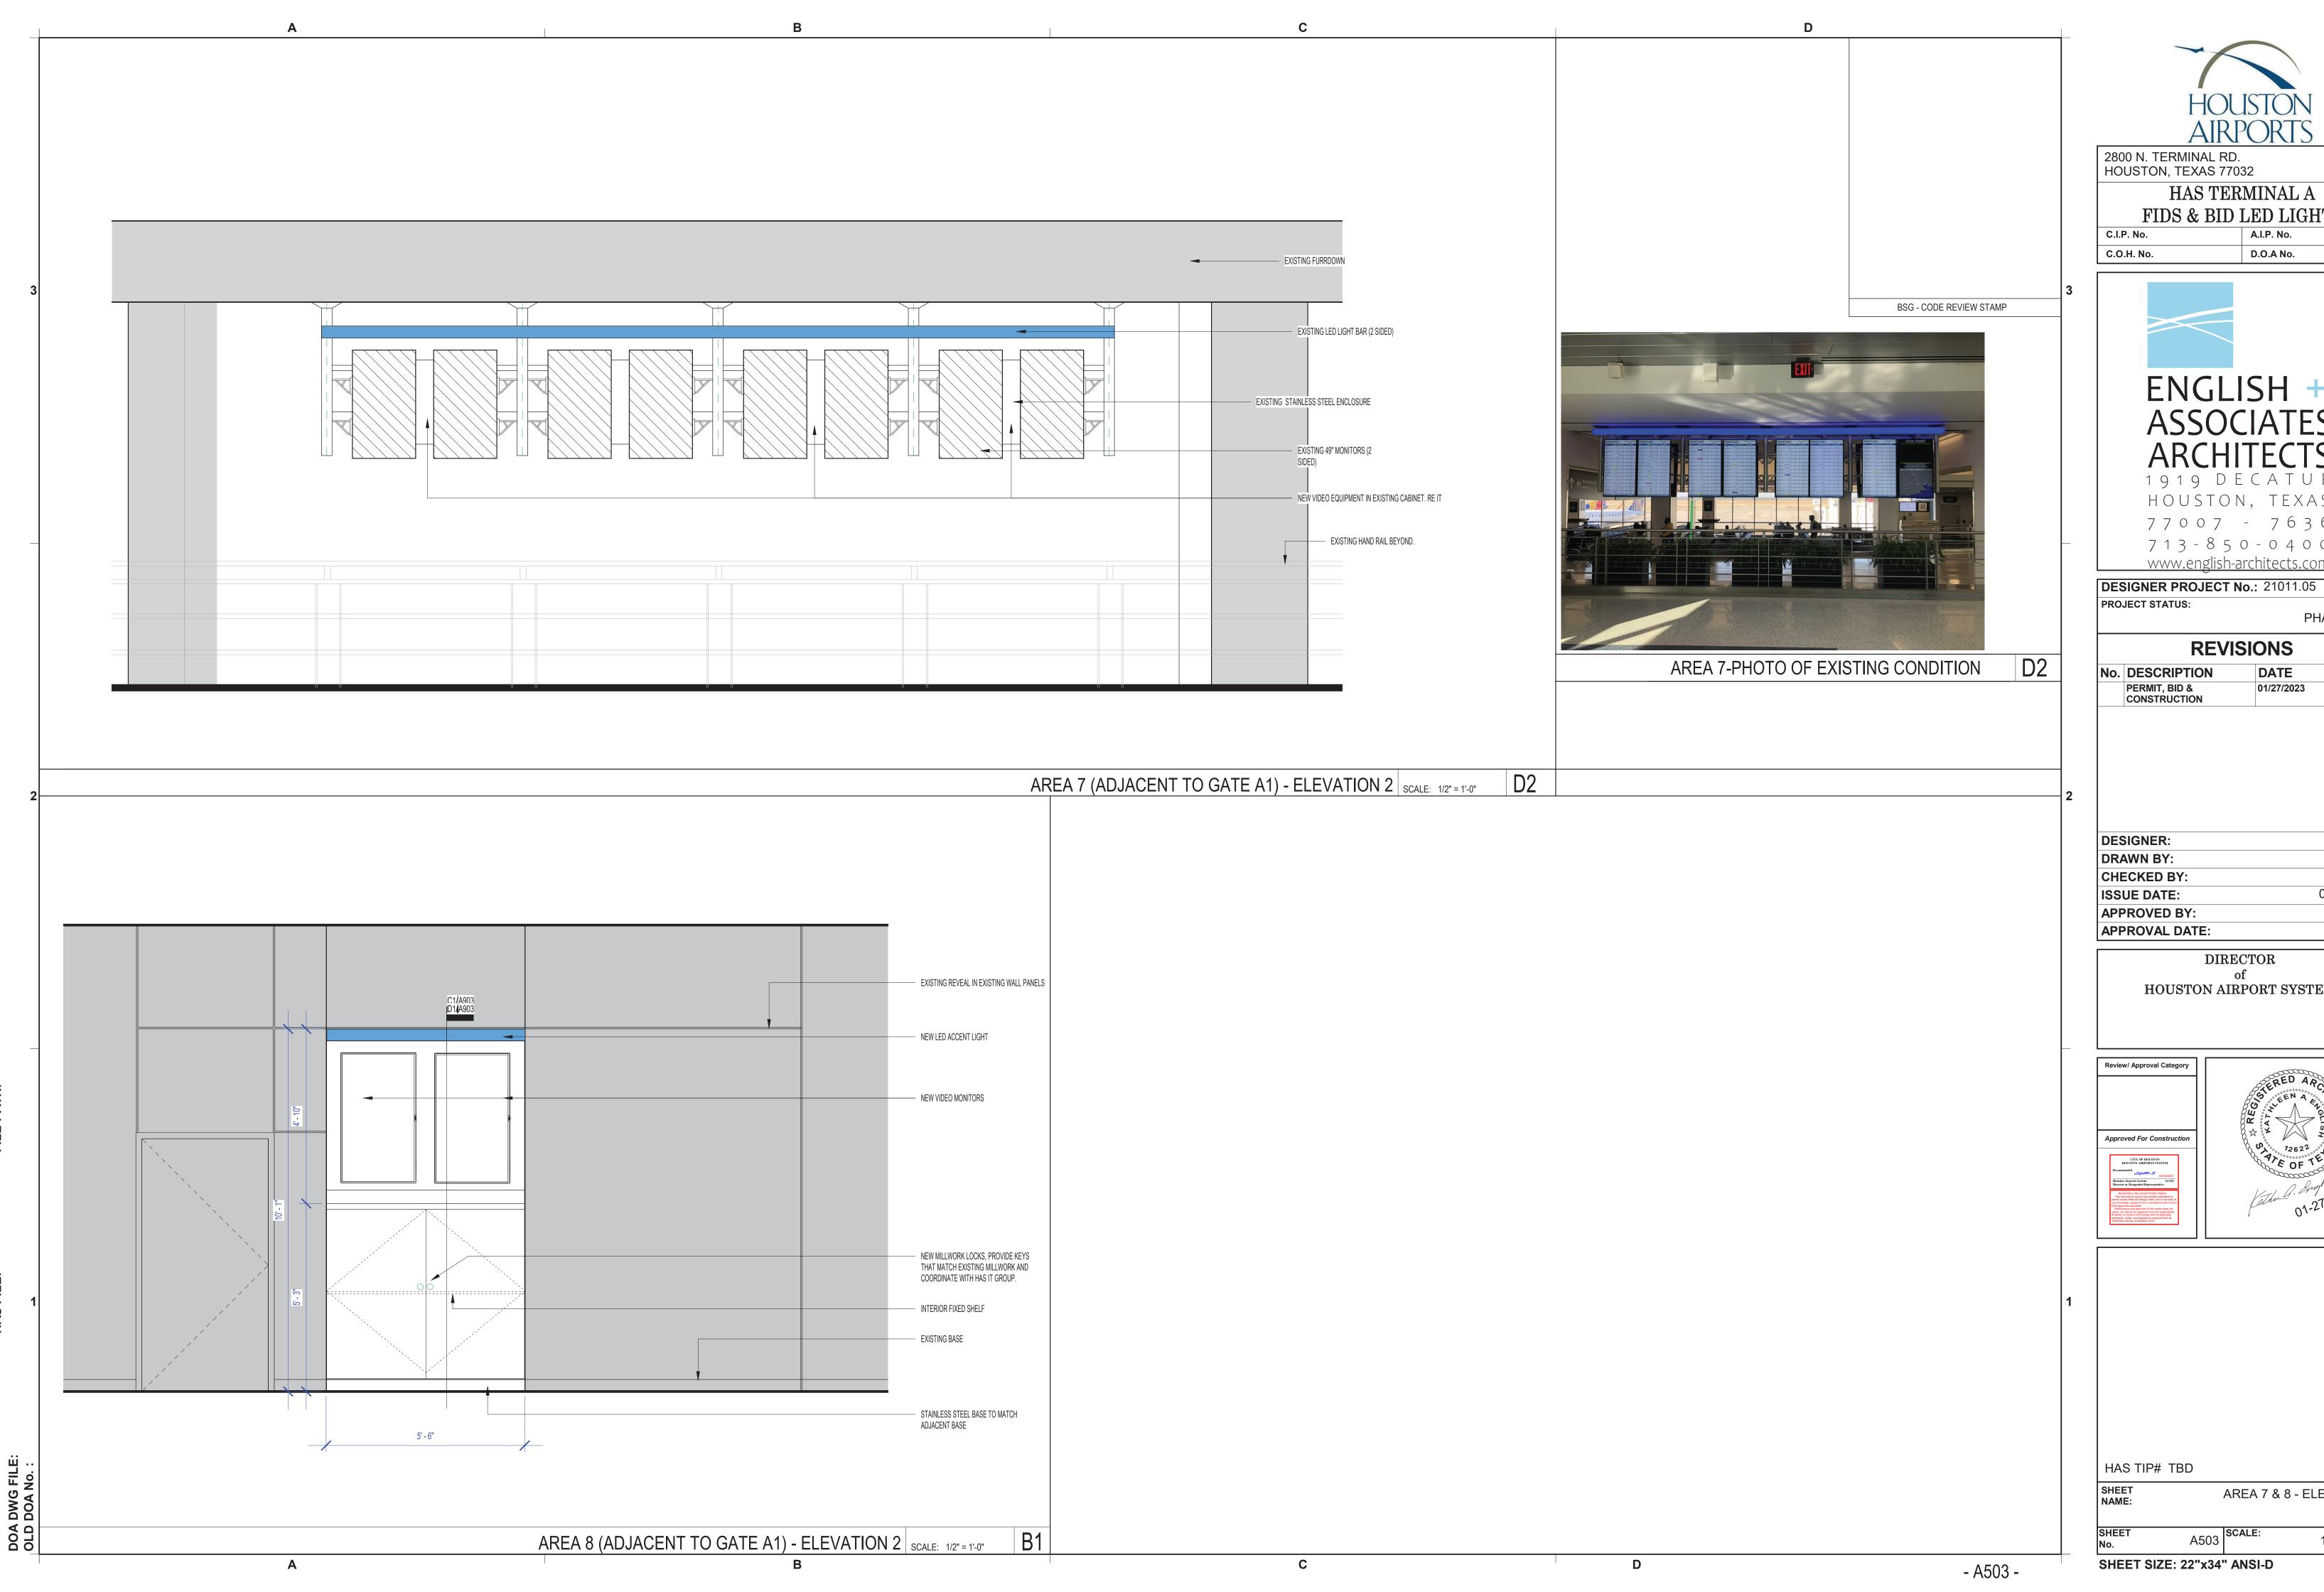
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ISSUE DATE:	01-27-2023
APPROVED BY:	KE
APPROVAL DATE:	

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AREA 7 & 8 - DATA, ELECTRICAL & EQUIPMENT PLAN

As indicated



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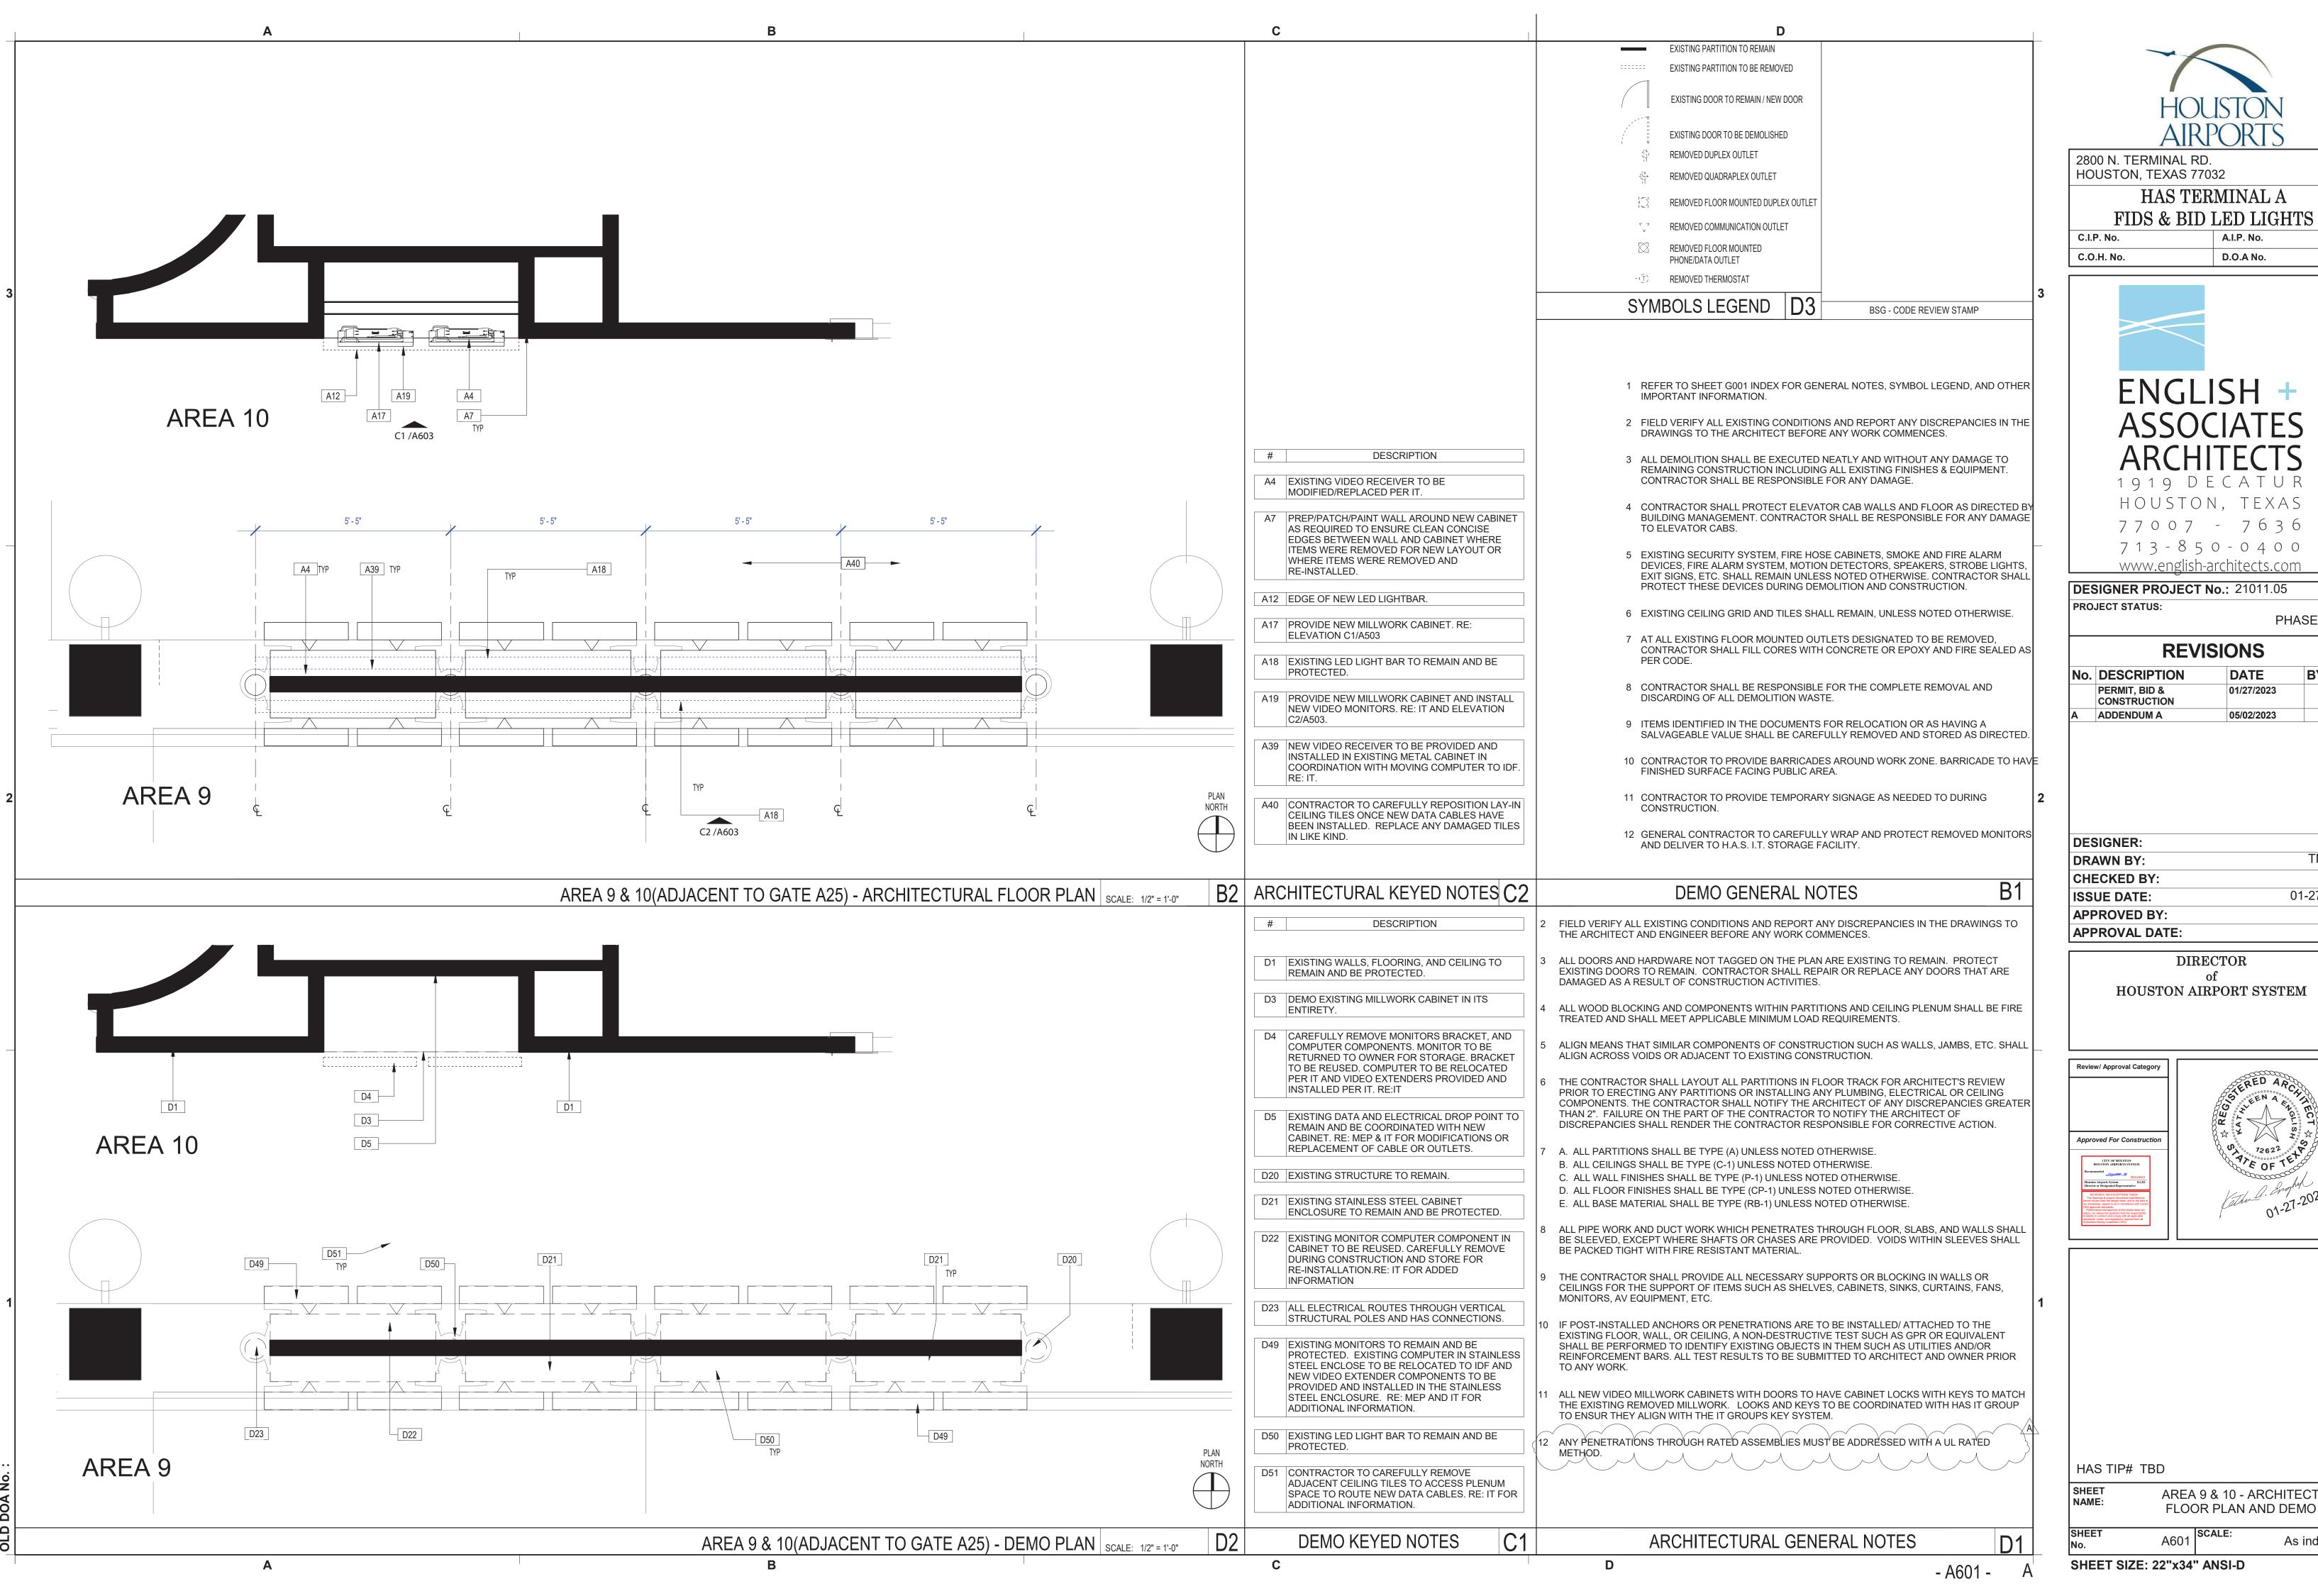
DATE 01/27/2023

TN/CRT 01-27-2023

HOUSTON AIRPORT SYSTEM



AREA 7 & 8 - ELEVATIONS 1/2" = 1'-0"





### HAS TERMINAL A

D.O.A No.



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PHASE TWO

#### **REVISIONS** DATE BY

01/27/2023

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Α	ADDENDUM A	05/02/2023	
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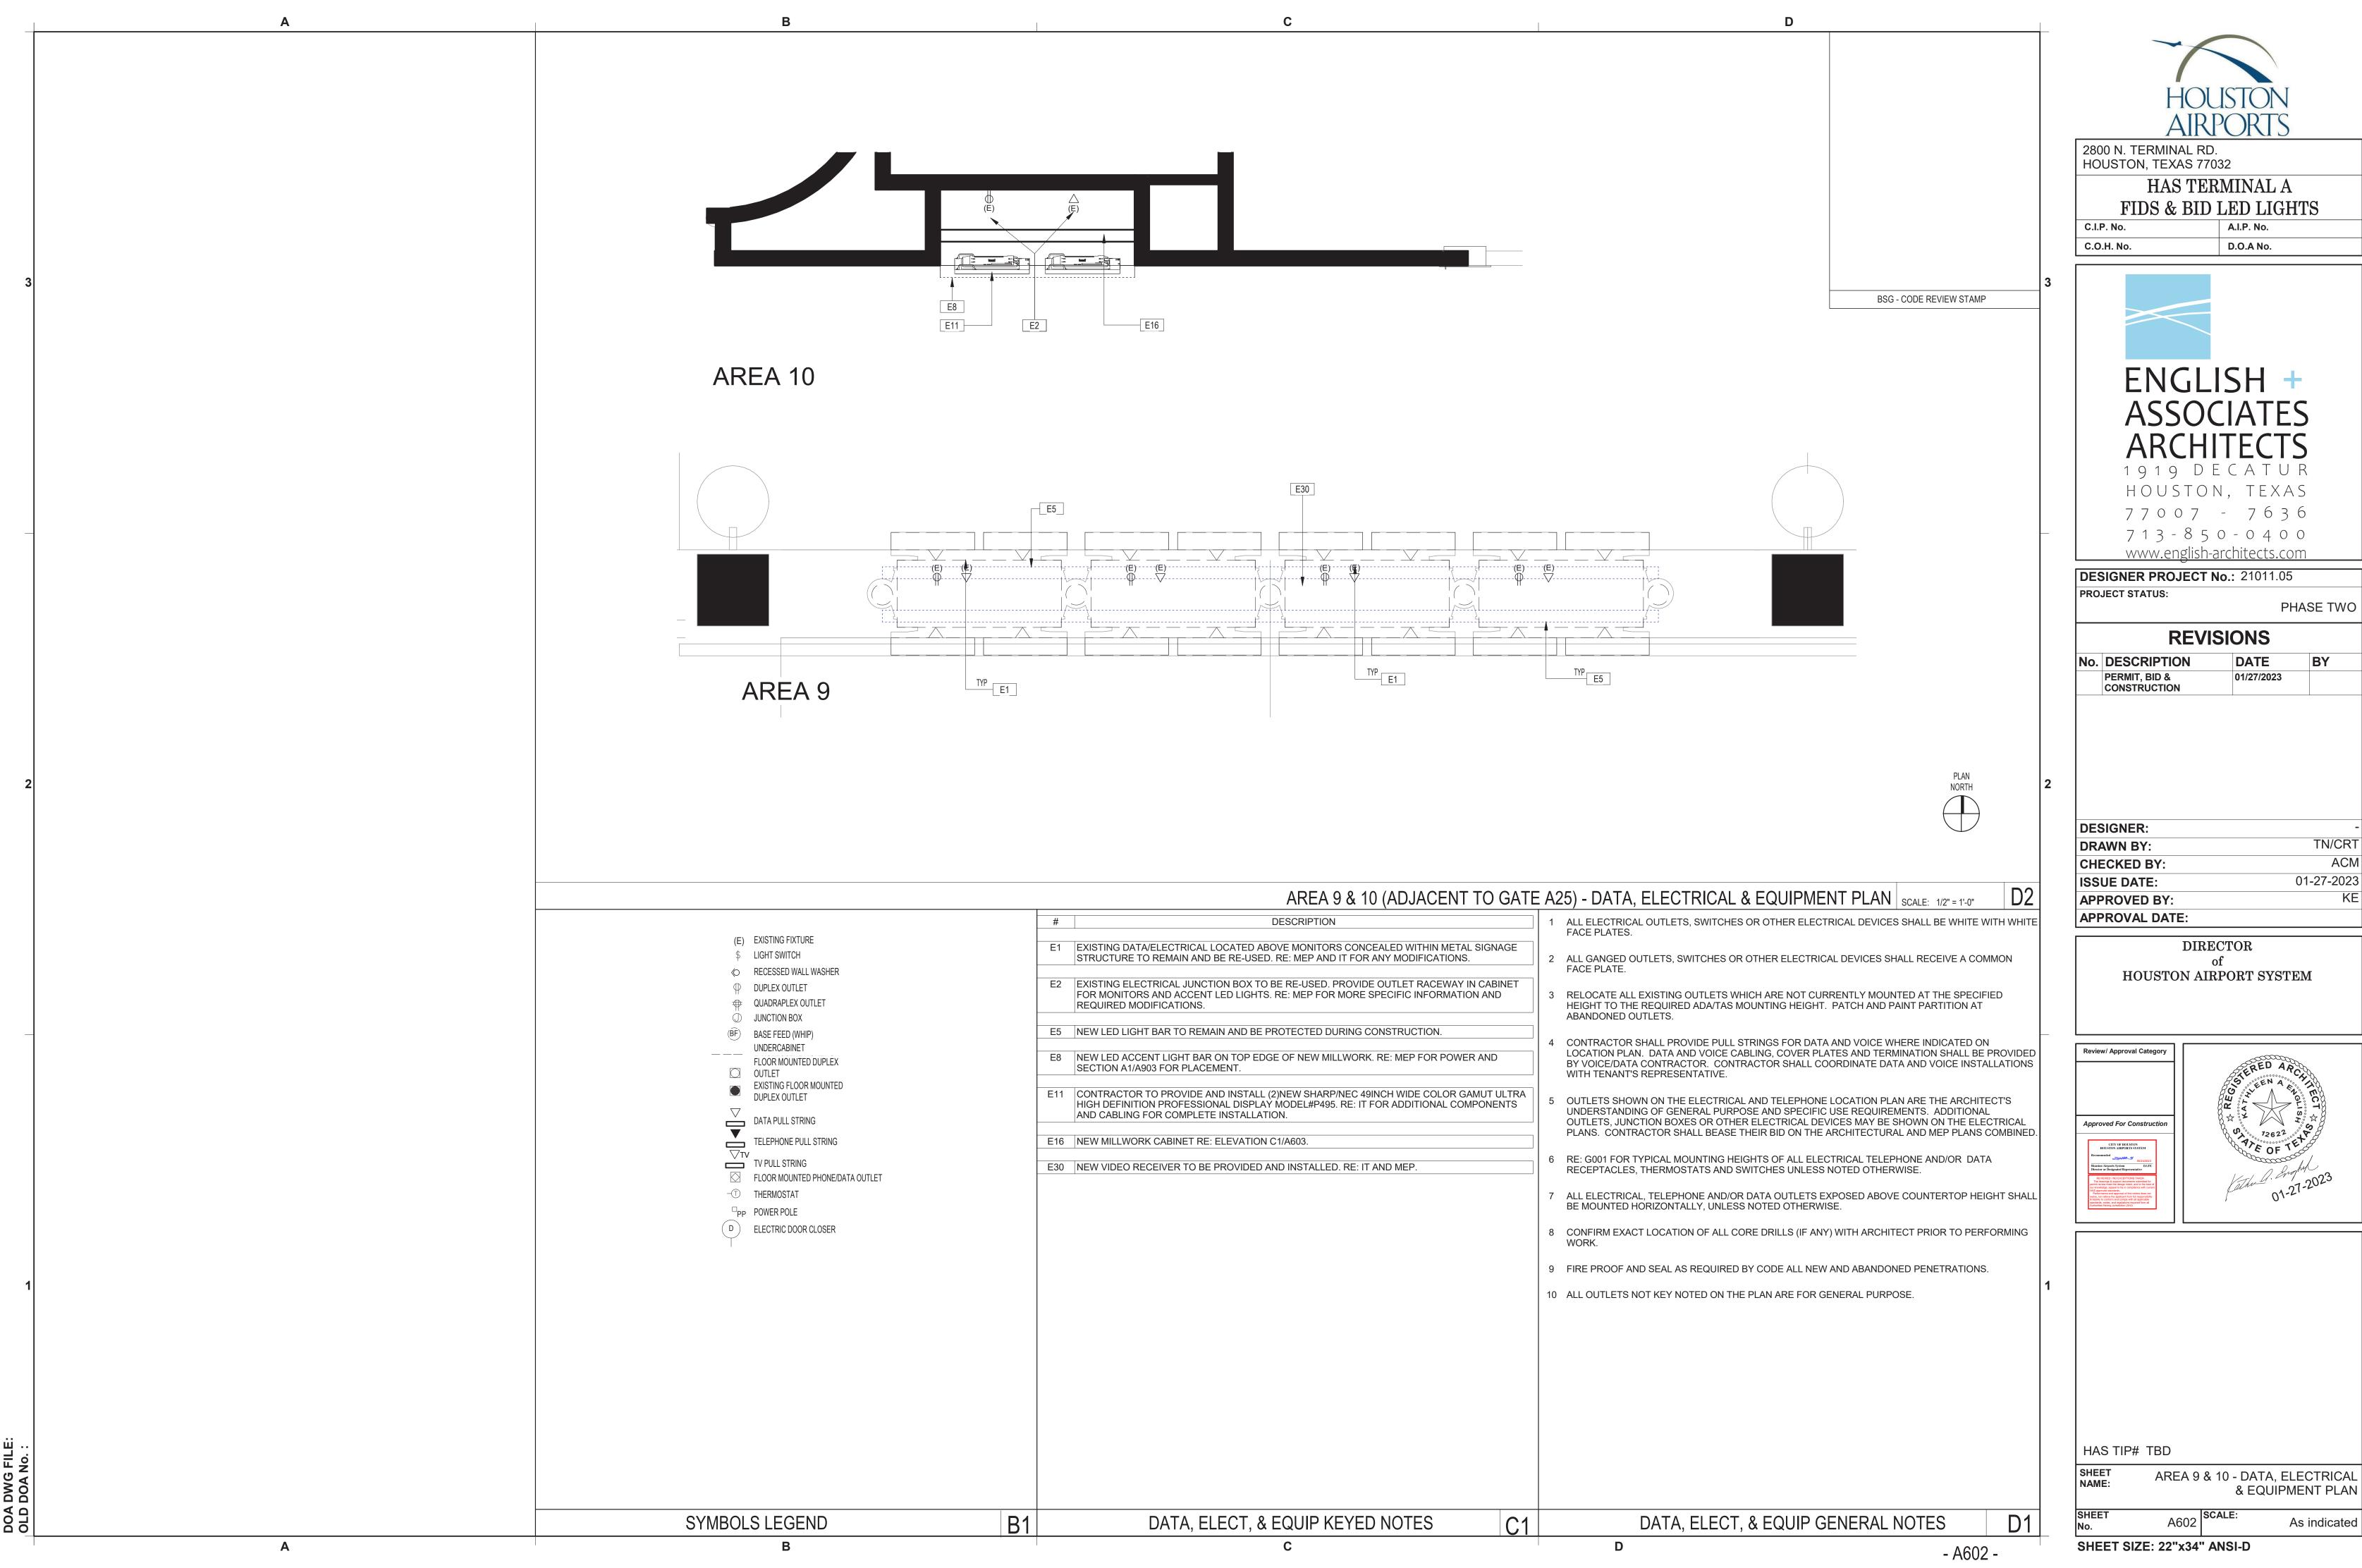
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ISSUE DATE:	01-27-2023
APPROVED BY:	KE
APPROVAL DATE:	

HOUSTON AIRPORT SYSTEM



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AREA 9 & 10 - ARCHITECTURAL FLOOR PLAN AND DEMO PLAN



A.I.P. No. D.O.A No.



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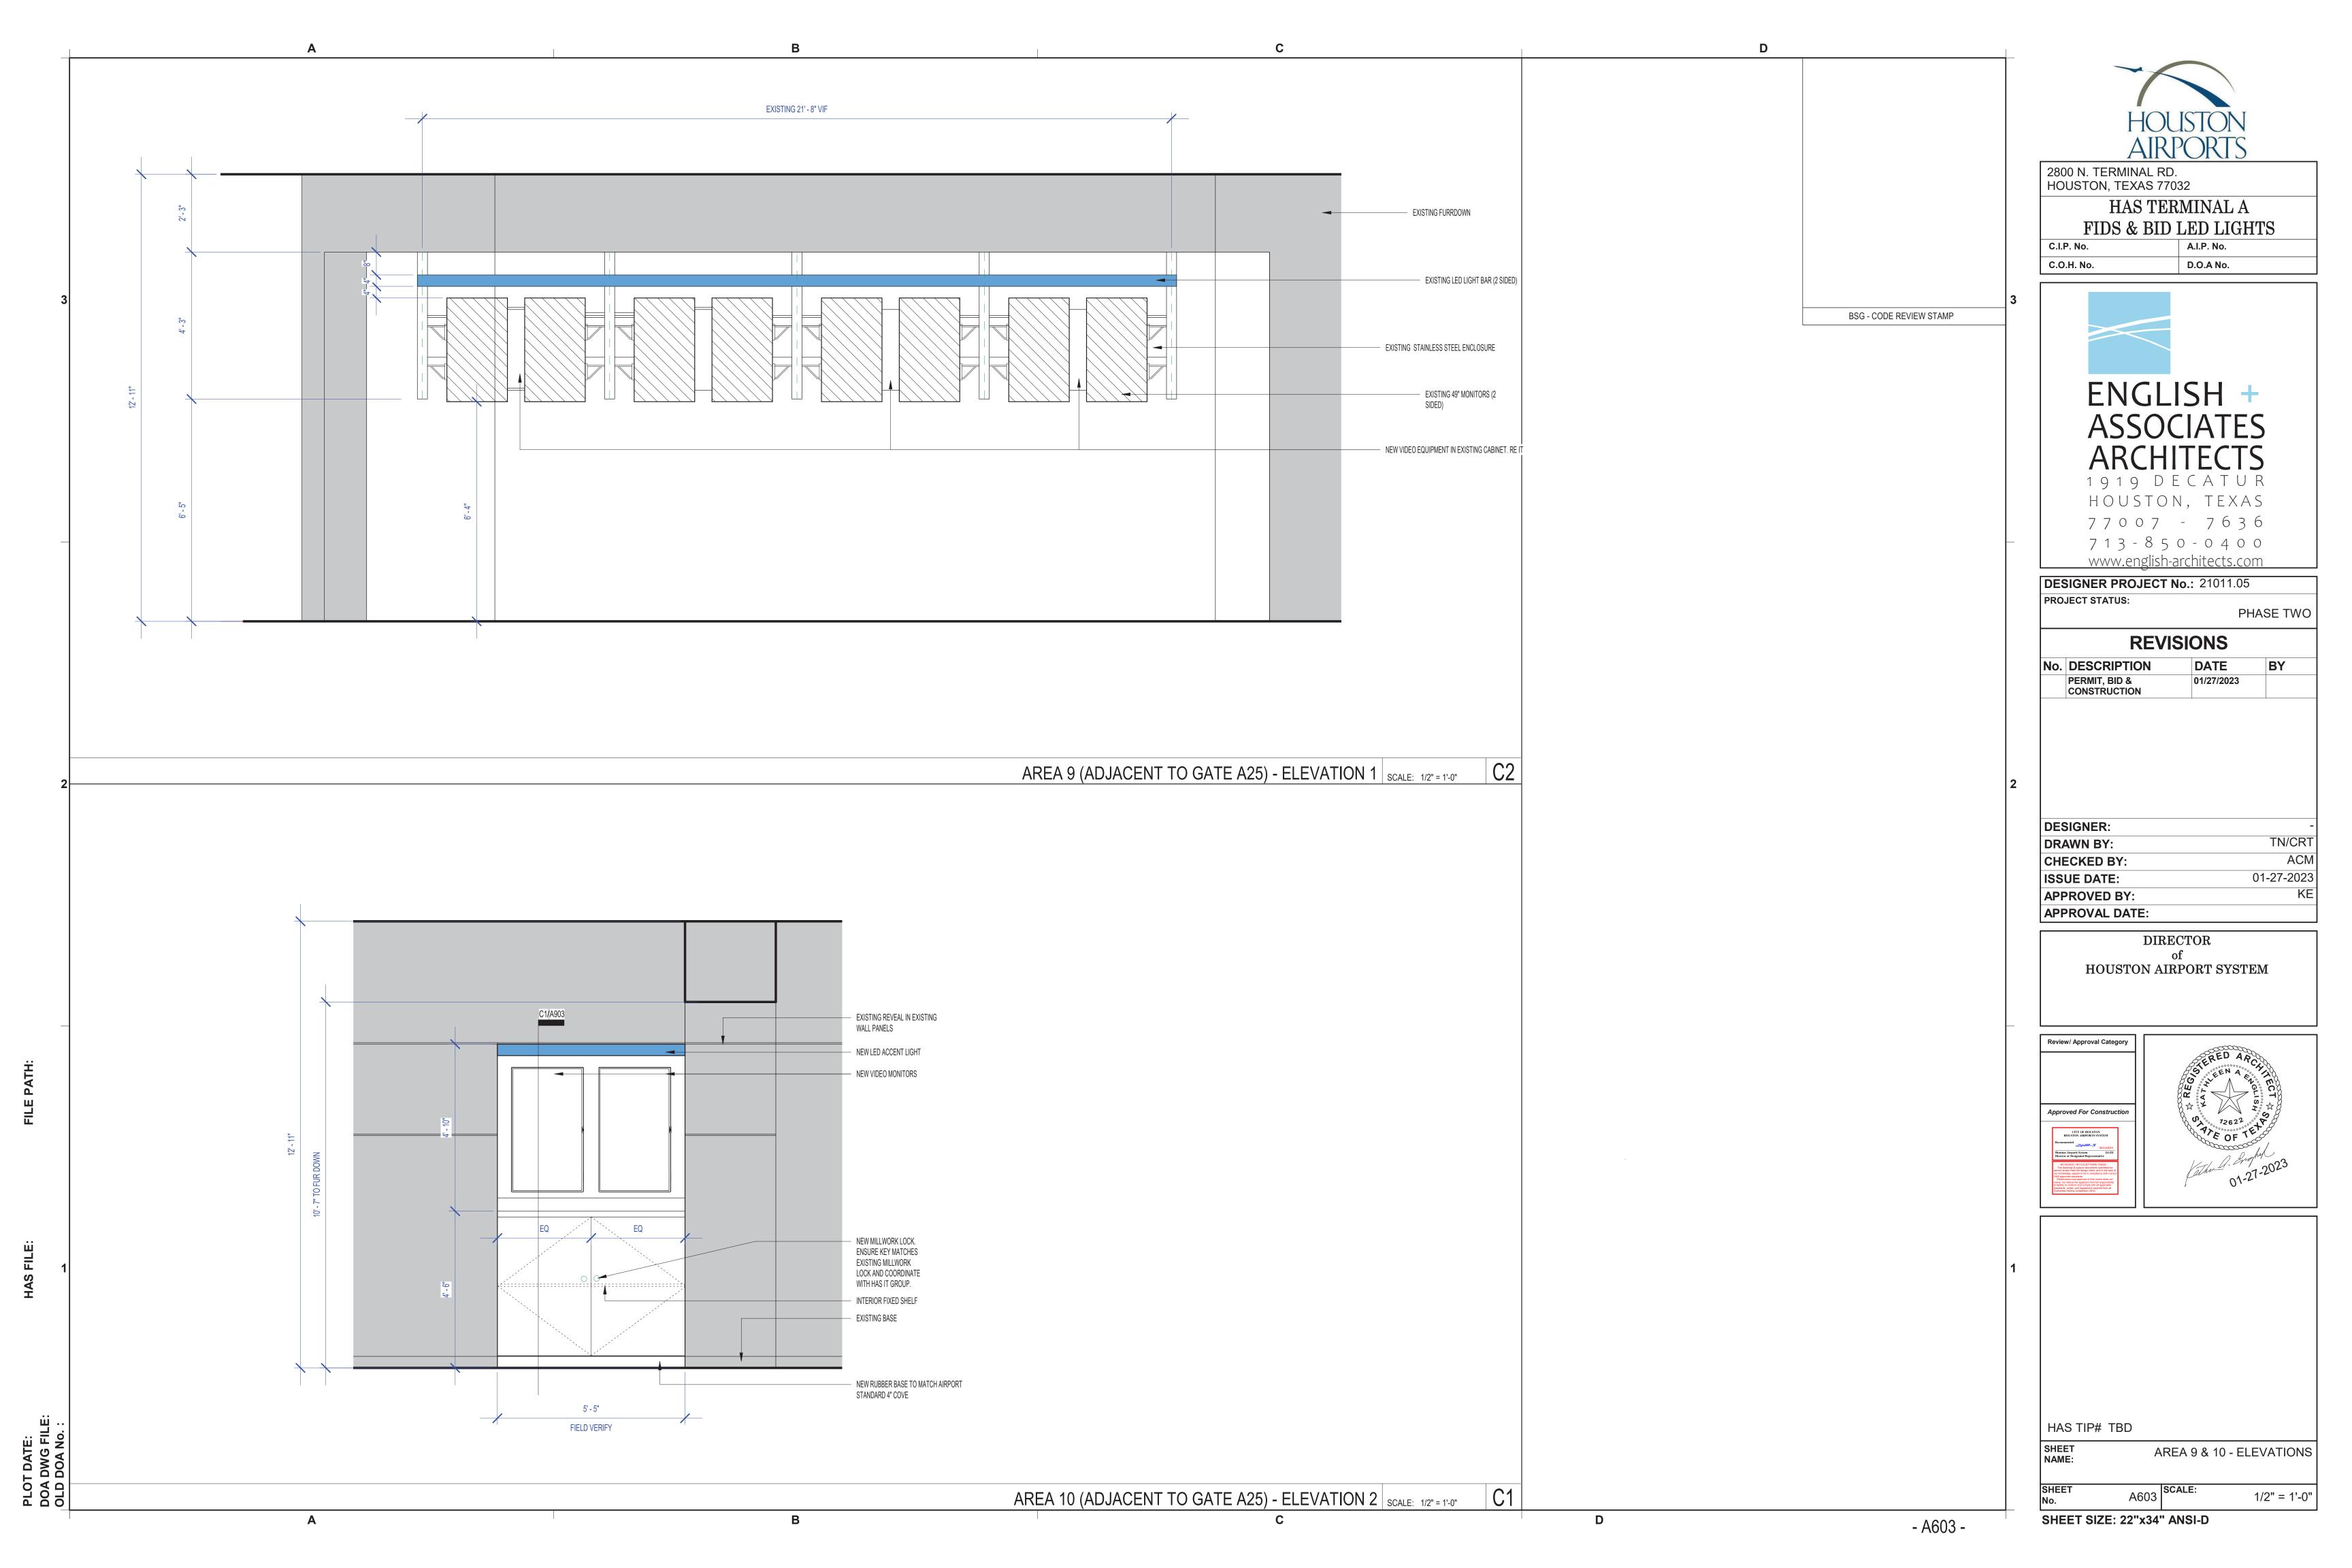
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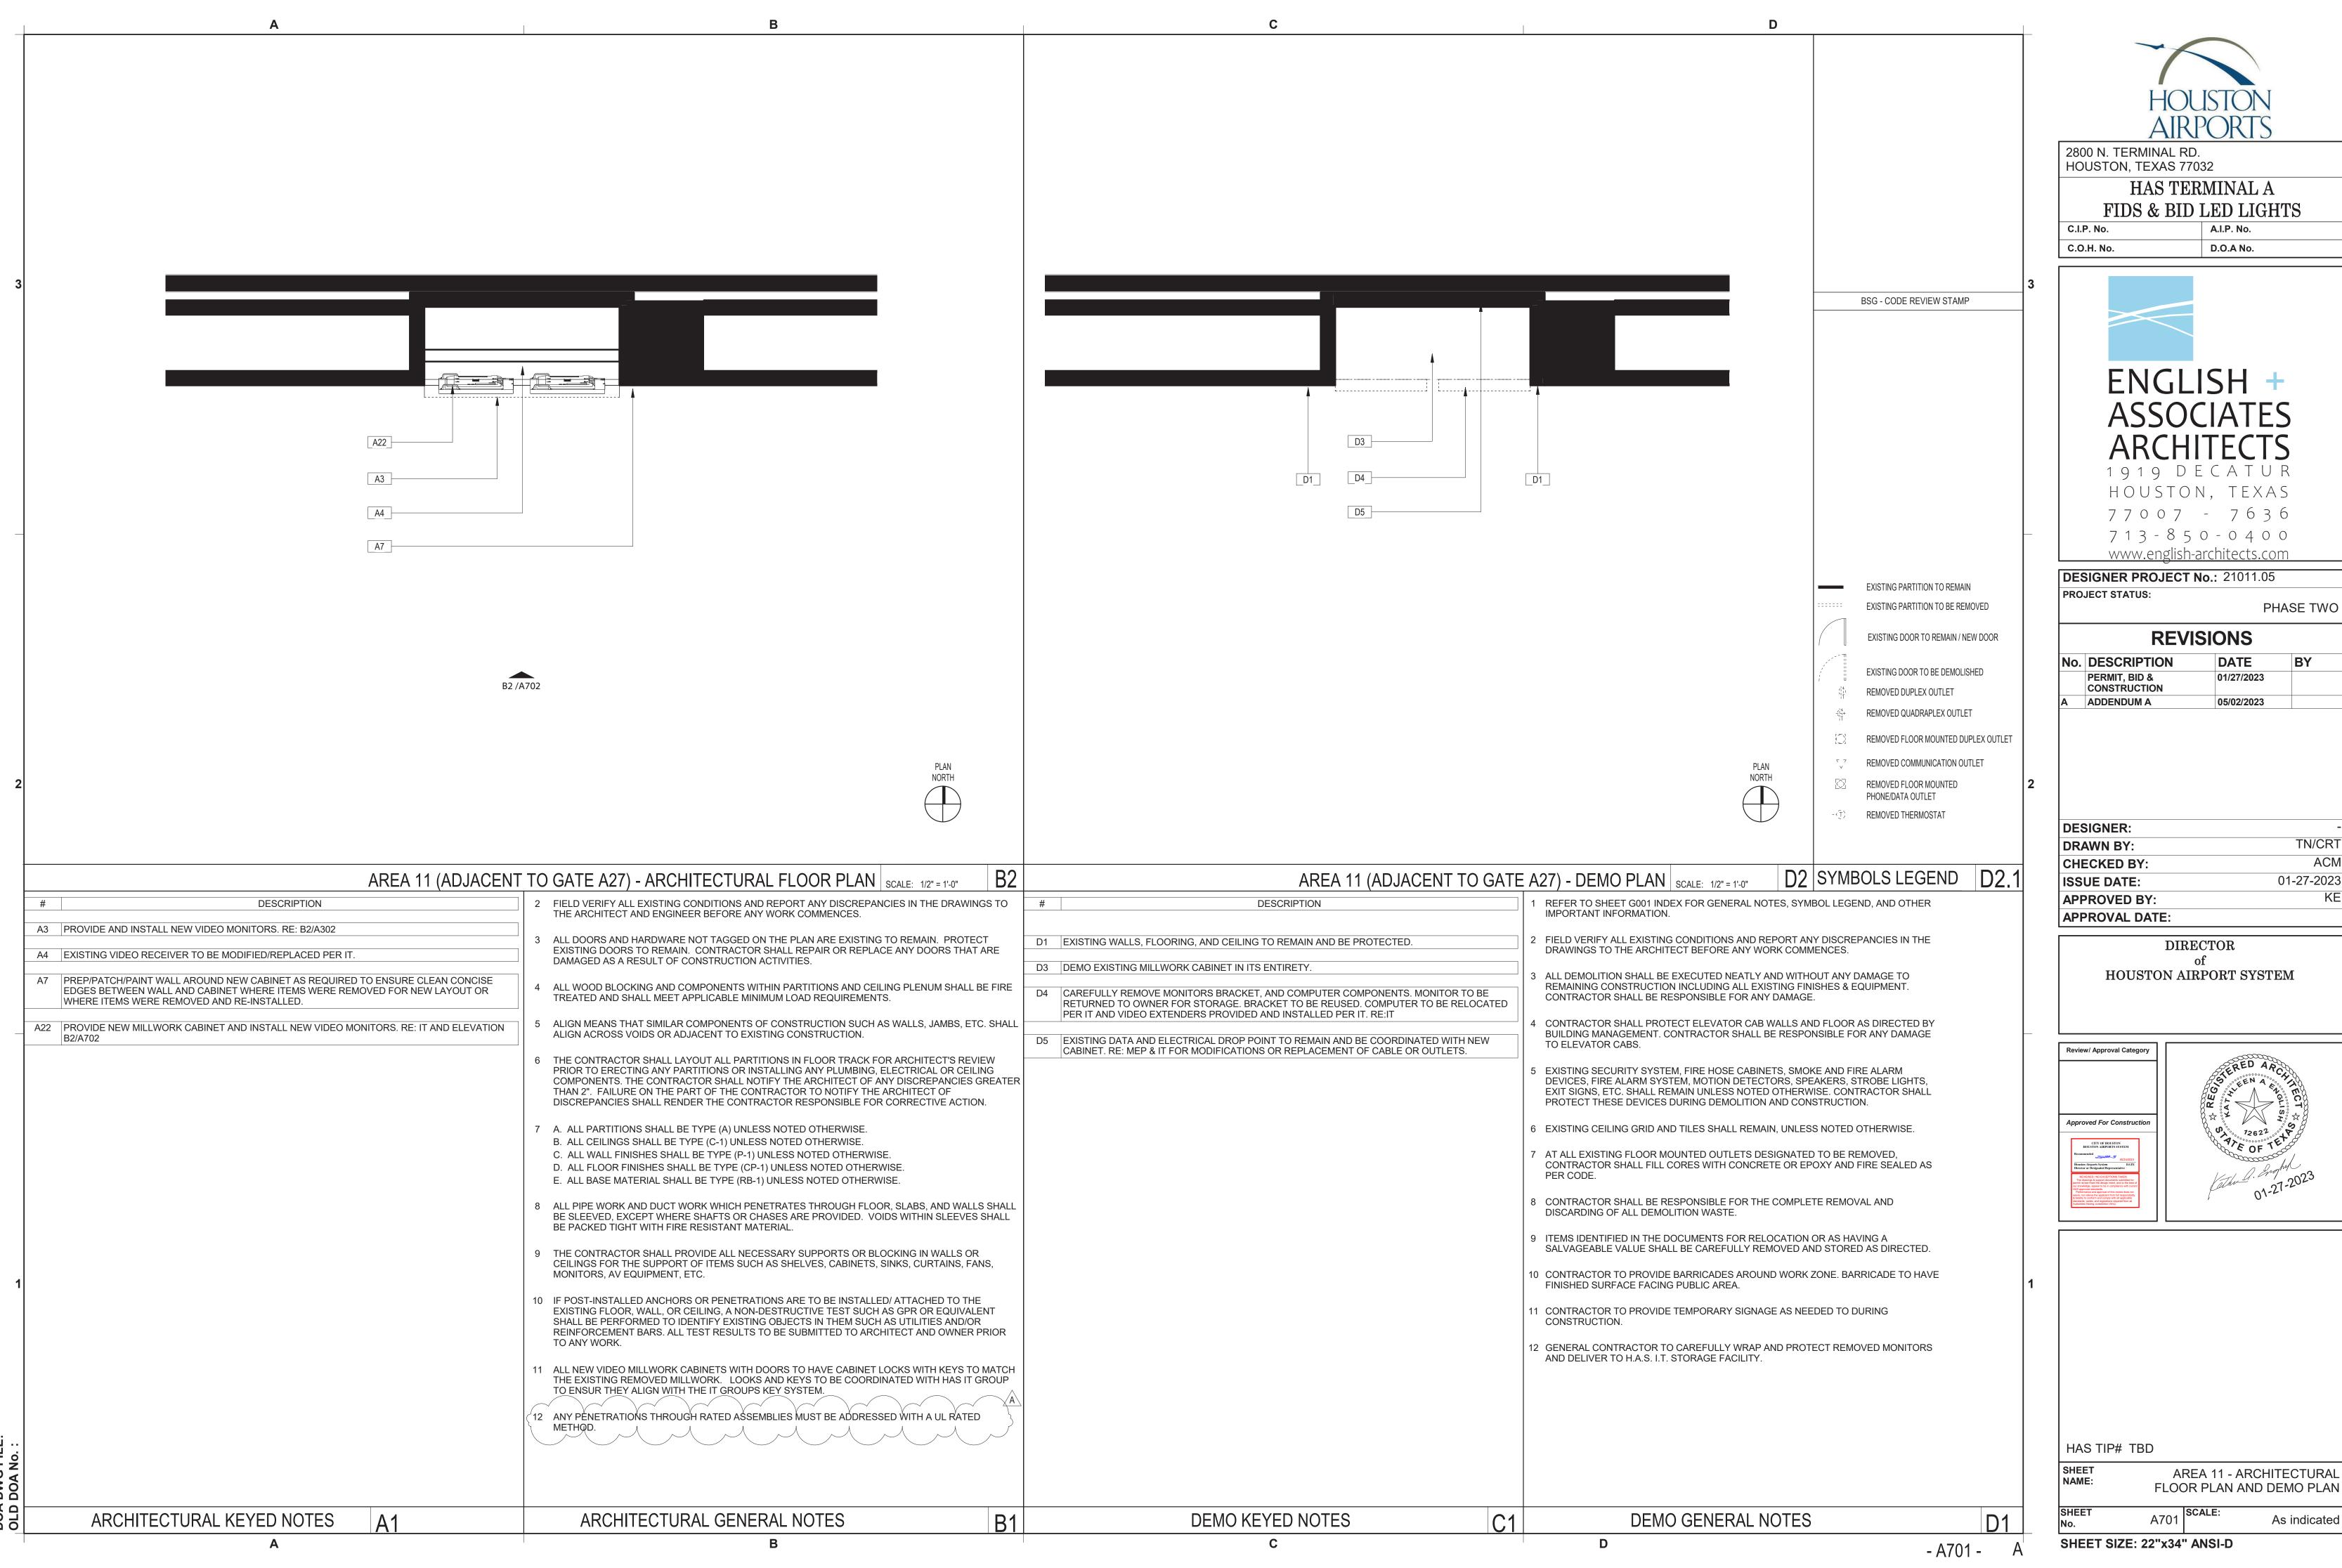
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APPROVED BY:	KE
APPROVAL DATE:	

## HOUSTON AIRPORT SYSTEM



As indicated






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Α	ADDENDUM A	05/02/2023	

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APPROVED BY:	KE
APPROVAL DATE:	



AREA 11 - ARCHITECTURAL FLOOR PLAN AND DEMO PLAN



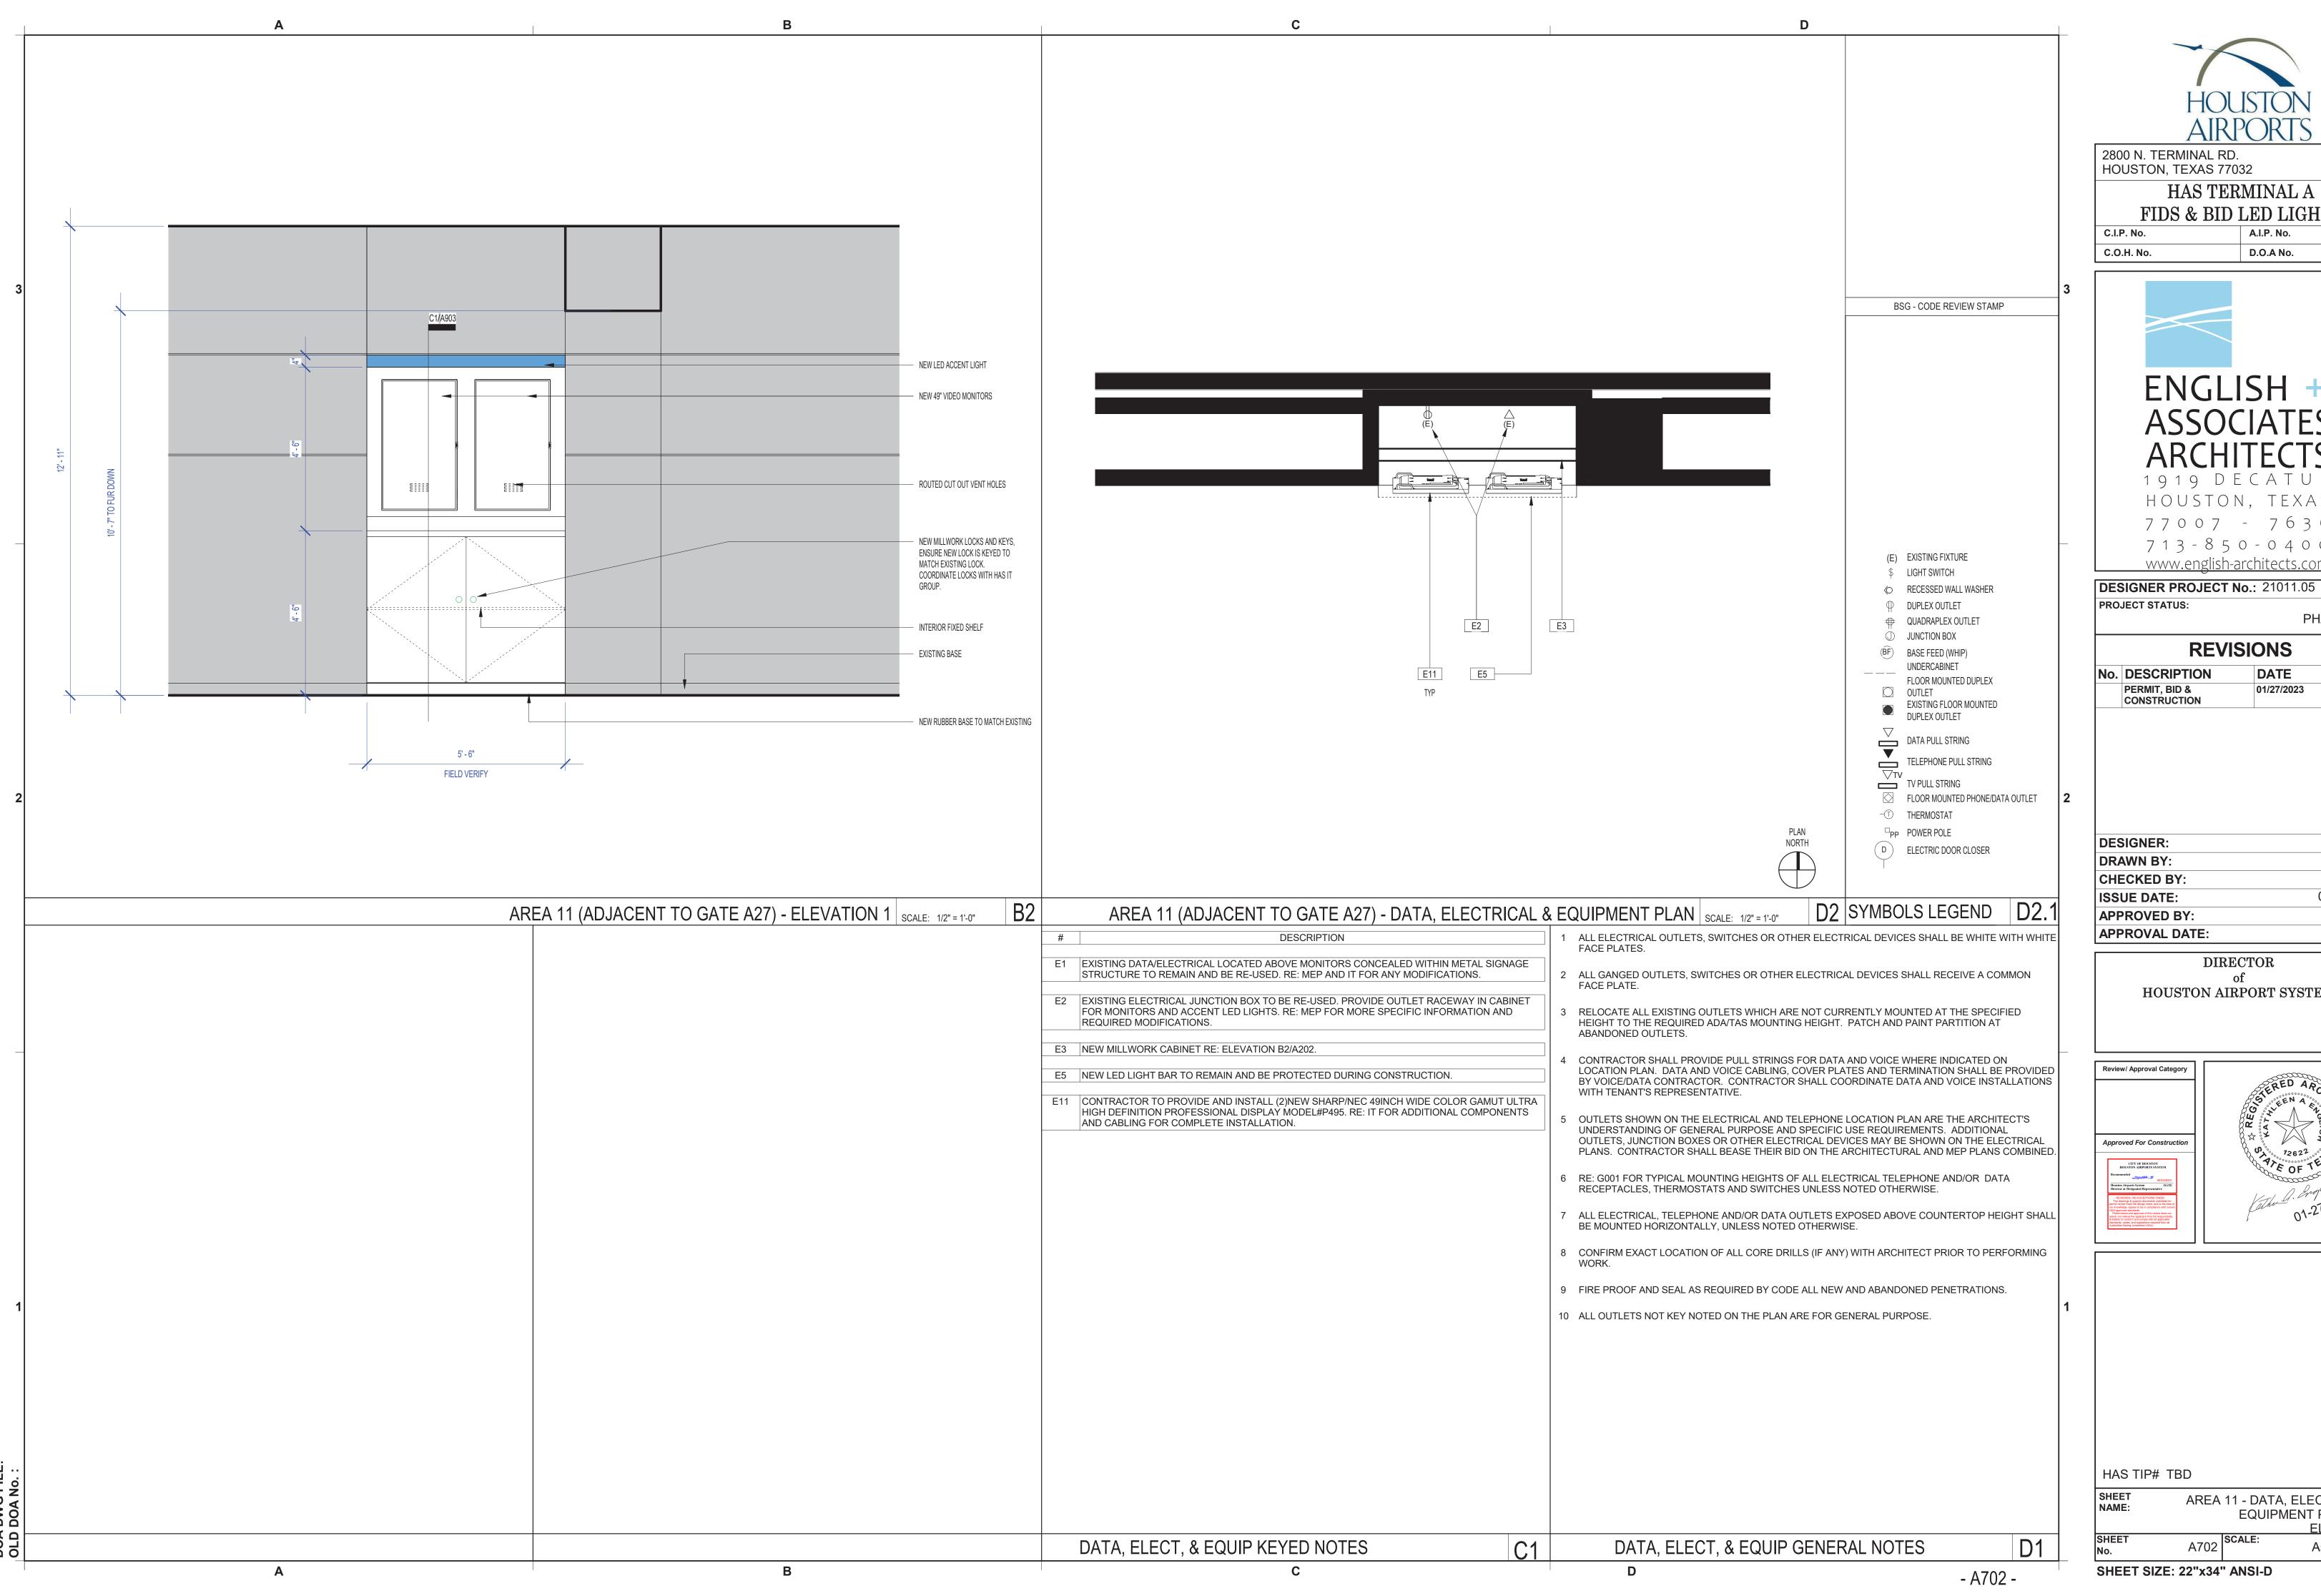

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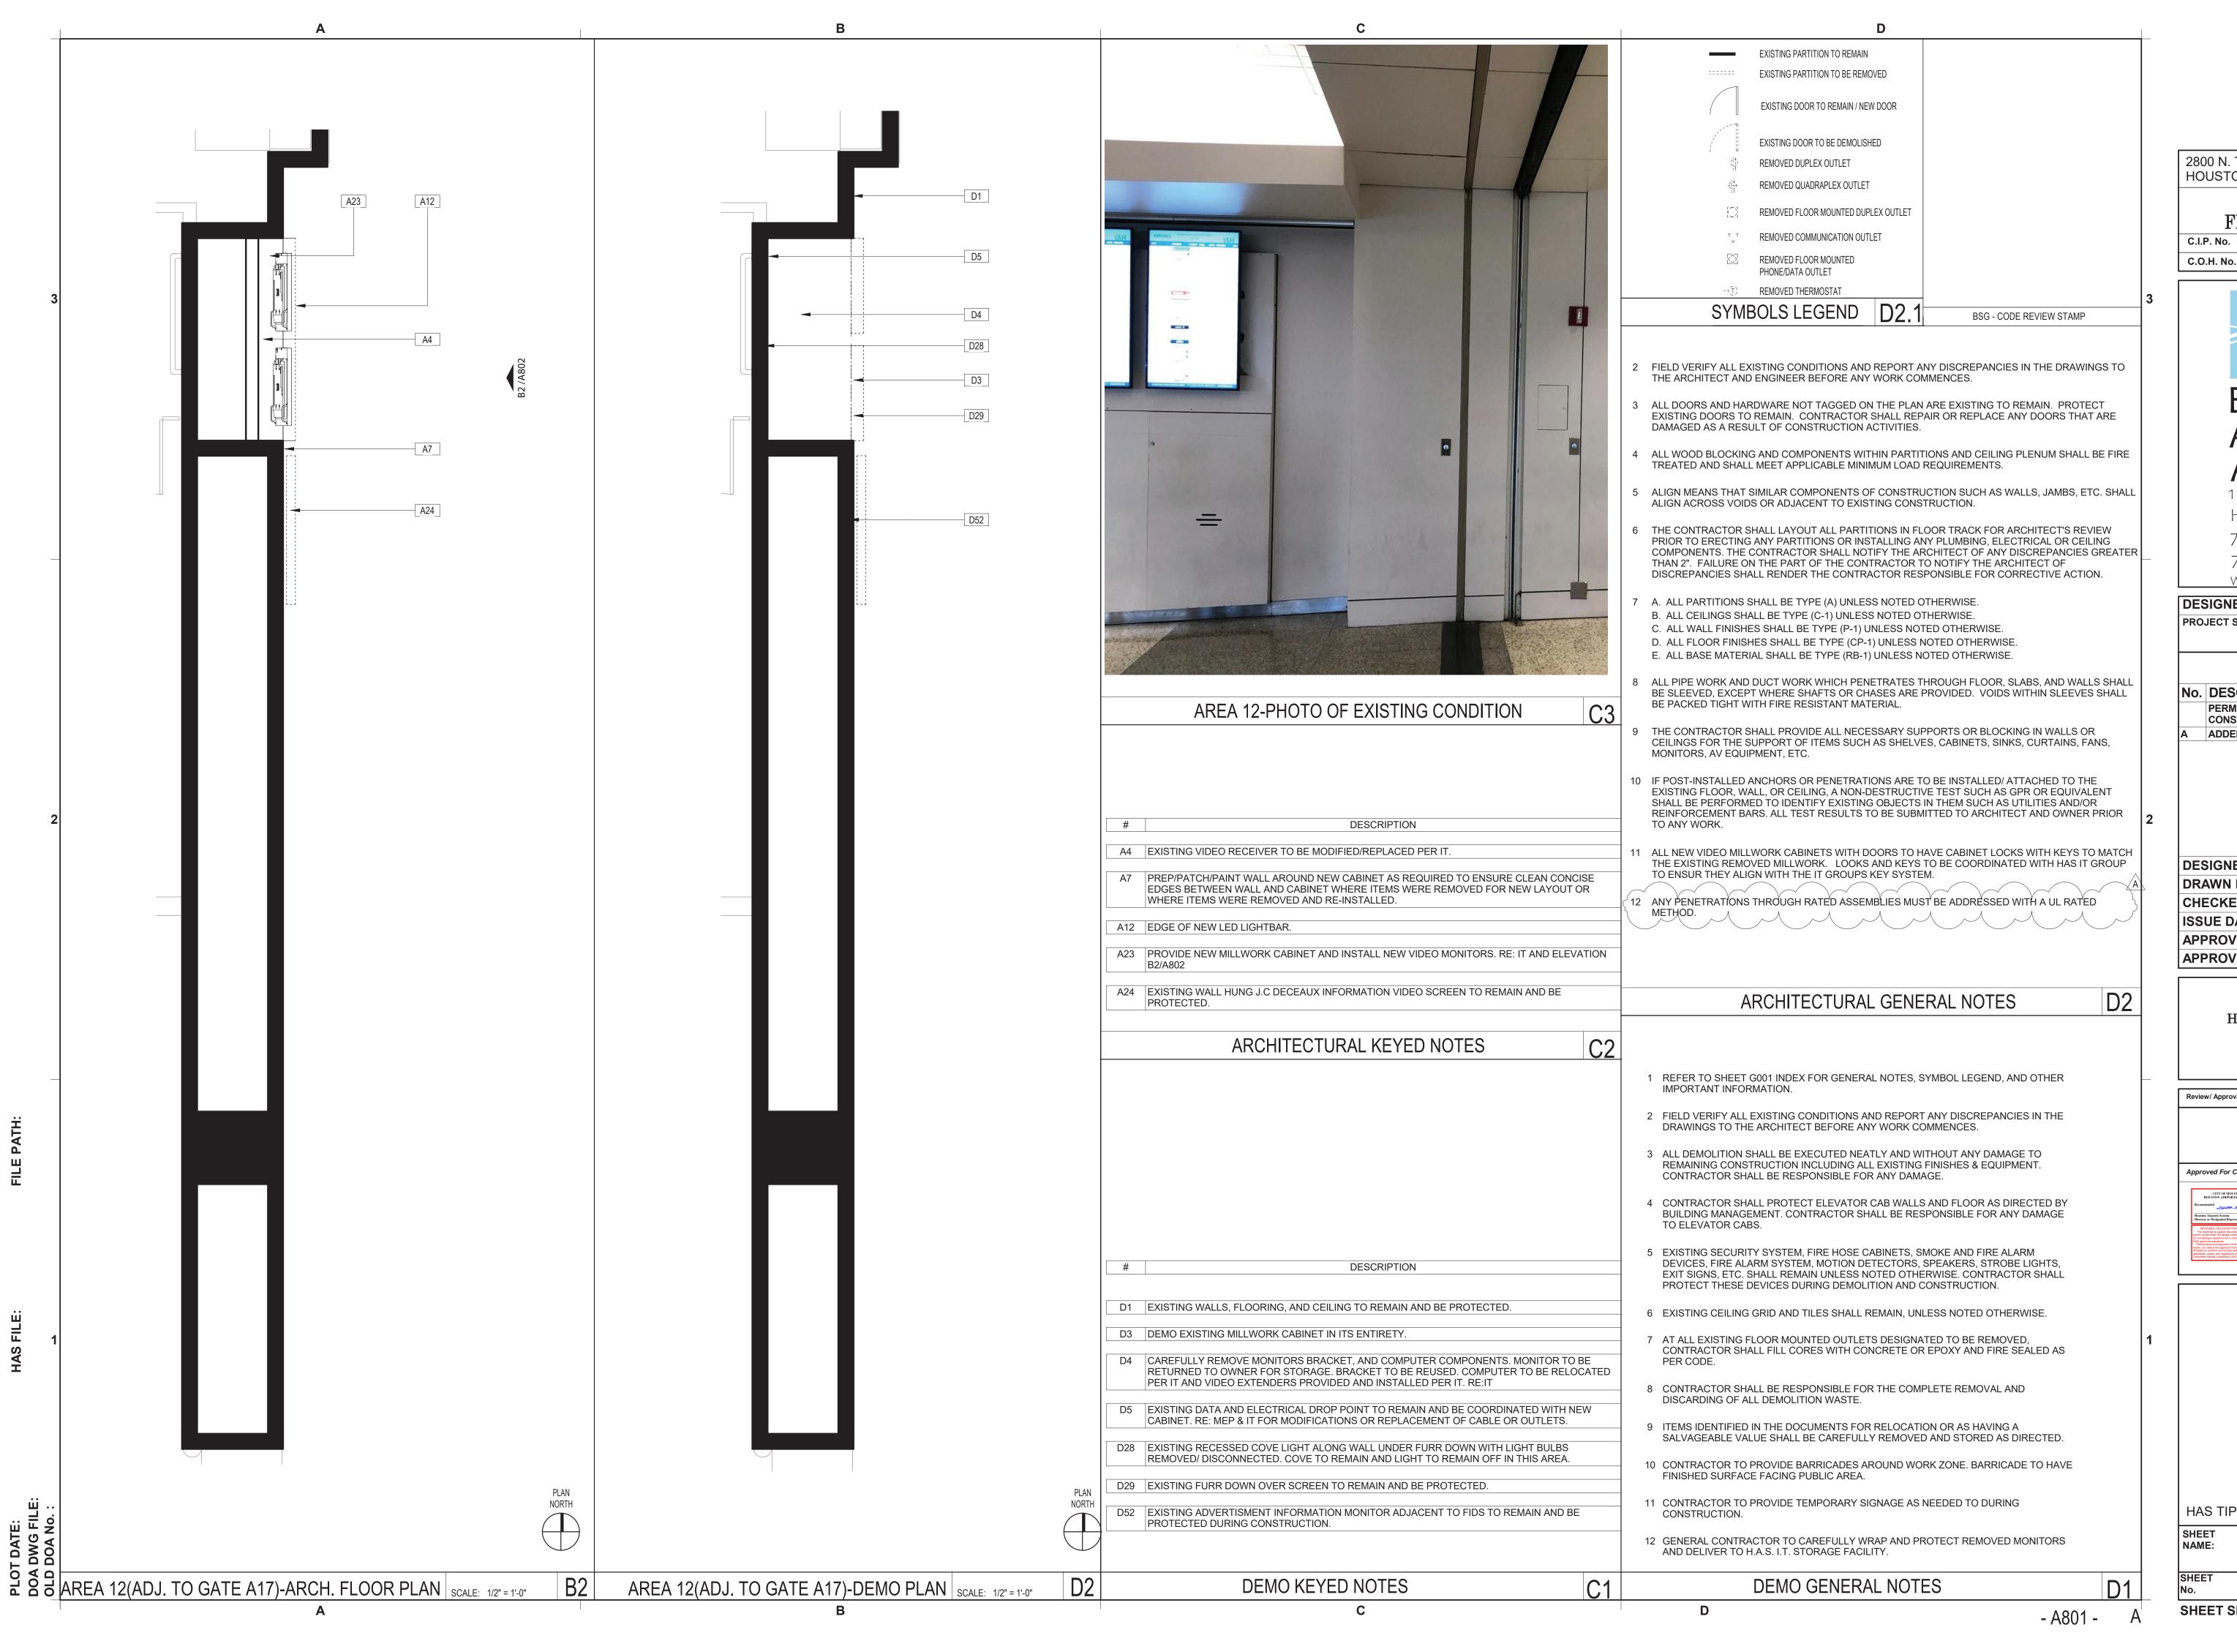
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TN/CRT ACM 01-27-2023

HOUSTON AIRPORT SYSTEM



AREA 11 - DATA, ELECTRICAL & EQUIPMENT PLAN AND ELEVATION A702 SCALE: As indicated





2800 N. TERMINAL RD. HOUSTON, TEXAS 77032

### HAS TERMINAL A FIDS & BID LED LIGHTS

D.O.A No.

C.I.P. No.



**ASSOCIATES ARCHITECTS** 1919 DECATUR

HOUSTON, TEXAS 77007 - 7636 713-850-0400

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**DESIGNER PROJECT No.:** 21011.05 PROJECT STATUS:

### PHASE TWO **REVISIONS**

No.	DESCRIPTION	DATE	BY
	PERMIT, BID & CONSTRUCTION	01/27/2023	
Α	ADDENDUM A	05/02/2023	

DESIGNER:	-
DRAWN BY:	TN/CRT
CHECKED BY:	ACM
ISSUE DATE:	06-30-2022
APPROVED BY:	KE
APPROVAL DATE:	

### DIRECTOR HOUSTON AIRPORT SYSTEM

Review/ Approval Category






HAS TIP# TBD

SHEET AREA 12 - ARCHITECTURAL NAME: FLOOR PLAN AND DEMO PLAN

As indicated

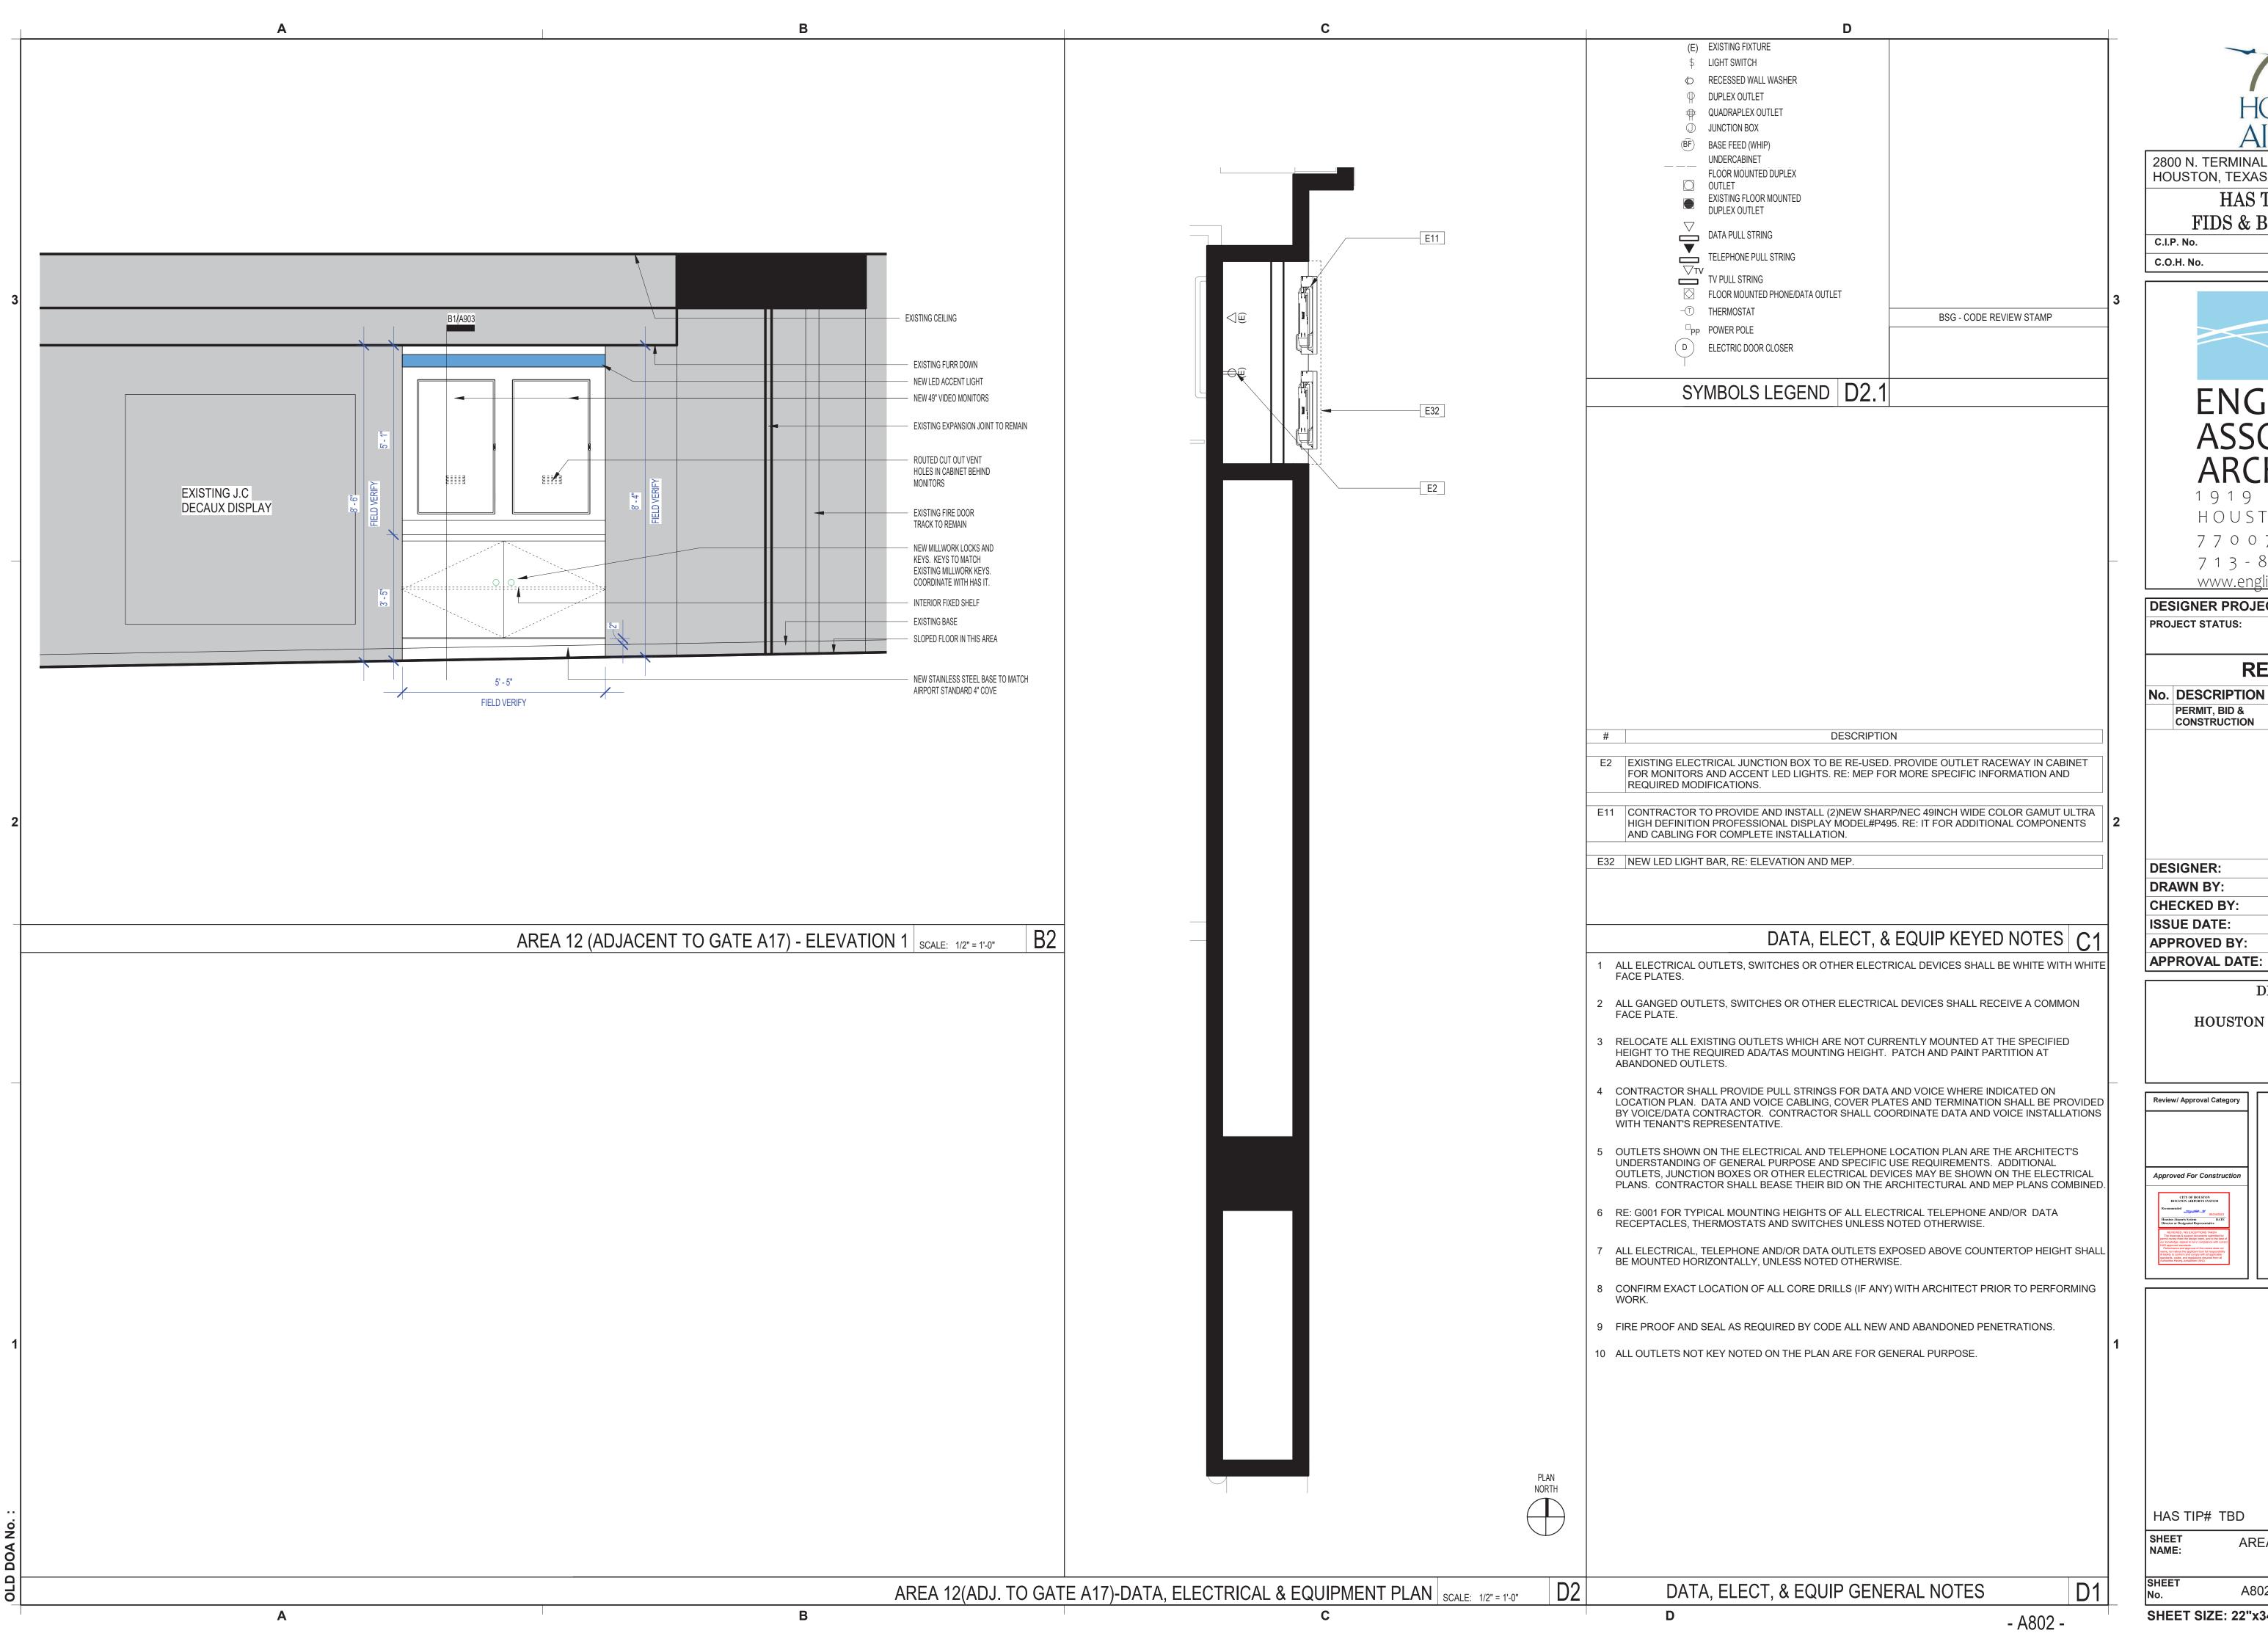



2800 N. TERMINAL RD. HOUSTON, TEXAS 77032

### HAS TERMINAL A FIDS & BID LED LIGHTS

C.I.P. No. A.I.P. No. C.O.H. No. D.O.A No.



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**DESIGNER PROJECT No.:** 21011.05 PROJECT STATUS: PHASE TWO

CONSTRUCTION

**REVISIONS** 

DATE

01/27/2023

**DESIGNER:** TN/CRT **DRAWN BY:** ACM **CHECKED BY:** 06-30-2022 ISSUE DATE: **APPROVED BY:** APPROVAL DATE:

> DIRECTOR HOUSTON AIRPORT SYSTEM


Review/ Approval Category Approved For Construction





HAS TIP# TBD

AREA 12 - DATA, ELECTRICAL & NAME: EQUIPMENT PLAN AND ELEVATION A802 SCALE: As indicated

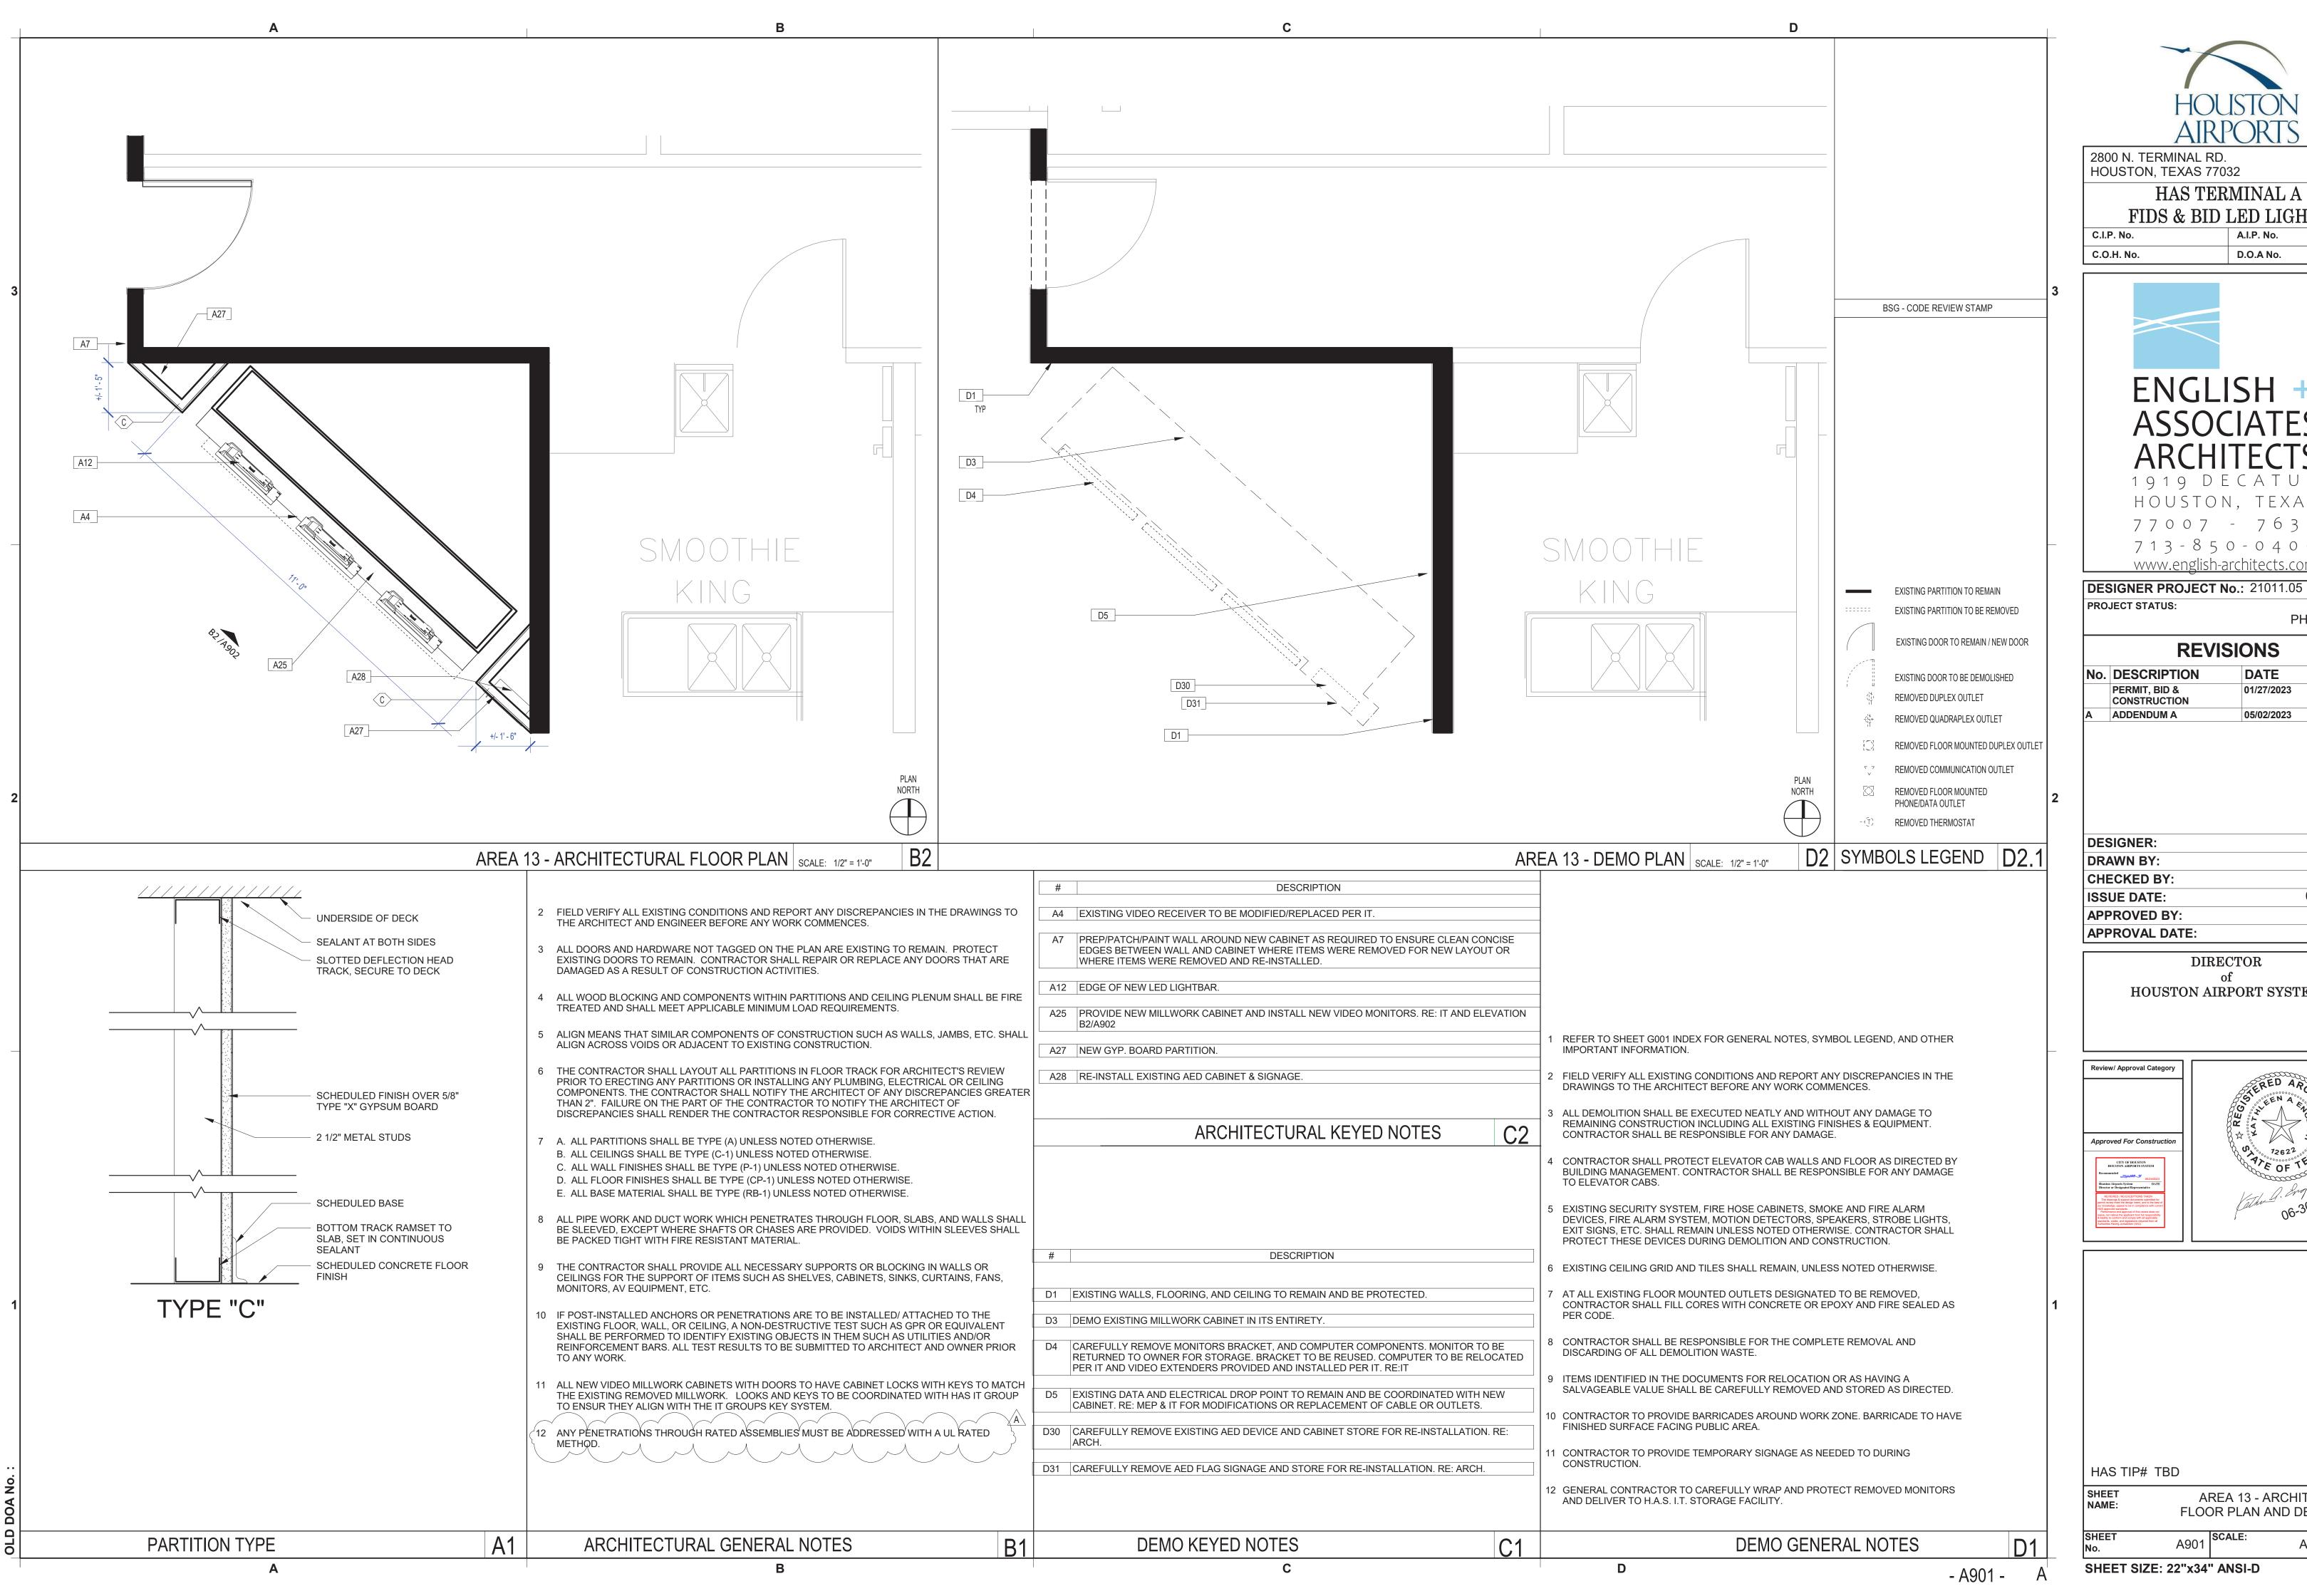



HOUSTON, TEXAS 77032

### HAS TERMINAL A FIDS & BID LED LIGHTS

A.I.P. No. D.O.A No.




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PHASE TWO

No	DESCRIPTION	DATE	BY
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	PERMIT, BID &	01/27/2023	
	CONSTRUCTION		
Α	ADDENDUM A	05/02/2023	


DESIGNER:	
DRAWN BY:	TN/CRT
CHECKED BY:	ACM
ISSUE DATE:	06-30-2022
APPROVED BY:	KE
APPROVAL DATE:	

### DIRECTOR HOUSTON AIRPORT SYSTEM

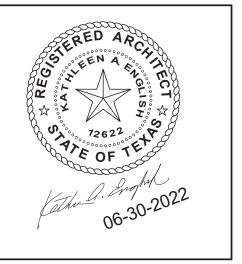


As indicated


AREA 13 - ARCHITECTURAL FLOOR PLAN AND DEMO PLAN SCALE:

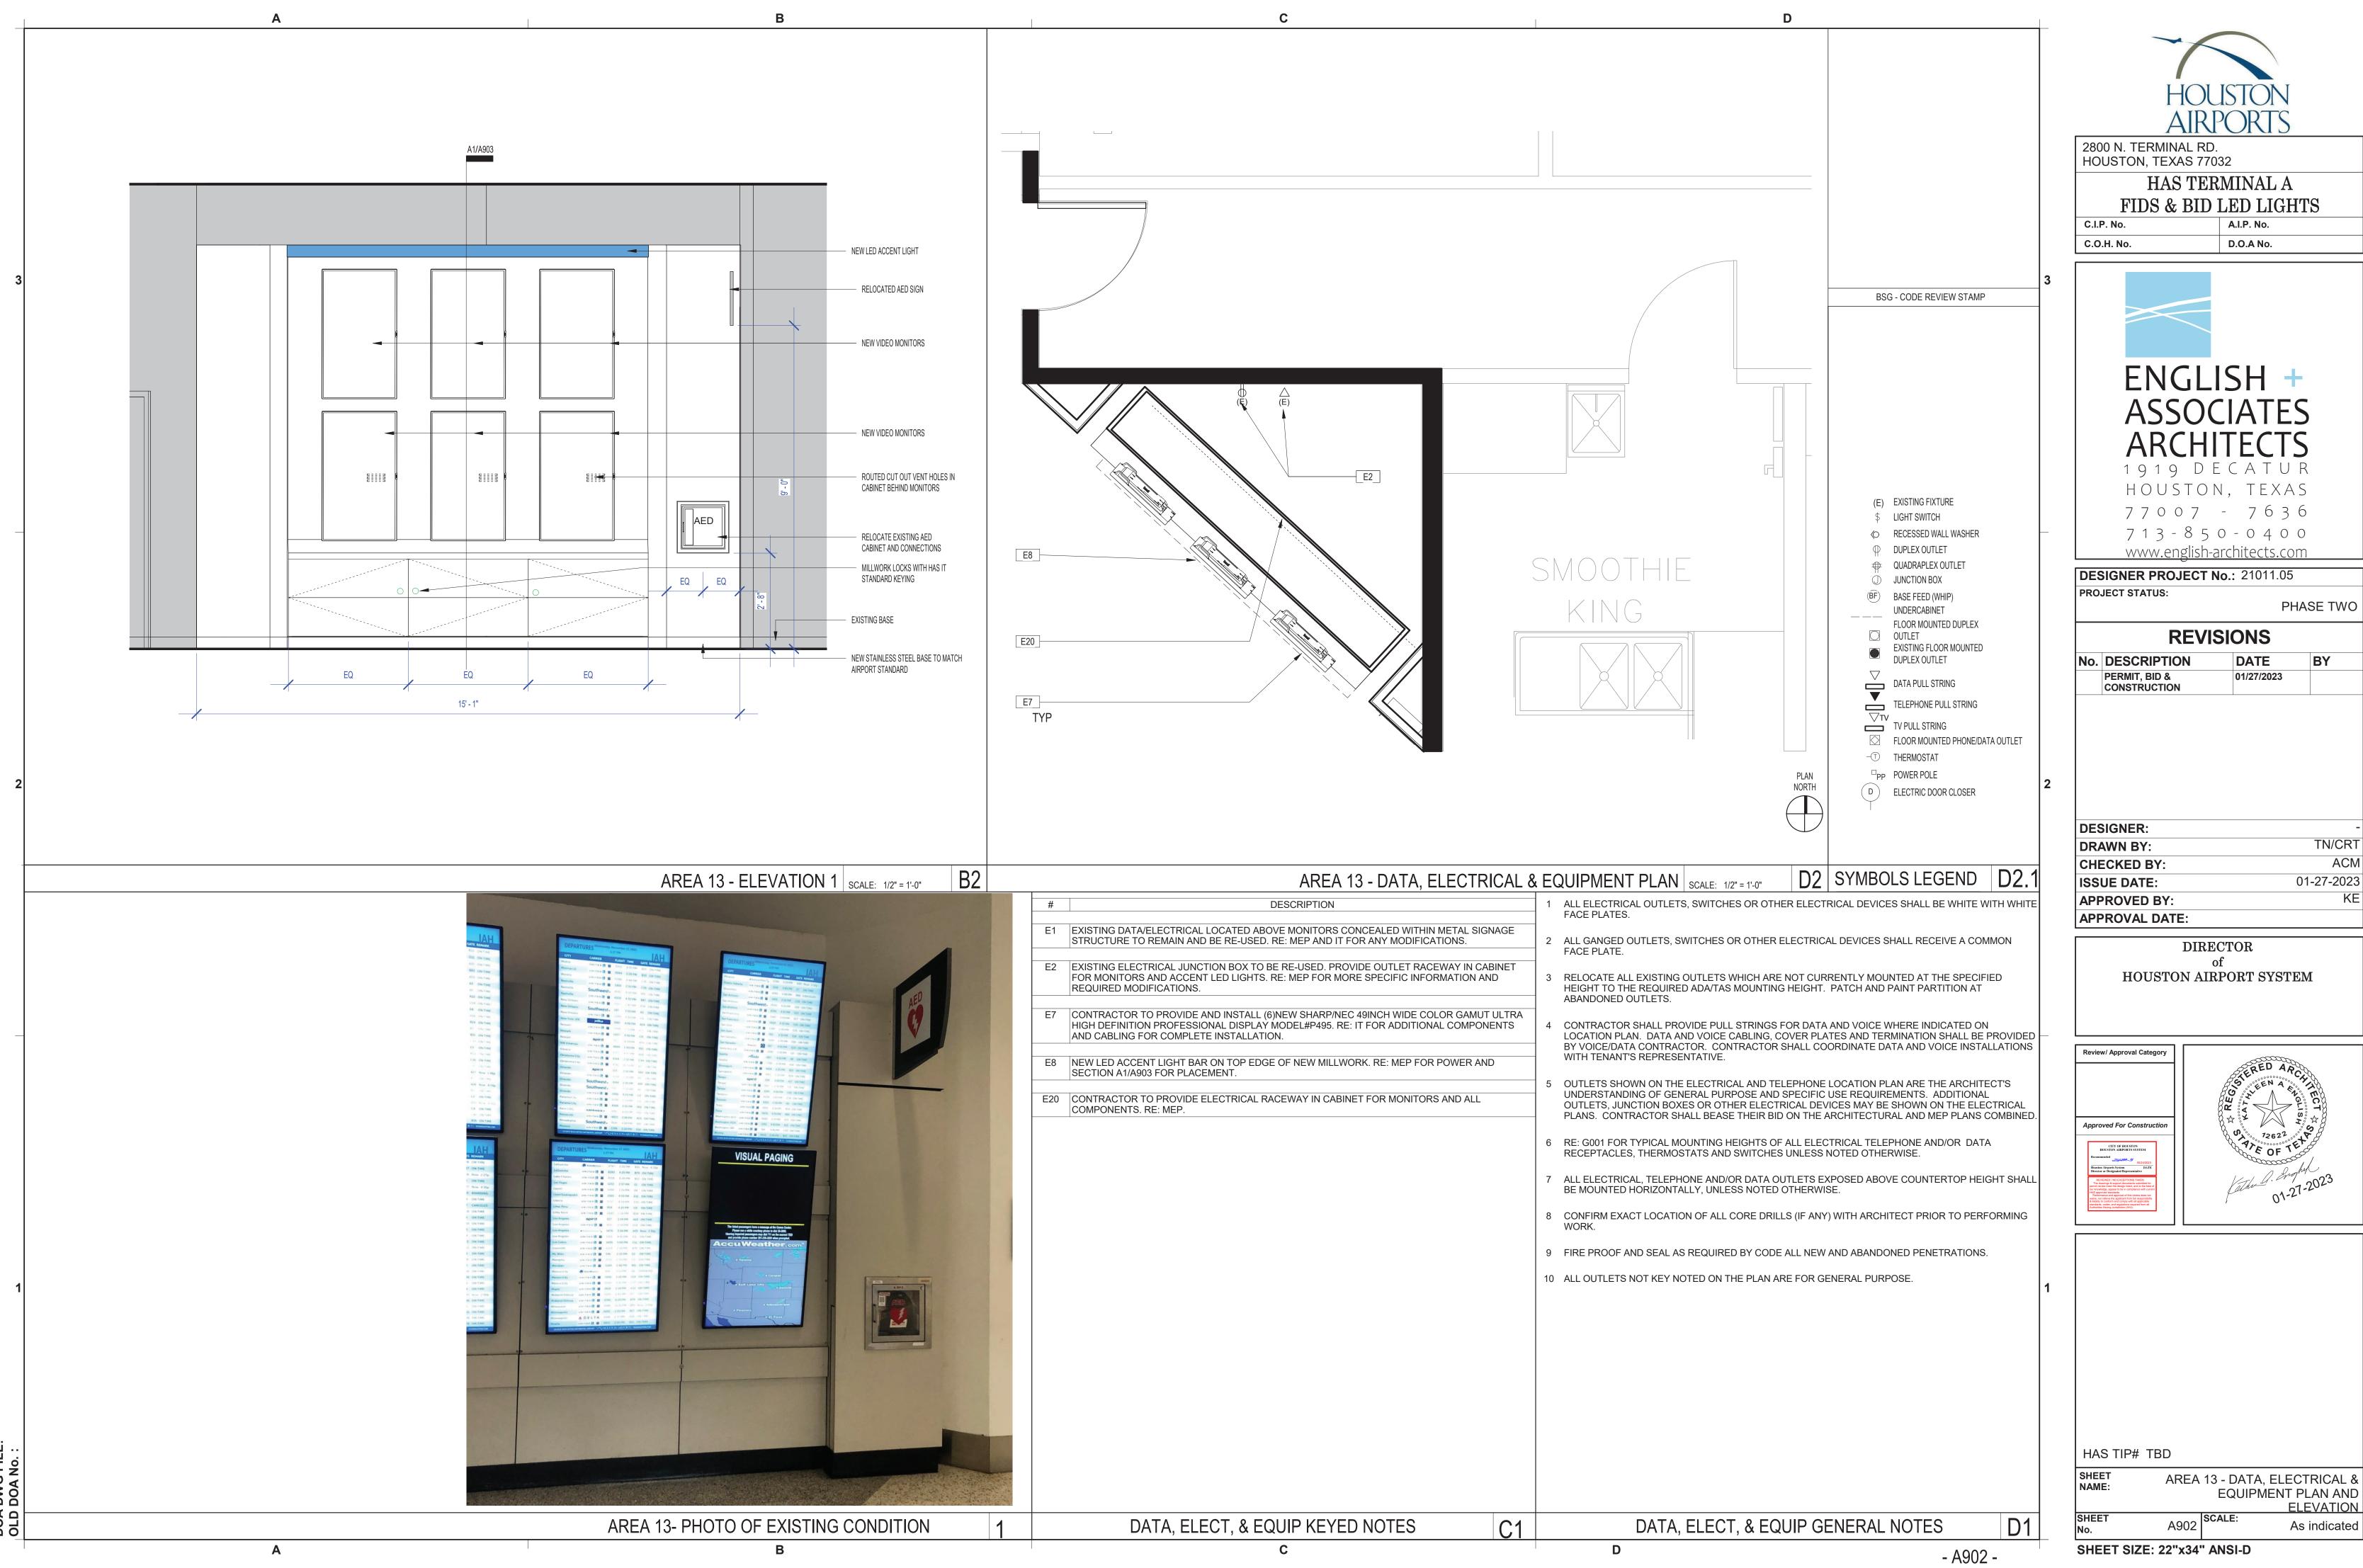


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AREA 13 - DATA, ELECTRICAL & EQUIPMENT PLAN AND **ELEVATION** 

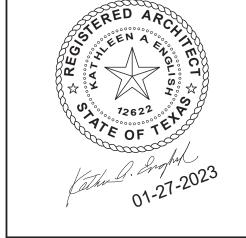



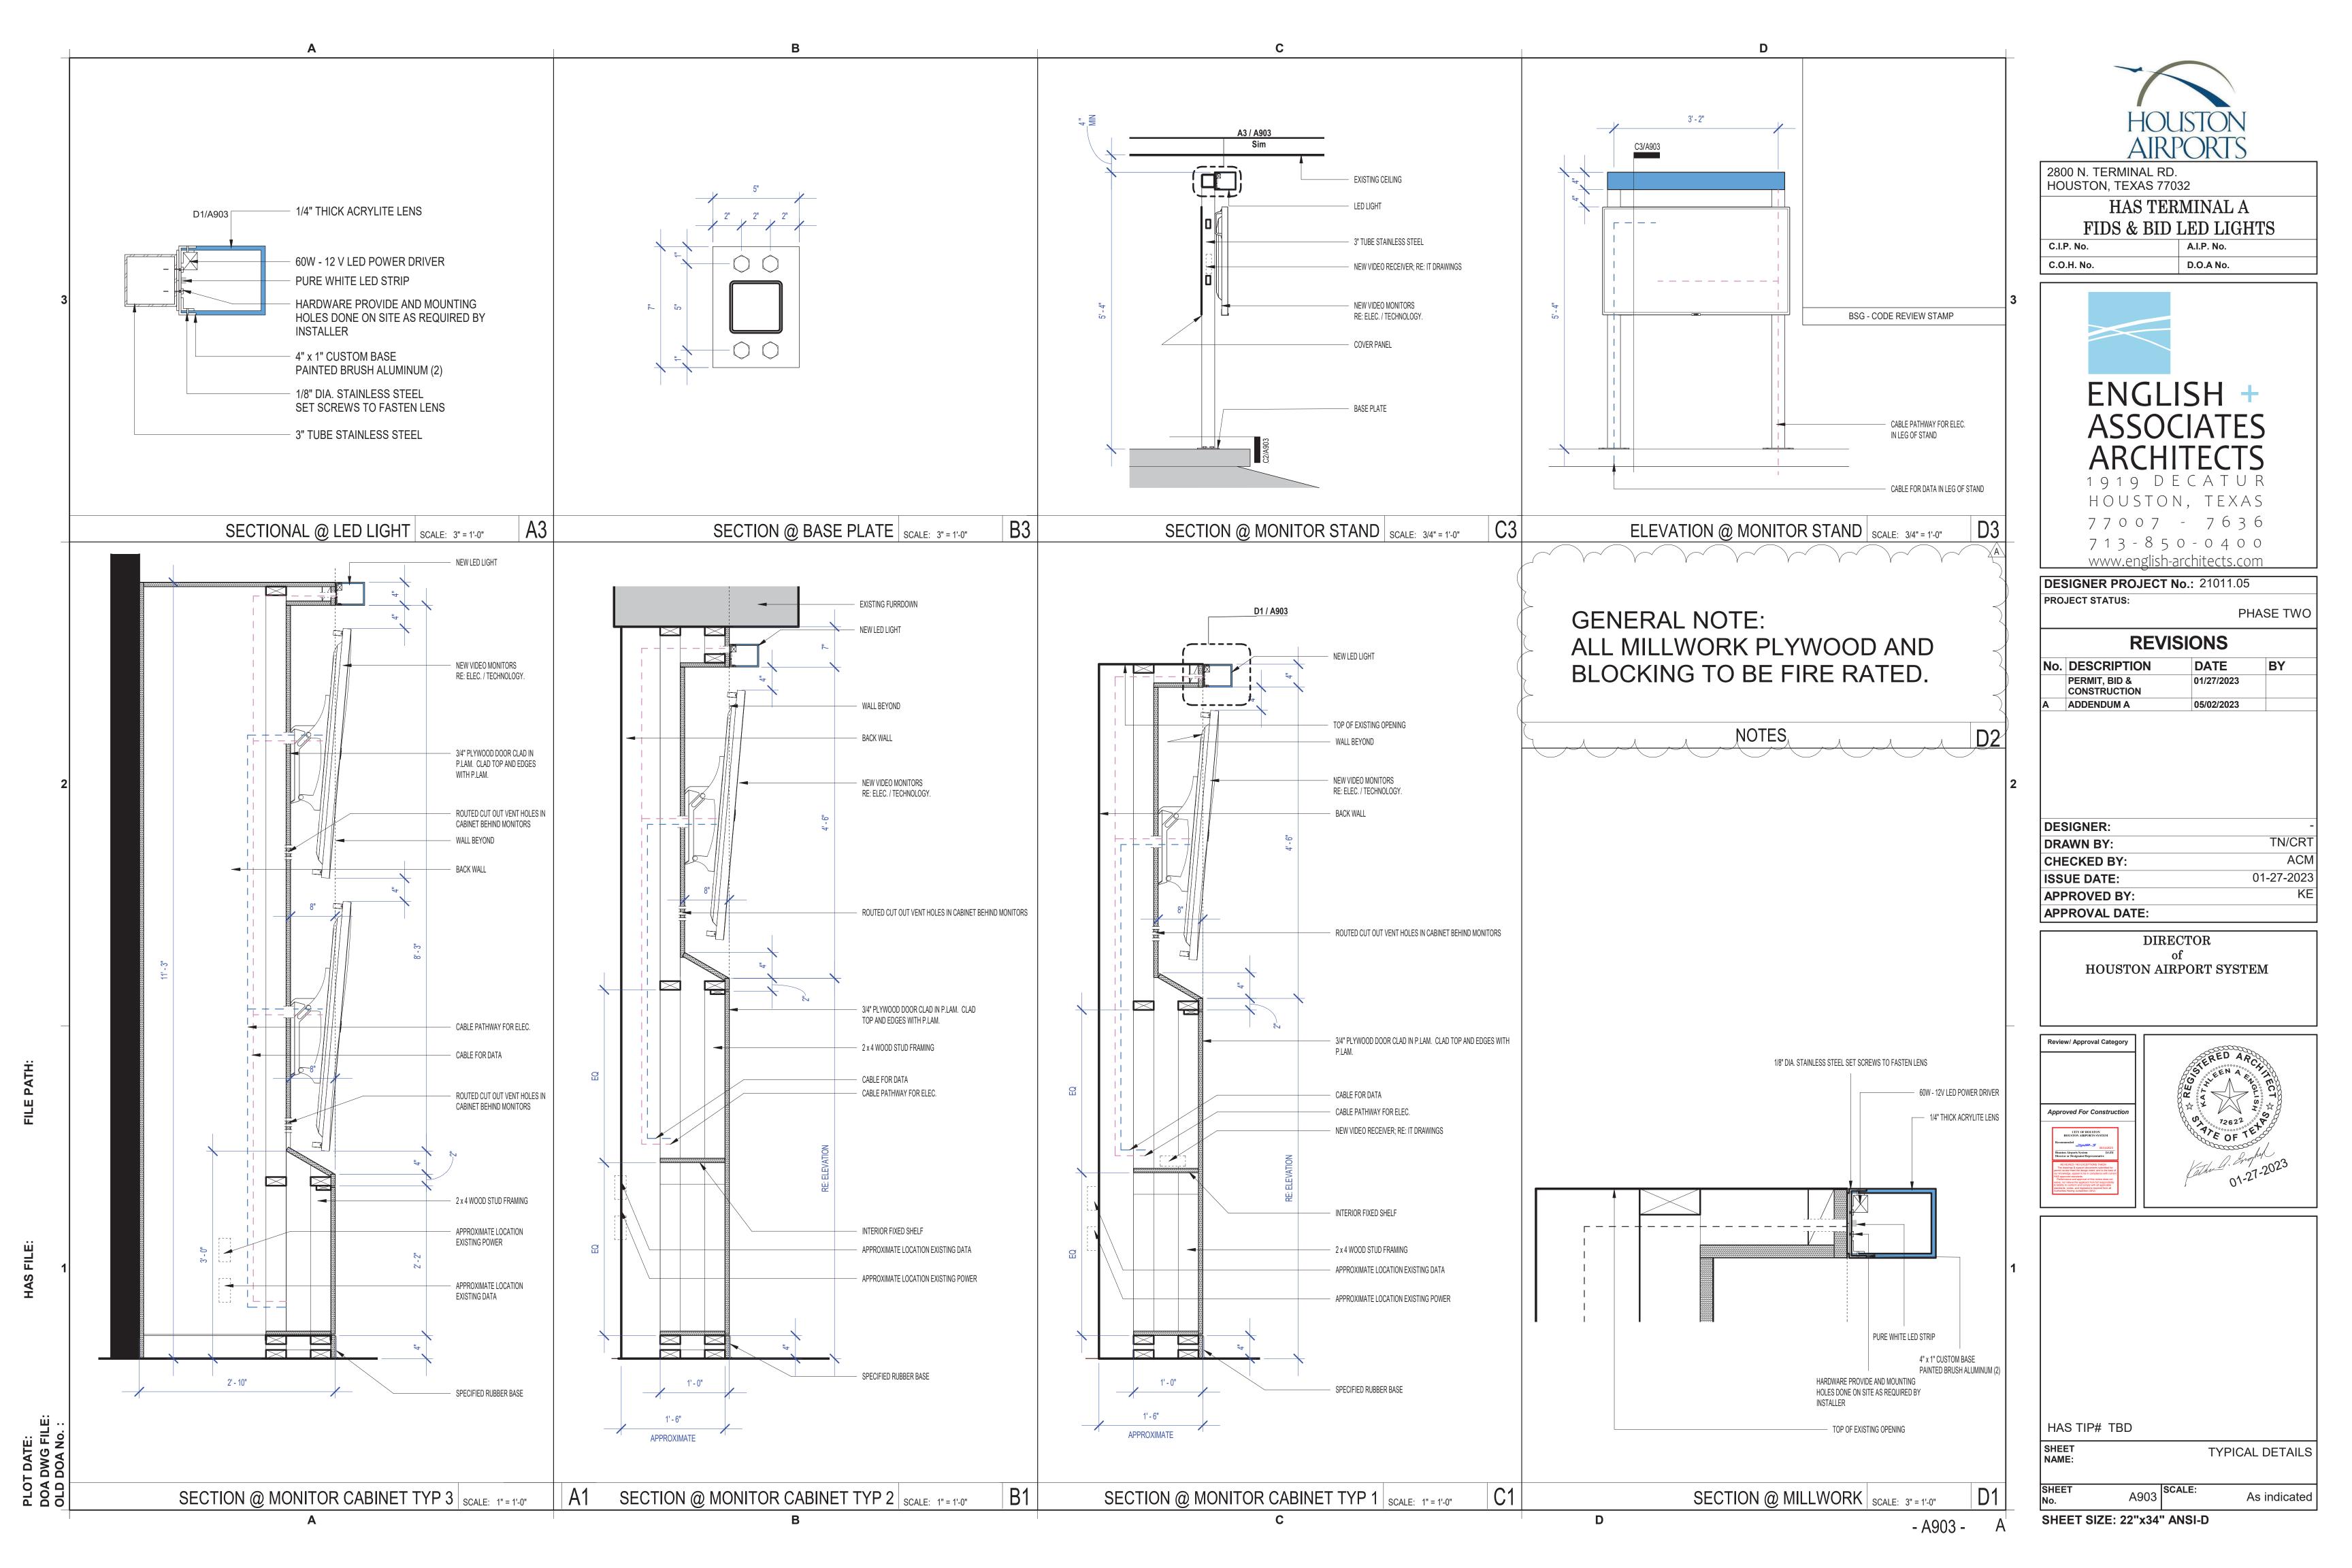
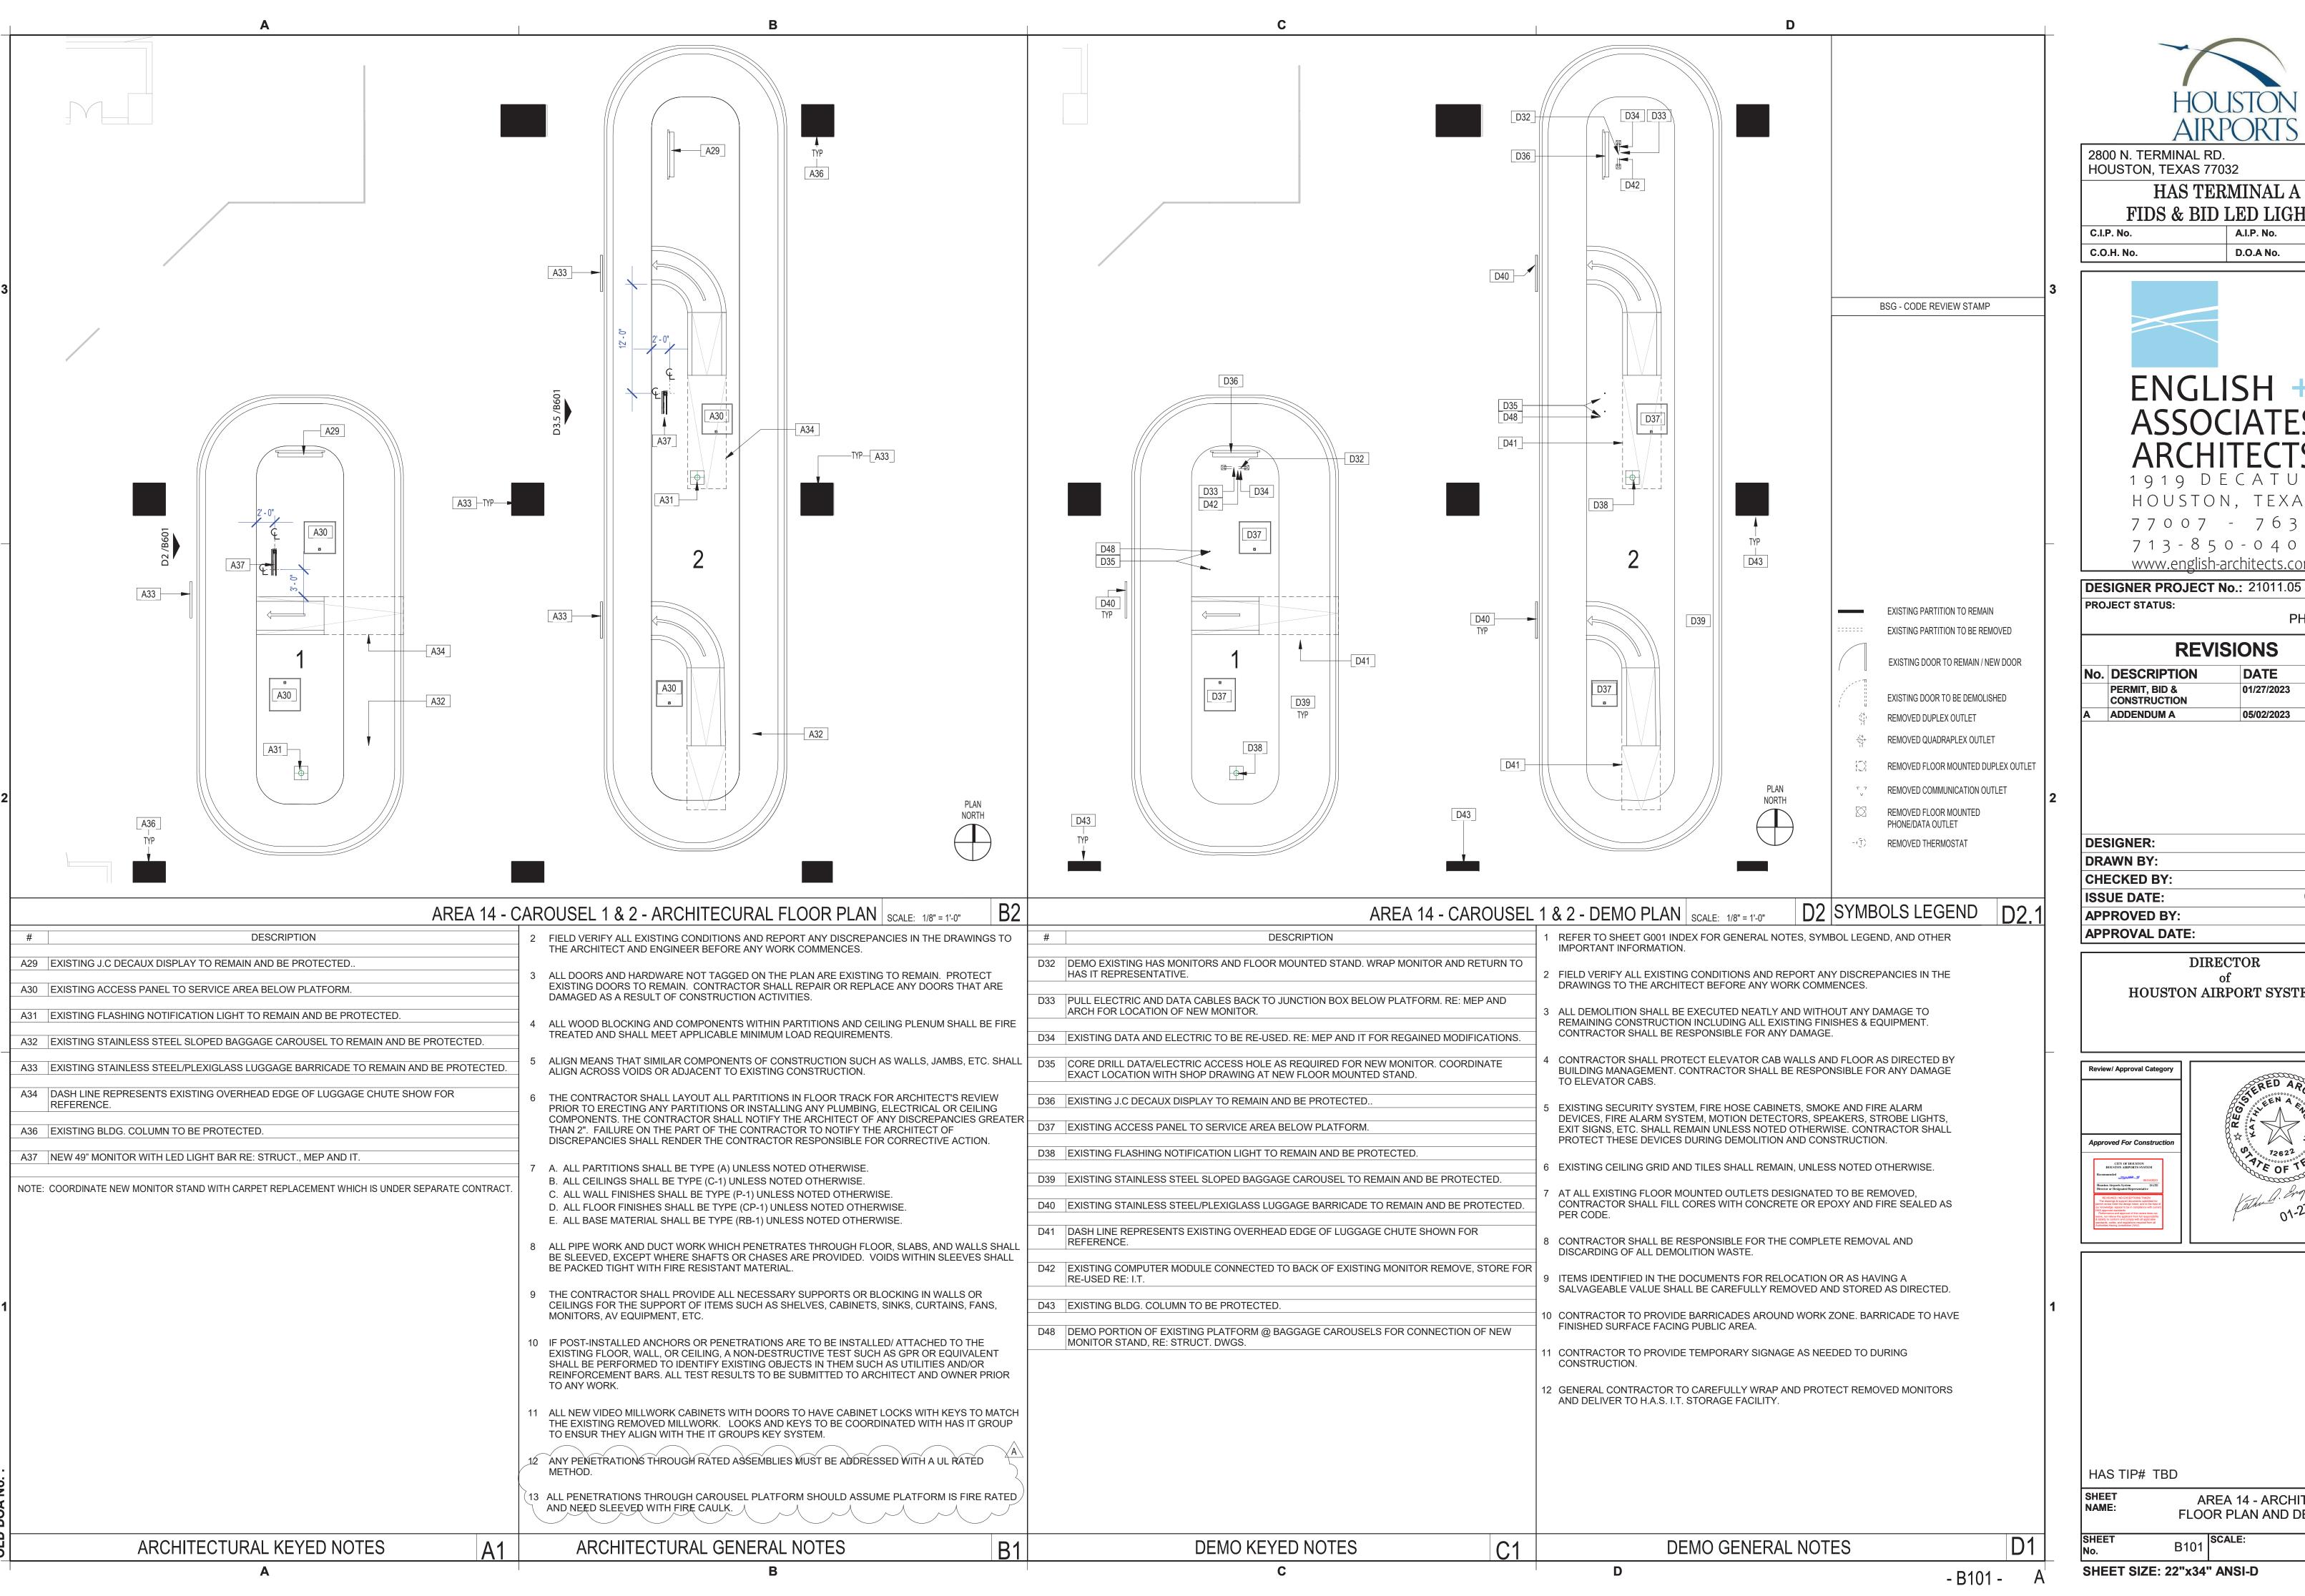
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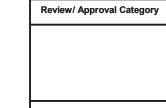
PROJECT STATUS:			ACE TWO
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	REVI	SIONS	
No.	DESCRIPTION	DATE	BY
	PERMIT, BID &	01/27/2023	

05/02/2023


CONSTRUCTION ADDENDUM A

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DRAWN BY:	TN/CRT
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ISSUE DATE:	01-27-2023
APPROVED BY:	KE
APPROVAL DATE:	

DIRECTOR HOUSTON AIRPORT SYSTEM






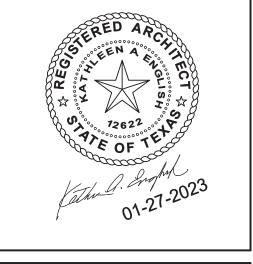

HAS TIP# TBD

AREA 14 - ARCHITECTURAL FLOOR PLAN AND DEMO PLAN B101 1/8" = 1'-0"

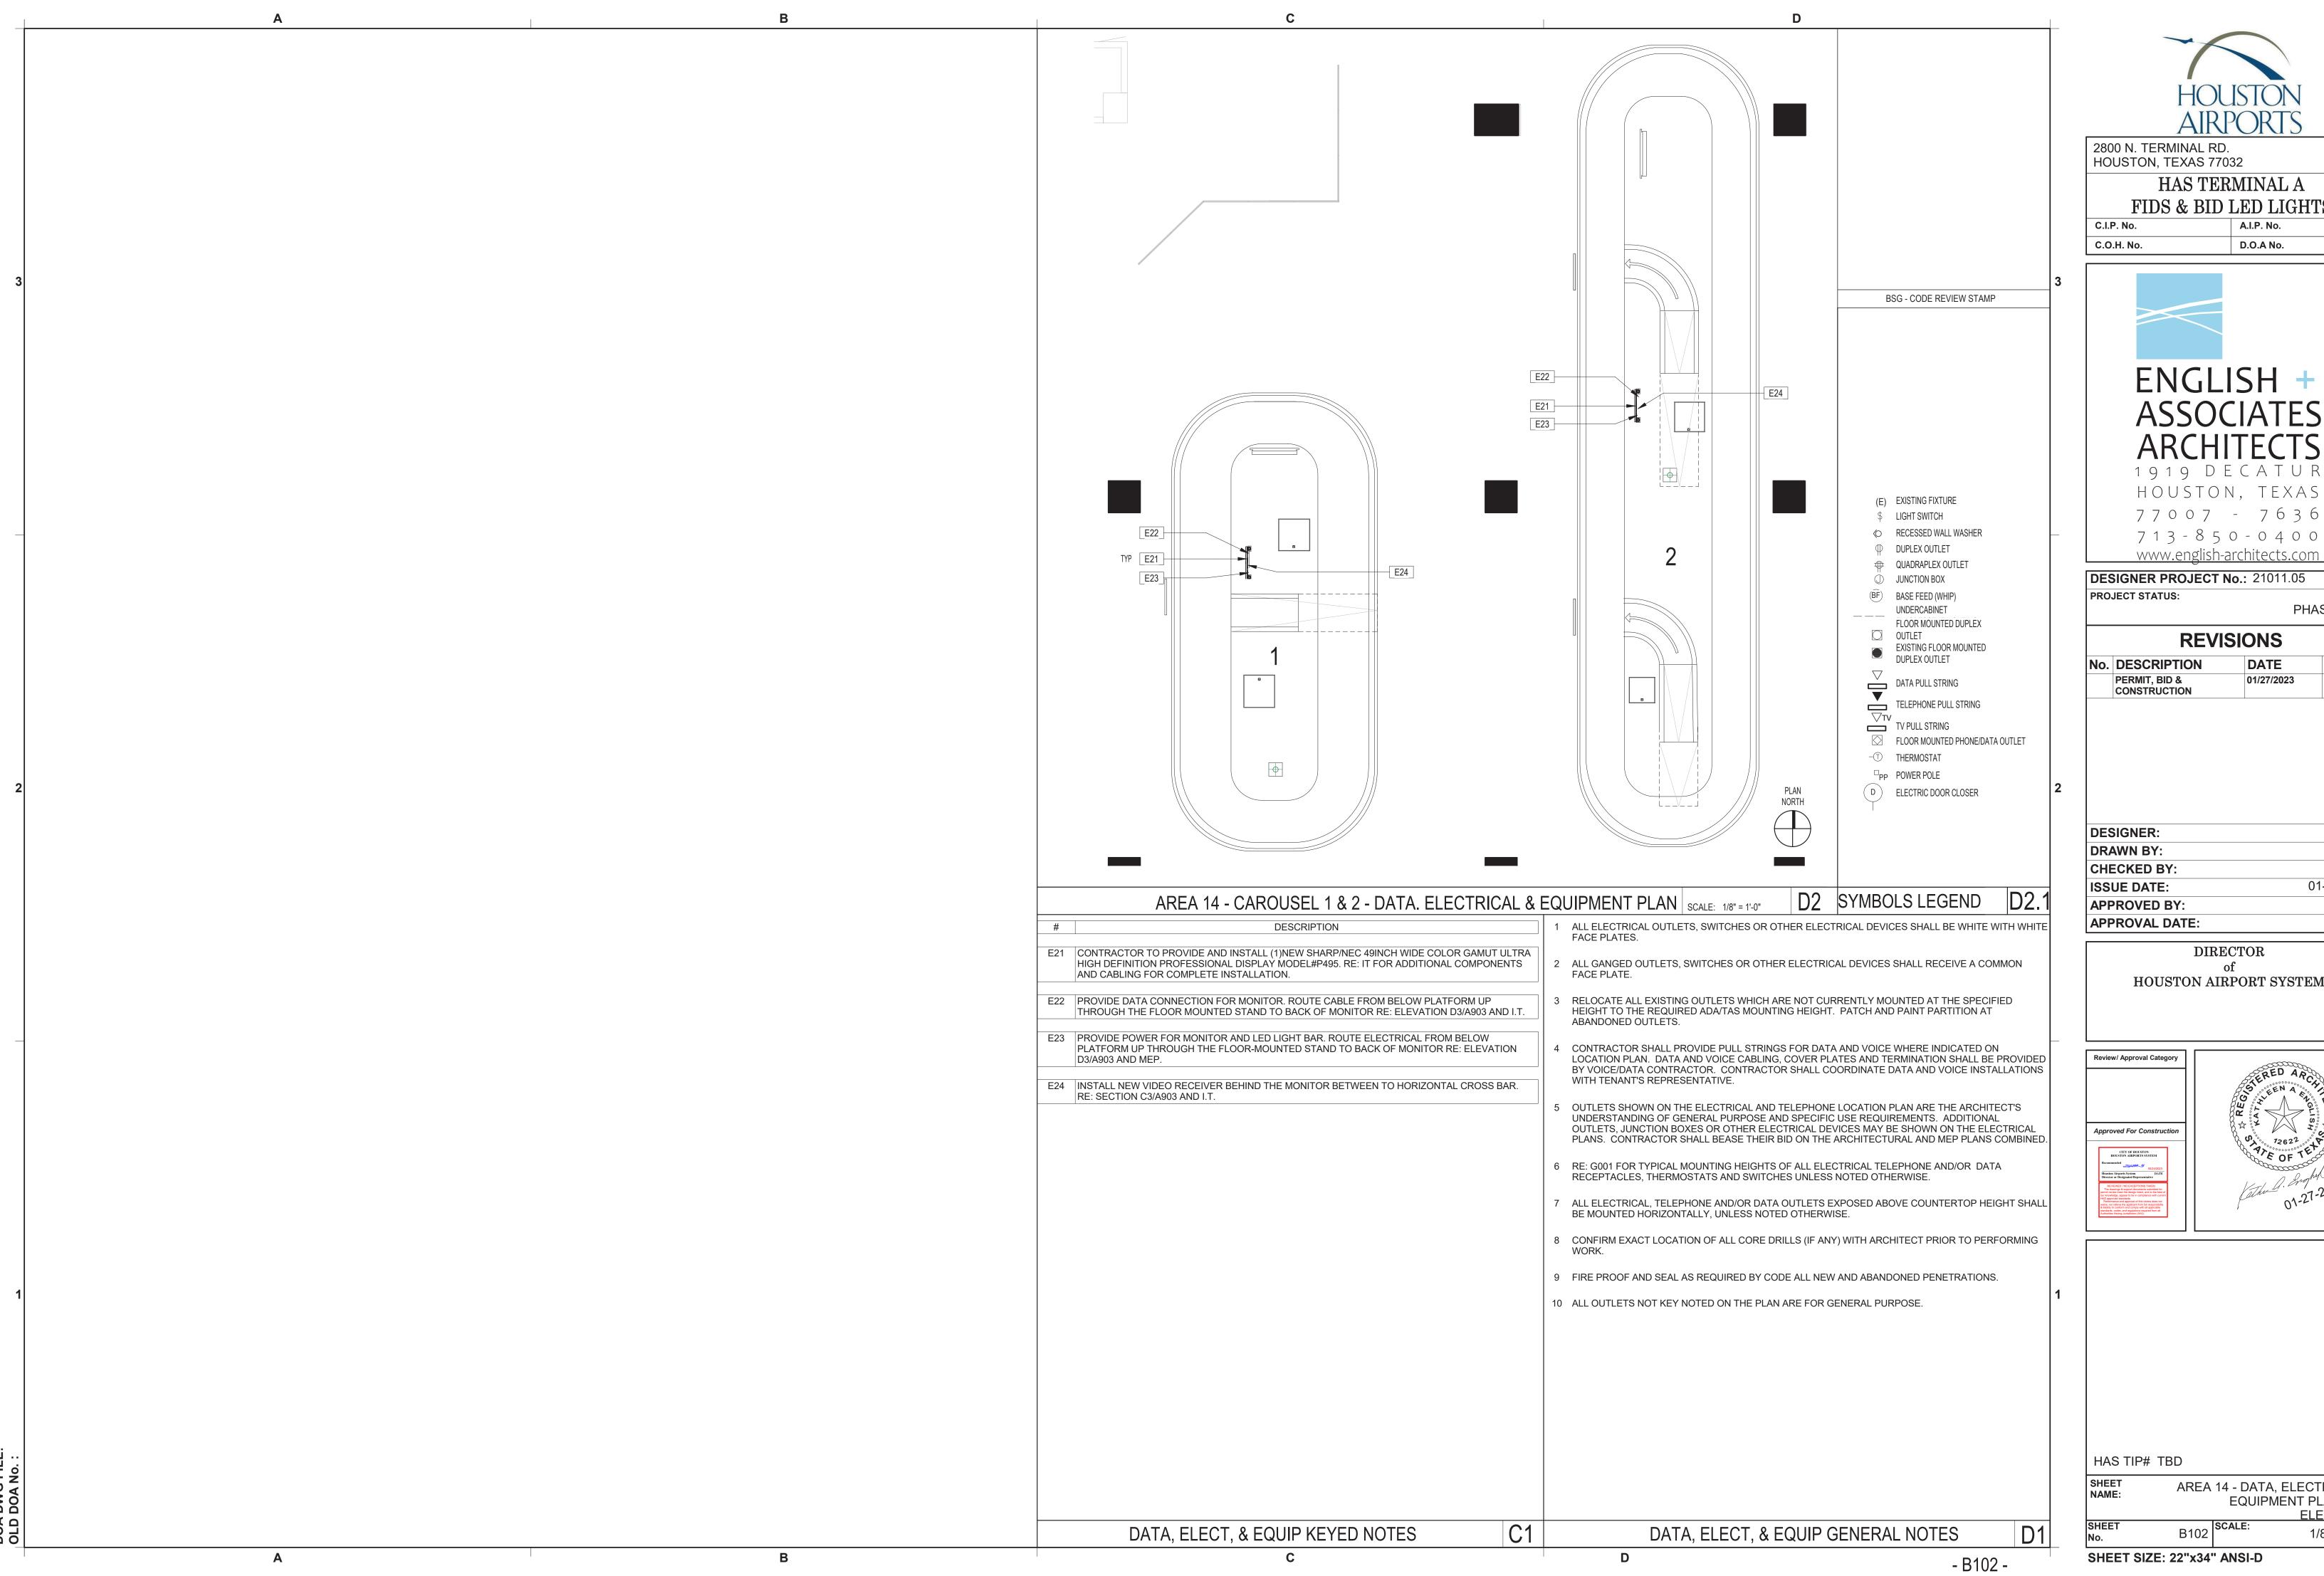



### HAS TERMINAL A FIDS & BID LED LIGHTS

A.I.P. No. D.O.A No.




**DESIGNER PROJECT No.:** 21011.05 PHASE TWO


### **REVISIONS DATE** BY 01/27/2023

DESIGNER:	-
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ISSUE DATE:	01-27-2023
APPROVED BY:	KE
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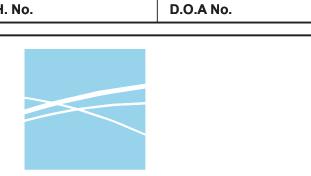


AREA 14 - DATA, ELECTRICAL & EQUIPMENT PLAN AND ELEVATION B102 SCALE: 1/8" = 1'-0"

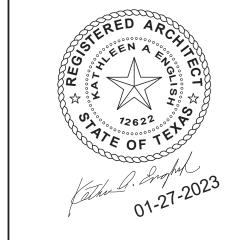

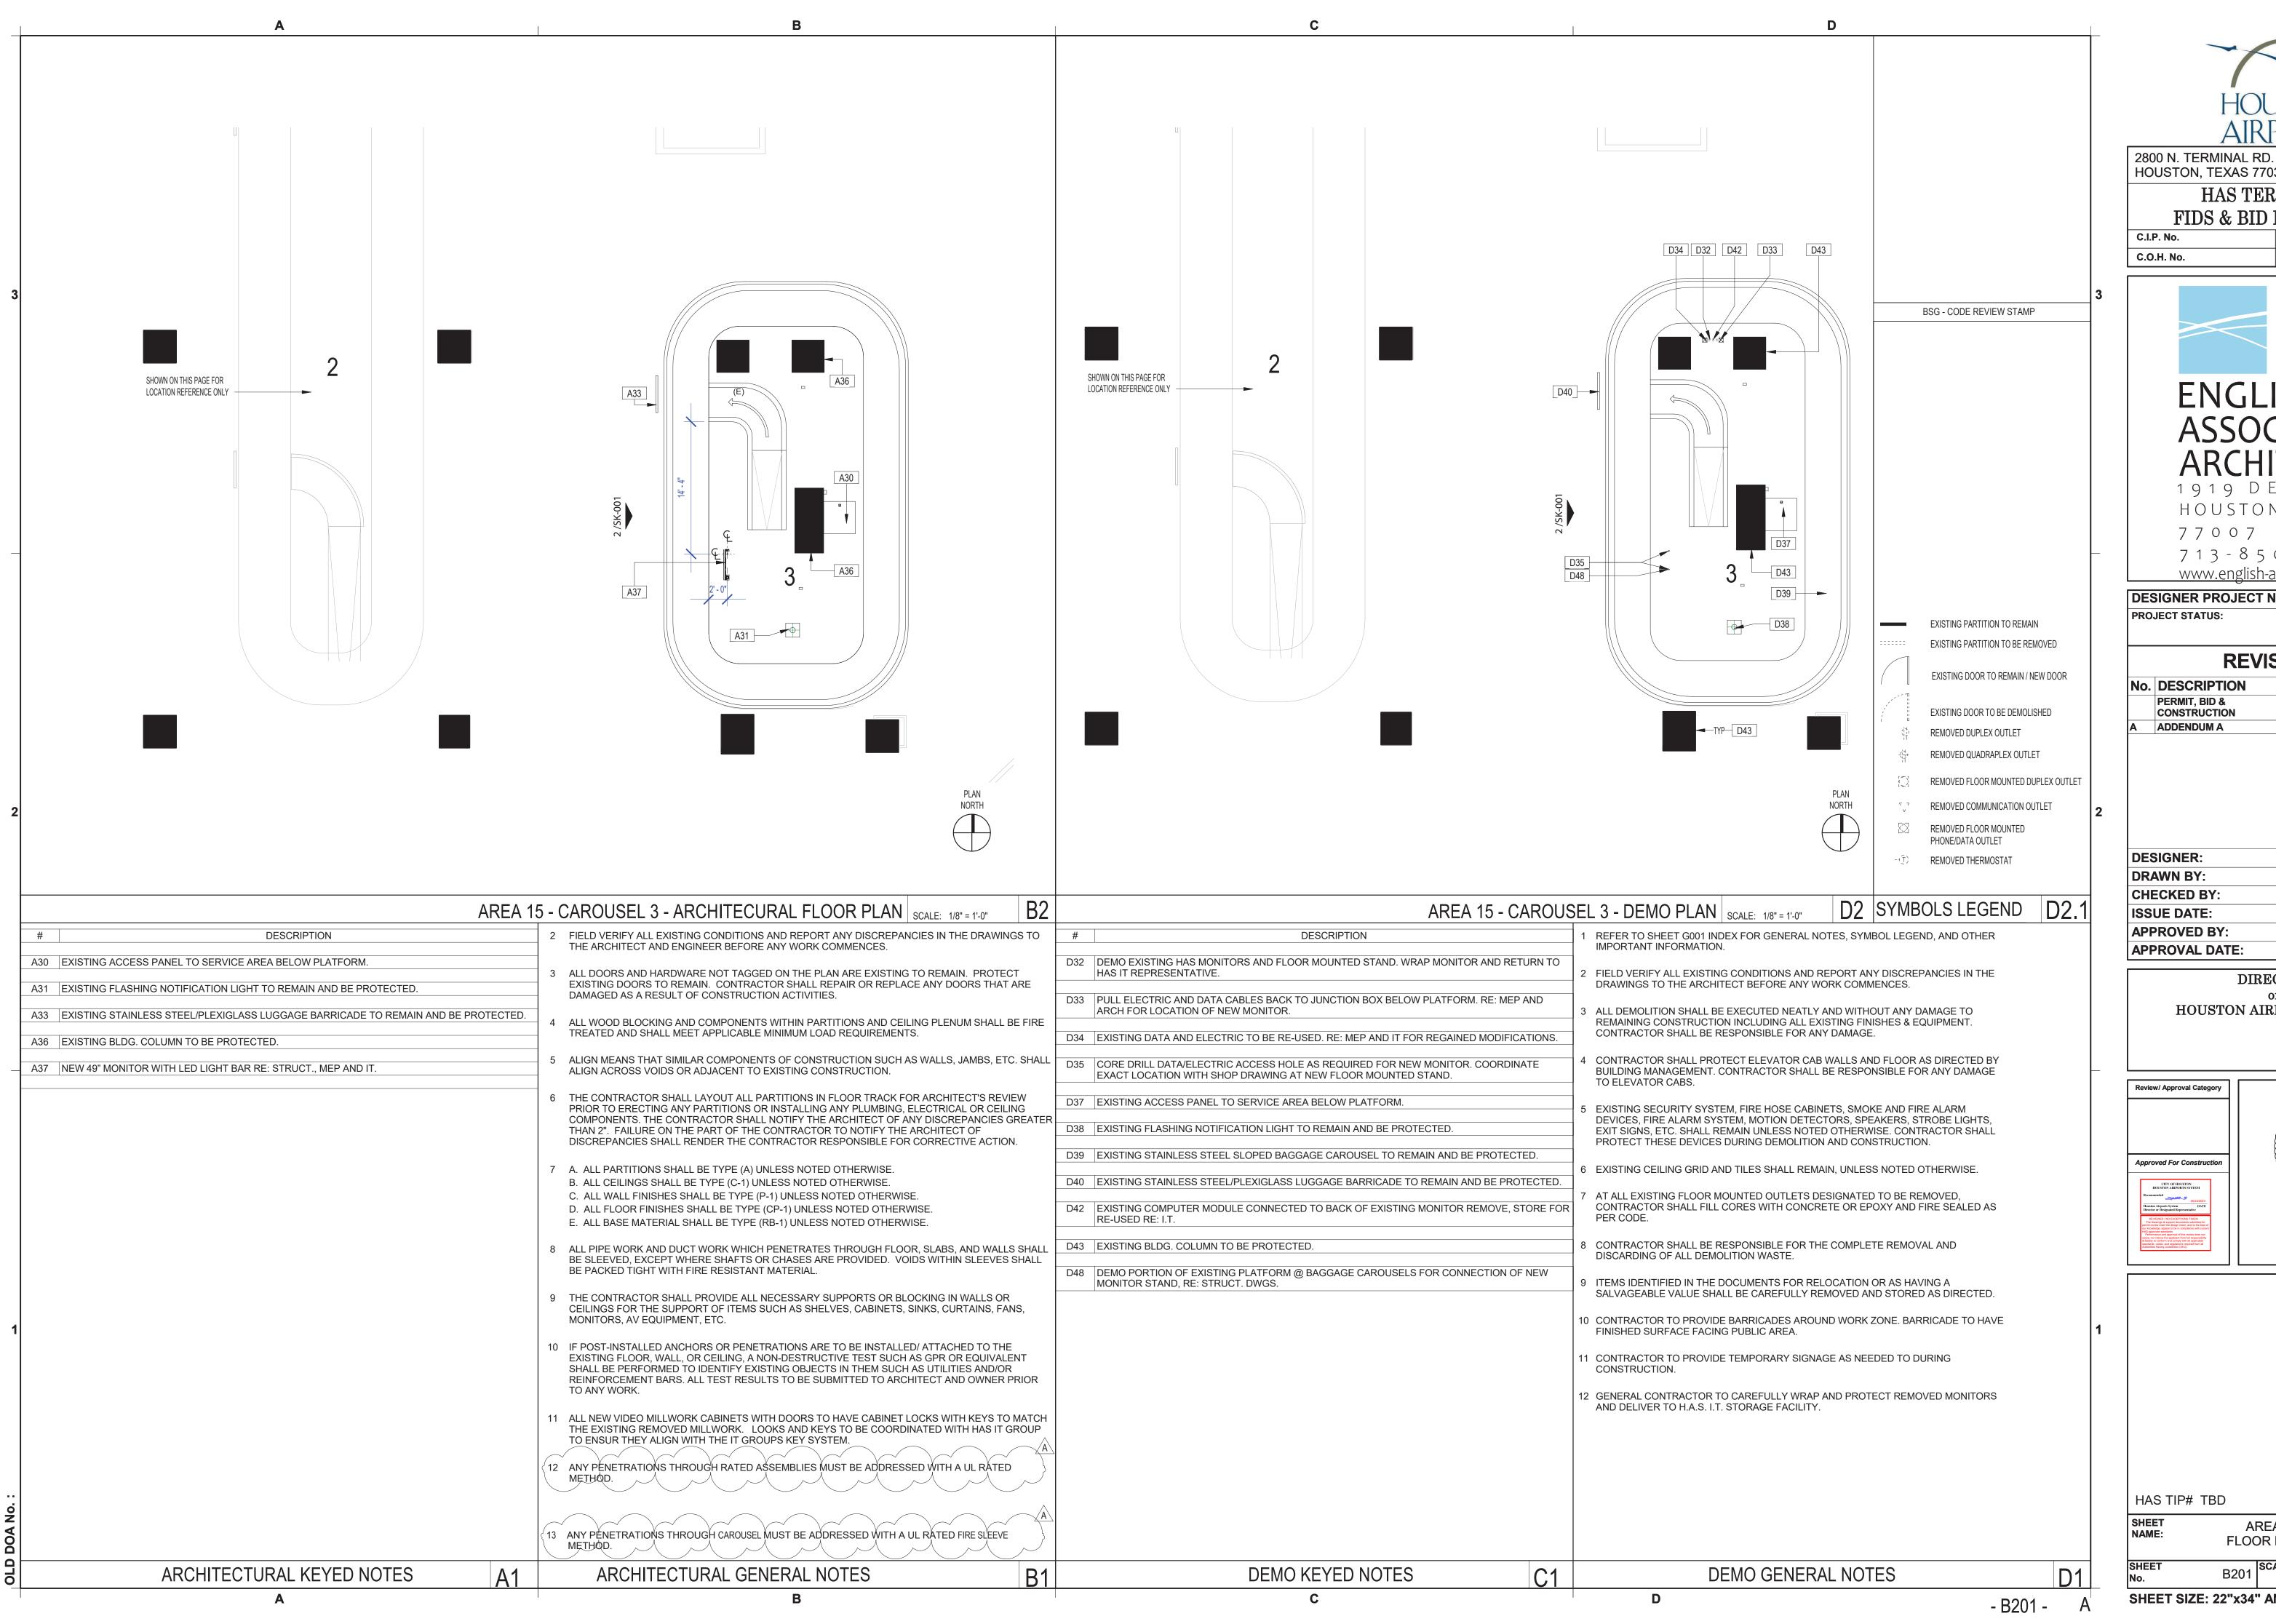

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A.I.P. No.

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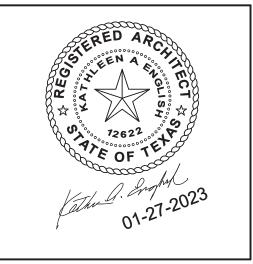
**DESIGNER PROJECT No.:** 21011.05 PROJECT STATUS: PHASE TWO **REVISIONS** 

	PERMIT, BID &	01/27/2023	
	CONSTRUCTION		
Α	ADDENDUM A	05/02/2023	

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ISSUE DATE:	01-27-2023
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APPROVAL DATE:	


### DIRECTOR HOUSTON AIRPORT SYSTEM





HAS TIP# TBD

AREA 15 - ARCHITECTURAL FLOOR PLAN AND DEMO PLAN B201 1/8" = 1'-0"

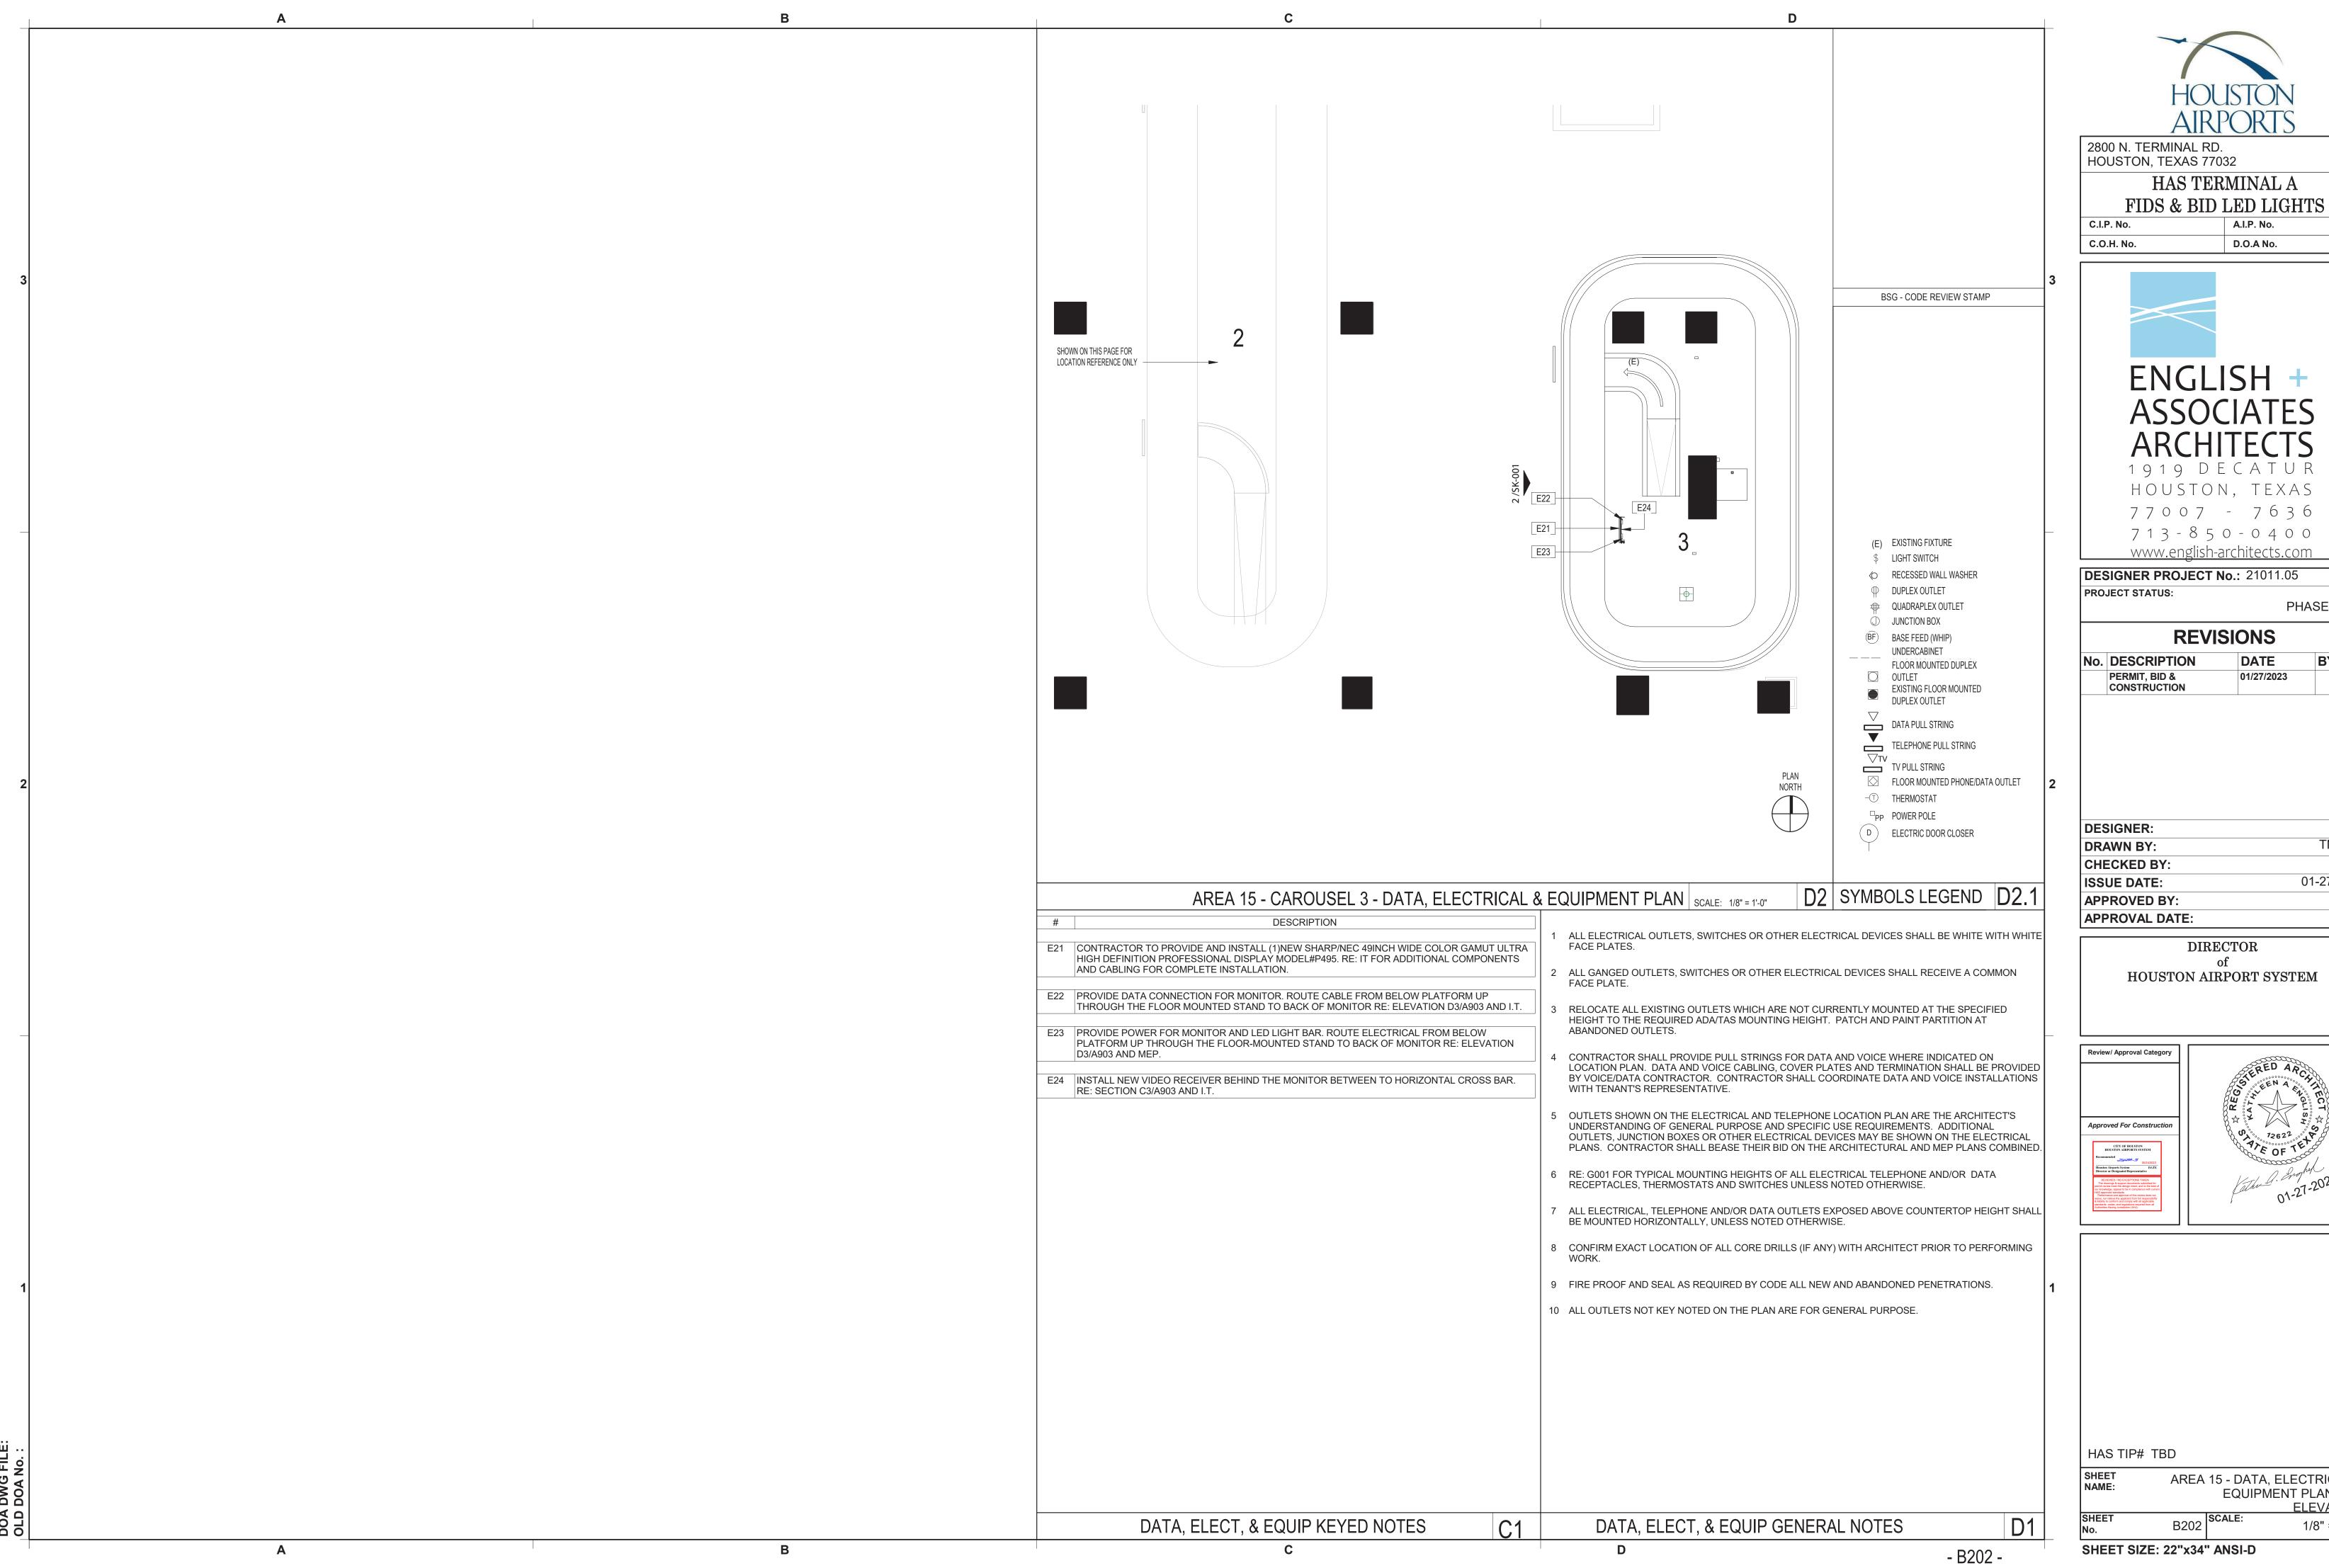




PHASE TWO

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AREA 15 - DATA, ELECTRICAL & EQUIPMENT PLAN AND ELEVATION 1/8" = 1'-0"





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C.O.H. No.

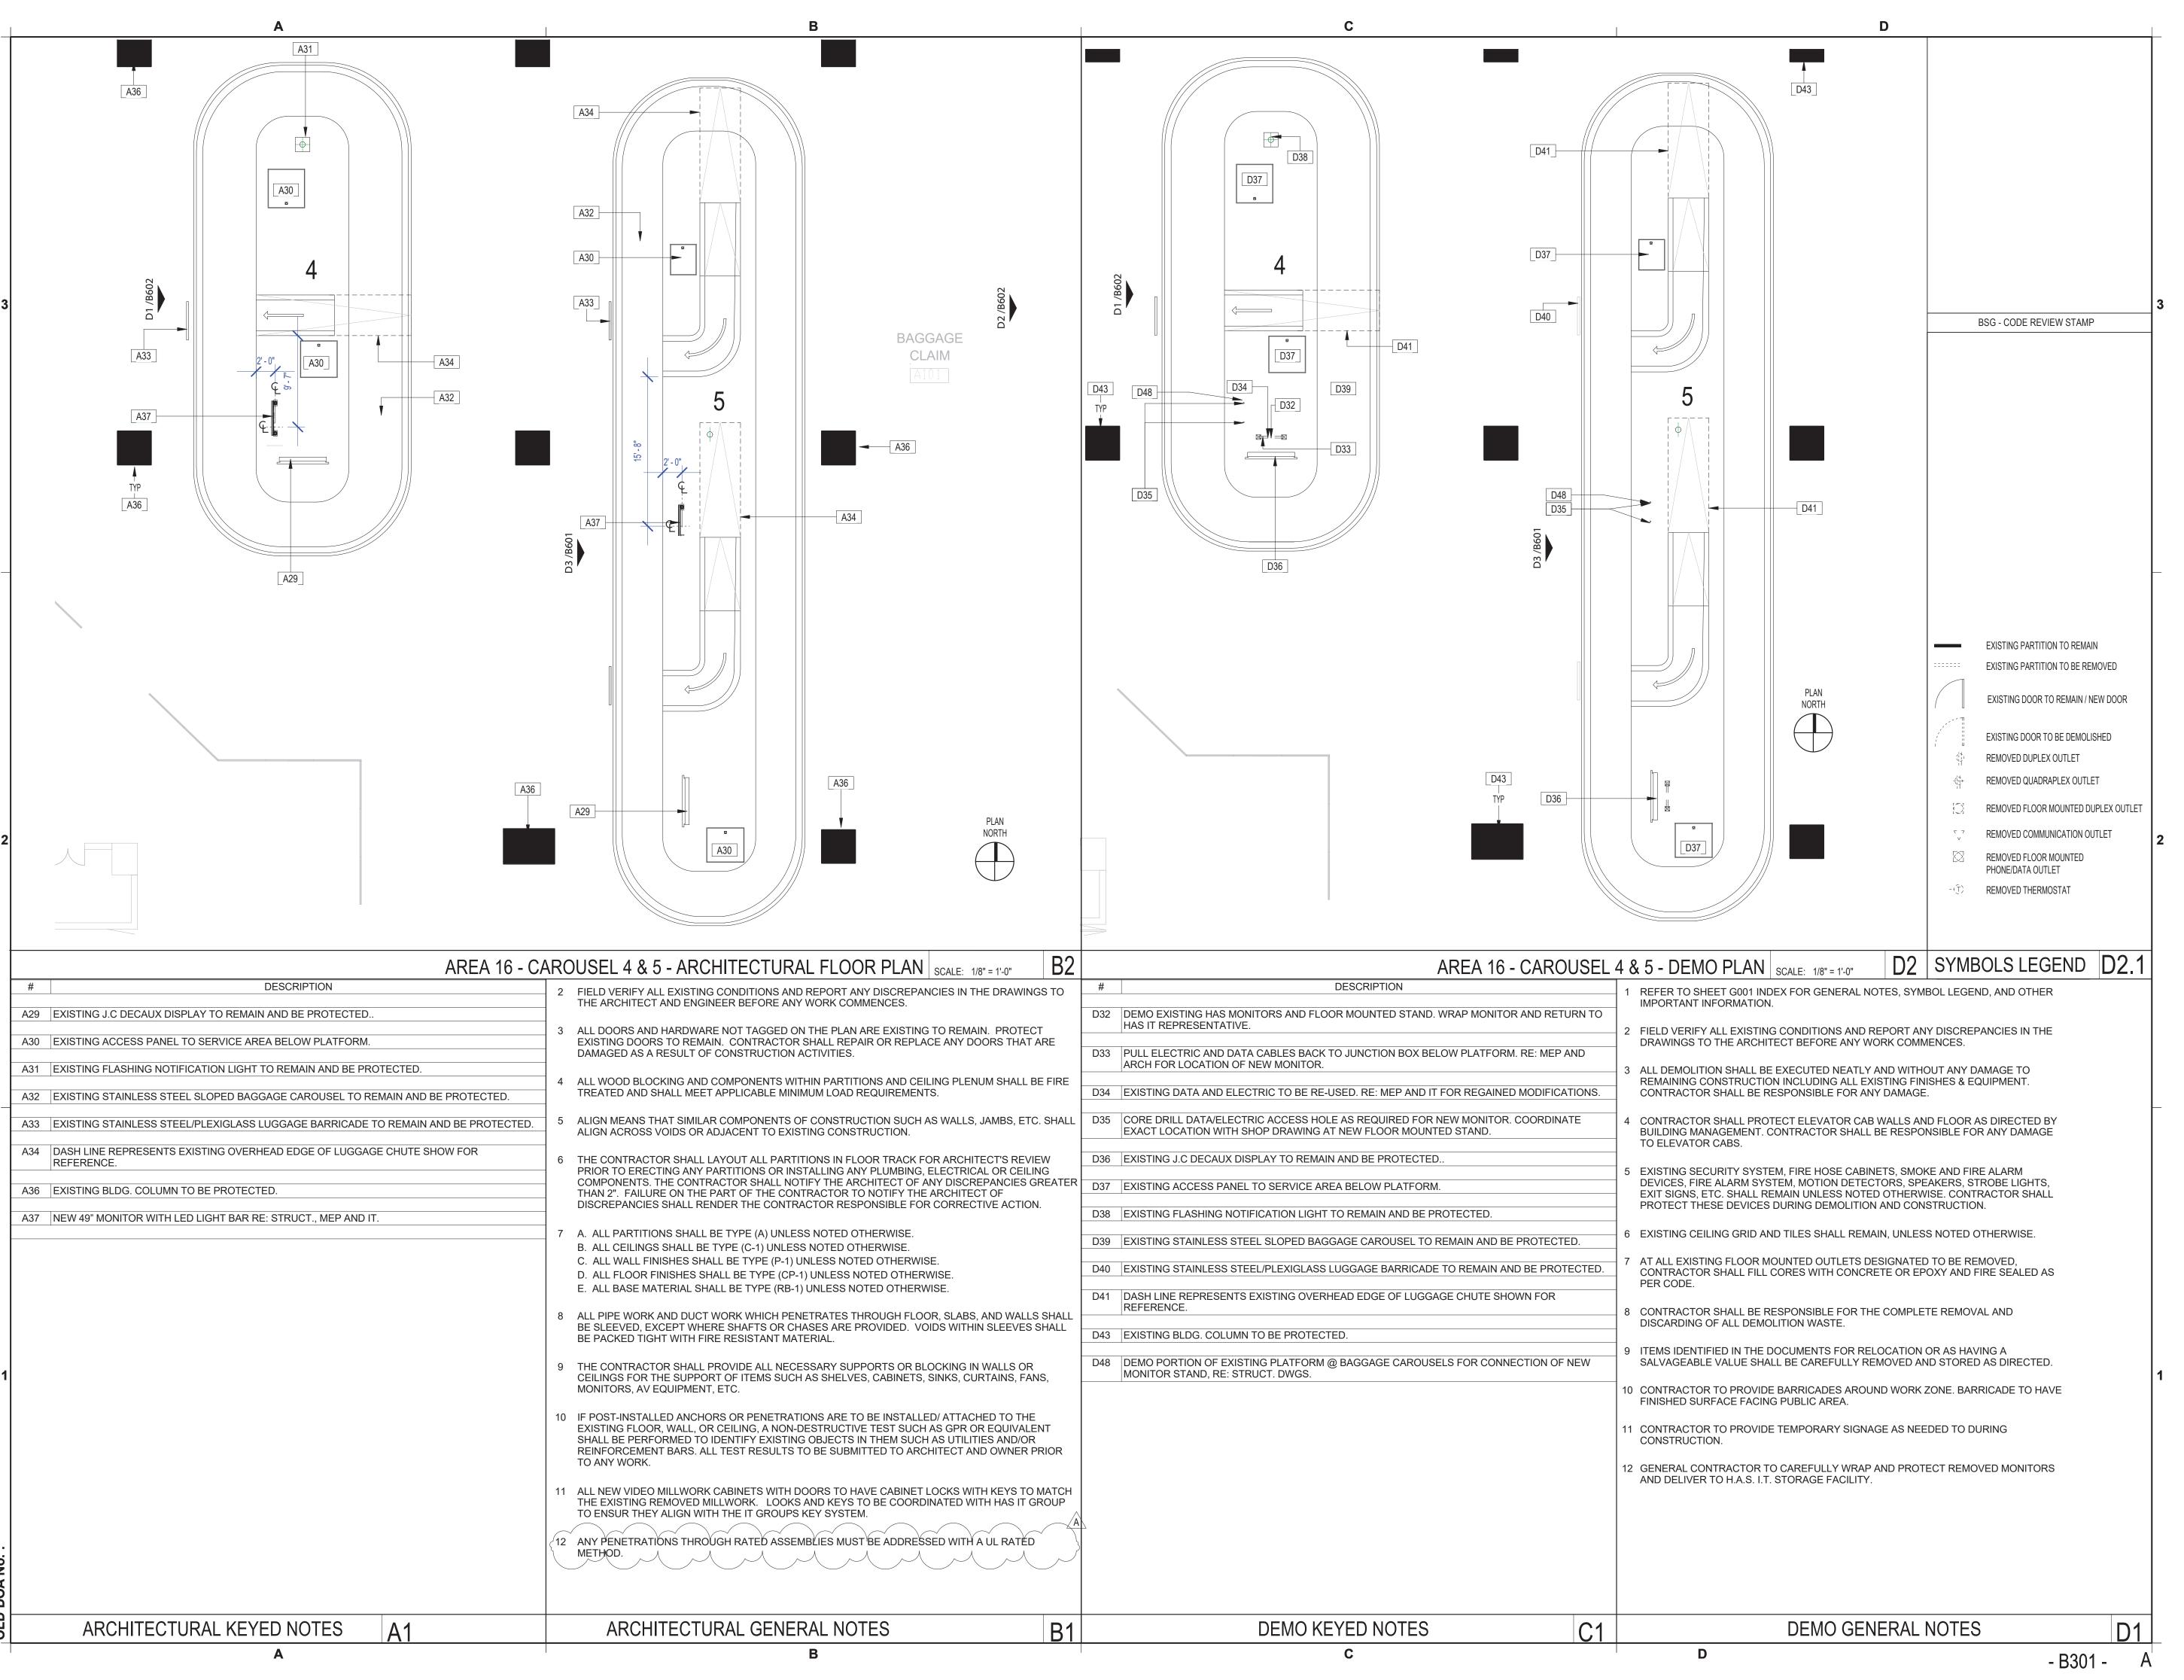

A.I.P. No.

D.O.A No.

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PHASE TWO

REVISIONS

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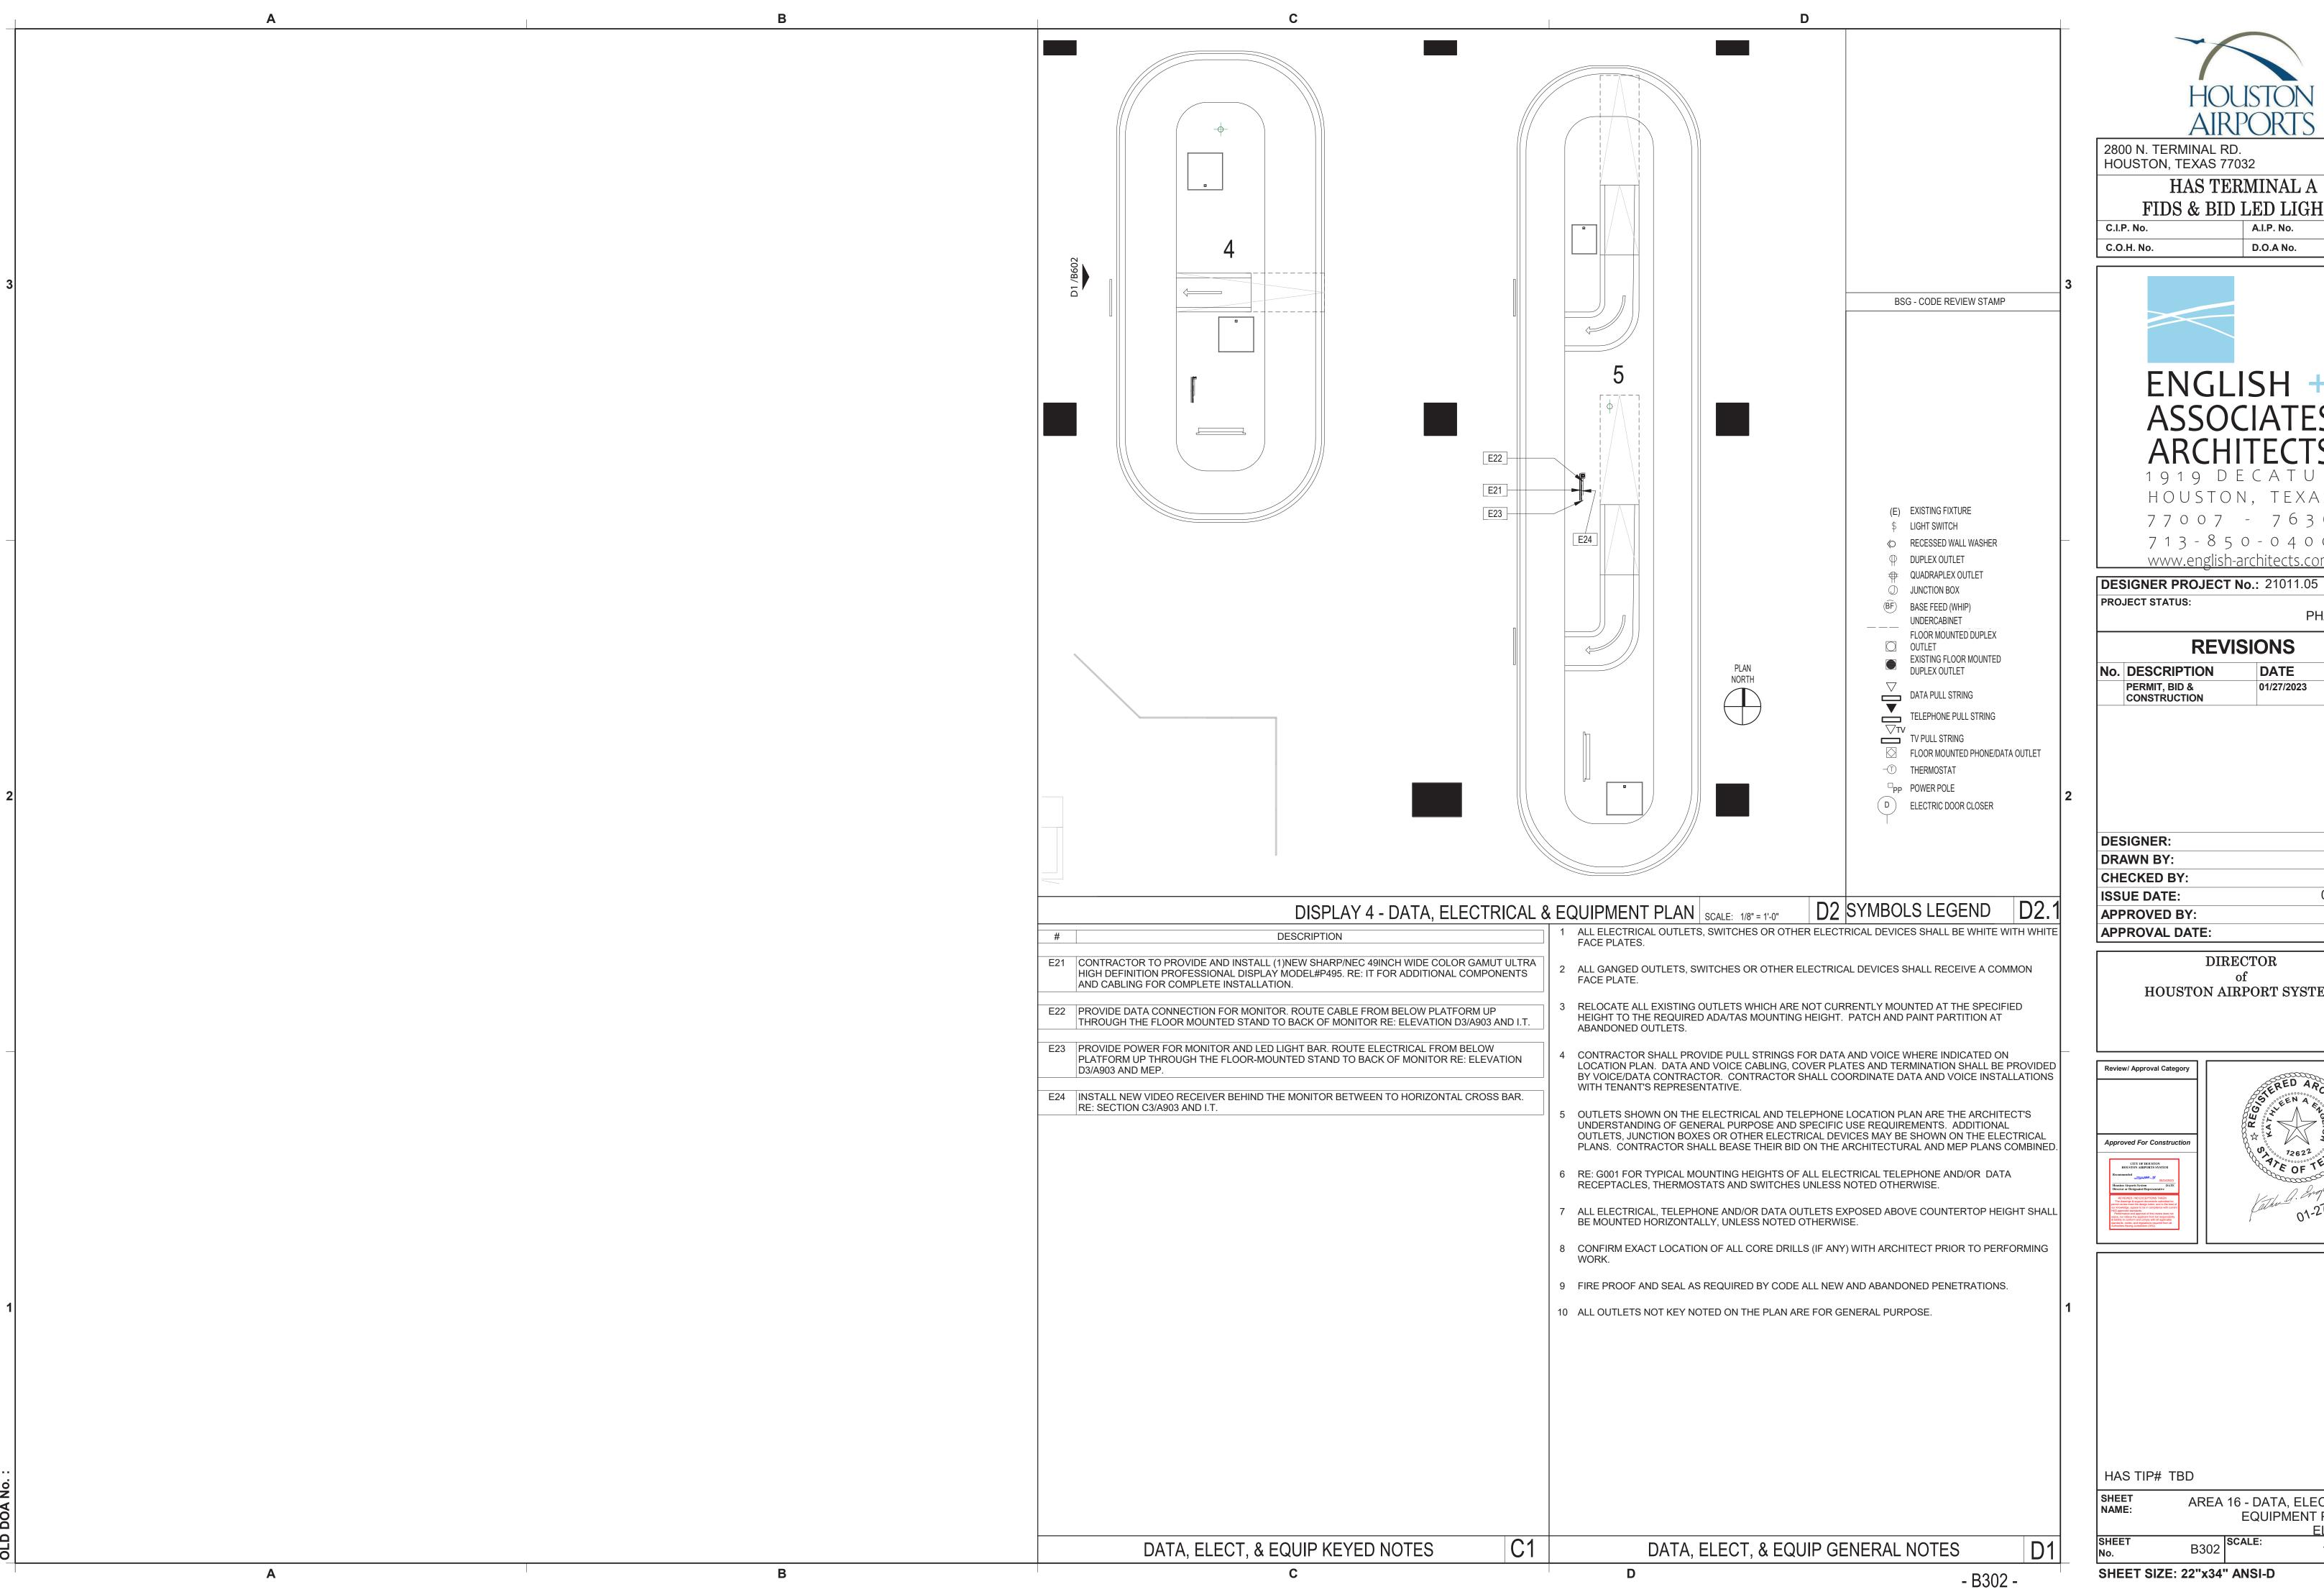
Houston Airports System Director or Designated Representati



HAS TIP# TBD

SHEET AREA 16 - ARCHITECTURAL FLOOR PLAN AND DEMO PLAN

SHEET B301 SCALE: 1/8" = 1'-0"





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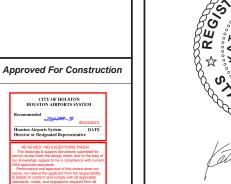
### PROJECT STATUS: PHASE TWO

REVISIONS			
No.	DESCRIPTION	DATE	BY
	PERMIT, BID & CONSTRUCTION	01/27/2023	

DESIGNER:	-
DRAWN BY:	TN/CRT
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ISSUE DATE:	01-27-2023
APPROVED BY:	KE
APPROVAL DATE:	

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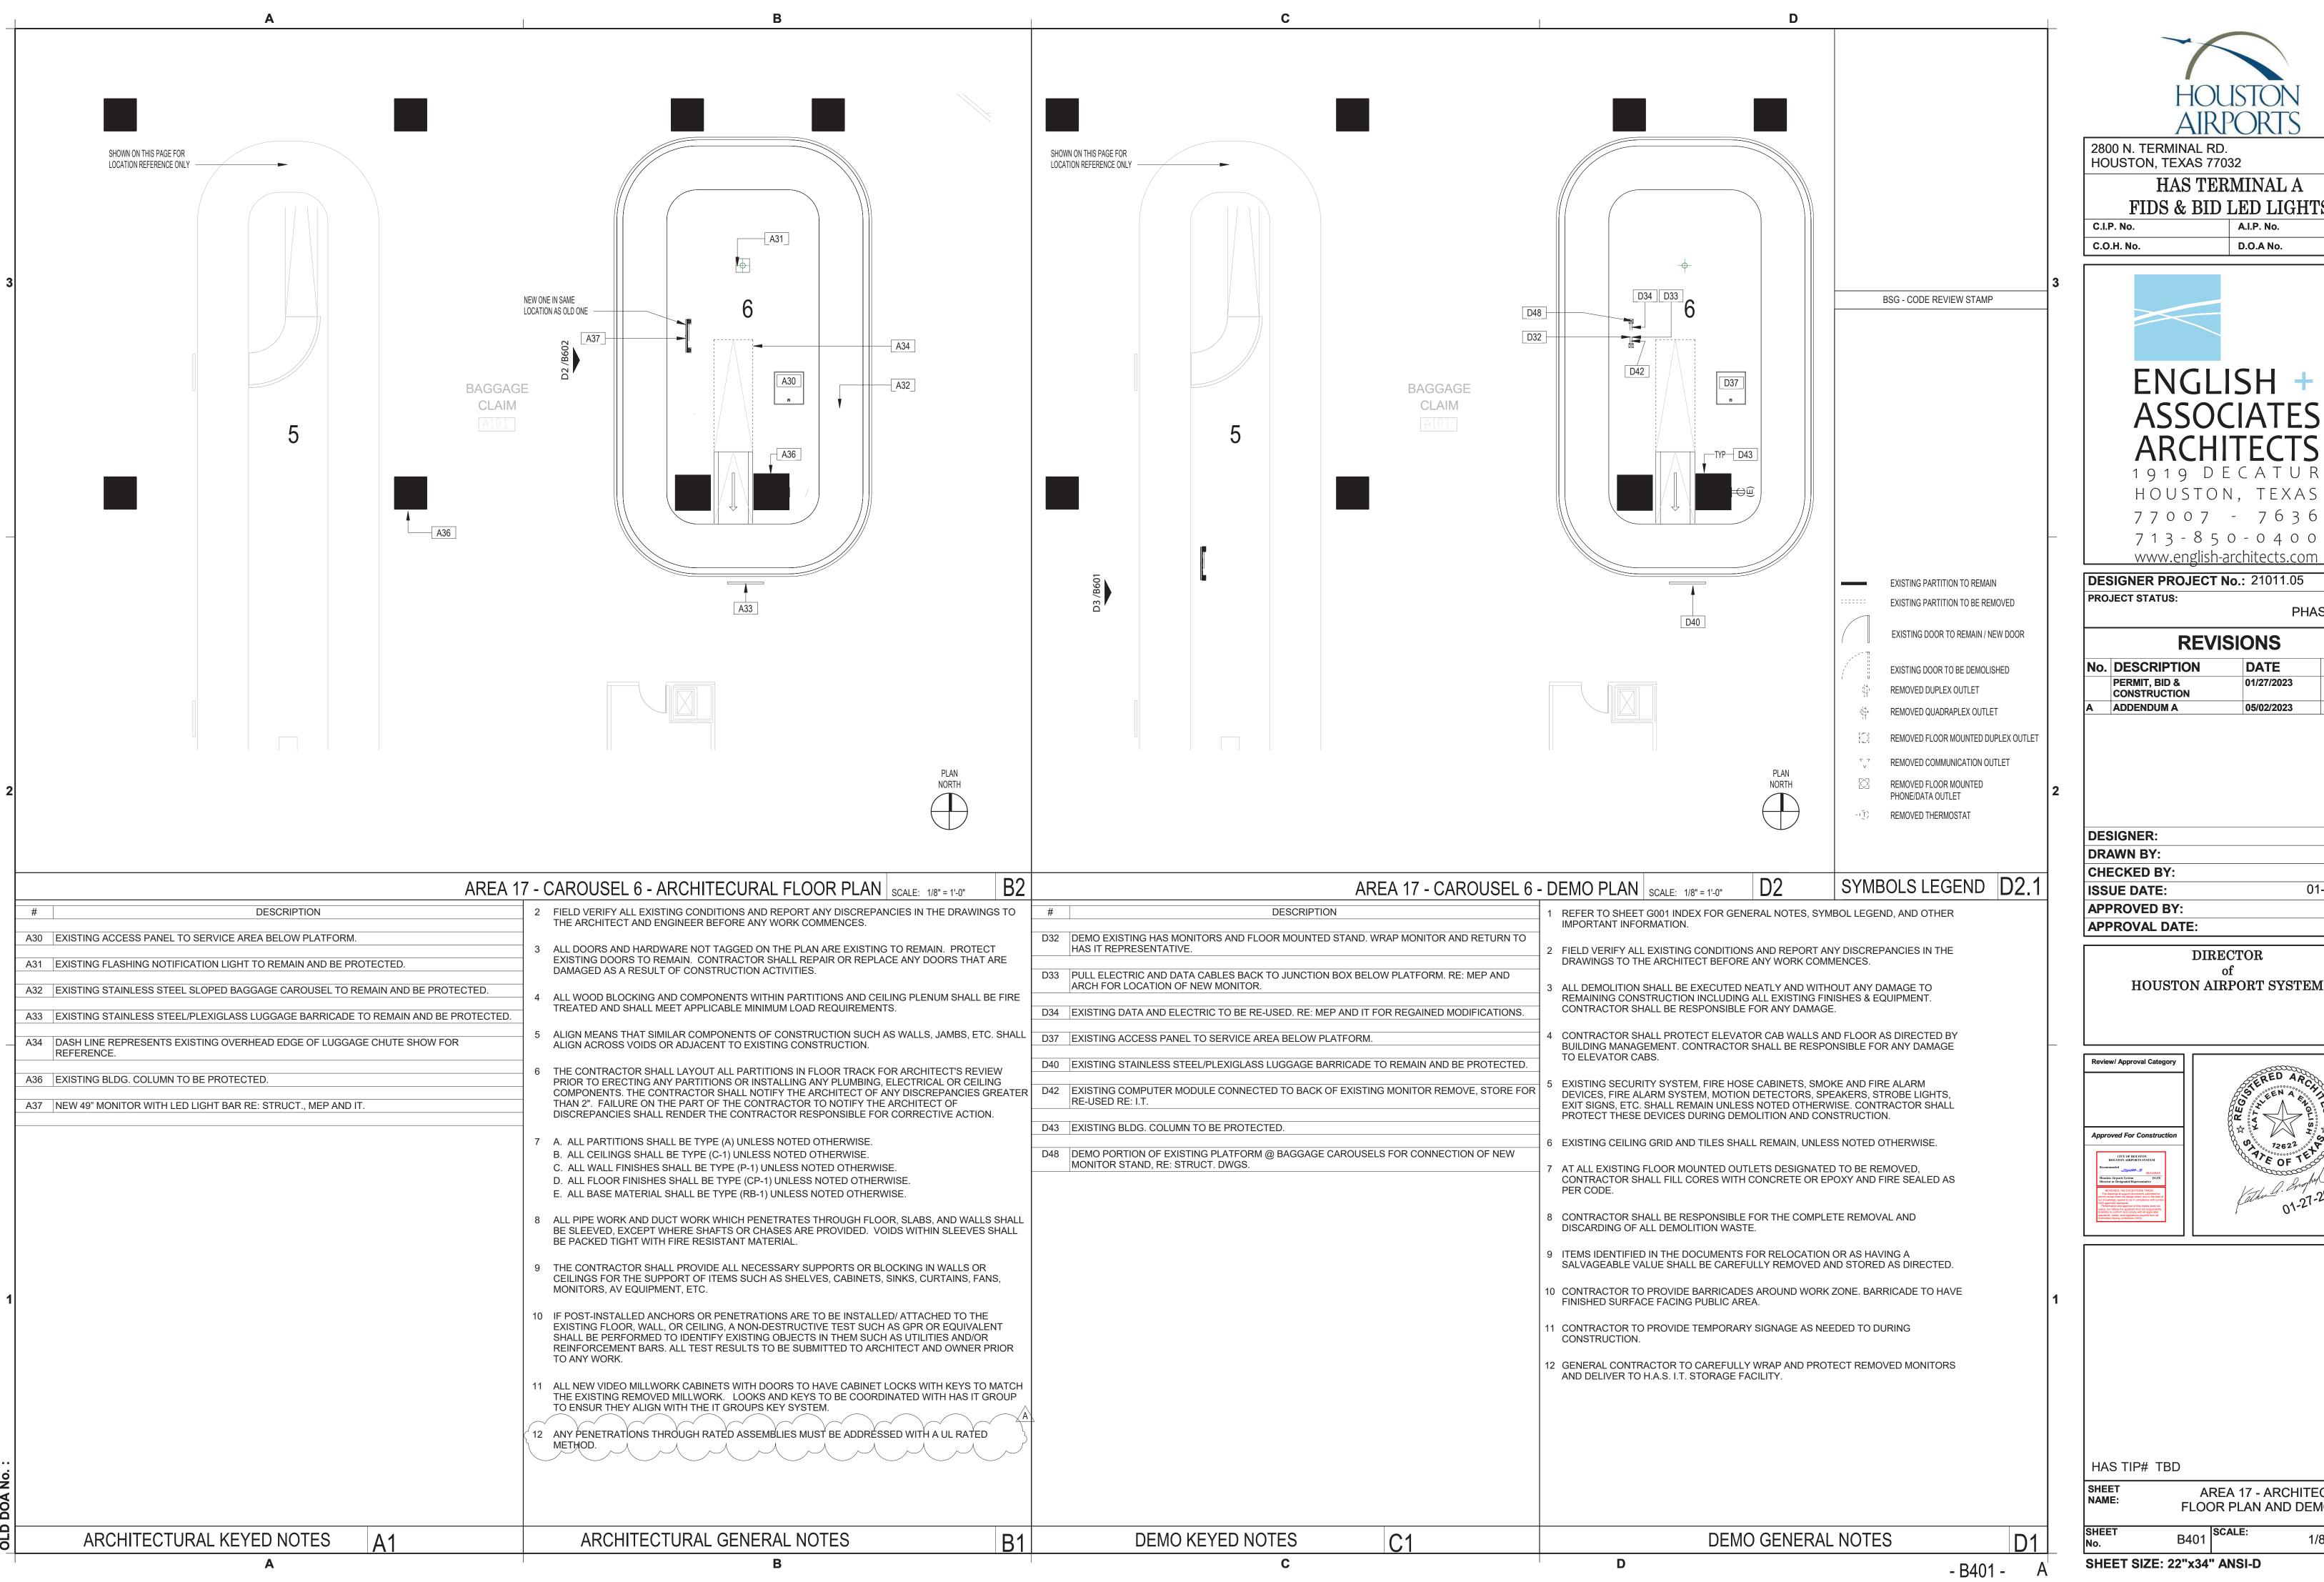
Review/ Approval Category





HAS TIP# TBD

AREA 16 - DATA, ELECTRICAL & EQUIPMENT PLAN AND ELEVATION B302 SCALE: 1/8" = 1'-0"





HOUSTON, TEXAS 77032 HAS TERMINAL A FIDS & BID LED LIGHTS



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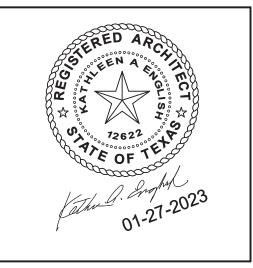
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REVISIONS				
No.	DESCRIPTION	DATE	BY	
	PERMIT, BID & CONSTRUCTION	01/27/2023		
Α	ADDENDUM A	05/02/2023		


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01-27-2023
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AREA 17 - ARCHITECTURAL FLOOR PLAN AND DEMO PLAN SCALE: 1/8" = 1'-0"






PHASE TWO


# BY

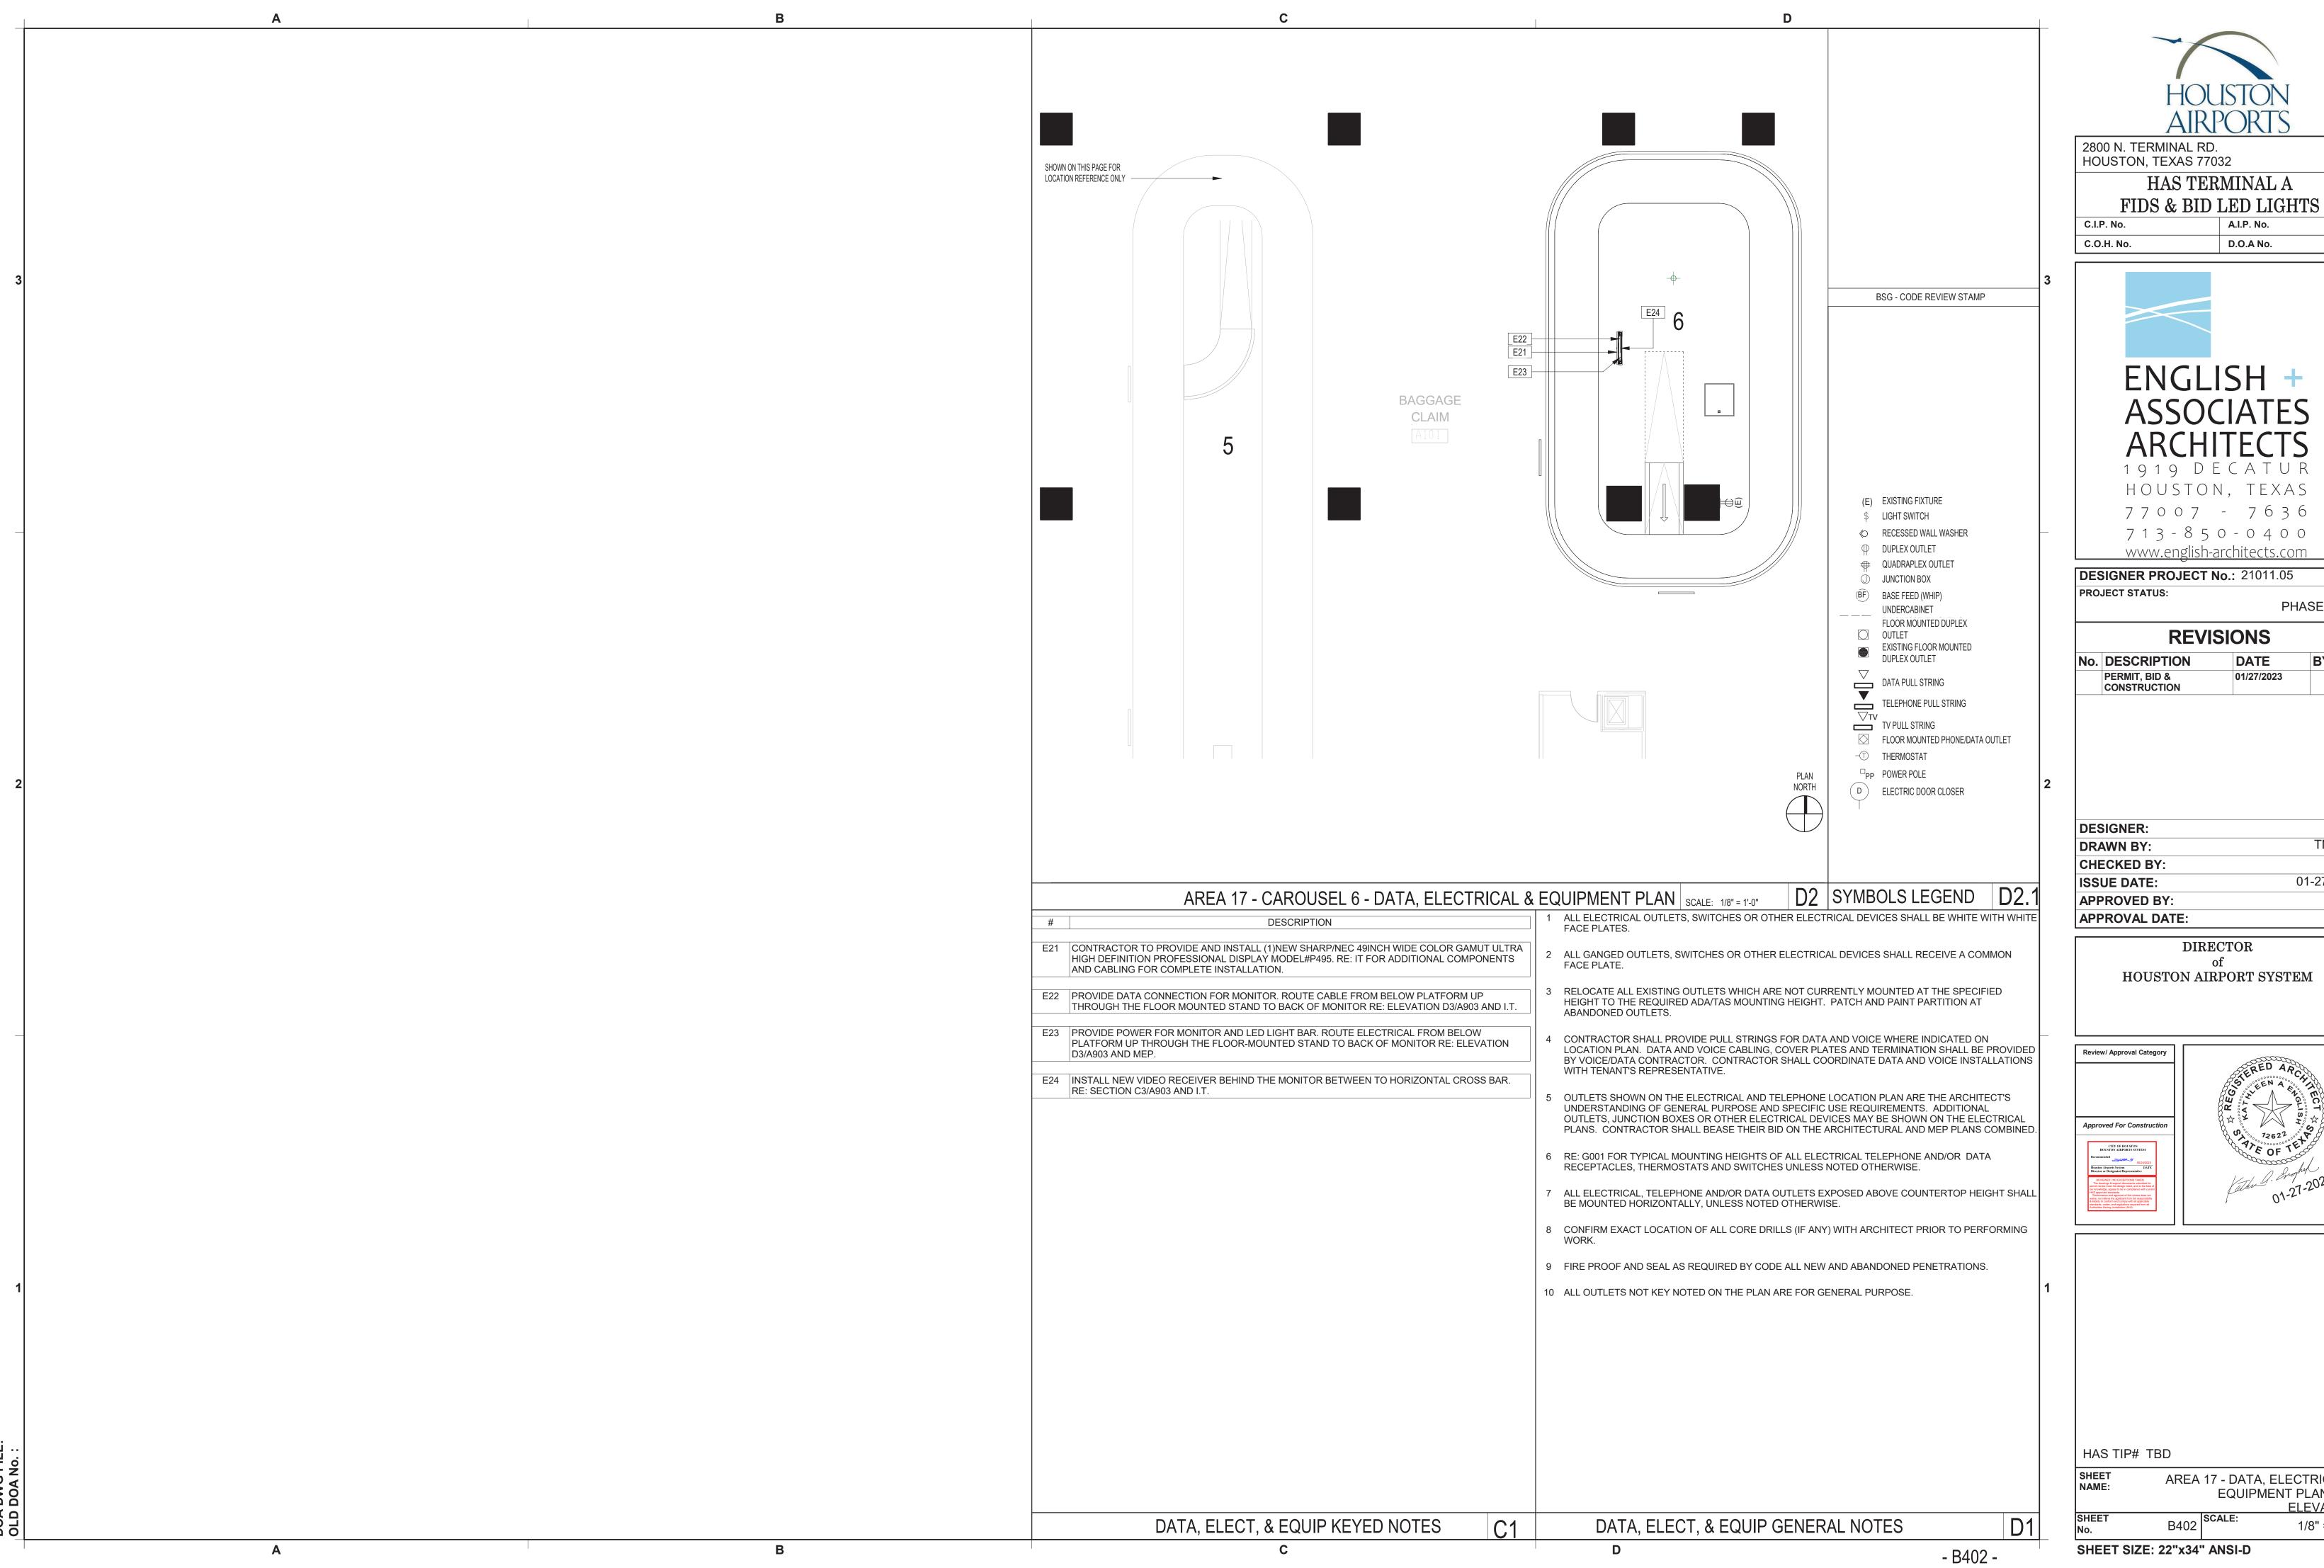DESIGNER:	-
DRAWN BY:	TN/CRT
CHECKED BY:	ACM
ISSUE DATE:	01-27-2023
APPROVED BY:	KE
APPROVAL DATE:	



AREA 17 - DATA, ELECTRICAL & EQUIPMENT PLAN AND ELEVATION 1/8" = 1'-0"

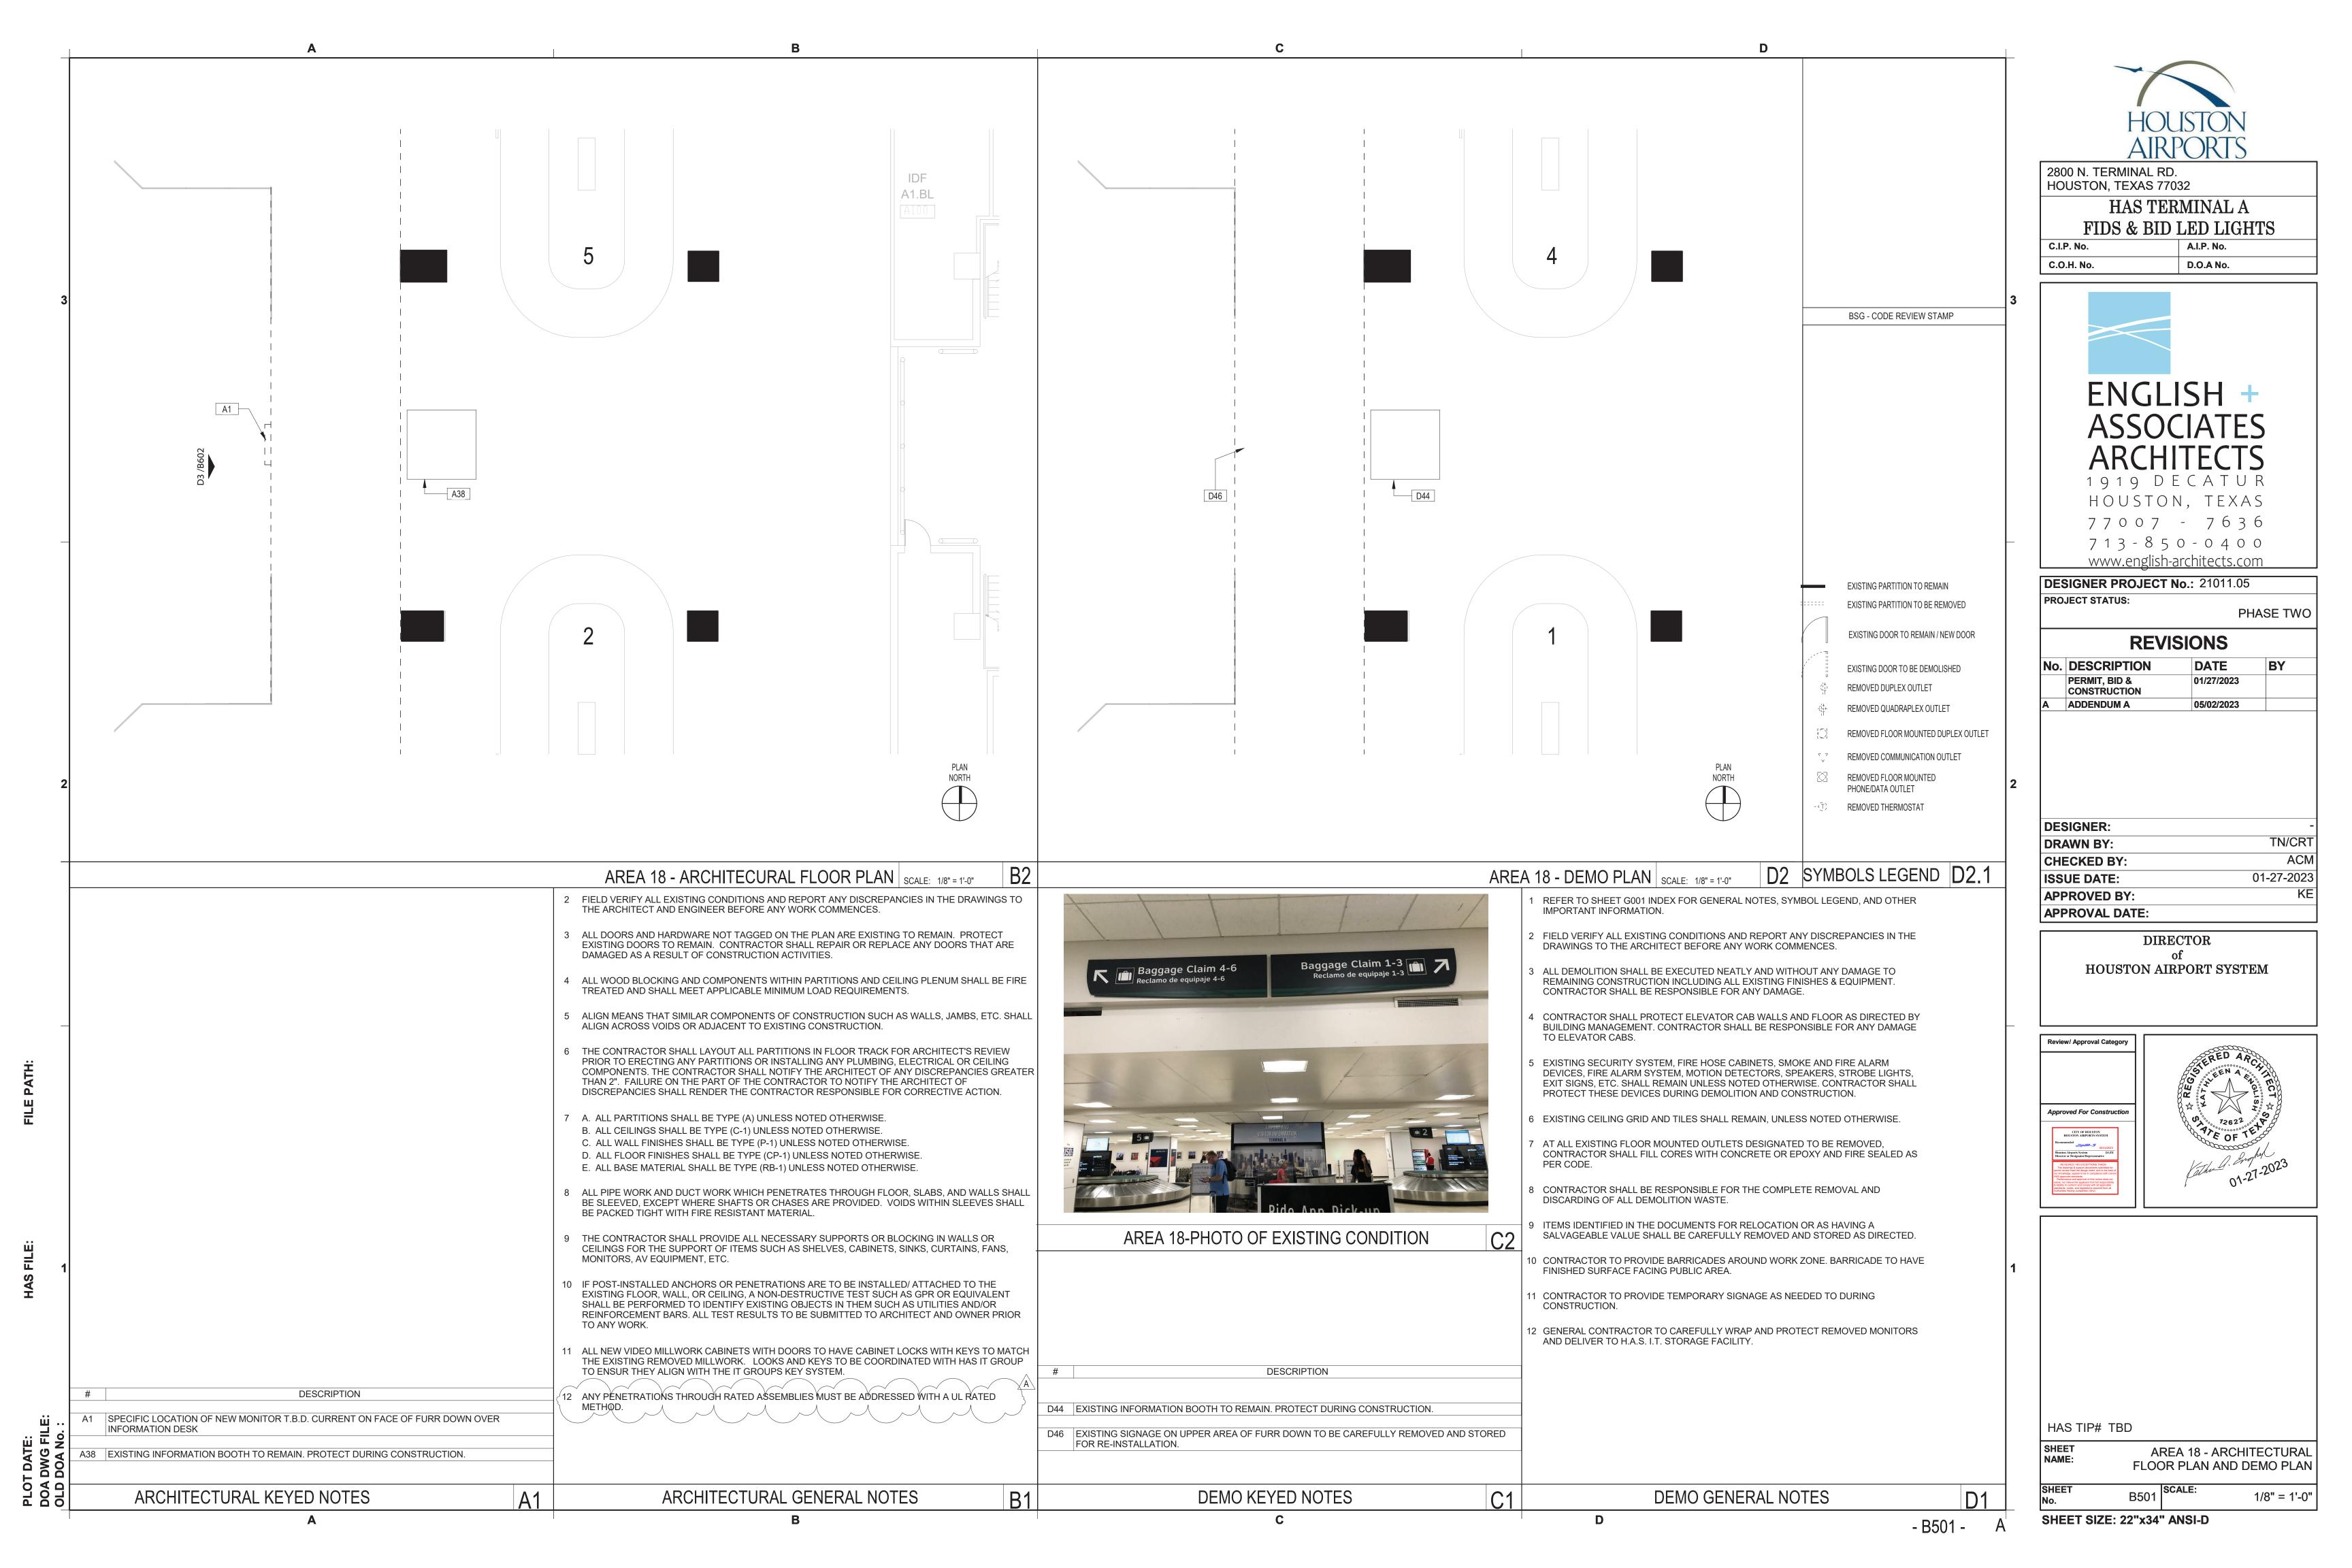

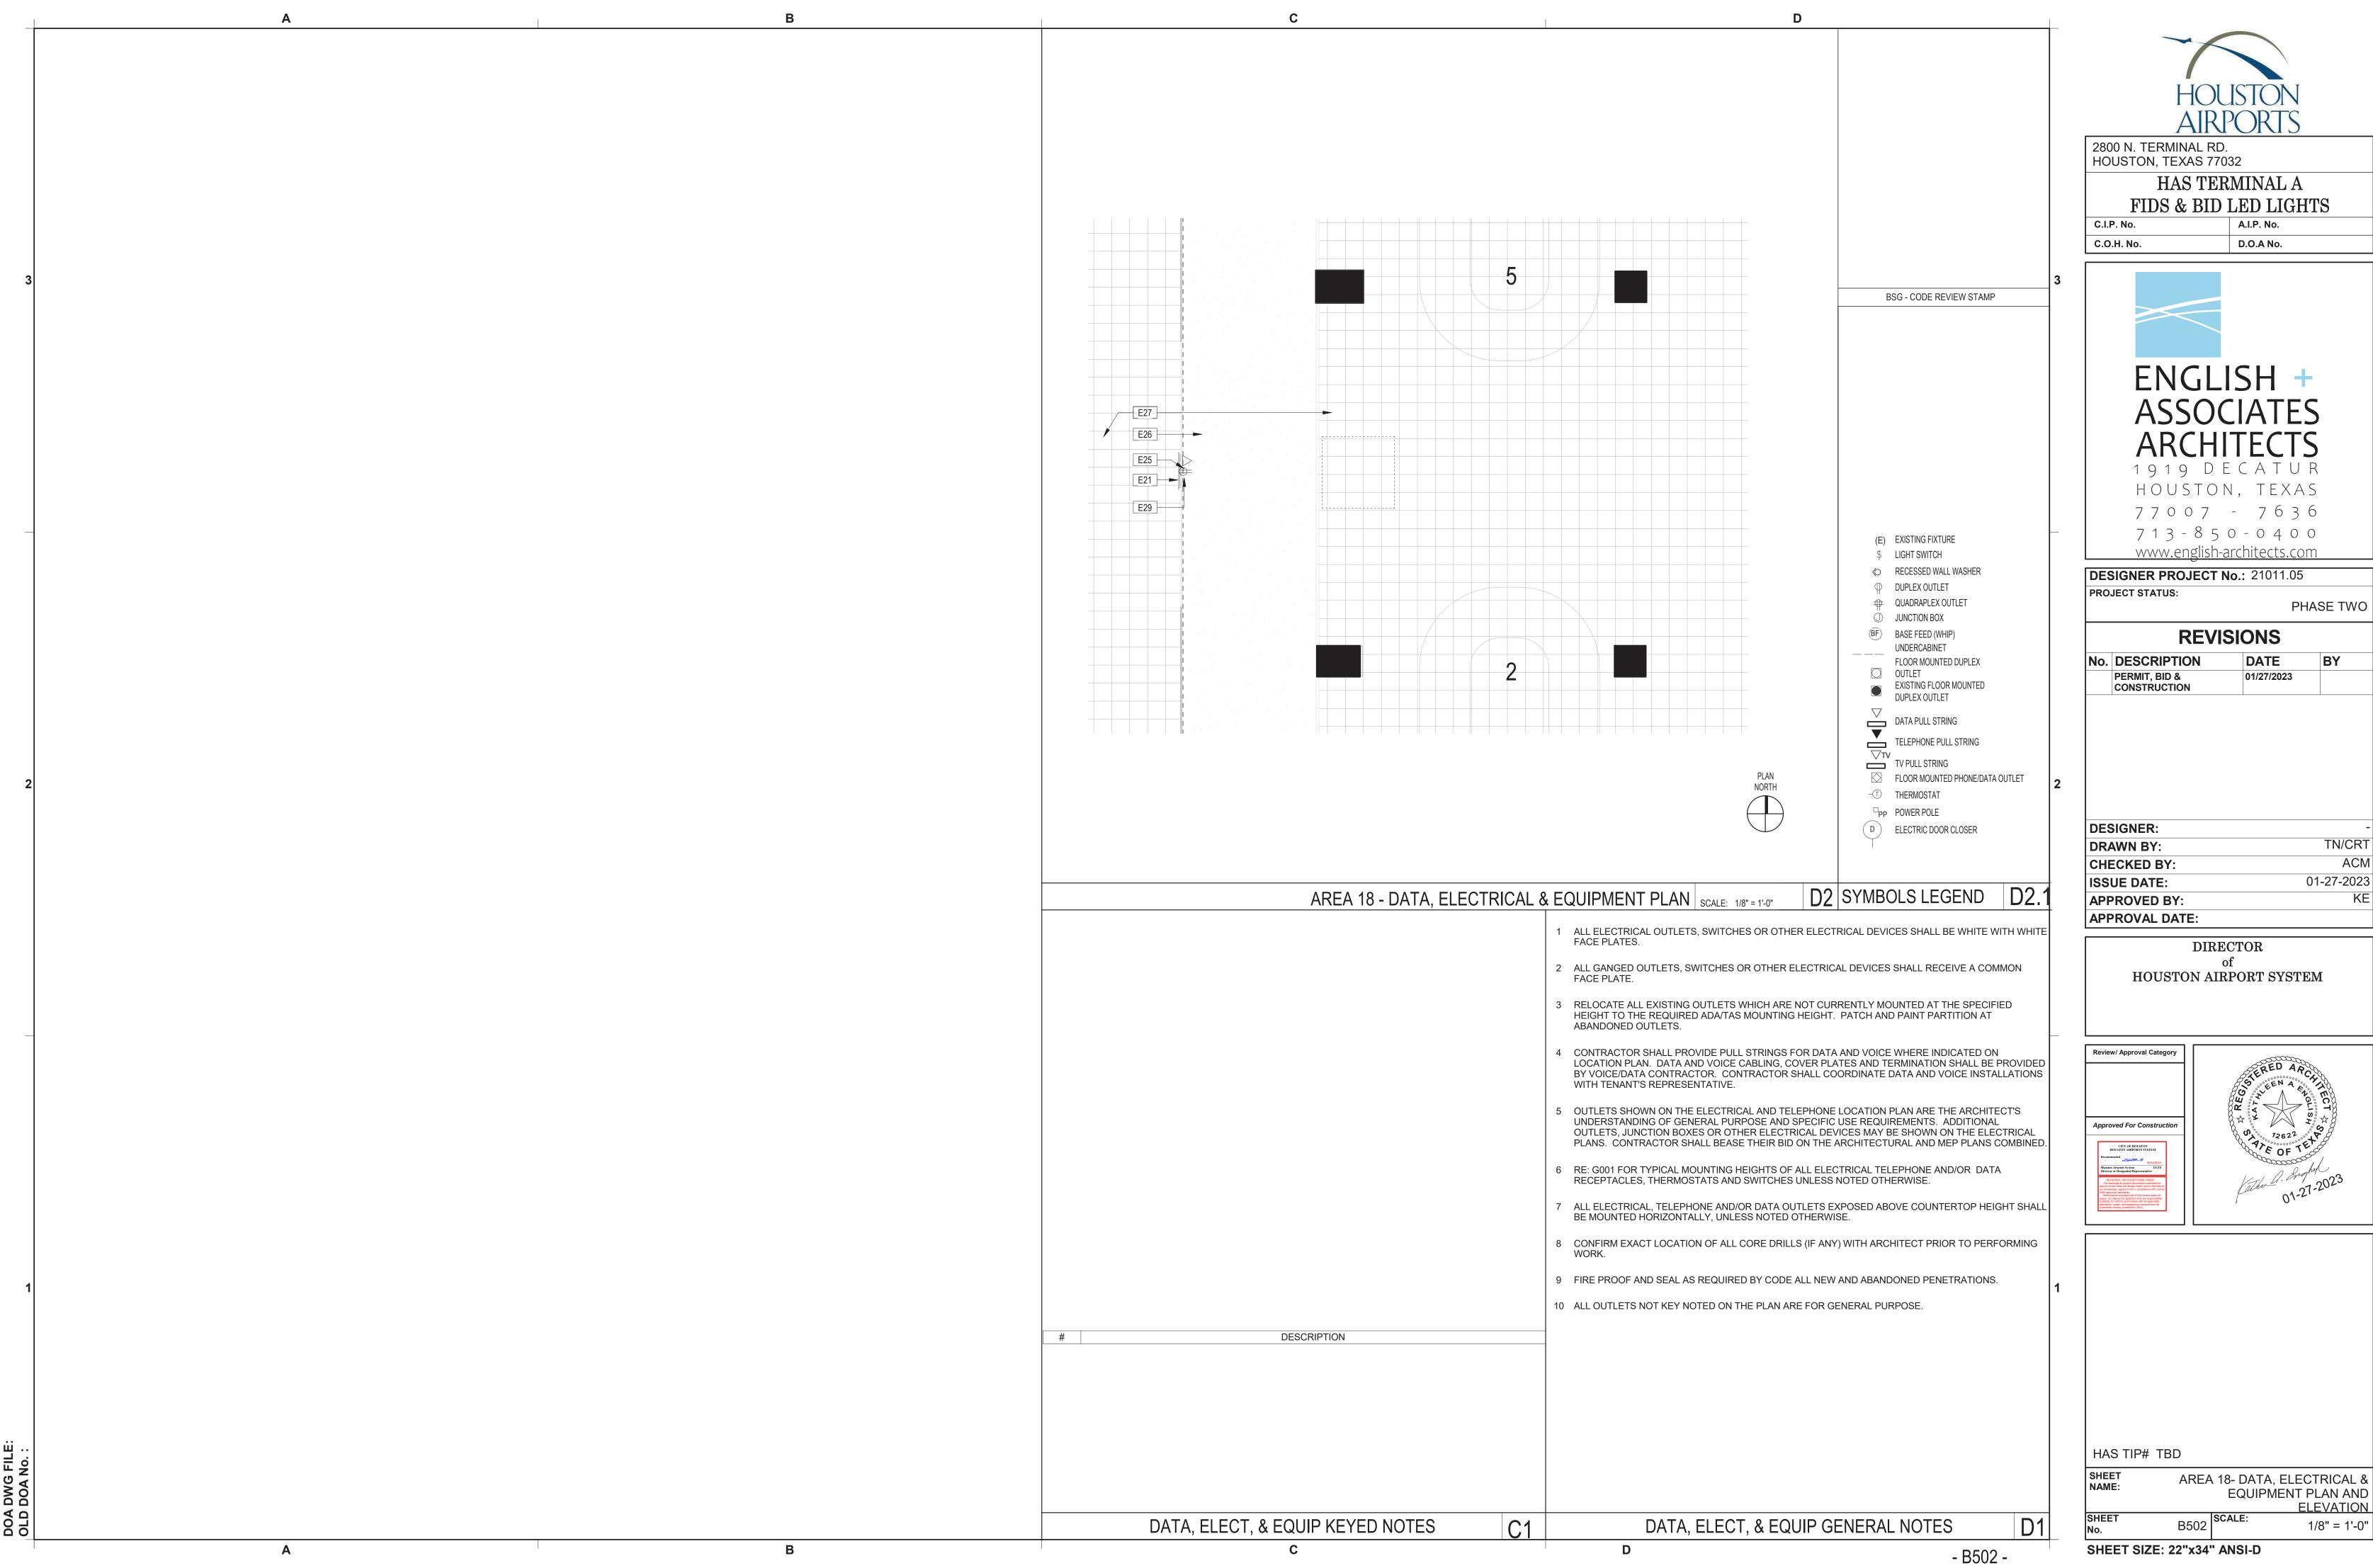


BY


TN/CRT ACM 01-27-2023



AREA 18- DATA, ELECTRICAL & EQUIPMENT PLAN AND ELEVATION 1/8" = 1'-0"

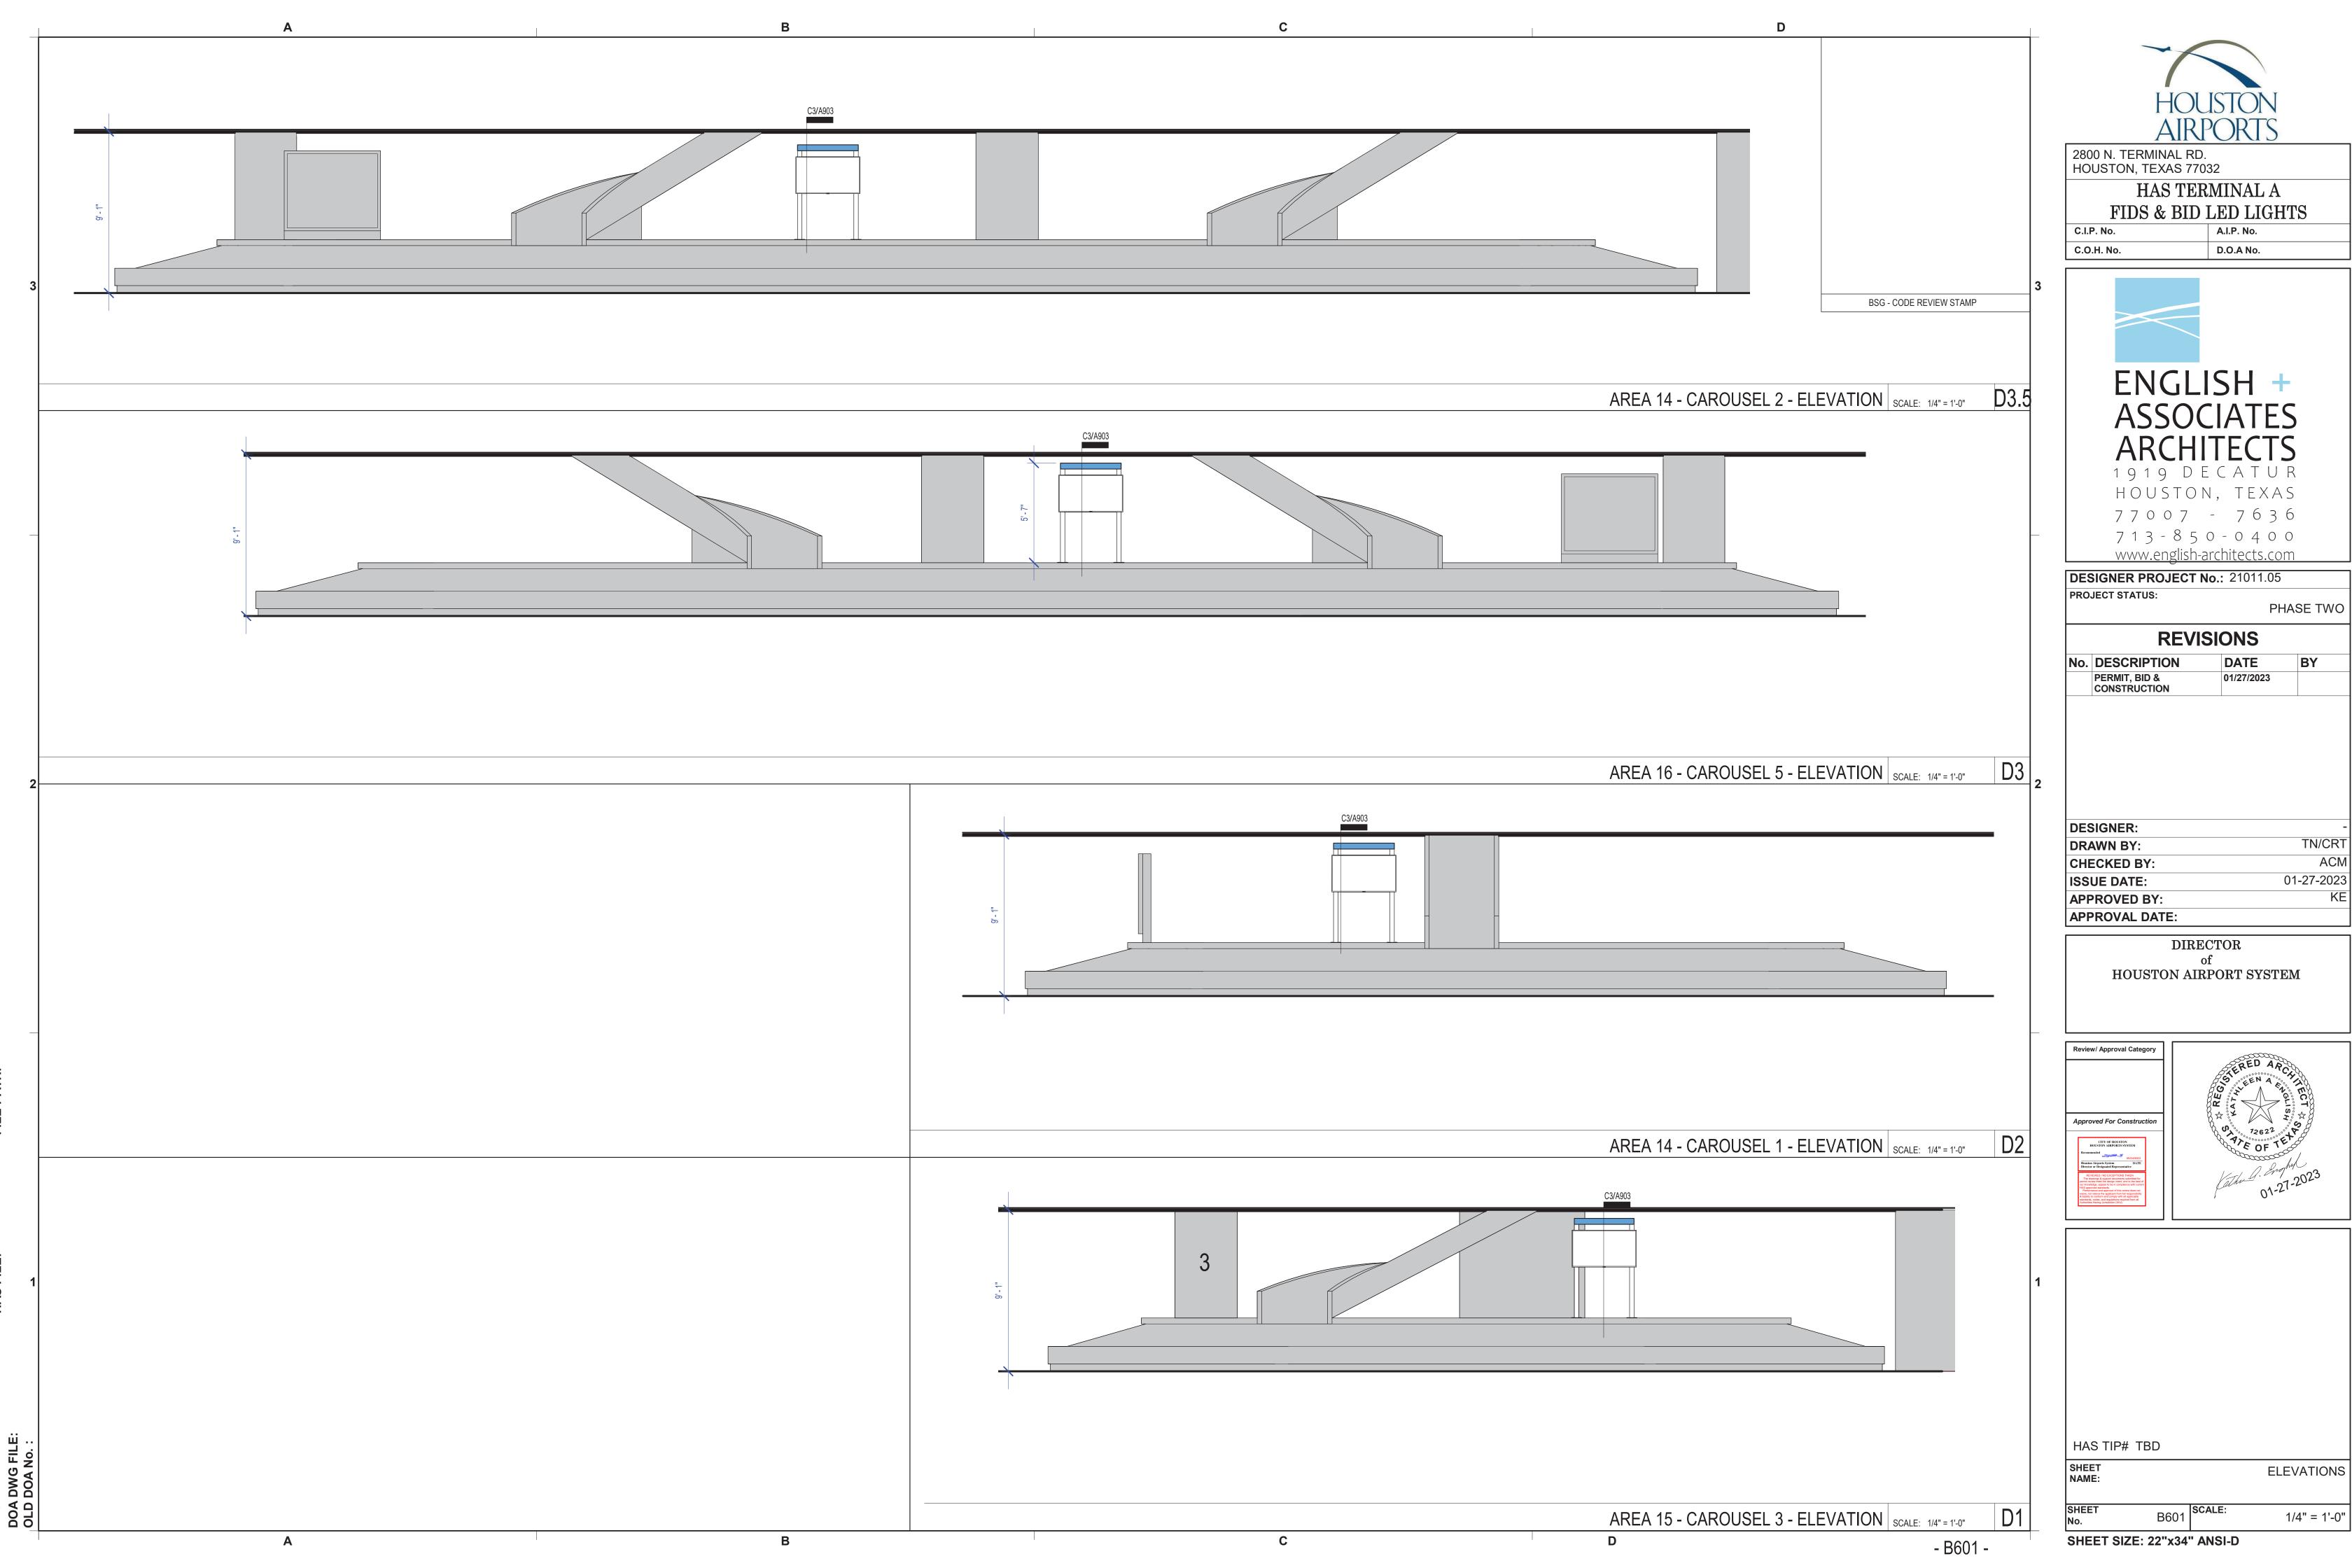

L	HAS T	ΓIP#	TBD		
N	HEET IAME:				ELEVATIONS
SI N	HEET o.		B601	SCALE:	1/4" = 1'-0"

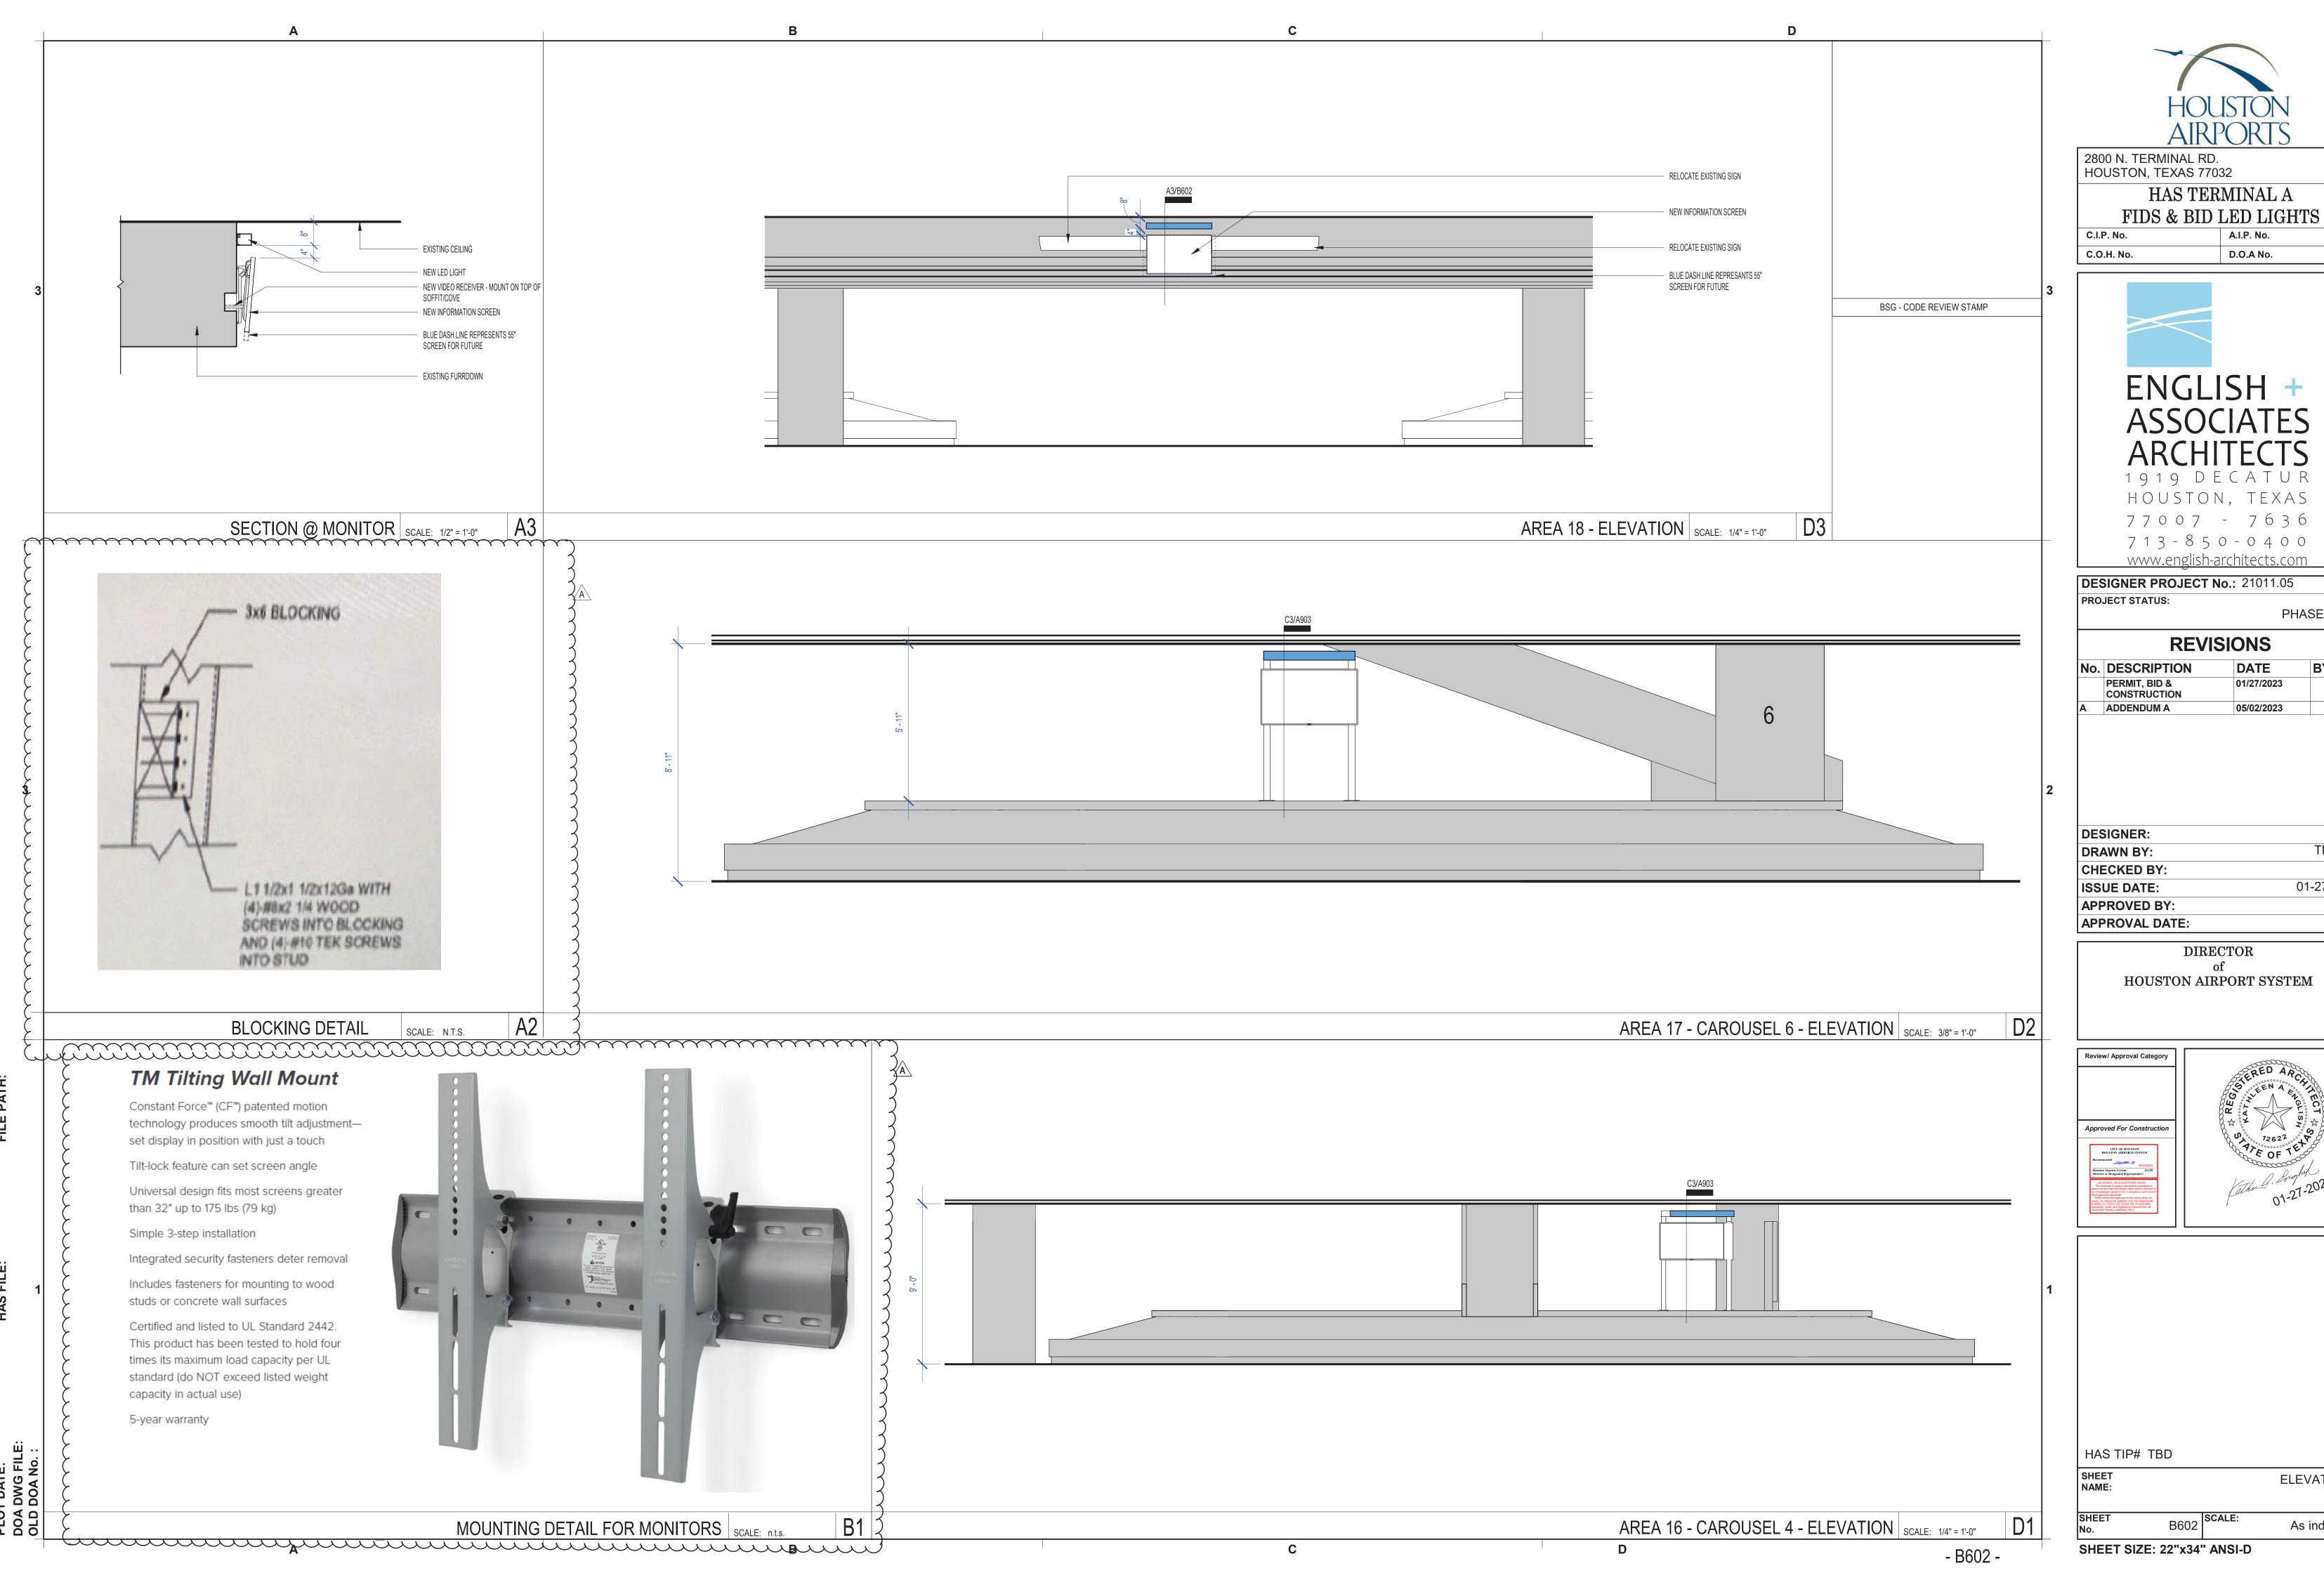



HAS TERMINAL A

D.O.A No.




**DESIGNER PROJECT No.:** 21011.05 PHASE TWO **REVISIONS** 


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DRAWN BY:	TN/CRT
CHECKED BY:	ACM
ISSUE DATE:	01-27-2023
APPROVED BY:	KE
APPROVAL DATE:	

HOUSTON AIRPORT SYSTEM

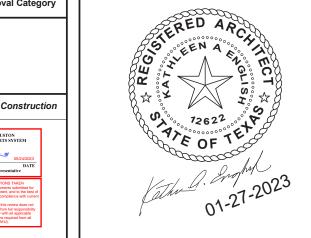

HAS TIP#	TDD		
TAS TIP#	. IDD		
SHEET NAME:			ELEVATIONS
SHEET No.	B602	SCALE:	As indicated



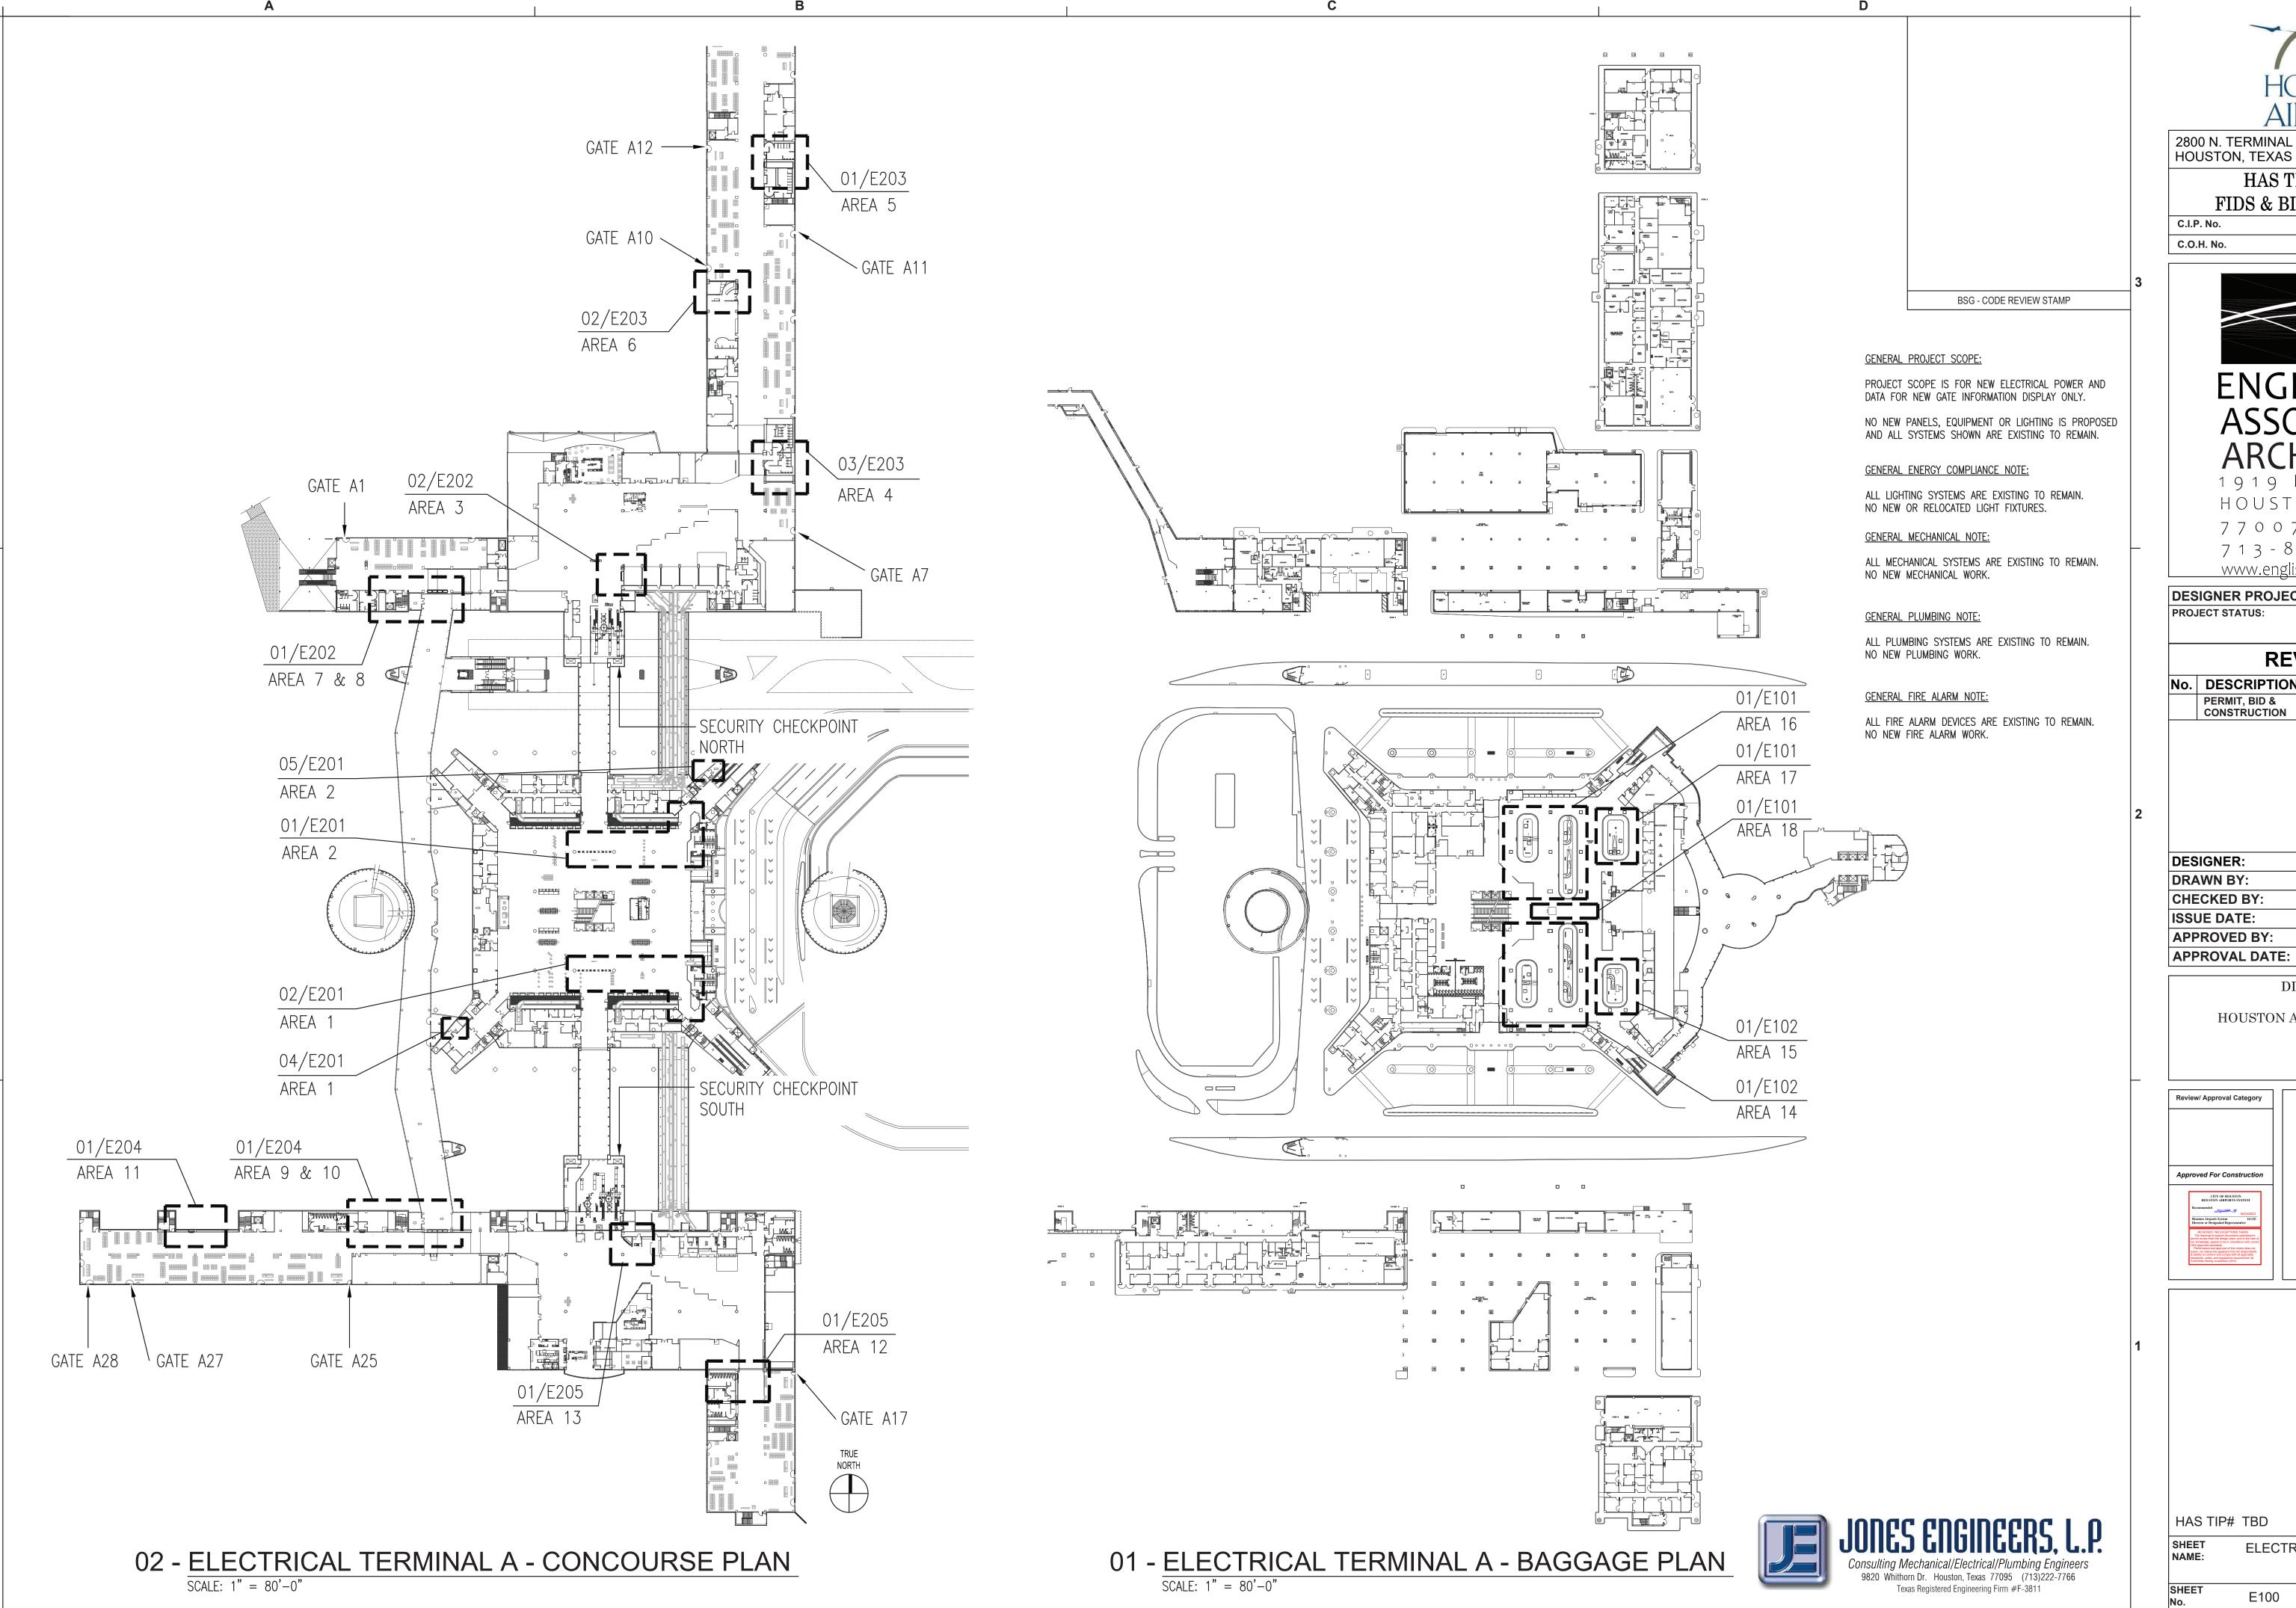

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#### HAS TERMINAL A

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### **DESIGNER PROJECT No.:** 21011.05

**PROJECT STATUS:** 

PHASE TWO

#### **REVISIONS**


No.	DESCRIPTION	DATE	BY
	PERMIT, BID & CONSTRUCTION	01/27/2023	

DESIGNER:	GB
DRAWN BY:	SP
CHECKED BY:	GB
ISSUE DATE:	01-27-2023
APPROVED BY:	CJ

DIRECTOR HOUSTON AIRPORT SYSTEM

Review/ Approval Category

Approved For Construction

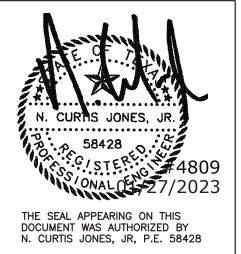


HAS TIP# TBD

ELECTRICAL OVERALL PLAN

1" = 80'-0

SHEET SIZE: 22"x34" ANSI-D


- E100 -

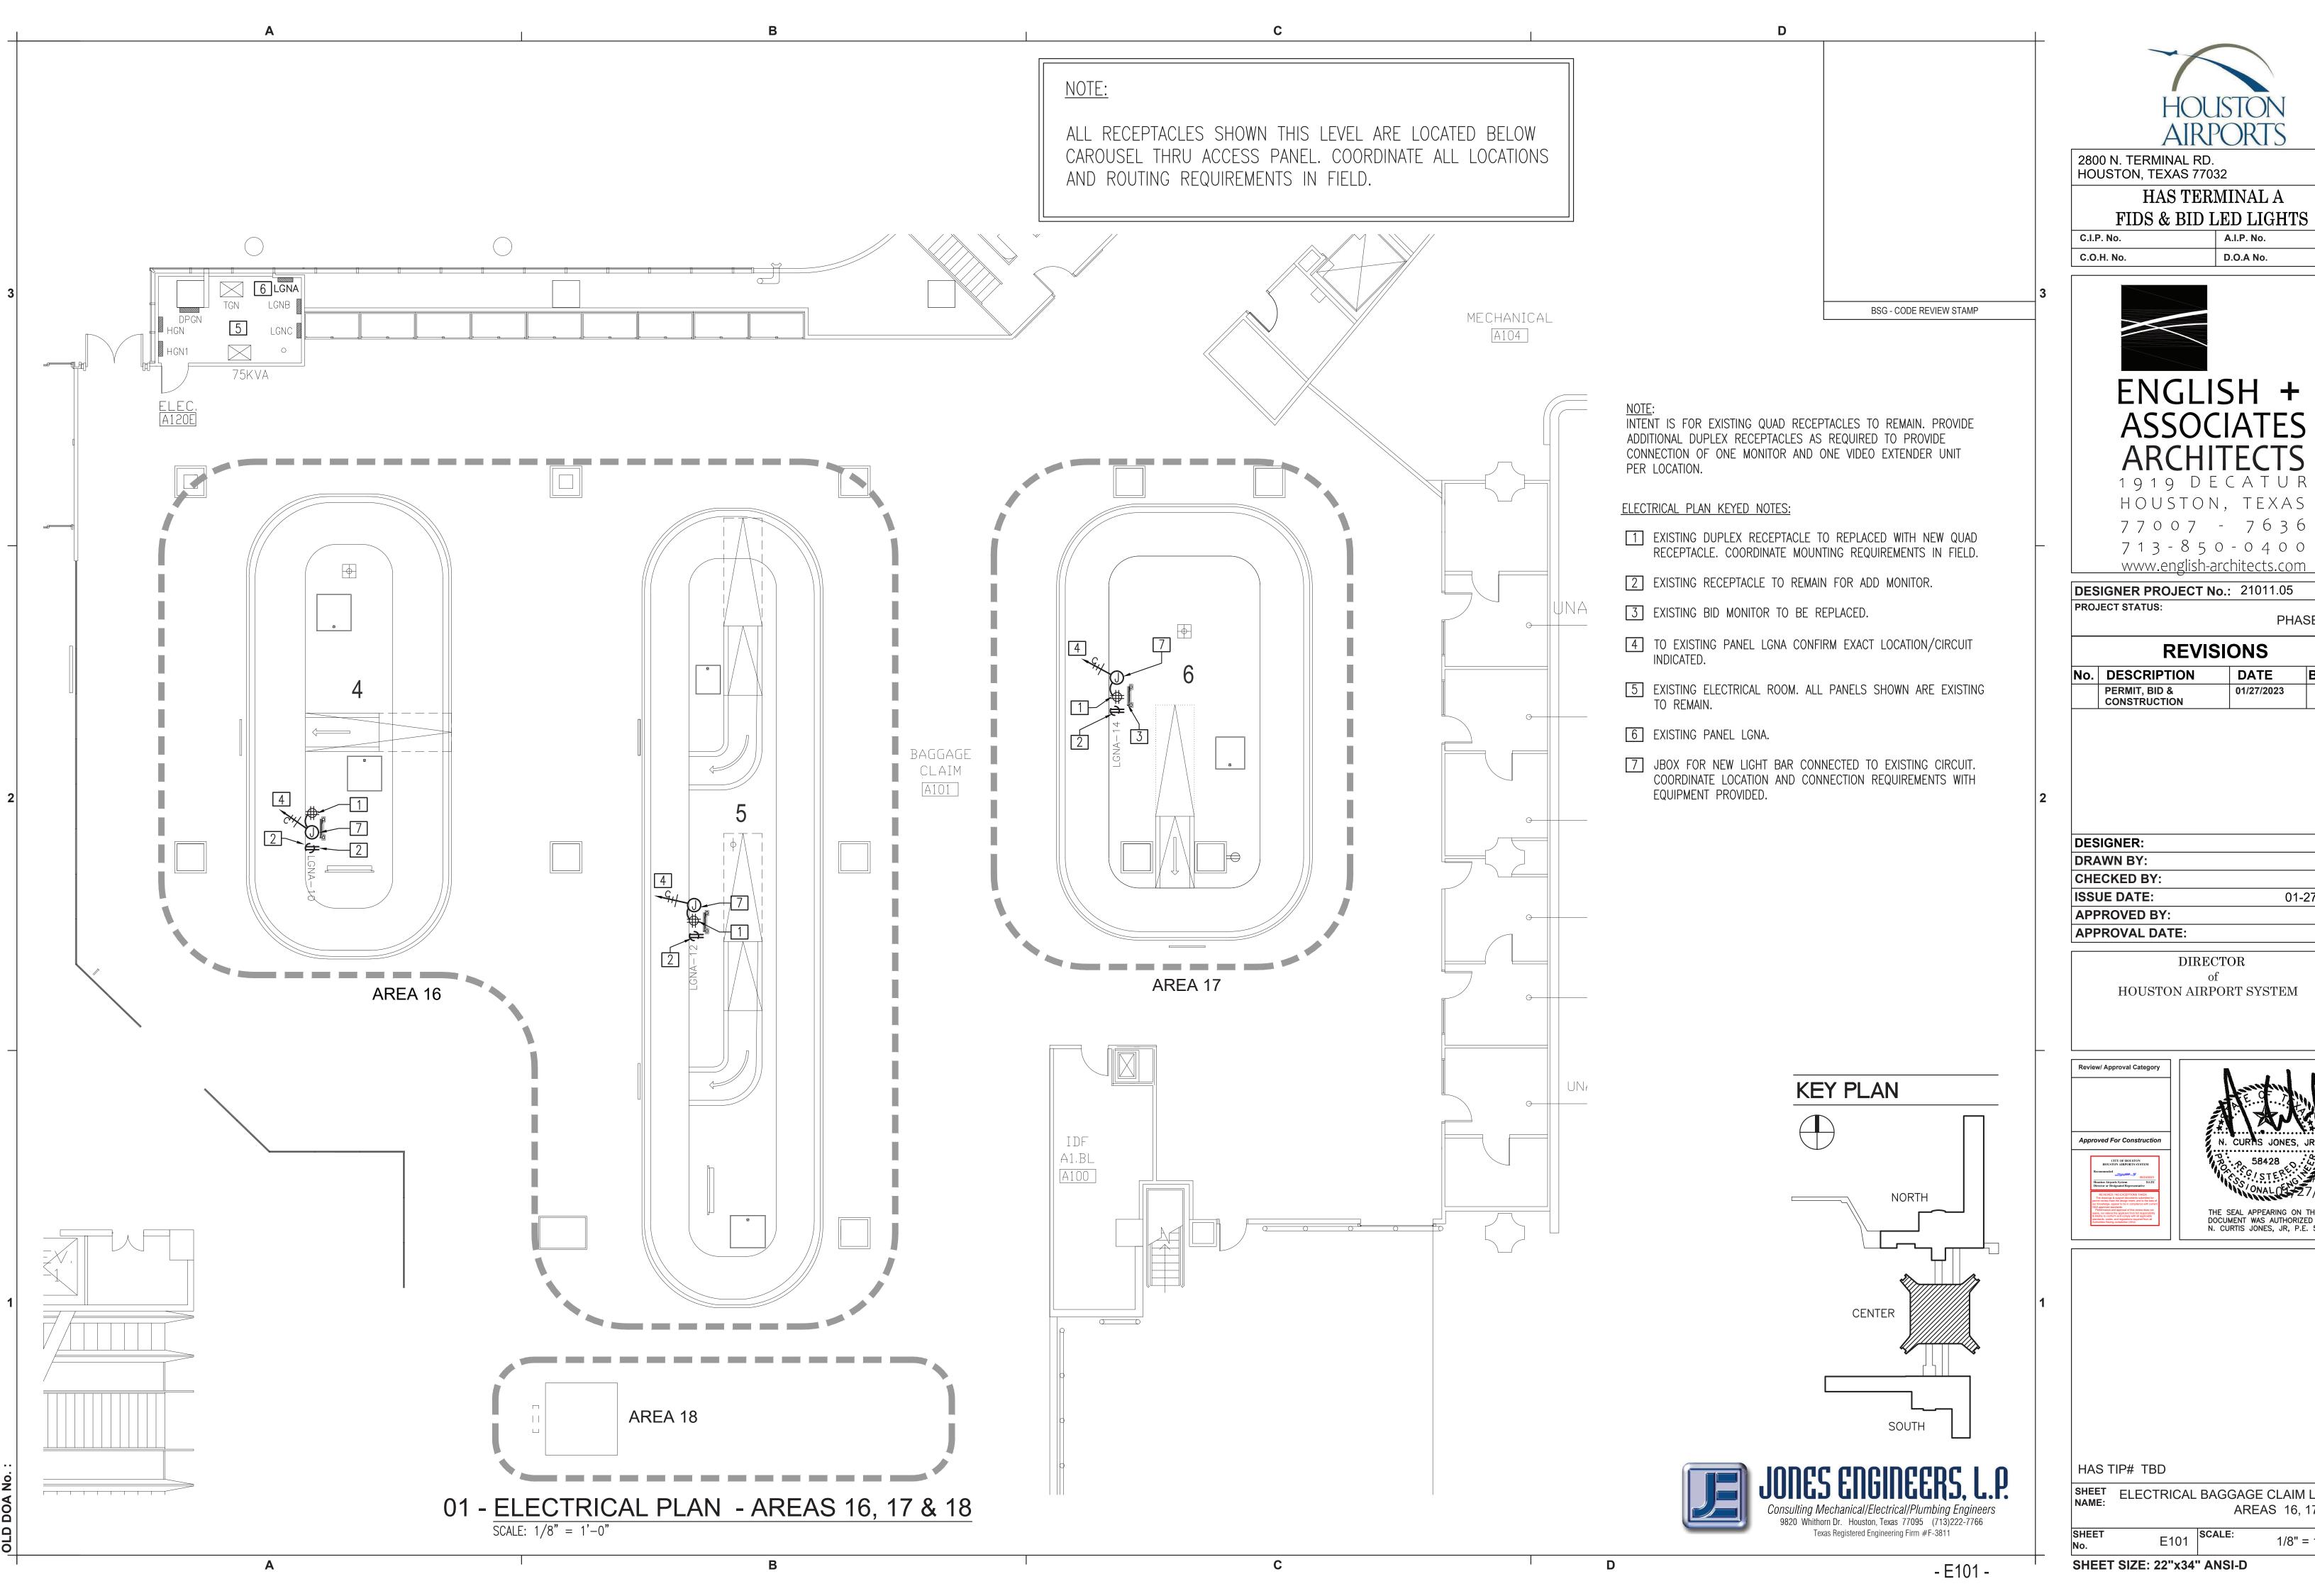



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A.I.P. No.

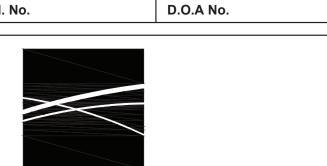

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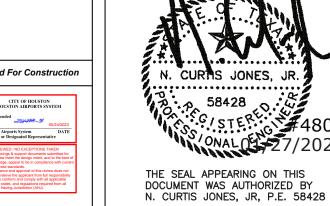
PHASE TWO

#### **REVISIONS**

о.	DESCRIPTION	DATE	BY
	PERMIT, BID & CONSTRUCTION	01/27/2023	


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SHEET ELECTRICAL BAGGAGE CLAIM LEVEL AREAS 16, 17 & 18

1/8" = 1'-0"





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HAS TERMINAL A

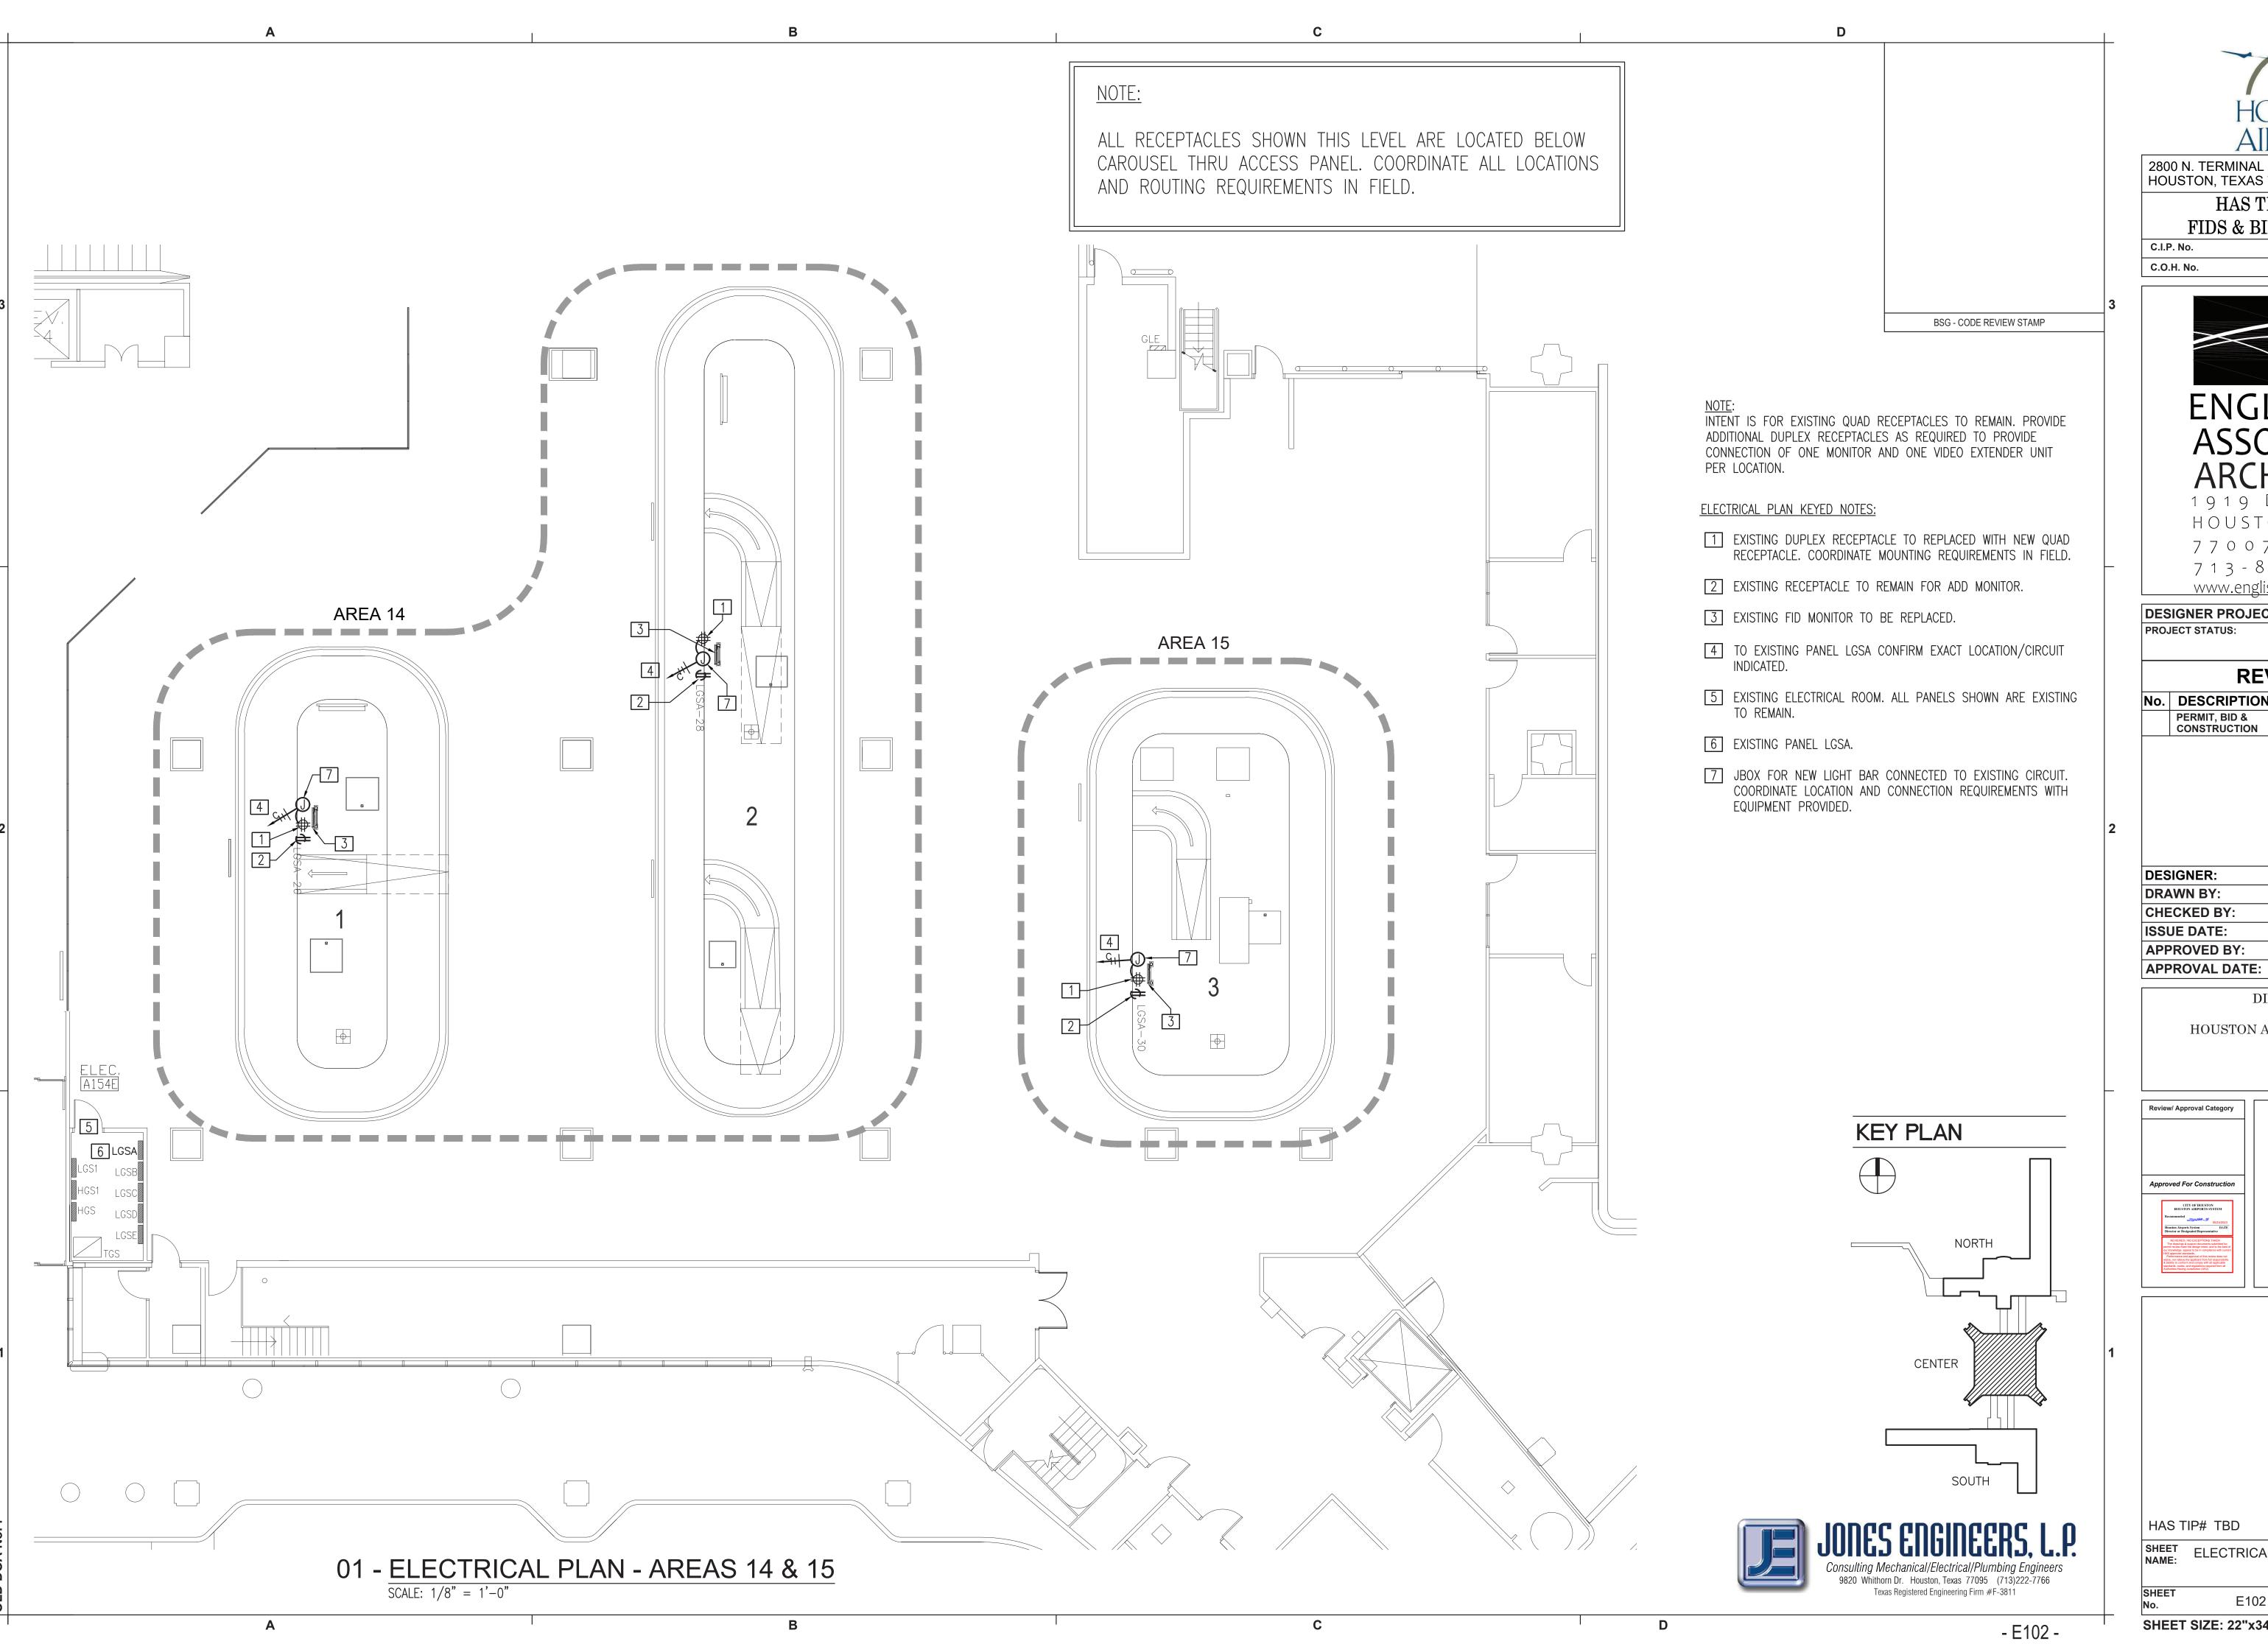D.O.A No.

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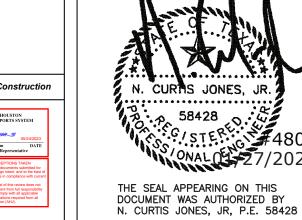
#### **REVISIONS**

0.	DESCRIPTION	DATE	BY
	PERMIT, BID & CONSTRUCTION	01/27/2023	
		-	

DESIGNER:	GB
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CHECKED BY:	GB
ISSUE DATE:	01-27-2023
APPROVED BY:	CJ

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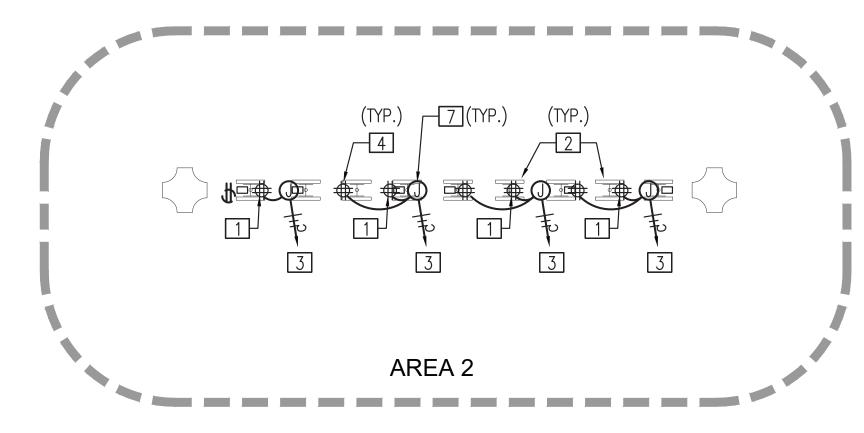


HAS TIP# TBD


ELECTRICAL BAGGAGE CLAIM LEVEL AREAS 14 & 15

1/8" = 1'-0"


01 - ELECTRICAL PLAN - OVERALL CONCOURSE LEVEL PLAN SCALE: 1/16" = 1'-0"




03 - ELECTRICAL PLAN - AREA 2 SCALE: 1/8" = 1'-0"

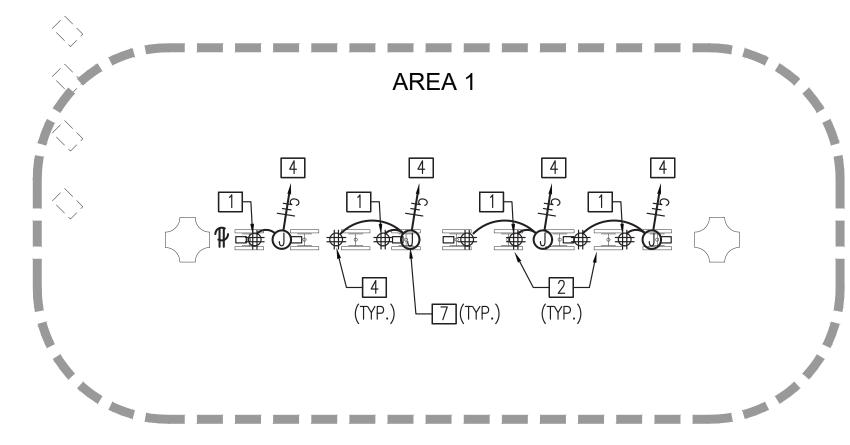

02 - ELECTRICAL PLAN - AREA 1 SCALE: 1/8" = 1'-0"

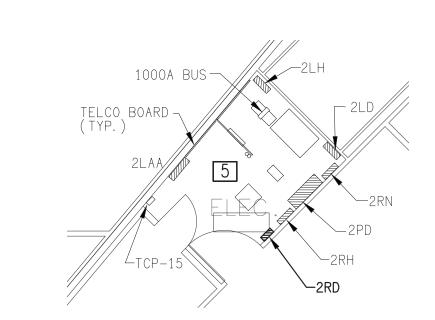

04 - ELECTRICAL ROOM - AREA 1 SCALE: 1/8" = 1'-0"

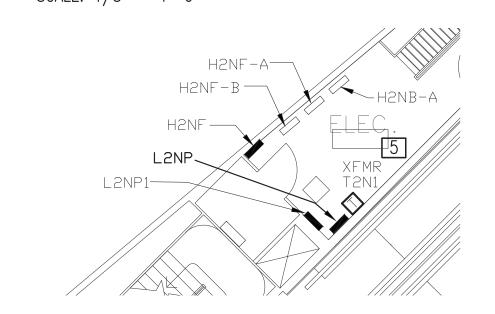


05 - ELECTRICAL ROOM - AREA 2 SCALE: 1/8" = 1'-0"



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#### **REVISIONS** BY No. DESCRIPTION DATE PERMIT, BID & CONSTRUCTION 01/27/2023


DESIGNER:	GB
DRAWN BY:	SP
CHECKED BY:	GB
ISSUE DATE:	01-27-2023
APPROVED BY:	CJ

DIRECTOR HOUSTON AIRPORT SYSTEM

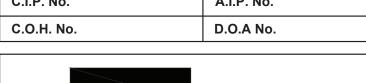**APPROVAL DATE:** 

Approved For Construction



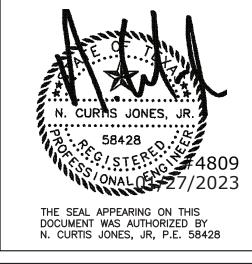

9820 Whithorn Dr. Houston, Texas 77095 (713)222-7766 Texas Registered Engineering Firm #F-3811

**KEY PLAN** 

BSG - CODE REVIEW STAMP

INTENT IS FOR EXISTING QUAD RECEPTACLES TO REMAIN. PROVIDE

ADDITIONAL DUPLEX RECEPTACLES AS REQUIRED TO PROVIDE CONNECTION OF ONE MONITOR AND ONE VIDEO EXTENDER UNIT

TO EXISTING PANEL L2NP, LOCATED IN BAGGAGE LEVEL. RE:

4 TO EXISTING PANEL 2RD, LOCATED IN BAGGAGE LEVEL. RE:

5 AREA OF EXISTING IDF ROOM ON MEZZANINE LEVEL ABOVE.

6 EXISTING PANEL UPS-N. PROVIDE NEW CIRCUIT FOR ITT EQUIPMENT. COORDINATE EXACT REQUIREMENTS WITH TECHNOLOGY DRAWING AND LOCATIONS IN FIELD.

7 EXISTING PANEL UPS-S. PROVIDE NEW CIRCUIT FOR ITT

TECHNOLOGY DRAWING AND LOCATIONS IN FIELD

EQUIPMENT. COORDINATE EXACT REQUIREMENTS WITH

SHEET E1.01 FOR LOCATION. CONFIRM EXACT LOCATION/CIRCUIT

SHEET E1.01 FOR LOCATION. CONFIRM EXACT LOCATION/CIRCUIT

PER LOCATION.

**ELECTRICAL PLAN KEYED NOTES:** 

INDICATED. RE: 05/E201.

INDICATED. RE: 04/E201.

1 EXISTING QUAD RECEPTACLE TO REMAIN.

2 EXISTING FID MONITOR TO BE REPLACED.

CENTER SOUTH

HAS TIP# TBD

ELECTRICAL CONCOURSE LEVEL AREA 1 & 2


SCALE:

1/8" = 1'-0"

E201

SHEET SIZE: 22"x34" ANSI-D

- E201 -

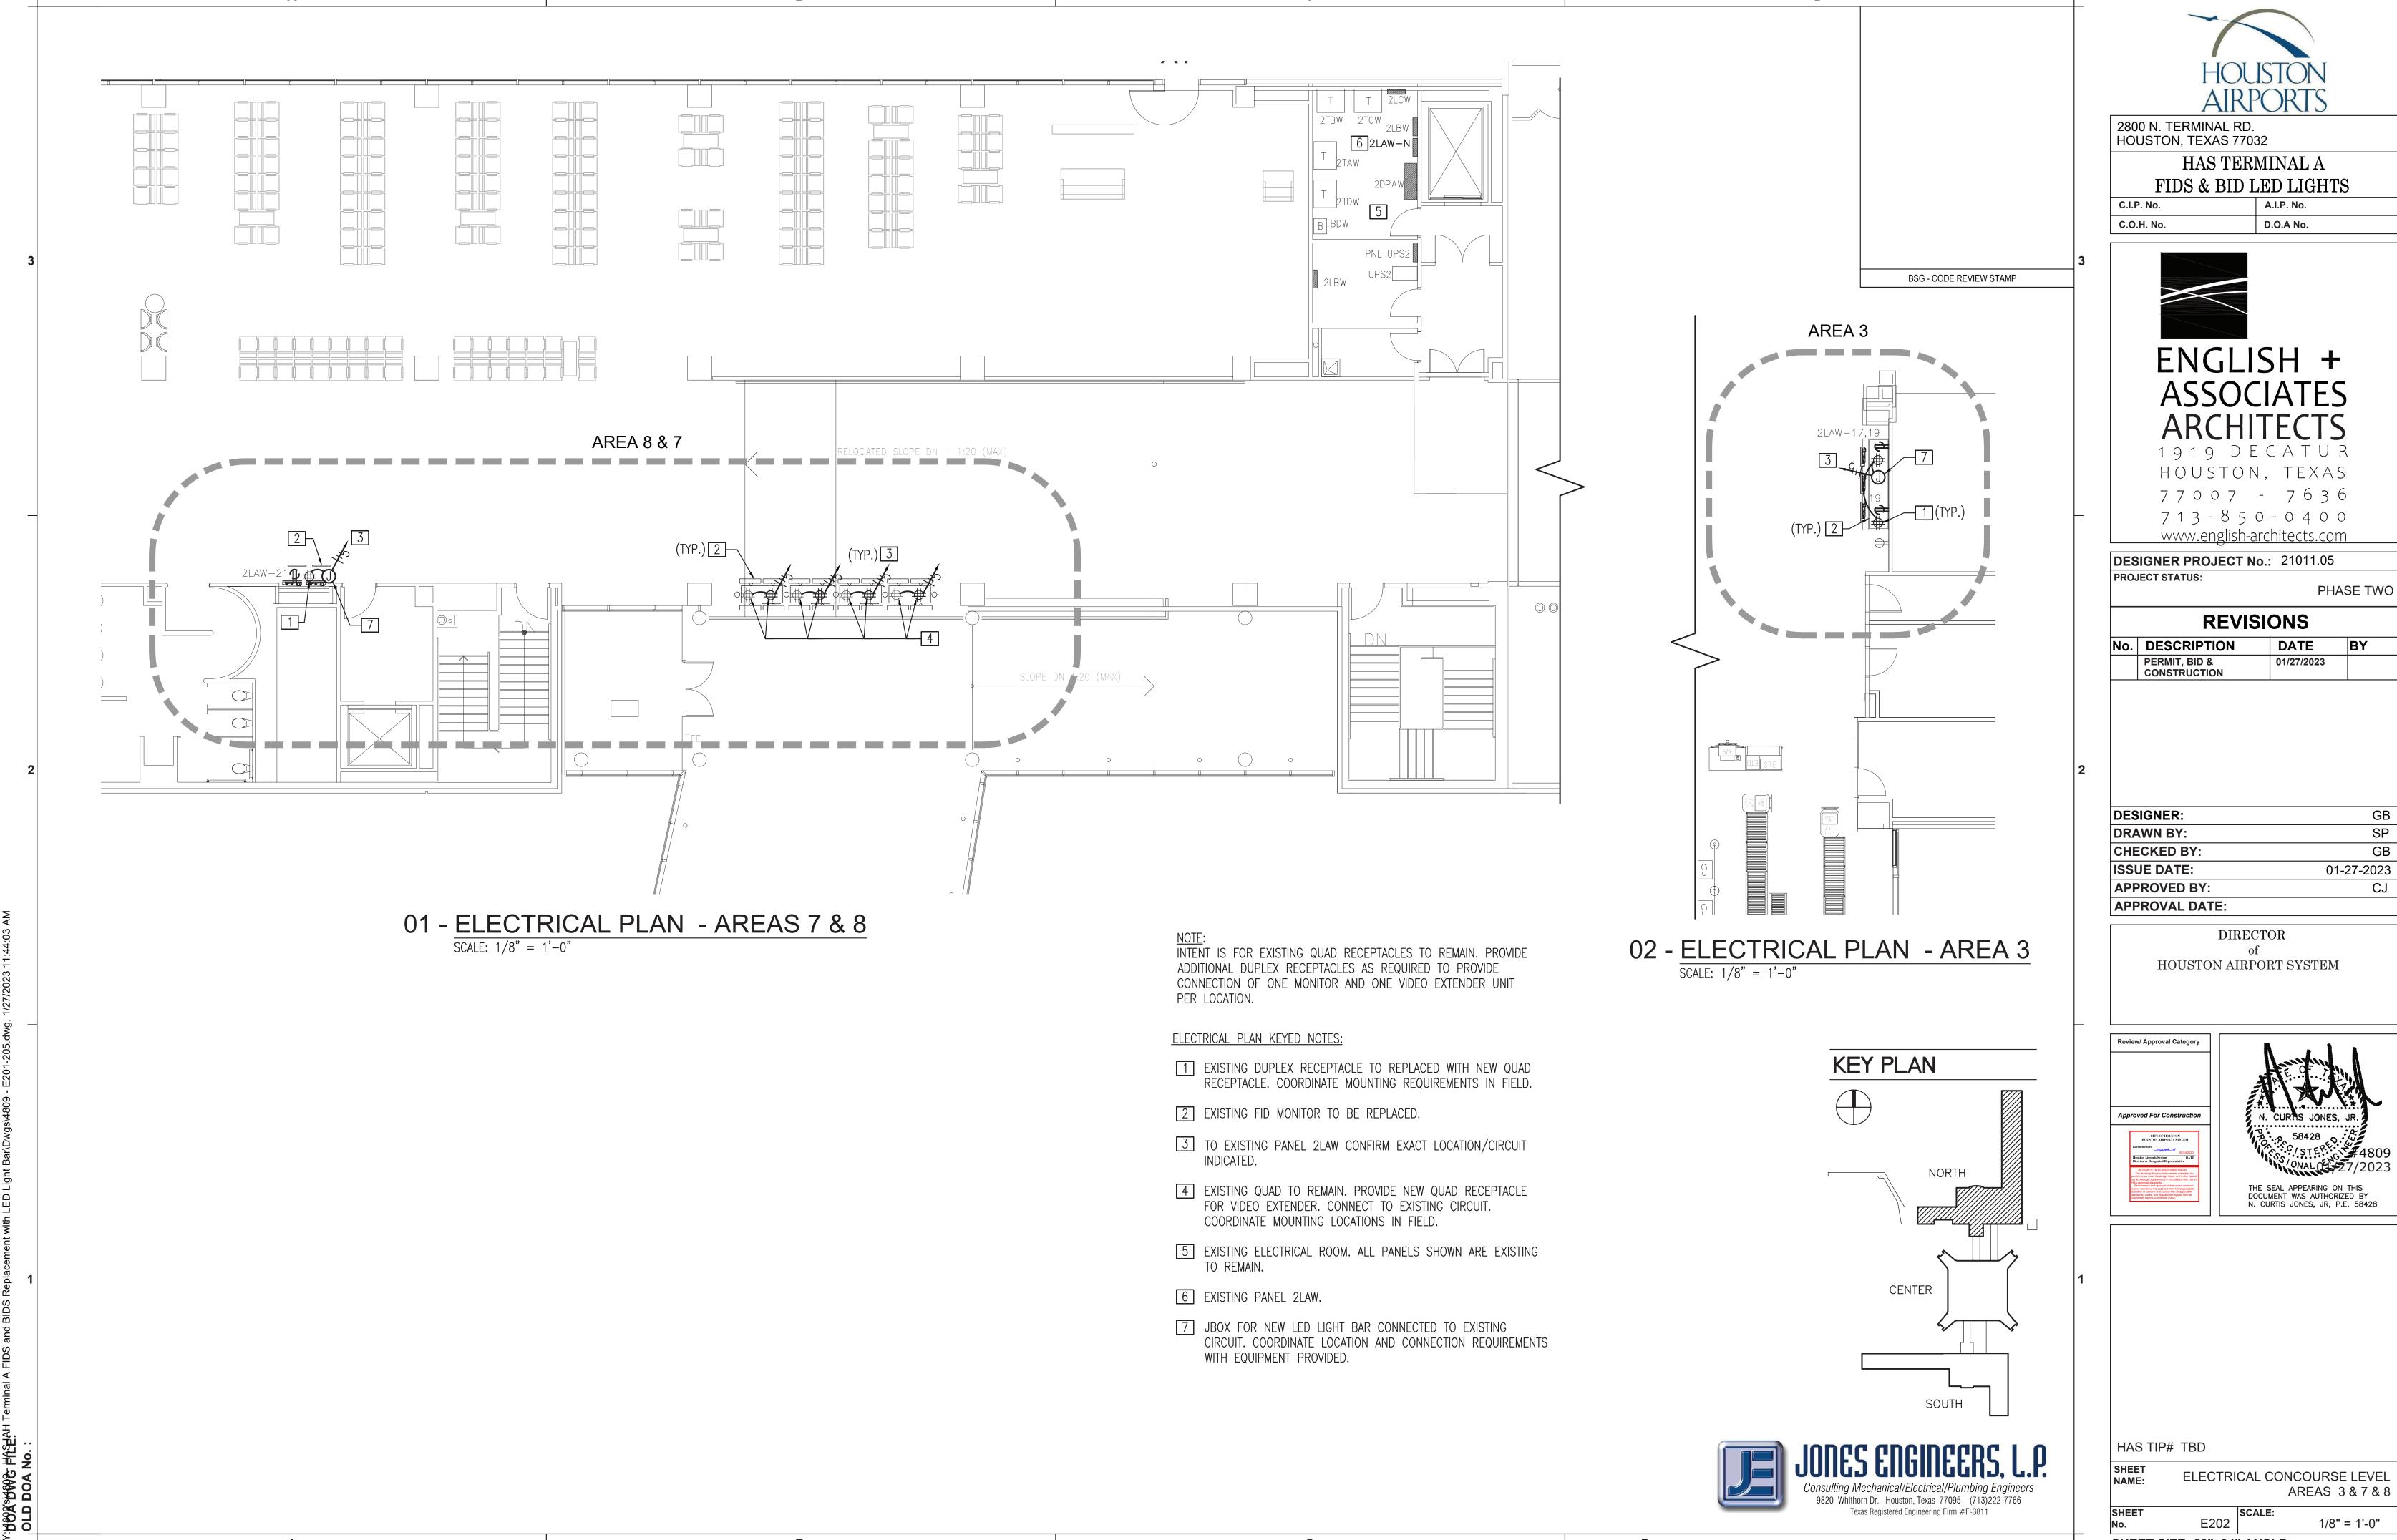


SP GB

SHEET SIZE: 22"x34" ANSI-D

- E202 -

AREA 6 2TAN 2TBN 2TCN 2TLN


02 - ELECTRICAL PLAN - AREA 6 SCALE: 1/8" = 1'-0"

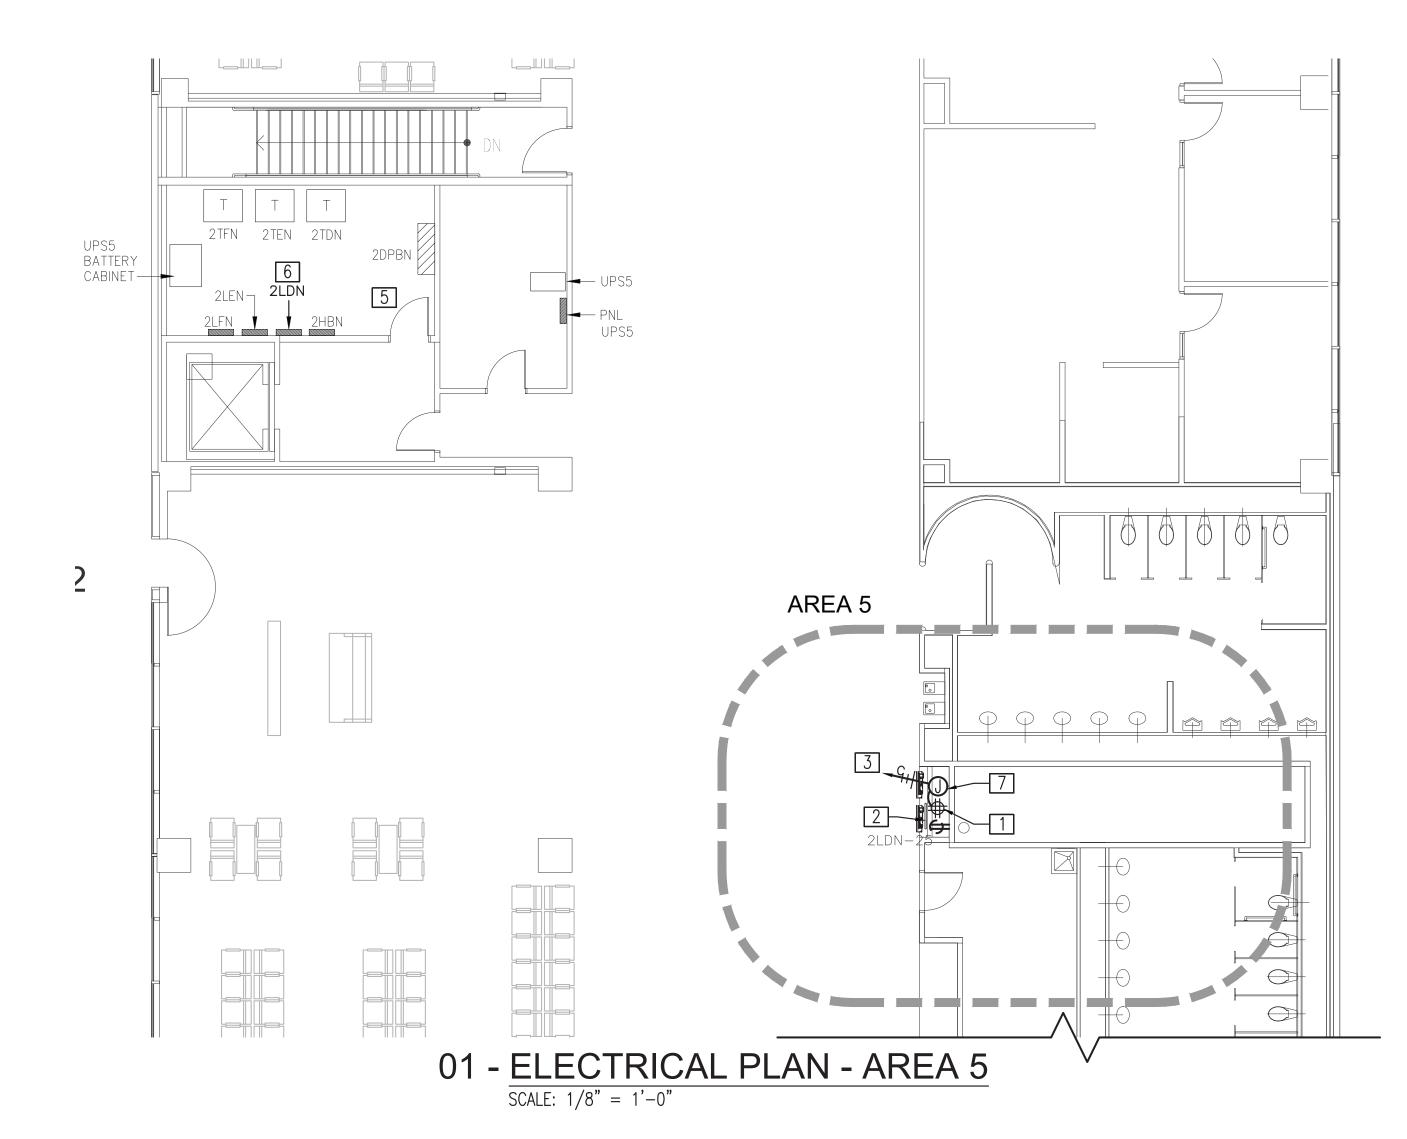


INTENT IS FOR EXISTING QUAD RECEPTACLES TO REMAIN. PROVIDE ADDITIONAL DUPLEX RECEPTACLES AS REQUIRED TO PROVIDE CONNECTION OF ONE MONITOR AND ONE VIDEO EXTENDER UNIT PER LOCATION.

#### ELECTRICAL PLAN KEYED NOTES:

- 1 EXISTING DUPLEX RECEPTACLE TO REPLACED WITH NEW QUAD RECEPTACLE. COORDINATE MOUNTING REQUIREMENTS IN FIELD.
- 2 EXISTING FID MONITOR TO BE REPLACED.
- 3 TO EXISTING PANEL 2LBN & 2LDN CONFIRM EXACT LOCATION/CIRCUIT INDICATED.
- 4 NOT USED.
- 5 EXISTING ELECTRICAL ROOM. ALL PANELS SHOWN ARE EXISTING
- 6 EXISTING PANEL 2LBN & 2LDN.
- 7 JBOX FOR NEW LED LIGHT BAR CONNECTED TO EXISTING CIRCUIT. COORDINATE LOCATION AND CONNECTION REQUIREMENTS WITH EQUIPMENT PROVIDED.

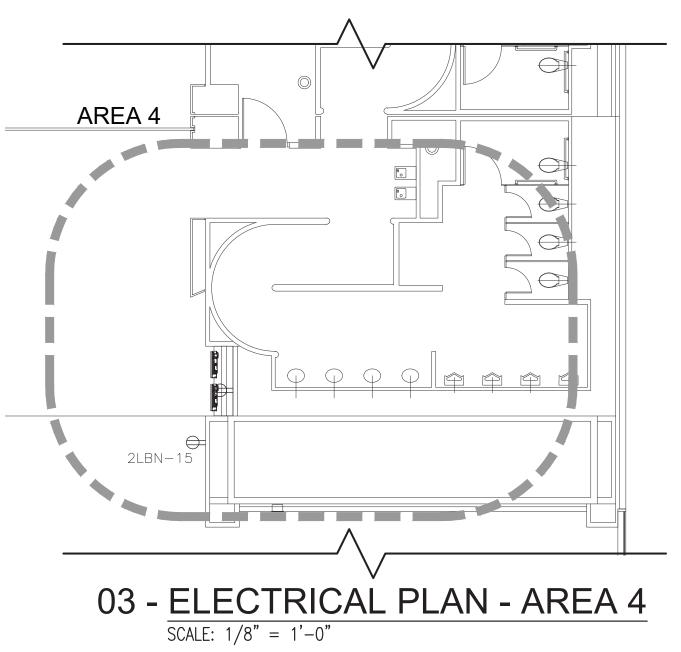

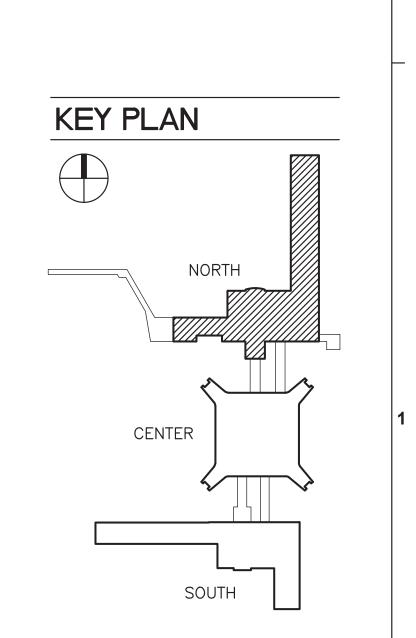

BSG - CODE REVIEW STAMP





2800 N. TERMINAL RD. HOUSTON, TEXAS 77032

HAS TERMINAL A

FIDS & BID LED LIGHTS

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**DESIGNER PROJECT No.:** 21011.05 **PROJECT STATUS:** PHASE TWO

**REVISIONS** No. DESCRIPTION DATE

01/27/2023


PERMIT, BID & CONSTRUCTION

DESIGNER: GB DRAWN BY: SP **CHECKED BY:** GB **ISSUE DATE:** 01-27-2023 **APPROVED BY:** 

> DIRECTOR HOUSTON AIRPORT SYSTEM

APPROVAL DATE:


Approved For Construction

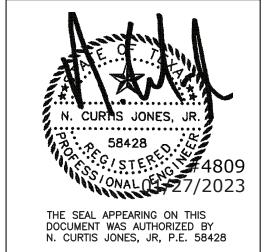

HAS TIP# TBD

ELECTRICAL CONCOURSE LEVEL AREAS 4 & 5 & 6

SCALE: 1/8" = 1'-0"

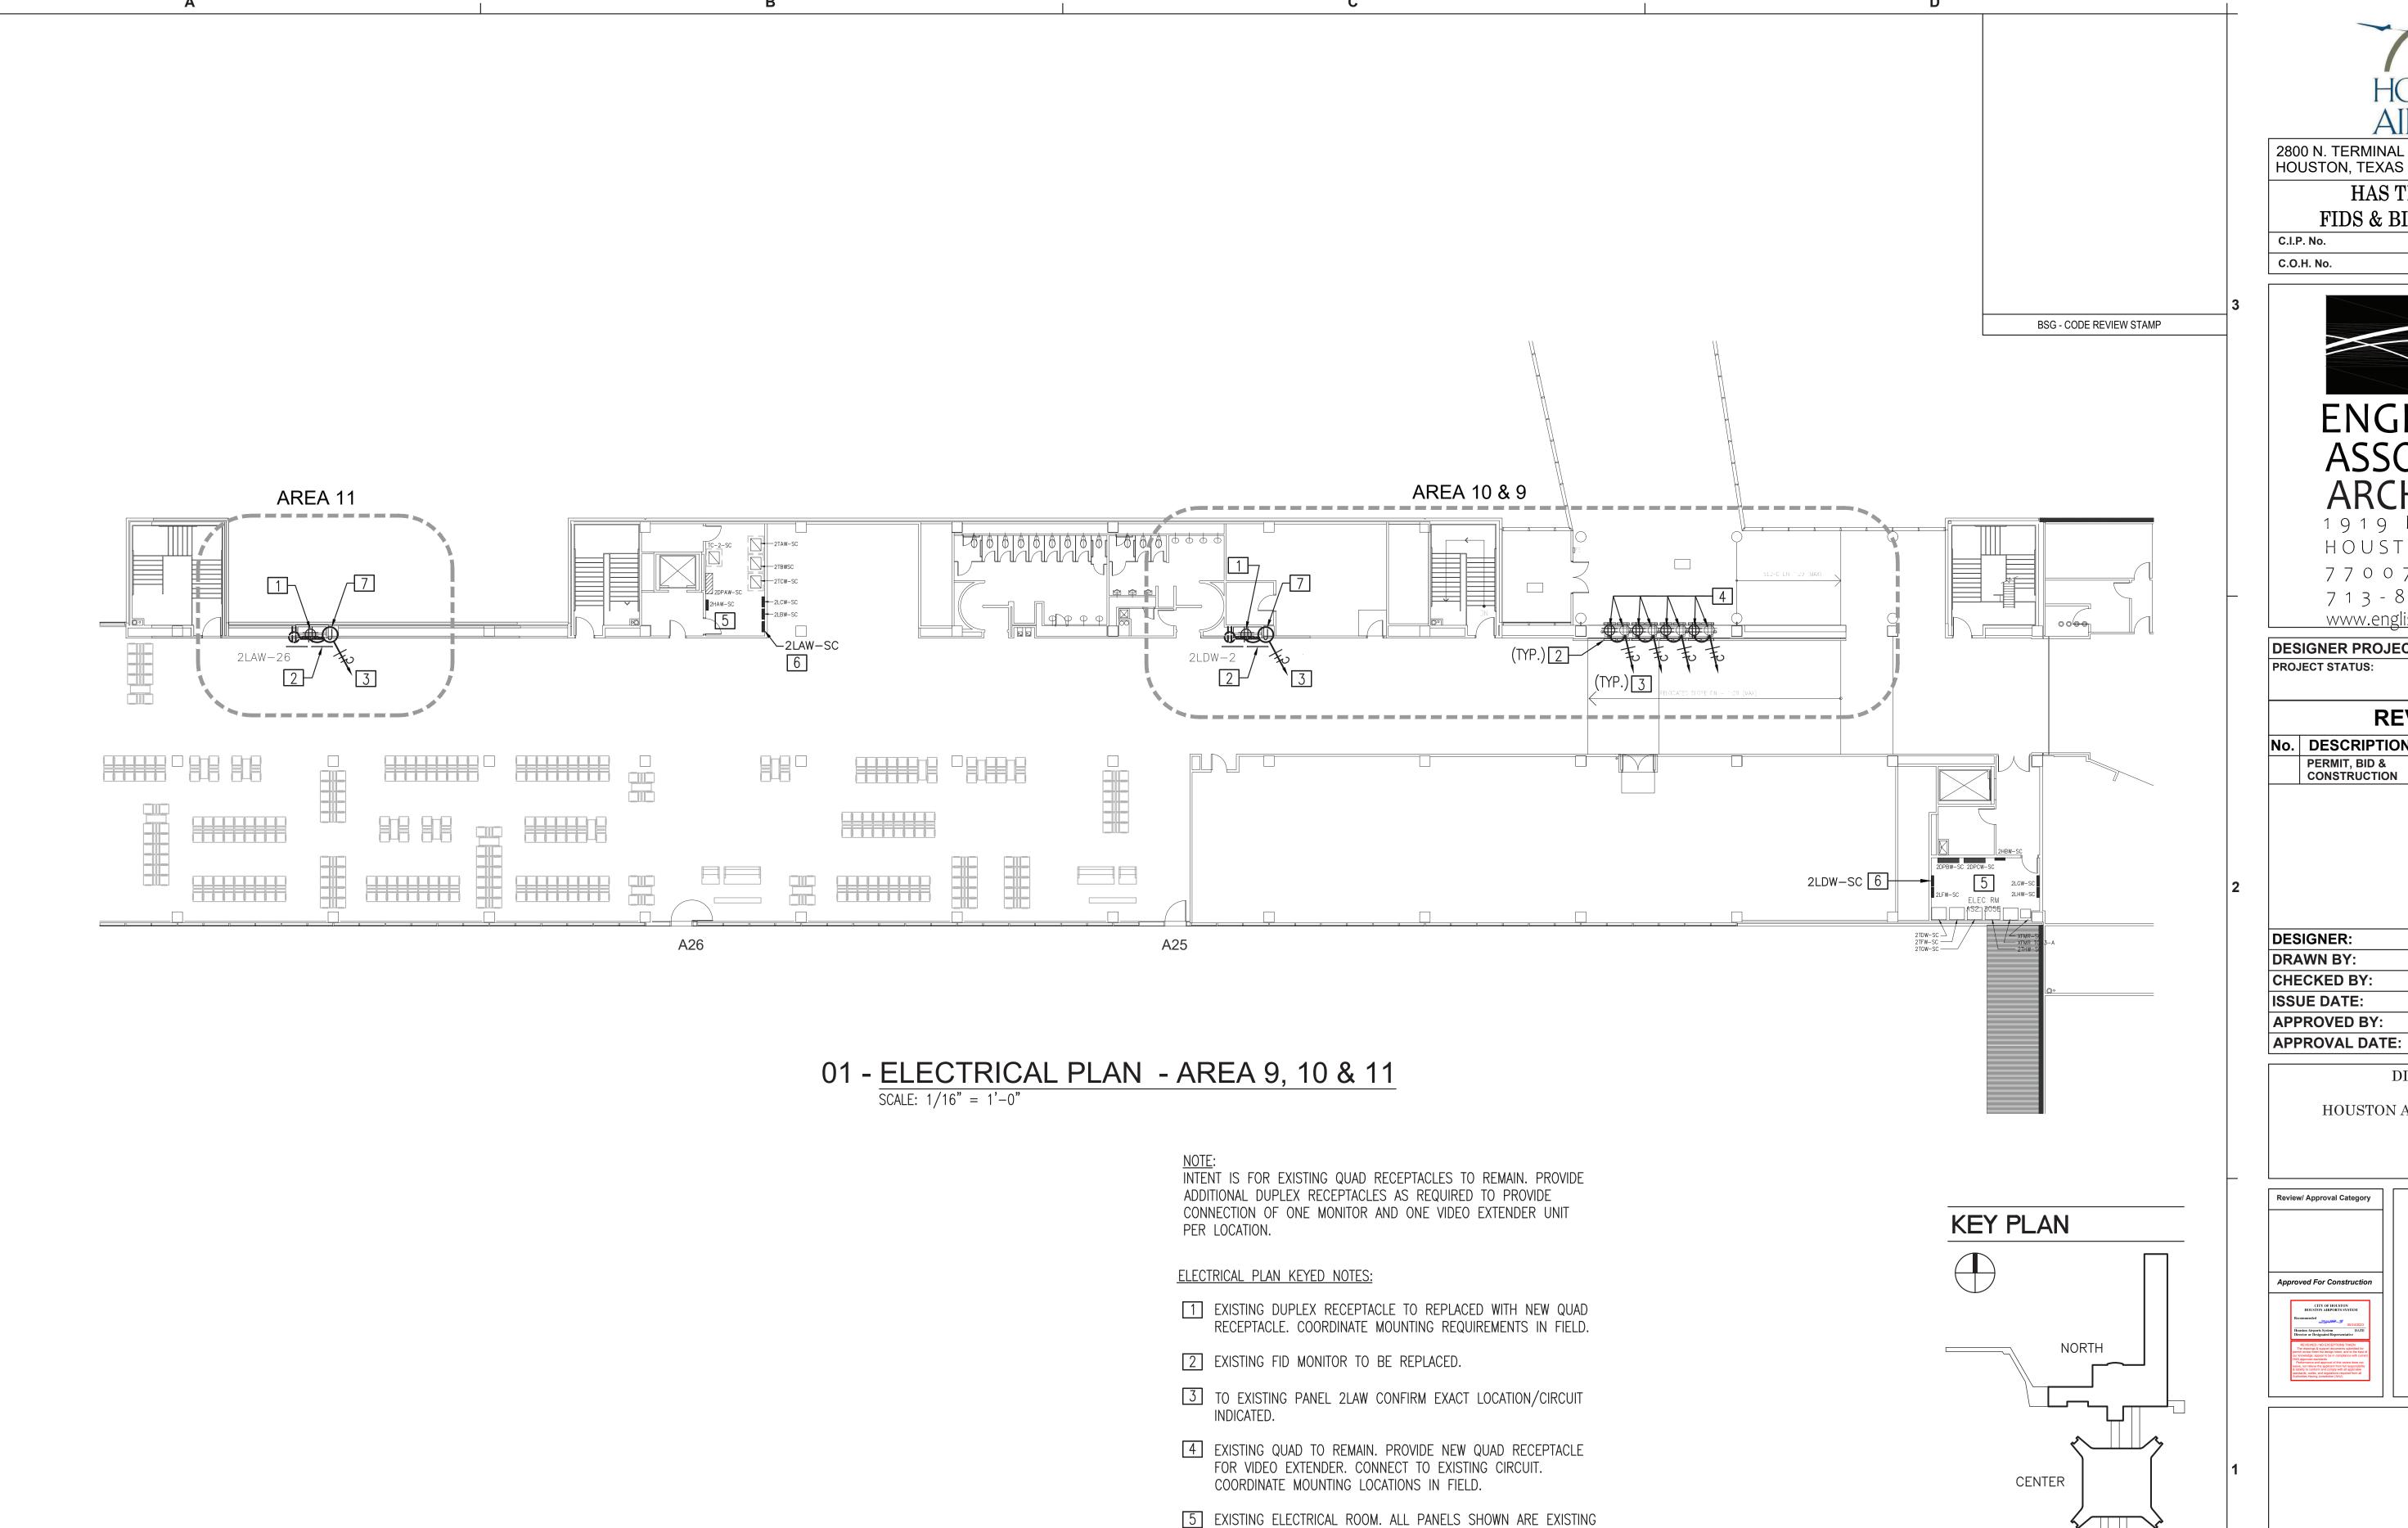



2800 N. TERMINAL RD. HOUSTON, TEXAS 77032

#### HAS TERMINAL A

FIDS & BID LED LIGHTS

A.I.P. No. C.O.H. No. D.O.A No.



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**DESIGNER PROJECT No.:** 21011.05

PHASE TWO


### **REVISIONS**

No.	DESCRIPTION	DATE	BY
	PERMIT, BID & CONSTRUCTION	01/27/2023	

DESIGNER:	GB
DRAWN BY:	SP
CHECKED BY:	GB
ISSUE DATE:	01-27-2023
APPROVED BY:	CJ

DIRECTOR HOUSTON AIRPORT SYSTEM



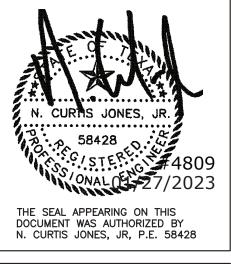

HAS TIP# TBD

ELECTRICAL CONCOURSE LEVEL AREAS 9, 10 & 11

1/16" = 1'-0"

TO REMAIN.

6 EXISTING PANEL 2LAW.

WITH EQUIPMENT PROVIDED.

7 JBOX FOR NEW LED LIGHT BAR CONNECTED TO EXISTING


CIRCUIT. COORDINATE LOCATION AND CONNECTION REQUIREMENTS

HAS FILE: I BIDS Replacemen

- E204 -

Consulting Mechanical/Electrical/Plumbing Engineers 9820 Whithorn Dr. Houston, Texas 77095 (713)222-7766 Texas Registered Engineering Firm #F-3811

SOUTH

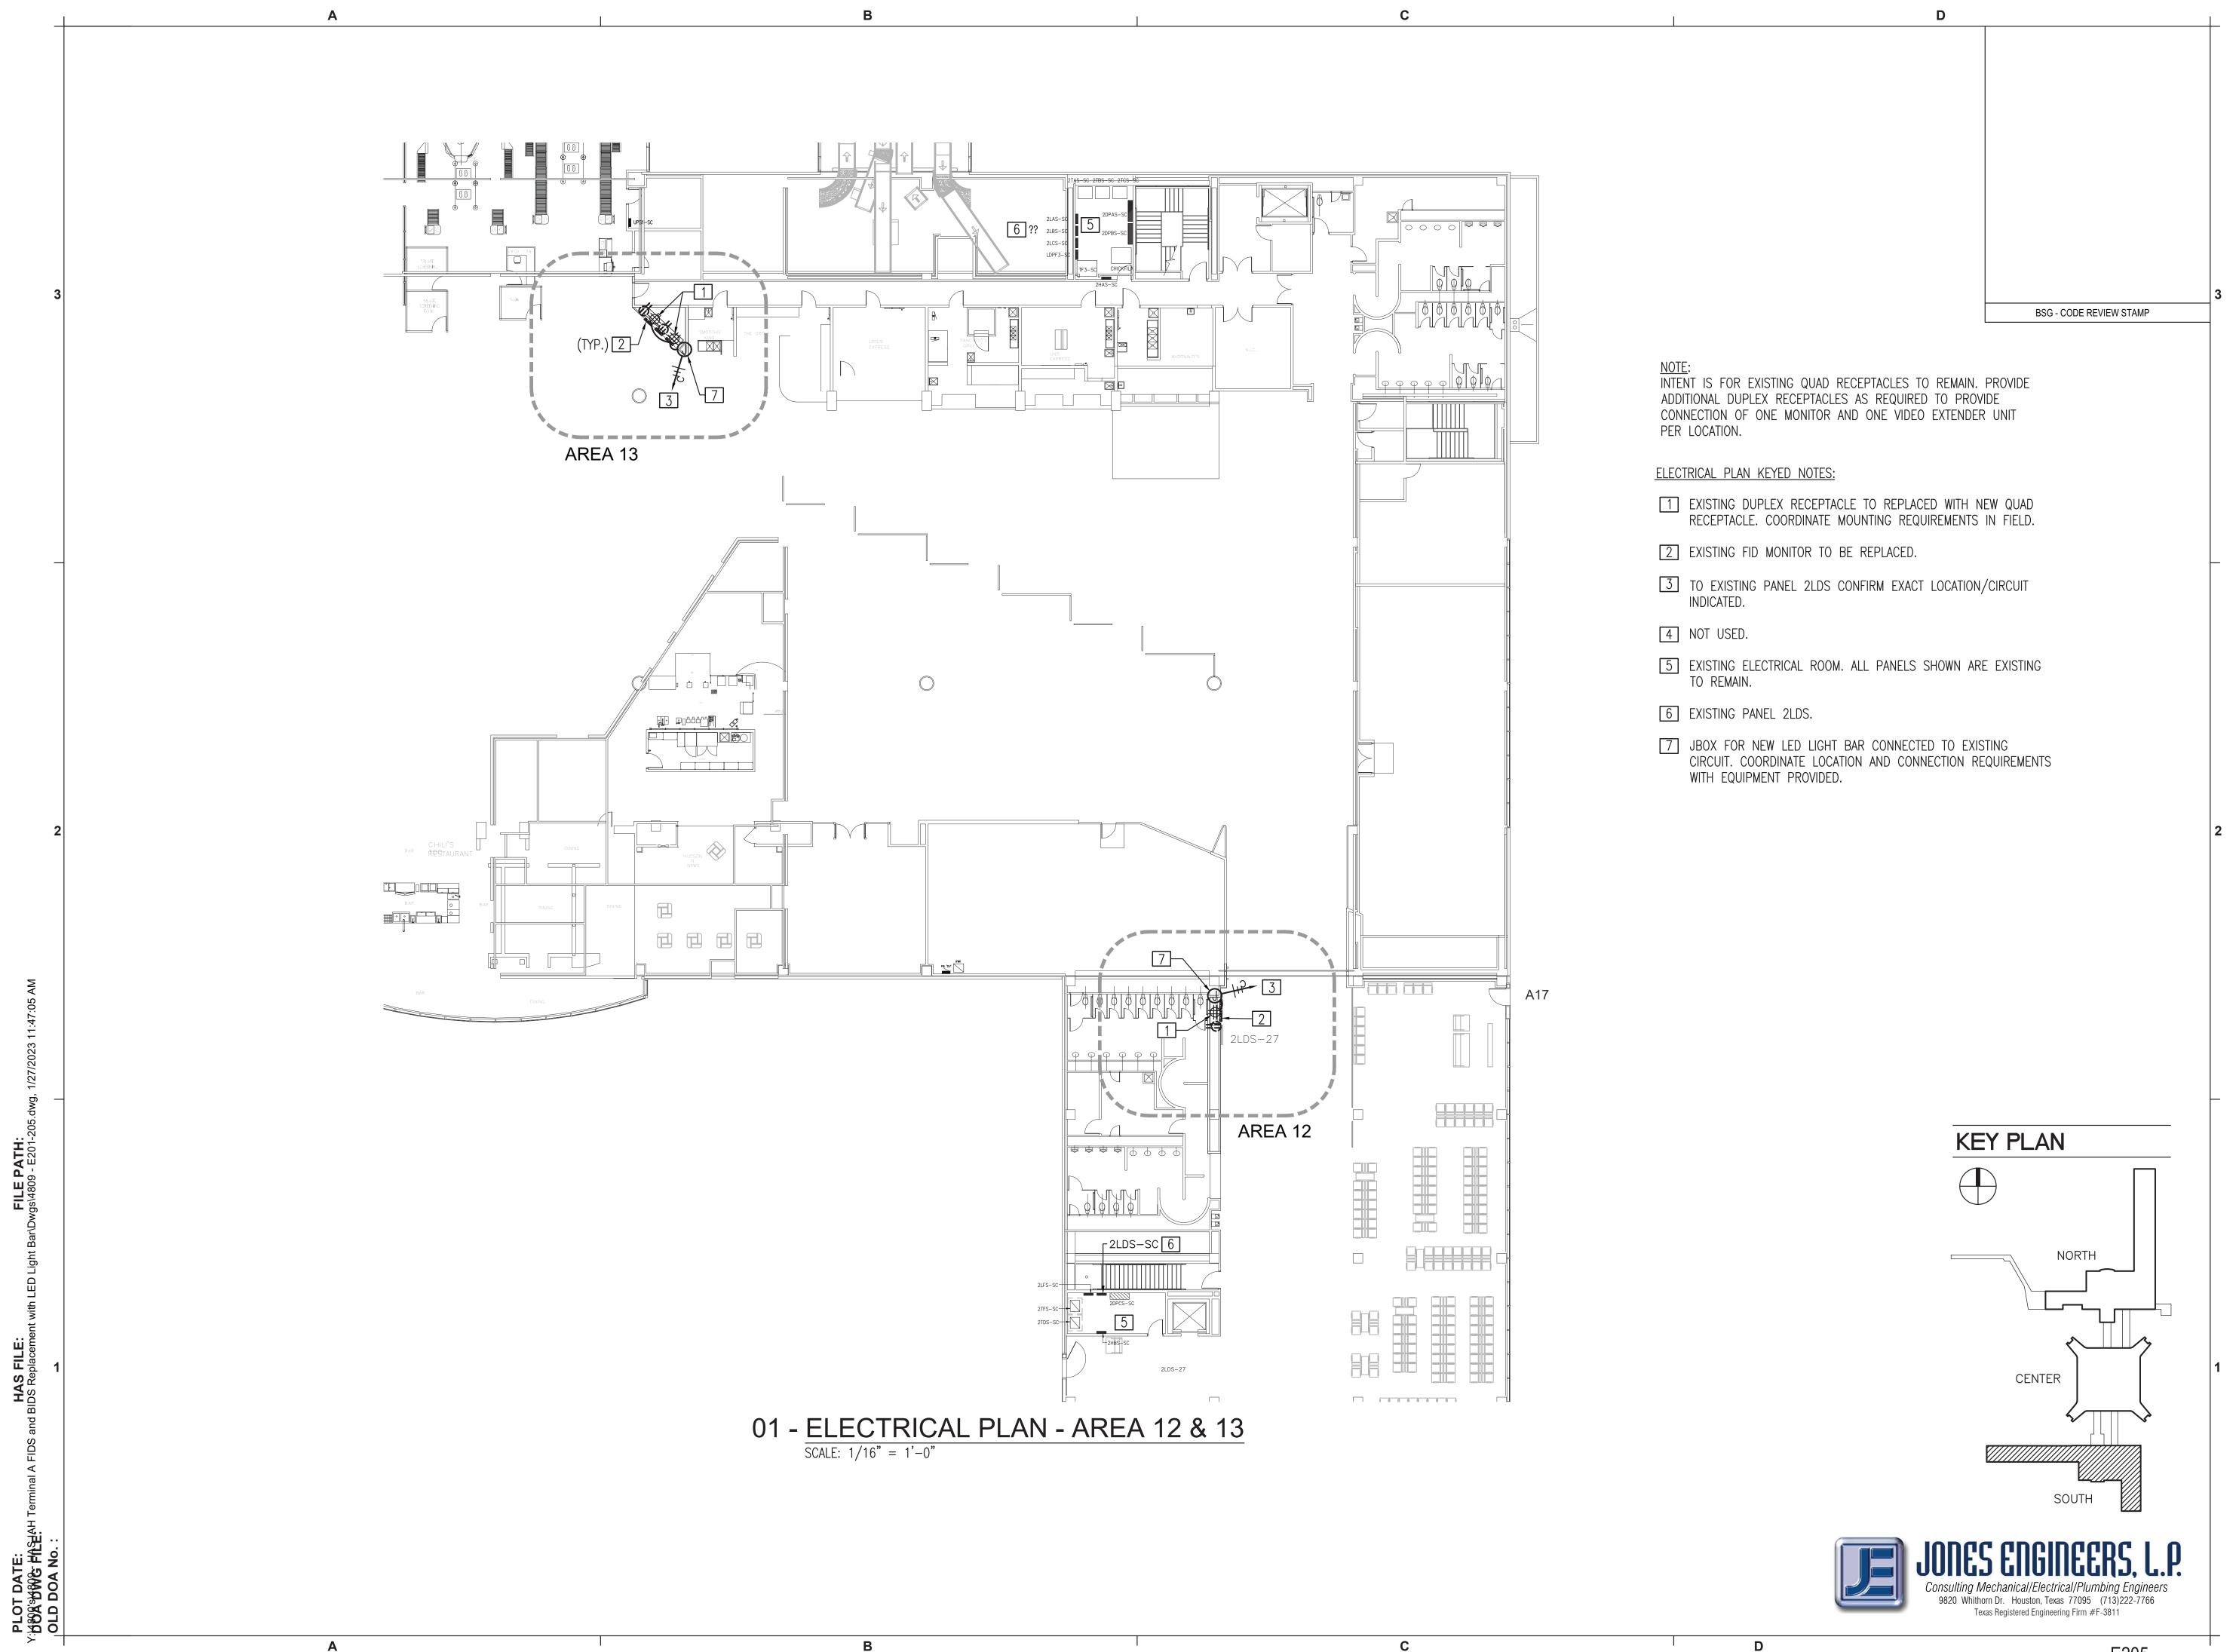

**FILE PATH:** vgs\4809 - E201-205.c

HAS FILE: I BIDS Replacemer



2800 N. TERMINAL RD. HOUSTON, TEXAS 77032

#### HAS TERMINAL A

FIDS & BID LED LIGHTS C.I.P. No. A.I.P. No.





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**DESIGNER PROJECT No.:** 21011.05 PROJECT STATUS:

PHASE TWO

#### **REVISIONS**


No.	DESCRIPTION	DATE	BY
	PERMIT, BID & CONSTRUCTION	01/27/2023	
	CONSTRUCTION		

DESIGNER:	GB
DRAWN BY:	SP
CHECKED BY:	GB
ISSUE DATE:	01-27-2023
APPROVED BY:	CJ

DIRECTOR HOUSTON AIRPORT SYSTEM

APPROVAL DATE:

Approved For Construction

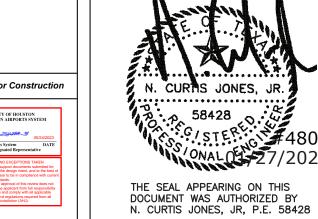

HAS TIP# TBD

ELECTRICAL CONCOURSE LEVEL AREAS 12 & 13

E205 1/16" = 1'-0"

SHEET SIZE: 22"x34" ANSI-D

- E205 -

2. Guarantee labor and materials for 1 year.

3. All new or additional power distribution equipment shall be the same manufacturer as the original building equipment and shall be provided with black, phenolic nameplates with white letters (min. 5/16" ht.). panelboards shall be embossed or engraved metal nameplate to indicate voltage, phase, bussing, and short circuit bracing. supply new, accurate panel directories for each panel board or distribution panel in which any work is performed. Equipment requiring servicing must have GFCI protection per NEC 210.63. Provide new breakers in existing spaces as required for this installation. breakers for abandoned circuits shall be labeled "spares".

4. Reused electrical equipment, wiring devices, siring device cover plated, conduit and wire which are damaged shall be restored to original integrity. all materials used for repairs shall meet original specifications. abandoned electrical, data, or communications elements shall be removed back to original source and returned to landlord. refer to data and telephone contractor for coordination.

5. Any electrical work affecting the lighting on the AOA must be coordinated with IAH electrical department.

6. For all telephones/data outlets, provide an opening, plaster ring, and device plate at normal receptacle height unless otherwise indicated and a pullstring to the accessible ceiling space above. Where the wall is located below an inaccessible ceiling space, provide a 4" square junction box with a single device plaster ring mounted flush with finished wall at normal receptacle height, unless otherwise noted. All telecommunication conduit to be 1" minimum and routed to IDF room and/or to above cable tray with

7. Electrical contractor shall field verify all circuit designations and shall make corrections as needed.

8. All fire alarm system devices and exit signage shall be interfaced with building fire alarm system. All new devices shall be fully compatible with the existing fire alarm system. Fire alarm system contractor shall verify location and quantity of fire alarm system initiating, automatic initiating and audible devices as required by existing building system. Provide additional fire alarm signaling devices as required to insure adequate coverage throughout the lease area. Additional fire alarm devices shall be added to meet building standards and fire alarm system code requirements. All Fire Alarms related work including fire alarm system shutdowns, must be coordinated with Owner.

9. The contractor is responsible for compliance with HAS construction requirements. Work that interferes with existing tenant or building activities may require special time. The electrical contractor shall coordinate special time with building management and include these costs in his bid proposal.

10. All work shall comply with the FAA, Local Building, Plumbing, and Mechanical codes, NFPA 90A, 70 and any other applicable codes. Electrical work must comply with NEC-2020, City Electric Code, and HAS—Electric Standards. Base Building Standards and Specifications shall apply to all work shown on these drawings. If any conflict between any code requirements arises, use the most restrictive

11. All locations of devices are approximate. See architectural drawings for exact

12. Seal new or existing penetrations in of floors, rated partitions, and corridor walls. 13. Secure all permits and provide any required temporary utilities.

14. All work and service interruptions shall be coordinated with the owner such that the work is performed at the owners convenience. This may be during evenings and weekends. 15. Contractor to provide "as-built" drawings indicating the configuration of the constructed work.

16. Repair any damage that occurs to any electrical equipment during demolition. 17. Submit information on all new equipment in the form of shop drawings. Refer to architectural specifications for the correct procedure.

18. Provide 3 copies of the operation and maintenance manuals to the owner. Provide instruction on the system operation to the owner.

19. As per 2020 NEC and all HAS standards All panels, disconnects, transformers shall have phenolic tags stating electrical room, circuit number and voltage with arc flash stickers. Where applicable, all receptacles on tables or bar area shall be GFCI protected. conduits crossing expansion joints shall have expansion fitting per NEC.

20. Wiring — All wiring shall be copper, minimum size #12 AWG, THWN, rated at 600 volts. Provide green grounding conductor with all power and receptacle circuits. All wiring to be in conduit. Lighting fixtures must have individual feeds to each fixture,"daisy chaining" of fixtures is not allowed. Lighting fixture whips must be 6 feet long or less.

NO AC (BX) OR MC CABLE ALLOWED.

**FILE PATH:** gs\4809 - E301-3

HAS IDS Rep

PLOT DATE: BBBSBBB FAREAH I OLD DOA No.:

ALL GROUND RODS TO BE STAINLESS STEEL.

ALL BONDING AND GROUNDING PER 250 OF 2020 NEC AND ALL HAS 2020 STANDARDS. ALL UNUSED CONDUIT AND WIRING OF ANY CRAFT SHALL BE REMOVED BACK TO ITS SOURCE. ALL ELECTRICAL WORK MUST PASS INSPECTION PRIOR TO BACKFILL, CONCRETE PLACEMENT, INSULATION OR COVER(WALL OR CEILING).

#### GENERAL NOTES: (Cont.)

21. Boxes - All boxes to be advanized steel suitable for location and sized per the N.E.C. and supported separately from conduit.

22. Devices: Switches — Single pole, 3—way and 4—way switches to be 20 amp., 120/240 or 277/480 volt as applicable. Mount switches as shown on plan. Switches and device plates shall be white in color, unless noted otherwise. Hubbell #11211 or equal Receptacles - Commercial grade 20 amp., 120v., NEMA 5-20R, Hubbell 52621 or equal. Install receptacles as shown on plan. Receptacles and device plates shall be white in color, unless noted otherwise. Isolated ground receptacles to be orange Hubbell 11211 or equal. Floor box with Brass carpet flange shall be Hubbell B2536 or equal.

23. Conduit - Conduit shall be 3/4" minimum galvanized EMT w/ compression fittings. Support conduit from structure, not to exceed 10' between supports. Do not support from ductwork or piping. Route conduit as directly as possible with large radius bends and installed per N.E.C. Provide U.L. Listed expansion fittings if conduit crosses Expansion or Deflection Joint. Clean conduit interior after installation, coat scratches with zinc paint. Provide pull wire for all empty conduit. Conduit under slab shall be schedule 40 PVC. All conduit shall be concealed in the sales areas. Any conduit passing through the floor shall be rigid galvanized steel conduit. All floor penetrations shall be inspected for fire caulking by BSG electrical inspectors before covering. 24. Conductors:

A. Minimum wire size for branch circuits be No. 12 AWG copper.

a. No. 14 AWG may be used for control circuit wiring when over current protection is provided in compliance with the applicable NEC, NFPA and JIC standards.

b. No. 14 AWG or No. 16 AWG may be used for "fixture whips" for individual fixtures when using individual fuse protection for each fixture.

B. Aluminum wire shall be used only for overhead spans from pole to pole, pole to building, or building to building applications.

C. Stranded wire smaller than No. 8 AWG may be for branch circuits providing:

a. They are connected to wiring devices that utilize clamp type terminations rather than binder head screw connections.

b. They are terminated with spade type lugs for binder head screw connections.

c. They are spliced to solid conductors for binder head screw connections.

D. Stranded conductors shall be used for all motor and control circuit wiring.

E. Conductors feeding computer outlets (or in close proximity to a telecommunications outlet) shall have a neutral one size larger than the phase conductor.

F. Required torque to terminals in breakers 100A and above must be witnessed by HAS/BSG Electrical inspectors.

G. Conduct color coding shall be consistent along the entire length of a circuit. Color coding shall be as follows:

240Y / 120V, 1ø. 3W 480Y / 277V, 3ø, 4W 208Y / 120V, 3ø, 4W AØ – Brown AØ - Black Aø - Black Bø – Purple Bø – Red Cø – Red Cø – Blue N - White Cø – Yellow Grnd - Bare N — Gray N - White Grnd - Bare Grnd - Bare Iso Grnd - Green

Iso Grnd - Green

#### SYMBOL LEGEND

#### SWITCHES

SWITCH, SPST, 20A, 120/277V

SWITCH, 20A, 120/277V, "2" DENOTES DPST, "3" DENOTES THREE-WAY, "OS" DENOTES OCCUPANT SENSOR.

DIMMER CONTROL SWITCH, 1000 WATT UNLESS OTHERWISE

SWITCH, MOTION SENSOR, NOVITAS #01-133

HASH MARKS INDICATE NUMBER OF CONDUCTORS PHASE/NEUTRAL/SWITCH LEG/GROUND FROM LEFT TO RIGHT. NO HASH MARKS INDICATES 2#12, 1#12G, UNLESS OTHERWISE

--- UNDER GROUND CONDUIT

#### RECEPTACLES AND OUTLETS

DUPLEX WALL RECEPTACLE, NEMA 5-15R, 15A, 125V OR NEMA 5-20R, 20A, 125V, RE: SPECIFICATIONS, DOT INDICATES ABOVE COUNTER.

DUPLEX WALL RECEPTACLE. "WP" DENOTES WEATHERPROOF, "TP" DENOTES SAFETY TYPE, "GFI" DENOTES GROUND FAULT PROTECTION. DOT INDICATES ABOVE COUNTER. FOURPLEX WALL RECEPTACLE. NEMA 5-15R. 15A. 125V

DOT INDICATES ABOVE COUNTER. SPECIAL RECEPTACLE, NEMA CONFIGURATION AS NOTED DOT INDICATES ABOVE COUNTER.

FLOOR OUTLET - (X) INDICATES SPECIFIC LAYOUT ON E3.03 JUNCTION BOX - (X) INDICATES SPECIFIC LAYOUT ON E3.03

DIRECT CONNECTION TO EQUIPMENT

TELEPHONE WALL OUTLET. PROVIDE 2"X4" OUTLET BOX. REFER TO IT/TELECOM DRAWINGS FOR EXACT REQUIREMENTS.

DATA WALL OUTLET. PROVIDE 2"X4" OUTLET BOX. REFER TO IT/TELECOM DRAWINGS FOR EXACT REQUIREMENTS.

COMBINATION RECEPTACLE/TELEPHONE/DATA FLOOR OUTLET

FIRE RATED POKE THRU

#### ELECTRICAL EQUIPMENT

DISTRIBUTION PANEL

PLYWOOD TERMINAL BOARD, TYPE AS NOTED, 4' X 8' X 3/4" UNLESS NOTED OTHERWISE

TRANSFORMER

#### MOTORS AND CONTROLS

SINGLE OR THREE PHASE MOTOR

머 DISCONNECT (SAFETY) SWITCH "200/3/150" DENOTES AMPERES/POLE/FUSE, "NF" DENOTES NON-FUSED

MOTOR STARTER

COMBINATION DISCONNECT (SAFETY) SWITCH AND MOTOR STARTER, "30/3/15/#0" DENOTES AMPERES/POLES/FUSE/STARTER SIZE, "NF" DENOTES NON-FUSED.

MANUAL MOTOR STARTING WITH THERMAL OVERLOAD

**AIRPORTS** 

2800 N. TERMINAL RD. HOUSTON, TEXAS 77032

BSG - CODE REVIEW STAMP

HAS TERMINAL A FIDS & BID LED LIGHTS

C.I.P. No. A.I.P. No. C.O.H. No. D.O.A No.



HOUSTON, TEXAS 77007 - 7636 713-850-0400 www.english-architects.com

**DESIGNER PROJECT No.:** 21011.05

**PROJECT STATUS:** 

PHASE TWO

**REVISIONS** 

No. DESCRIPTION BY DATE 01/27/2023 CONSTRUCTION

**DESIGNER:** GB **DRAWN BY:** SP GB **CHECKED BY: ISSUE DATE:** 01-27-2023 **APPROVED BY:** 


> DIRECTOR HOUSTON AIRPORT SYSTEM

Review/ Approval Category

**APPROVAL DATE:** 

Approved For Construction CITY OF HOUSTON HOUSTON AIRPORTS SYSTE

Houston Airports System Director or Designated Representati

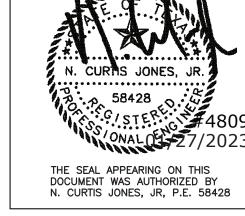

HAS TIP# TBD

**ELECTRICAL ONE-LINES DIAGRAMS NORTH AREA** 


SCALE: E301 NO SCALE

9820 Whithorn Dr. Houston, Texas 77095 (713)222-7766 Texas Registered Engineering Firm #F-3811

Iso Grnd - Green

- E301 -

EXISTING PANEL "2LAW-N" AND FEEDER SCHEDULES SHOWN FOR INFORMATION ONLY.

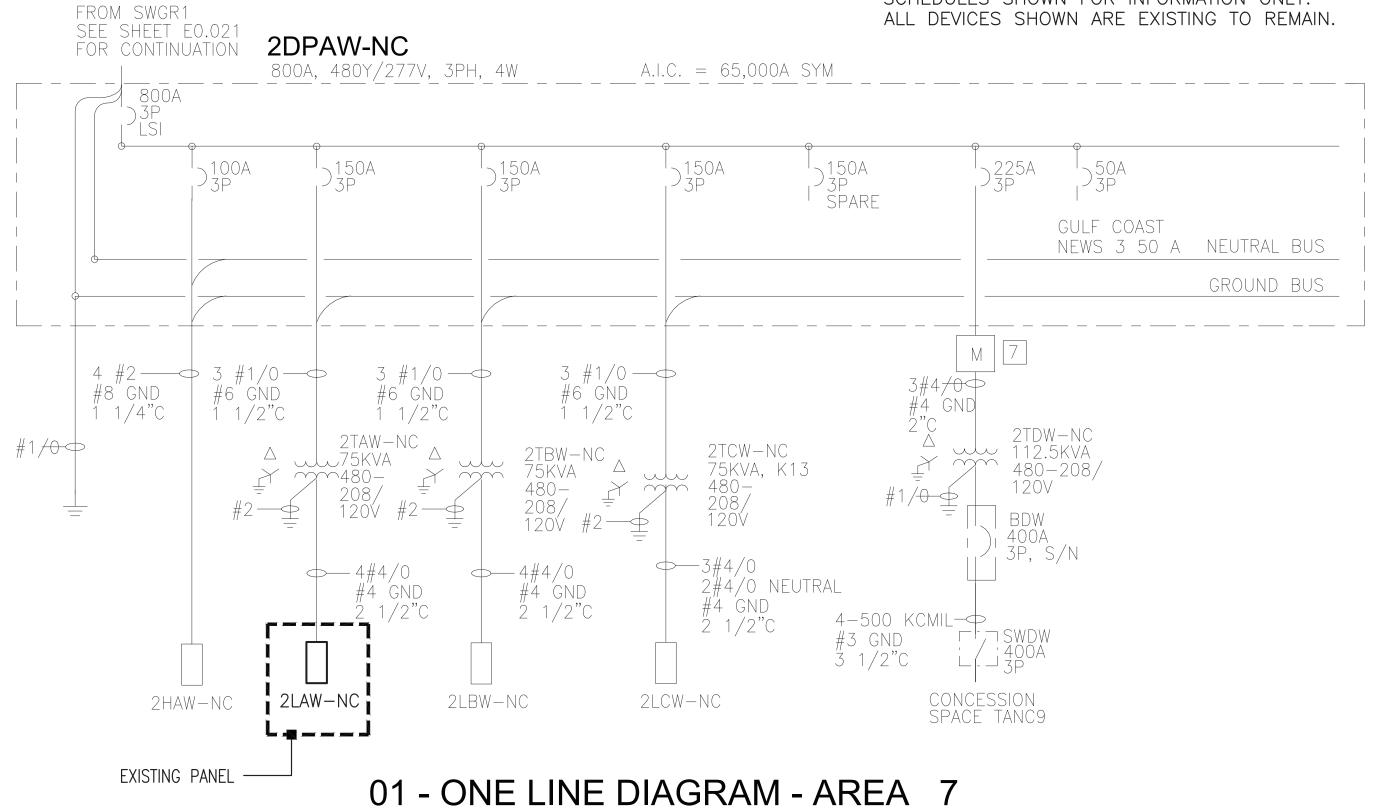

⊏XISIII	ng Panel			Service:		120	)/208	; Volt	s, 3 phase,	, 4 Wire, S	3olid/Ne	utral		
2LAW	-N			Mains:		100	)A M	LO W	// SURGE	PROTEC	TION		Surface Mounted	
Load	Serving	Wire	Cond.(	Breaker	Circuit				Circuit	Breaker	Cond.(	" Wire	Serving	Load
	Backdrop Gate A1			1P-20	1	Α	1		2	1P-20			RCPT Holdroom 201	
	Backdrop Gate A2			1P-20	3	;	В		4	1P-20			RCPT Holdroom 201	
	Ticket STN Gate A1			1P-20	5	,		С	6	1P-20			RCPT Holdroom 201	
	RCPT TV Room 206			1P-20	7	' A			8	1P-20			RCPT Holdroom 201	
	RCPT TV Room 206			1P-20	9	,	В		10	1P-20			RCPT Holdroom 201	
	Ticket STN Gate A2			1P-20	11			С	12	1P-20			RCPT Conc. 207	
	LED Sign Gate A1			1P-20	13	i A			14	1P-20			Spare	
	LED Sign Gate A2			1P-20	15	,	В		16	1P-20			RCPT Rm. 208 & 212	
	FIDS Conc. 233			1P-20	17	1		С	18	1P-20			RCPT Rm. 209	
	FIDS Conc. 233			1P-20	19	A			20	1P-30			RCPT Rm. 213 SEC Area	
	FIDS Conc. 207			1P-20	21		В		22	1P-20			RCPTS Coor. 215	
_	Dimmer Panel			3P-40	23	5	T	С	24	1P-20			RCPT SEC QUE PED Bridge	
	Dimmer Panel				25	5 A			26	1P-20			RCPT Conc. 207	
	Dimmer Panel				27		В		28	1P-20			Spare	
	P/A Cabinet			1P-20	29	į .		С	30				Meter	
	P/A Cabinet				31	Α			32				Space	
	P/A Cabinet				33	5	В		34					
					35	,		С	36					
	UPS 1 Control Circuit					' A			38				JCD Pole TV's	
	Spare				39	i	В		40	3P-15			JCD Pole TV's	
	UPS-1				41			С	42				Space	
0														
	Load Summary (Including S	Sub Par	nels)			]		NO	TE: PAI	NEL IS I	EXSTI	NG TO	REMAIN AND NO NEW	
		Con			Dem				CIRCUI	MENT REVISION ONLY.				
		KW		Factor					oical Circ					
	Lighting	0		1.25				Re	moved M	Ionitors	-	W		
	Rec(10K@100%, rest @50%)	0.0		1.00				Re	moved C	;PU -		(85)w		
	Rec 50%	0.0		0.50	1			Ne	w Monit	tors -				
	Equip	0.0		1.00										
	HVAC	0.0	ı 📗	1.00	0.0	ı]		Ne	w LED E	∃ar-		55w		
	Kitchen	0.0	,	0.65	0.0	4								
	Total KW	0.0	.1		0.00	.1				015011			14W. NO NEW LOAD ADDED	

- NOTE: VERIFY FIDS CIRCUIT IN FIELD. PROVIDE UPDATED PANEL SCHEDULE (TYPED) FOR ANY CIRCUITS THAT DO NOT MATCH EXISTING SCHEDULE.

	REPLACE EXISTING 40A,3P, BREAKER CKTS-38,40,42 WITH NEW 90A, 3P, 480V BREAKER AND CONNECT TO XFMR T2N1 FEEDER.
	3#4, 1#8GND, 1″C
	Δ
	4#1/0, 1#6GND, 1 1/2 "C
	PANEL LANP
EXISTING PANEL -	

NOT TO SCALE

01 - ONE LINE DIAGRAM - AREA 2 NOT TO SCALE

oad Serving Existing Existing F.I.D.S. F.I.D.S.		Wire 	Mains: Breaker 1P-20	Circuit	225	A ML	_0				O of a self of	
Existing Existing F.I.D.S.				Circuit							Surface Mounted	
Existing F.I.D.S.			1P-20					Circuit	Breaker	Wire	Serving Loa	ad
F.I.D.S.			0	1	Α			2	1P-20		Existing	
			1P-20	3		В		4	1P-20	T	Existing	
F.I.D.S.			1P-20	5			С	6	1P-20	<b></b>	Existing	
			1P-20	7	Α			8	1P-20		Existing	
F.I.D.S.			1P-20	9		В		10	1P-20		Existing	
Existing			1P-20	11			С	12	1P-20		Existing	
Existing			1P-20	13	Α			14	1P-20		Existing	
Existing			1P-20	15		В		16			Ticket Counter	
Existing			1P-20	17			С	18	1P-20		Ticket Counter	
Existing			1P-20	19	Α			20	1P-20		Ticket Counter	
Ticket Co	counter		1P-20	21		В		22	1P-20		Ticket Counter	
Ticket Co	counter		1P-20	23			С	24	1P-20		Ticket Counter	
Ticket Co	Counter		1P-20	25	Α			26	1P-20		Ticket Counter	
Ticket Co	counter		1P-20	27		В		28	1P-20		Ticket Counter	
Ticket Co	Counter		1P-20	29			С	30	1P-20		Ticket Counter	
Ticket Co	Counter		1P-20	31	Α			32	1P-20	<b></b>	Ticket Counter	
Ticket Co	ounter		1P-20	33		В		34	1P-20	T	Existing	
Ticket M	lachine		1P-20	35			С	36			Existing	
DDC Co	ontrols on HVAC Unit		1P-20	37				38	1P-20		Existing	
Security	Check Point		1P-20	39		В		40	1P-20		Existing	
Security	Check Point		1P-20	41			С	42	1P-20		Existing	



2800 N. TERMINAL RD. HOUSTON, TEXAS 77032

C.O.H. No.

BSG - CODE REVIEW STAMP

HAS TERMINAL A FIDS & BID LED LIGHTS

C.I.P. No. A.I.P. No.



D.O.A No.

**ARCHITECTS** 1919 DECATUR HOUSTON, TEXAS 77007 - 7636 713-850-0400

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**DESIGNER PROJECT No.:** 21011.05

PROJECT STATUS: PHASE TWO

**REVISIONS** 


BY No. DESCRIPTION DATE PERMIT, BID & CONSTRUCTION 01/27/2023

DESIGNER: GB DRAWN BY: SP GB CHECKED BY: 01-27-2023 **ISSUE DATE: APPROVED BY:** 

> DIRECTOR HOUSTON AIRPORT SYSTEM

**APPROVAL DATE:** 



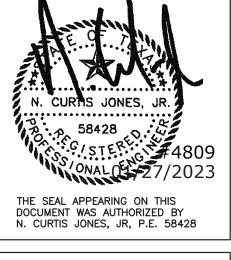

HAS TIP# TBD

**ELECTRICAL ONE-LINES DIAGRAMS** NORTH AREA

NO SCALE

Consulting Mechanical/Electrical/Plumbing Engineers 9820 Whithorn Dr. Houston, Texas 77095 (713)222-7766 Texas Registered Engineering Firm #F-3811

**FILE PATH:** vgs\4809 - E301-307.c

HAS FILE: I BIDS Replacemen

Total KW

0.00 0.00

- E302 -

C

EXISTING PANEL "2LDN" AND FEEDER SCHEDULES SHOWN FOR INFORMATION ONLY. ALL DEVICES SHOWN ARE EXISTING TO REMAIN. 2DPBN-NC 800A, 480Y/277V, 3PH, 4W W/GROUND BUS A.I.C. = 65,000A SYM ) 150A | 3P \150A )150A SPARE NEUTRAL BUS GROUND BUS 4#2 — 1#8 GND 1 1/4"C 3#1/0 — 1#6 GND 3#1/0— 1#6 GND 3#1/0 — 1#6 GND 1" 1/2"C 4#4/0 3#4/0, 1#4 GND 1#4 GND 2#4/0 2" 1/2"C 1/<del>2</del>~+---NËUTRAL 1#4 GND 2 1/2"C 2HBN-NC **2LDN-NC** 2LEN-NC 2LFN-NC

01 - ONE LINE DIAGRAM - AREA 3 NOT TO SCALE

EXISTING PANEL ----

Serving	IAC		Mains:		ZZOI	a vvit	h 200	OA MCB				Surface Mounted	
	Wire	Cond.(	Breaker	Circuit					Breaker	Cond.(	' Wire	Serving	Load
A-11			1P-20	1	Α			2	1P-20			Receptacles	
A-11			1P-20	3		В		4	1P-20			Receptacles	
A-12			1P-20	5			С	6	1P-20			Receptacles	
A-12			1P-20	7	Α			8	1P-20			Bagg. Cart Com.	
A-14 Door			1P-20	9		В		10	1P-20			Receptacles	
A-14 Door			1P-20	11			С	12	1P-20			Receptacles	
A-15			1P-20	13	Α			14	1P-20			Receptacles	
A-15			1P-20	15		В		16	1P-20			Receptacles	
TV			1P-20	17			С	18	1P-20			Receptacles	
TV			1P-20	19	Α			20	1P-20			Receptacles	
ΓV			1P-20	21		В		22	1P-20			Receptacles	
Bagg. Cart Conn.			1P-20	23			С	24	1P-20			A-10	
IDS			1P-20		Α			26	1P-20			Receptacles	
All LED over door			1P-20			В		28	1P-20			Receptacles	
Existing			1P-20				С		1P-20			Receptacles	
ADVPNL			1P-20						1P-20			Receptacles	
Existing			1P-20			В			1P-20			Receptacles	
A-14 Door			1P-20				С					Spare	
Space			1P-20		Α							"	
Space						В			2P-50			Existing	
Spare			1P-20	41			С	42					
	A-12 A-14 Door A-15 A-15 A-15 V V Sagg. Cart Conn. SIDS AILED over door Existing ADVPNL Existing A-14 Door Space	A-12 A-14 Door A-15 A-14 Door Existing A-14 Door Space Space	A-12 A-14 Door A-14 Door A-15 A-15	1-12	1-12	1-12	1-12	1-12	1-12	1-12	1-12	1-12	1-12

New LED Bar -

REMOVED CIRCUIT LOAD - 165W. NO NEW LOAD ADDED.

- NOTE: VERIFY FIDS CIRCUIT IN FIELD. PROVIDE UPDATED PANEL SCHEDULE (TYPED) FOR ANY CIRCUITS THAT DO NOT MATCH EXISTING SCHEDULE.

 0
 1.23
 0

 0.0
 1.00
 0.0

 0.0
 0.50
 0.0

 0.0
 1.00
 0.0

 0.0
 1.00
 0.0

0.0 0.65 0.0

0.0

Equip HVAC

Kitchen

Total KW



2800 N. TERMINAL RD. HOUSTON, TEXAS 77032

BSG - CODE REVIEW STAMP

HAS TERMINAL A

FIDS & BID LED LIGHTS C.I.P. No. A.I.P. No.

C.O.H. No. D.O.A No.



1919 DECATUR HOUSTON, TEXAS 77007 - 7636 713-850-0400

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**DESIGNER PROJECT No.:** 21011.05

PROJECT STATUS: PHASE TWO

**REVISIONS** BY No. DESCRIPTION DATE PERMIT, BID & CONSTRUCTION 01/27/2023

DESIGNER: GB DRAWN BY: SP GB CHECKED BY: 01-27-2023 **ISSUE DATE: APPROVED BY:** 

> DIRECTOR HOUSTON AIRPORT SYSTEM

APPROVAL DATE:

Approved For Construction

THE SEAL APPEARING ON THIS DOCUMENT WAS AUTHORIZED BY N. CURTIS JONES, JR, P.E. 58428

HAS TIP# TBD

**ELECTRICAL ONE-LINES DIAGRAMS NORTH AREA** 

NO SCALE

Consulting Mechanical/Electrical/Plumbing Engineers 9820 Whithorn Dr. Houston, Texas 77095 (713)222-7766 Texas Registered Engineering Firm #F-3811

**FILE PATH:** vgs\4809 - E301-307.c HAS FILE: I BIDS Replaceme

- E303 -

2-3"C EA W/ 4-350KCMIL 1#1 GND EXISTING PANEL "LGNA" AND FEEDER SCHEDULES SHOWN FOR INFORMATION ONLY. ALL DEVICES SHOWN ARE EXISTING TO REMAIN. DPGN-A 600A, 480Y/277V, 3Ø, 4W + GND, 35 KAIC 300A 3 SPARES NEUTRAL GROUND LGN , 400A 3P → 4-350KCMIL 1#1 GND 3"C \$\rightarrow 3#4/0,
1#4 GND,
2"C TGN 112.5KVA 480-208Y/120V Z=5.4% AHU ← 2-2"C EA. W/ 4 - 3/01-#2 GND EXISTING PANEL

**FILE PATH:** vgs\4809 - E301-307.

HAS FILE: I BIDS Replaceme

HGN-A 400A, 480Y/208V, 3Ø, 4W + GND, 35 KAIC NEUTRAL GROUND EXISTING EXISTING LOADS MECHANICAL LOADS HGN1-A A-120E

01 - ONE LINE DIAGRAM - AREA B4, B5, B6 & B7 NOT TO SCALE

Existing Panel 120/208 Volts, 3 phase, 4 Wire, Solid/Neutral LGNA 225A MLO Surface Mounted Wire Cond.(Breaker Circuit Circuit Breaker Cond.(" Wire Serving Load 1P-20 -- Baggage Carts Room A101 1P-20 -- Baggage Carts Room A102 -- 1P-20 -- Baggage Carts Room A103 1P-20 -- Claim Device Monitor Lighting -- -- 1P-20 1P-20 -- Claim Device Monitor Lighting -- Claim Device Monitor -- | -- | 1P-20 | -- -- RCPTS Room A101 1P-20 -- *RCPTS Room A102* Lighting 1P-20 -- -- RCPTS Room A103 -- 1P-20 19 A Lighting -- 1P-20 1P-20 -- -- RCPTS Room A106, A107 Lighting 1P-20 -- -- RCPTS Room A108, A109 Lighting 1P-20 -- -- Baggage Claim, LED -- -- 1P-20 Lighting Budget Plug -- 1P-20 Lighting SWA Kiosk Spare in Box -- 1P-20 1P-20 -- -- Spare 1P-20 -- -- SWA Kiosk Delta Ticket Counter -- -- 1P-20 Delta Ticket Counter Delta Ticket Counter -- -- TVSS Unit Delta Ticket Counter -- -- 1P-20 Load Summary (Including Sub Panels) NOTE: PANEL IS EXSTING TO REMAIN AND NO NEW CIRCUITS ADDED. EQUIPMENT REVISION ONLY. Factor KW Typical Circuit load summary: 1.25 1.00 0.0 0.50 0.0 1.00 0.0 
 Rec(10K@100%, rest @50%)
 0.0

 Rec 50%
 0.0
 Removed Monitors -280w New Monitors -New LED Bar -55w Equip 0.0 1.00 0.0

> NOTE: VERIFY FIDS CIRCUIT IN FIELD. PROVIDE -UPDATED PANEL SCHEDULE (TYPED) FOR ANY CIRCUITS THAT DO NOT MATCH EXISTING SCHEDULE.

REMOVED CIRCUIT LOAD - 165W. NO NEW LOAD ADDED.

Existin	g Panel			Service:	,	120/20	8 Vol	ts, 3 phase	, 4 Wire, S	Solid/Ne	eutral		
UPS-2N	N			Mains:	•	100A V	Vith 40	DA MCB				Surface Mounted	
Load	Serving	Wire	Cond.(	Breaker	Circuit			Circuit	Breaker	Cond.	(" Wire	Serving	Load
200	Ex. IDF			1P-20	1/	A		2	1P-20			Ex. IDF	20
200	Ex. IDF			1P-20	3	В		4	1P-20			Ex. IDF	20
300	Ex. IDF			1P-20	5		С	6	1P-20			Ex.	50
400	PWR Concourse			1P-20	7 /	4		8	1P-20			Ex.	50
400	PWR Concourse			1P-20	9	В		10	1P-20			Ex. IDF 2, Switch / Streamers	20
200	Ex. IDF -FIDS			1P-20	11		С	12	1P-20			Ex. IDF 2, WIFI	10
500	UPS Cabinet			1P-20	13 /	4		14	1P-20			Ex.	50
500	Ex.			1P-20	15	В		16	1P-20			Ex.	50
500	Ex.			1P-20	17		С	18	1P-20			Ex.	50
200	New FIDS CPU	#12	3/4	1P-20	19 /	4		20				SPACE	
300	New FIDS CPU	#12	3/4	1P-20	21	В		22				SPACE	
-	SPACE				23		С	24				SPACE	
	SPACE				25 /	4		26				SPACE	
	SPACE				27	В		28				SPACE	
	SPACE				29		С	30				SPACE	
3700													320
	Load Summary (Including S		neis)	ı	D		EX	ISTING	LOAD:				
		Con		Factor	Dem KW				CON.		DEM.		
	Lighting	0		1.25	5 0		То	tal KW	6.4	1	6.4	4	
	Rec(10K@100%, rest @50%)	5.9		1.00	5.9		An	nps	17.8	}	17.8	3	
	Rec 50%	0.0		0.50	0.0			-					
	Equip	0.0		1.00	0.0								
	NEW LOAD	1.0		1.00	1.0		DI	D NOT E	XCEED	PANE	L CAF	PACITY OF 40 AMPS	
	Kitchen	0.0		0.65	0.0								
	Total KW	6.9			6.90		NE	W PAN	EL TOTA	AL LC	AD		
	Amps	19.2			19.2								

NEW CIRCUIT: PROVIDE NEW 1P/20A BREAKER TO EXISTING PANEL OR UTILIZE EXISTING SPARE, IF AVAILABLE.

0.0

0.0

Kitchen

Amps

Total KW

0.65 0.0



2800 N. TERMINAL RD. HOUSTON, TEXAS 77032 HAS TERMINAL A

BSG - CODE REVIEW STAMP

FIDS & BID LED LIGHTS

C.I.P. No. A.I.P. No. C.O.H. No. D.O.A No.



HOUSTON, TEXAS 77007 - 7636 713-850-0400 www.english-architects.com

**DESIGNER PROJECT No.:** 21011.05 PROJECT STATUS: PHASE TWO

**REVISIONS** BY No. DESCRIPTION DATE PERMIT, BID & CONSTRUCTION 01/27/2023


**DESIGNER:** GB DRAWN BY: SP GB CHECKED BY: 01-27-2023 **ISSUE DATE: APPROVED BY: APPROVAL DATE:** 

> DIRECTOR HOUSTON AIRPORT SYSTEM

Review/ Approval Category

Approved For Construction



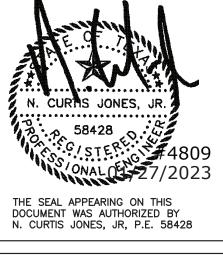

NO SCALE

HAS TIP# TBD

**ELECTRICAL ONE-LINES DIAGRAMS BAGGAGE AREA** 

E304

SHEET SIZE: 22"x34" ANSI-D

9820 Whithorn Dr. Houston, Texas 77095 (713)222-7766

Texas Registered Engineering Firm #F-3811

- E304 -

#### 02 - ONE LINE DIAGRAM - AREA B1, B2 & B3 NOT TO SCALE

	ng Panel			Service:		120	/208	VOI	s, 3 pnase	, 4 Wire, S	olia/ive	u <b>r</b> ai		
_GSA				Mains:		225	A Wi	th 22	25A MCB				Surface Mounted	
.oad	Serving	Wire	Cond.(	Breaker	Circuit				Circuit	Breaker	Cond.(	Wire	Serving	Load
	South Entry Air Curtain			2P-30	1	Α			2	1P-20			Smart Carts #1	
	South Entry Air Curtain	#12	3/4		3		В		4	1P-20	3/4	#12	Smart Carts #3	
	South Entry Electric Doors	#12	3/4	1P-20	5			С	6	1P-20	3/4	#12	Spare	
	United Ticket Counter	#12	3/4	1P-20	7	Α			8	1P-20	3/4	#12	GFI #11	
	United Ticket Counter	#12	3/4	1P-20	9		В		10	1P-20	3/4	#12	GFI #8, #9, #10	
	United Ticket Counter	#12	3/4	1P-20	11			С	12	1P-20	3/4	#12	Smart Carts #2 & #4	
	MUFIDS Ticket Level South	#12	3/4	1P-20	13	Α			14	1P-20	3/4	#12	GFI #7 & Carousel Plug	
	MUFIDS Ticket Level South	#12	3/4	1P-20	15		В		16	1P-20	3/4	#12	GFI #5, #6 Delta	
	MUFIDS Ticket Level South	#12	3/4	1P-20	17			С	18	1P-20	3/4	#12	AA & TWA Baggage	
	MUFIDS Ticket Level South	#12	3/4	1P-20	19	Α			20	1P-20	3/4	#12	SWA BSO Office	
	MUFIDS Ticket Level South	#12	3/4	1P-20	21		В		22	1P-20	3/4	#12	American BSO Office	
	MUFIDS Ticket Level South	#12	3/4	1P-20	23			С	24	1P-20	3/4	#12	SWA BSO Office	
	MUFIDS Ticket Level South	#12	3/4	1P-20	25	Α			26	1P-20	3/4	#12	Carousel #1	
	MUFIDS Ticket Level South	#12	3/4	1P-20	27		В		28	1P-20	3/4	#12	Carousel #2	
	MUFIDS Ticket Level South	#12	3/4	1P-20	29			С	30	1P-20	3/4	#12	Carousel #3	
	MUFIDS Ticket Level South	#12		1P-20	31	Α			32	1P-20		#12	Delta Ticket Counter	
	MUFIDS Ticket Level South	#12		1P-20	33		В		34	1P-20		#12	Delta Ticket Counter	
	MUFIDS Ticket Level South	#12		1P-20	35			С	36	1P-20		#12	United Ticket Counter	
	MUFIDS Ticket Level South	#12		1P-20	37	Α			38	1P-20		#12	Space	
	MUFIDS Ticket Level South	#12		1P-20	39		В		40	1P-20		#12	Space	
	MUFIDS Ticket Level South	#12		1P-20	41			С	42	1P-20		#12	Space	
)	Load Summary (Including S		nels)	11 -20	Dem	]	<u> </u>		TE: PA	NEL IS I	EXSTI	NG TC	REMAIN AND NO NEW MENT REVISION ONLY.	
		KW		Factor	kw			Туі	oical Cir	cuit load	sumn	nary:		
	Lighting	0		1.25	0	1								
	Rec(10K@100%, rest @50%)	0.0		1.00	0.0	1		Re	moved N	/lonitors	-	(500)v	v	
	Rec 50%	0.0		0.50	0.0	1		Ne	w Moni	tors -		280w		
	Equip	0.0		1.00					w LED E			55w		
	HVAC	0.0		1.00	0.0	1								
	Kitchen	0.0		0.65				RE	MOVED	CIRCU	T LO	AD - 16	55W. NO NEW LOAD ADDED	).
	Total KW	0.0			0.00	1								
	Amps	0.0			0.0									

NOTE: VERIFY FIDS CIRCUIT IN FIELD. PROVIDE -

EXISTING SCHEDULE.

UPDATED PANEL SCHEDULE (TYPED) FOR ANY CIRCUITS THAT DO NOT MATCH

Existii	ng Panel			Service:		120	/208	Volts	s, 3 phase	, 4 Wire, 9	Solid/Ne	utral		
UPS-2	S			Mains:		100	A Wit	th 40	A MCB				Surface Mounted	
Load	Serving	Wire	Cond.	Breaker	Circuit				Circuit	Breaker	Cond.	" Wire	Serving	Load
200	Ex. IDF 4			1P-20	1	Α			2	1P-20			Ex. IDF 2	200
200	Ex. IDF 4			1P-20	3		В		4	1P-20	T		Ex. IDF 2	200
300	Ex. IDF 4			1P-20	5			С	6	1P-20	T		Ex. IDF 2	200
400	PWR Concourse			1P-20	7	Α			8	1P-20			Ex. IDF 2	200
400	PWR Concourse			1P-20	9		В		10	1P-20	T		Ex. IDF 2, Switch / Streamers	200
200	Ex. IDF 2 -FIDS			1P-20	11			С	12	1P-20	T		Ex. IDF 2, WIFI	100
500	UPS Cabinet			1P-20	13	Α			14	1P-20	3/4	#12	New FIDS CPU	300
500	Ex.			1P-20	15		В		16	1P-20	3/4	#12	New FIDS CPU	200
500	Ex.			1P-20	17			С	18	1P-20			Ex.	500
	SPACE				19	Α			20				SPACE	
	SPACE	0			21		В		22				SPACE	
	SPACE				23			С	24				SPACE	
	SPACE				25	Α			26				SPACE	
	SPACE				27		В		28				SPACE	
	SPACE				29			С	30				SPACE	
3200	Load Summary (Including S	Sub Pa	nels)		Dem	]		EX	ISTING	LOAD:				2100
		KW		Factor						CON.		DEM.		
	Lighting	0	1	1.25		1		Tot	al KW	4.8	3	4.8		
	Rec(10K@100%, rest @50%)	4.8		1.00				Am		13.3		13.3		
	Rec 50%	0.0		0.50										
	Equip	0.0		1.00										
	NEW LOAD	0.5		1.00		4		DIE	NOT E	XCEED	PANE	L CAF	ACITY OF 40 AMPS	
	Kitchen	0.0		0.65						<del>-</del>				
	Total KW	5.3			5.30			NE	W PANI	EL TOTA	AL LC	AD		
	Amps	14.7			14.7									

NEW CIRCUIT: PROVIDE NEW 1P/20A BREAKER -TO EXISTING PANEL OR UTILIZE EXISTING SPARE, IF AVAILABLE.



2800 N. TERMINAL RD. HOUSTON, TEXAS 77032

C.O.H. No.

BSG - CODE REVIEW STAMP

#### HAS TERMINAL A

FIDS & BID LED LIGHTS C.I.P. No. A.I.P. No.

D.O.A No.



1919 DECATUR HOUSTON, TEXAS 77007 - 7636 713-850-0400 www.english-architects.com

**DESIGNER PROJECT No.:** 21011.05 PROJECT STATUS: PHASE TWO

### **REVISIONS**

No.	DESCRIPTION	DATE	BY
	PERMIT, BID & CONSTRUCTION	01/27/2023	


DESIGNER:	GB
DRAWN BY:	SP
CHECKED BY:	GB
ISSUE DATE:	01-27-2023
APPROVED BY:	CJ

DIRECTOR HOUSTON AIRPORT SYSTEM

Review/ Approval Category

APPROVAL DATE:



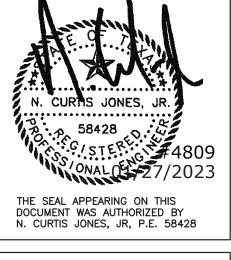

HAS TIP# TBD

**ELECTRICAL ONE-LINES DIAGRAMS BAGGAGE AREA** 

> SCALE: E305 NO SCALE


**FILE PATH:** vgs\4809 - E301-307.c HAS FILE: I BIDS Replacemer

C

- E305 -

EXISTING PANEL "2LDW" AND FEEDER SCHEDULES SHOWN FOR INFORMATION ONLY.

ALL DEVICES SHOWN ARE EXISTING TO REMAIN.

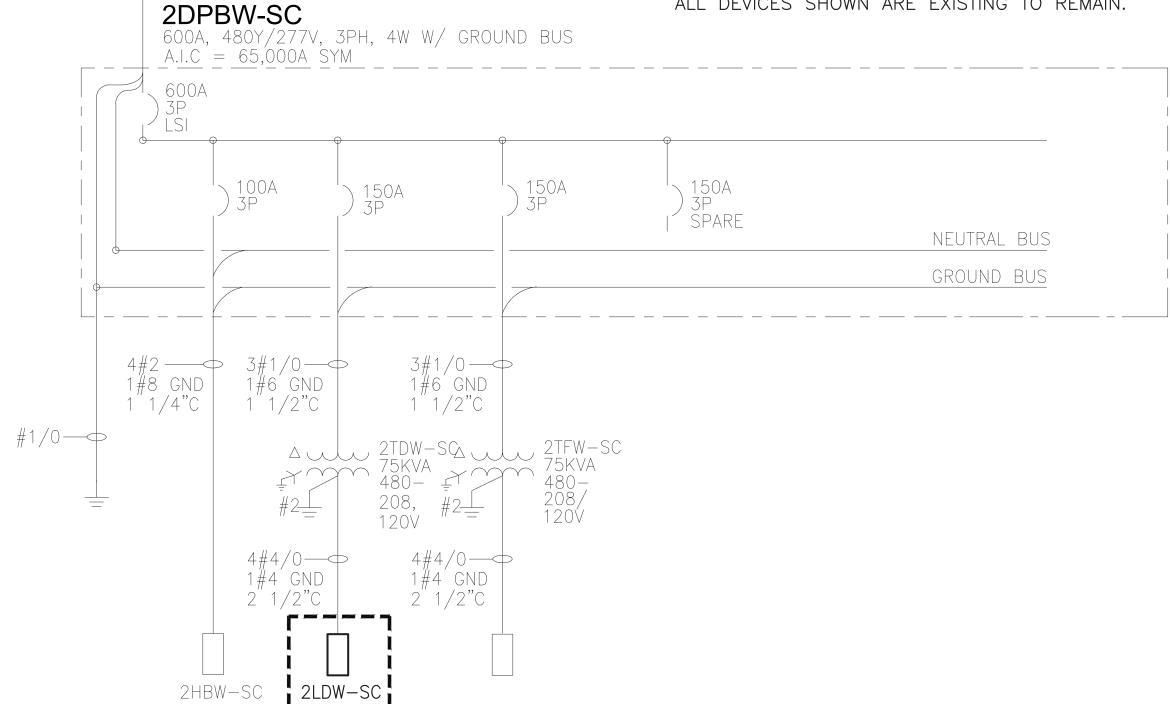

_DW				Mains:		225	A ML	-0					Surface Mounted	
oad	Serving	Wire	Cond.(	Breaker	Circuit				Circuit	Breaker	Cond. (	Wire	Serving	Load
	RCPT Rm 214			1P-20	1	Α			2	1P-20			FIDS Area 207	
	Spare			1P-20	3		В		4	1P-20			Spare	
	"			1P-20	5			С	6	1P-20			FA Remote Trans Rm 213	
	RCPT Rm 212			1P-20	7	Α			8	1P-20			Spare	
	RCPT Rm Area 215			1P-20	9		В		10	1P-20			Spare	
	RCPT Rm 220, 217, 219			1P-20	11			С	12	1P-20			RCPT Pass Connector	
	RCPT Rm 211			1P-20	13	Α			14	1P-20			RCPT Pass Connector	
	RCPT Rm 221-222 & CK Point			1P-20	15		В		16	1P-20			Spare	
	HVAC Controls			1P-20	17			С	18	1P-20			Spare	
	HVAC Controls			1P-20	19	Α			20	1P-20			Overhead Gate Motor Zone 3	
	HVAC Controls			1P-20	21		В		22	1P-20			Overhead Gate Motor Zone 6	
	HVAC Controls			1P-20	23			С	24	1P-20			Kiosk Rm 250	
	HVAC Controls			1P-20	25				26	1P-20			Kiosk Rm 250	
	HVAC Controls			1P-20	27		В		28	1P-20			Spare	
	HVAC Controls			1P-20	29			С	30	1P-20			Spare	
	HVAC Controls			1P-20	31				32	1P-20			Spare	
	Spare			1P-20	33		В		34	1P-20			Spare	
	Spare			1P-20	35			С	36	1P-20			Plumb Fixt Rm 212	
	Spare			1P-20	37	Α			38				Space	
	Spare			1P-20	39		В		40				Space	
	Spare			1P-20	41			С	42				Space	

Factor KW Lighting 0

Rec(10K@100%, rest @50%) 0.0 0.50 0.0 1.00 0.0 1.00 0.0 0.0 0.0 0.0 Kitchen Total KW 0.0

C

CIRCUITS ADDED. EQUIPMENT REVISION ONLY. Typical Circuit load summary:

Removed Monitors - (500)w New Monitors -280w New LED Bar -

REMOVED CIRCUIT LOAD - 165W. NO NEW LOAD ADDED.

NOTE: VERIFY FIDS CIRCUIT IN FIELD. PROVIDE -UPDATED PANEL SCHEDULE (TYPED) FOR ANY CIRCUITS THAT DO NOT MATCH EXISTING SCHEDULE.

01 - ONE LINE DIAGRAM - AREA 9 NOT TO SCALE


EXISTING PANEL ----

**FILE PATH:** vgs\4809 - E301-307.

HAS FILE: BIDS Replaceme

PLOT DATE: Y:1688868 FAREAH Ten OLD DOA No.:

EXISTING PANEL "2LDS" AND FEEDER SCHEDULES SHOWN FOR INFORMATION ONLY. ALL DEVICES SHOWN ARE EXISTING TO REMAIN.

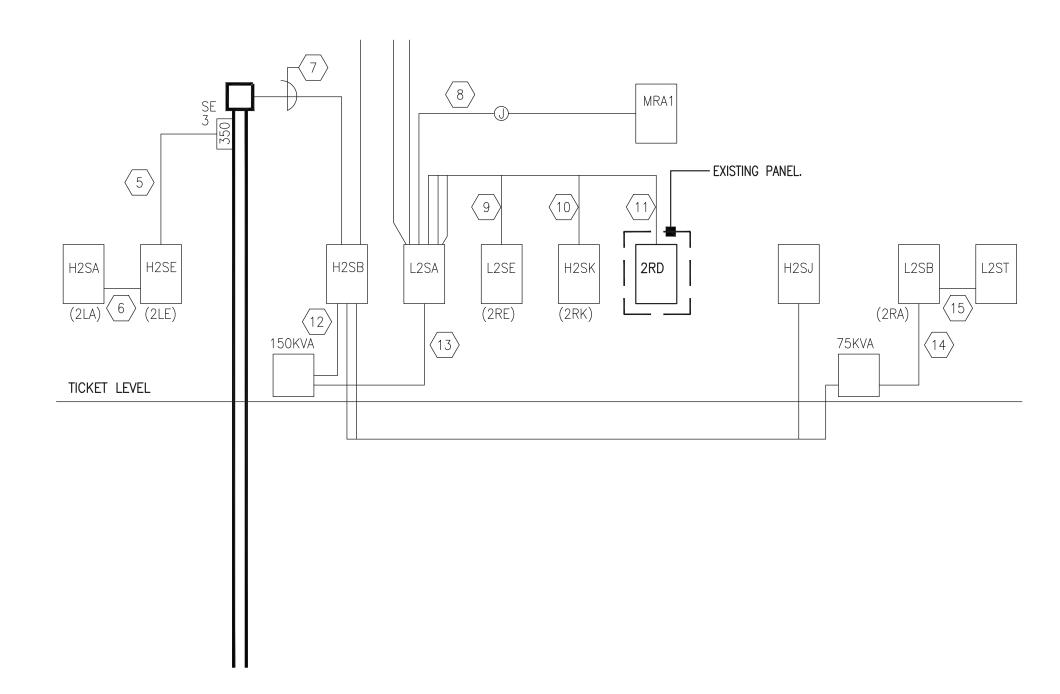

01 -	ONE LINE DIAGRAM - AREA	1
	NOT TO SCALE	

Existir	ng Panel		Service:		120	/208	Volts	s, 3 phase	, 4 Wire, S	Solid/Ne	utral	
2RD			Mains:		225	ia Ml	LO				Surface Mounted	
₋oad	Serving	Wire	Breaker	Circuit				Circuit	Breaker	Wire	Serving	Load
	Existing		1P-20	1	Α			2	1P-20		Existing	
	Existing		1P-20	3		В		4	1P-20		Existing	
	Existing		1P-20	5			С	6	1P-20		Existing	
	Existing		1P-20	7	Α			8	1P-20		F.I.D.S.	
	Existing		1P-20	9		В		10	1P-20		F.I.D.S.	
	Existing		1P-20	11			С	12	1P-20		F.I.D.S.	
	Existing		1P-20	13	Α			14	1P-20		Secure Corr. Conv. Receptacle	
	Existing		1P-20	15		В		16	1P-20		Ticket Counter	
	Existing		1P-20	17			С	18	1P-20		Ticket Counter	
	Existing		1P-20	19	Α			20	1P-20		Ticket Counter	
	Ticket Counter		1P-20	21		В		22	1P-20		Ticket Counter	
	Ticket Counter		1P-20	23			С	24	1P-20		Ticket Counter	
	Ticket Counter		1P-20	25	Α			26	1P-20		Ticket Counter	
	Ticket Counter		1P-20	27		В		28	1P-20		Ticket Counter	
	Ticket Counter		1P-20	29			С	30	1P-20		Ticket Counter	
	Ticket Counter		1P-20	31	Α			32	1P-20		Ticket Counter	
	Ticket Counter		1P-20	33		В		34	1P-20		Existing	
	Ticket Machine		1P-20	35			С	36	1P-20		Existing	
	DDC Controls on HVAC Unit		1P-20	37	Α			38	1P-20		Existing	
	Security Check Point		1P-20	39		В		40	1P-20		Existing	
	Security Check Point		1P-20	41			С	42	1P-20		Existing	
	0				1		. T.E.	DANIEL	10 540	TIMO		
	Load Summary (Including S	Con	neis)	Dem		NO					TO REMAIN AND NO NEW PMENT REVISION ONLY.	
		1	Factor			Tur						
	Lighting	0.00				<u> 1 y k</u>	JiCal	Circuit	load sur	mmary	<u>.</u>	
		0.00				Do:	ma\	ed Moni	tors	(500)	A.	
	Rec(10K@100%, rest @50%) Rec 50%	0.00			ı			ea Moni Ionitors		280w		
		0.00			l			ionitors ED Bar -		280W 55W		
	Equip HVAC	0.00			ı	146/	VV LE	- ואם ט		บบพ		
	Kitchen	0.00			ı	DE	MO	VED CIE	CHIT		165W. NO NEW LOAD ADDE	ED
						ΚĽ	IVIO		COII L	.UAD -	105VV. NO NEVV LOAD ADDE	LD.
	Total KW	0.00		0.00	ı							



- E306 -

D.O.A No.

2800 N. TERMINAL RD. HOUSTON, TEXAS 77032

C.O.H. No.

BSG - CODE REVIEW STAMP

HAS TERMINAL A

FIDS & BID LED LIGHTS C.I.P. No. A.I.P. No.



HOUSTON, TEXAS 77007 - 7636 713-850-0400

www.english-architects.com

PROJECT STATUS: PHASE TWO

**DESIGNER PROJECT No.:** 21011.05

**REVISIONS** 


BY No. DESCRIPTION DATE PERMIT, BID & CONSTRUCTION 01/27/2023

DESIGNER: GB DRAWN BY: SP GB CHECKED BY: **ISSUE DATE:** 01-27-2023 **APPROVED BY:** 

> DIRECTOR HOUSTON AIRPORT SYSTEM

APPROVAL DATE:



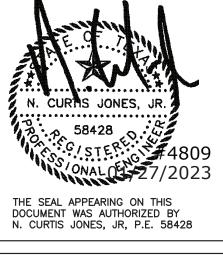

NO SCALE

HAS TIP# TBD

**ELECTRICAL ONE-LINES DIAGRAMS** SOUTH AREA

2DPAW-SC

EXISTING PANEL ----

600A, 480Y/277V, 3PH, 4W W/GROUND BUS

EXISTING PANEL "2LAW-S" AND FEEDER SCHEDULES SHOWN FOR INFORMATION ONLY. ALL DEVICES SHOWN ARE EXISTING TO REMAIN.

150A 3P SPARE 150A ) 3P NEUTRAL BUS GROUND BUS 4#2 3#1/0 1#8 GND 1#6 GND 1 1/4"C 1 1/2"C 3#1/0-0 1#6 GND 1 1/2"C 3#2 — 1#8 GND 1 1/4"C #1/0-1#4 GND, 2 1/2"C 2HAW-SC 2LAW-SC

A.I.C = 65,000A SYM

01 - ONE LINE DIAGRAM - (2DPAW-SOUTH) NOT TO SCALE

LAW.	-8			Mains:		225	A ML	-0					Surface Mounted	
oad	Serving	Wire	Cond.(	Breaker	Circuit				Circuit	Breaker	Cond.(	Wire	Serving	Load
	RCPT. Area 201			1P-20	1	Α			2	1P-20			Spare	
	RCPT. Area 202, 203			1P-20	3		В		4	1P-20			Spare	
	RCPT. Area 202, 203			1P-20	5			С	6	1P-20			RCPT Backdrip Area 202	
	RCPT. Area 205			1P-20	7	Α			8	1P-20			Ticket Lift Station	
	RCPT. Area 206			1P-20	9		В		10	1P-20			Ticket Lift Station	
	RCPT. Area 206			1P-20	11			С	12	1P-20			Ticket Lift Station	
	RCPT. Area 211			1P-20	13	Α			14	1P-20			Ticket Lift Station	
	RCPT. Area 207			1P-20	15		В		16	1P-20			Ticket Lift Station	
	RCPT. Area 208			1P-20	17			С	18	1P-20			TV Sets	
	HVAC Controls			1P-20	19	Α			20	1P-20			HVAC Controls	
	HVAC Controls			1P-20	21		В		22	1P-20			HVAC Controls	
	HVAC Controls			1P-20	23			С	24	1P-20			HVAC Controls	
	Lavatory Rm. 211 & 212			1P-20	25	Α			26	1P-20			FIDS Area 205	-
	Auto Air Fresh Rm. 211 & 212			1P-20	27		В		28	1P-20			Lockers Area 205	
	RCPT. Backdrops Area 207			1P-20	29			С	30	1P-20			TV Sets	
	Spare			1P-20	31	Α			32	1P-20			TV Sets	
	Spare			1P-20	33		В		34	1P-20			Baggage Carts	
	Spare			1P-20	35			С	36	1P-20			Plumb Fixt Rm 211	
	Spare			1P-20	37				38	1P-20		-	Spare	(
	EDF West			1P-20	39		В		40	1P-20			Spare	(
	Spare			1P-20	41			С	42	1P-20			Amer. Airline AS1.314.12 MicWave	
	Load Summary (Including S	Sub Pa Con KW	nels)	Factor	Dem KW				CIRCU		DED. E	QUIPI	REMAIN AND NO NEW MENT REVISION ONLY.	1
	Lighting	0		1.25				<u>.,,,,,,,,,,,,,,,,,,,,,,,,,,,,,,,,,,,,</u>				<u> , .</u>		
	Rec(10K@100%, rest @50%)	0.0		1.00				Rer	noved M	onitors	_	(500)	v	
	Rec 50%	0.0		0.50								280w	-	
	Equip	0.0		1.00								55w		

0.65 0.0

NOTE: VERIFY FIDS CIRCUIT IN FIELD. PROVIDE -UPDATED PANEL SCHEDULE (TYPED) FOR ANY CIRCUITS THAT DO NOT MATCH EXISTING SCHEDULE.

REMOVED CIRCUIT LOAD - 165W. NO NEW LOAD ADDED.



2800 N. TERMINAL RD. HOUSTON, TEXAS 77032

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#### HAS TERMINAL A FIDS & BID LED LIGHTS

A.I.P. No. C.I.P. No. C.O.H. No. D.O.A No.



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**DESIGNER PROJECT No.:** 21011.05 PROJECT STATUS: PHASE TWO

### **REVISIONS**


No. DESCRIPTION	DATE	BY
PERMIT, BID & CONSTRUCTION	01/27/2023	

DESIGNER:	GB
DRAWN BY:	SP
CHECKED BY:	GB
ISSUE DATE:	01-27-2023
APPROVED BY:	CJ

DIRECTOR HOUSTON AIRPORT SYSTEM

APPROVAL DATE:

Approved For Construction

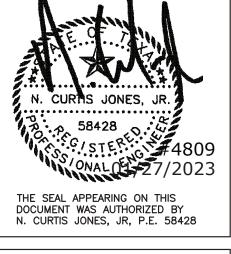

NO SCALE

HAS TIP# TBD

**ELECTRICAL ONE-LINES DIAGRAMS** SOUTH AREA

SHEET SIZE: 22"x34" ANSI-D

Consulting Mechanical/Electrical/Plumbing Engineers 9820 Whithorn Dr. Houston, Texas 77095 (713)222-7766 Texas Registered Engineering Firm #F-3811

HAS FILE: nd BIDS Replacemer

**FILE PATH:** vgs\4809 - E301-307.c

Kitchen Total KW Amps

- E307 -

BSG - CODE REVIEW STAMP



2800 N. TERMINAL RD. HOUSTON, TEXAS 77032

### HAS TERMINAL A

FIDS & BID LED LIGHTS A.I.P. No. C.I.P. No.



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**DESIGNER PROJECT No.:** 21011.05 PROJECT STATUS:

PHASE TWO

### **REVISIONS**

DESCRIPTION	DATE	BY
PERMIT, BID & CONSTRUCTION	01/27/2023	

A Addendum A

04-28-2023

DESIGNER: GB SP DRAWN BY: GB CHECKED BY: 01-27-2023 **ISSUE DATE:** 

**APPROVED BY:** APPROVAL DATE:

> DIRECTOR HOUSTON AIRPORT SYSTEM

Review/ Approval Category

Approved For Construction

CITY OF HOUSTON HOUSTON AIRPORTS SYSTE

THE SEAL APPEARING ON THIS DOCUMENT WAS AUTHORIZED BY N. CURTIS JONES, JR, P.E. 58428


HAS TIP# TBD


LED LIGHT BAR AND MONITOR

DETAILS NO SCALE

SHEET SIZE: 22"x34" ANSI-D

TYPICAL DETAILS FOR CABINET/POLE BRACKET MOUNT LED LIGHT FIXTURES

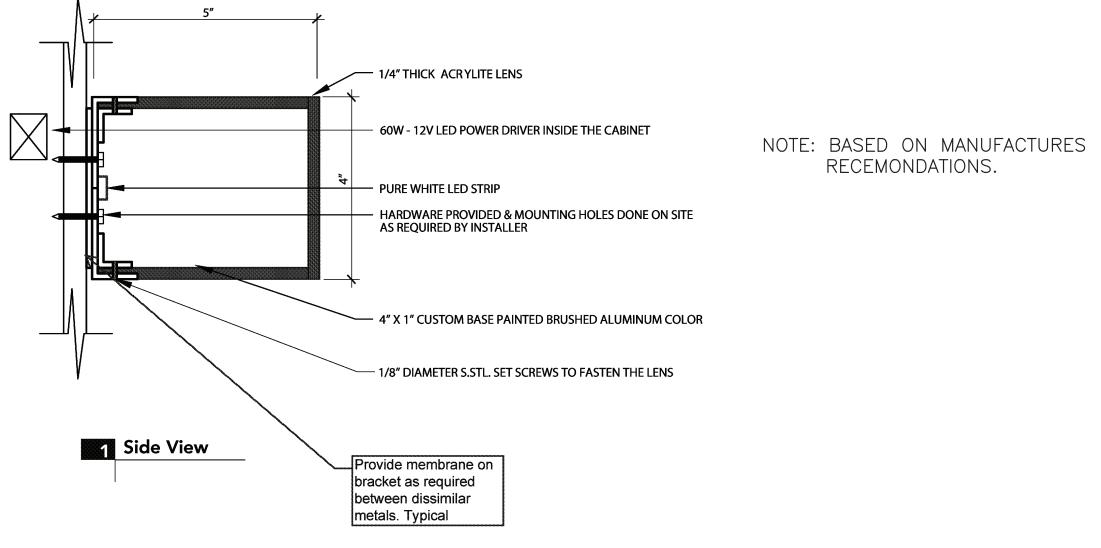

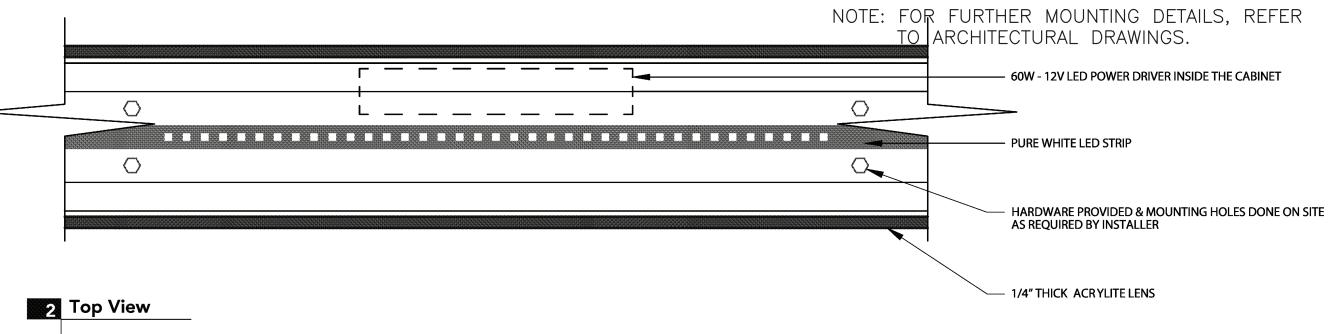

01 - TYPICAL LED LIGHT BAR DETAIL

FILE PATH:

HAS FILE:



- E308 -

6A HORIZONTAL DATA CABLES WITH A BLACK JACKET.

19. ALL HAS CAT 6A PATCH CORDS SHALL BE COMMSCOPE SYSTIMAX

#X10D F/UTP SERIES. RJ45 CONNECTORS SHALL BE COMMSCOPE

XFMR

LAWA

LRA

LTG

PLO DOA OLD

LOS ANGELES WORLD AIRPORTS

LINEAR FEET

LIGHTING

LOCKED ROTOR AMPS

TRANSFORMER

1T2.107

TELEPHONES W/ SUBSCRIPT 'W'-42" A.F.F. TO CENTER OF OUTLET. HANDICAP TELEPHONES-32" A.F.F. TO CENTER OF OUTLET.

REFER TO SPECIFICATIONS FOR MATERIALS AND METHODS FOR ELECTRICAL CONSTRUCTION. ALL WORK SHALL BE INSTALLED

B. FOLLOW DIVISION 27 FOR COMMUNICATION CABLING, CONDUIT,

C. REFER TO ARCHITECTURAL REFLECTED CEILING PLANS FOR

D. REFER TO ARCHITECTURAL INTERIOR ELEVATION DRAWINGS, WHERE THE ARCHITECT HAS DRAWN SUCH ELEVATIONS, FOR

E. REFER TO ARCHITECTURAL EQUIPMENT DRAWINGS FOR THE

F. FURNISH ACCESS DOORS FOR INSTALLATION IN WALLS AND CEILINGS WHERE ACCESS IS REQUIRED TO CONCEALED

G. ARRANGE WITH AUTHORITIES AND UTILITY COMPANIES FOR PERMITS, FEES, AND SERVICE CONNECTIONS, VERIFYING LOCATIONS AND ARRANGEMENT AND PAYING ALL CHARGES,

H. COORDINATE WORK WITH ARCHITECTURAL FEATURES AND COORDINATE WORK SO THAT INTERFERENCES BETWEEN MECHANICAL WORK, AND BUILDING STRUCTURE WILL BE

ENSURE THAT CLEARANCE REQUIREMENTS ARE MET FOR ALL

ALL COMMUNICATION INSTALLATION SHALL COMFORM TO TIA

K. REFER TO 270500 FOR CONTRACTOR REQUIREMENTS FOR THE

TELECOMMUNICATION INTERFACES WITH OTHER PROJECT DISCIPLINES ARE PROVIDED AND THAT WORK IS COMPLETE AND

M. ALL HAS CABLING AND TECHNOLOGY INFRASTRUCTURE SHALL

N. ALL CAT 6/6A CABLES AND TERMINATIONS MUST BE STP TYPE

	CONDUIT FILL QUANTITIES										
SIZE	QTY CAT-6	QTY CAT-6A	QTY RG-6	QTY RG-11	QTY ACCESS CTRL						
CABLE DIA.	0.24"	0.28"	0.26"	0.38"	0.35"						
1.0"C	1-6	1-4	1-5	1	1						
1.5"C	7-14	5-7	6-11	2-3	2-3						
2.0"C	15-20	8-14	12-17	4-6	4-6						
2.5"C	21-30	15-18	18-22	7-11	7-11						
3.0"C	31-40	19-22	23-32	12-15	12-16						
3.5"C	-	-	-	-	-						
4.0"C	41-70	23-40	33-55	16-25	17-26						

2800 N. TERMINAL RD. HOUSTON, TEXAS 77032 HAS TERMINAL A FIDS & BID LED LIGHTS C.I.P. No. A.I.P. No.

D.O.A No.



C.O.H. No.

**BSG - CODE REVIEW STAMP** 

Ferguson Consulting

Aviation Specialists for Electrical,

Telecommunications and Security Systems

Ferguson Consulting Inc.

10200 Grogans Mill Rd. Ste. #420

The Woodlands, TX 77380

(281) 252-9232 Firm No. 6864

- A901 -

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**DESIGNER PROJECT No.:** 21011.05

PROJECT STATUS:


PHASE 2 **REVISIONS** No. DESCRIPTION DATE BY 01/27/2023 PERMIT. BID & CONSTRUCTION

DESIGNER:	СР
DRAWN BY:	FR
CHECKED BY:	LF
ISSUE DATE:	01/27/23
APPROVED BY:	LF
APPROVAL DATE:	


### DIRECTOR

HOUSTON AIRPORT SYSTEM


Review/ Approval Category Approved For Construction CITY OF HOUSTON HOUSTON AIRPORTS SYST Houston Airports System Director or Designated Representat

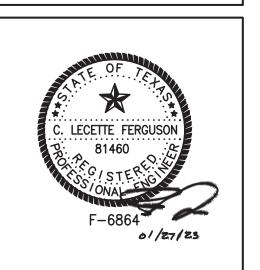

HAS TIP# TBD SYMBOLS AND ABBREVIATIONS NAME: T-001 SCALE: As indicated

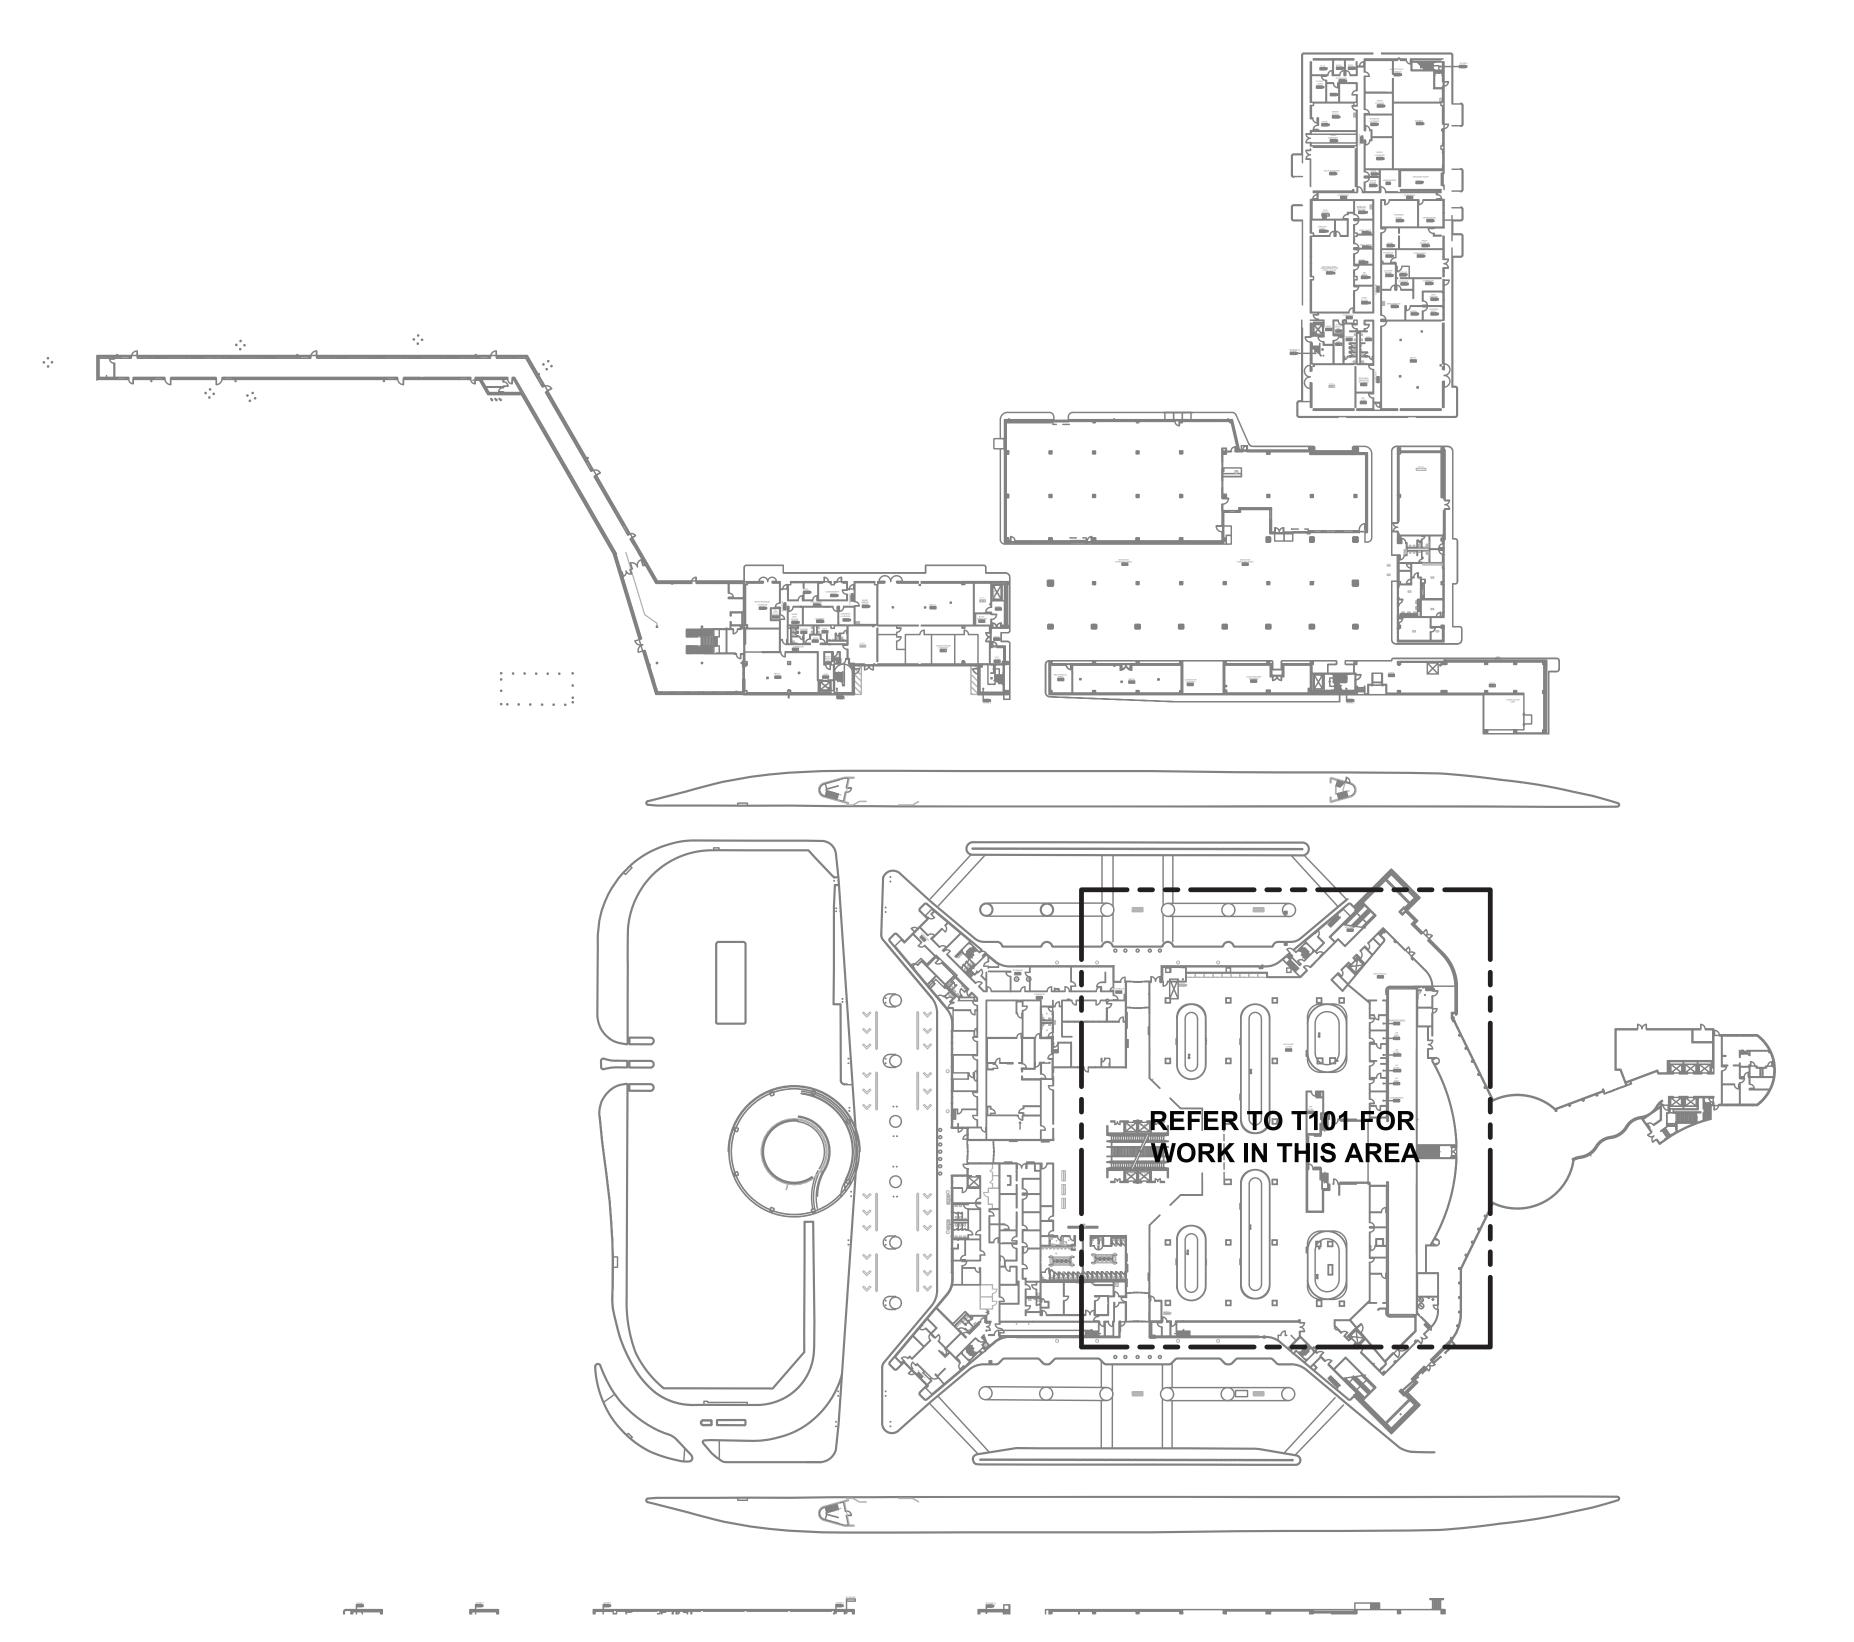

TERMINAL A - LEVEL 1 - OVERALL PLAN

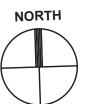



2800 N. TERMINAL RD. HOUSTON, TEXAS 77032

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HAS TERMINAL A FIDS & BID LED LIGHTS

A.I.P. No. C.I.P. No. C.O.H. No. D.O.A No.



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**DESIGNER PROJECT No.:** 21011.05 PROJECT STATUS: PHASE 2

**REVISIONS** DATE No. DESCRIPTION 01/27/2023 PERMIT, BID & CONSTRUCTION


CP DESIGNER: FR DRAWN BY: CHECKED BY: 01/27/23 ISSUE DATE: APPROVED BY: APPROVAL DATE:

DIRECTOR

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Aviation Specialists for Electrical,
Telecommunications and Security Systems


Ferguson Consulting Inc. 10200 Grogans Mill Rd. Ste. #420 The Woodlands, TX 77380 (281) 252-9232 Firm No. 6864

HAS TIP# TBD

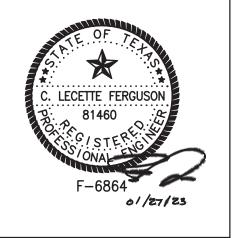NAME:

TERMINAL A - LEVEL 1 -OVERALL PLAN

T100 SCALE: As indicated

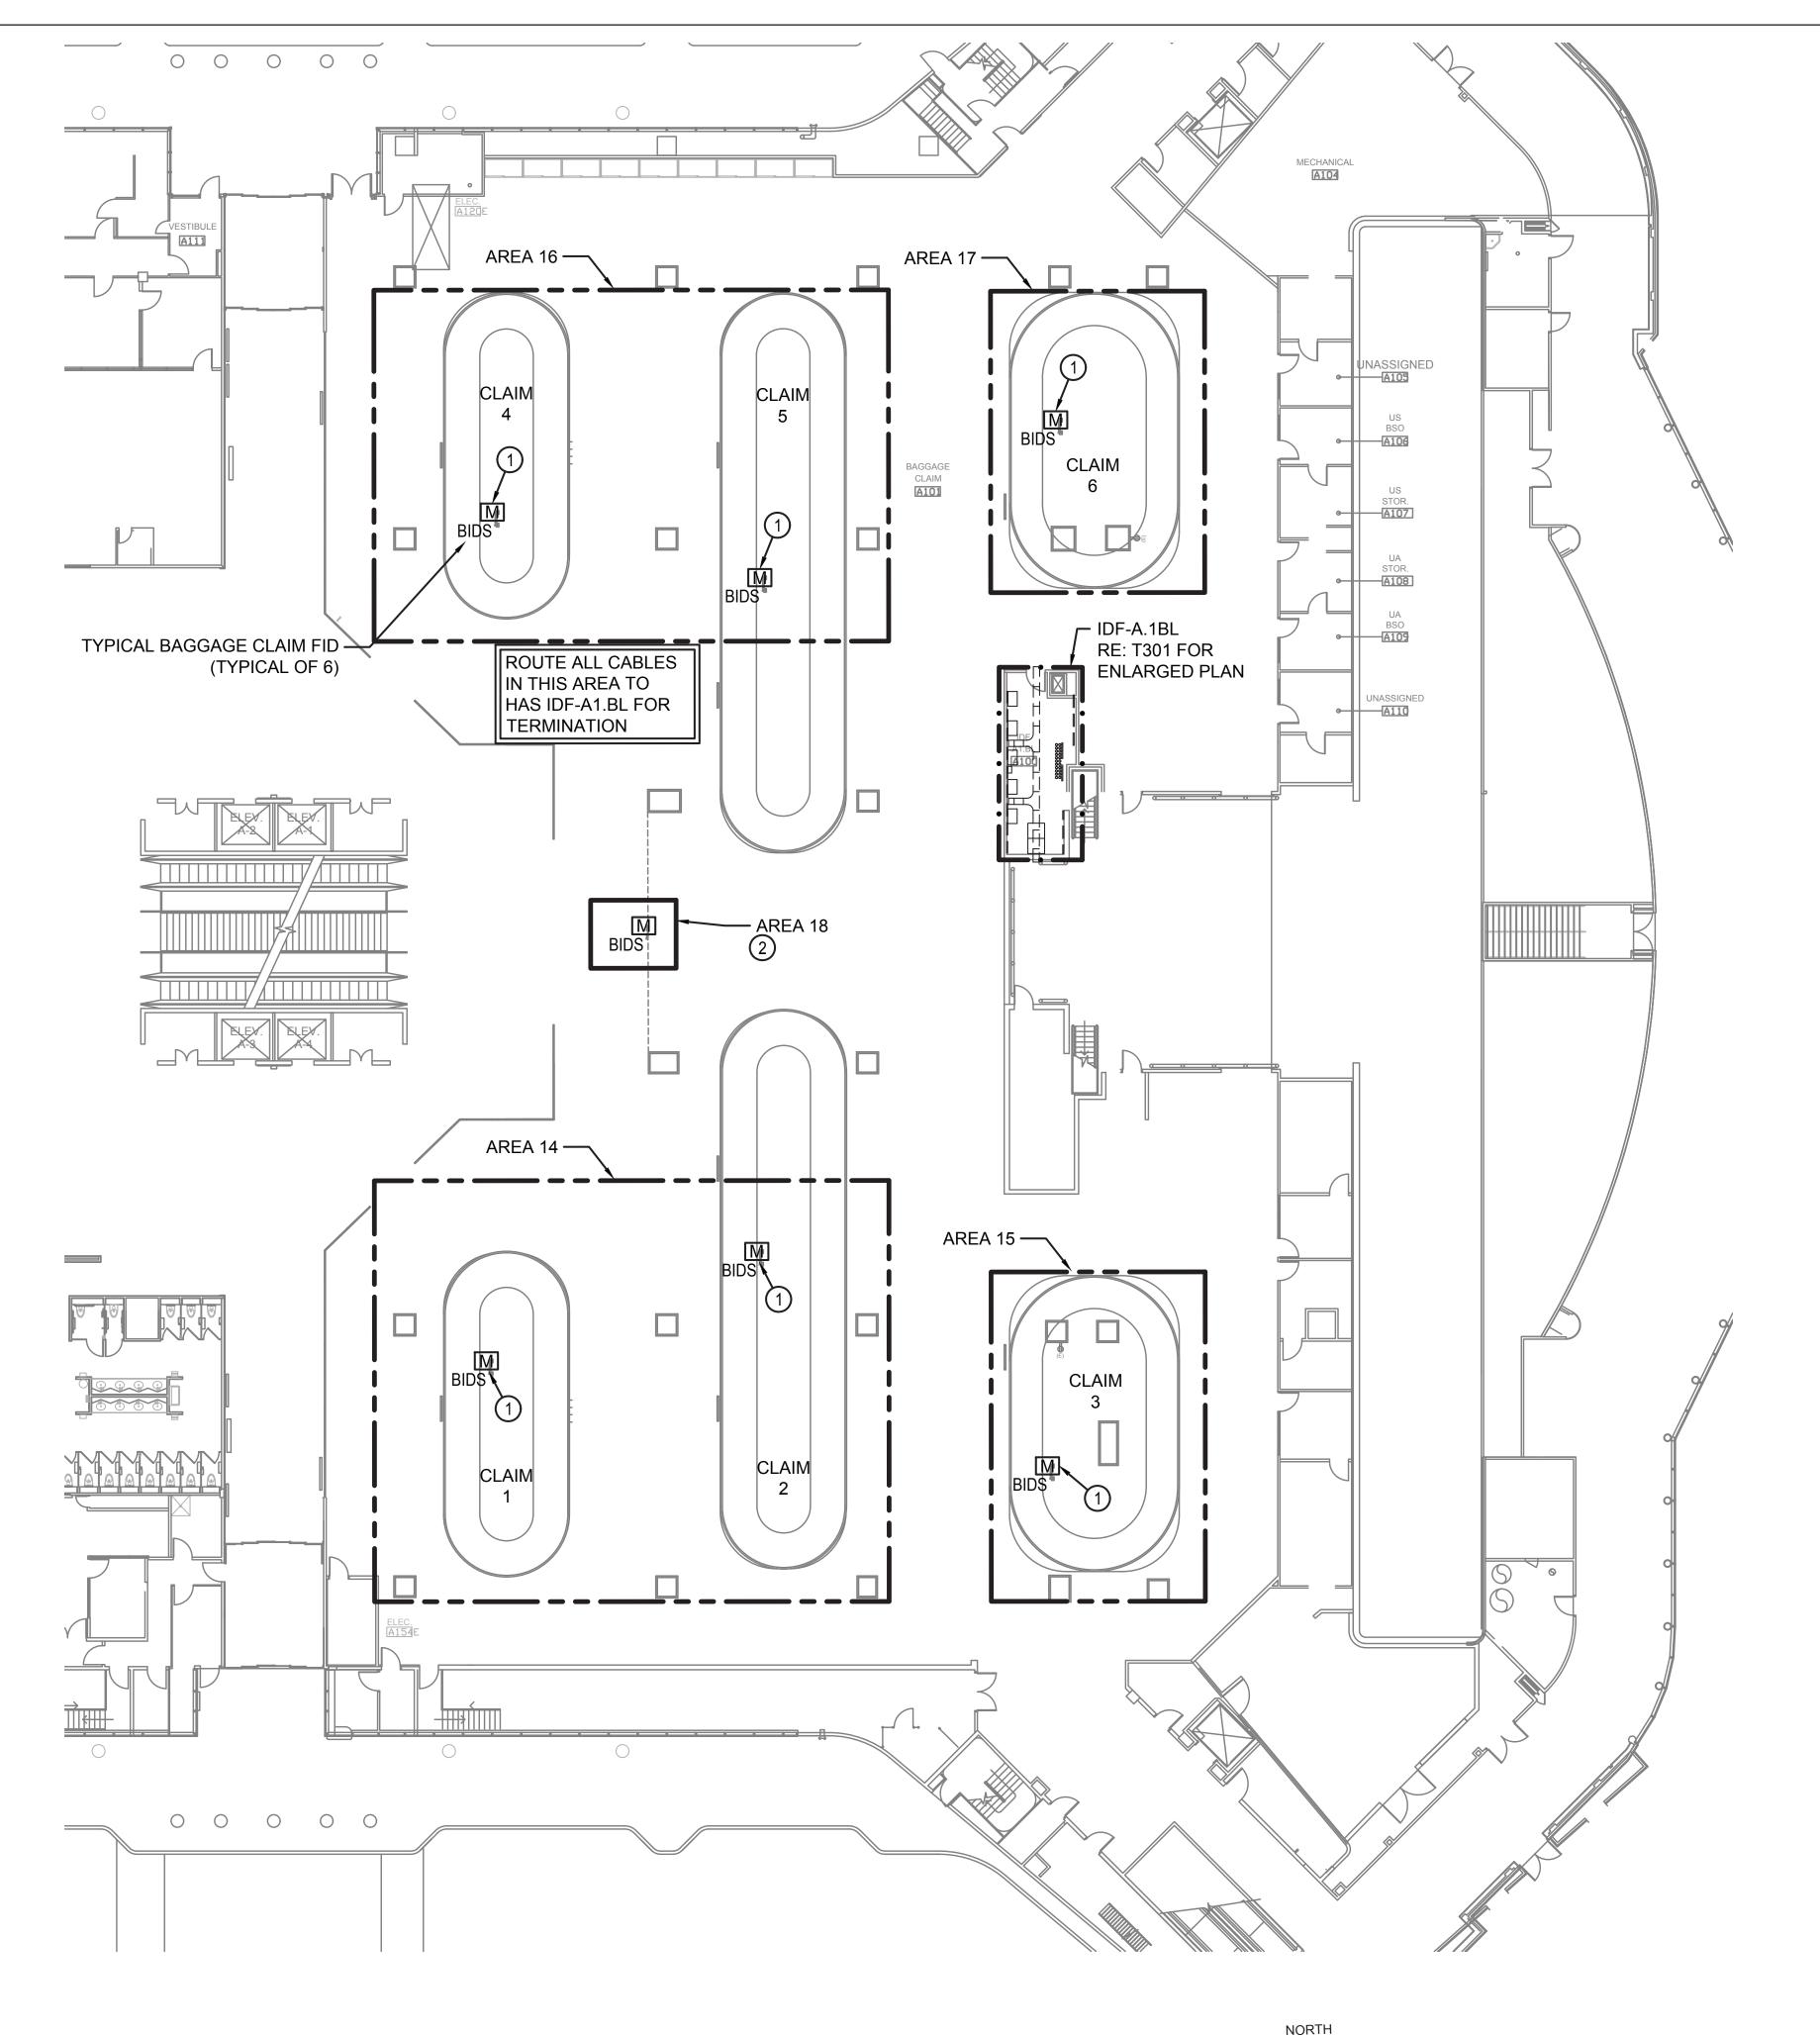

BSG - CODE REVIEW STAMP

#### **GENERAL NOTES**

- 1. THE CONTRACTOR SHALL COORDINATE ALL IDF ROOM RELATED WORK WITH THE RESPECTIVE OWNER. PROVIDE A MINIMUM OF 10 DAYS NOTICE WHEN WORKING IN AN EXISTING IDF ROOM
- 2. ALL CABLES ARE HAS AND ROUTE TO HAS PATCH PANELS FOR TERMINATION UNLESS OTHERWISE NOTED.

#### **KEYED NOTES**

- (1) EXISTING BIDS DISPLAY LOCATION. REMOVE AND SALVAGE OR DISPOSE EXISTING EQUIPMENT AS DIRECTED BY HAS IT. INSTALL NEW CABLES USING EXISTING PATHWAY WHERE AVAILABLE. MODIFY OR ADD NEW PATHWAY AS REQUIRED. REFER TO T001 FOR CONDUI SIZING CHART. ONLY REMOVE EXISTING CAT 6 UTP CABLES WHERE IT IS NECESSARY FOR THE SUCCESSFUL INSTALLATION OF THE NEW CAT 6 STP CABLE. REMOVE THE CAT 6 UTP PATCH CORD AT EACH END FOR CABLES REMOVED AND CABLES ABANDONED IN PLACE. REFER TO DETAIL NOTED FOR ADDITIONAL SCOPE.
- PROPOSED BIDS DISPLAY LOCATION. INSTALL NEW EQUIPMENT FOLLOWING PLANS AND DETAILS. INSTALL NEW CAT 6 STP CABLE IN 1"C TO IDF ROOM NOTED FOR TERMINATION. REFER TO DETAIL NOTED FOR ADDITIONAL SCOPE.



A.I.P. No.

D.O.A No.

2800 N. TERMINAL RD. HOUSTON, TEXAS 77032 HAS TERMINAL A FIDS & BID LED LIGHTS



C.I.P. No.

C.O.H. No.

### ENGLISH + **ASSOCIATES ARCHITECTS**

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**DESIGNER PROJECT No.:** 21011.05 PROJECT STATUS: PHASE 2

#### **REVISIONS** No. DESCRIPTION DATE

PERMIT, BID &

CONSTRUCTION	

01/27/2023

DESIGNER:	CP
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APPROVED BY:	LF
APPROVAL DATE:	

DIRECTOR HOUSTON AIRPORT SYSTEM

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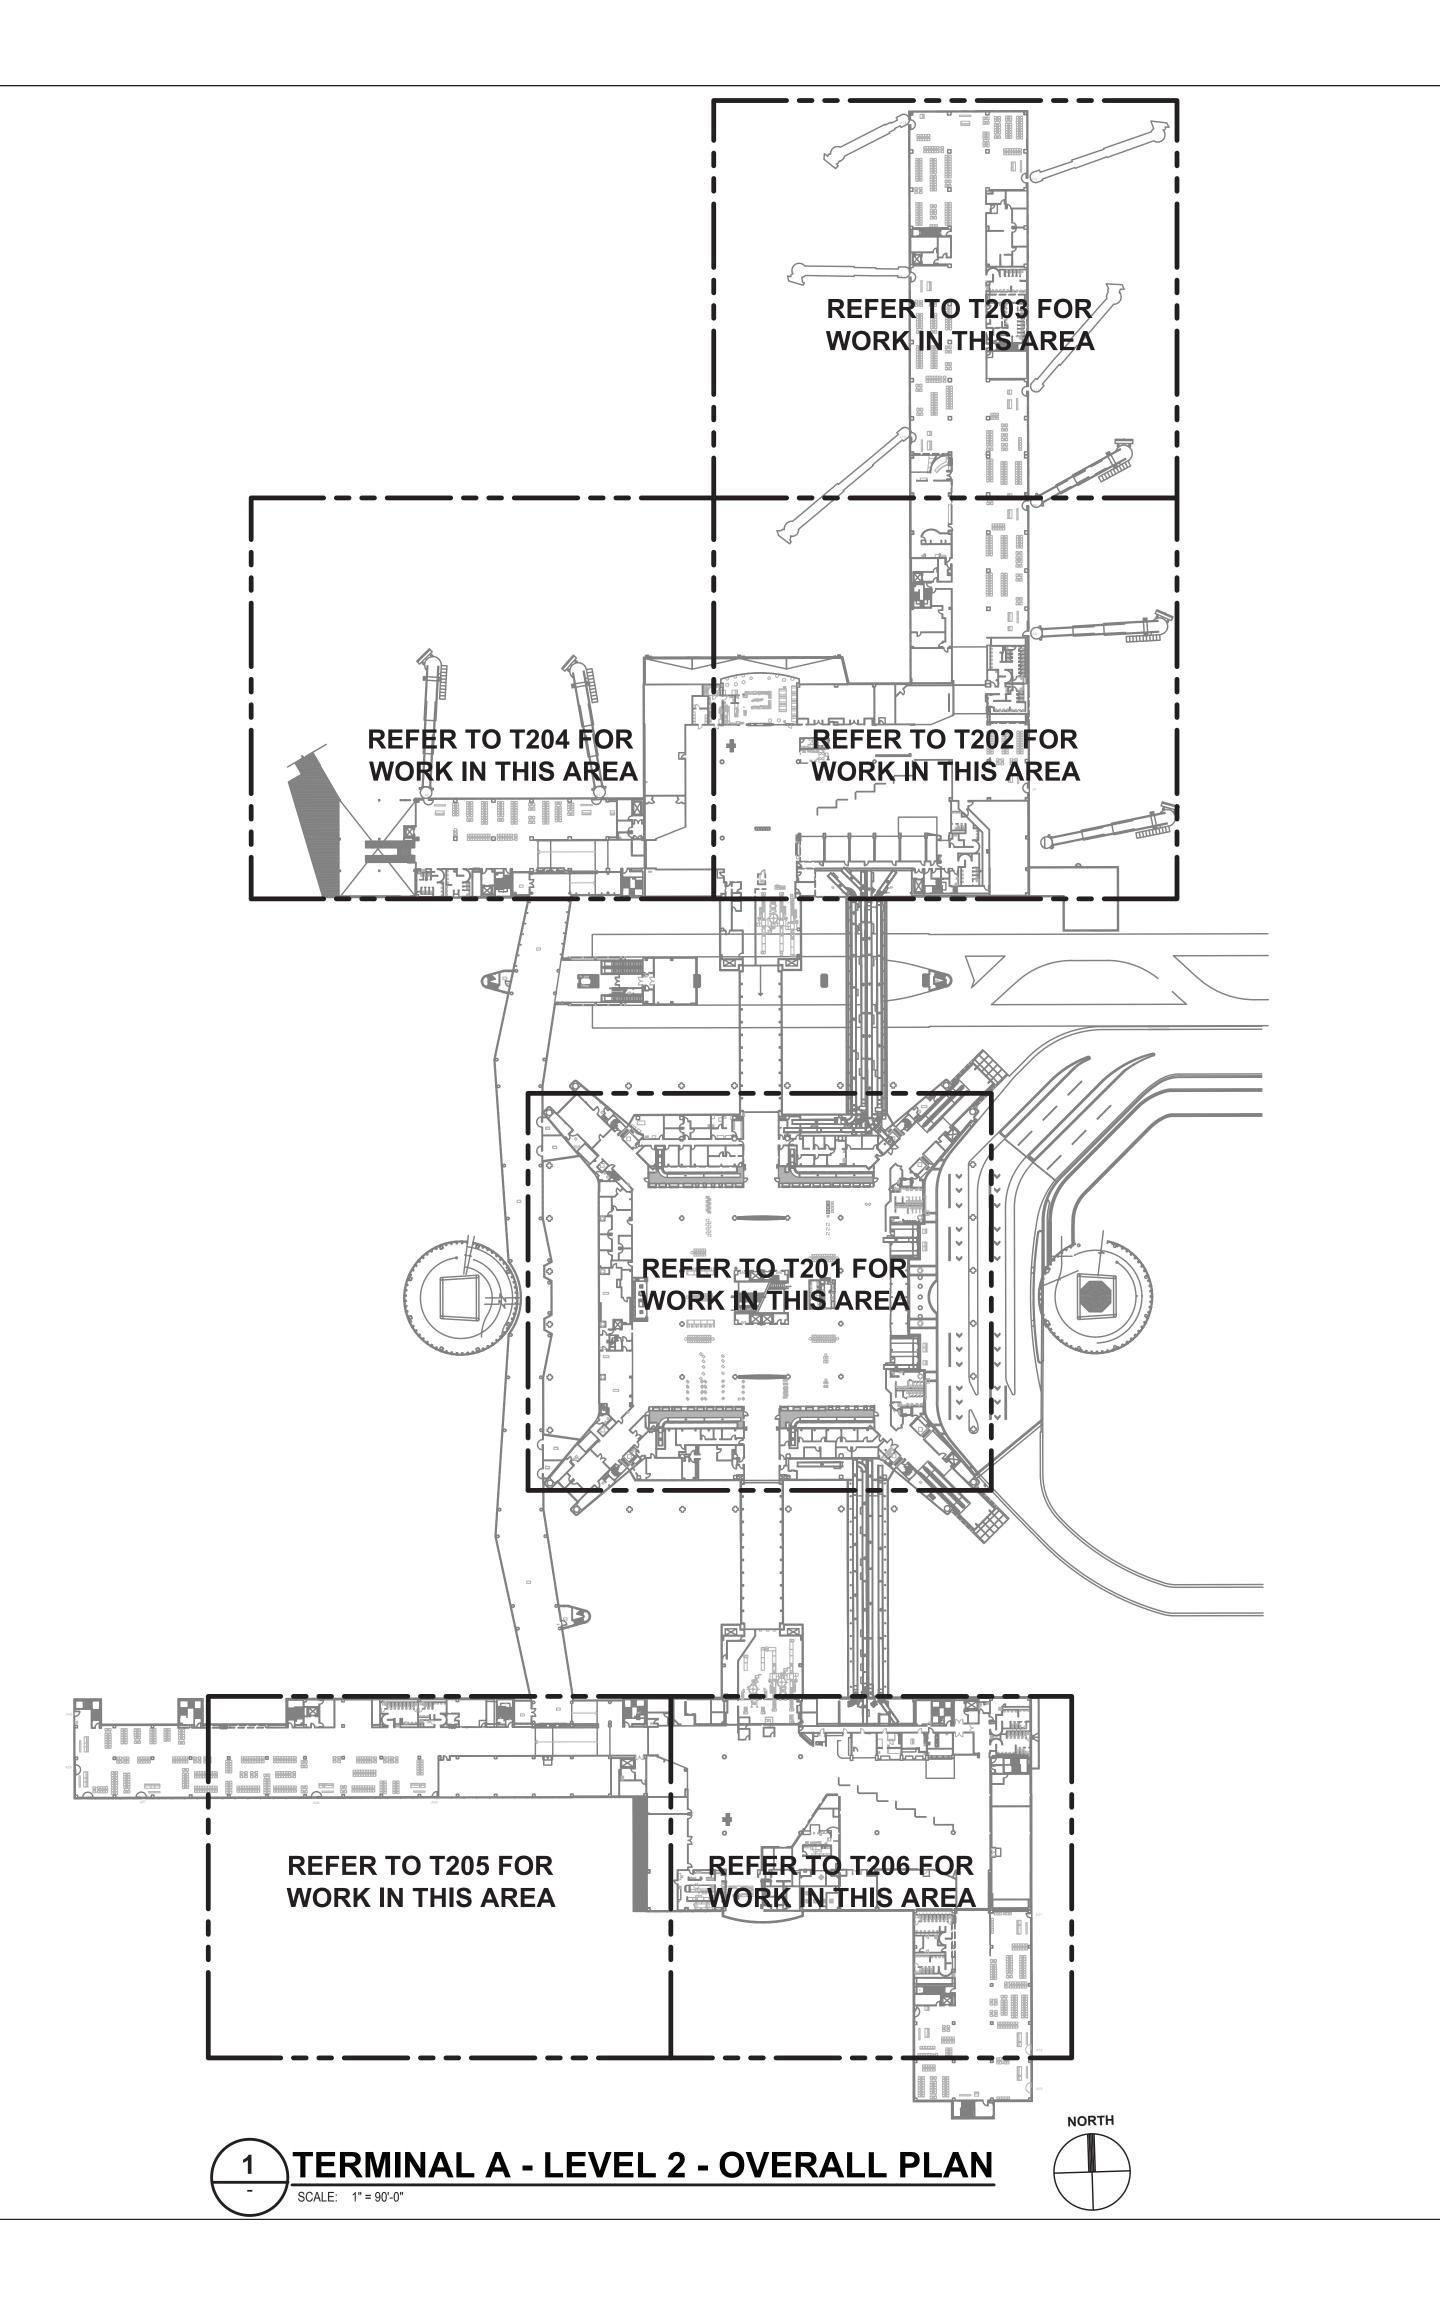
Telecommunications and Security Systems

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HAS TIP# TBD

TERMINAL A - BAGGAGE CLAIM NAME: AREA 14-18 As indicated

TERMINAL A - BAGGAGE CLAIM AREA 14-18 SCALE: 1/16" = 1'-0"





2800 N. TERMINAL RD. HOUSTON, TEXAS 77032

HAS TERMINAL A

FIDS & BID LED LIGHTS C.I.P. No.

A.I.P. No. D.O.A No. C.O.H. No.



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**DESIGNER PROJECT No.:** 21011.05 PROJECT STATUS: PHASE 2

**REVISIONS** DATE No. DESCRIPTION 01/27/2023 PERMIT, BID & CONSTRUCTION


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> DIRECTOR HOUSTON AIRPORT SYSTEM

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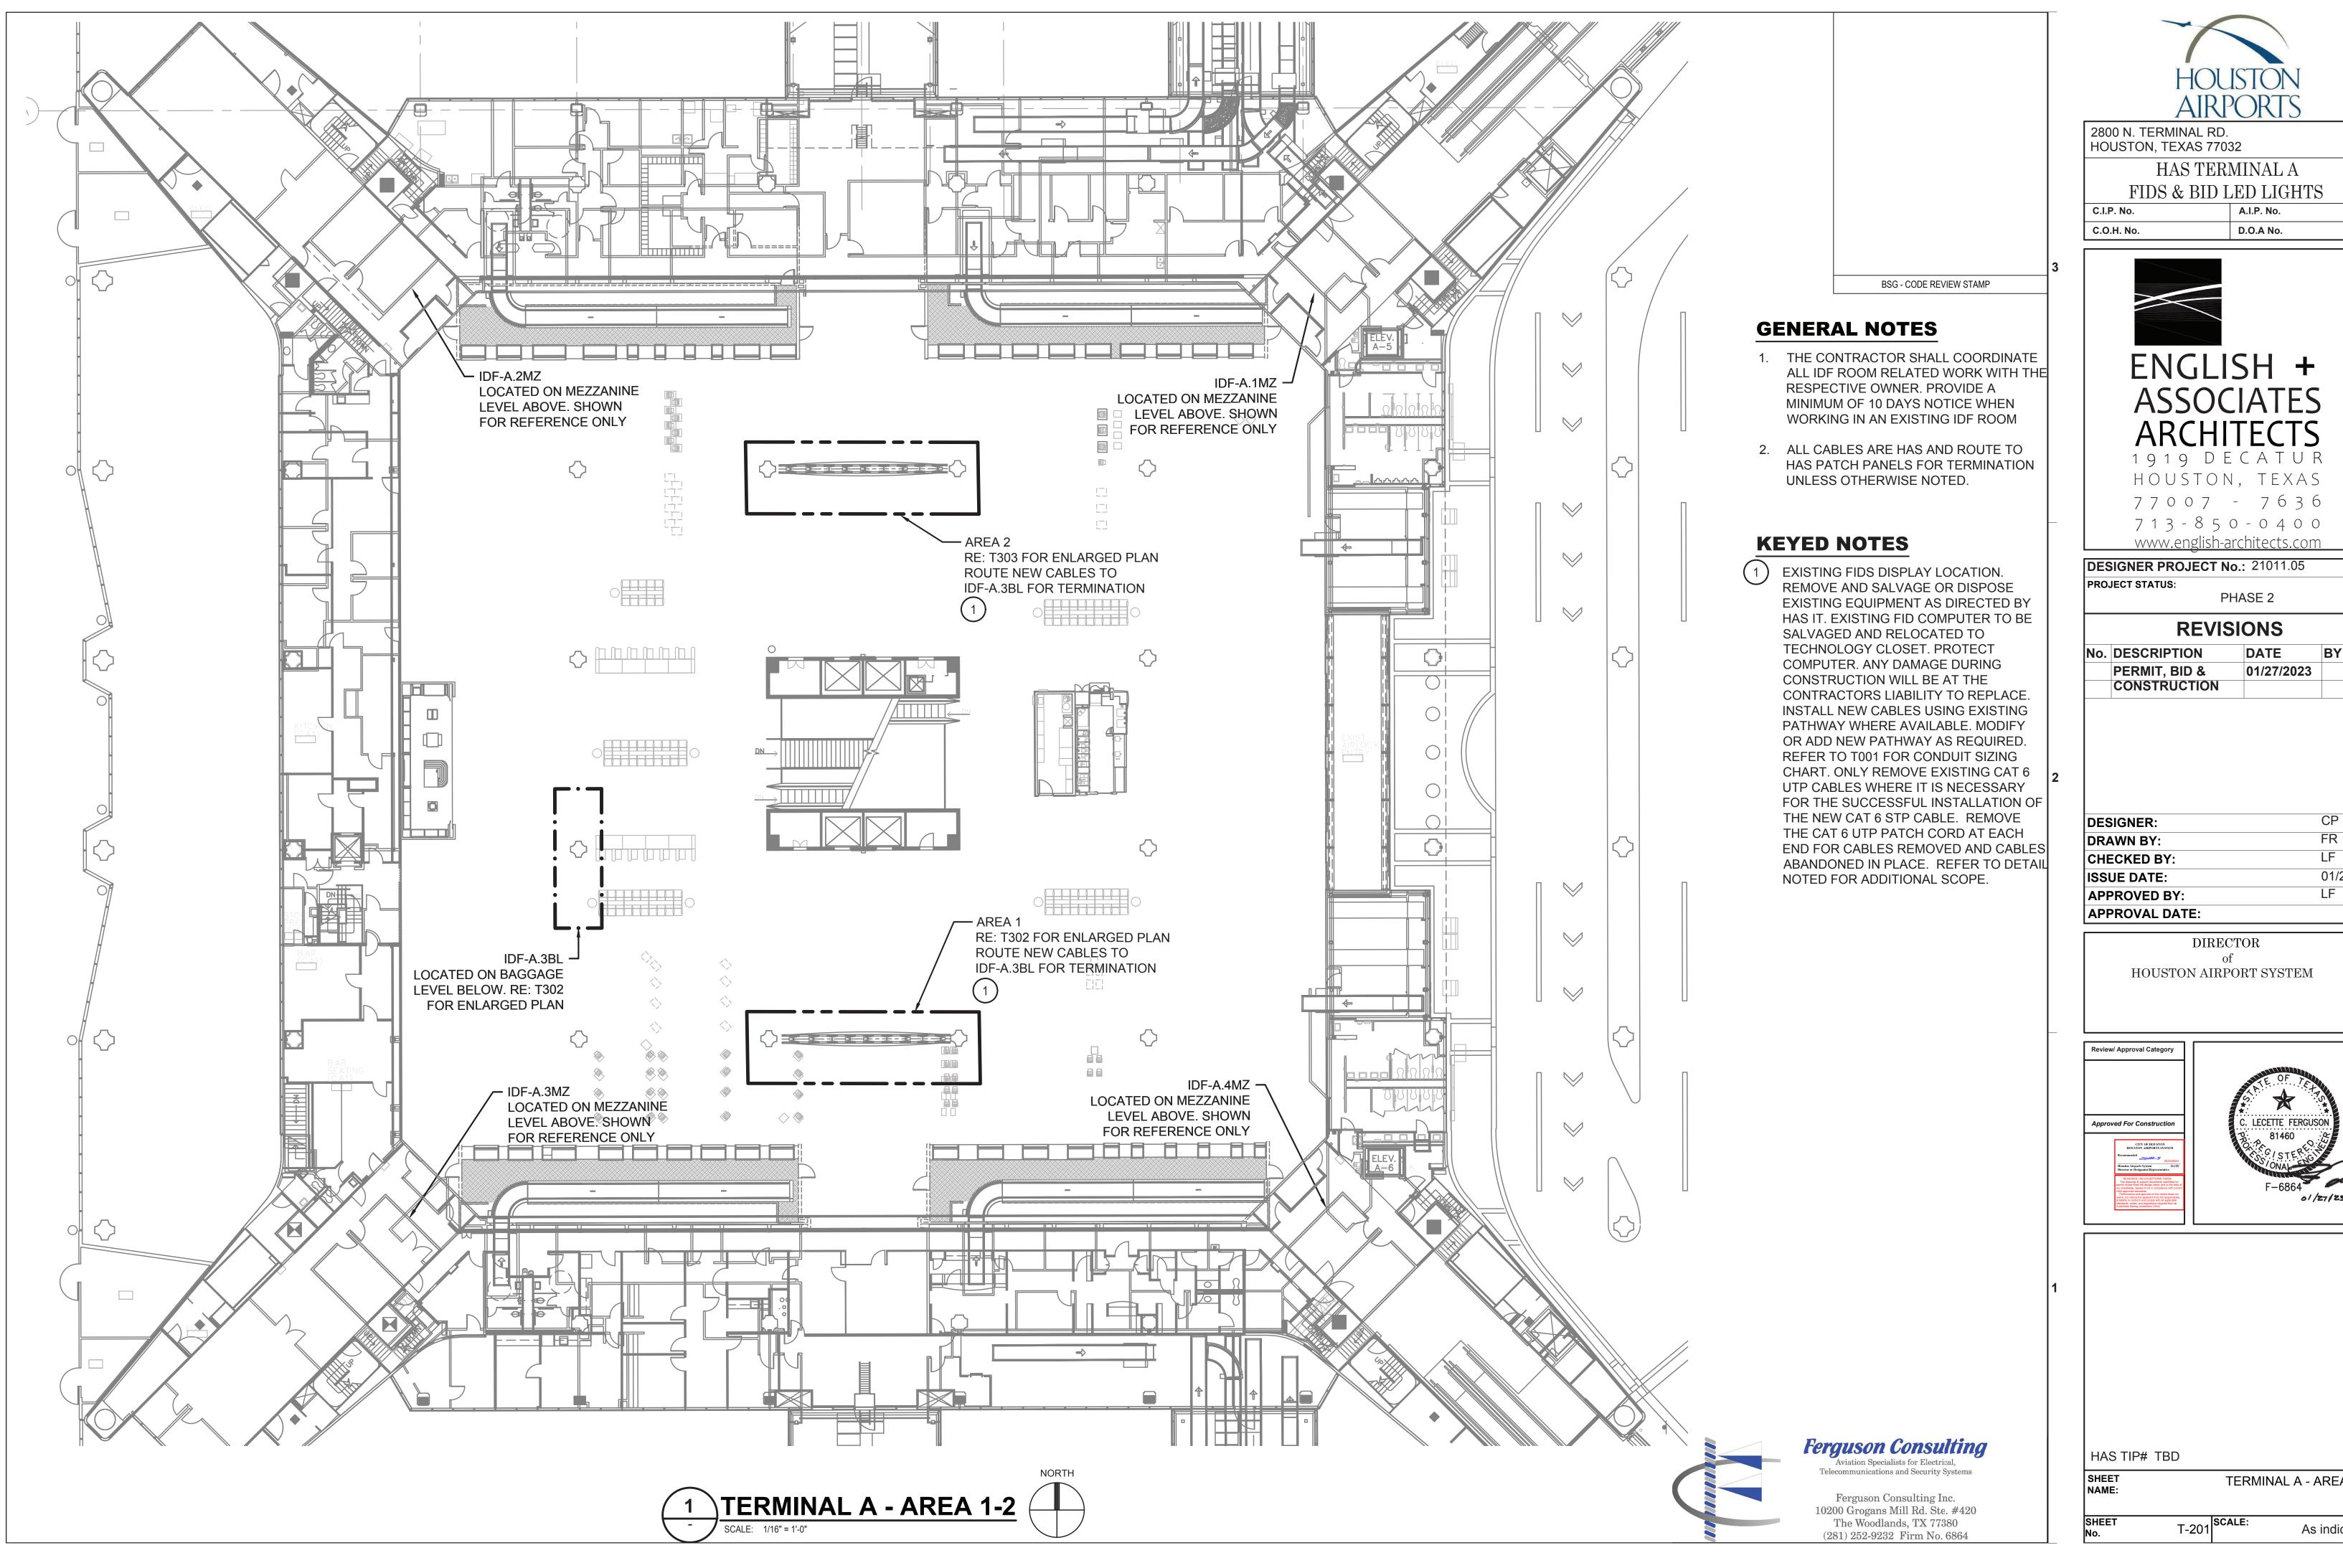
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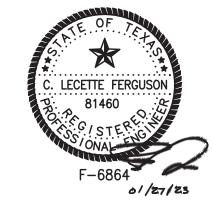
NAME:

TERMINAL A - LEVEL 2 -OVERALL PLAN

T-200 SCALE: As indicated

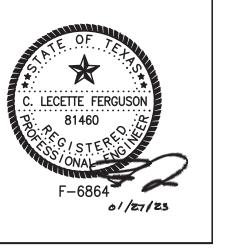



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APPROVAL DATE:	



TERMINAL A - AREA 1-2

As indicated

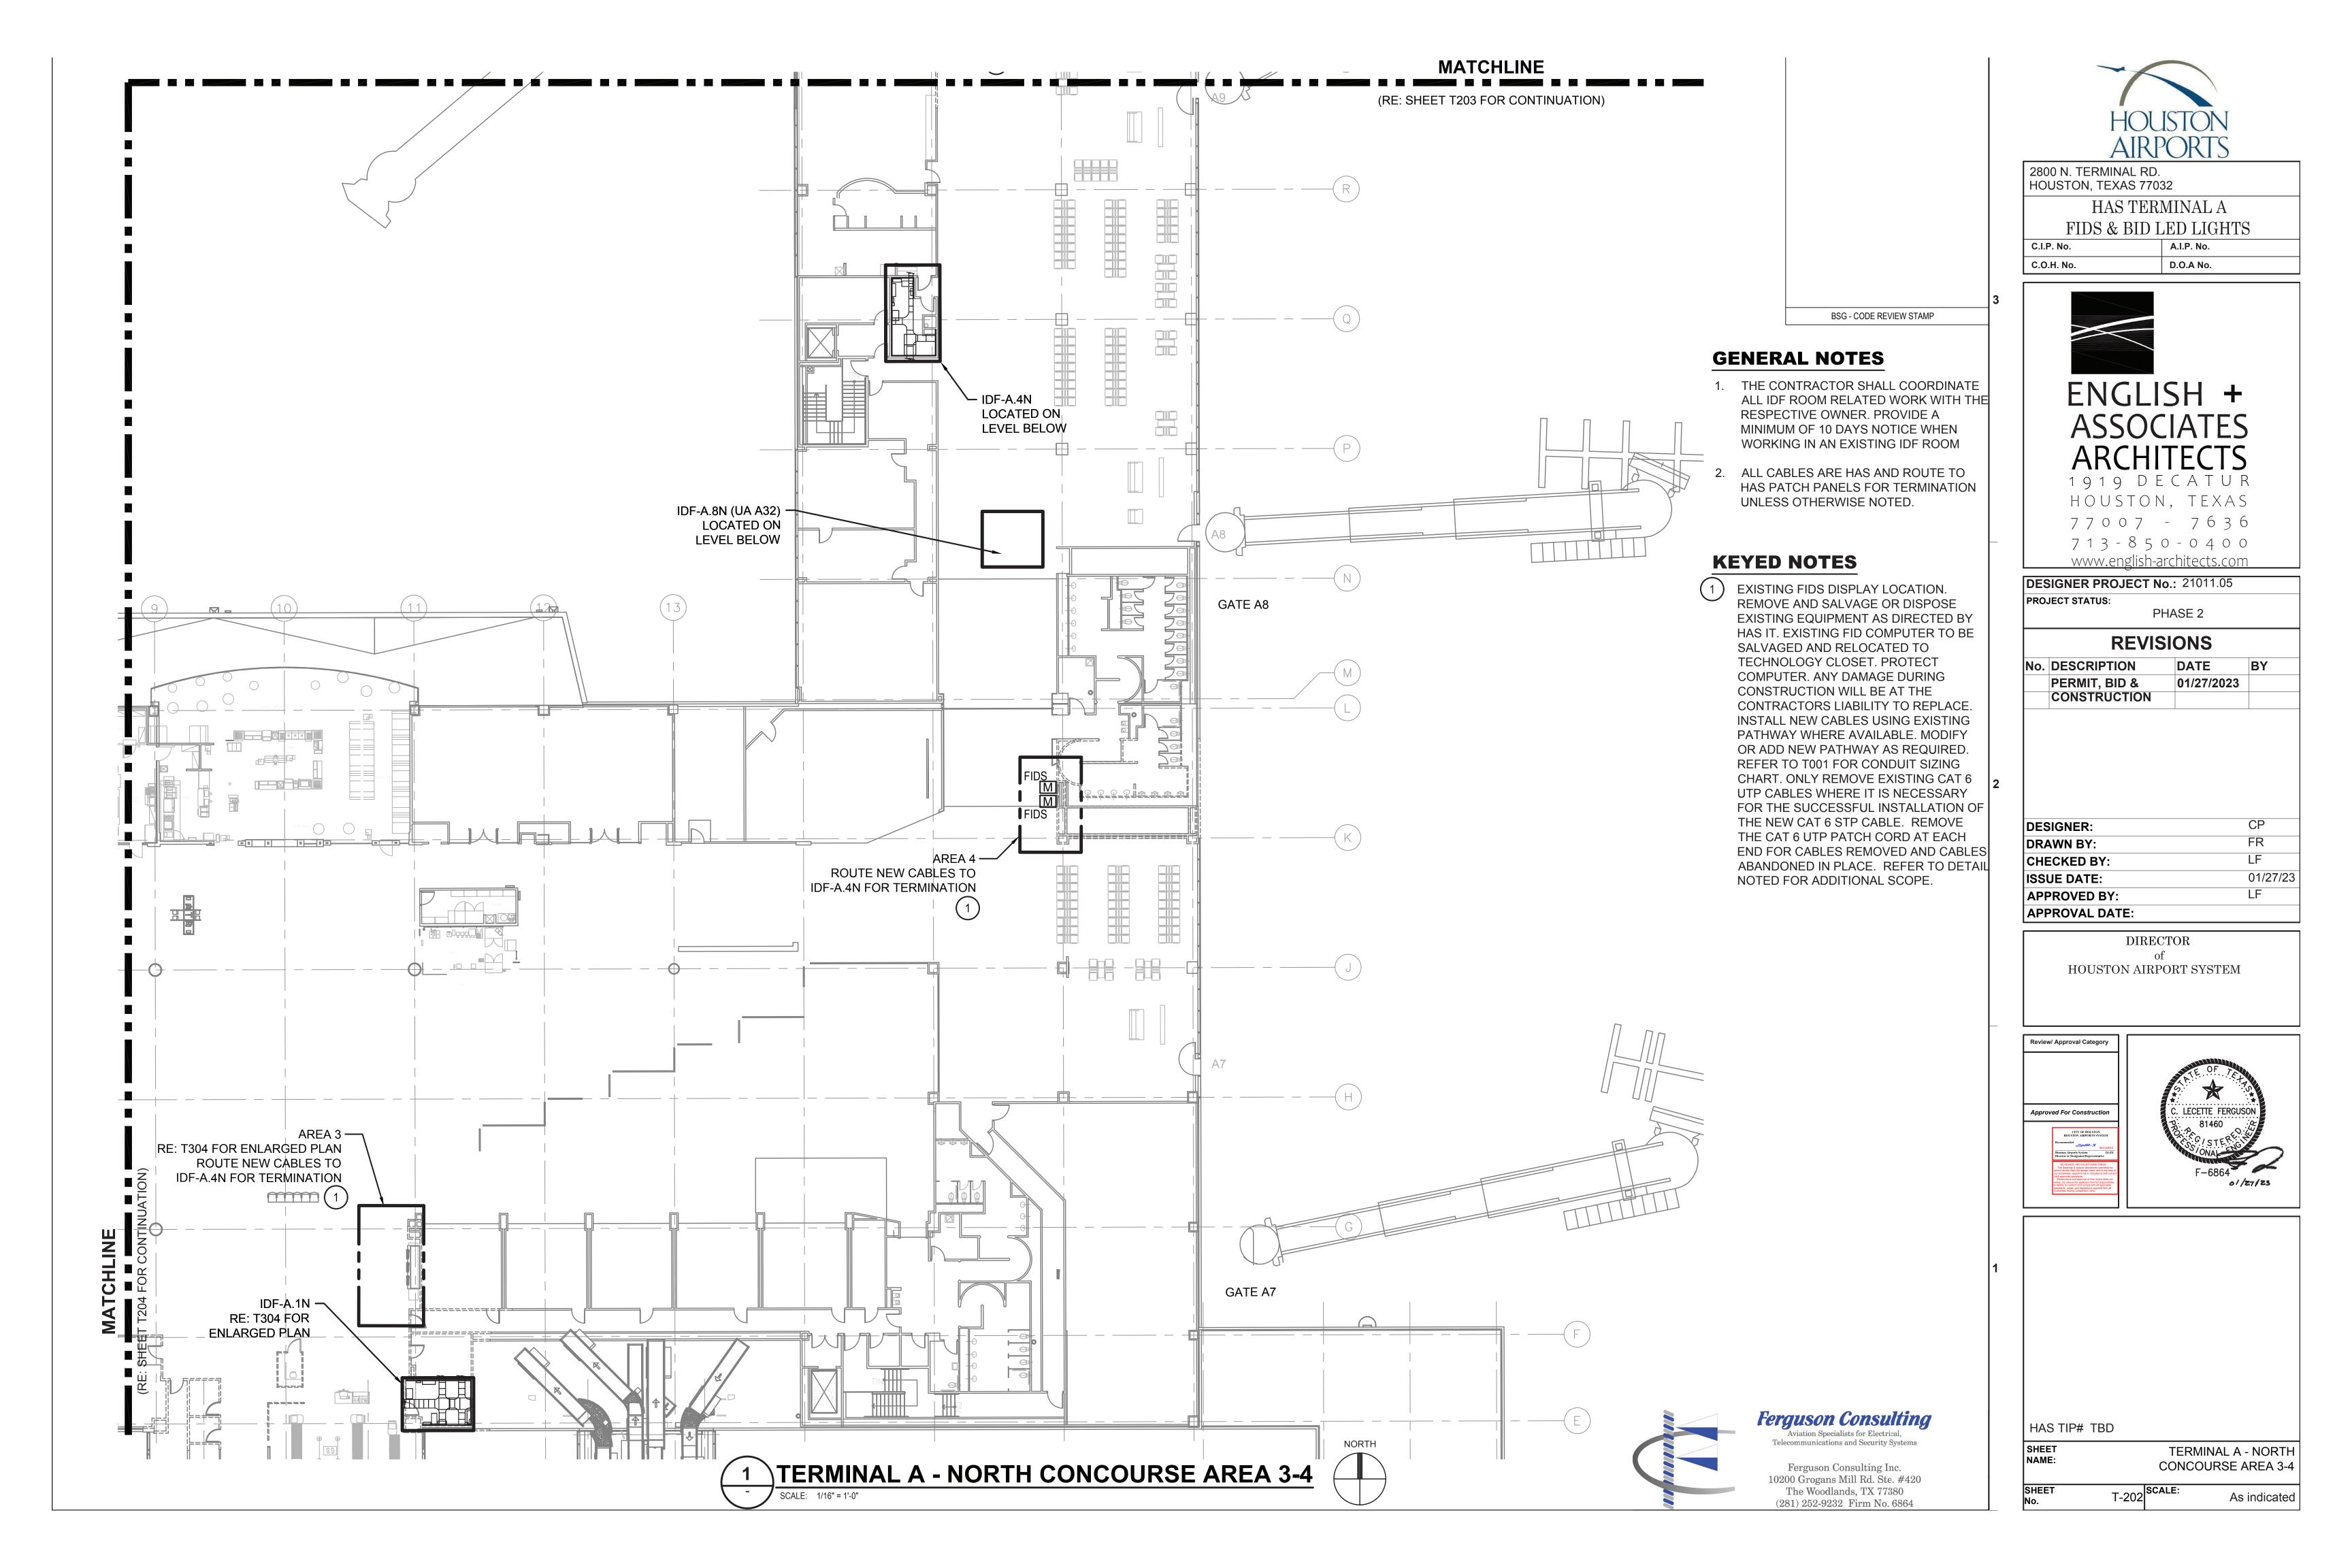

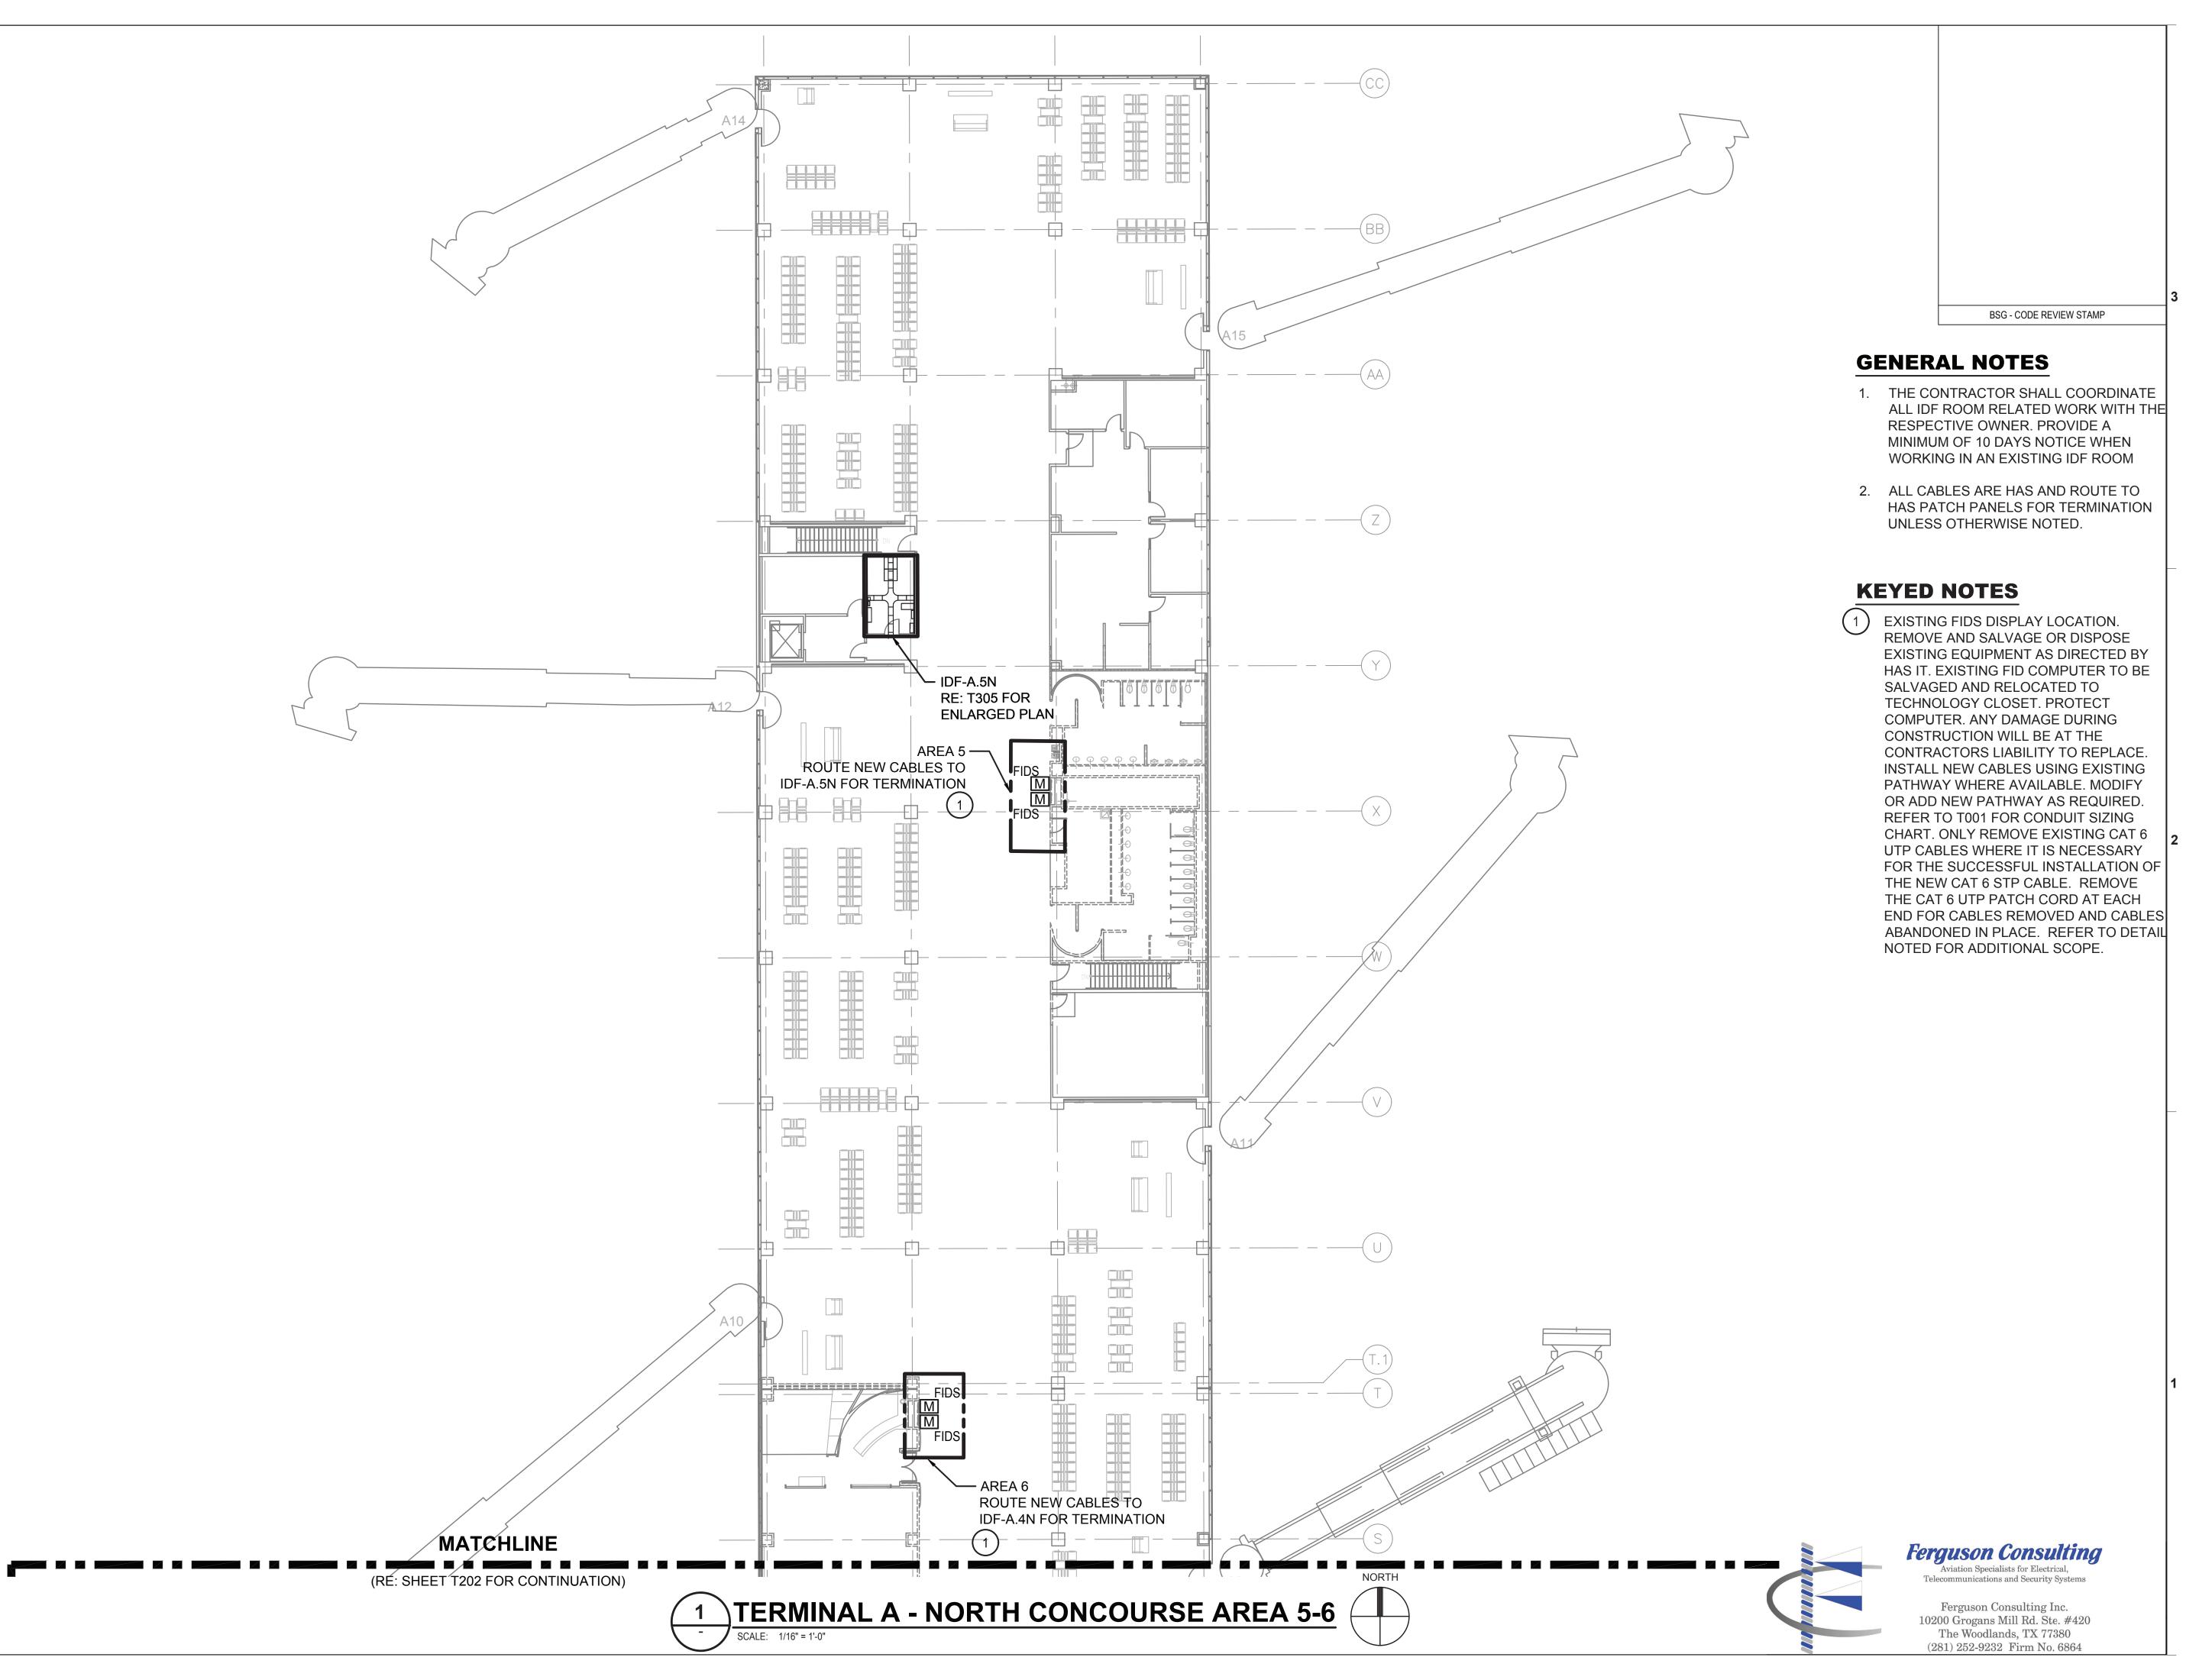



2800 N. TERMINAL RD. HOUSTON, TEXAS 77032 HAS TERMINAL A

FIDS & BID LED LIGHTS A.I.P. No. C.I.P. No.

C.O.H. No. D.O.A No.



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**DESIGNER PROJECT No.:** 21011.05 PROJECT STATUS: PHASE 2

#### DEVISIONS

REVISIONS				
No.	DESCRIPTION	DATE	BY	
	PERMIT, BID &	01/27/2023		
	CONSTRUCTION			

DESIGNER:	CP
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ISSUE DATE:	01/27/23
APPROVED BY:	LF
APPROVAL DATE:	

DIRECTOR HOUSTON AIRPORT SYSTEM

Review/ Approval Category

Approved For Construction






HAS TIP# TBD

TERMINAL A - NORTH NAME: **CONCOURSE AREA 5-6** 

T-203 SCALE: As indicated

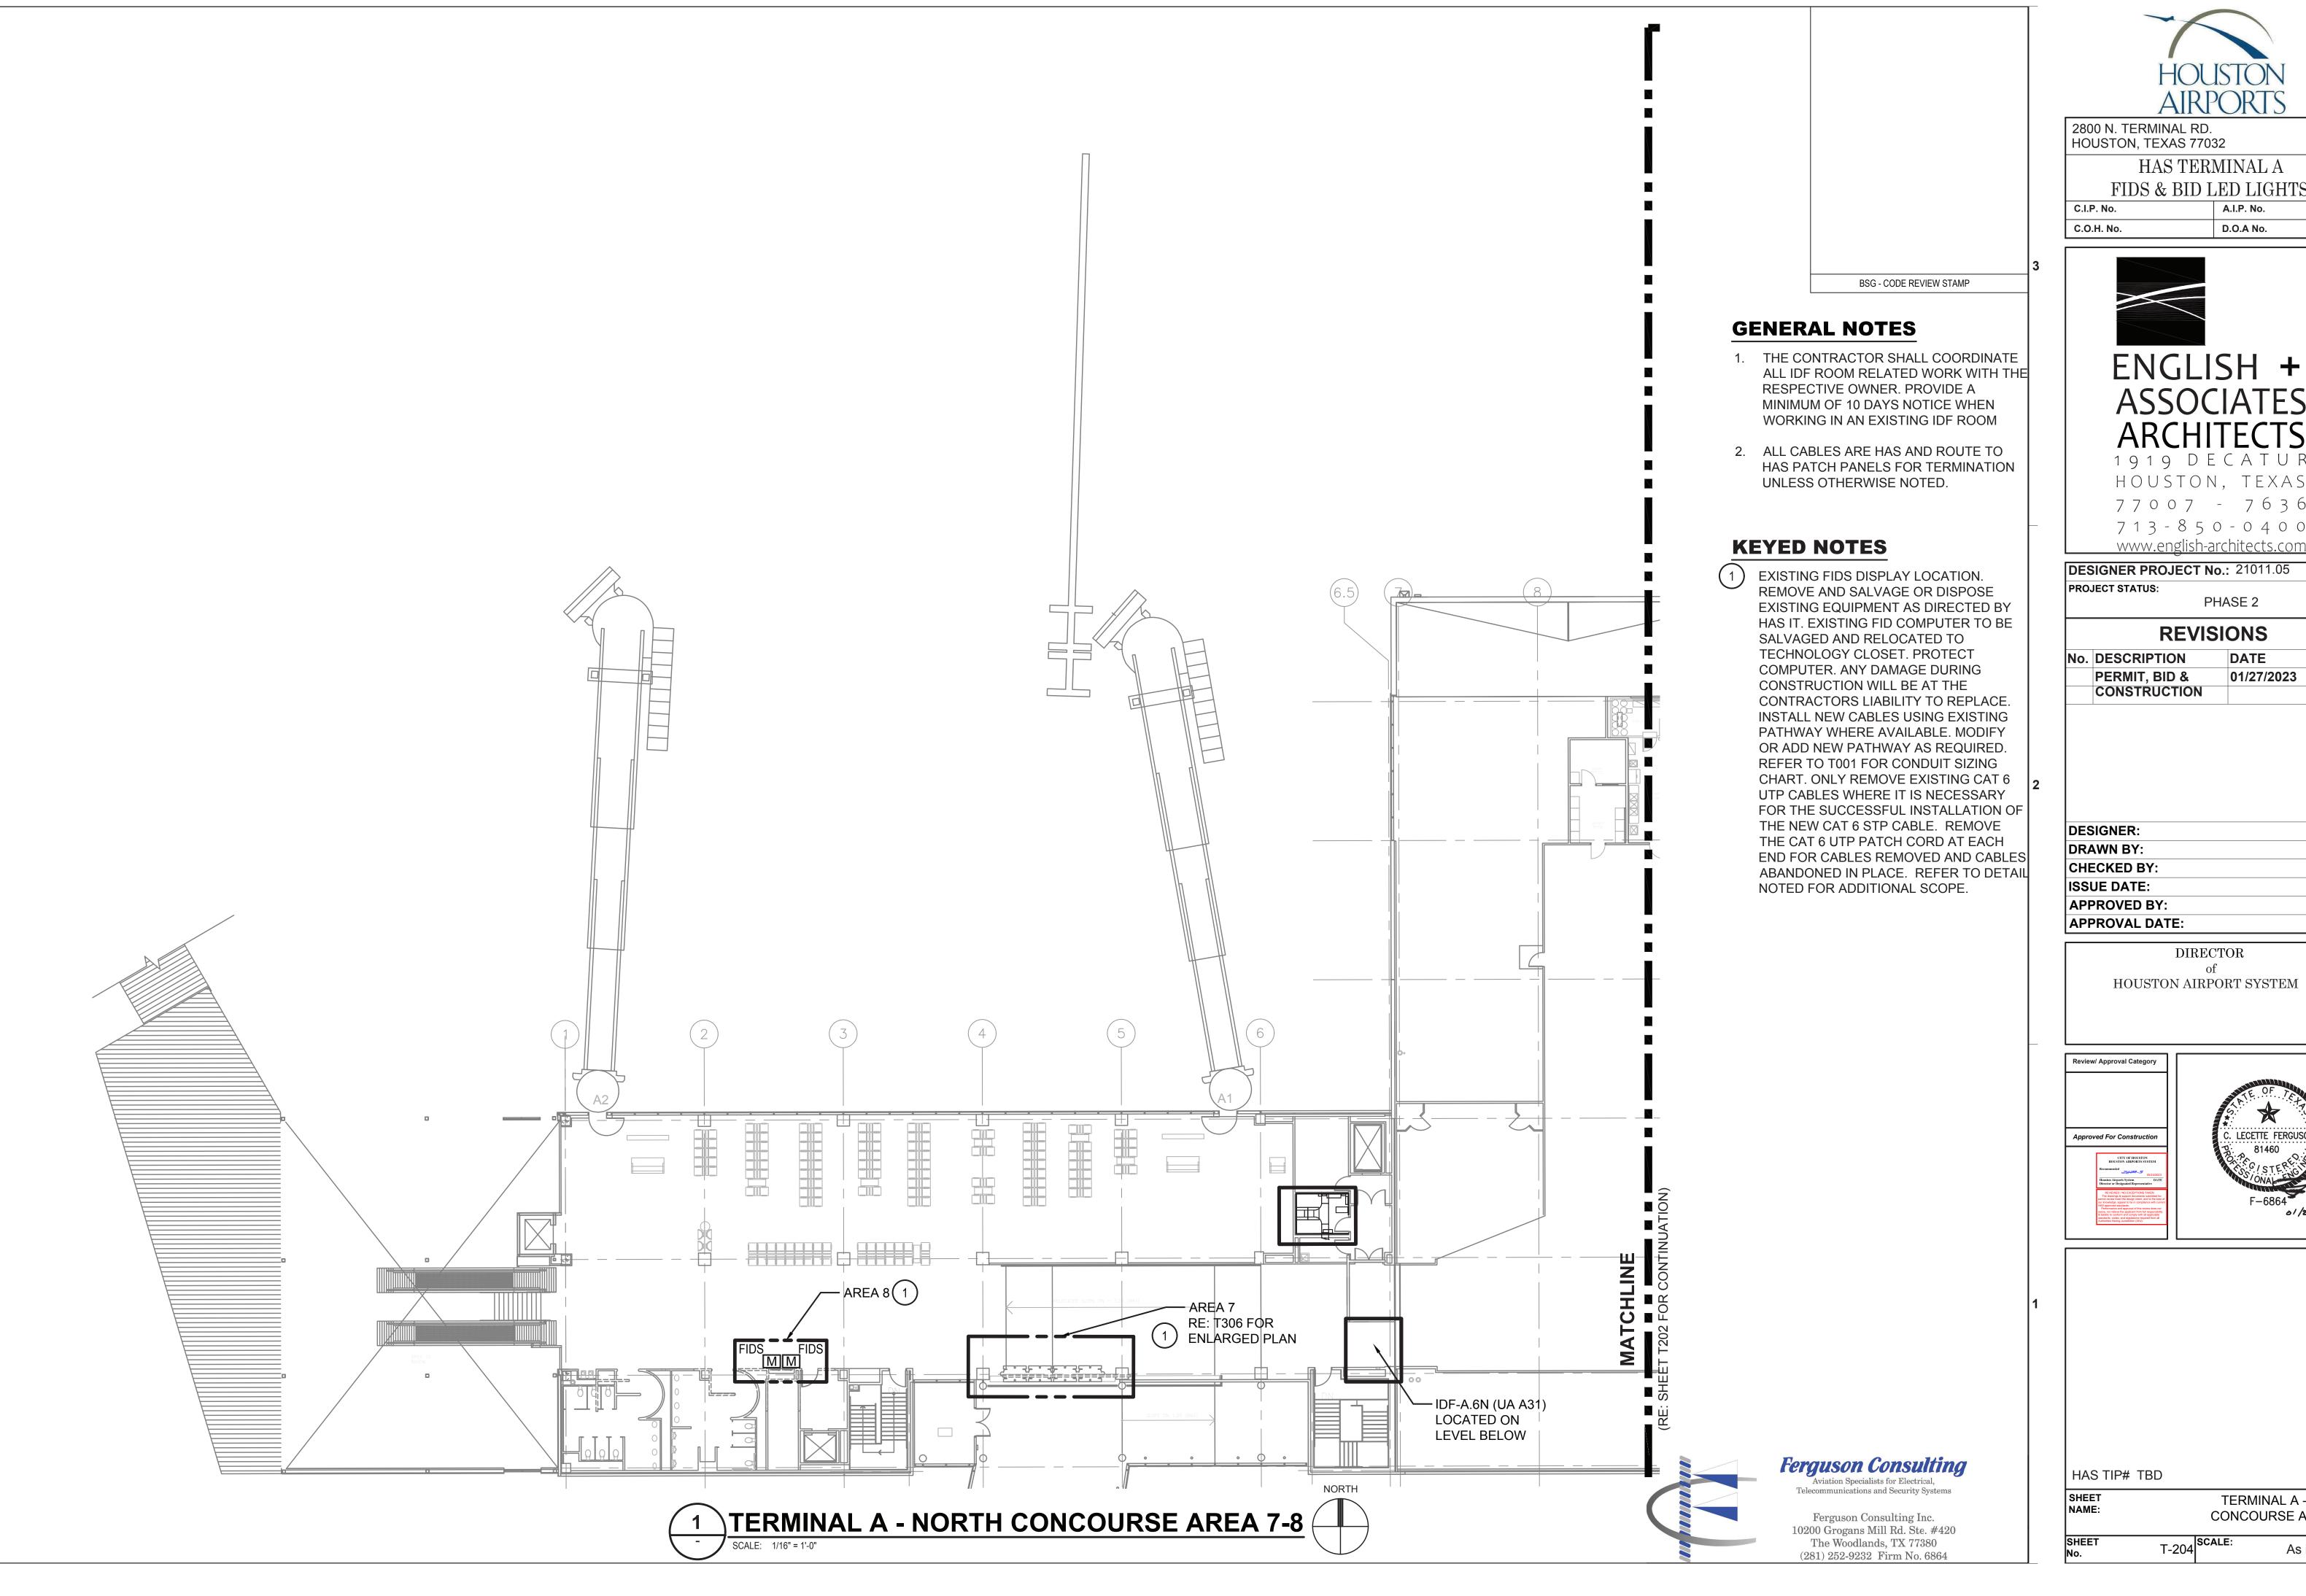



FIDS & BID LED LIGHTS

A.I.P. No. D.O.A No.

# **ASSOCIATES ARCHITECTS**

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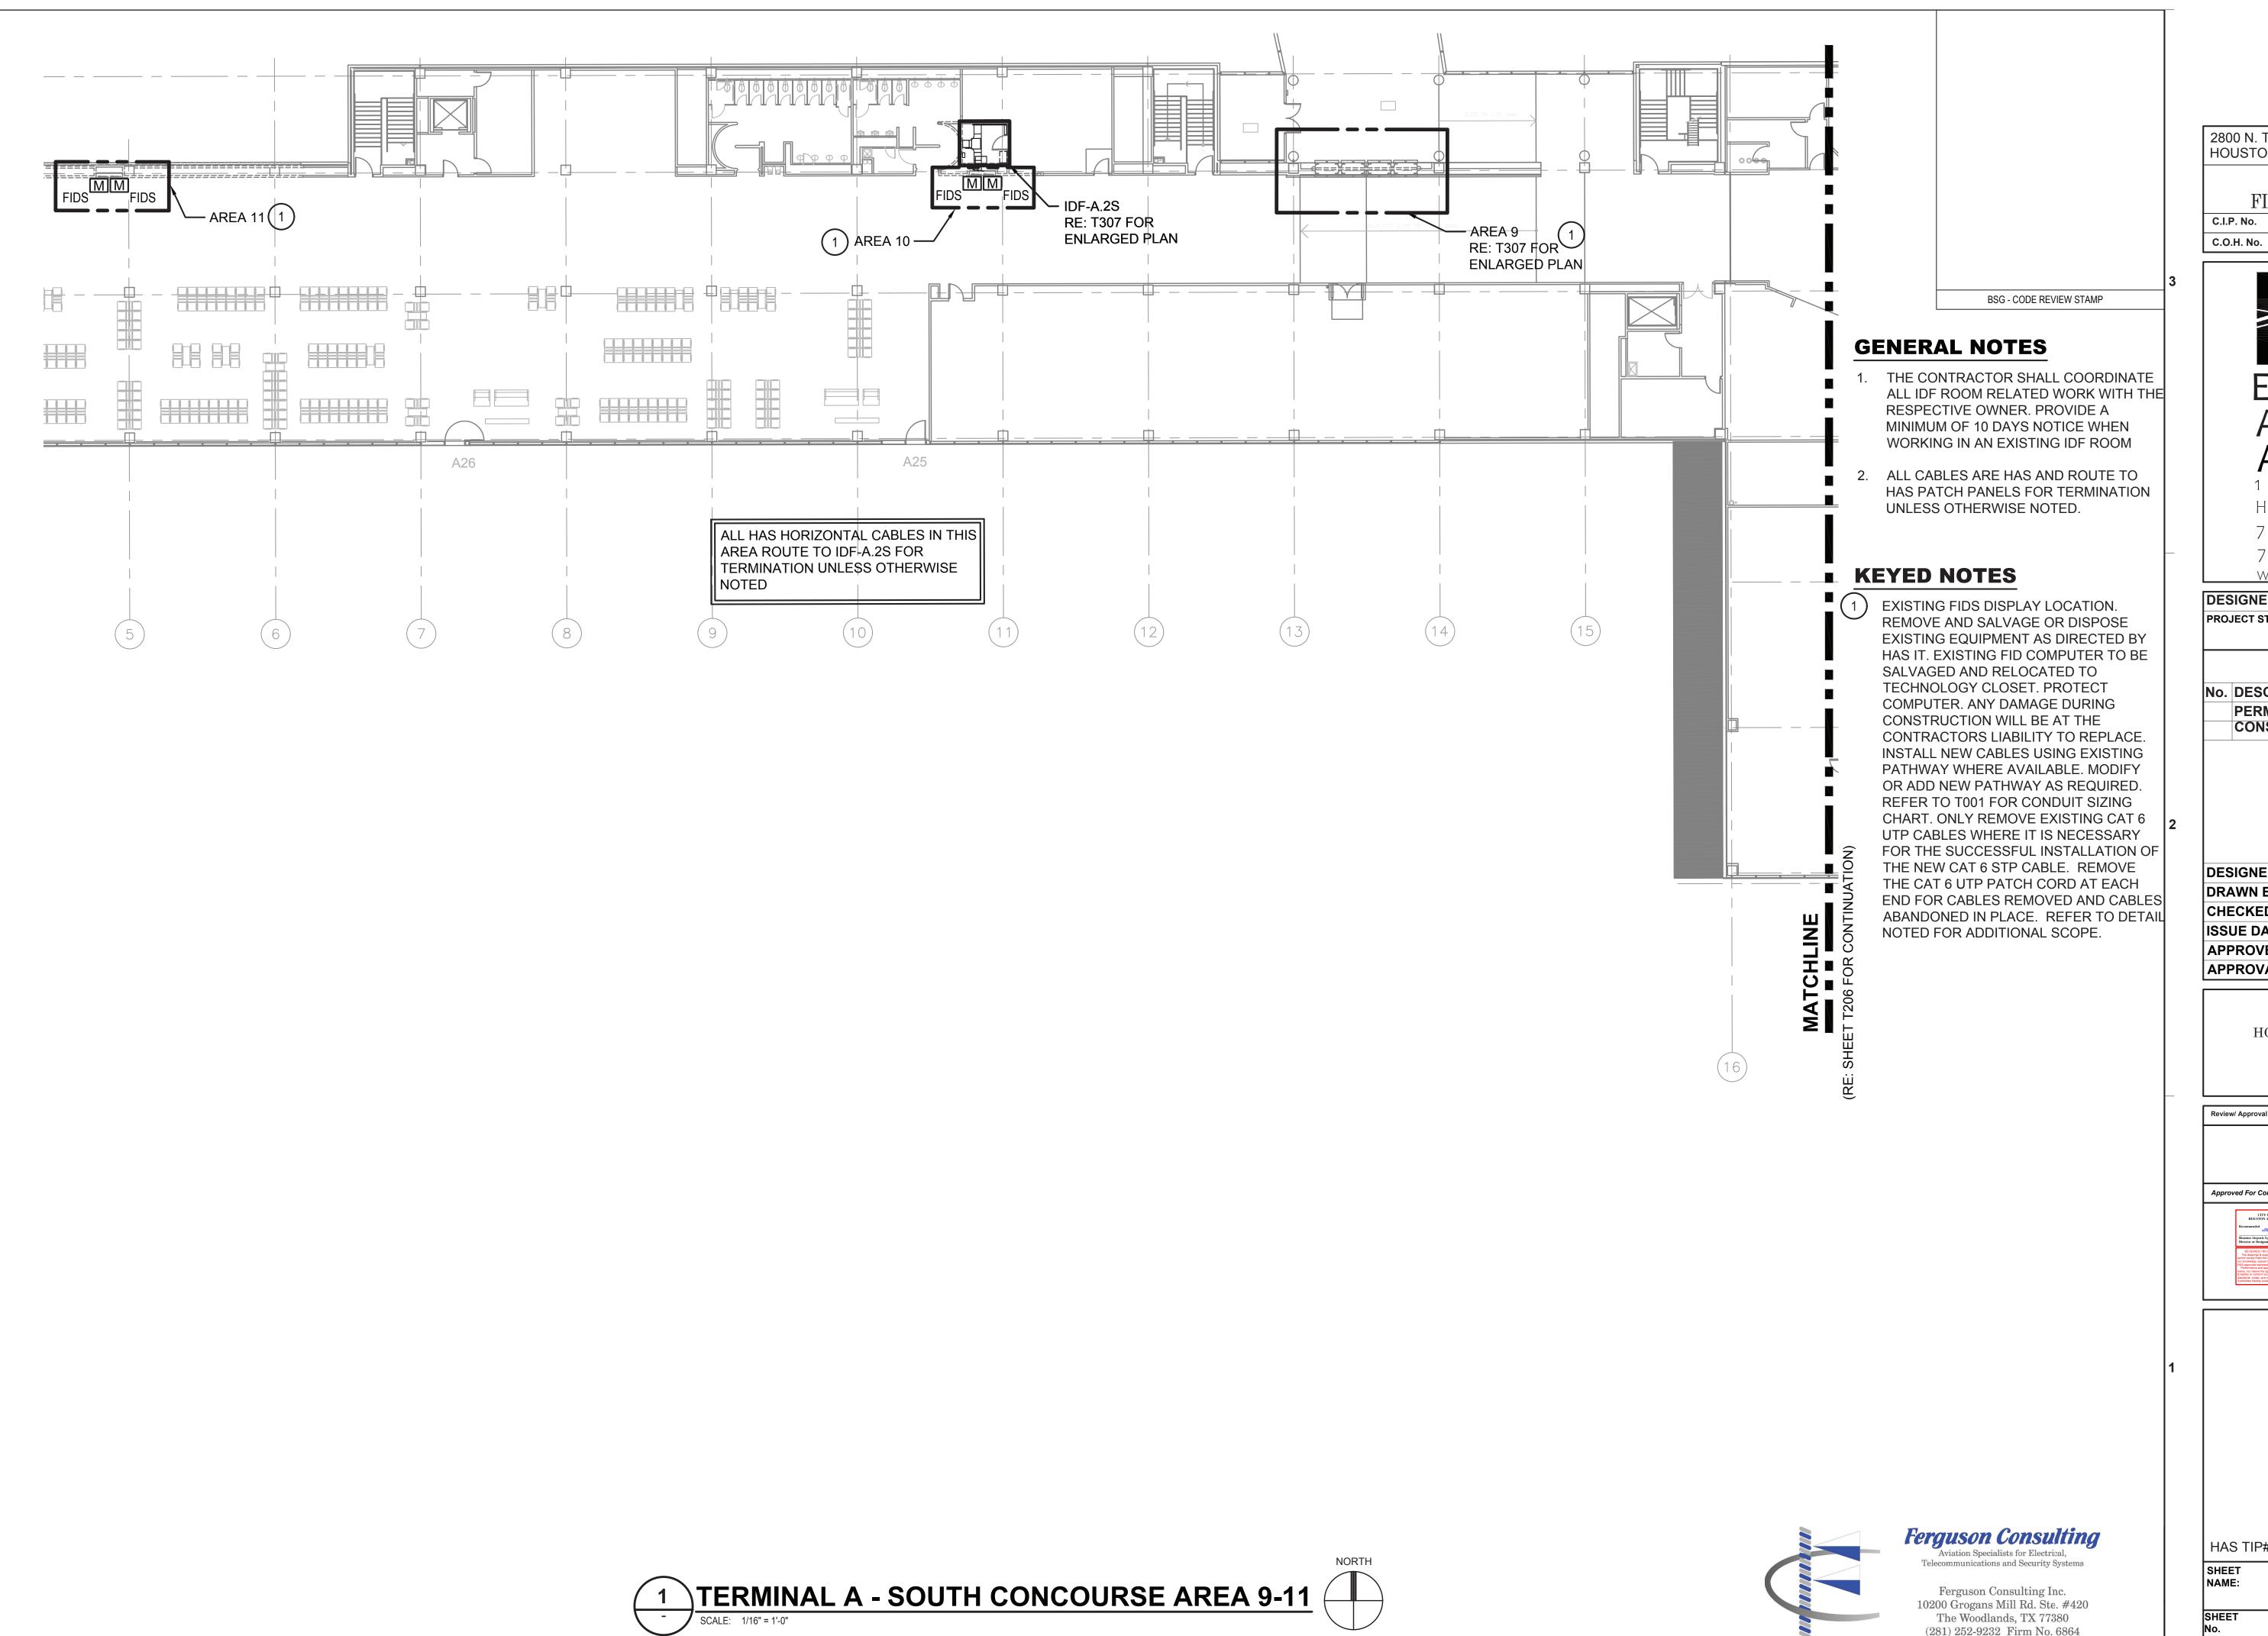
PHASE 2

### DATE 01/27/2023

DESIGNER:	СР
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ISSUE DATE:	01/27/23
APPROVED BY:	LF
APPROVAL DATE:	

TERMINAL A - NORTH **CONCOURSE AREA 7-8** 

As indicated





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### **REVISIONS**

DATE No. DESCRIPTION 01/27/2023 PERMIT, BID & CONSTRUCTION

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APPROVED BY:	LF
APPROVAL DATE:	

DIRECTOR

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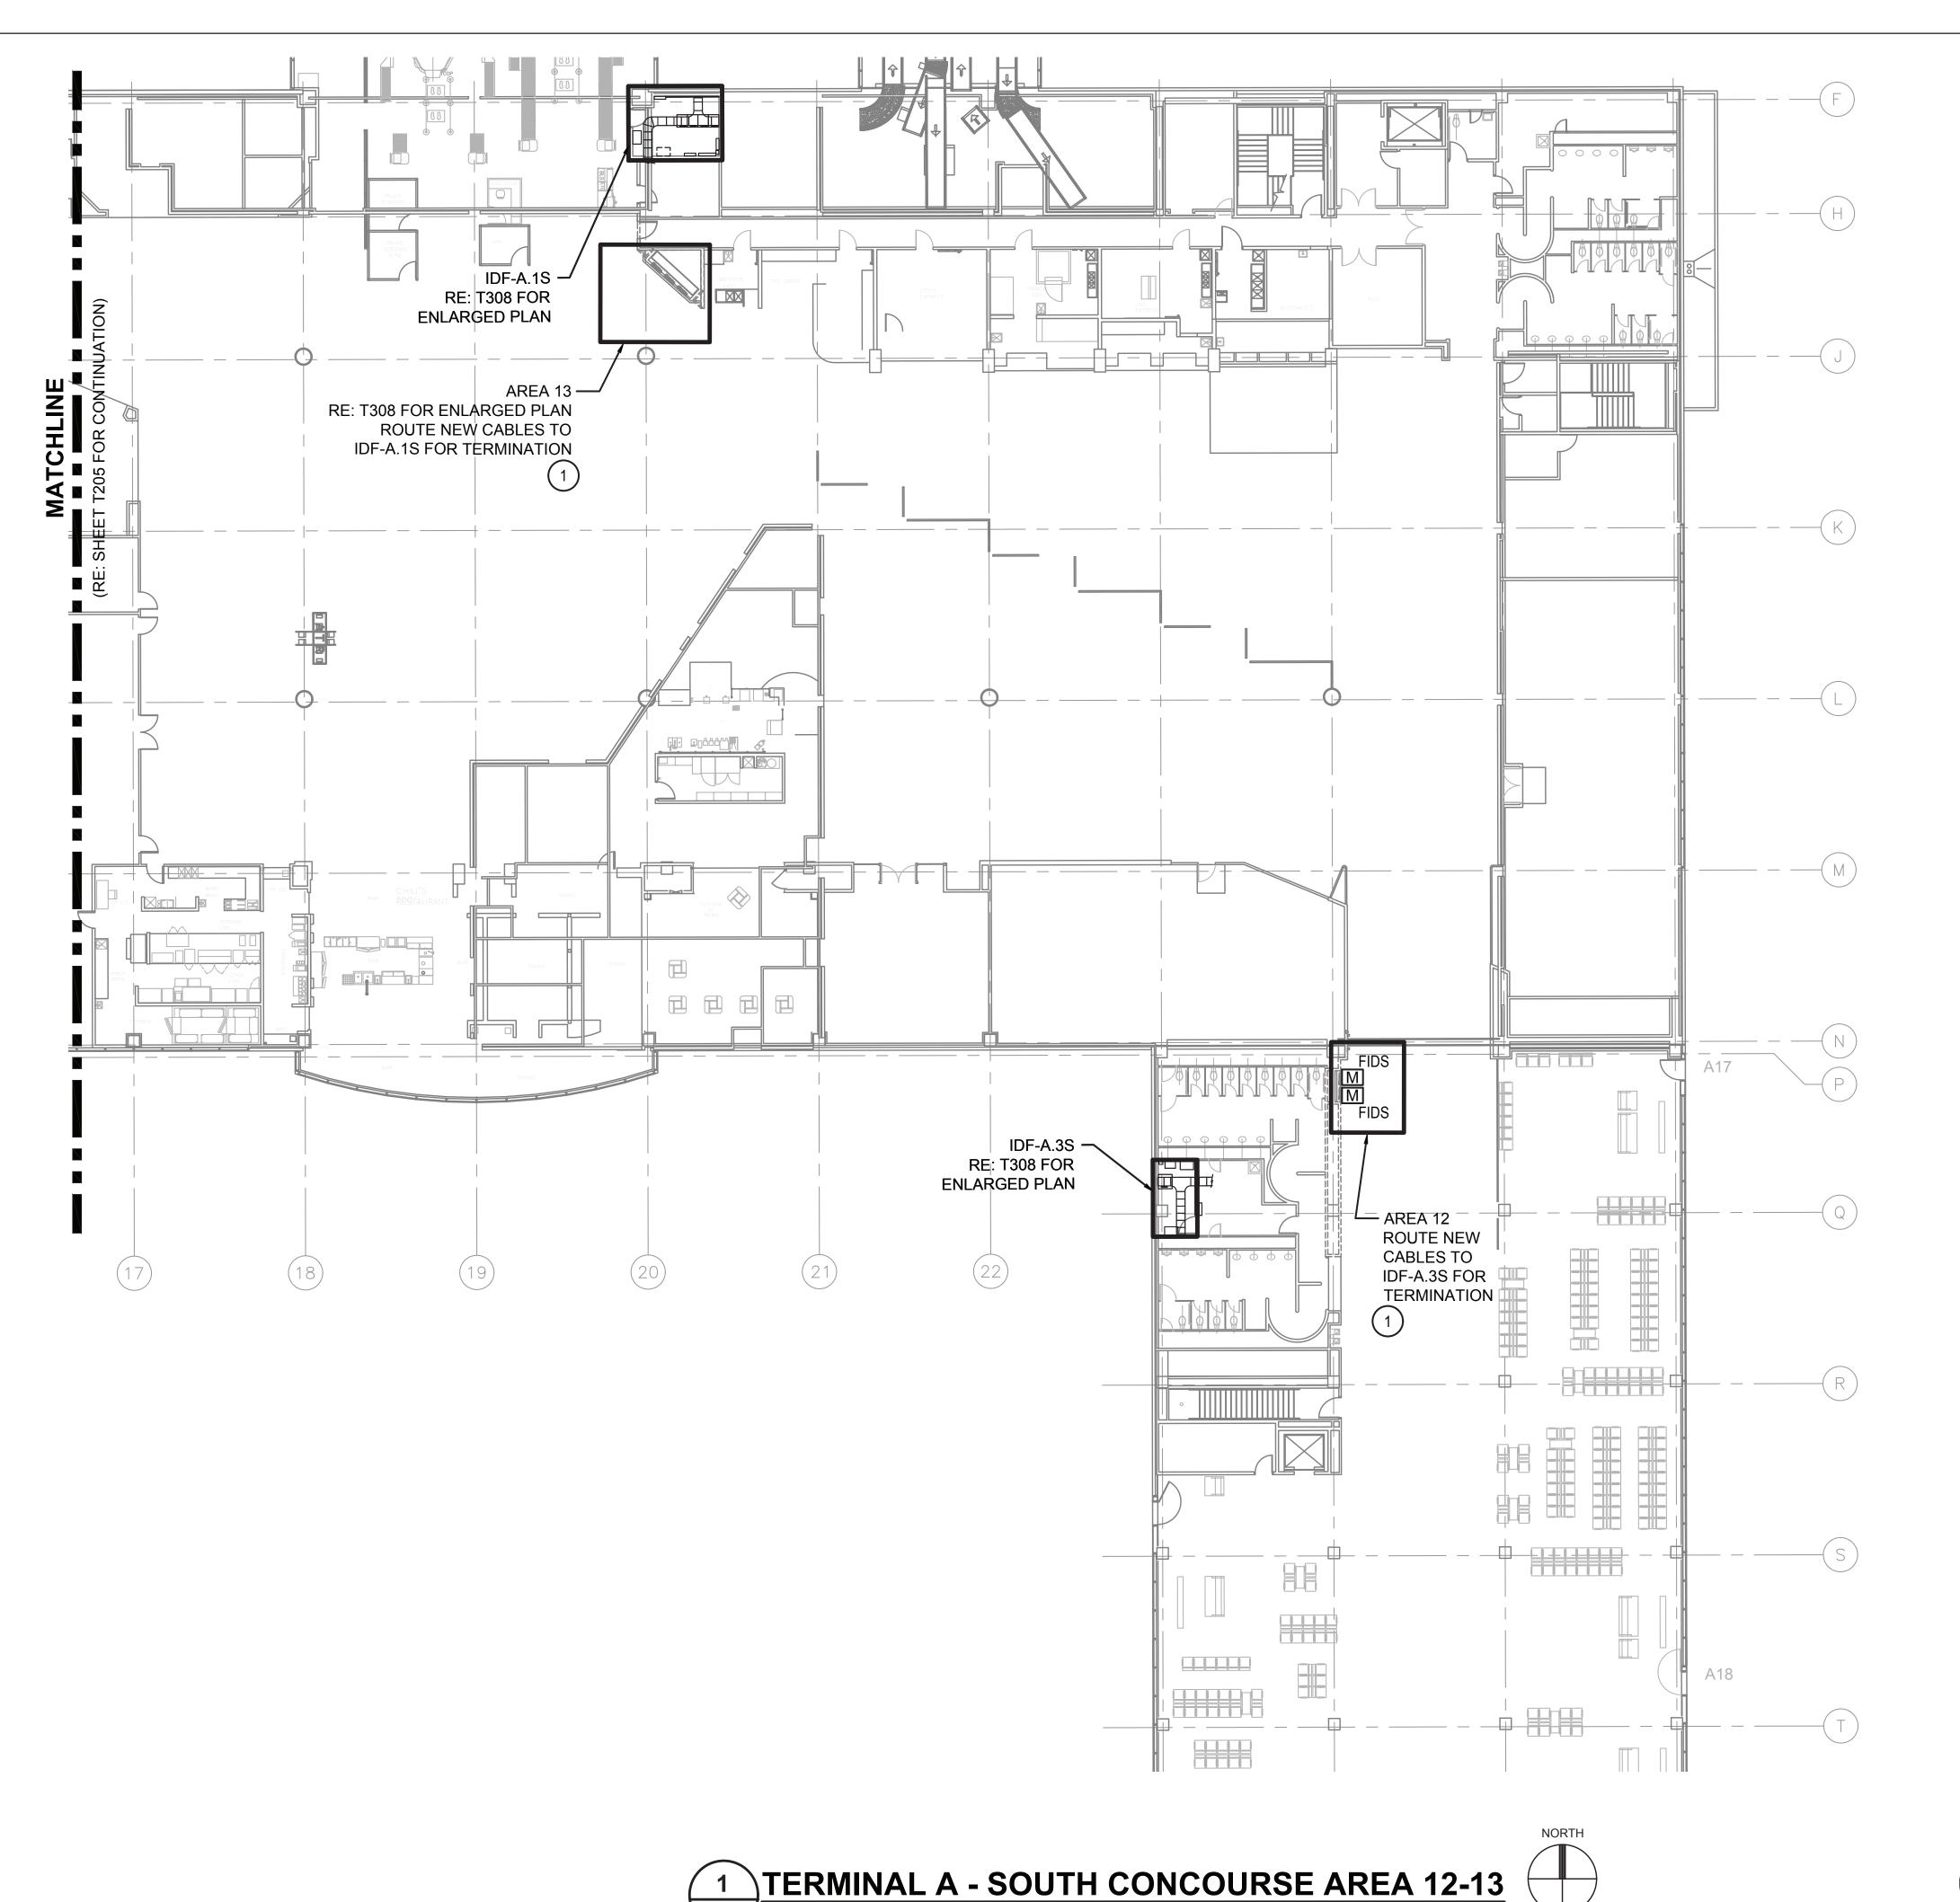
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HAS TIP# TBD

TERMINAL A - SOUTH **CONCOURSE AREA 9-11** 

As indicated



BSG - CODE REVIEW STAMP

#### **GENERAL NOTES**

- 1. THE CONTRACTOR SHALL COORDINATE ALL IDF ROOM RELATED WORK WITH THE RESPECTIVE OWNER. PROVIDE A MINIMUM OF 10 DAYS NOTICE WHEN WORKING IN AN EXISTING IDF ROOM
- 2. ALL CABLES ARE HAS AND ROUTE TO HAS PATCH PANELS FOR TERMINATION UNLESS OTHERWISE NOTED.

#### **KEYED NOTES**

EXISTING FIDS DISPLAY LOCATION. REMOVE AND SALVAGE OR DISPOSE EXISTING EQUIPMENT AS DIRECTED BY HAS IT. EXISTING FID COMPUTER TO BE SALVAGED AND RELOCATED TO TECHNOLOGY CLOSET. PROTECT COMPUTER. ANY DAMAGE DURING CONSTRUCTION WILL BE AT THE CONTRACTORS LIABILITY TO REPLACE. INSTALL NEW CABLES USING EXISTING PATHWAY WHERE AVAILABLE. MODIFY OR ADD NEW PATHWAY AS REQUIRED. REFER TO T001 FOR CONDUIT SIZING CHART. ONLY REMOVE EXISTING CAT 6 UTP CABLES WHERE IT IS NECESSARY FOR THE SUCCESSFUL INSTALLATION OF THE NEW CAT 6 STP CABLE. REMOVE THE CAT 6 UTP PATCH CORD AT EACH END FOR CABLES REMOVED AND CABLES ABANDONED IN PLACE. REFER TO DETAIL NOTED FOR ADDITIONAL SCOPE.



2800 N. TERMINAL RD. HOUSTON, TEXAS 77032 HAS TERMINAL A FIDS & BID LED LIGHTS A.I.P. No.

D.O.A No.



C.I.P. No.

C.O.H. No.

## ENGLISH + **ASSOCIATES ARCHITECTS**

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**DESIGNER PROJECT No.:** 21011.05 PROJECT STATUS: PHASE 2

### **REVISIONS**


No.	DESCRIPTION	DATE	BY
	PERMIT, BID &	01/27/2023	
	CONSTRUCTION		
	•		

DESIGNER:	CP
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ISSUE DATE:	01/27/23
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APPROVAL DATE:	

DIRECTOR HOUSTON AIRPORT SYSTEM

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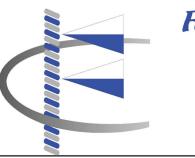
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TERMINAL A - SOUTH NAME: **CONCOURSE AREA 12-13** 


T-206 SCALE:

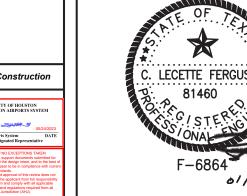As indicated

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Ferguson Consulting Aviation Specialists for Electrical, Telecommunications and Security Systems



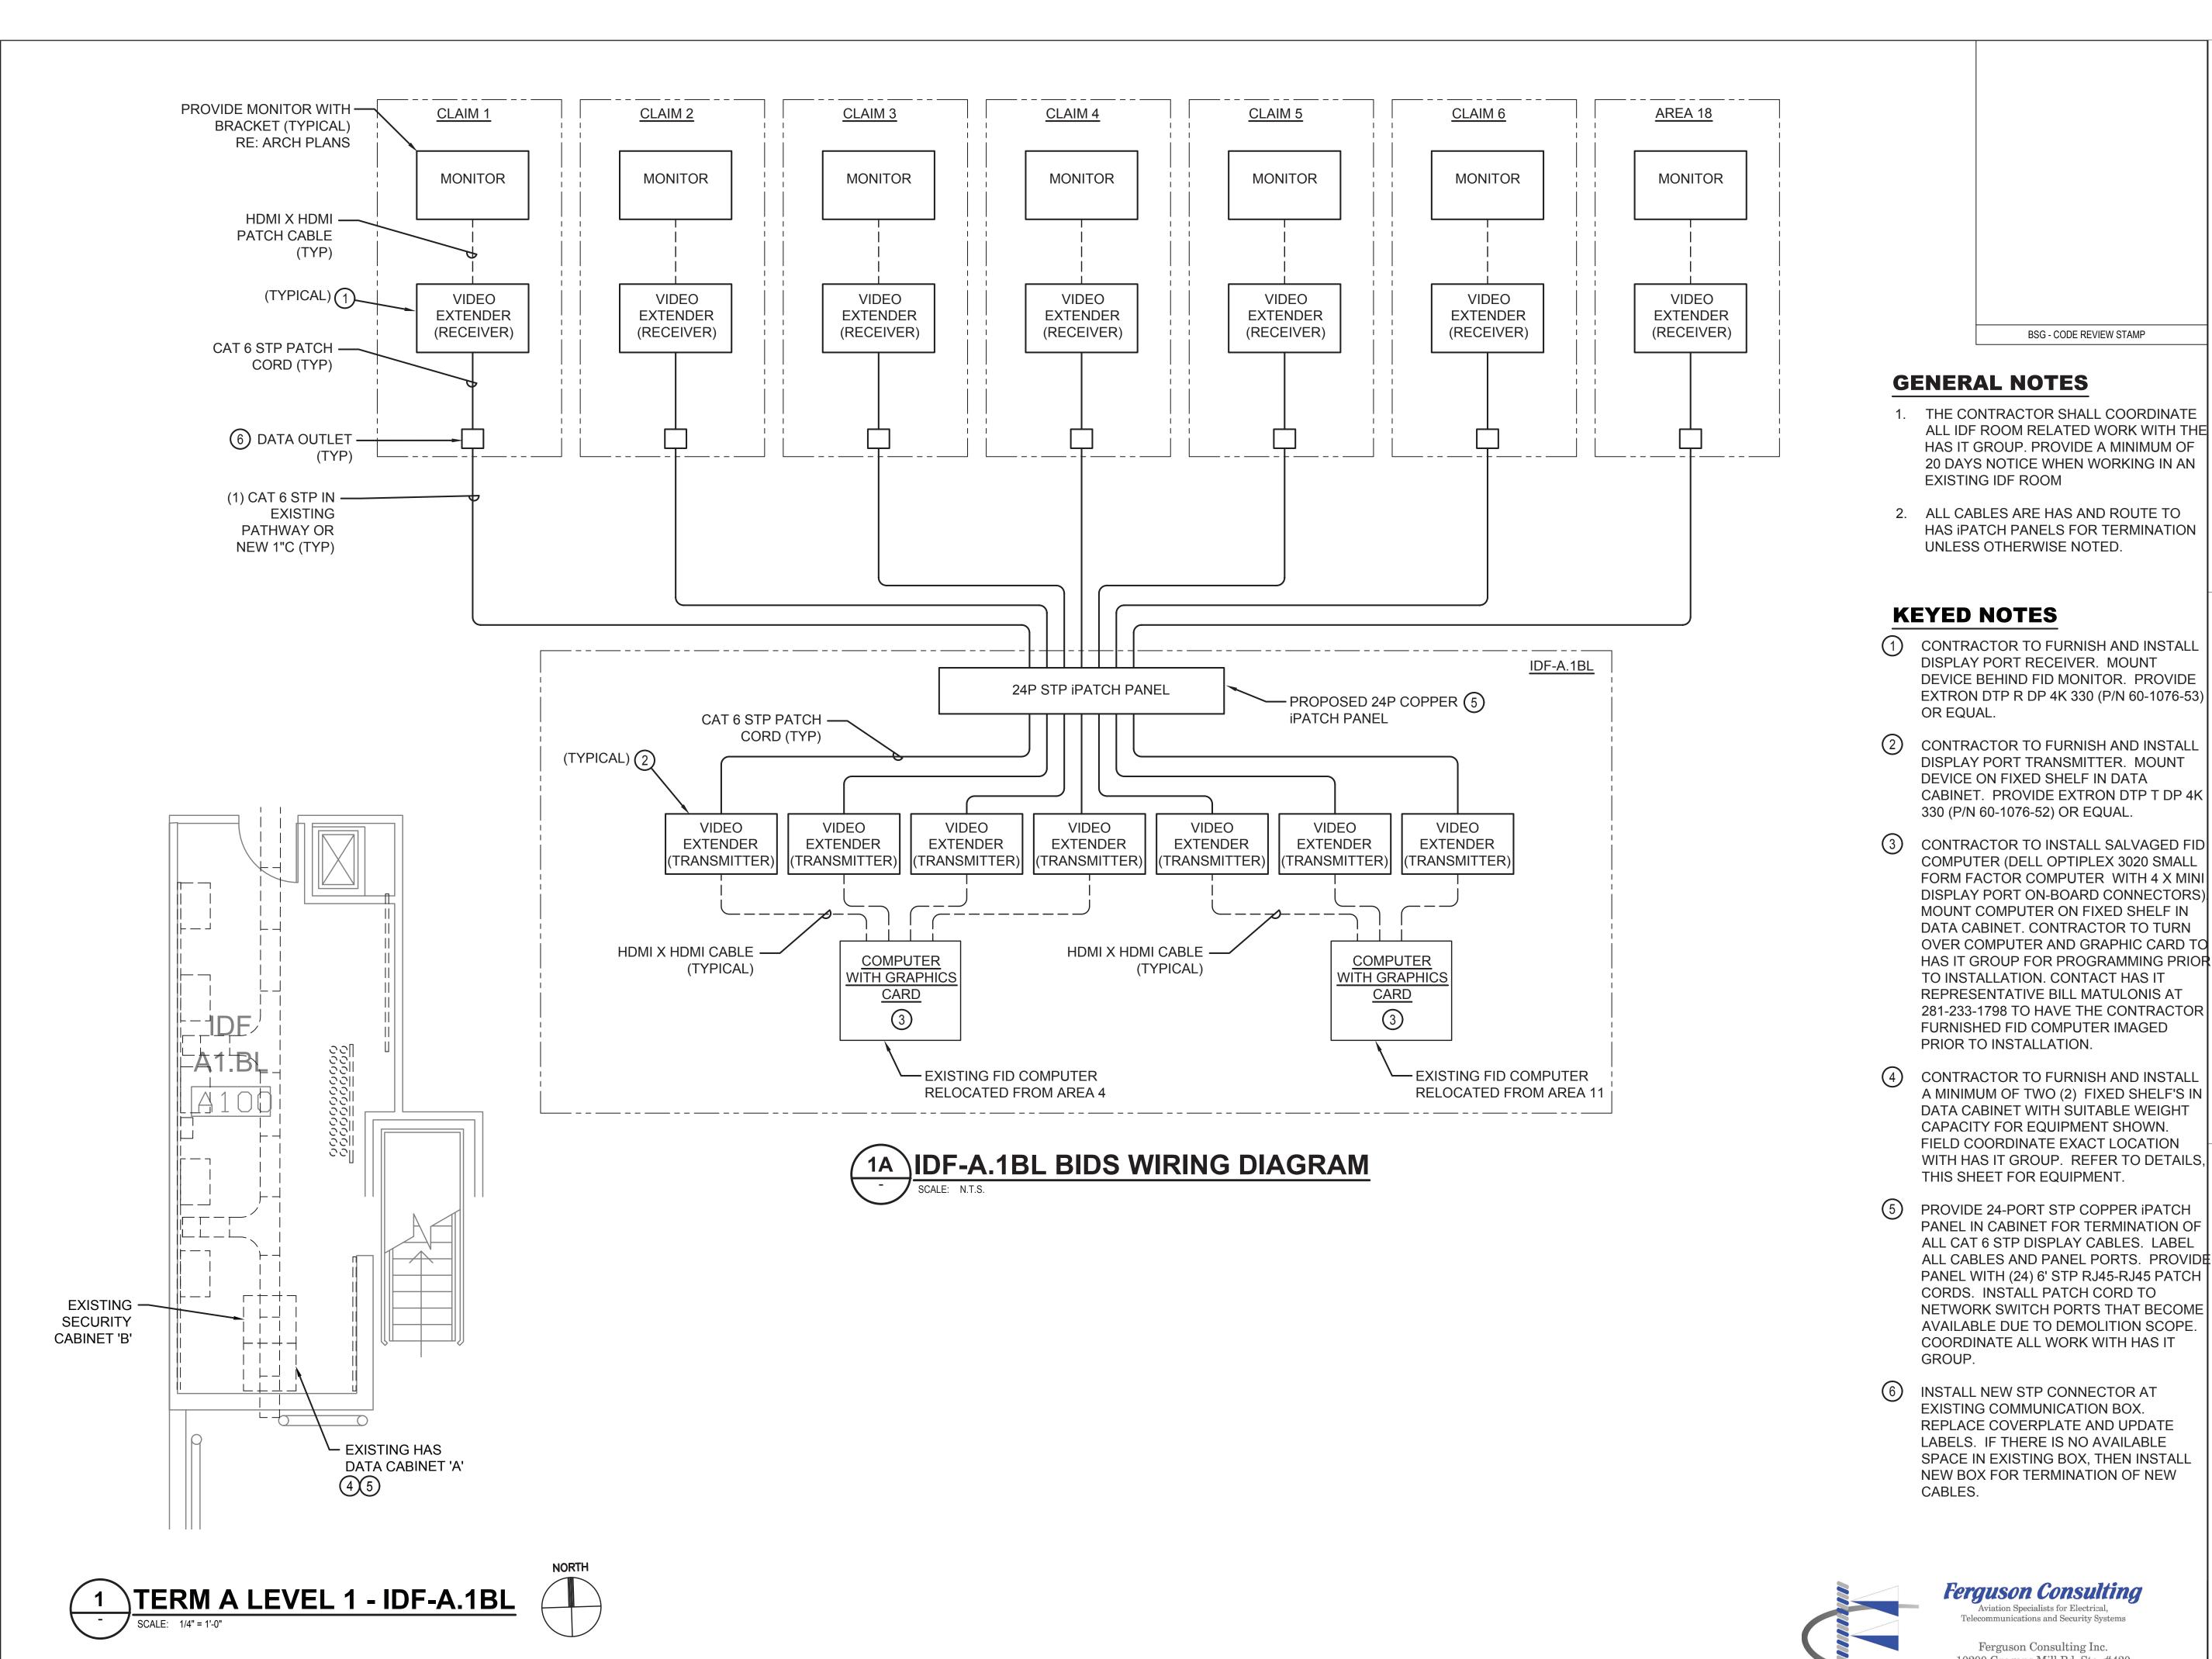

2800 N. TERMINAL RD. HOUSTON, TEXAS 77032 HAS TERMINAL A

FIDS & BID LED LIGHTS A.I.P. No. C.I.P. No.

D.O.A No.



C.O.H. No.

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### ENGLISH + **ASSOCIATES ARCHITECTS**

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**DESIGNER PROJECT No.:** 21011.05 PROJECT STATUS: PHASE 2

#### REVISIONS

REVISIONS			
No.	DESCRIPTION	DATE	BY
	PERMIT, BID &	01/27/2023	
	CONSTRUCTION		

DESIGNER:	СР
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APPROVAL DATE:	

DIRECTOR HOUSTON AIRPORT SYSTEM

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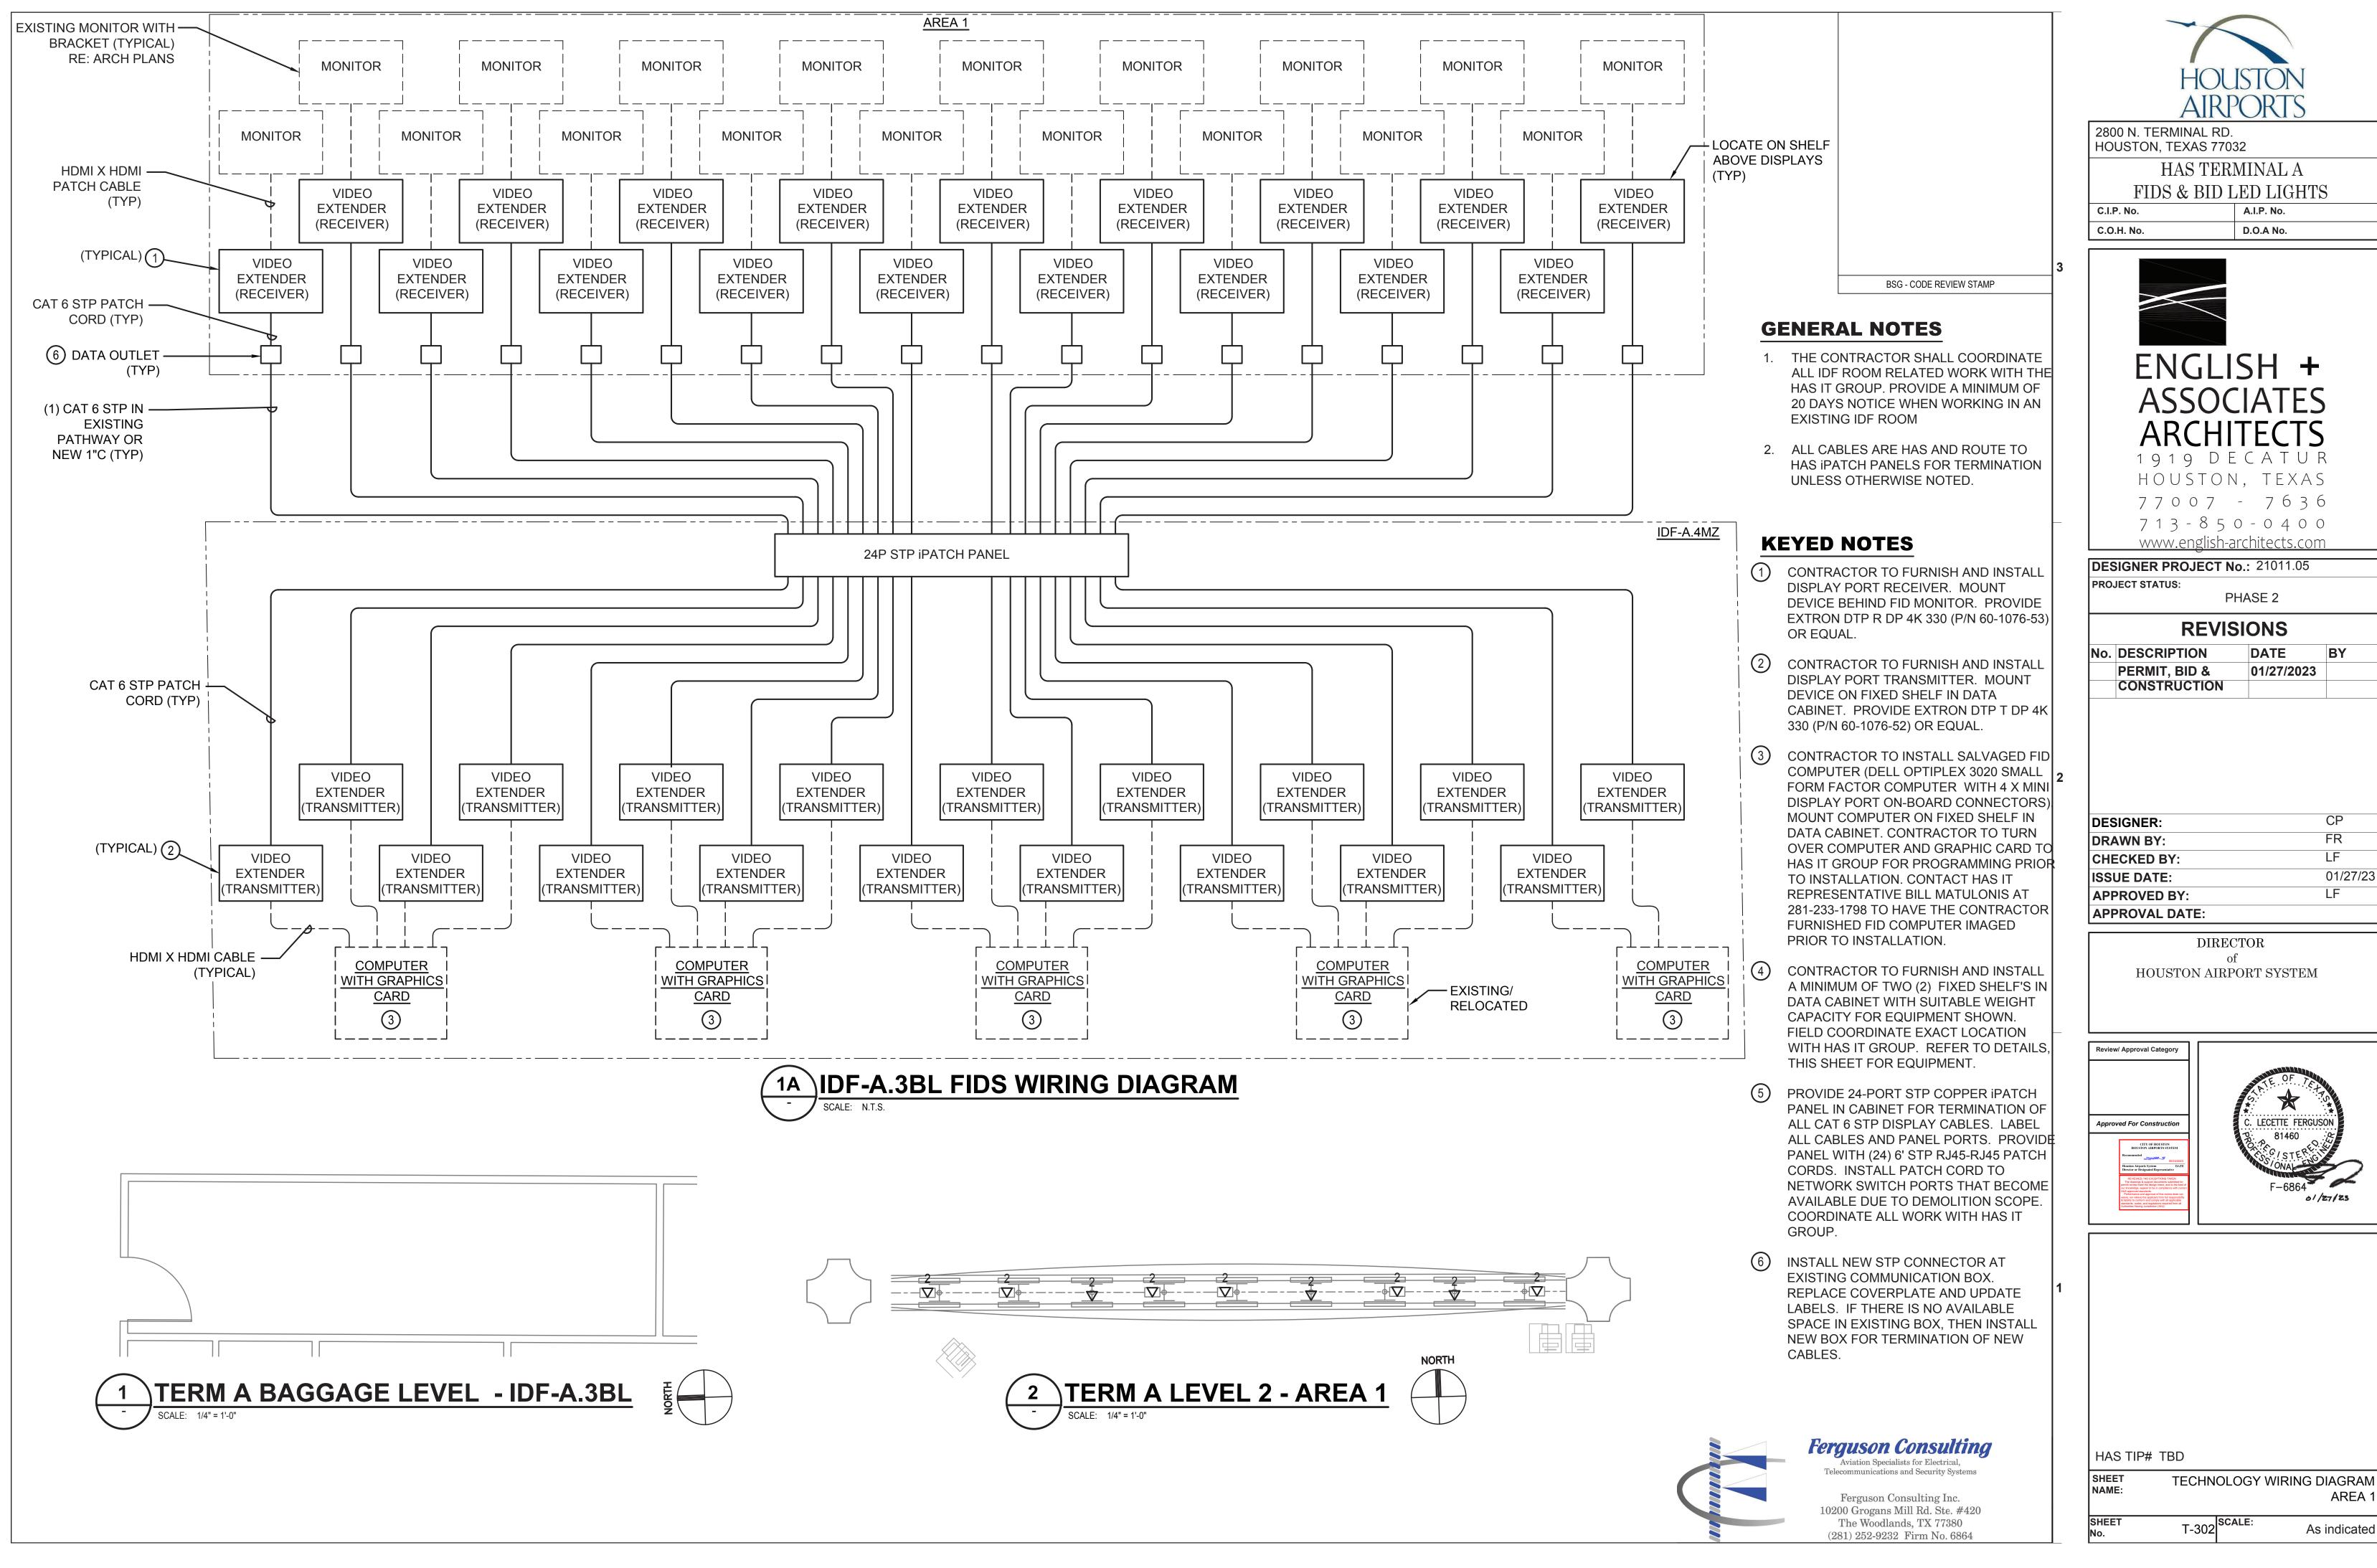
Ferguson Consulting Inc. 10200 Grogans Mill Rd. Ste. #420 The Woodlands, TX 77380 (281) 252-9232 Firm No. 6864

Ferguson Consulting

HAS TIP# TBD


TECHNOLOGY WIRING DIAGRAM NAME: AREA 14-18 T-301 SCALE:

As indicated




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APPROVAL DATE:	



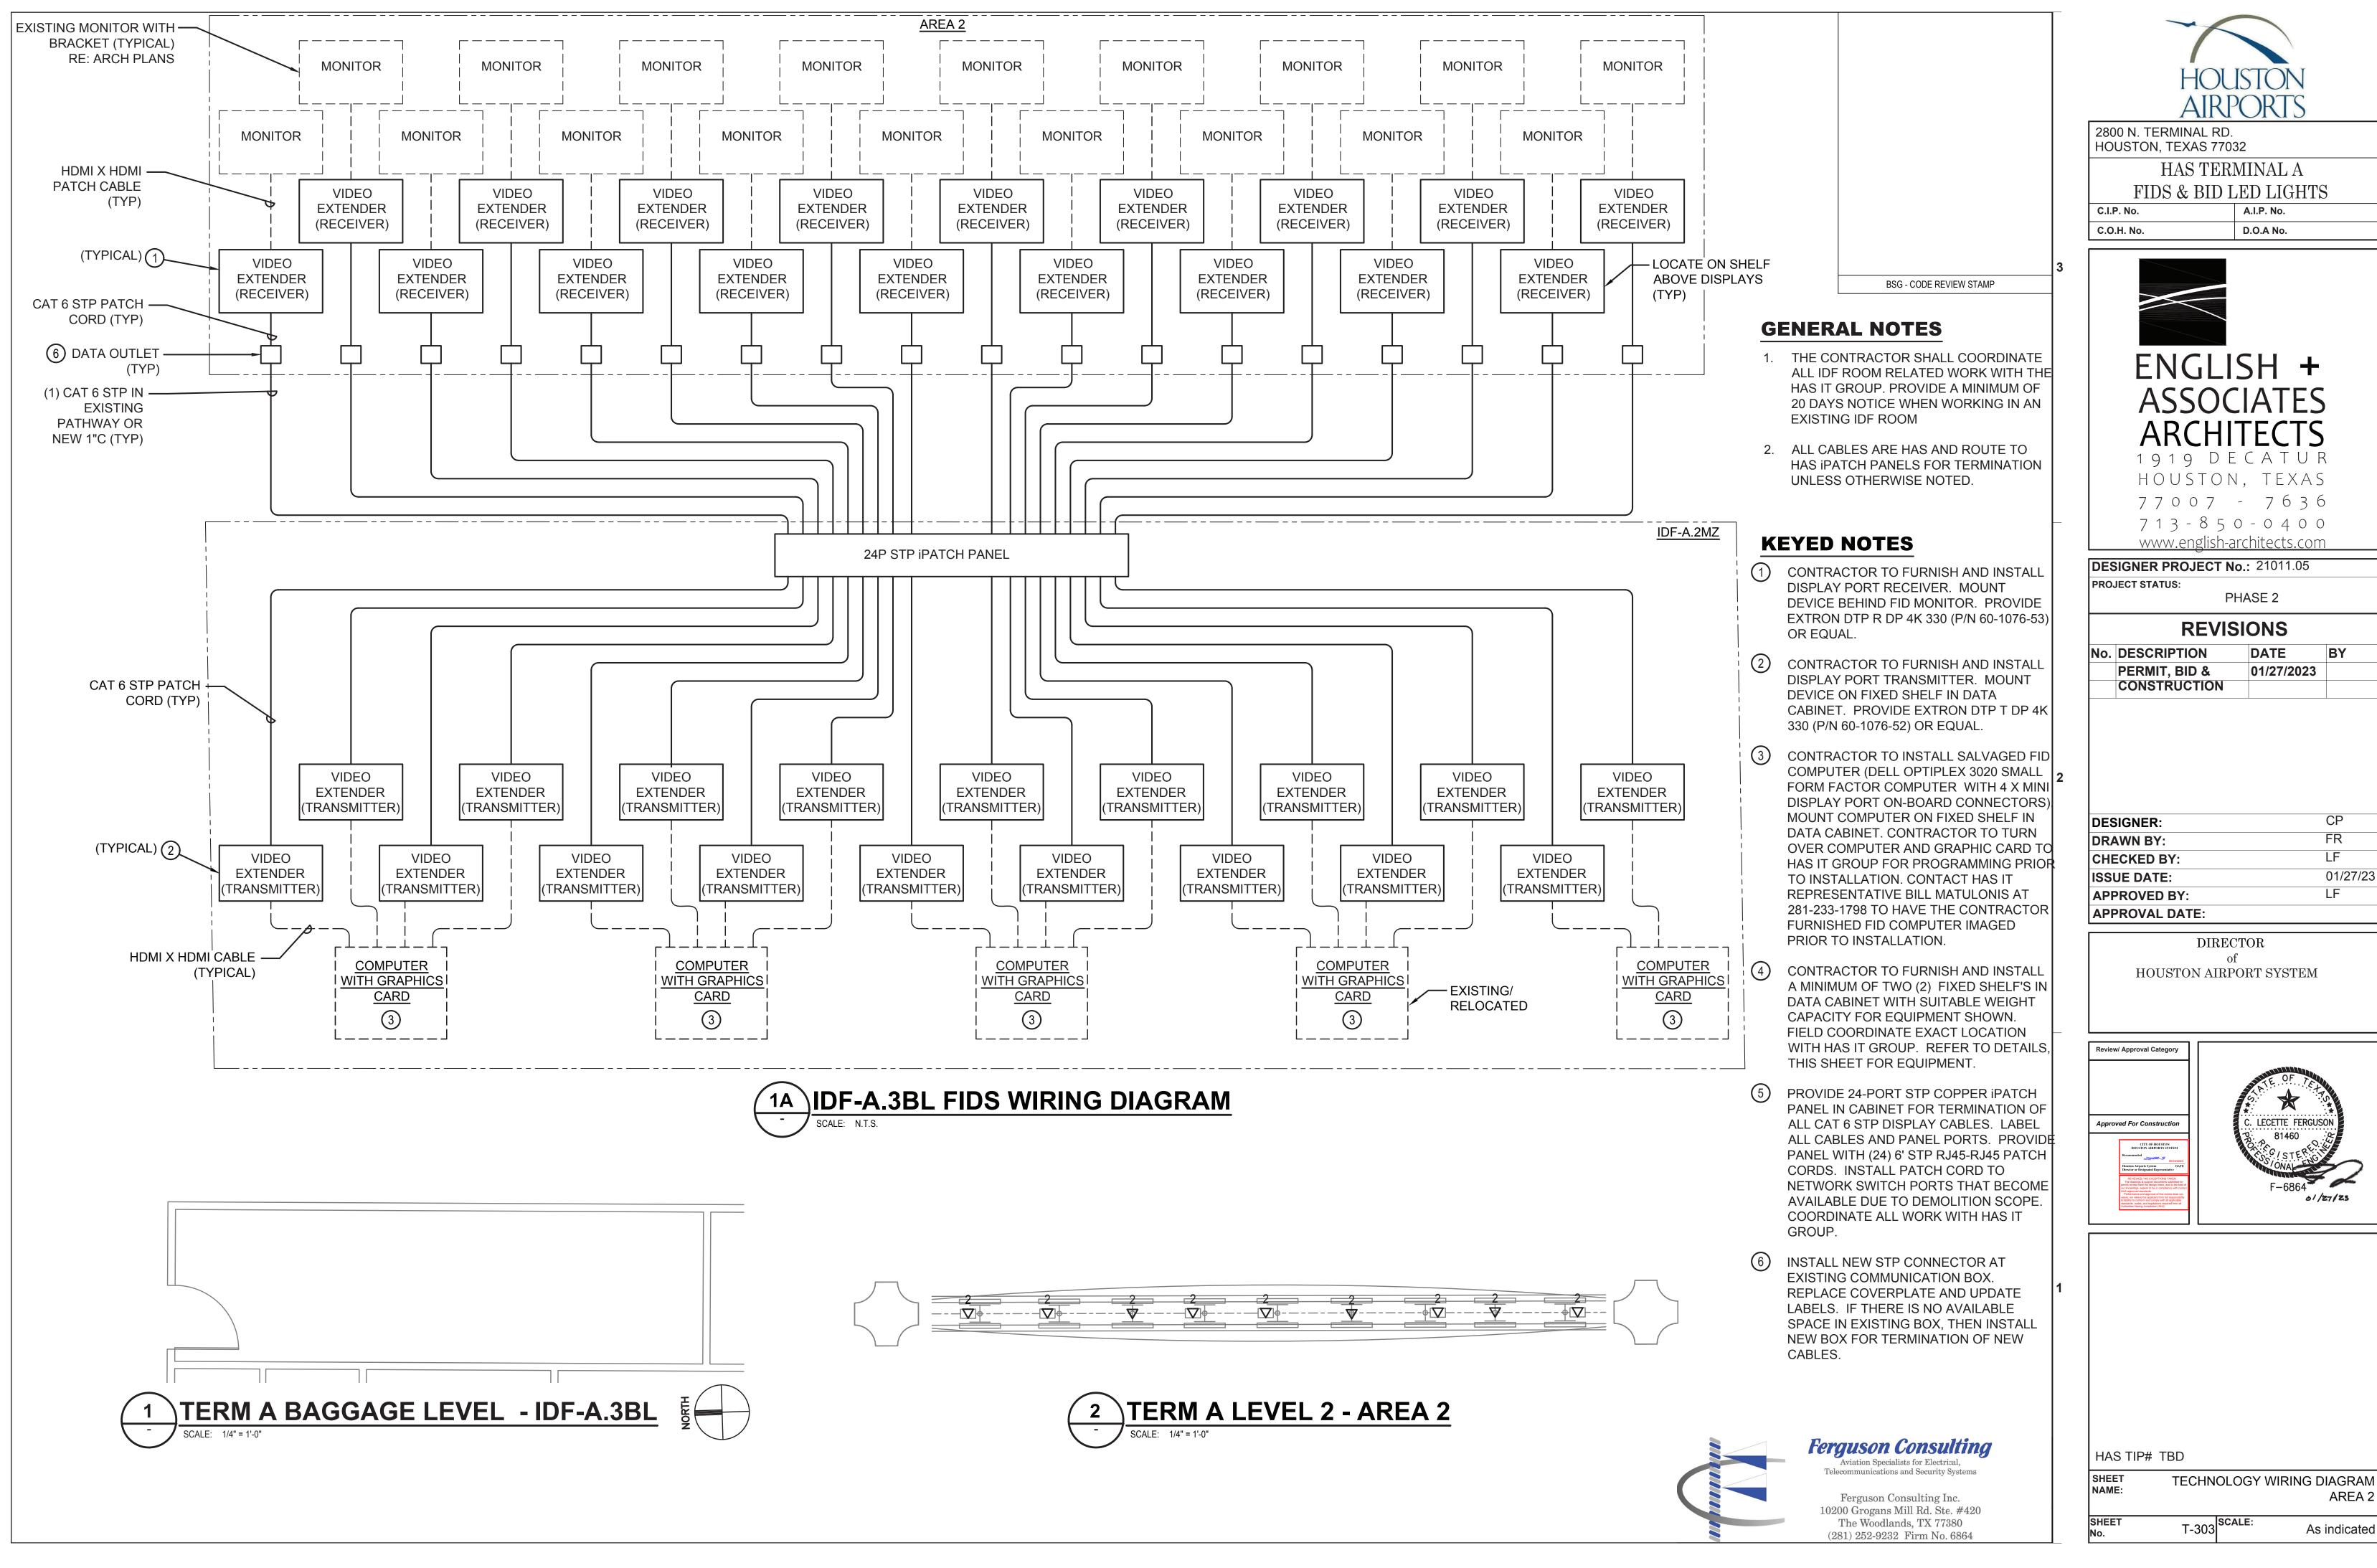

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DRAWN BY:	FR
CHECKED BY:	LF
ISSUE DATE:	01/27/23
APPROVED BY:	LF
APPROVAL DATE:	



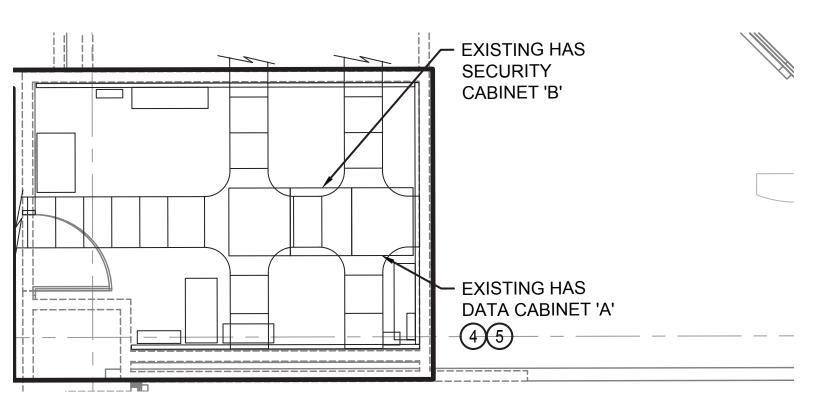

TERM A LEVEL 2 - IDF-A.1N



TERM A LEVEL 2 - AREA 3 SCALE: 1/4" = 1'-0" PROVIDE MONITOR WITH -AREA 3 BRACKET (TYPICAL) RE: ARCH PLANS **MONITOR** MONITOR **MONITOR MONITOR MONITOR MONITOR** HDMI X HDMI PATCH CABLE (TYP)  $\stackrel{+}{ o}$  LOCATED IN CABINET BELOW DISPLAY (TYP) (TYPICAL) (1) **VIDEO VIDEO VIDEO VIDEO VIDEO VIDEO EXTENDER EXTENDER EXTENDER EXTENDER EXTENDER** EXTENDER (RECEIVER) (RECEIVER) (RECEIVER) (RECEIVER) (RECEIVER) (RECEIVER) CAT 6 STP PATCH -CORD (TYP) (6) DATA OUTLET -(1) CAT 6 STP IN **EXISTING** PATHWAY OR NEW 1"C (TYP) **IDF-A.1N ROOM** 24P STP iPATCH PANEL CAT 6 STP PATCH — - PROPOSED 24P COPPER CORD (TYP) iPATCH PANEL (5) (TYPICAL) (2) **VIDEO VIDEO** VIDEO **VIDEO VIDEO VIDEO EXTENDER EXTENDER EXTENDER EXTENDER** EXTENDER **EXTENDER** (TRANSMITTER) (TRANSMITTER) (TRANSMITTER) (TRANSMITTER) (TRANSMITTER) (TRANSMITTER) - HDMI X HDMI CABLE (TYPICAL) COMPUTER COMPUTER WITH GRAPHICS WITH GRAPHICS CARD <u>CARD</u> 3

IDF-A.1N FIDS WIRING DIAGRAM


BSG - CODE REVIEW STAMP

#### **GENERAL NOTES**

- 1. THE CONTRACTOR SHALL COORDINATE ALL IDF ROOM RELATED WORK WITH THE HAS IT GROUP. PROVIDE A MINIMUM OF 20 DAYS NOTICE WHEN WORKING IN AN EXISTING IDF ROOM
- 2. ALL CABLES ARE HAS AND ROUTE TO HAS IPATCH PANELS FOR TERMINATION UNLESS OTHERWISE NOTED.

#### **KEYED NOTES**

- CONTRACTOR TO FURNISH AND INSTALL DISPLAY PORT RECEIVER. MOUNT DEVICE BEHIND FID MONITOR. PROVIDE EXTRON DTP R DP 4K 330 (P/N 60-1076-53) OR EQUAL.
- CONTRACTOR TO FURNISH AND INSTALI DISPLAY PORT TRANSMITTER. MOUNT DEVICE ON FIXED SHELF IN DATA CABINET. PROVIDE EXTRON DTP T DP 4K 330 (P/N 60-1076-52) OR EQUAL.
- CONTRACTOR TO INSTALL SALVAGED FID COMPUTER (DELL OPTIPLEX 3020 SMALL FORM FACTOR COMPUTER WITH 4 X MINI DISPLAY PORT ON-BOARD CONNECTORS) MOUNT COMPUTER ON FIXED SHELF IN DATA CABINET. CONTRACTOR TO TURN OVER COMPUTER AND GRAPHIC CARD T HAS IT GROUP FOR PROGRAMMING PRIOR TO INSTALLATION. CONTACT HAS IT REPRESENTATIVE BILL MATULONIS AT 281-233-1798 TO HAVE THE CONTRACTOR FURNISHED FID COMPUTER IMAGED PRIOR TO INSTALLATION.
- CONTRACTOR TO FURNISH AND INSTALI A MINIMUM OF TWO (2) FIXED SHELF'S IN DATA CABINET WITH SUITABLE WEIGHT CAPACITY FOR EQUIPMENT SHOWN. FIELD COORDINATE EXACT LOCATION WITH HAS IT GROUP. REFER TO DETAILS, THIS SHEET FOR EQUIPMENT.
- PROVIDE 24-PORT STP COPPER iPATCH PANEL IN CABINET FOR TERMINATION OF ALL CAT 6 STP DISPLAY CABLES. LABEL ALL CABLES AND PANEL PORTS. PROVIDE PANEL WITH (24) 6' STP RJ45-RJ45 PATCH CORDS. INSTALL PATCH CORD TO NETWORK SWITCH PORTS THAT BECOME AVAILABLE DUE TO DEMOLITION SCOPE COORDINATE ALL WORK WITH HAS IT GROUP.
- INSTALL NEW STP CONNECTOR AT EXISTING COMMUNICATION BOX. REPLACE COVERPLATE AND UPDATE LABELS. IF THERE IS NO AVAILABLE SPACE IN EXISTING BOX, THEN INSTALL NEW BOX FOR TERMINATION OF NEW CABLES.

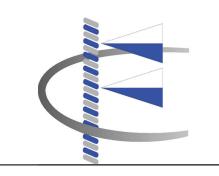

#### Ferguson Consulting

Aviation Specialists for Electrical, Telecommunications and Security Systems

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FIDS & BID LED LIGHTS C.I.P. No. A.I.P. No.

D.O.A No.



C.O.H. No.

### ENGLISH + **ASSOCIATES ARCHITECTS**

1919 DECATUR HOUSTON, TEXAS 77007 - 7636 713-850-0400 www.english-architects.com

**DESIGNER PROJECT No.:** 21011.05 PROJECT STATUS: PHASE 2

#### DEVICIONO

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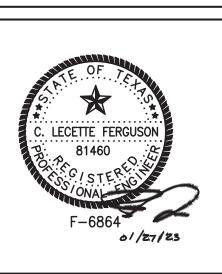
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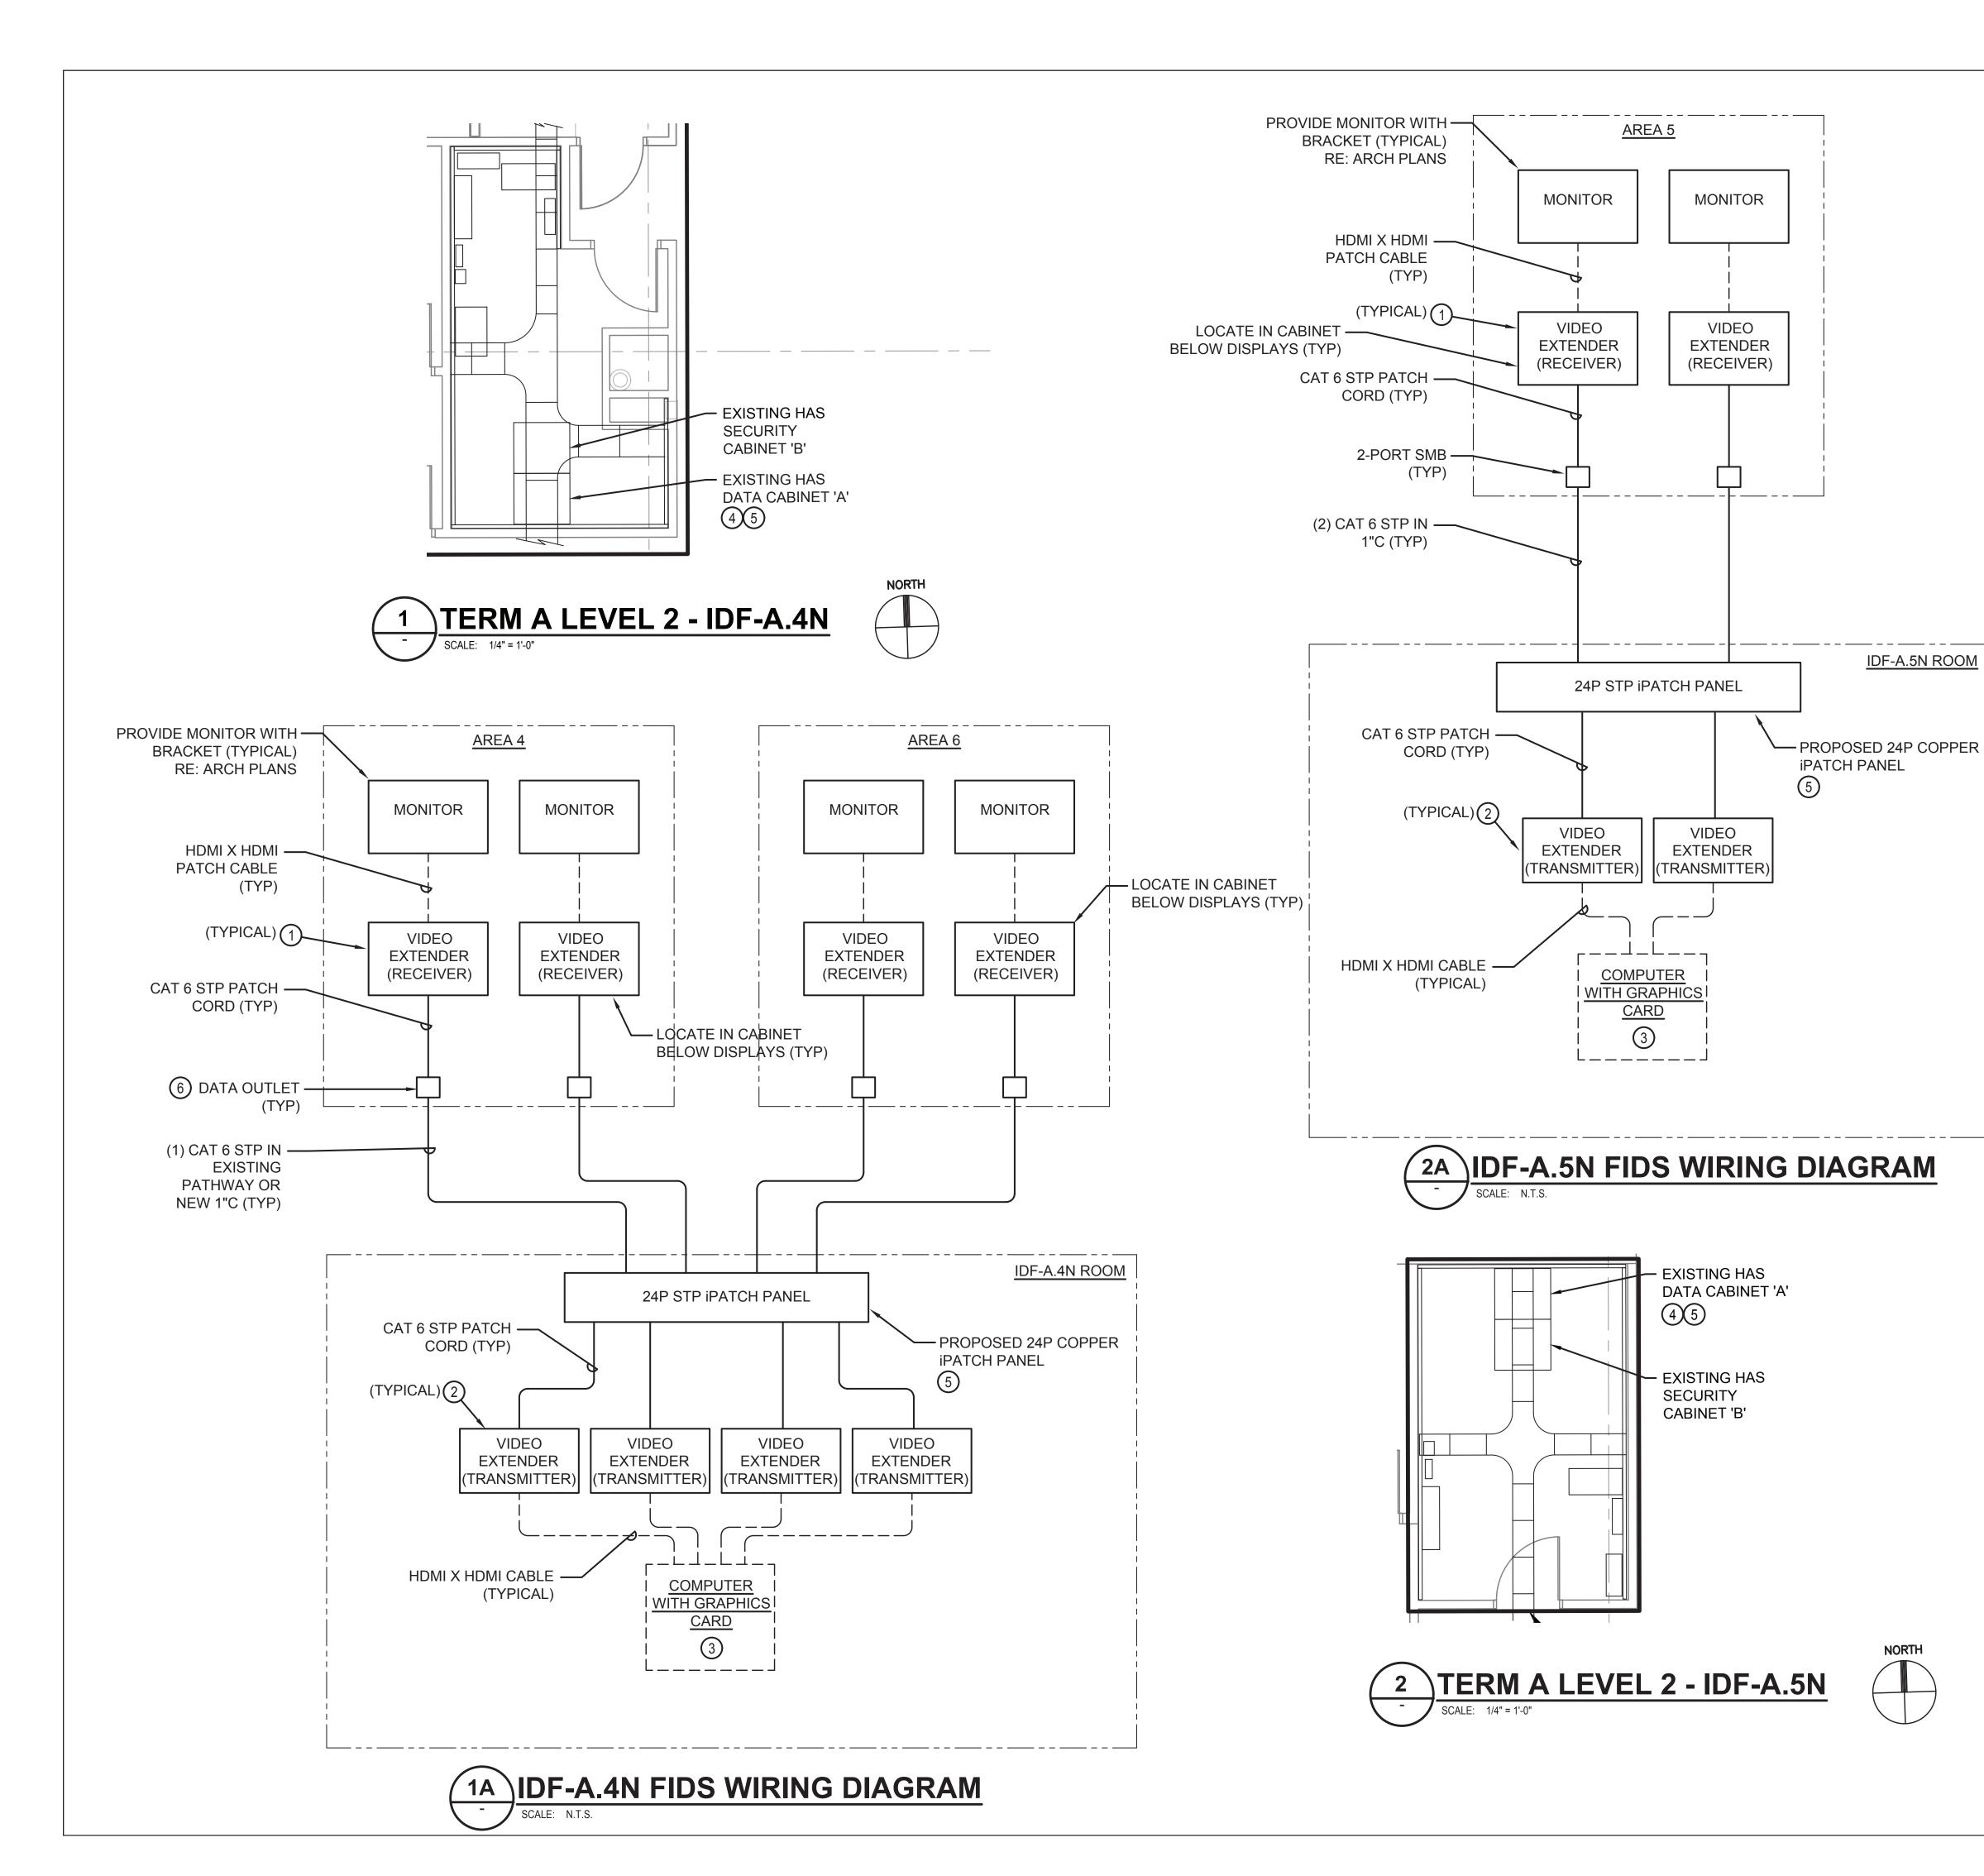




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**TECHNOLOGY WIRING DIAGRAM** NAME: AREA 3

T-304 SCALE: As indicated





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2. ALL CABLES ARE HAS AND ROUTE TO

UNLESS OTHERWISE NOTED.

ALL IDF ROOM RELATED WORK WITH THE

HAS IT GROUP. PROVIDE A MINIMUM OF

20 DAYS NOTICE WHEN WORKING IN AN

HAS IPATCH PANELS FOR TERMINATION

CONTRACTOR TO FURNISH AND INSTALL

DEVICE BEHIND FID MONITOR. PROVIDE

CONTRACTOR TO FURNISH AND INSTALI

DISPLAY PORT TRANSMITTER. MOUNT

CABINET. PROVIDE EXTRON DTP T DP 4K

CONTRACTOR TO INSTALL SALVAGED FID

FORM FACTOR COMPUTER WITH 4 X MINI

DISPLAY PORT ON-BOARD CONNECTORS)

MOUNT COMPUTER ON FIXED SHELF IN

DATA CABINET. CONTRACTOR TO TURN

OVER COMPUTER AND GRAPHIC CARD T

TO INSTALLATION. CONTACT HAS IT

FURNISHED FID COMPUTER IMAGED

PRIOR TO INSTALLATION.

THIS SHEET FOR EQUIPMENT.

REPRESENTATIVE BILL MATULONIS AT

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WITH HAS IT GROUP. REFER TO DETAILS,

PROVIDE 24-PORT STP COPPER iPATCH

PANEL IN CABINET FOR TERMINATION OF

ALL CABLES AND PANEL PORTS. PROVIDE

PANEL WITH (24) 6' STP RJ45-RJ45 PATCH

NETWORK SWITCH PORTS THAT BECOME AVAILABLE DUE TO DEMOLITION SCOPE

CORDS. INSTALL PATCH CORD TO

COORDINATE ALL WORK WITH HAS IT

REPLACE COVERPLATE AND UPDATE LABELS. IF THERE IS NO AVAILABLE

SPACE IN EXISTING BOX, THEN INSTALL

NEW BOX FOR TERMINATION OF NEW

INSTALL NEW STP CONNECTOR AT EXISTING COMMUNICATION BOX.

GROUP.

CABLES.

ALL CAT 6 STP DISPLAY CABLES. LABEL

HAS IT GROUP FOR PROGRAMMING PRIOR

281-233-1798 TO HAVE THE CONTRACTOR

COMPUTER (DELL OPTIPLEX 3020 SMALL

DEVICE ON FIXED SHELF IN DATA

330 (P/N 60-1076-52) OR EQUAL.

EXTRON DTP R DP 4K 330 (P/N 60-1076-53)

DISPLAY PORT RECEIVER. MOUNT

**GENERAL NOTES** 

**EXISTING IDF ROOM** 

**KEYED NOTES** 

OR EQUAL.

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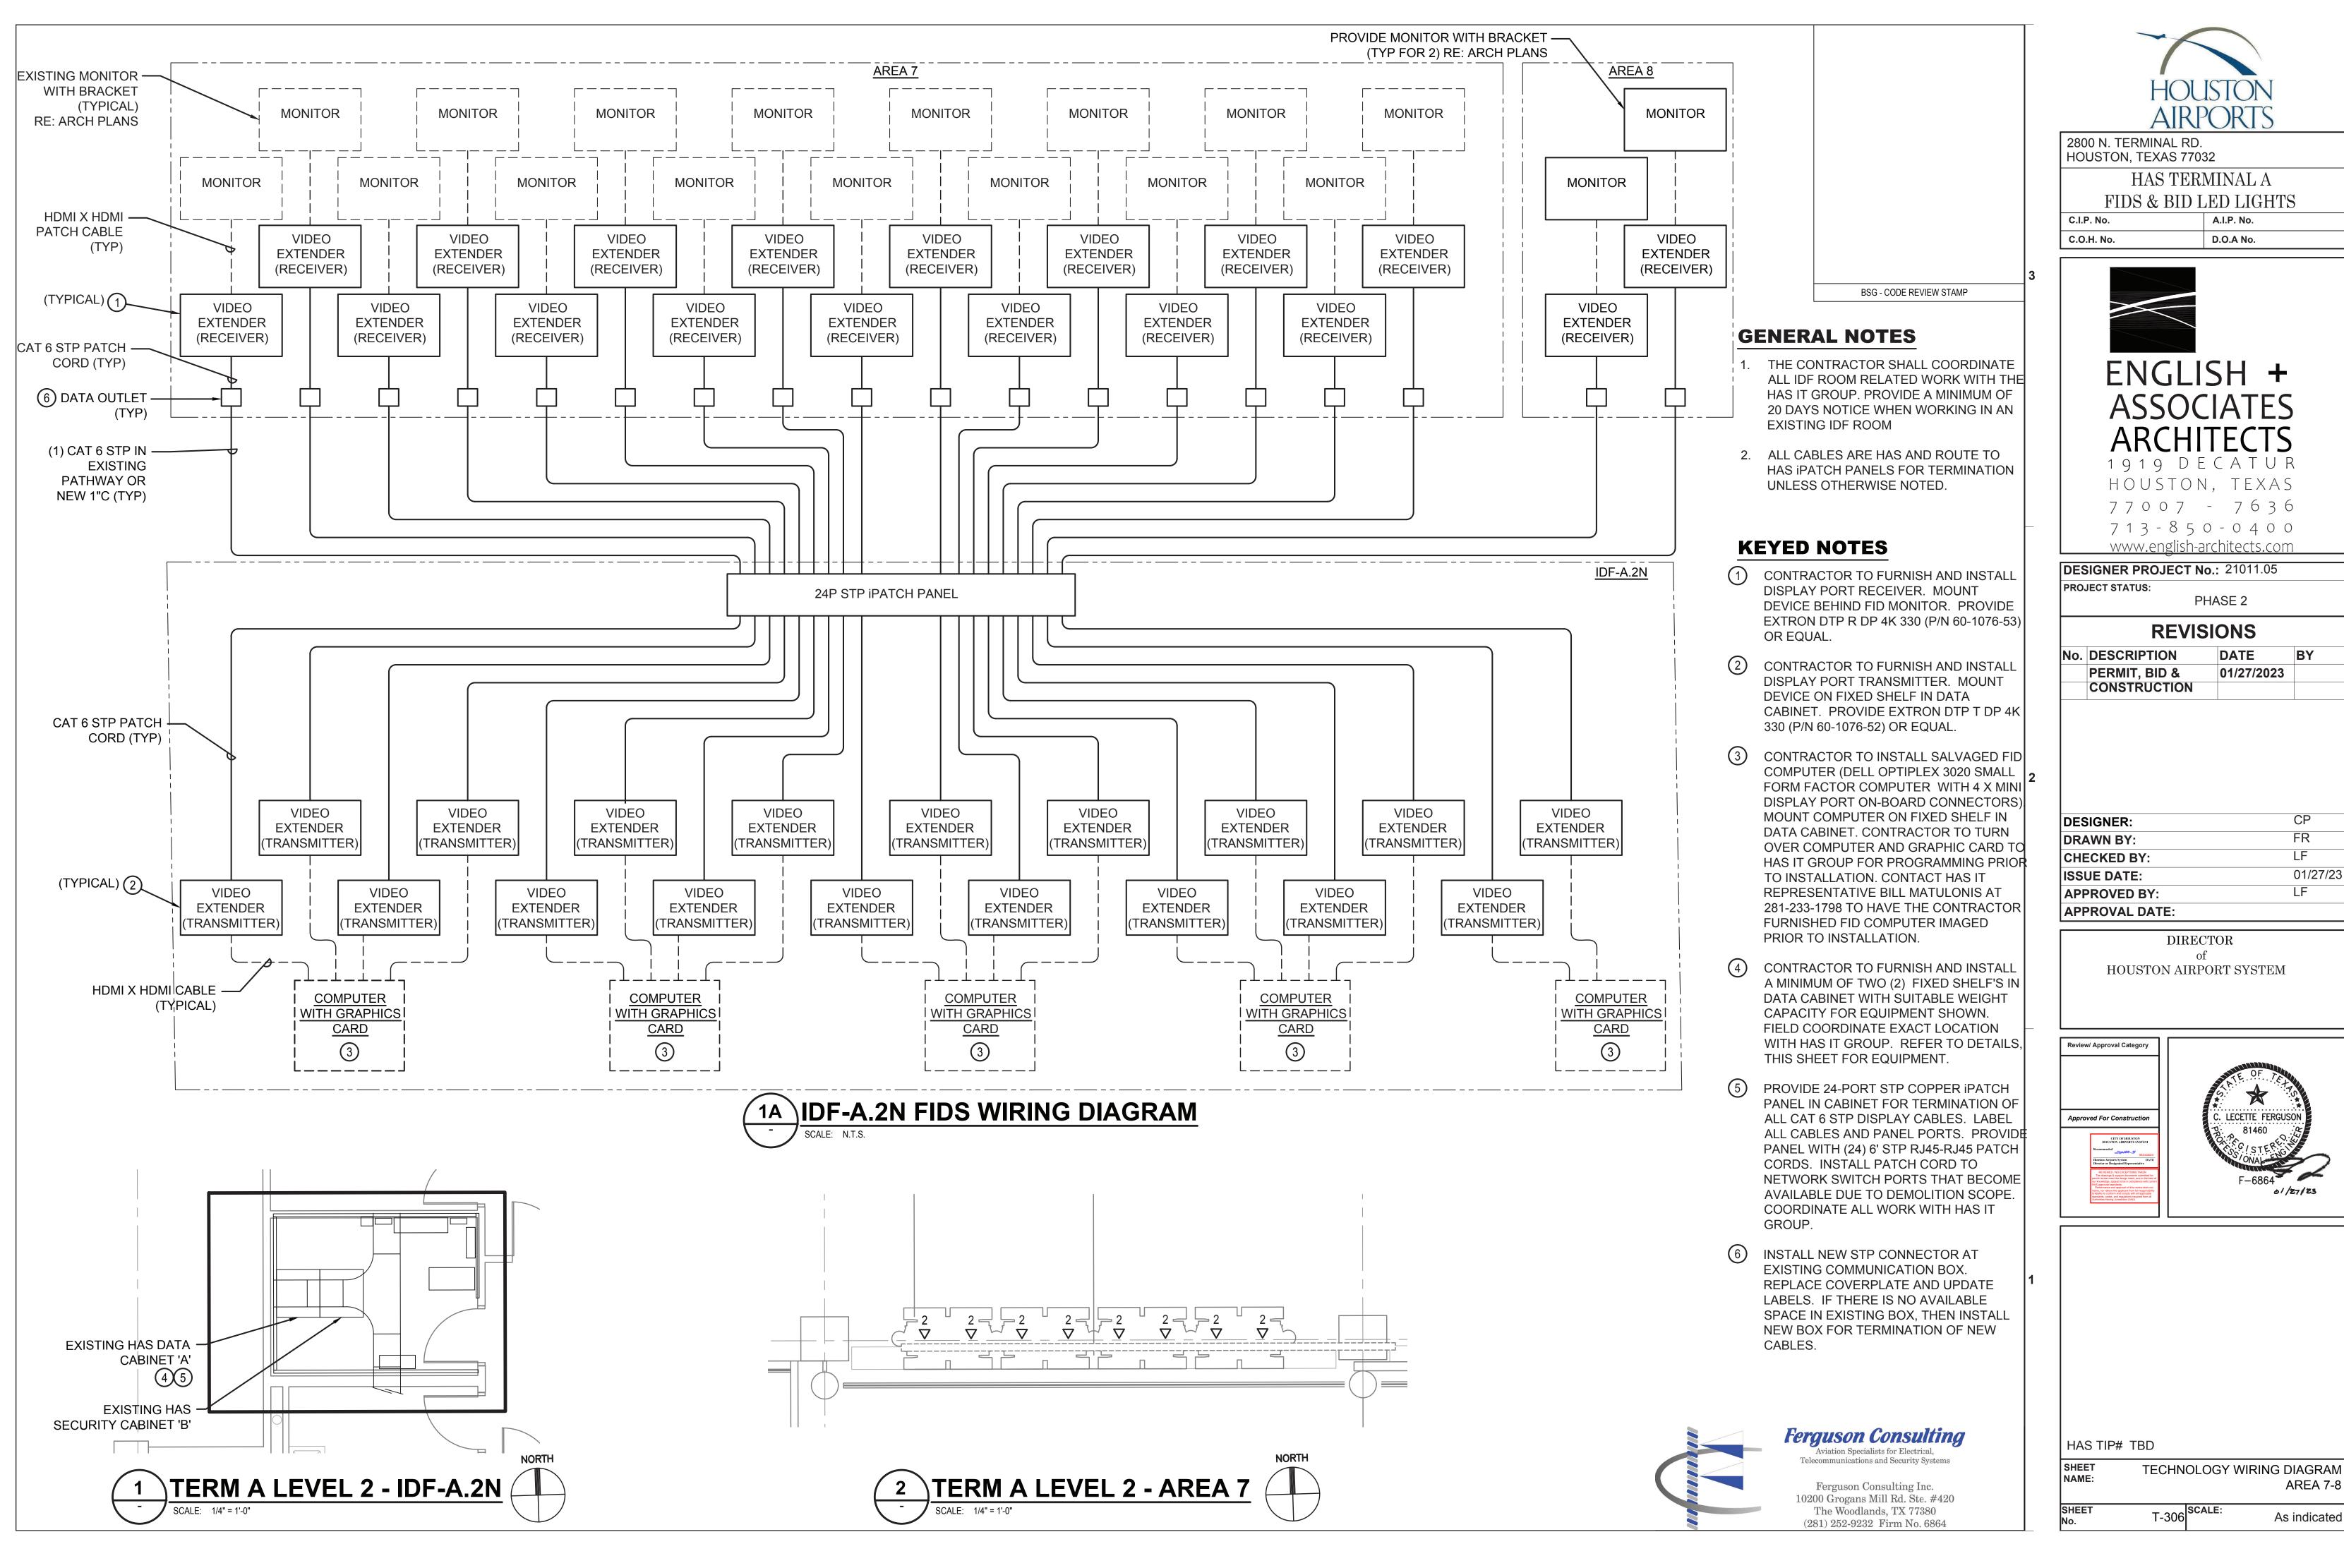
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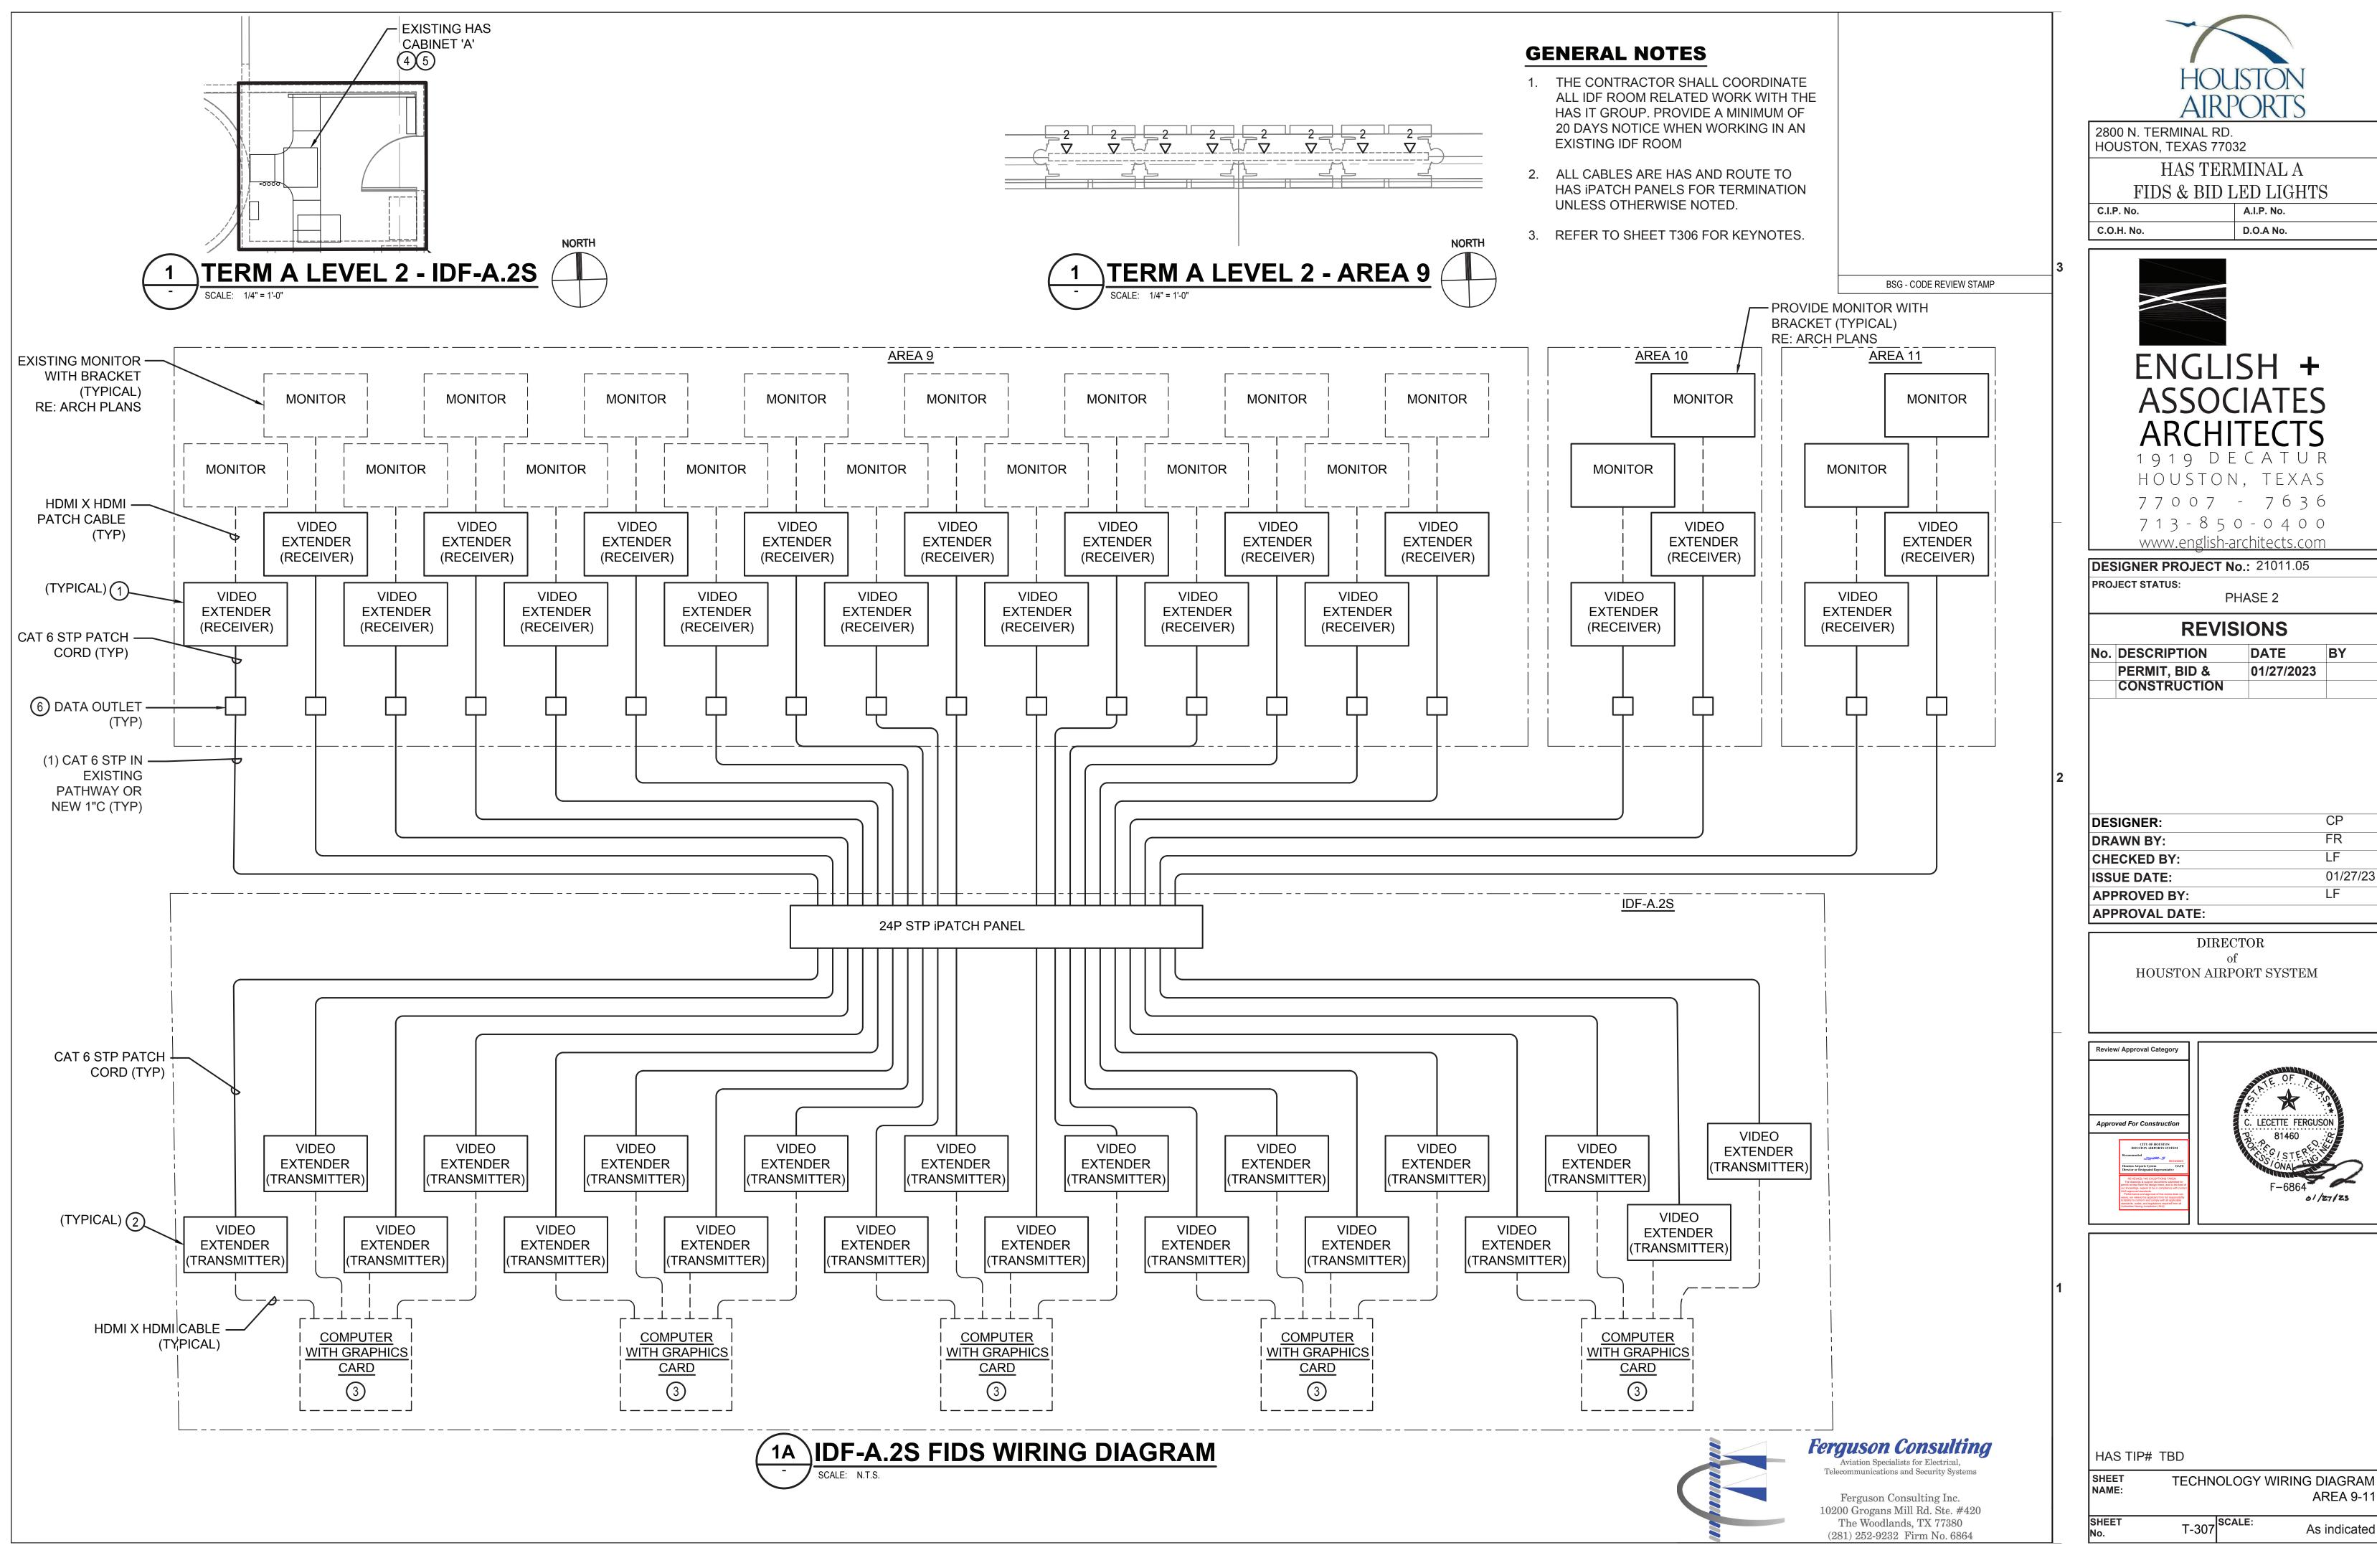
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HAS TIP# TBD **TECHNOLOGY WIRING DIAGRAM** NAME: **AREA 4-6** T-305 SCALE:




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EXTRON DTP R DP 4K 330 (P/N 60-1076-53)

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THIS SHEET FOR EQUIPMENT.

FIELD COORDINATE EXACT LOCATION

**EXISTING IDF ROOM** 

OR EQUAL.
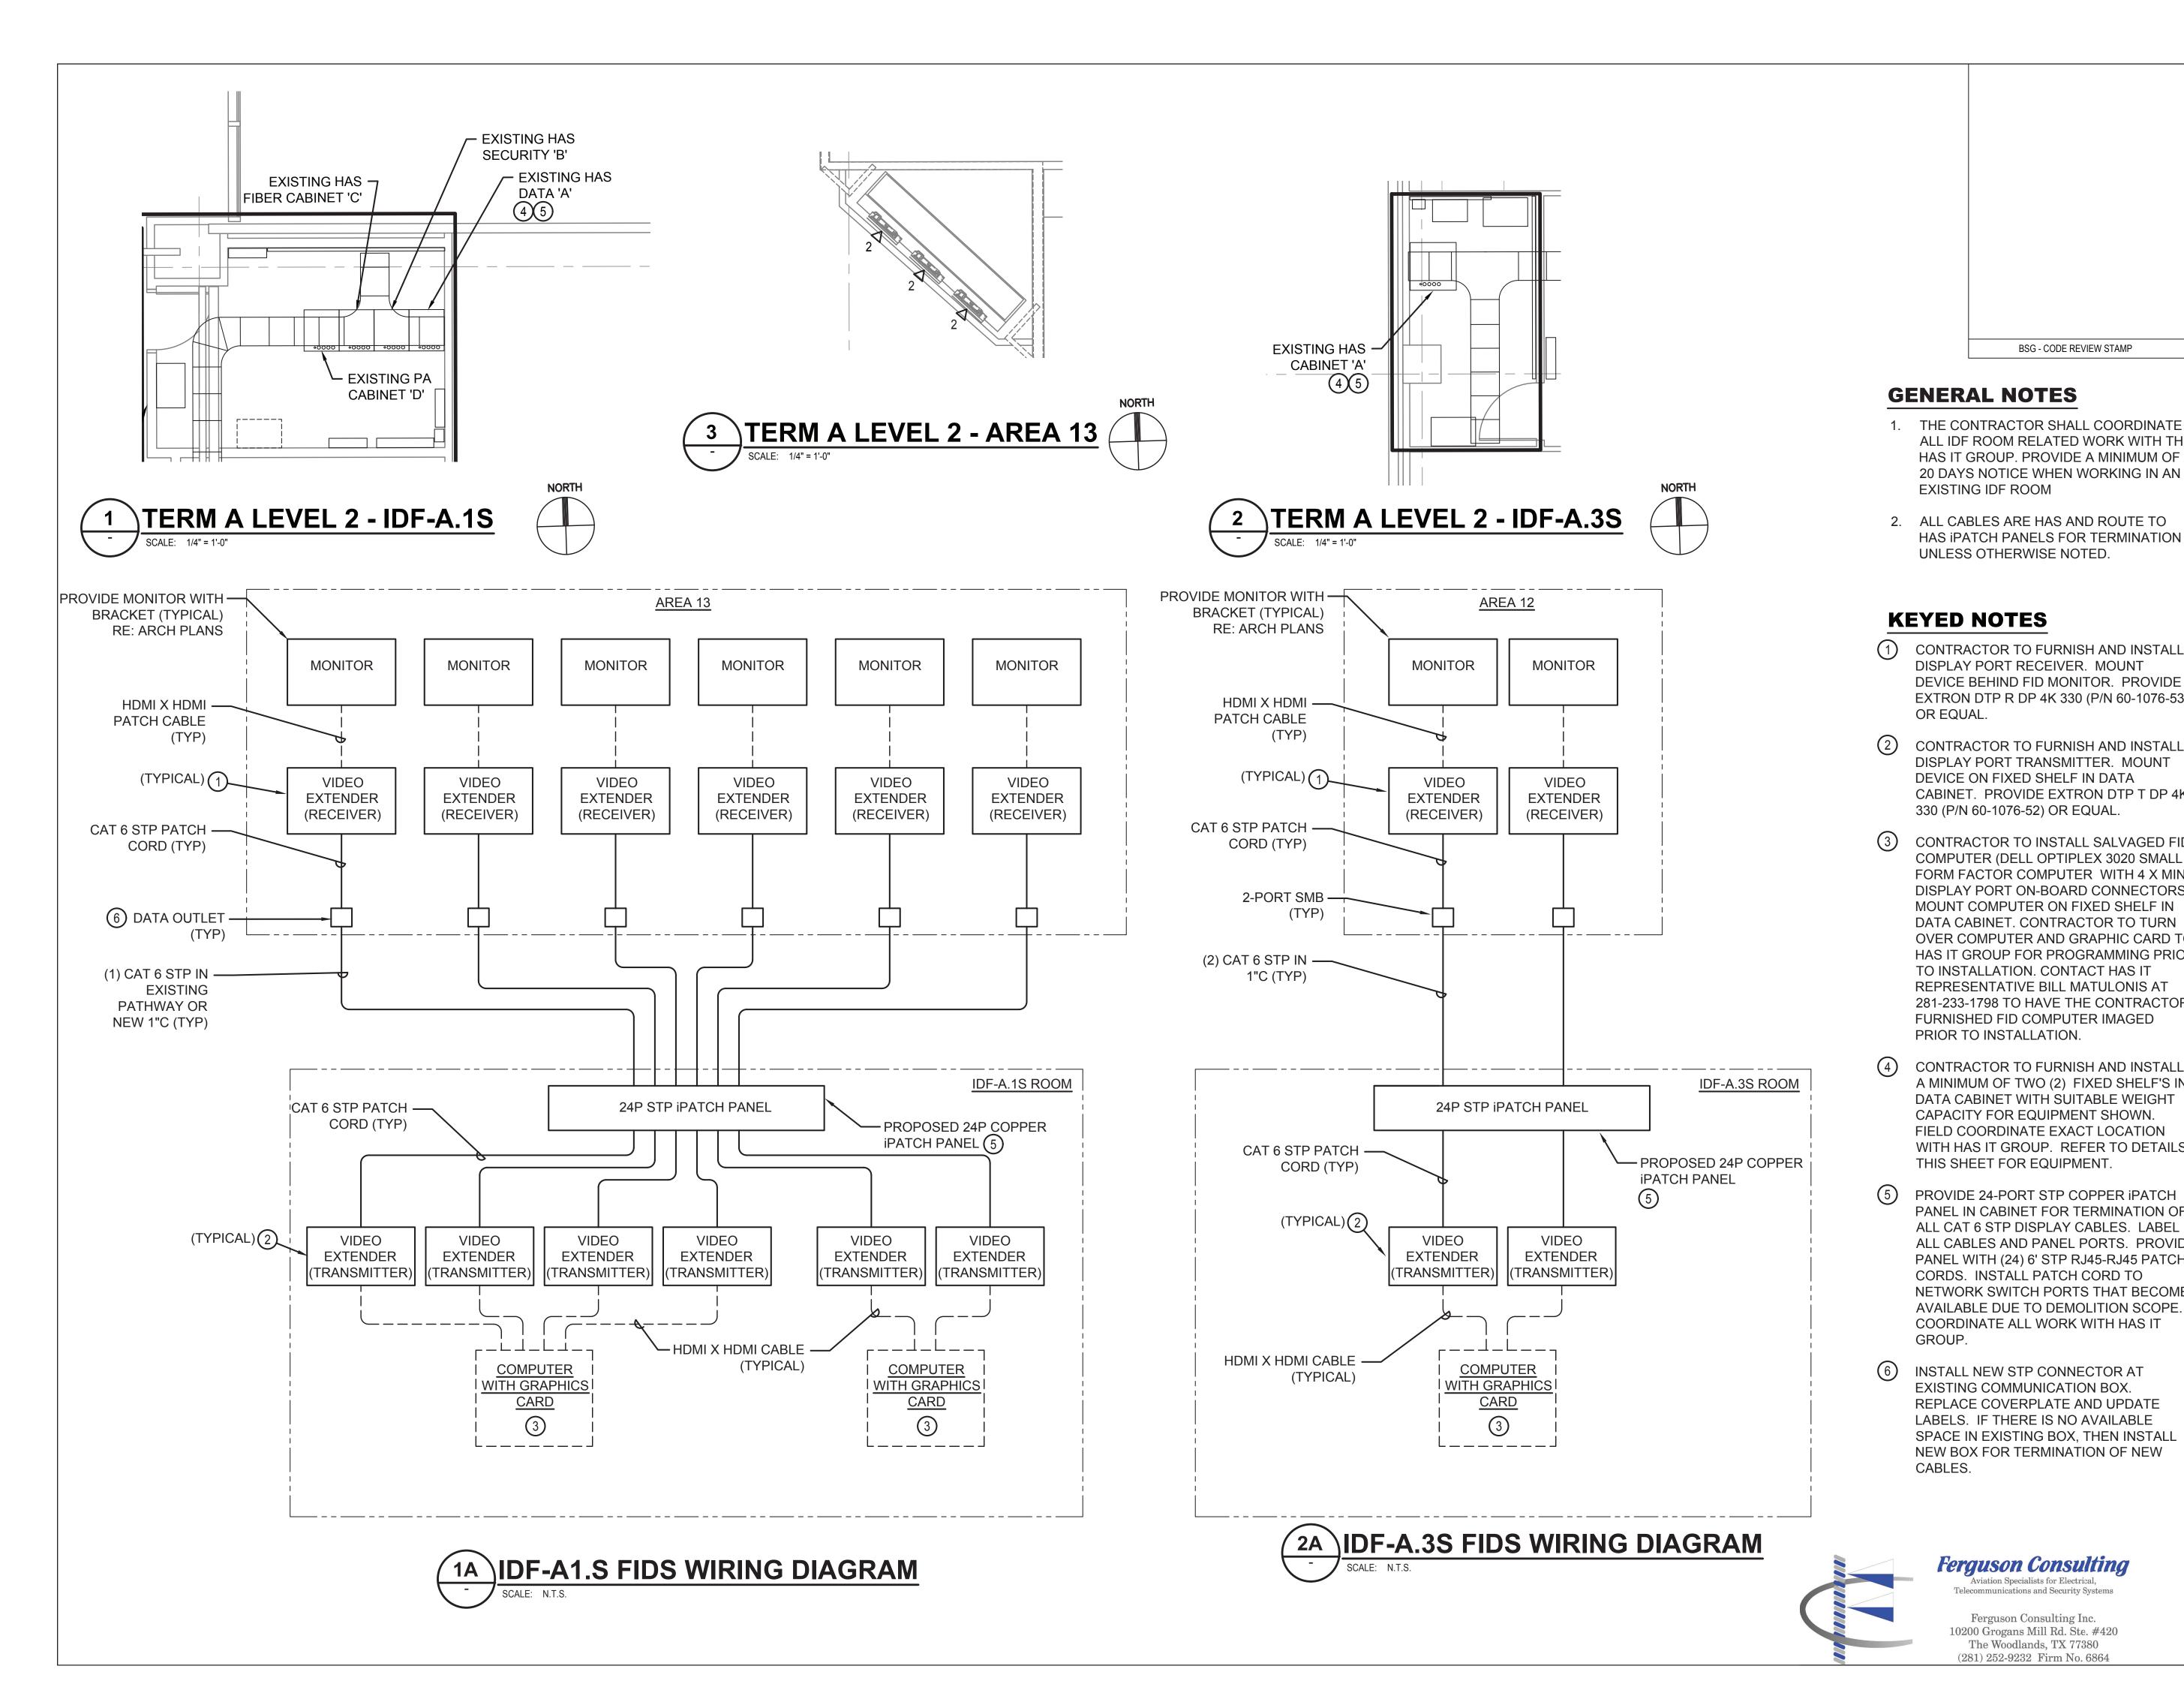
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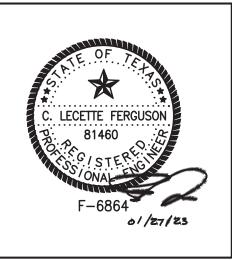
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AREA 12-13


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> **TECHNOLOGY WIRING DIAGRAM** NAME: T-308 SCALE:



SCALE: 1" = 1'-0"



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CP DESIGNER: FR DRAWN BY: **CHECKED BY:** 01/27/23 **ISSUE DATE:** 
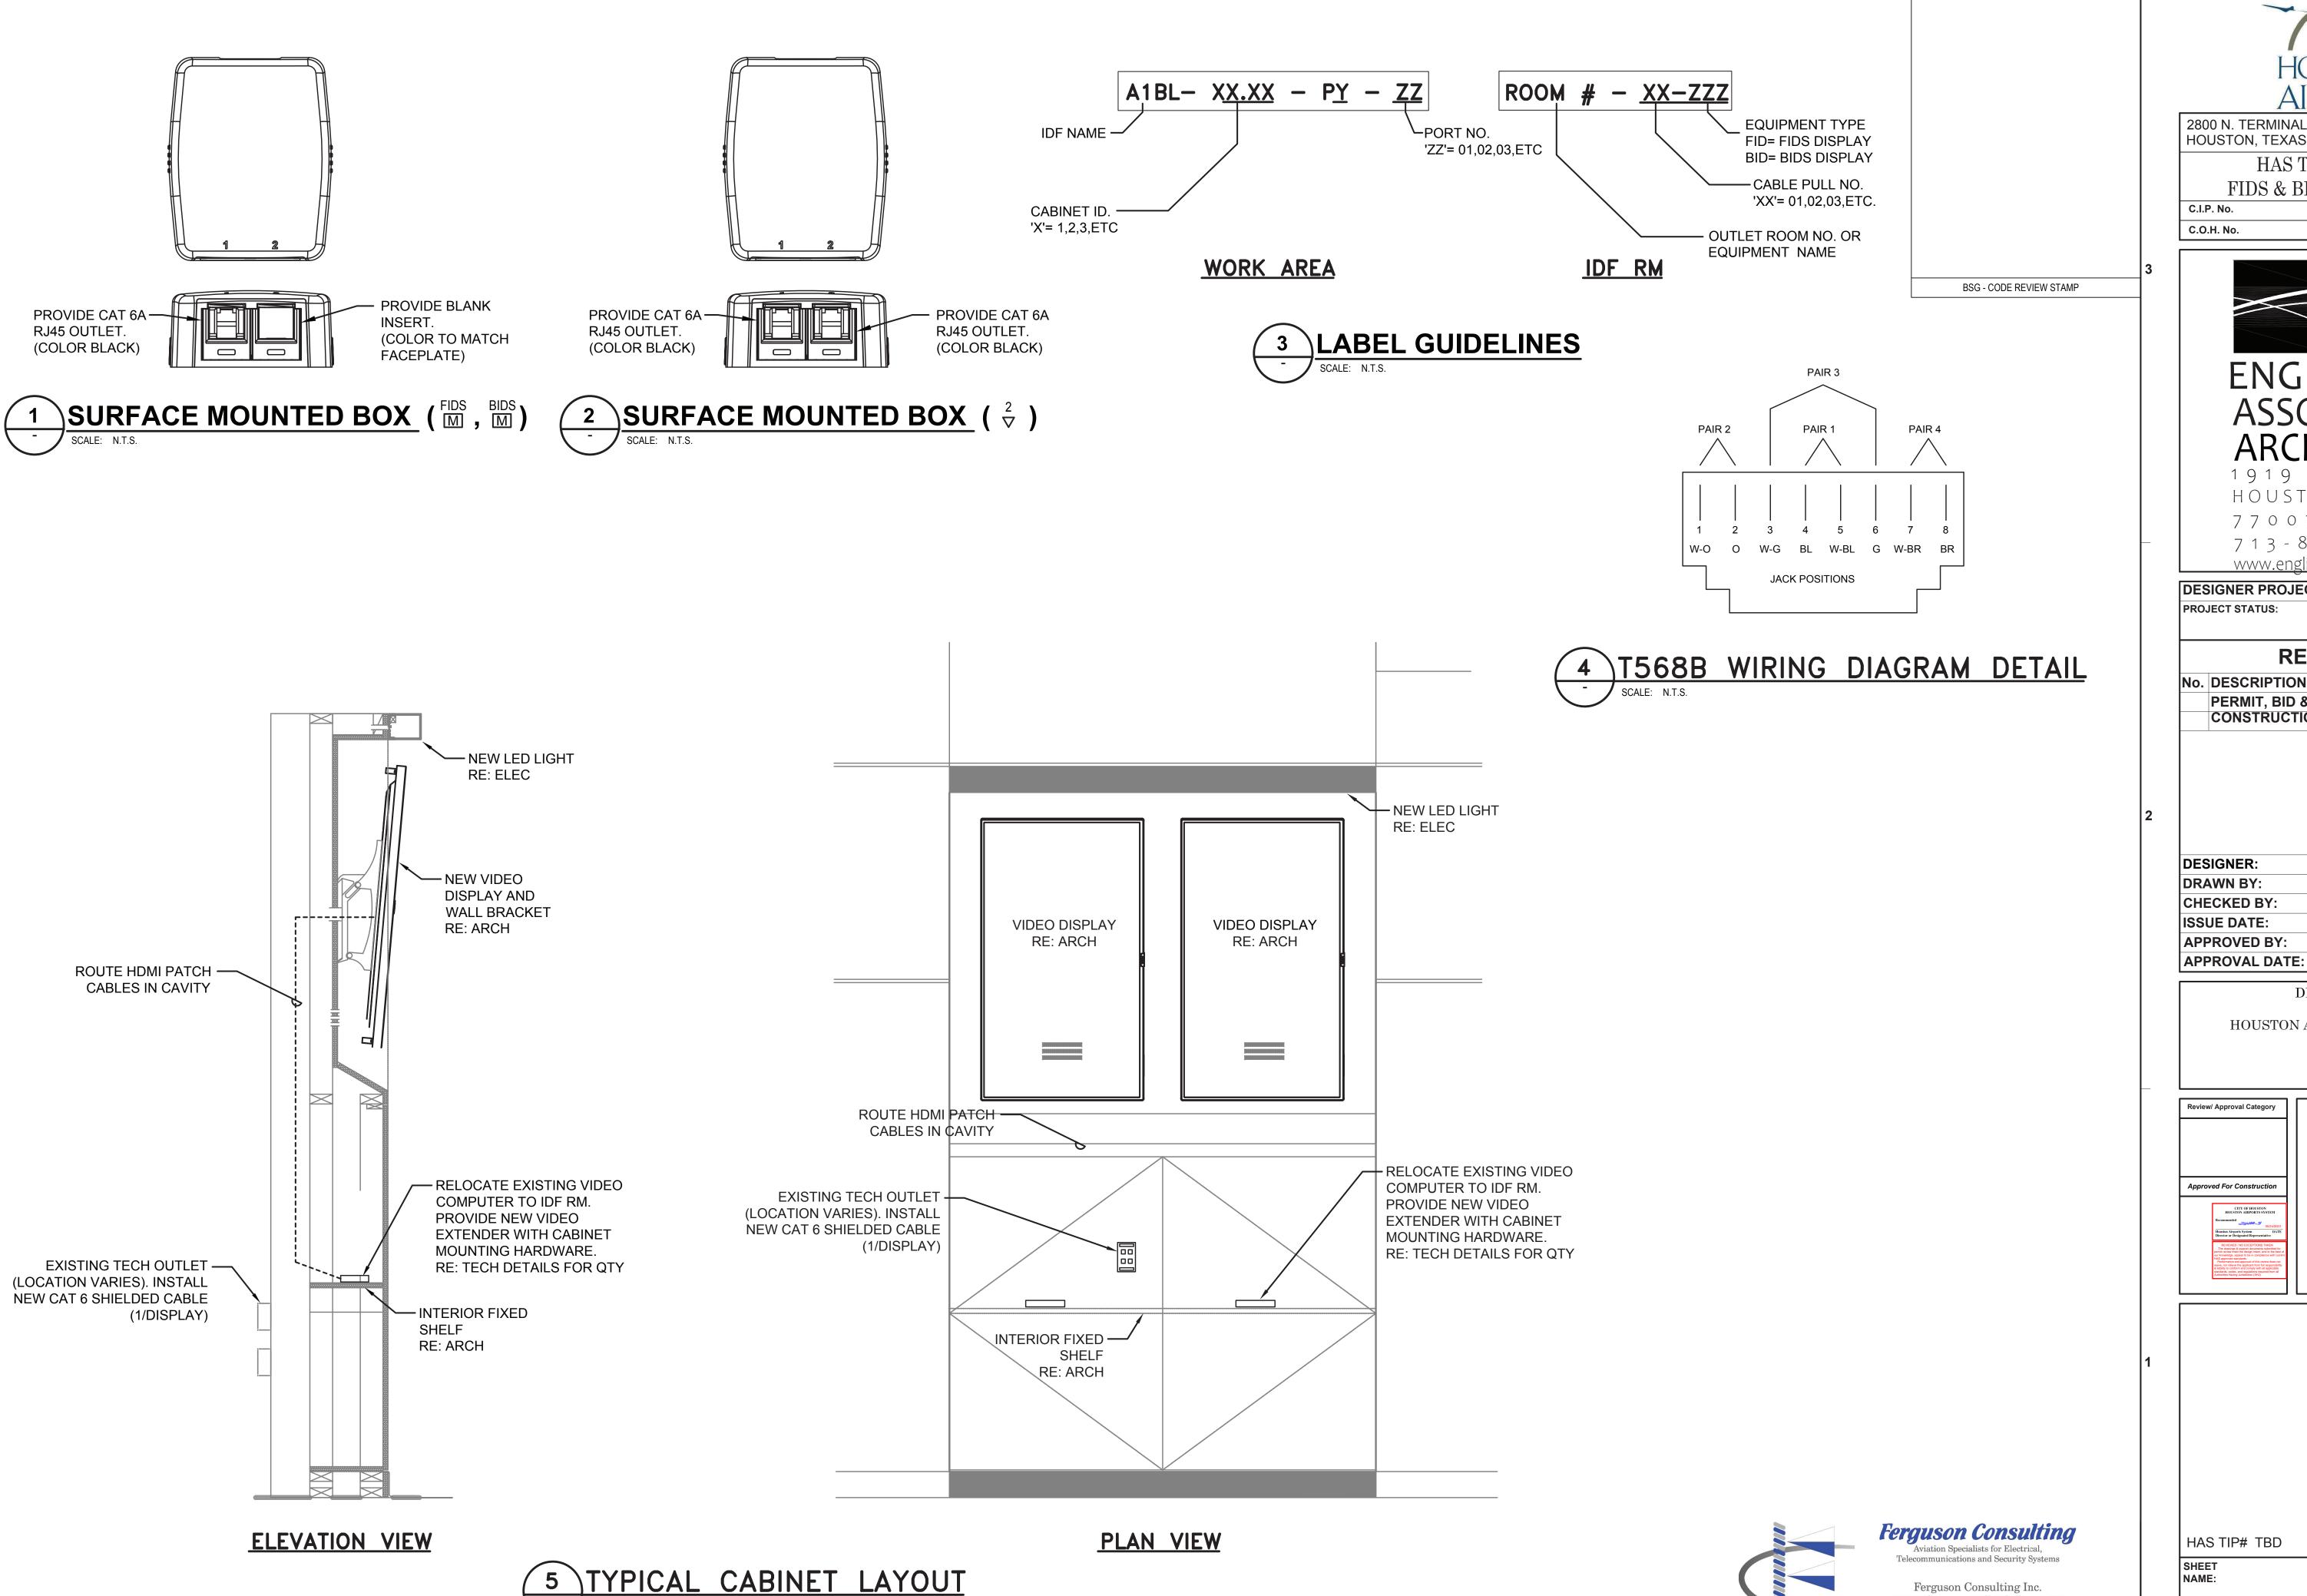
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HAS TIP# TBD

SHEET DETAILS NAME: T-401 SCALE: As indicated